


Document Set ID: 6419983 version: 1, version Date: 10/02/2015

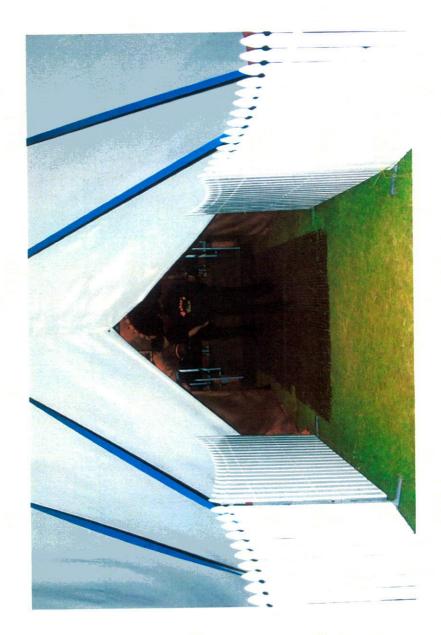







version: 1, version Date. 10/02/2019



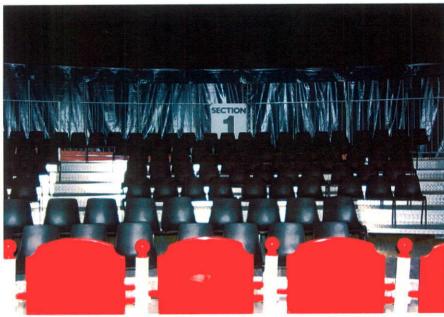



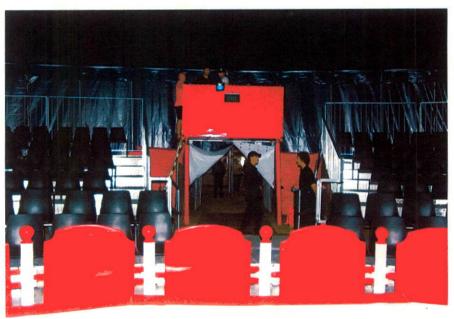

## INFORMATION MANUAL

for

## WEBERS CIRCUS

#### **INDEX**

- 1. INTRODUCTION THE SHOW
- 2. THE PRODUCERS
- 3. INFORMATION BRIEF
- 4. SITE PLAN
- 5. TECHNICAL DATA
- 6. FOYER SALES
- 7. EMERGENCY EVACUATION
- 8. INSURANCE

# 1. INTRODUCTION THE SHOW

### 1. INTRODUCTION

#### **WEBERS CIRCUS**

Webers Circus with a touch of South America takes you through a journey of exciting circus acts and Salsa dancing. Featuring the Wheel of Death and High Wire from Colombia, Trapeze, Hula Hoops, Miniature Horses and Clowns with a difference. Enjoy the excitement, fun and laughter for all ages.

The magic of the circus is presented by world class acts and artistes from Colombia, Hungary, Germany, New Zealand and Australia with everything to love about the circus – from the crazy and riotous antics of the clowns to the skill and daring of the aerialists.

The show features magnificent sets and costumes, sophisticated lighting, performing miniature horses and comedy dogs.

### 2. THE PRODUCERS

#### 2. THE PRODUCERS

Webers Circus presents a new production of circus in Australia by the experienced managers Rudy and Natalie Weber. They have previously been involved in the hit musicals "Cats", "Grease", "Shout" and "Long Way to the Top" and have co-produced and toured, "The Great Moscow Circus" and more recently "Cirque le Voyageuse".

Webers Circus with a touch of South America is the latest show touring Australia by the Weber family. The Webers came to Australia in 1972 from Germany. Their family history goes back six generations in circus with three generations currently here in Australia. Together Rudy, Natalie and their three daughters, Wonita, Dakota and Wonona travel, perform and do correspondence school. Natalie is originally from the famous West circus family in Australia and is herself a fifth generation circus member.

#### **CONTACT DETAILS:**

Rudy Weber:

0419 419 165

Natalie Weber:

0412 850 478

Office: Bookings: 0448 247 022

Address

0448 247 287

Address:

P.O. Box 573 ORMEAU QLD 4208

Website:

www.weberscircus.com

Email:

weberscircus@yahoo.com.au

## 3. INFORMATION BRIEF

#### 3. INFORMATION BRIEF

#### 2.1 Seating Capacity

There is provision for 594 persons in all chair seating configuration (See TRH report for technical details)

#### 2.2 Performances

It is proposed to hold 7 to 8 performances per week including matinees on Saturdays and Sundays. This may vary according to the relevant season, i.e. School Holidays and the like.

#### 2.3 Show Duration

The show is 2 hours including interval

#### 2.4 Performance Times

Times may vary from time to time depending on the season. As a guide an evening performance begins at 7.30pm and concludes at 9.30pm.

#### 2.5 Ticketing

Entry to the performance is on a ticket basis through our phone booking service and on site booking office.

#### 2.6 Toilets

Local contractors are engaged if onsite facilities are insufficient.

#### 2.7 General Rubbish Disposal

Local contractors are engaged to provide a large rubbish collection (industrial bin) and the circus provides smaller wheelie bins for public use both inside and outside tent.

#### 2.8 Disabled Provisions

Seating allocations are provided for each performance at ringside level which is accessed be a ramp at the main entrance. The ushers and house staff are on stand by to assist as required.

#### 2.9 Parking

Parking facilities vary from venue to venue and as such arrangements are made with the relevant authorities prior to the event to accommodate this requirement. We provide parking management as required. Local police will be advised of the event.

Pocument Set ID: 6419983 ersion: 1, Version Date: 16/02/2015


### 4. SITE PLAN

## 5. TECHNICAL DATA


## 5. TECHNICAL DATA

### 5a. TENT (BIG TOP)

5a 1	<b>Tent Plan and elevation</b>
5b 2	<b>Manufacturers statement</b>
5c 3	<b>Engineers Certificate</b>
5d 4	<b>BCA Compliance – TRH Report</b>

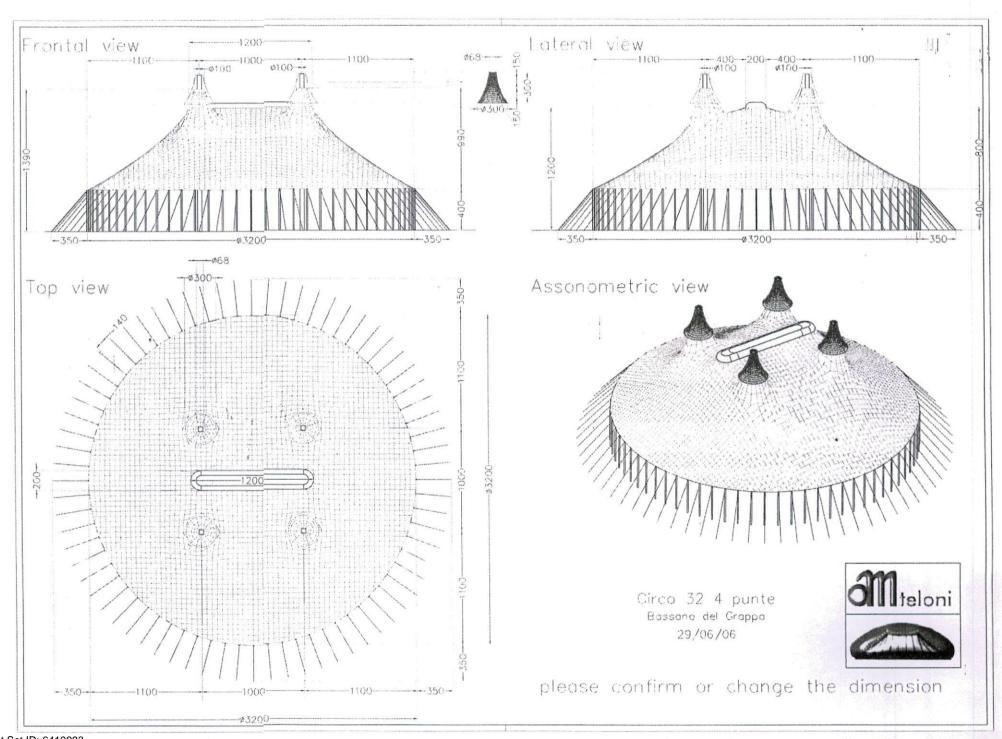

on: 1 year on Day 3/02/2

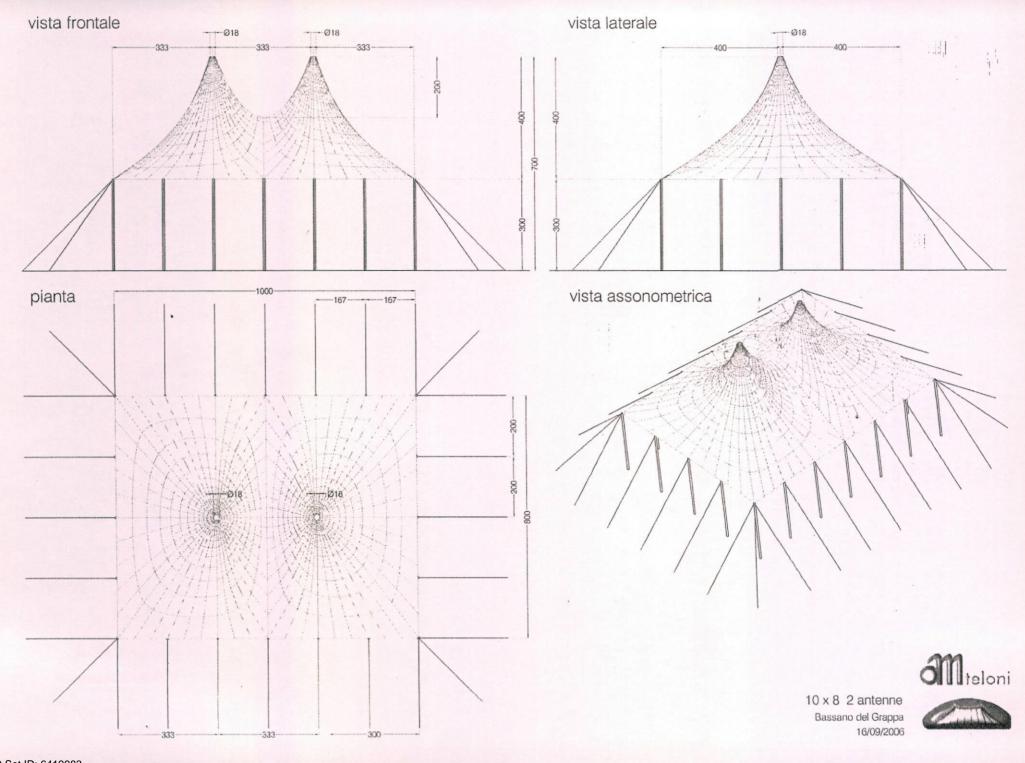

version: 1 version Date: 16/02/2015

## an

#### MIOTTI GIANANTONIO & C. s.a.s.

#### PRODUZIONE TELONI IMPERMEABILI TAPPEZZERIA AUTO

Romano d'Ezzelino, 25 September 2006

SPETT.LE DITTA

Weber Circus 537 Jacobs Well Road Alberton Queensland (Australia)

Oggetto: FIREPROOF DECLARATION

We certify that the material PRECONTRAINT 702 M2, ref. our invoice **n. 128** dated **25/09/2006** was approved with reaction fire's test CSE RF 1/75/A CSE RF 3/77 – DIN - by LAPI SRL CALENZANO with number **MN222A70CD200003** of MINISTERO DEGLI INTERNI - DIREZIONE GENERALE DELLA PROTEZIONE CIVILE on behalf of F.LLI GIOVANARDI SNC – VILLIMPENTA MN.

The material has been manufacture from our company with the observance of the rules.

Direction for use: 1) Material's use

2) The material's laying: ......

3) Maintenance: Method "C" and "D", enclosure 1.6 = D.M. Dated 26/06/84

36060 ON THE TANANTONO & C. SAS 36060 ON THE TANANTONO & C. SAS 2 FLINO (VI) CIO. T. TANANTONO & C. SAS CIO. TA

Document Set ID: 6419983 Prsion: 1, Version Date: 16/02/2015



#### MIOTTI GIANANTONIO & C. s.a.s.



CALIFORNIA DEPARTMENT OF FORESTRY and FIRE PROTECTION
OFFICE OF THE STATE FIRE MARSHAL

#### REGISTERED FLAME RESISTANT PRODUCT

Product:

PRECONTRAINT 702,392


Registration No. F-44402

Product Marketed By:

FERRARI SA BX54,38352 LA TOUR DU PIN LA TOUR DU PIN, FRANCE

This product meets the minimum requirements of flame resistance established by the California State Fire Marshal for products identified in Section 13115, California Health and Safety Code.

The scope of the approved use of this product is provided in the current edition of the CALIFORNIA APPROVED LIST OF FLAME RETARDANT CHEMICALS AND FABRICS, GENERAL AND LIMITED APPLICATIONS CONCERNS published by the California State Fire Marshal.

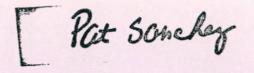

Expire: 06/30/2005

Deputy State Fire Marshal

FR-8

SERVIZIO I LUNIOU CE I TRALLI Isperiorato Attività e Normative Speciali di Prevenzione Incendi

Codice Omolog. MN222A70CD200003 del 6/3/87

VALIDITA RINNOVATA AL 6/3/97

L'ISP. GEN. CAPO (Dotting. Paolo ANCILLOTTI)



### VALIDITA' ULTERIORMENTE RINNOVATA AL 06/03/2002

p. L'ISPETTORE GENERALE CAPO IL DIRIGENTE DEL SERVIZIO TECNICO CENTRALE (Dott. Ing. Alberto d'ERRICO)





#### DIPARTIMENTO DEI VIGILI DEL FUOCO DEL SOCCORSO PUBBLICO E DELLA DIFESA CIVILE

DIREZIONE CENTRALE PER LA PREVENZIONE E LA SICUREZZA TECNICA AREA RISCHI INDUSTRIALI

Validità ulteriormente rinnovata al; 06/03/2007

Atto di omologazione non ricadente nei casi previsti dall'art.3, comma 2, del D.M.03/09/2001

IL DIRETTORE CENTRALE (Dott.Ing. Michele FERRARO)

ay

MODULARIO

SERVIZIO TECNICO CENTRALE Ispettorato Attività e Normative



LLA PROTLZ ONE CIVILE

MOD. 3 PC

(ex Mod. 863)

Speciali di Prevenzione Incendi (1900)

Ministero dell'Interno

#### DIREZIONE GENERALE DELLA PROTEZIONE CIVILE

VISTO il decreto ministeriale 26 giugno 1984 concernente "Classificazione di reazione al fuoco ed omologazione ai fini della prevenzione incendi ";

VISTA l'istanza presentata dalla ditta F.LLI GIOVANARDI S.n.c. sita in via G. Marconi, 63 - 46039 VILLIMPENTA (MN), produttrice del materiale denominato "PRECONTRAINT 702 M2" per ottenere l'omologazione del materiale stesso ai fini della prevenzione incendi;

VISTO il certificato di reazione al fuoco n° 512 emesso per il predetto materiale dal LA.P.T. di G. Borsini e C. sas di Calenzano (VA);

VISTA la scheda tecnica, allegata al predetto certificato, prodotta dalla ditta F.LLI GIOVANARDI S.n.c. di VILLIMPENTA

#### SIOMOLOGA

con il numero di codice MN222A70CD200003 ,il prototipo del materiale denominato "PRECCNTRAINT 702 M2" prodotto dalla ditta F.LLI GIOVANARDI S.n.c. di VILLIMPENTA (MN), ai soli fini della prevenzione incendi, nella CLASSE di REAZIONE al FUOCO 2 (DUE) e se ne AUTORIZZA la riproduzione, ai sensi del decreto ministeriale citato in premessa, conformemente a tutte le caratteristiche apparenti e non apparenti, nonchè a quelle dichiarate dalla predetta ditta nella scheda tecnica parimenti citata in premessa.

Sul marchio o sulla dichiarazione di conformità, da allegarsi ad ogni tipo di fornitura del materiale oggetto della presente omologazione, dovranno essere riportati:

- NOME DEL PRODUTTORE: Ditta F.LLI GIOVANARDI S.n.c. (o altro segno distintivo);
- ANNO DI PRODUZIONE: (da indicarsi);
- CLASSE DI REAZIONE AL FUOCO: 2 (DUE)
- CODICE: MN222A70CD200003;
- POSA IN OPERA: SOSPESO SUSCETTIBILE DI PRENDERE FUOCO SU AMBO LE FACCE ;
- IMPIEGO: TENDONE ;
- MANUTENZIONE: METODI "C e D" ALLEGATO A 1.6 AL D.M. 26/6/1984

Si richiamano tutti gli obblighi di legge spettanti al produttore e a tutti i soggetti comunque interessati, a norma del Codice Civile, del Codice Penale e del decreto ministeriale 26 giugno 1984.

Roma, 6 marzo 1987

Fasc. 4190 sott. 212

N.B: IL PRESENTE ATTO DI OMOLOGAZIONE E' RIPRODUCIBILE UNICAMENTE NELLA SUA INTEGRALE STESURA L'ISPETTORE GENERALE CAPO (Dott.Ing. Cesare SANGIORGI)



#### Rudy Ernie Weber

in accordance with part 11 of the Building Act 1993 is registered as a **Building**Practitioner in the category and class specified and has satisfied all relevant provisions of the Act.

Registration Number V2 17304 Supervisor -Tmp Struc Class 2

Printed on 7 December, 2004

Carolyn Lloyd Chair Peter Brilliant Registrar



#### PLACE OF PUBLIC ENTERTAINMENT

#### PREPARED FOR

Webers Circus

#### REGARDING

Webers Circus – Temporary Place of Public Entertainment

Trevor R Howse & Associates Pty Ltd ABN 24 003 753 839 Level 8, 210 George Street, Sydney NSW 2000 PO Box N694, Grosvenor Place, NSW 1220 Telephone +612 9251 4500 Facsimile +612 9252 9822 Email trh@trh.com.au www.trh.com.au Building Regulations Fire Safety Engineering Management Services

#### REPORT REGISTER

The following report register documents the development and issue of this report and project as undertaken by this office, in accordance with the *Quality Assurance* policy of Trevor R Howse & Associates Pty Ltd.

Our Reference	Issue No.	Remarks	Issue Date
J29080	-1	Completed report issued to client	29.04.09
	,		
1,			
	1 10 1111111111111111111111111111111111		
	1 20 1 10		P

The format, technical content and intellectual property associated with this report remain the property of Trevor R. Howse & Associates Pty Limited, and has been prepared and may only be used, for the development / buildings the subject of this report.

#### CONTENTS PAGE

1.0	INTRODUCTION 1
1.1	General1
1.2	Report Basis1
1.3	Exclusions1
1.4	Report Purpose
2.0	BUILDING DESCRIPTION 3
2.1	General
2.2	Rise in Storeys (Clause C1.2)
2.3	Building Classification (Clause A3.2)
2.4	Effective Height (Clause A1.1)
2.5	Type of Construction (Table C1.1)
2.6	Floor Area and Volume Limitations
3.0	POPE ASSESSMENT – SUMMARY 4
3.1	General4
3.2	Regulation 98C - Conditions applying to use of buildings as POPE4
3.3	Schedule 3A – Places of public entertainment
3.4	Part B1 – Structural provisions
3.5	Part H102 – Temporary structures5
4.0	POPE ASSESSMENT - DETAILED ANALYSIS 6
4.1	General6
4.2	Regulation 98C – Conditions applying to use of buildings as POPE6
4.3	Schedule 3A – Places of public entertainment6
4.4	Part B1 – Structural provisions6
4.5	Part H102 – Temporary structures

#### <u>ANNEXURES</u>

Annexure "A" - Architectural Plans

Annexure "B" - Tent material flammability

Document Set ID: 6419983 Persion: 1, Version Date: 16/02/2015

#### 1.0 Introduction

#### 1.1 GENERAL

This "Place of Public Entertainment" report has been prepared at the request of Webers Circus, and relates to the proposed temporary Place of Public Entertainment structure, the Webers Circus.

This report is based upon and limited to, the information depicted in the documentation provided for assessment, and does not make assumptions regarding "design intention" or the like.

From this documentation, it is understood that the proposed development encompasses –

(a) The erection of a temporary tent structure, incorporating internal demountable tiered seating

#### 1.2 REPORT BASIS

The content of this report reflects -

- (a) Regulation 98C and Schedule 3A in the Environmental Planning & Assessment Regulation 2000 (EP&A Regulation);
- (b) The Building Code of Australia 2008 (BCA 2008);
- (c) Architectural documentation provided by Webers Circus (refer Annexure "C").
- (d) Site inspection undertaken 20 April 2009 at Wollongong.

#### 1.3 EXCLUSIONS

It is conveyed that this report should not construed to infer that an assessment for compliance with the following has been undertaken –

- (a) Structural and services design documentation;
- (b) General building services (i.e. passenger lifts);
- (c) The individual requirements of service providers (i.e. Telstra, Sydney Water, Energy Australia);
- (d) The individual requirements of the WorkCover Authority;
- Those provisions of BCA 2008 not relevant to temporary places of public entertainment;
- (f) Disability Discrimination Act 1992 (DDA).

#### 1.4 REPORT PURPOSE

Temporary places of public entertainment must comply with the applicable provisions of Regulation 98C, as contained within the EP&A Regulation.

This report has been prepared to identify the extent to which the proposed design documentation complies with the relevant provisions of this Regulation, as also activates Schedule 3A from the EP&A Regulation and Parts B1 and H102 of BCA 2008.

Assessment of the proposed design considers each of the relevant requirements, and identifies such as either –

- (a) Being complied with; or
- (b) Not being complied with; or
- (c) Requiring the provision further detail; or
- (d) Not being relevant to the particular building works proposal.

The status of the design, in terms of these four (4) categories, is summarised within Part 3 of this report.

Where prescriptive non-compliance is identified, suitable recommendations to remedy the non-compliance shall be detailed in Part 4.

In instances where insufficient detail exists, summary of the information required from the project team shall also be outlined in Part 4.

#### 2.0 BUILDING DESCRIPTION

#### 2.1 GENERAL

In the context of the Building Code of Australia (BCA), the subject development is described within items 2.2 - 2.6 below.

#### 2.2 RISE IN STOREYS (CLAUSE C1.2)

Having a rise in storeys of one (1)

#### 2.3 BUILDING CLASSIFICATION (CLAUSE A3.2)

Being of single classification, namely: -

(a) Class 9b – Assembly

#### 2.4 EFFECTIVE HEIGHT (CLAUSE A1.1)

Having an effective height not exceeding 25 metres.

#### 2.5 Type of Construction (Table C1.1)

Based upon the rise in storeys and classification contained within the building, compliance is required with the fire rating requirements of Type C Construction.

#### 2.6 FLOOR AREA AND VOLUME LIMITATIONS

(a) The building is subject to the following maximum fire compartment floor area and volume limits for Type C Construction: –

□ Class 9b − Floor area −  $3,000 \text{ m}^2$ − Volume −  $18,000 \text{ m}^3$ 

#### 3.0 POPE ASSESSMENT - SUMMARY

#### 3.1 GENERAL

The tables contained within items 3.2 - 3.5 below summarise the compliance status of the proposed design in terms of Regulation 98C and Schedule 3A of the EP&A Regulation, and Parts B1 and H102 of BCA 2008.

For those instances of either "prescriptive non-compliance" or "insufficient detail", a detailed analysis and commentary is provided within Part 4.

#### 3.2 REGULATION 98C - CONDITIONS APPLYING TO USE OF BUILDINGS AS POPE

EP&A Regulation reference	Complies	Does not comply	Detail required	Not relevant
Sub-clause (1)				1
Sub-clause (2)			1	
Sub-clause (3)				1
Sub-clause (4)			1	
Sub-clause (5)				/

#### 3.3 SCHEDULE 3A - PLACES OF PUBLIC ENTERTAINMENT

EP&A Regulation reference	Complies	Does not comply	Detail required	Not relevant
Sub-clause 1 – dangerous entertainment	T			1
Sub-clause 2 – stage management				1
Sub-clause 3 – proscenium safety curtains				1
Sub-clause 4 – projection suites				1
Sub-clause 5 - marking of aisles and cross-overs				1
Sub-clause 6 – seating in rows	1			
Sub-clause 7 – seating in paths to designated exit	1			
Sub-clause 8 – aisle lights to be on			<b>✓</b>	
Sub-clause 9 – locks				1
Sub-clause 10 – rope barriers				1
Sub-clause 11- emergency evacuation plans			<b>✓</b>	
Sub-clause 12 - council may require fire safety info				1
Sub-clause 13 – upholstery, curtains or blinds	1			

#### 3.4 PART B1 – STRUCTURAL PROVISIONS

BCA reference	Complies	Does not comply	Detail required	Not relevant
B1.1 – resistance to actions			1	
B1.2 - determination of individual actions			1	
B1.3 – loads			<b>✓</b>	
B1.4 - materials and form of construction			1	

#### 3.5 PART H102 – TEMPORARY STRUCTURES

BCA reference	Complies	Does not comply	Detail required	Not relevant
H102.3 – location of exits	1			
H102.4 – exits to be provided	1			
H102.5 - vertical clearances for exits	<b>✓</b>			
H102.6 – curtains across exits	V			
H102.7 – curtains and blinds				1
H102.8 – fabrics	✓			
H102.9 – guardrails	1			
H102.10 – seating	1			
H102.11 – sanitary accommodation	1			
H102.12 – projection suites				1
H102.13 – fireplaces and heating				1
H102.14 – electrical services			<b>V</b>	
H102.15 – artificial lighting			1	
H102.16 – exit signs			<b>✓</b>	
H102.17 – fire-fighting services			1	

#### 4.0 POPE ASSESSMENT – DETAILED ANALYSIS

#### 4.1 GENERAL

With reference to the "POPE Assessment Summary" contained within Part 3 above, the following detailed analysis and commentary is provided.

This commentary is formulated to enable the design documentation to be further progressed, for the purpose of evidencing the attainment of compliance with the relevant provisions of Regulation 98C of the EP&A Regulation.

4.2	REGULATION 9	8C-Co	NDITIONS	APPLVING TO USE	OF BUILDINGS AS PO	PF
	THE GULATION 3			AFFILLING IN USE	OF BUILDINGS AS FULL	- n.

SubCl. (2)	Refer Items 4.4 and 4.5 of this report below.
	A sign must be displayed in a prominent position in the tent that specifies the following: —  the maximum number of persons that are permitted in the tent; and the name, address and telephone number of the council of the area in which the tent is located.

#### 4.3 SCHEDULE 3A - PLACES OF PUBLIC ENTERTAINMENT

- Cl. 6 Refer Item 4.5 of this report below.

  Cl. 8 Aisle lighting must be maintained in the on-position whenever the building is publicly occupied and the main lighting is dimmed

  Cl. 11 An emergency evacuation plan must be implemented during the use of the building, and must: —

  The location of exits and fire protection equipment

  The number of safety officers present during a performance

  Methodology for how the occupants are evacuated in an emergency

  Safety officers must be appropriately trained.
- Cl. 13 Refer Item 4.5 of this report below.

#### 4.4 PART B1 – STRUCTURAL PROVISIONS

Cl. B1.3	Stru	nctural elements must according Dead & Live Loads	rd with -	
		Dead & Live Loads and Load Combinatio Wind Loads	_	AS 1170.1–1989
		and Load Combination	ons	
		Wind Loads	_	AS 1170.2-1989
Cl. B1.4	Mat	erials and forms of constru	ction must	comply with the following -
		Steel	_	AS 4100-1998

Trevor R. Howse & Associates Pty Ltd

Document Set ID: 6419983 Persion: 1, Version Date: 16/02/2015

#### 4.5 PART H102 - TEMPORARY STRUCTURES

Cl. H102.4	Based upon a peak occupant load within the tent structure of 6594 persons, a total of three (4) exits with an aggregate exit width of 6000-mm must be provided around the perimeter of the building
Cl. H102.5	A clear unobstructed height not less than 2000-mm must be maintained to the exits
Cl. H102.7	Curtains or blinds used within the tent structure must have a flammability index not greater than 6
Cl. H102.8	The tent fabric must have a flammability index not greater than 6
Cl. H102.9	Guardrails of minimum 750-mm height must be provided to the sides and rear of steeper platforms and seating areas
Cl. H102.10	The position and installation of seating must accord with NSW H101.11.
Cl. H102.11	Sanitary facilities must be provided in close proximity to the proposed tent, and be of a sufficient number to accommodate the proposed population
Cl. H102.14	Electrical installations must comply with local authority requirements, AS 3002, and AS/NZS 3000
Cl. H102.15	<ul> <li>□ Artificial lighting switches must be in accessible to members of the public, and instantly re-light via an override button if having a dimming capacity</li> <li>□ Emergency lighting must be provided and have a minimum 0.2 lux, and have a minimum 30-minute battery supply</li> </ul>
Cl. H102.16	Exit signs must be provided above the exits
Cl. H102.17	AS 2444 compliant portable fire extinguishers should be provided throughout, in areas accessible to staff


Author

Kate Howse

**Senior Consultant** 

Trevor R. Howse & Associates Pty Limited

Trevor R. Howse & Associates Pty Ltd

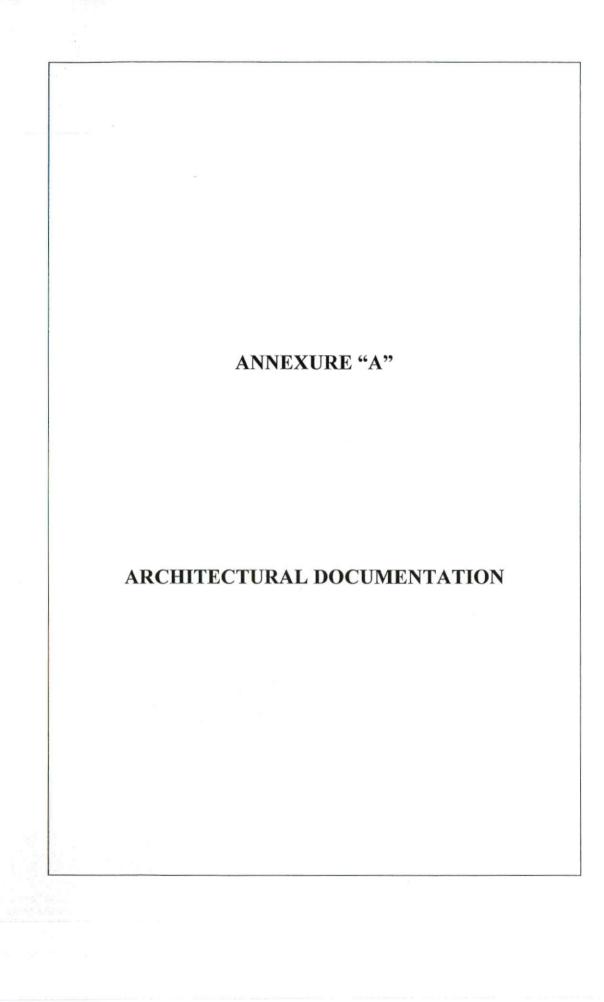

Document Set ID: 6419983 Persion: 1, Version Date: 16/02/2015

#### **5b SEATING**


5 b 1. Seating Plan

5 b 2. Seating Elevation 5 b 3. Structural Certification

5 b 4. BCA Compliance - TRH

Copyright Reproduction in part or whole is forbidden without written permission. Z=1600 7=00 - 1-DOWN SIDE OF SEATING PANEL PANEL B 25x50x1.6 RHS BALUSTRADE < FRAME 3mm THICK ALUMINIUM + CHECKER PLATE FLOOR PANEL S 25x50 RHS BALUSTRADE 4 200 BARS AT 125 MAX CRS 25x50 RHS FLOOR PANEL SUPPORT 1637 TYPICAL 100x50 STRINGER 65x65x4.0 SHS
BALUSTRADE SUPPORT
POSTS WELDED TO ENDS
OF STRINGERS BAULSTRADE SUPPORT POSTS WELDED TO STRINGER BALUSTRADE SUPPORT SUPPORT DETAIL SECTION 2—2 DOWN, SIDE OF SEATING PANEL SEATING SYSTEMS **SECTIONS** location DRAWN BY OSMAN DESIGNPAC (T. FIELD) BY SEATING AUDITORIUM 594 SEATING. CAPACITY WEBERS CIRCUS SHEET 9 P.O.Box 573 ORMEAU SCALE 1:50 PRELIMINARY SUBJECT TO QLD. 4208 SEATING COMPLIANCE C:\DWG\WEBER BROS\6476-31DIA-TENT.DWG Ph: 0448 850 478 Em: weberscircus@vahoo.com.au JOB NUMBER Document Set ID: 6419983

Reproduction in part or whole is forbidden without written permission.

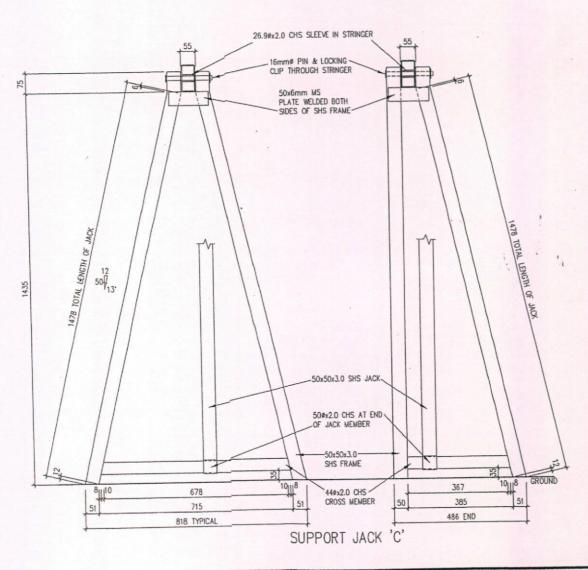

# location

SEATING AUDITORIUM 594 SEATING CAPACITY PRELIMINARY SUBJECT TO SEATING COMPLIANCE

# SEATING SYSTEMS

BY
WEBERS CIRCUS
P.O.Box 573 ORMEAU
QLD. 4208
Ph: 0448 850 478


Em: weberscircus@yahoo.com.au Web: www.weberscircus.com


# SUPPORT JACKS

DRAWN BY OSMAN DESIGNPAC (T. RELD)
SHEET 8
SCA E 1:10
DATE 11.05,2006
CADWGWEBER BROS6476-31 DIA-TENT.DWG

JOB NUMBER 6476

Reproduction in part or whole is forbidden without written permission.

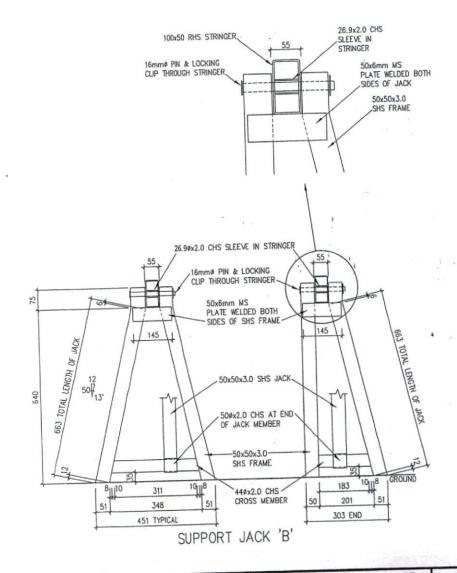

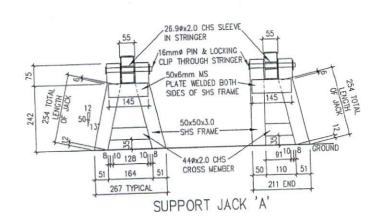

# location

SEATING AUDITORIUM 594 SEATING CAPACITY PRELIMINARY SUBJECT TO SEATING COMPLIANCE

# SEATING SYSTEMS

BY WEBERS CIRCUS P.O.Box 573 ORMEAU QLD. 4208 Ph: 0448 850 478


Em: weberscircus@yahoo.com.au Web: www.weberscircus.com


# SUPPORT JACKS


DRAWN BY OSMAN DESIGNPAC (T. FIELD)
SHEET 7
SCALE 1:10
DATE 11,05/2006
CADWGWEBER BROS\6476-31DIA-TENT.DWG

JOB NUMBER 6476

Document Set ID: 6419983

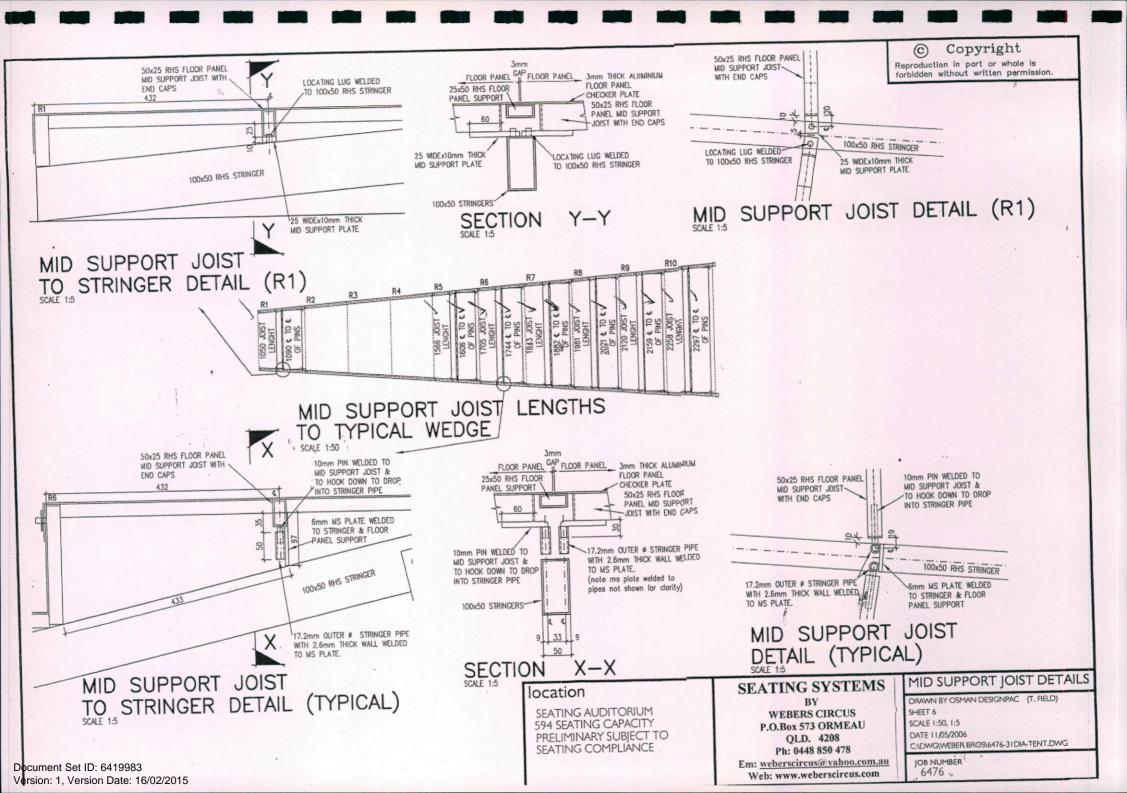

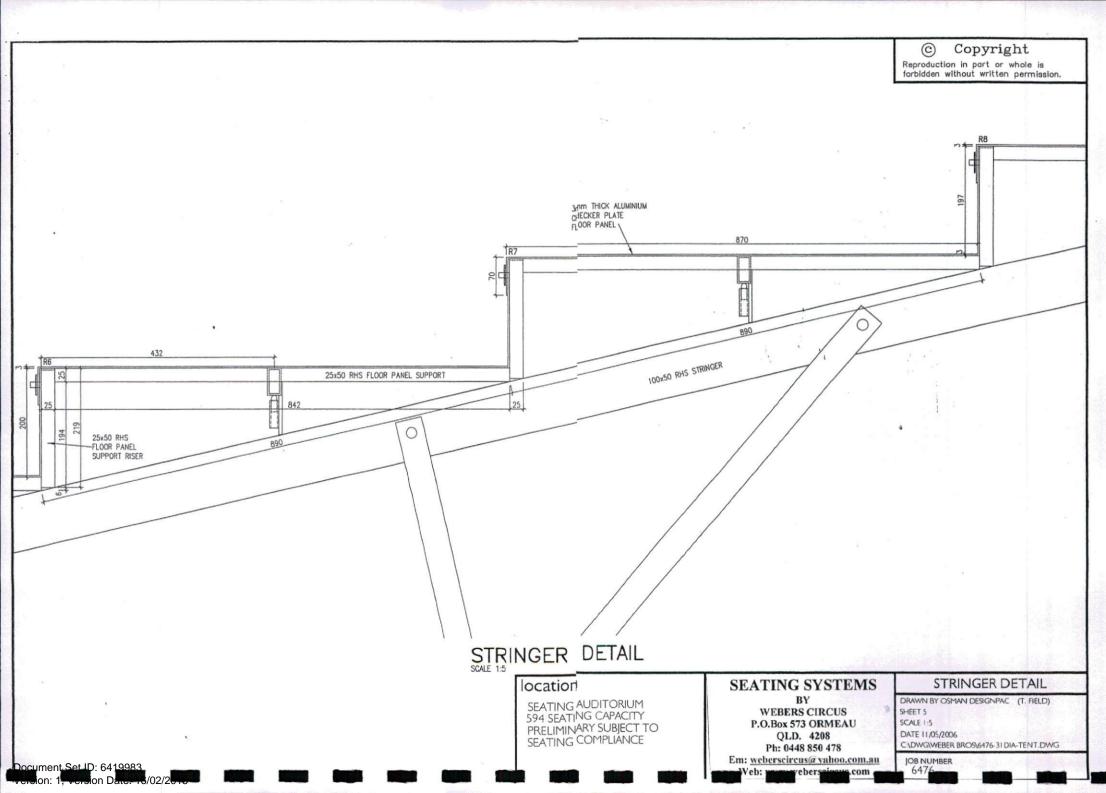

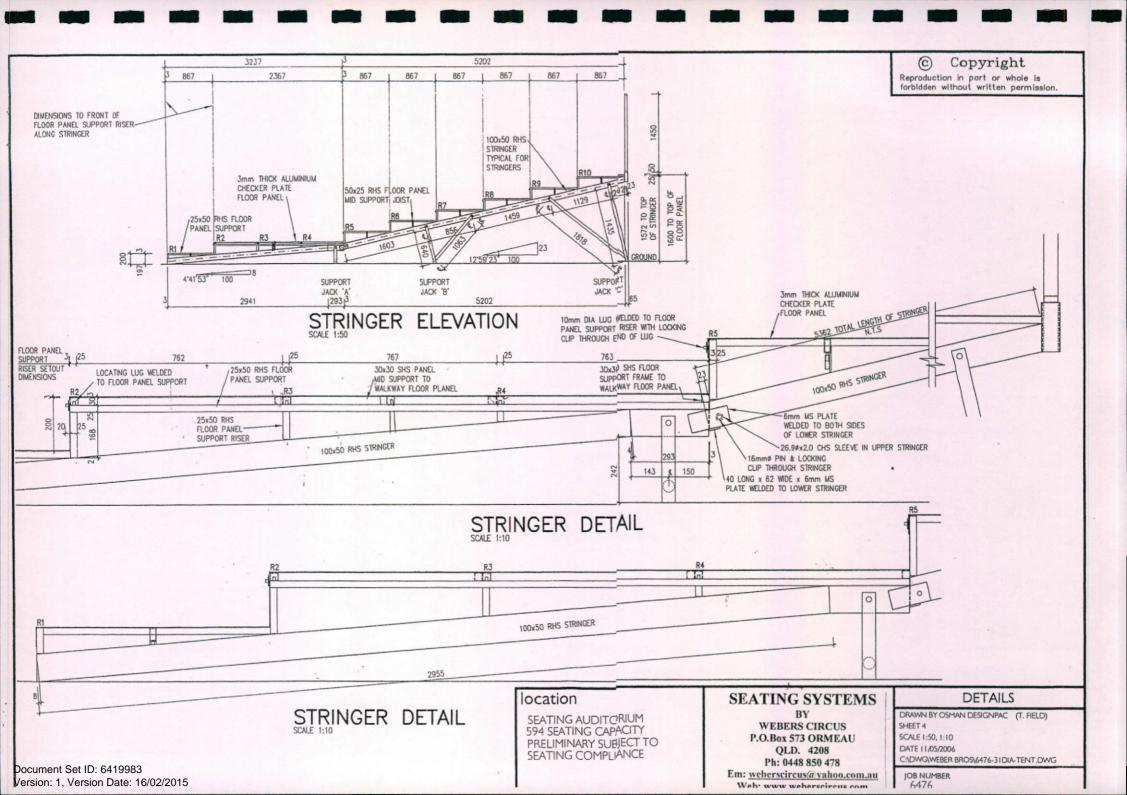


Copyright Reproduction in part or whole is forbidden without written permission. R9 867 3 25 S 3 25 8 8 R7 867 3 25 8 5 864 2401 LENGTH OF HANDRAIL PANEL 5188 R8 R6 R9 867 R8 867 3 25 25 25 R10 867 3 R4 787 3 25 5 R6 867 3 25 8 86 704 R5 TO R9 25 TYPICAL WEDGE FLOOR PANEL LAYOUT EXTENT OF FLAT FLOOR PANEL CHECKER PLATE LINE OF DOWN TURN UNDER 3mm CHECKER SEATING SYSTEMS location FLOOR PANEL LAYOUT PLATE AT FRONT EXTENT OF FLAT FLOOR OF FLOOR PANEL LINE OF UPSTAND PANEL CHECKER PLATE DRAWN BY OSMAN DESIGNPAC (T. FIELD) . -IN 3mm CHECKER SEATING AUDITORIUM WEBERS CIRCUS SHEET 3 PLATE AT BACK 594 SEATING CAPACITY P.O.Box 573 ORMEAU SCALE 1:50, 1:2 OF FLOOR PANEL DIMENSION TAKEN FROM PRELIMINARY SUBJECT TO QLD. 4208 DATE 11/05/2006 THIS POINT ON THIS SHEET DIMENSION TAKEN FROM SEATING COMPLIANCE THIS POINT ON THIS SHEET C:\DWG\WEBER BROS\6476-31DIA-TENT.DWG Ph: 0448 850 478 DIMENSION SET OUT DETAIL Documer# Ser D: 6479983 ANF Version: 4, Version Date: 16/02/2015 Em: weberscircus@yahoo.com.au JOB NUMBER Web: www.weberscircus.com 6476 -

Reproduction in part or whole is forbidden without written permission.

SETOUT DIMENSIONS ON THIS SHEET TO THE BOTTOM OF THE STRINGER ARE DIMENSIONED TO THE CENTRE POINT AT THE END OF THE STRINGER

SETOUT DIMENSIONS ON THIS SHEET TO THE TOP OF THE STRINGER ARE DIMENSIONED TO THE CENTRE POINT AT THE END OF THE STRINGERY

> \_\_ CENTRE LINE\_\_ OF STRINGER

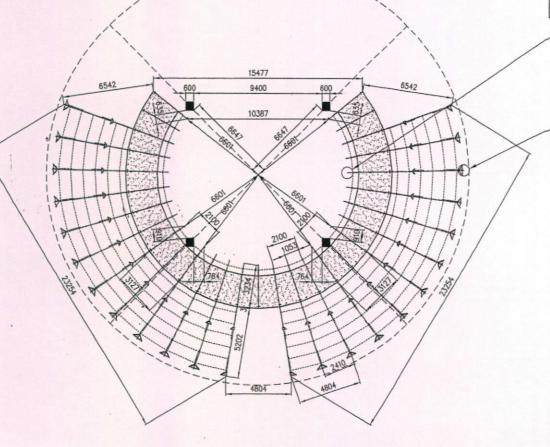

# location

SEATING AUDITORIUM 594 SEATING CAPACITY PRELIMINARY SUBJECT TO SEATING COMPLIANCE

# SEATING SYSTEMS

BY WEBERS CIRCUS P.O.Box 573 ORMEAU QLD. 4208 Ph: 0448 850 478

Em: weberscircus@yahoo.com.au

m.au

# STRINGER SETOUT PLAN


DRAWN BY OSMAN DESIGNPAC (T. FIELD) SHEET 2 SCALE 1:200 DATE 11,05/2006

C:\DWG\WEBER BROS\6476-31DIA-TENT.DWG

JOB NUMBER

Document Set ID: 6419983 Version: 1, Version Date: 15/02/2016

Reproduction in part or whole is forbidden without written permission.

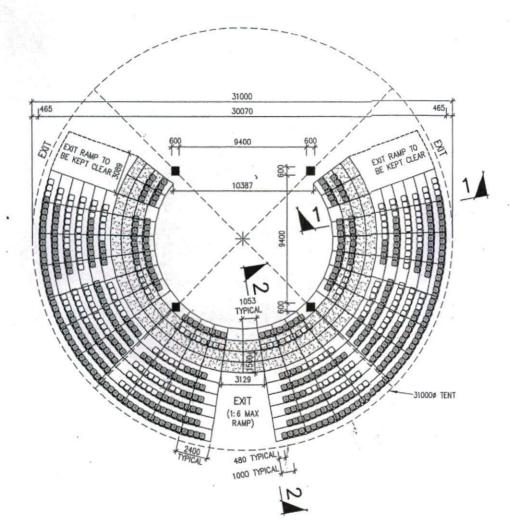

# SEATING LEGEND

SLIM'N'COMFY 1 SEAT 4 TOTAL = 4 seats
AUDITTO UNIT

SLIM'N'COMFY 3 SEAT 66 TOTAL = 198 seats
AUDITTO UNIT

SLIM'N'COMFY 4 SEAT 98 TOTAL = 392 seats
AUDITTO UNIT

TOTAL = 594 seats

## location

SEATING AUDITORIUM 594 SEATING CAPACITY PRELIMINARY SUBJECT TO SEATING COMPLIANCE

# SEATING SYSTEMS

BY WEBERS CIRCUS P.O.Box 573 ORMEAU QLD. 4208 Ph: 0448 850 478


Em: weberscircus(a)yahoo.com.au Web: www.weberscircus.com

# SEATING LAYOUT PLAN

DRAWN BY OSMAN DESIGNPAC (T. FIELD)
SHEET I
SCALE 1:200
DATE 11,05,/2006
C\(^1\)DWGWEBER BROS\(^476\)-3 I DIA TENT. DWG


JOB NUMBER 6476

Document Set ID: 6419983
Version: 1. Version Date: 16/02/2015

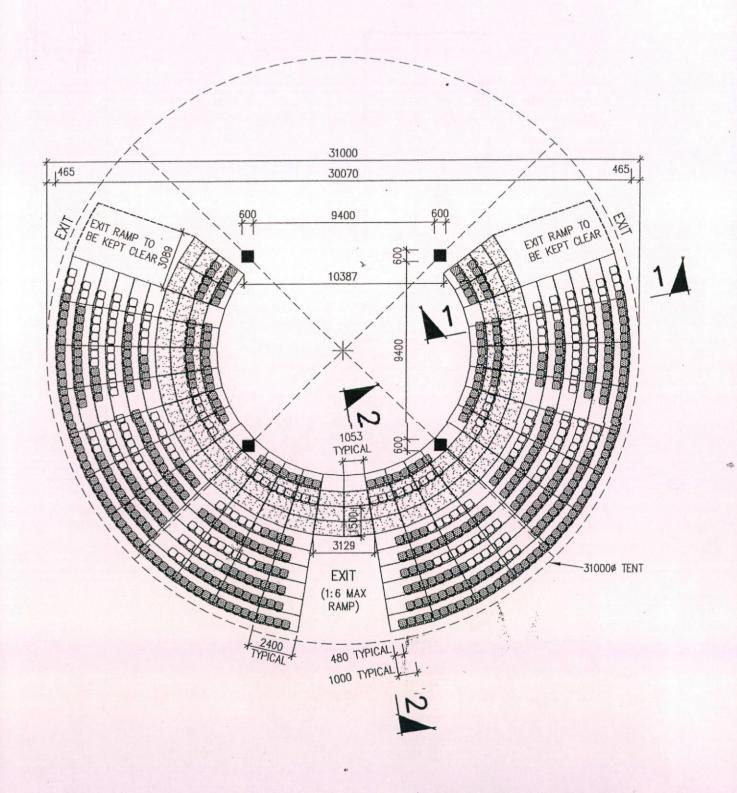

# location

SEATING AUDITORIUM 594 SEATING CAPACITY PRELIMINARY SUBJECT TO SEATING COMPLIANCE

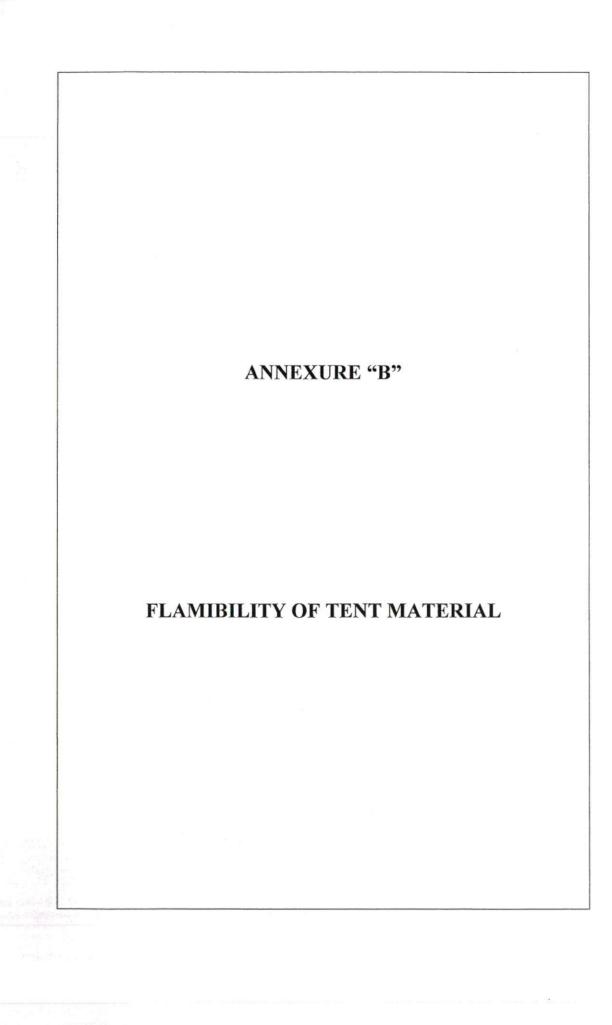

Document Set ID: 6419983 Yersion: 1, Version Date: 16/02/2015



# Occupation & fire safety certificate for Temporary Place of Public Entertainment

1. Details of the applicant

	Mr  Ms  Other	Mrs 🗌	Dr 🗌 Ms	3		
	First name		Surname			
	Natalie		Weber			
	Organisation					
		Webers	Circus			
	Flat/street no.	Street na	ame			
	84	Frank Str	reet			
	Suburb or town				State	Postcode
Mt [	Druitt				NSW	2770
	Daytime telephon	ie	Fax		Mobile	
041	2 850 478		None		0412 850 478	3
	Email					
	webercircus@yah	100.com.au				
2.	Certification of Es	ssential Se	rvices			
	The agent's owner, must complete and sign the certificate. Being the agent of the owner, certify that:  ———————————————————————————————————					
						apable of performing
	to					
		least the sta ilding;	andard required b	y the curre	ent fire safety s	chedule for the
	the information contained in this statement is true and accurate to the best of my knowledge and belief.					
	Signature					
	Name					
	Natalie Weber					
	Address					
	Same as above					
	The capacity in wh	nich you are	e signing if you are	e not the or	wner of the buil	ding
	For Weber Bros& Logisitcs					

Trevor R Howse & Associates Pty Ltd ABN 24 003 753 839
Suite 3, Level 1, 19 Harris Street, Pyrmont NSW 2009
Telephone +612 9518 6550 Facsimile +612 9518 6551 Email trh@trh.com.au www.trh.com.au
A member of Greencap Limited (ASX Code GCG)

Building Regulations Fire Safety Engineering Management Services

#### 3. Details of the land

	Flat/street no.	Street name			
		Swan Street			
	Suburb or town				Postcode
	JJ Kelly Park Woollo	ngong			2500
	If the land is Crown la	and:			
	Lease no.			Type of holding	
	*****	460000000000000000000000000000000000000			
4.	Description of the si	te being certif	ied		
	Owner of the building	J			
	First name		Last na	me	
	Description of premis	ses			
	<b>Woollongong Publi</b>	c Park			
	The nearest cross st	reet			
	Swan and Corrimal S	Street			

#### 5. Structural certification

Pursuant to the provisions of relevant Clauses of the B.C.A & Australian Standards, I certify:

1.\* that the structural drawings listed below will comply with the provisions of the Building Code of Australia, relevant Australian Standards referenced in the Building Code of Australia and the Council approved architectural plans.

This certificate is given and has relied upon the following provisions of the Building Code of Australia, Australian Standards or other relevant specifications, codes of practice or publications.

Reference to attached structural documentation/ certification

2.\* that the structural works have been inspected and, the works are structurally adequate and are deemed to comply with the structural drawings, certified and listed below.

\*Delete item 1 or 2, as applicable

Document Set ID: 6419983 Persion: 1, Version Date: 16/02/2015

# 6. Assessment of fire safety measures

List of each essential fire safety measure specified in the Fire Safety Schedule for the building.

Measure		Standard of performance required by the fire safety schedule	Applica ble Y / N	Date assessed	OK?
Aisle lighting		BCA H101.23.3 to 5	N		
Building emergency control plan and procedures		AS 3745:1995	N		
Emergency lighting		BCA E4.4, AS/NZS 2293.1:1998	N		
Emergency warning intercommunication systems	and	BCA E4.9, AS2220.1:1989, AS 2220.2:1989	N		
Exit signs		BCA E4.8 AS/NZS 2293.1:1998	Υ	20.04.08	OK
Exits not impeded		Environmental Planning and Assessment Regulation 2000	Υ	20.04.08	ОК
Exits operate freely		Environmental Planning and Assessment Regulation 2000	Y	20.04.08	ОК
Fire hydrant systems		BCA E1.3, AS 2419.1:1994	N		
Hose reel systems		BCA E1.4, AS 2441:1988	N		
Mechanical air handling systems		BCA F4.5, AS 1668.2:1991	N		
Mechanical smoke co including exhaust and make up air systems	d	BCA E2.2, AS/NZS 1668.1:1998	N		
Paths of travel to exit	s are	Environmental Planning and Assessment Regulation 2000	Υ	20.04.08	OK
Portable fire extinguis	shers	BCA E1.6, AS 2444:1995	Υ	20.04.08	OK
Safety curtains in proscenium openings		BCA Spec C1.10 (4d)	N		
Stage smoke & heat vents		BCA NSW Clause H101.22, AS 2665:1983	N		
Warning and operation signs	onal	BCA D2.23, E3.3, Environmental Planning and Assessment Regulation 2000, relevant Australian Standards	N		
COMMENTS / OBSERVATIONS	1				

Document Set ID: 6419983 Version: 1, Version Date: 16/02/2015

#### 7. Occupation statement

I Kate Howse for Trevor R Howse & Associates	Certifies that:	
Katcoff. Signed:	Dated: 20.04.08	
	Dated. 20.04.00	

- X the health and safety of the occupants of the building have been taken into consideration
- the building is suitable for occupation or use in accordance with its classification under the Building Code of Australia as a Building class
- X the above fire safety measures have been assessed for the building
- NA a report from the Commissioner of Fire Brigades has been considered.

Document Set ID: 6419983 ersion: 1, Version Date: 16/02/2015

INSPECTION COMMENTS / REQUIREMENTS	

# Approval

For & on behalf of CPMPT

Signature

Name

Document Set ID: 6419983 Version: 1, Version Date: 16/02/2015

# Fire Safety Statement

(Annual Fire Safety Statement)

under the Environmental Planning and Assessment Act 1979

Location:	Swansea
Location:	Swai

Address:

Webers Circus

Temporary Structure

This statement is for - part of building	the whole of the building (please tick)	$\checkmark$
Description of building or part of th		
Temporary Structure: Fabric Circus Te	ent Class 9b	
Subject to: Environmental Planning an	nd Assessment Regulation 2000	
Schedule 3A; Entertainmer	nt Venues and the Building Code of	

Inspection of Temporary Structure

Date the circus tent, was inspected in relation to fire safety notices, fire exits and paths of travel to fire exits.

Australia (2009) NSW Part H102 Temporary Structures

Date: Wednesday 24th February 2010

Measure	Standard of Performance	Date of Assessment
Fire Extinguishers	AS2444 and AS1851.1	24/02/2010
Fire Blanket	AS2444	24/02/2010
Exits	Building Code of Australia Clause Pt H102	24/02/2010
Exit Signs	AS2293	24/02/2010
Paths of Egress	Building Code of Australia BCA Pt H102	24/02/2010

I '	ody Weber
Of	Webers Circus
Rein	he owner of the building described above or the agent of the owner certify that

- Being the owner of the building described above, or the agent of the owner, certify that:
- Each essential fire safety measure listed above has been assessed by a properly qualified person; and
   Each essential fire safety measure was found, when it was assessed:
- Where an essential fire safety measure applies because it is specified in the fire safety schedule for the building, to be capable of performing to at least the standard set out in the schedule.
- A properly qualified person has inspected the building and found, when it was inspected, that no fire safety offences under the Environmental Planning and Assessment Regulation 2000 in relation to fire safety notices, fire exits and paths of travel to fire exits had been committed; and
   The information contained in this statement is true and accurate to the best of my knowledge and belief.

Signature Ruhl diver	
bwner -	Agent

Date of Statement: Wednesday 24th February 2010



Ray Manser. CEngFlFireE. MA(Fire Investigation) CSturt.

Grad.Dip Bushfire Prone Areas. (UWS) Consultant in:
Fire Investigation \* Post Fire Analysis \* Fire Safety Assessments \* BCA & Performance
Assessments.

Bushfire Safety Engineering and Assessments (79B & 100B) \* Alternative Solutions.

ABN: 27 105 734 608

# 6. FOYER SALES

Food and drinks are available to patrons at the Foyer marquee which is located immediately in front of the main auditorium.

Frozen pre packaged pies and sausage rolls are purchased on the day of the show and heated in pie warmers for sale.

Fairy floss is made on the day of the show and packed and sealed into fairy floss bags for sale.

Popcorn is made and sold at time of show.

Drinks and ice creams are pre purchased from Streets and Coca Cola and sold at time of show.


# 7. EMERGENCY DATA

# **EVACUATION PLAN**

In the event of a fire or situation requiring the evacuation of the tent the following procedures will be put in place.

- Chief Fire Warden will inform staff of fire or situation and its whereabouts.
- Exits will be manned as appointed to assist public to exit tent.
- Announcement from Sound Box will be made and Lighting Technician will advise foyer staff and office. (Who will contact emergency services if required)

EXITS: Back Door -- Scotty
Side Exit -- Paul
Side Exit -- Kevin
Ring Doors -- Hewin & Yean Paul
Front Door -- Tim

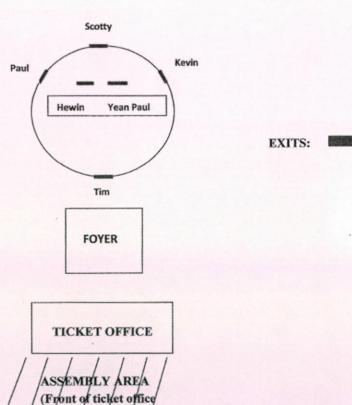

Document Set ID: 6419983 Version: 1, Version Date: 16/02/2015

# 8. INSURANCE