MT VERNON RESIDENCE

264 Mount Vernon Road, Mount Vernon NSW 2759



DRAWING No. DESCRIPTION **SCALE** Title Page Site & Site Analysis Plan 1:500, 1:1000 DA102 1:100, 1:5000 Ground Floor Plan Level 01 Plan 1:5000, 1:100 1:5000, 1:100 Roof Plan Basement Plan 1:5000, 1:100 Tennis Pavillion and Staff Quarters Plan 1:5000, 1:100 1:100 East & West Elevations 1:100 1:100 Sections DA111 Development Data 1:500 Schedule of Finishes & 3D Views DA113 Shadow Diagram: 9:00am June 21 DA114 Shadow Diagram: 12:00pm June 21 Shadow Diagram: 3:00pm June 21 1:200 1:1000 Notification - Site Plan Notification - Elevations 1:500

SCHEDULE OF BASIX COMMITMENTS

Refer to relevant BASIX certificate for greater detail.

WATER COMMITMENTS

The applicant must plant indigenous or low water use species of vegetation throughout the area of land specified for the dwelling in the "Indigenous species" column of the table below, as private landscaping for that dwelling. (This area of indigenous vegetation is to be contained within the "Area of garden and lawn" for the dwelling specified in the "Description of Project" table).

| Common area landscape | |
|--|-------|
| Common area lawn (m²) | 200.0 |
| Common area garden (m²) | 100.0 |
| Area of indigenous or low water use species (m²) | 0.0 |

The applicant must not install a private swimming pool or spa for the dwelling, with a volume exceeding that specified for it in the

The pool or spa must be located as specified in the table.

| | | viduai pooi | | marriadar spa | | | |
|---------------------|---------------------------|---------------|------------------|----------------|---------------------------|--------------|---------------|
| Dwelling no. | Volume (max volume) | Pool cover | Pool location | Pool shaded | Volume (max volume) | Spa cover | Spa shaded |
| Sec | - | - | - | - | - | - | - |
| All other dwellings | 120.0 | yes | indoors | no | - | - | - |

The applicant must install, for the dwelling, each alternative water supply system, with the specified size, listed for that dwelling in the table below. Each system must be configured to collect run-off from the areas specified (excluding any area which supplies any other alternative water supply system), and to divert overflow as specified. Each system must be connected as specified.

| | | Alternative water source | | | | | | | | |
|---------------|----------------------------------|--------------------------|---------------------|-------------------------|-----------------------|-----------------------|----------------|------------|--|--|
| Dwelling no. | Alternative water supply systems | Size | Configuration | Landscape connection | Toilet connection (s) | Laundry connection | Pool top-up | Spa top-up | | |
| All dwellings | central water tank (no. 1) | See central systems | See central systems | no | yes | yes | no | no | | |
| None | - | - | - | - | - | - | - | - | | |

ENERGY COMMITMENTS

The applicant must install each hot water system specified for the dwelling in the table below, so that the dwelling's hot water is supplied by that system. If the table specifies a central hot water system for the dwelling, then the applicant must connect that central system to the dwelling, so that the dwelling's hot water is supplied by that central system.

| | Hot water | Bathroom ventilation system | | Kitchen venti | lation system | Laundry ventilation system | | |
|------------------|---|-------------------------------|----------------------|-------------------------------|----------------------|-------------------------------|----------------------|--|
| Dwelling no. | Hot water system | Each bathroom | Operation control | Each kitchen | Operation control | Each laundry | Operation control | |
| All dwellings | solar (gas boosted, flat plate) 26 to 30 STCs | individual fan, not ducted | manual switch on/off | individual fan, not ducted | manual switch on/off | individual fan, not ducted | manual switch on/off | |

This commitment applies to each room or area of the dwelling which is referred to in a heading to the "Natural lighting" column of the table below (but only to the extent specified for that room or area). The applicant must ensure that each such room or area is fitted with a window and/or skylight.

| | Cooling Heating | | | | | | Artificial | lighting | | | Natural lig | hting |
|---------------------------|--|--|--|--|----------------------------------|--|--------------------|------------------------------|--------------------|--------------------|--|-----------------|
| Dwelling no. | living areas | bedroom areas | living areas | bedroom areas | No. of bedrooms &/or study | No. of living &/or dining rooms | Each kitchen | All bathrooms/ toilets | Each laundry | All hallways | No. of bathrooms &/or toilets | Main kitchen |
| Sec | 3-phase airconditioning EER > 4.0 (zoned) | 3-phase airconditioning EER > 4.0 (zoned) | 3-phase airconditioning EER > 4.0 (zoned) | 3-phase airconditioning EER > 4.0 (zoned) | 2 (dedicated) | 1 | yes (dedicated) | yes (dedicated) | yes (dedicated) | yes (dedicated) | 0 | no |
| All other dwellings | 3-phase airconditioning EER > 4.0 (zoned) | 3-phase airconditioning EER > 4.0 (zoned) | 3-phase airconditioning EER > 4.0 (zoned) | 3-phase airconditioning EER > 4.0 (zoned) | 5 (dedicated) | 6 (dedicated) | yes (dedicated) | yes (dedicated) | yes (dedicated) | yes (dedicated) | 4 | no |

| | Individual p | ool | Individual s | ра | Appliances & other efficiency measures | | | | | | | |
|---------------------|------------------------|-------|-----------------------|-------|--|--------------|---------------------------------------|------------|-------------------|------------------|--|--|
| Dwelling no. | Pool heating system | Timer | Spa heating system | Timer | Kitchen cooktop/oven | Refrigerator | Well ventilated fridge space | Dishwasher | Clothes washer | Clothes dryer | Indoor or sheltered clothes drying line | Private outdoor or unsheltered clothes drying line |
| Sec | - | - | - | - | gas cooktop & electric oven | - | yes | - | - | - | yes | yes |
| All other dwellings | solar (gas boosted) | no | - | - | gas cooktop & electric oven | - | yes | - | - | - | yes | yes |

The applicant must install the photovoltaic system specified for the dwelling under the "Photovoltaic system" heading of the "Alternative energy" column of the table below, and connect the system to that dwelling's electrical system.

| · ···································· | |
|--|--|
| | Alternative energy |
| Dwelling no. | Photovoltaic system (min rated electrical output in peak kW) |
| Sec | 0.0 |
| All other dwellings | 10.0 |



THERMAL COMFORT COMMITMENTS

The applicant must show on the plans accompanying the development application for the proposed development, all matters which the Thermal Comfort Protocol requires to be shown on those plans. Those plans must bear a stamp of endorsement from the Accredited Assessor, to certify that this is the case.

Where there is an in-slab heating or cooling system, the applicant must:

(aa) Install insulation with an R-value of not less than 1.0 around the vertical edges of the perimeter of the slab; or

(bb) On a suspended floor, install insulation with an R-value of not less than 1.0 underneath the slab and around the vertical

| | Therma | al loads |
|---------------------|--|--|
| Dwelling no. | Area adjusted heating load (in mJ/m²/yr) | Area adjusted cooling load (in mJ/m²/yr) |
| Sec | 27.2 | 25.3 |
| All other dwellings | 53.7 | 55.6 |
| | | |

The applicant must construct the floors and walls of the development in accordance with the specifications listed in the table

| subfloor (m²) endclosed subfloor (m²) garage (m²) mudbrick walls ec - - 91 - No lother 661 314 - - No | | | | Construction of floors and walls | | |
|---|-------------|-----------------------------|-----|----------------------------------|---|----|
| l other 661 314 No | welling no. | Concrete slab on ground(m²) | | | | |
| l other vellings 661 314 No | ec | - | - | 91 | - | No |
| | | 661 | 314 | - | - | No |

COMMITMENTS FOR COMMON AREAS AND CENTRAL SYSTEMS/FACILITIES FOR THE DEVELOPMENT (NON-**BUILDING SPECIFIC)**

Common areas and central systems/facilities

The applicant must install (or ensure that the development is serviced by) the alternative water supply system(s) specified in the "Central systems" column of the table below. In each case, the system must be sized, be configured, and be connected, as

A swimming pool or spa listed in the table must not have a volume (in kLs) greater than that specified for the pool or spa in the

| Central systems | Size | Configuration | Connection (to allow for) |
|--|--------|---|---|
| Central water tank - rainwater or stormwater (No. 1) | 4000.0 | To collect run-off from at least: - 500.0 square metres of roof area of buildings in the development - 0.0 square metres of impervious area in the development - 0.0 square metres of garden/lawn area in the development - 0.0 square metres of planter box area in the development (excluding, in each case, any area which drains to, or supplies, any other alternative water supply system). | - irrigation of 100.0 square metres of common landscaped area on the site - car washing in 0 car washing bays on the site |
| Reticulated alternative water supply | - | Installation of plumbing to make provision for connection to Hoxton Park (proposed) reticulated alternative water supply. | - irrigation of 200.0 square metres of common landscaped area on the site - car washing in 0 car washing bays on the site |

Common areas and central systems/facilities

The applicant must install the systems and fixtures specified in the "Central energy systems" column of the table below. In each case, the system or fixture must be of the type, and meet the specifications, listed for it in the table.

GLAZING COMMITMENTS:



PO Box 334 Surry Hills NSW 2010 T 02 9955 5604 E info@popovbass.com.au W popovbass.com.au

NOTES:

- ALL LEVELS TO AHD.

REFER TO SURVEY FOR INFORMATION RELATING TO EXISTING SITE

THE BATHLA GROUP

MT VERNON RESIDENCE

264 Mount Vernon Road, Mount Vernon NSW 2759

DEVELOPMENT APPLICATION


Title Page

Drawing No. 0593-DA100


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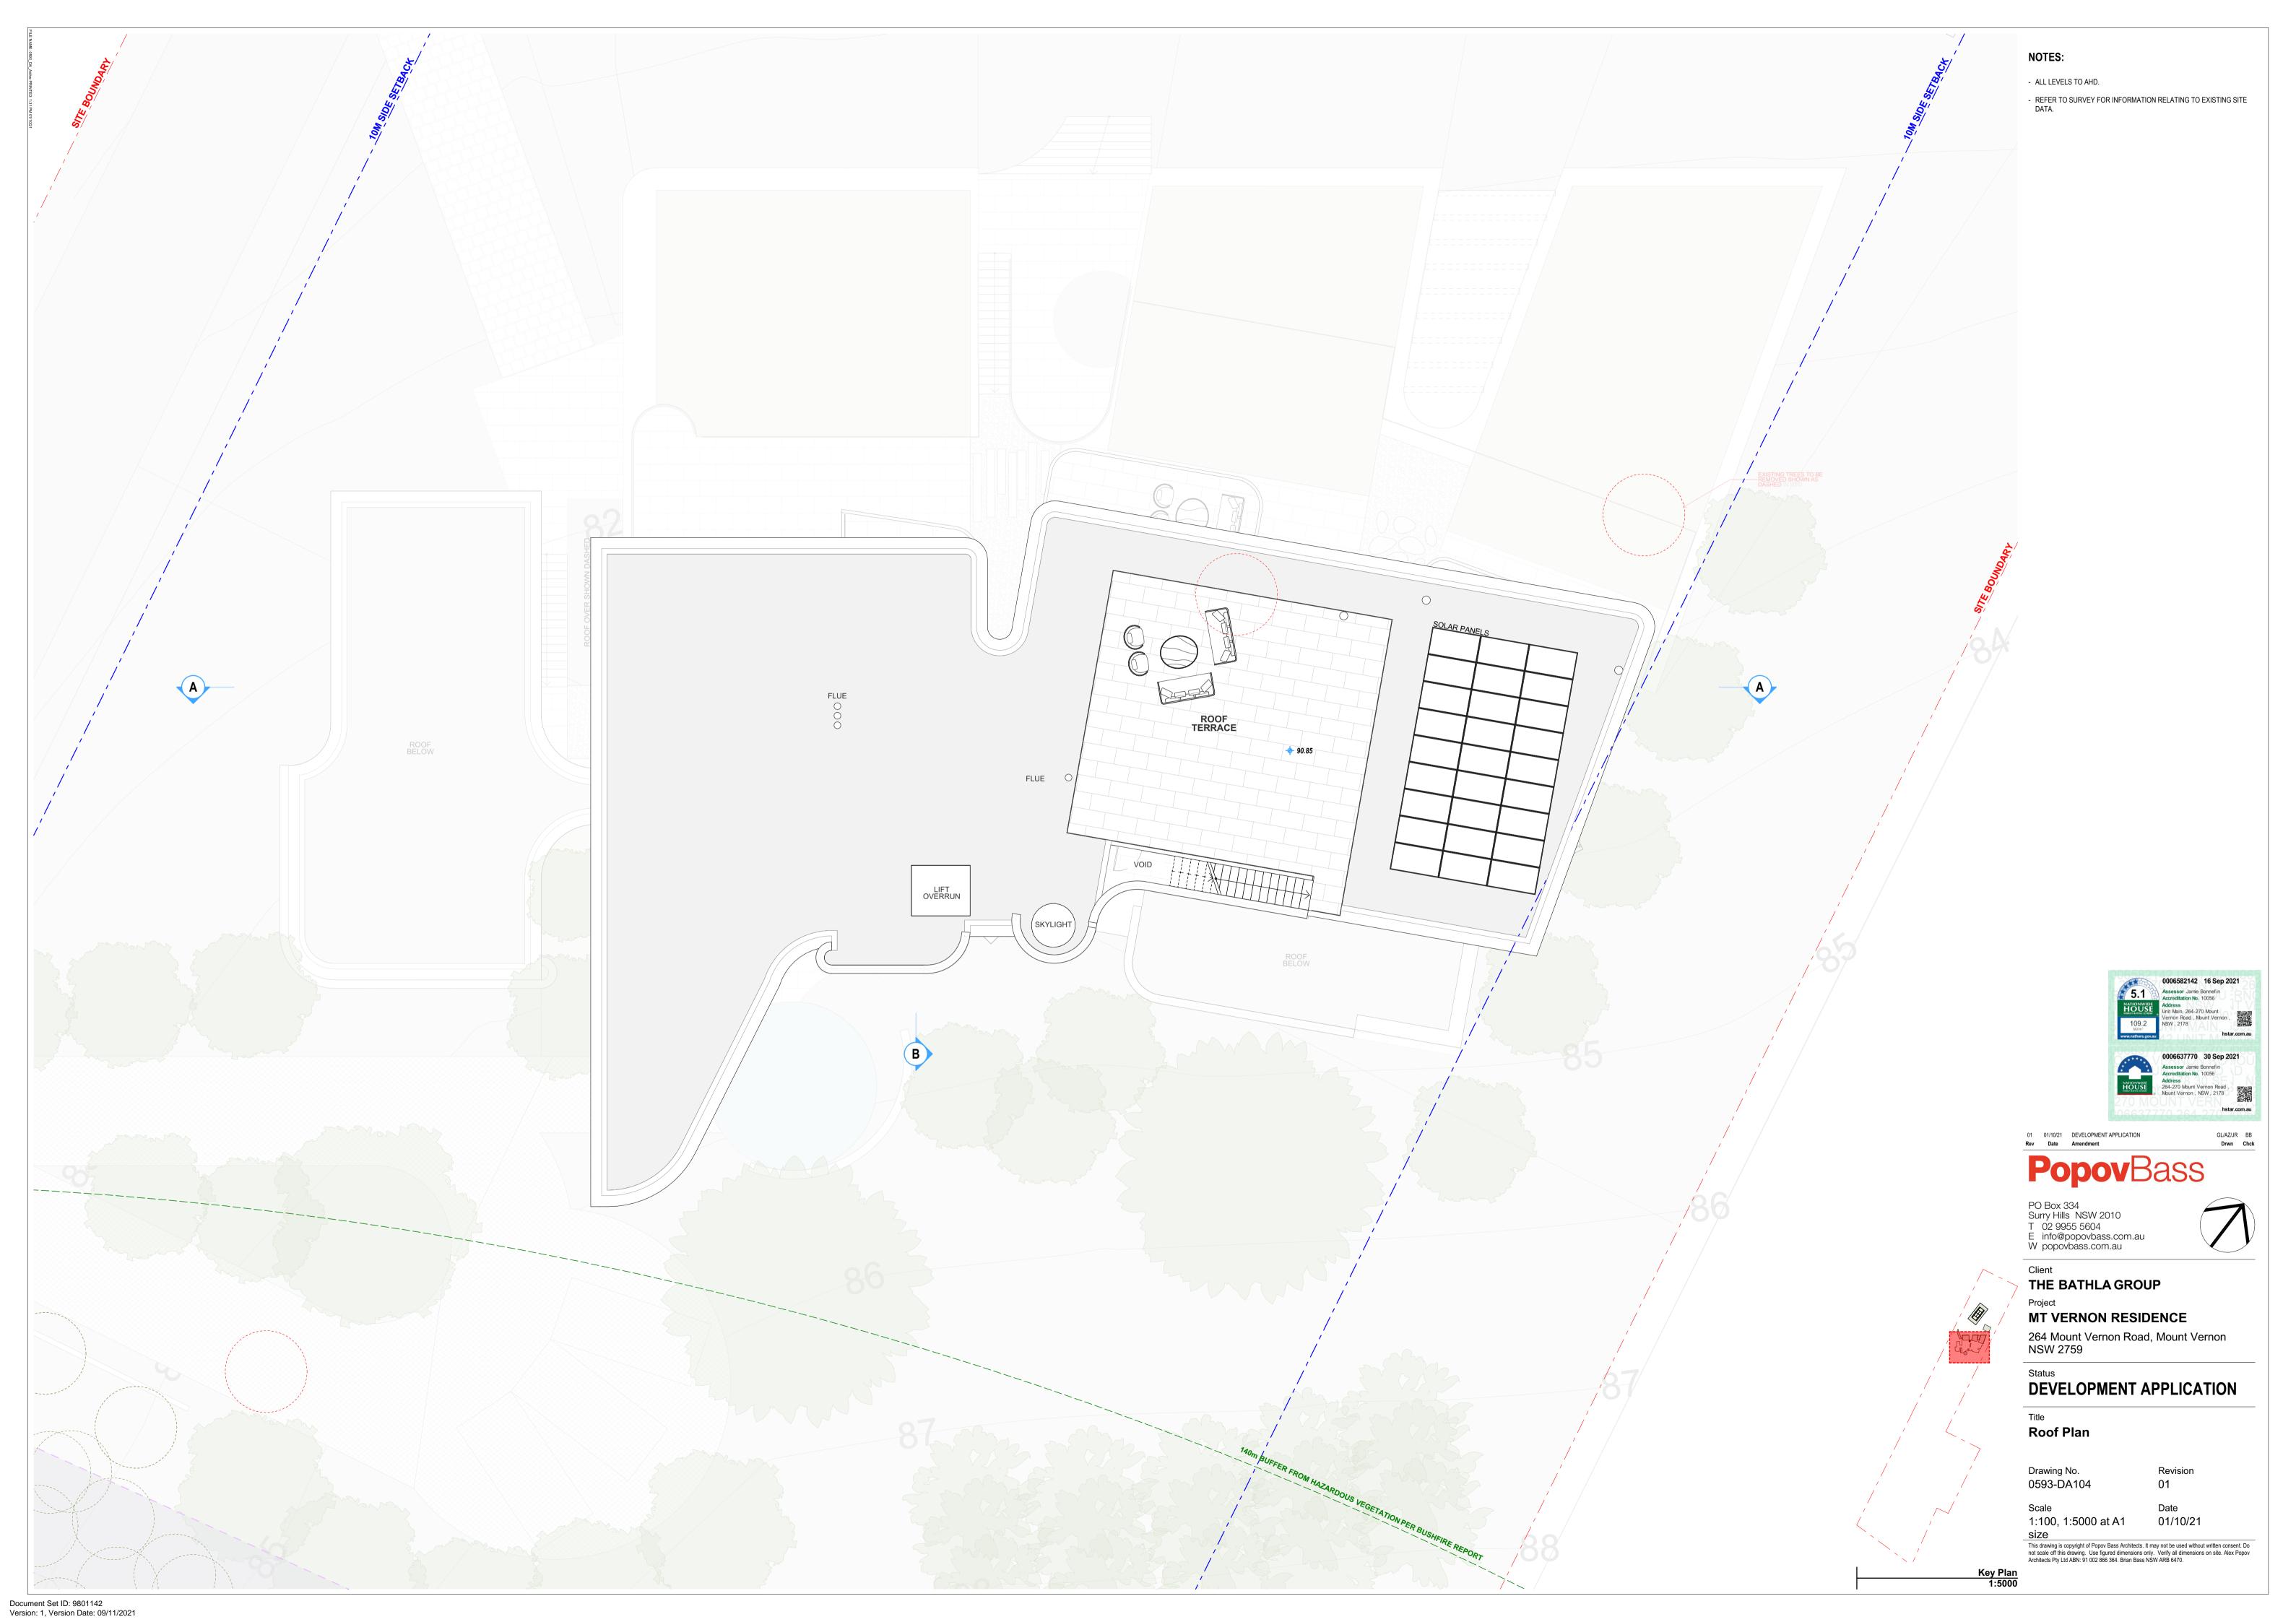
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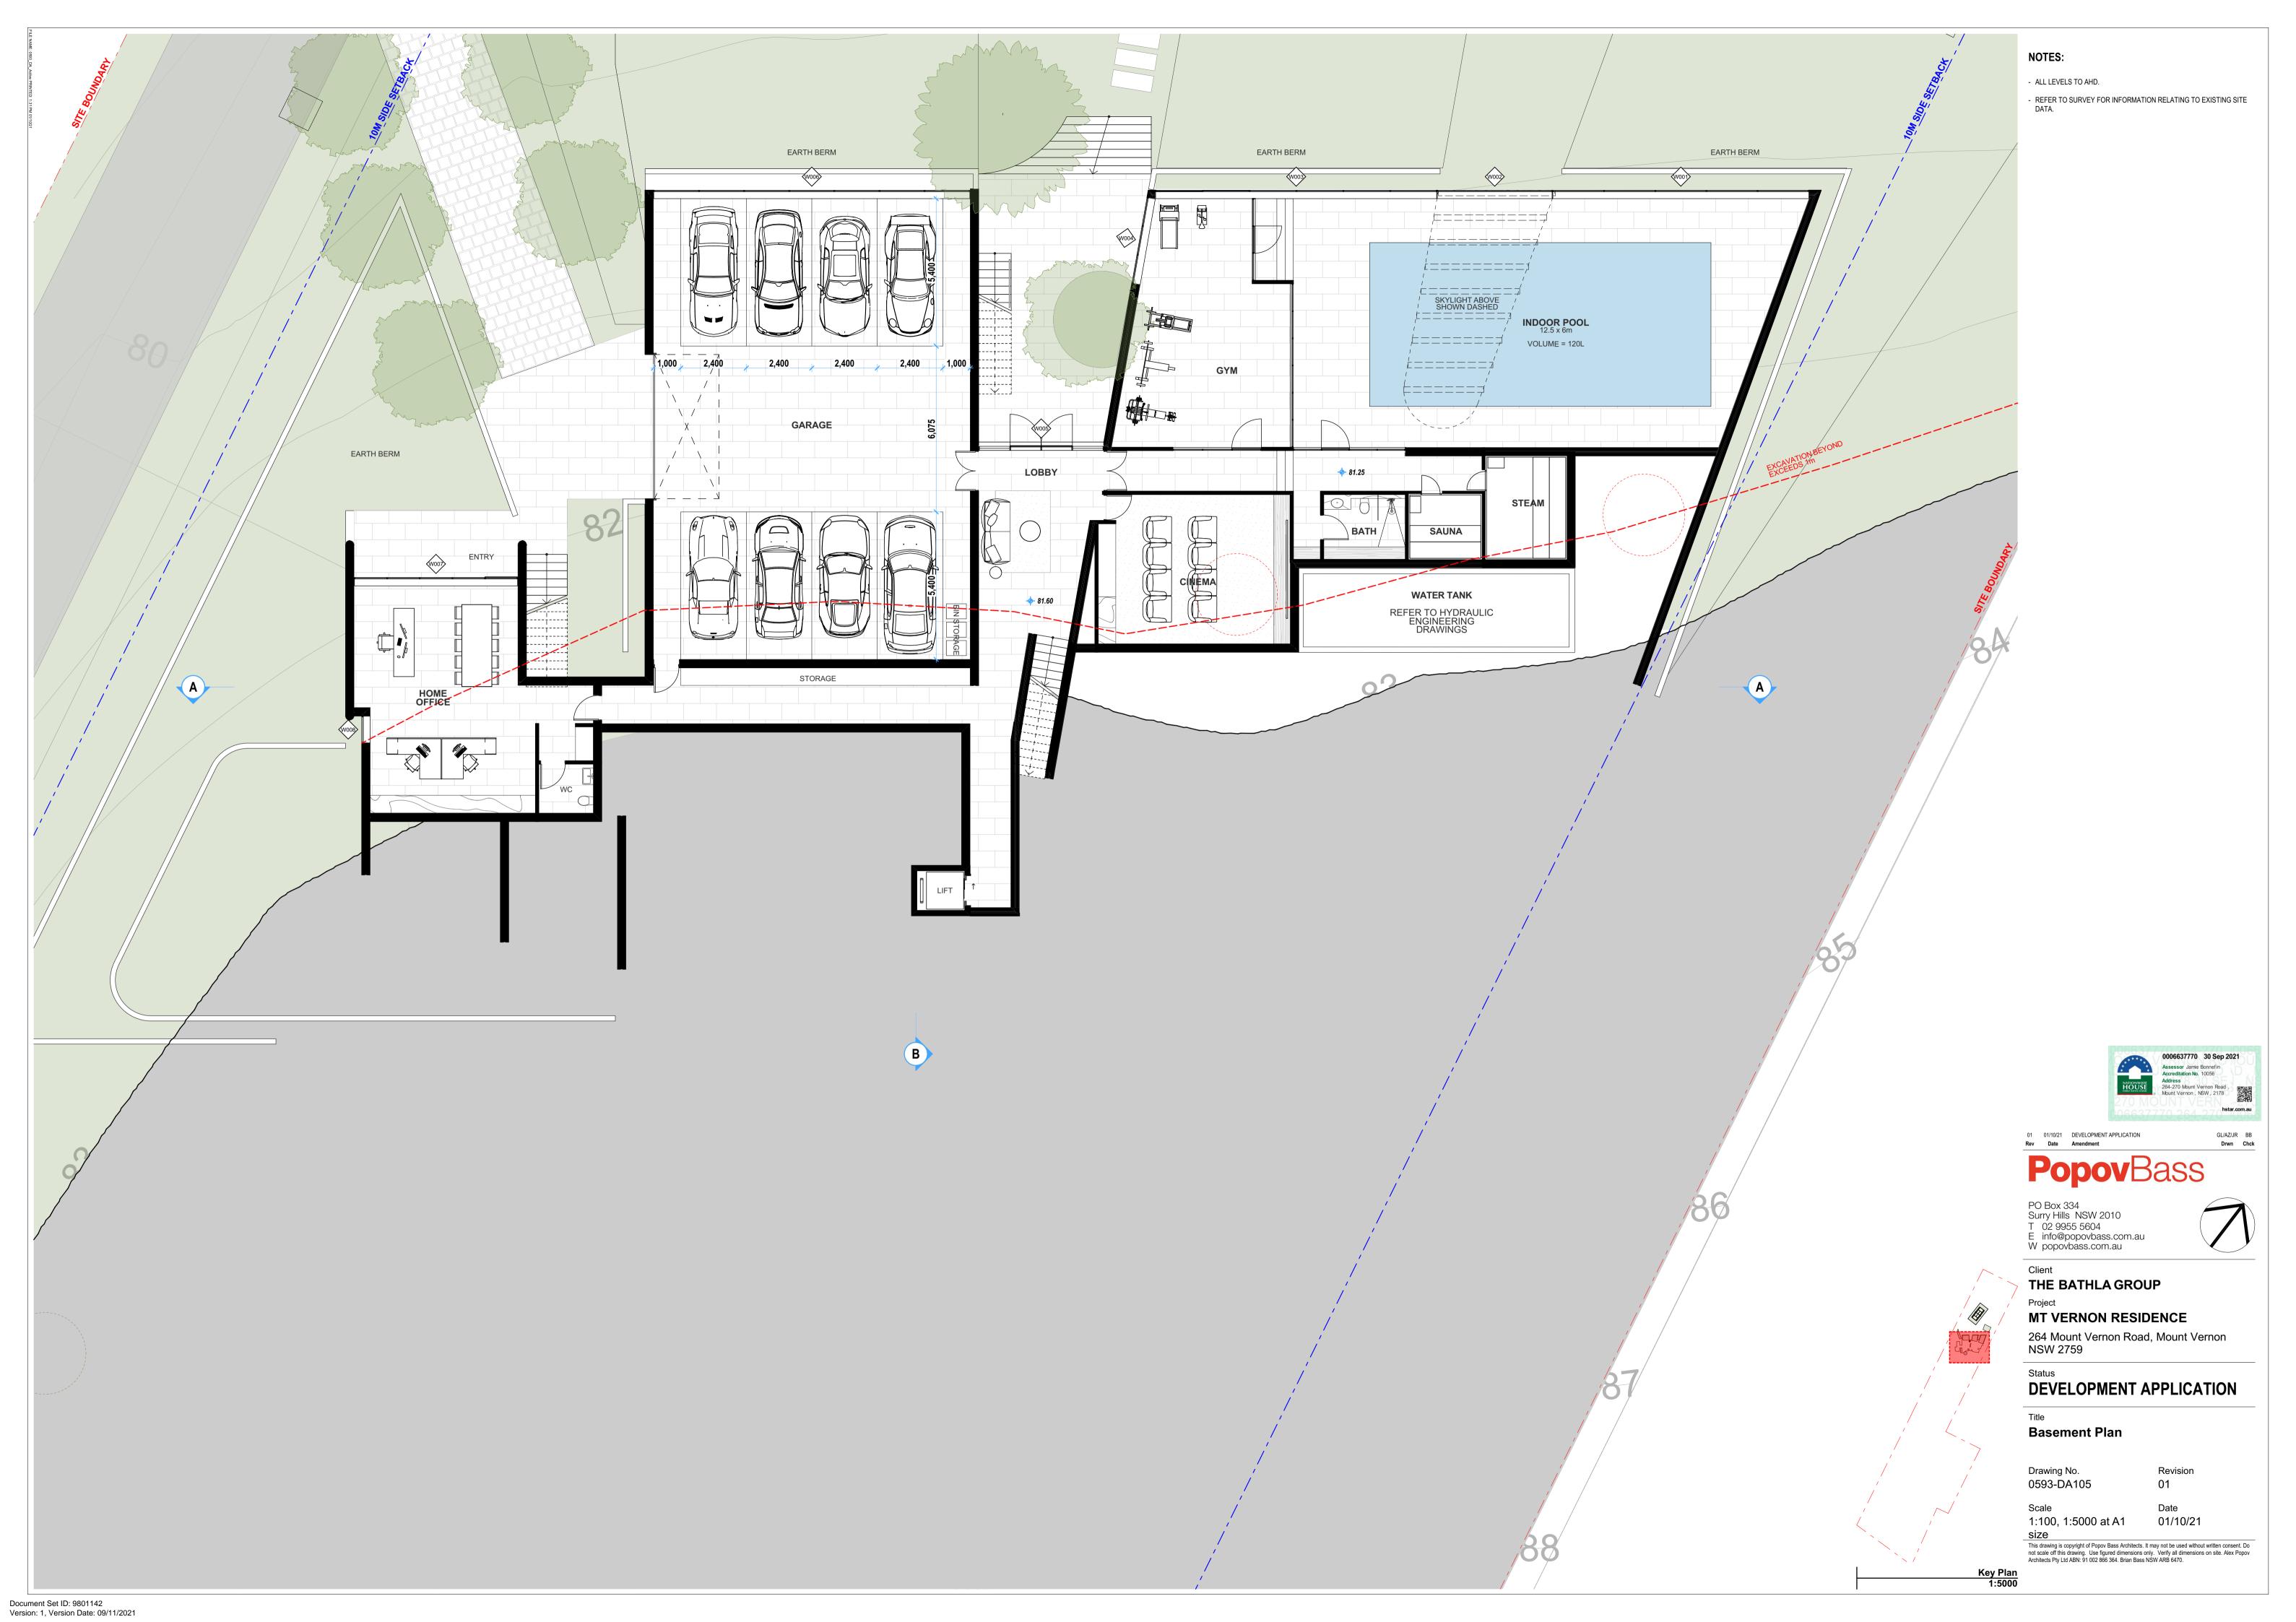
Revision





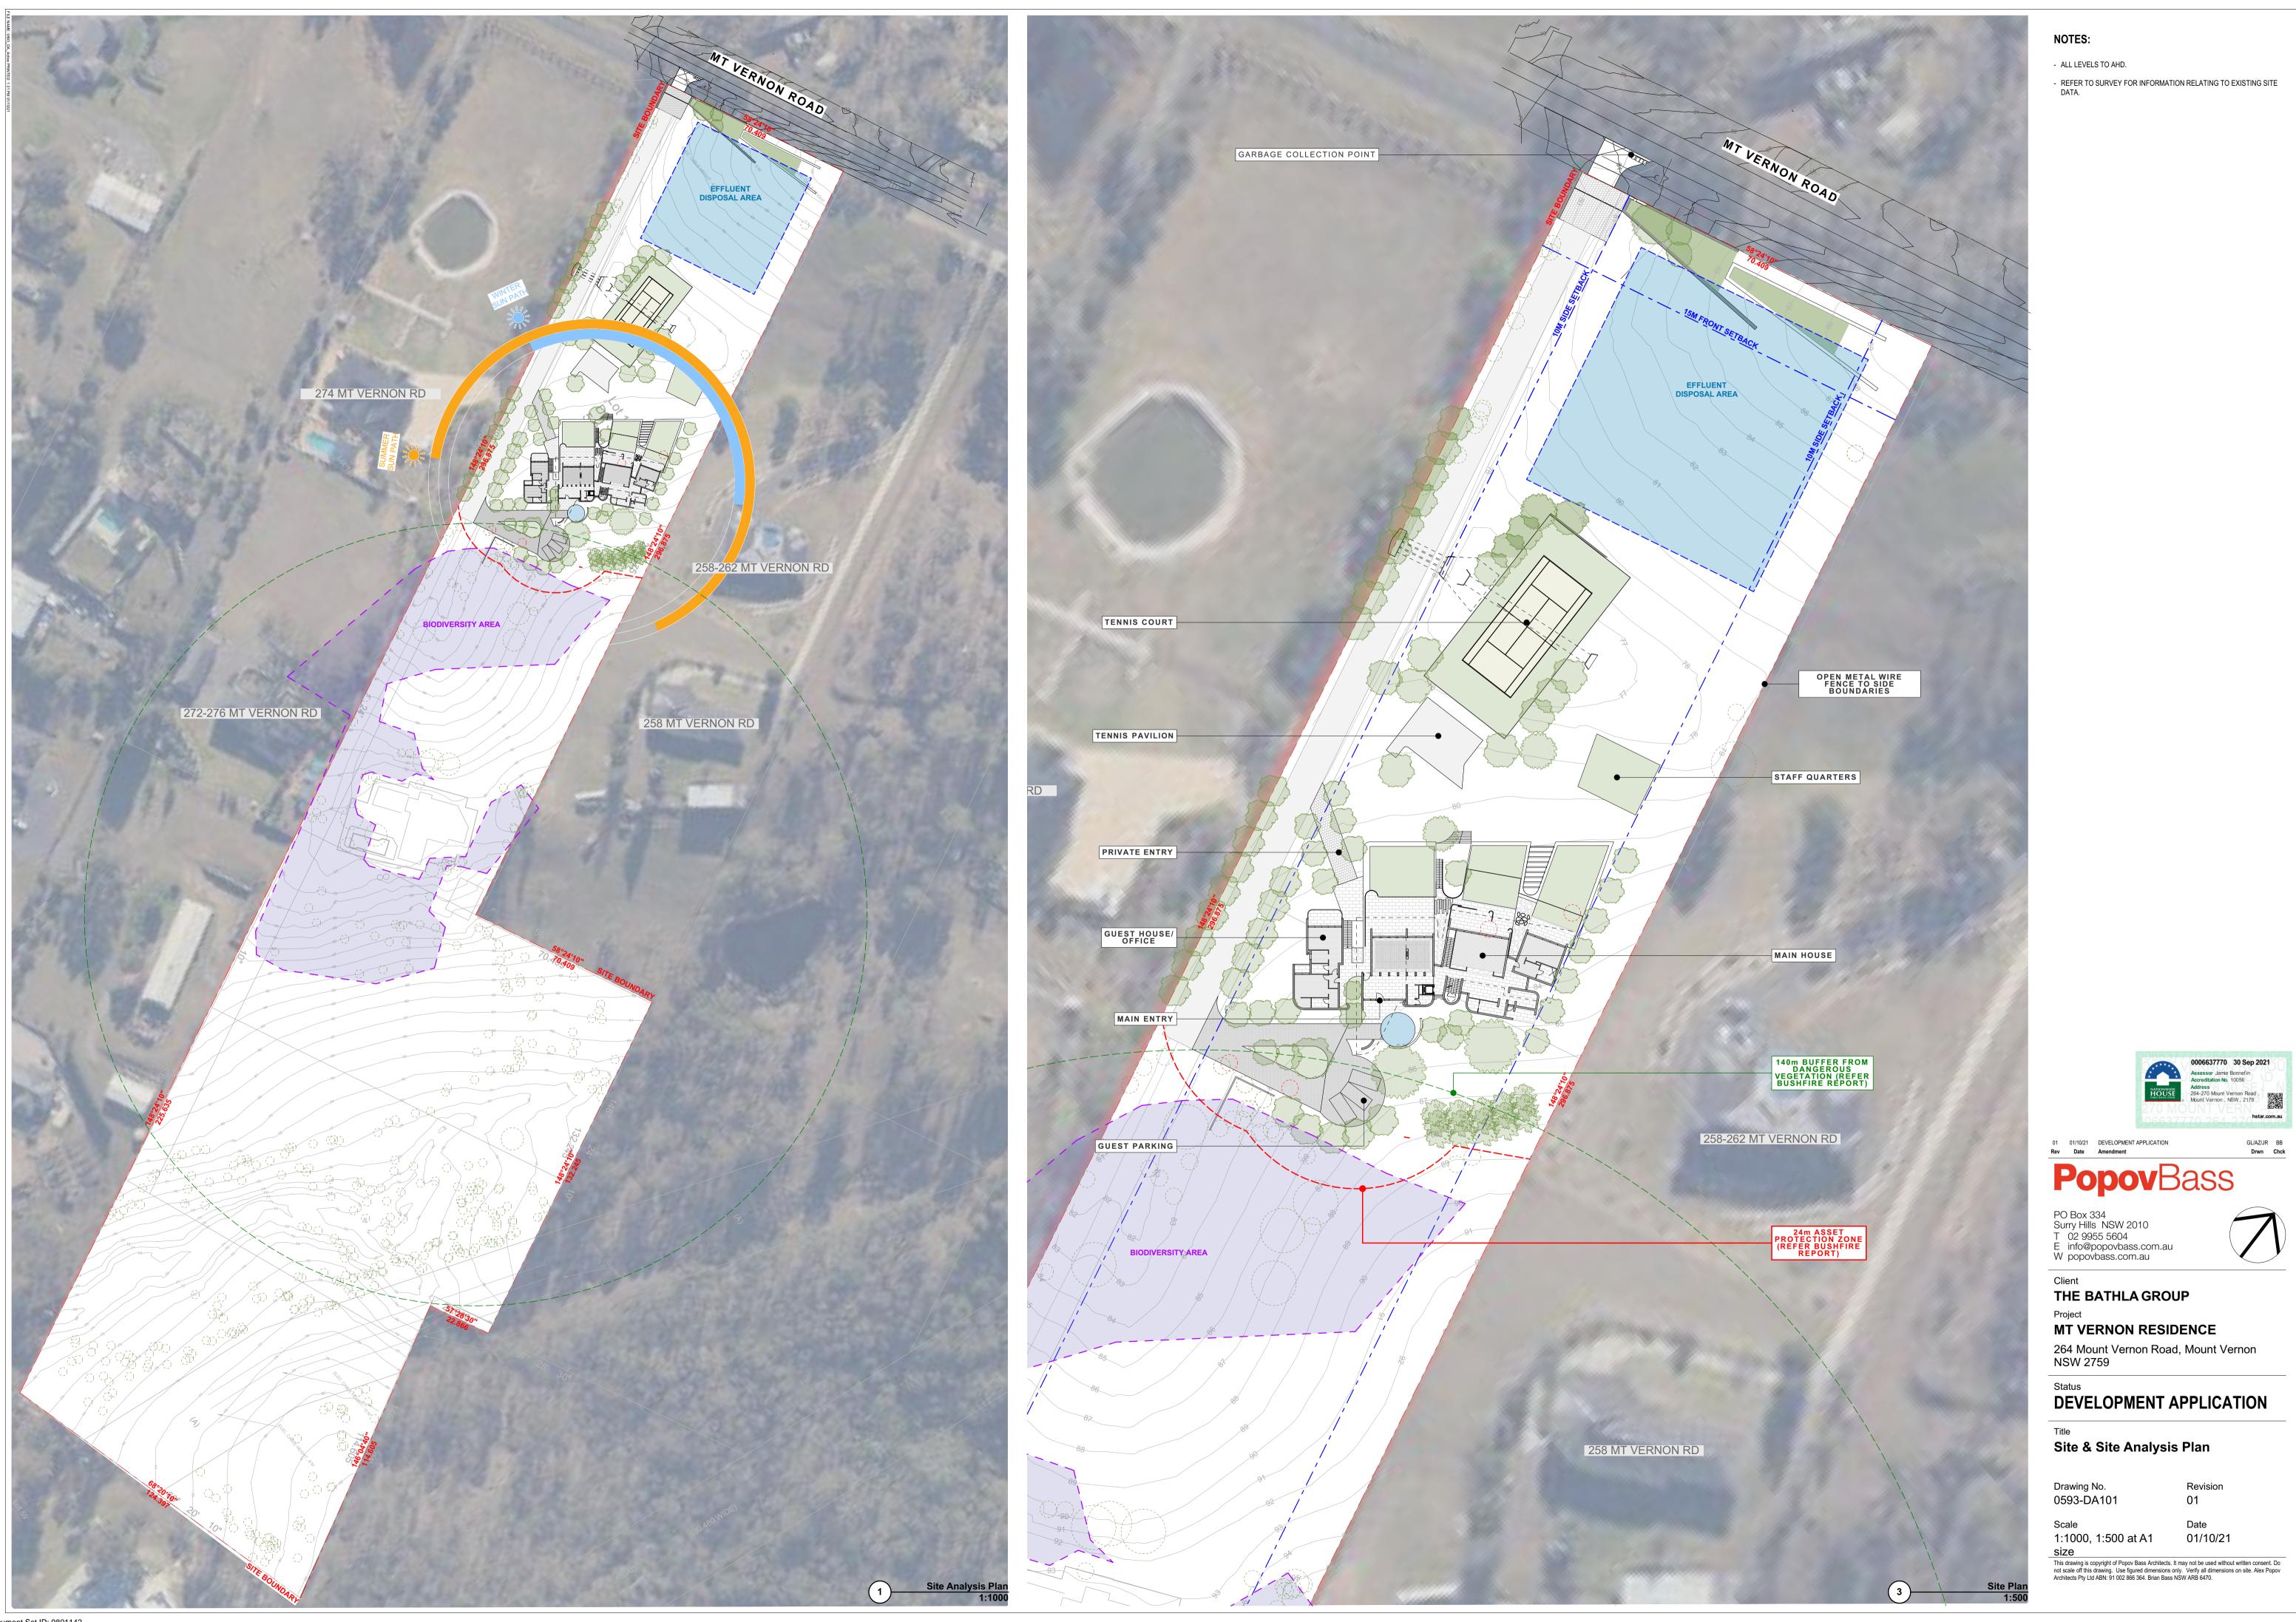



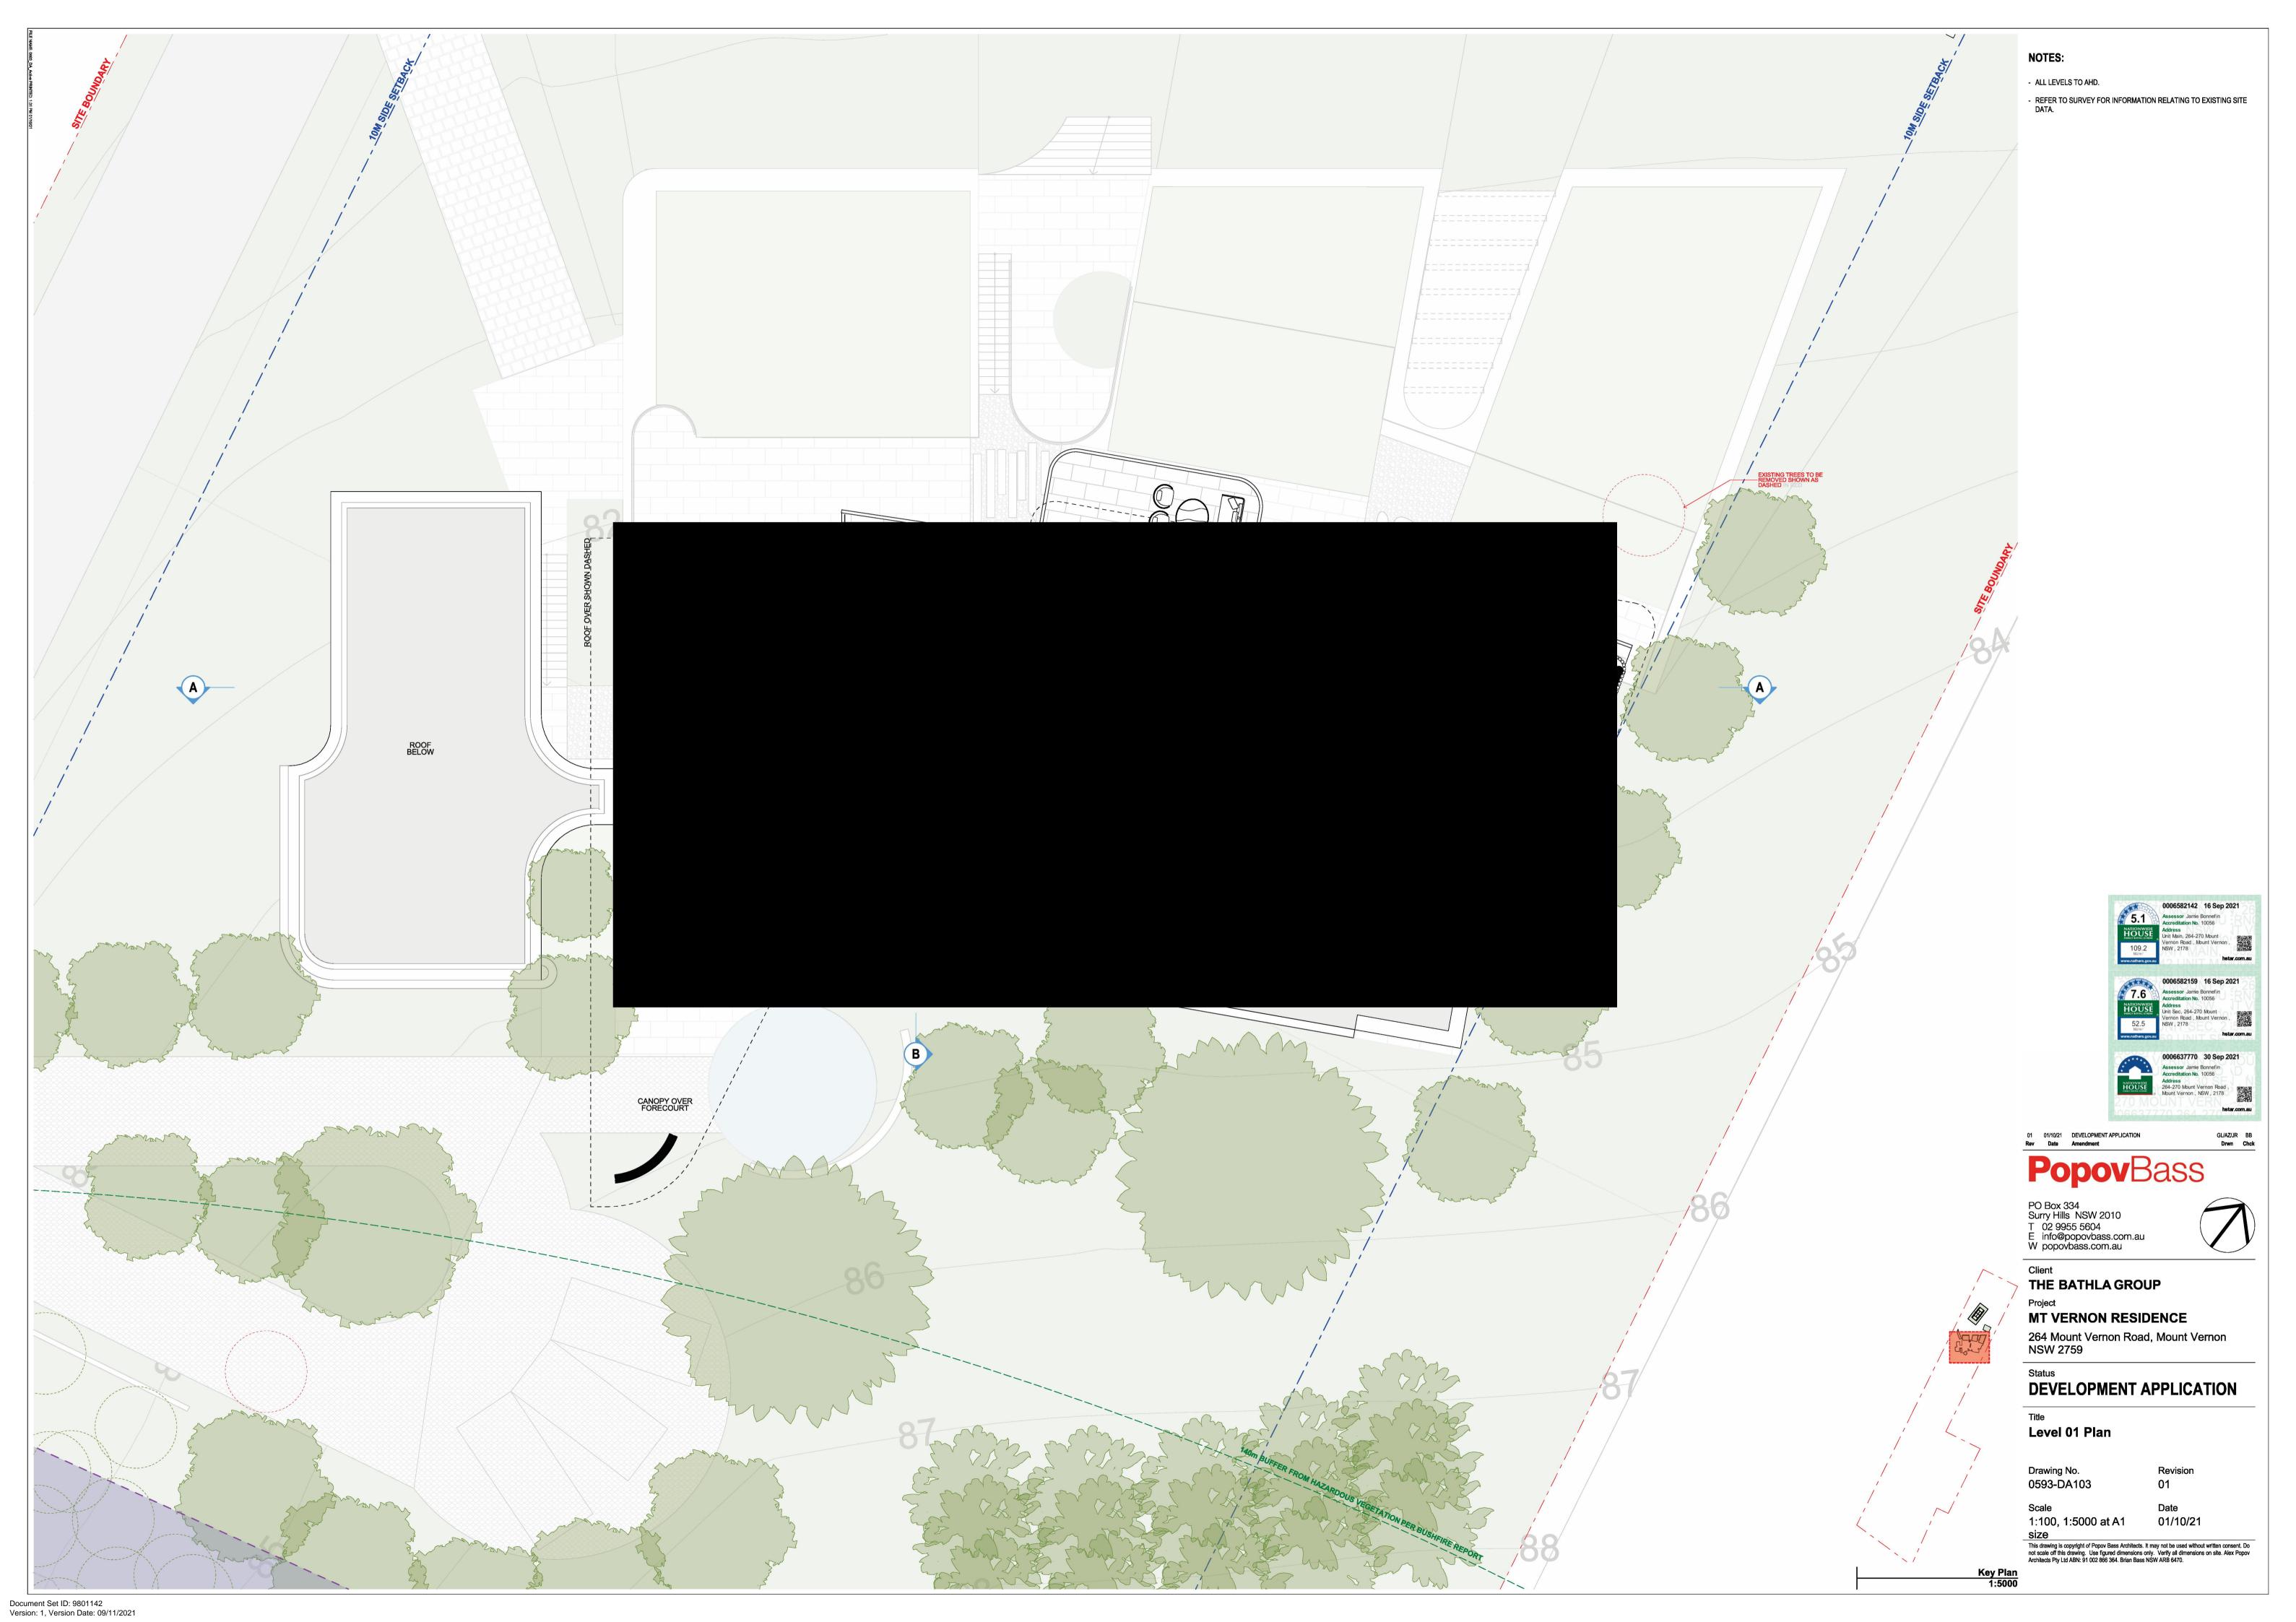







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NOTES:

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THE BATHLA GROUP

MT VERNON RESIDENCE

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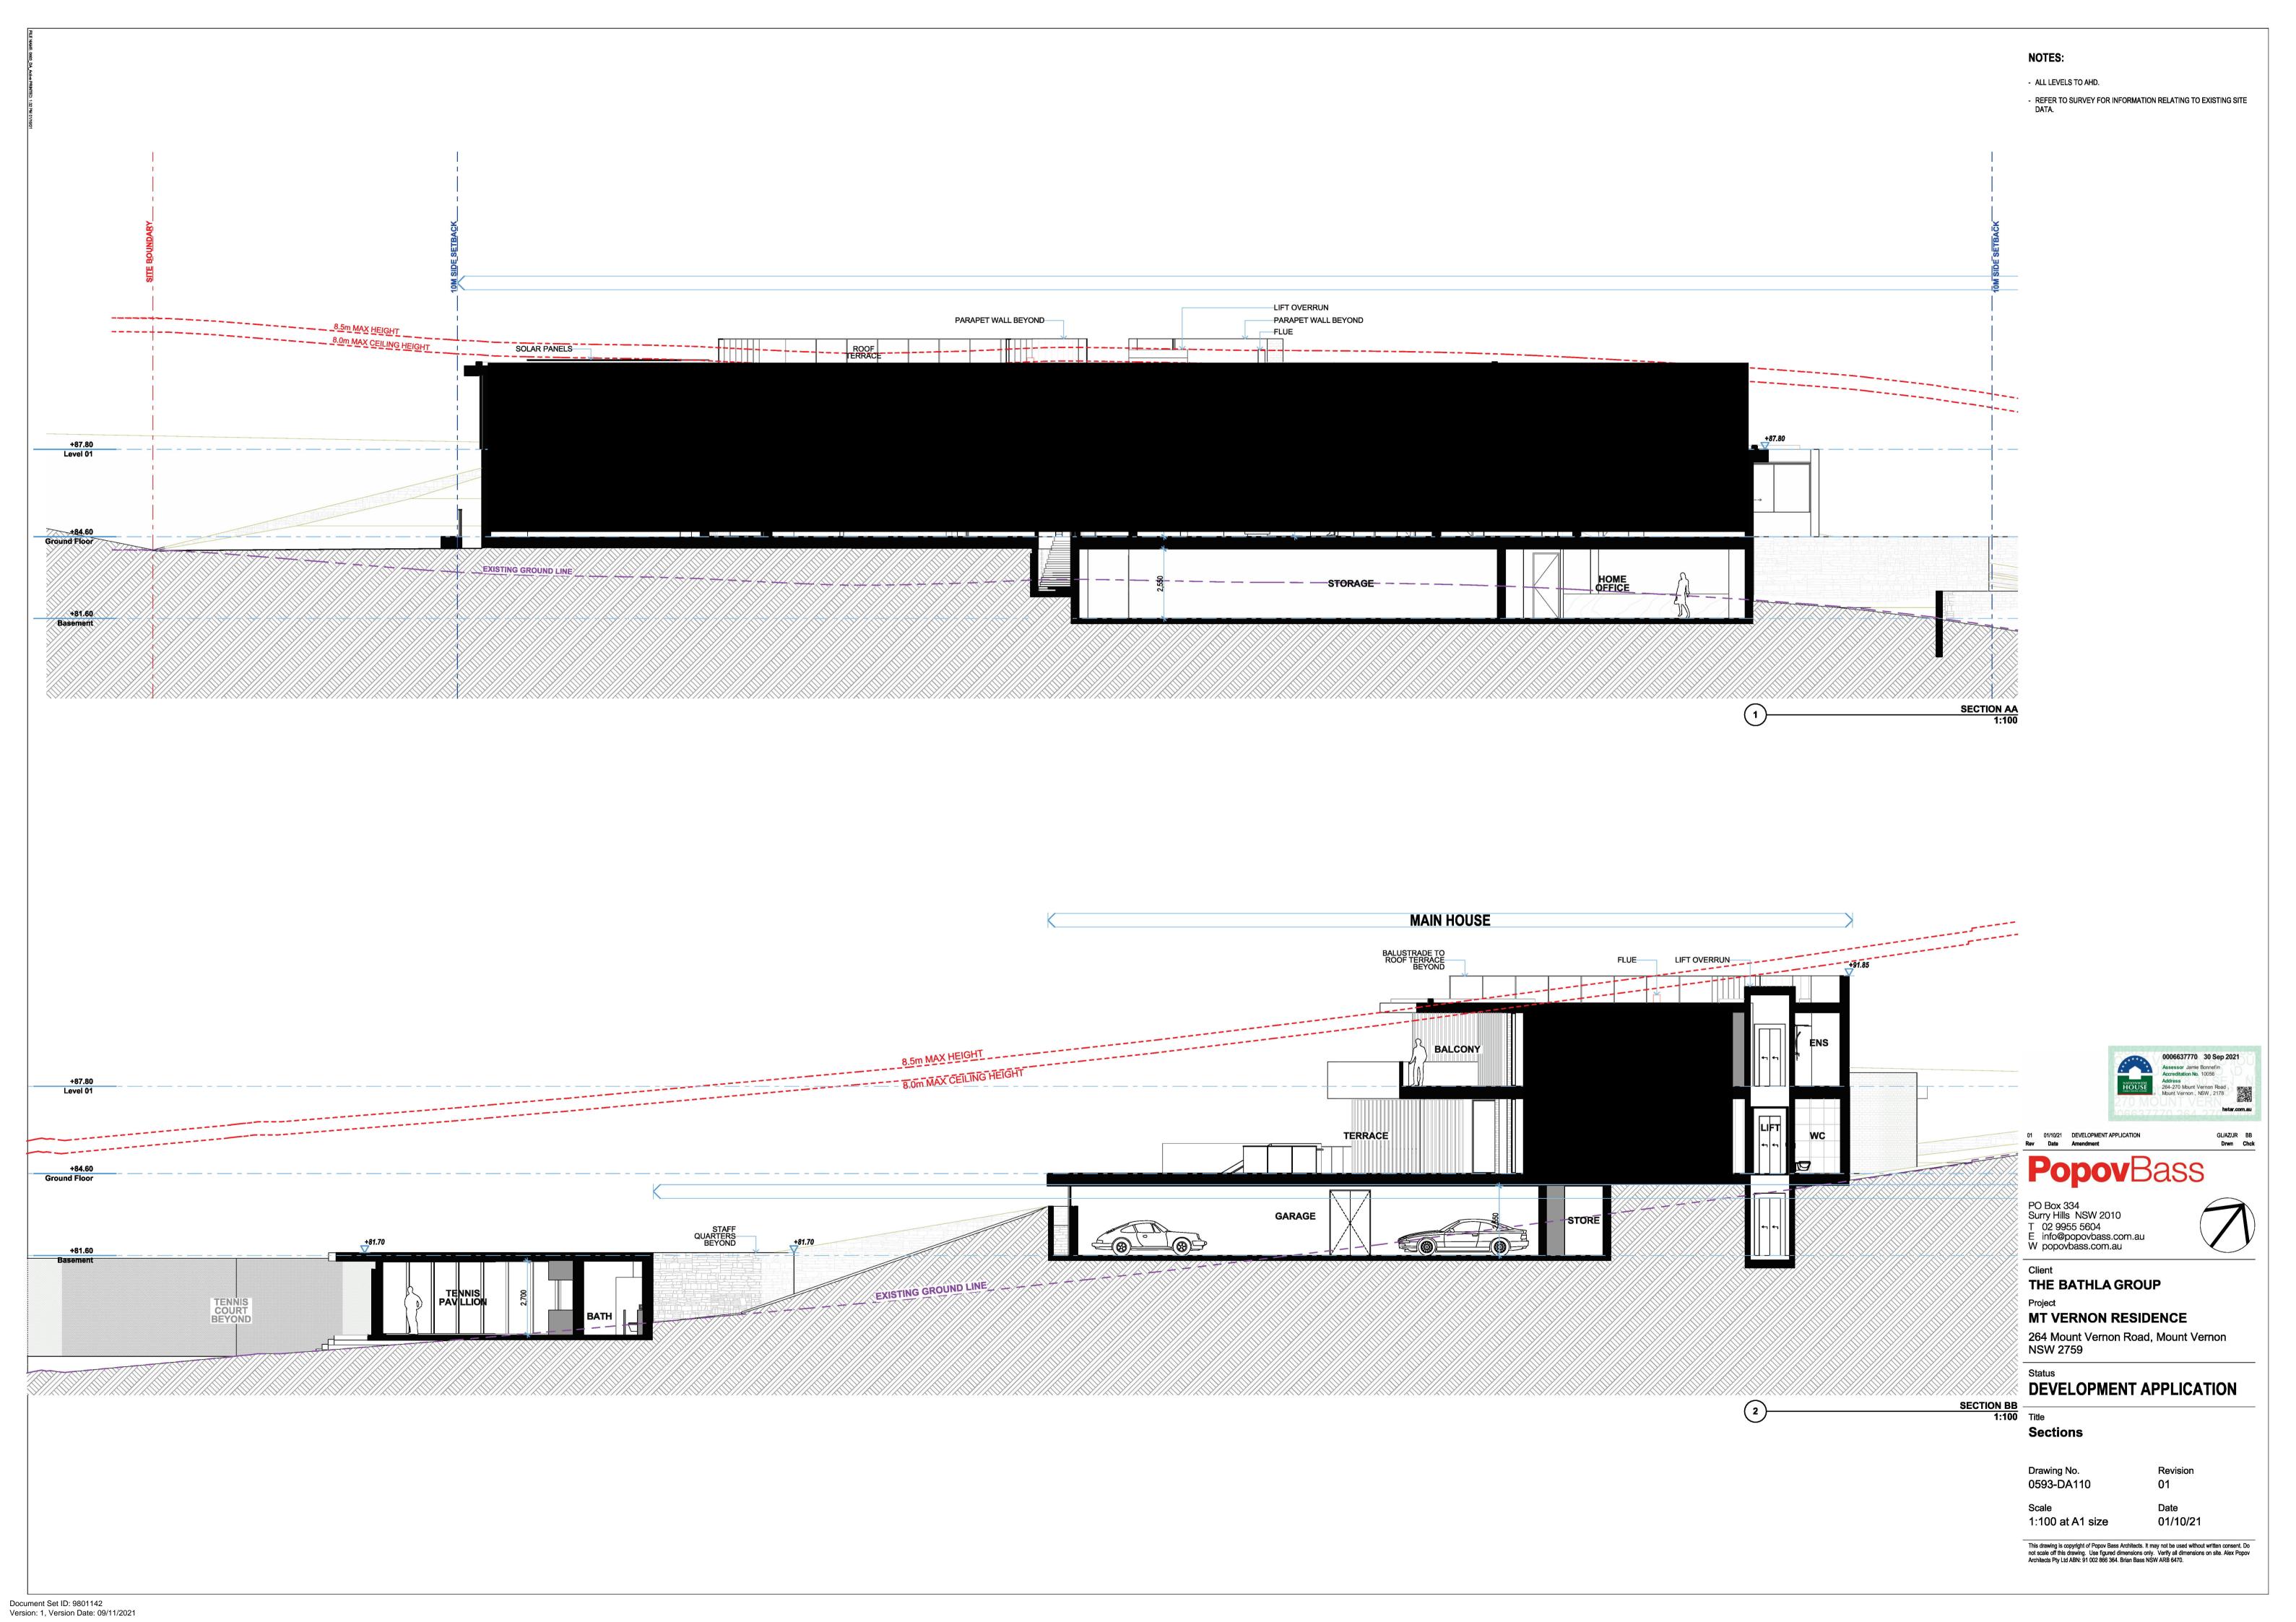
DEVELOPMENT APPLICATION


Title
Entry Gate

Drawing No. 0593-DA109

Scale 1:200, 1:100 at A1 01/10/21

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GROUND FLOOR FOOTPRINT:

CONTROL FROM PENRITH DCP 2014 D1 1.2.3 **MAX FOOTPRINT** = 500 SQM **PROPOSED FOOTPRINT** = 394.10 + 105.05 = 499.15 SQM

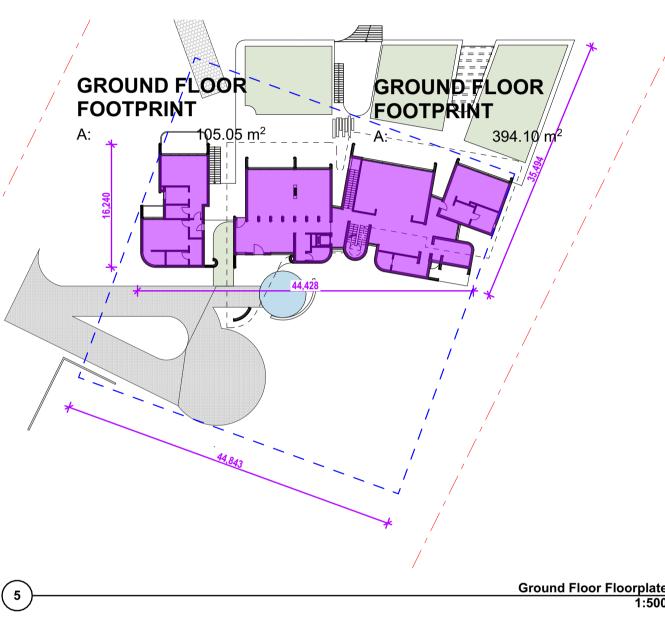GROSS FLOOR AREA:

PRIMARY DWELLING

BASEMENT = 439.9 SQM GROUND FLOOR = 459.2 SQM

LEVEL 01 = 239.7 SQM (MAX 70% OF GROUND FLOOR)

TOTAL = 1,138.8 SQM

SECONDARY DWELLING

CONTROL FROM PENRITH LEP 2010 CLAUSE 5.4

MAX FLOOR AREA = GREATER OF 60 SQM OR 10% TOTAL FLOOR

AREA OF PRIMARY DWELLING

= 10% x 1138.8

= 113.9 SQM

STAFF = 86.6 SQM (COMPLIES)

ANCILLARY DEVELOPMENT

PAVILION = 82.3 SQM

| Address: Lot No / DP: | 264-270 Mount Vernon Road, 1/1246952 | , Mount Vernon | | | | |
|------------------------------|---|-----------------------|--|------------------|--|---|
| Water | | | | | | |
| Fixtures | | | Specification | | | |
| Shower head rat | ting | | 4 star (> 6 but <= 7 | .5 L/min) | | |
| Toilet rating | | | 4 star | | | |
| Kitchen taps rati | | | 4 star | | | |
| Bathroom taps r | rating | | 4 star | | | |
| Alternative wate | er details | | | | | |
| Rainwater tank | size | Individual | 4000L | | | |
| Connected to: | Garden and lawn areas | | Yes | | | |
| | All toilets | | Yes | | | |
| | Laundry | | No | | | |
| Thermal Comfo | rt | Accreditation Number: | HERA 10056 | | NatHERS Number | 6637770 |
| External walls | | Accreditation Number. | Requirements | | Nathers Number | 0037770 |
| Cavity brick | | | | R1.1 | Bulk + Reflective foil | |
| Weatherboard | | | Light colour R | R2.7 | Bulk + Anti-glare foil | |
| | | | | | | |
| Internal walls | at Charles to the state of | | | | | |
| Cavity wall, direc | ct fix plasterboard | | No insulation | | | |
| Coiling | | | | | | |
| Ceiling External ceiling | - Concrete, plasterboard | | R5.0 Bulk insulation | | | |
| _ | - Concrete, plasterboard | | No insulation | .1 | | |
| e. mai ceiling - | Some step product boditu | | | | | |
| Roof | | | | | | |
| Waterproofing r | memhrane | | Medium Colour (so | olar absorptanc | e 0.475-0.7) | |
| water proofing r | membrane | | No insulation | | | |
| | | | | | | |
| Floors | | | | | | |
| Concrete slab or | | | No insulation | | | |
| Suspended cond | crete slab | Exposed areas only | R2.5 Bulk insulation | ו | | |
| Windows | | | | | | |
| Willdows | | | Single low-e glazing | with H-value | 5 6 and SHGC 0.36 for Group A windo | ows (awning, bifold, casement and tilt 'n' turn |
| Aluminium fram | ne ALM-001-04 | | type windows/doo | _ | 5.0 and street 0.50 for Group A winde | ws (awning, briola, casement and the firetain |
| | | | • | • | 5.6 and SHGC 0.41 for Group B windo | ws (double hung, fixed, louvres and sliding |
| Aluminium fram | ne ALM-002-04 | | type windows/doo | | | 3, 33, 33, 33, 33, 33, 33, 33, 33, 33, |
| A l | 1111 004 04 | Indoor Dool Area | Double air-fill low- | e glazing with L | J-value 4.9 and SHGC 0.33 for Group | B windows (double hung, fixed, louvres and |
| Aluminium fram | 16 ALIVI-004-04 | Indoor Pool Area | sliding type window | ws/doors) | | |
| | | | | | | |
| Downlights | | | | | | |
| Downlight Cover | rs | | Approved fireproof | f downlight cov | ers must be installed to all downlight | s in ceilings where insulation is installed. |
| | | | | | | |
| Lighting specific | ation | | Dwelling is rated w | ithout downlig | ht | |
| | | | | | | |
| Overshadowing | details | | Adjoining units cald | culated into mo | odel calculations | |
| 0 | | | , , | | | |
| Site | | | | | | |
| Orientation of n | ominal north elevation | | As shown on plans | | | |
| | | | | | | |
| Energy | | | | | | |
| Hot water | | | Specification | | Rating | |
| Individual syster | m | | Solar (gas boosted, | flat plate) | 26 to 30 STCs | |
| M | | | | | | |
| Ventilation | uet | | Individual face and | ductod | | |
| Bathroom exhau | | | Individual fan, not of Manual switch on/ | | | |
| Control s Kitchen exhaust | | | Individual fan, not | | | |
| Control s | | | Manual switch on/ | | | |
| Laundry | TVVICCII | | Individual fan, not | | | |
| Control s | switch | | Manual switch on/ | | | |
| 32 | | | | | | |
| Cooling | | | | | | |
| Individual syster | ms - living areas | | 3-phase aircondition | ning | EER > 4.0 | |
| | ms - bedroom areas | | 3-phase aircondition | | EER > 4.0 | |
| | | | | | | |
| Heating | | | | | | |
| Individual syster | | | 3-phase aircondition | | EER > 4.0 | |
| Individual syster | ms - bedroom areas | | 3-phase aircondition | ning | EER > 4.0 | |
| Dool | | | | | | |
| Pool Volume | | | 120kL | | | |
| Heating system | | | Solar (gas boosted) |) | | |
| Pool cover | | | Yes | | | |
| Pool shaded | | | No | | | |
| Timer | | | No | | | |
| | | | | | | |
| Appliances | | | | | | |
| Cooktop/oven | | | Gas cooktop & elec | tric oven | | |
| Ventilated fridge | | | Yes | | | |
| | clothes drying line | | Yes | | | |
| | or sheltered clothes drying line | | Yes | | | |
| Zoned Air-condi | itioning | | Yes | | | |
| | | | | | | |

Main Dwelling 10 kW

BASIX Number: 1238229M

Dual Occupancy

Address: 264-270 Mount Vernon Road, Mount Vernon

NOTES:

- ALL LEVELS TO AHD.

- REFER TO SURVEY FOR INFORMATION RELATING TO EXISTING SITE



01 01/10/21 DEVELOPMENT APPLICATION Rev Date Amendment

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THE BATHLA GROUP

MT VERNON RESIDENCE

264 Mount Vernon Road, Mount Vernon

DEVELOPMENT APPLICATION

Development Data

Drawing No. 0593-DA111


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FINISHES SCHEDULE




'PF2' PAINT FINISH (CHARCOAL)



'BR' BRICKWORK

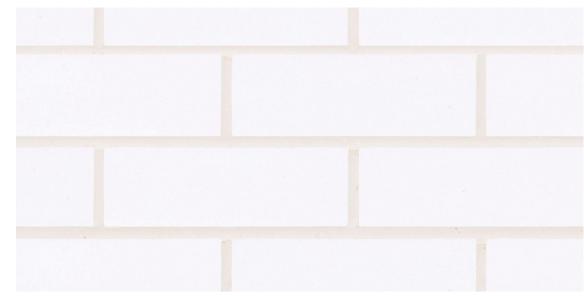


'PF1' PAINT FINISH (LIGHT)

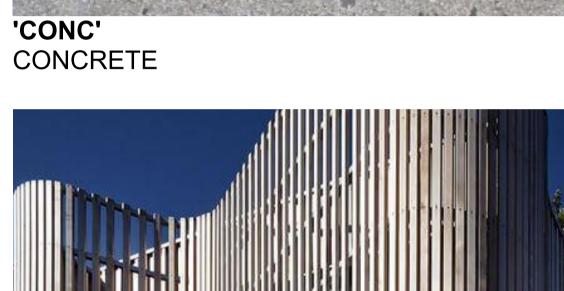

TIMBER SCREEN



'TC' TIMBER CLADDING

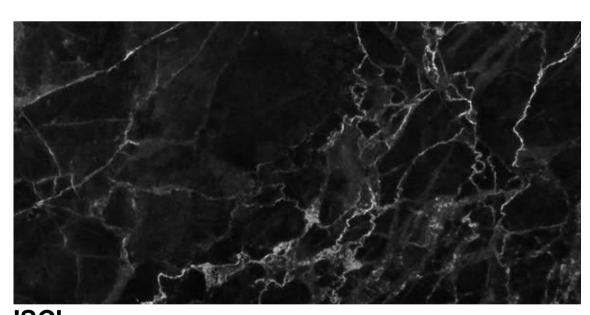

'SC' STONE CLADDING




'SS' SANDSTONE



GLASS BALUSTRADE



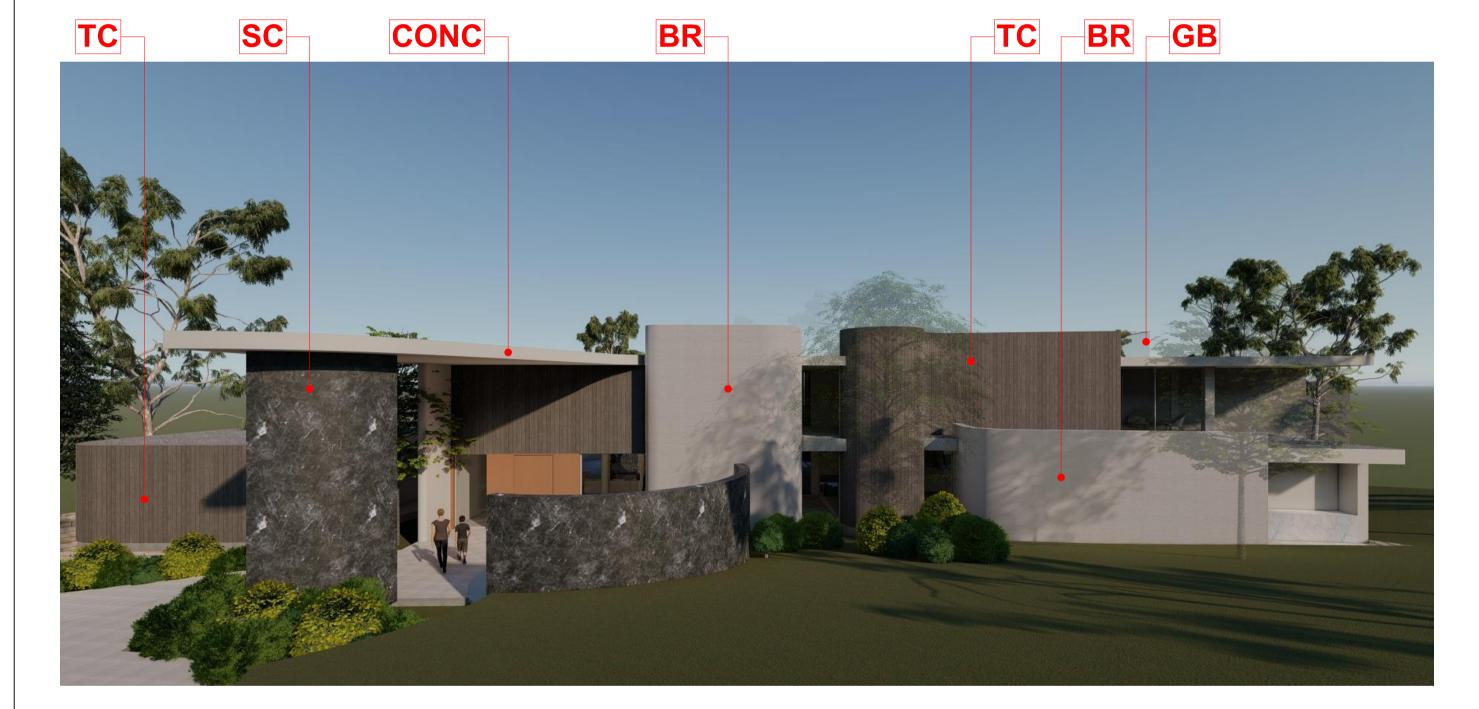





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Project
MT VERNON RESIDENCE


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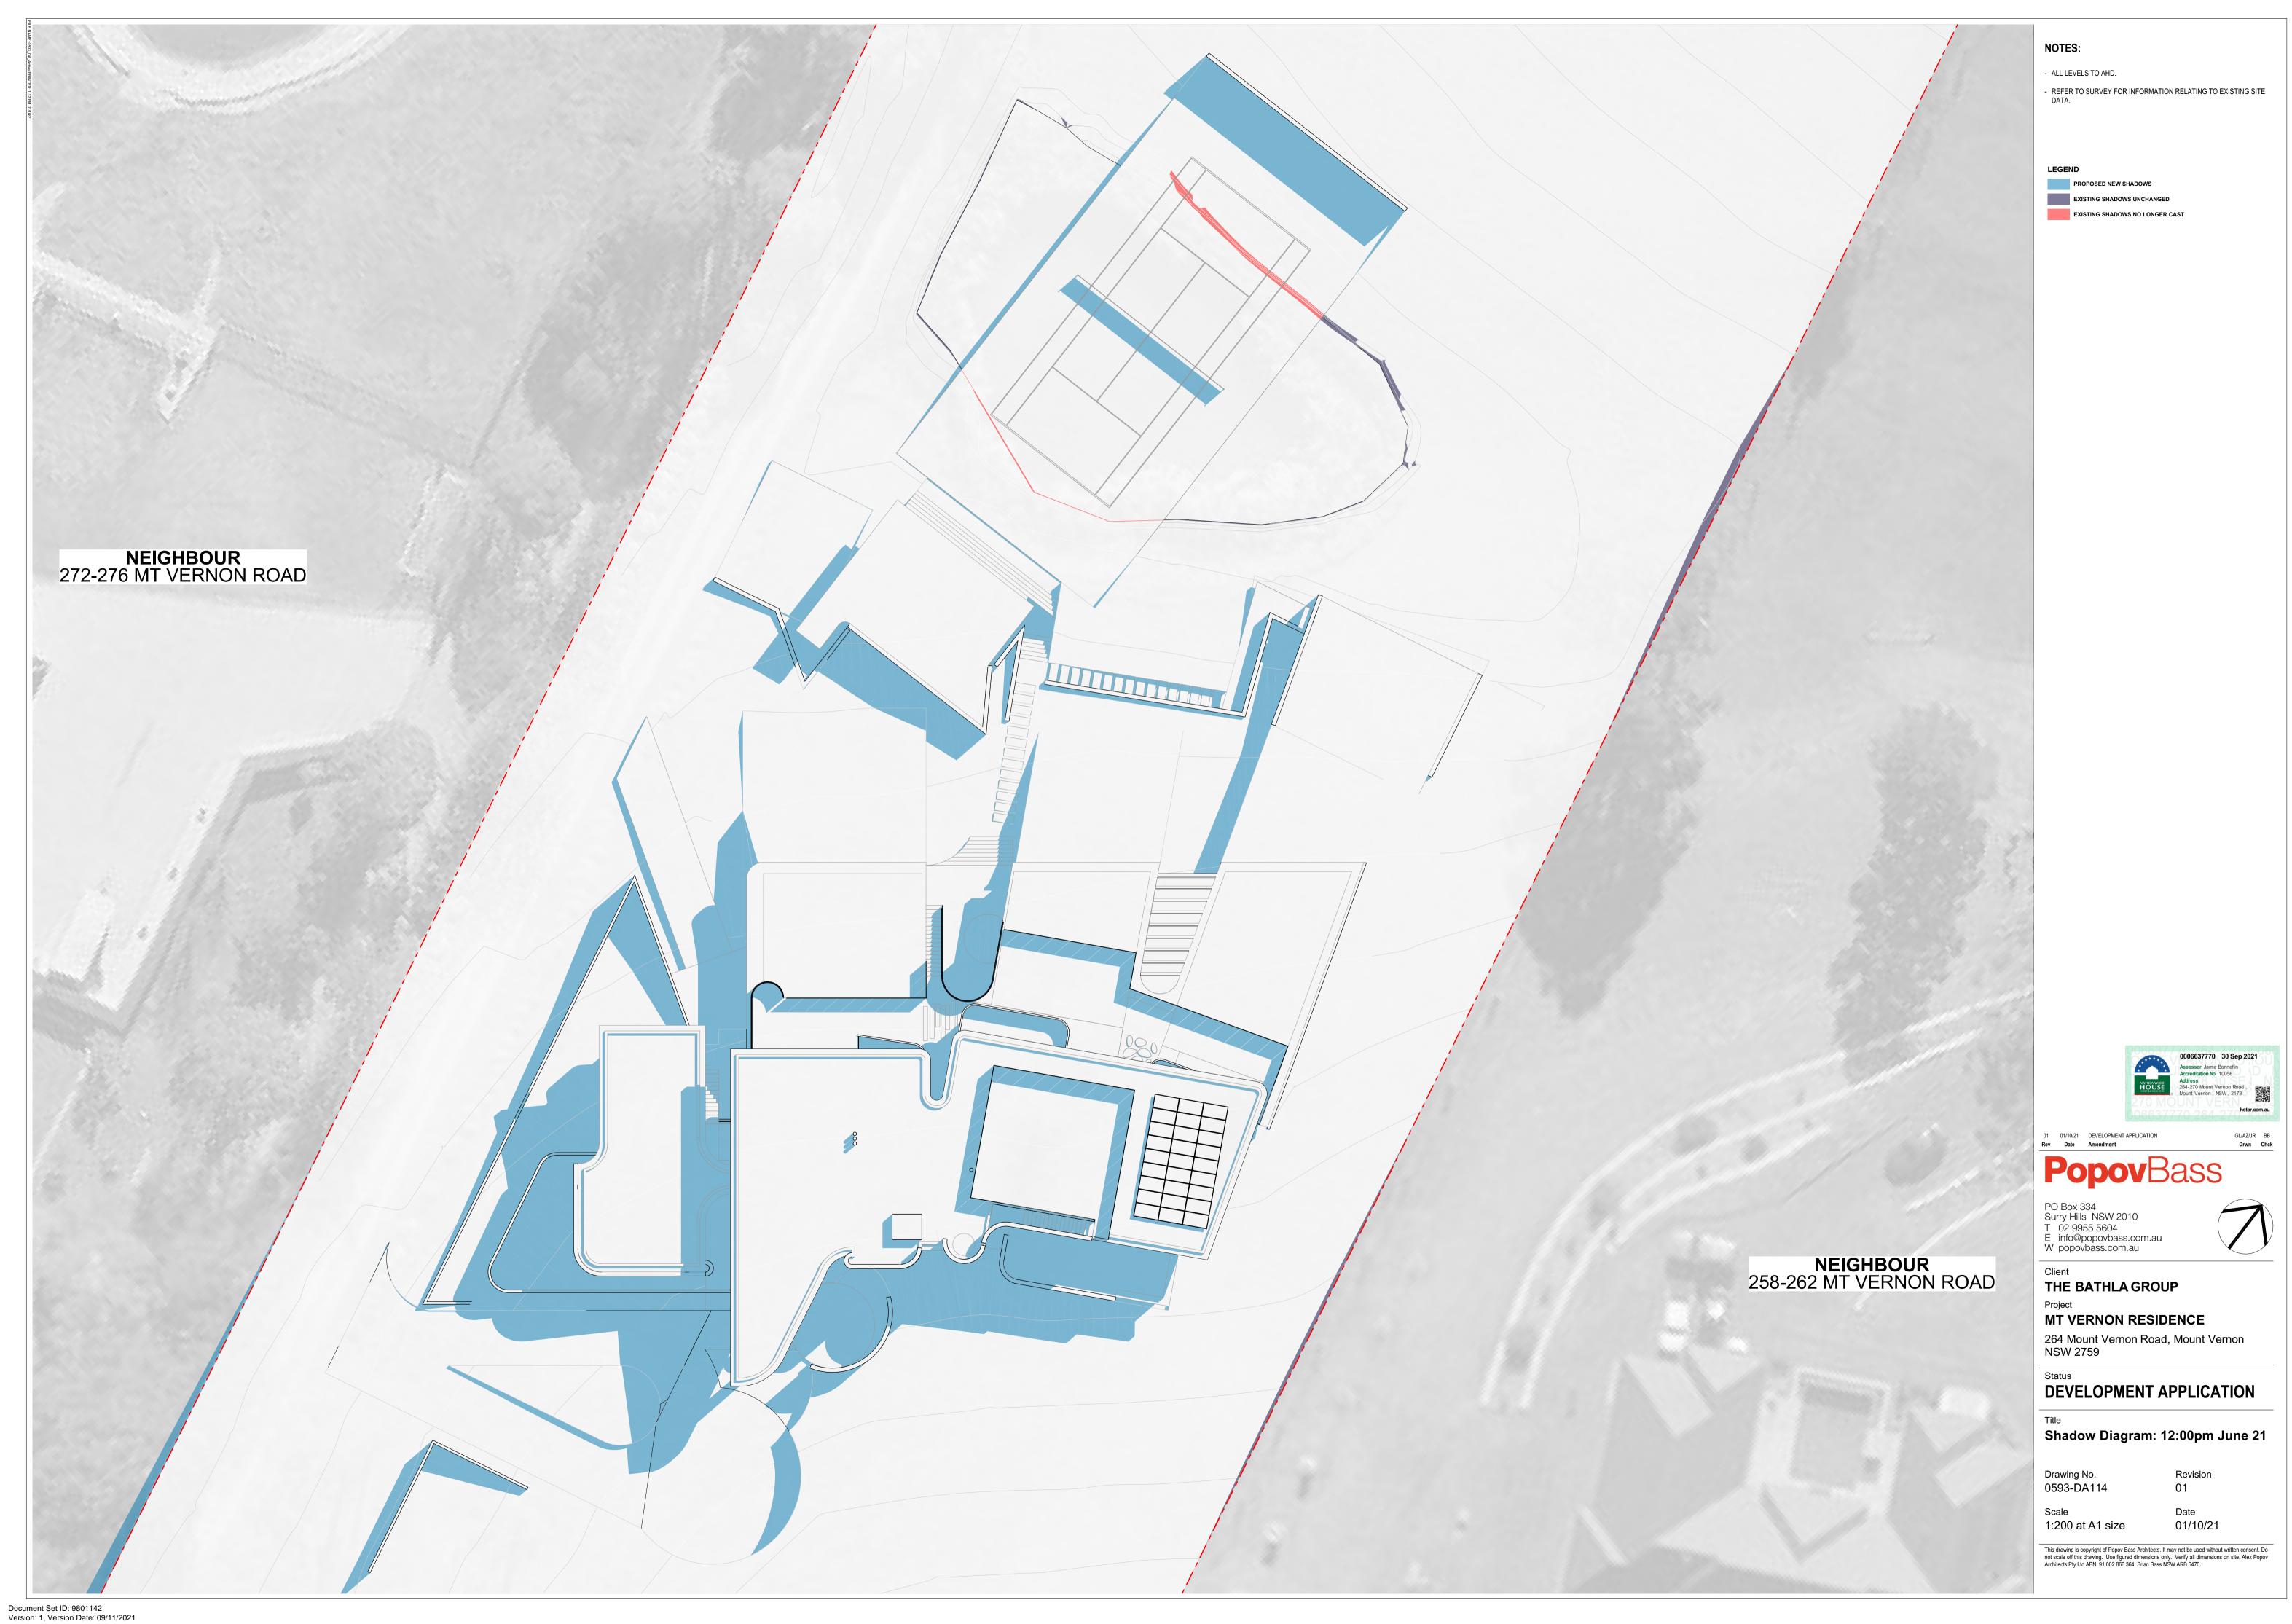
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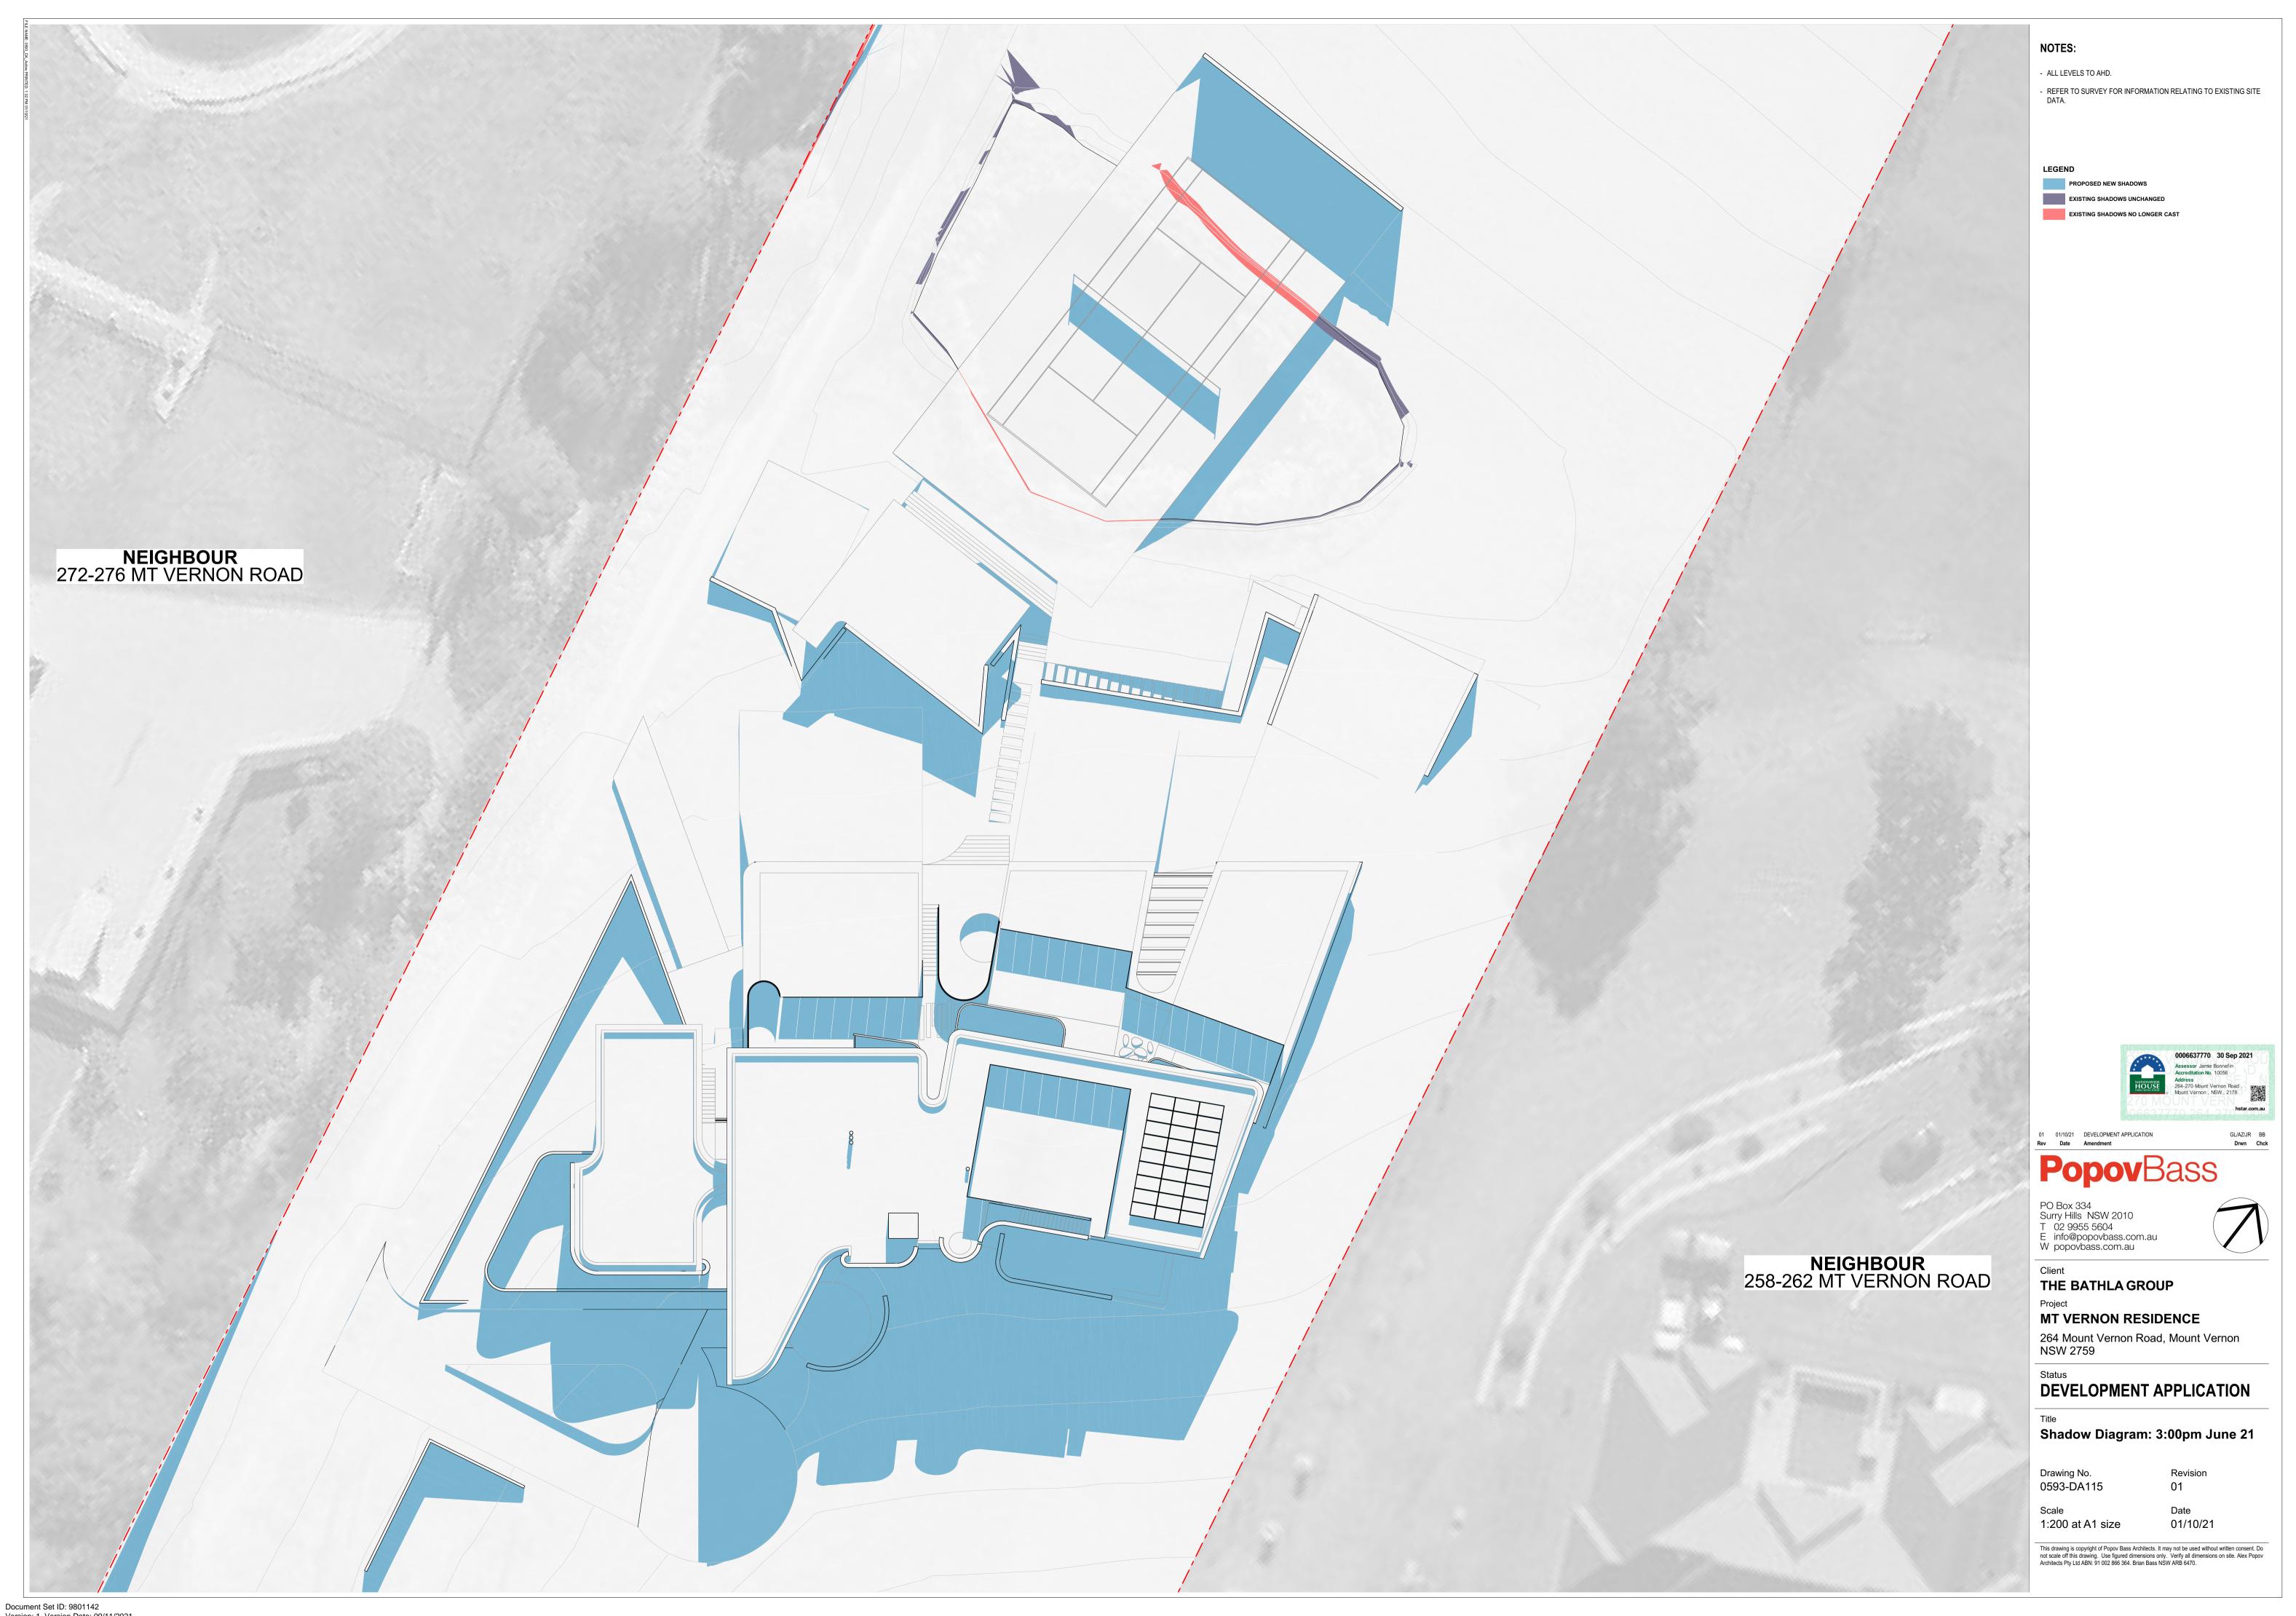
DEVELOPMENT APPLICATION

Schedule of Finishes & 3D Views

Drawing No. 0593-DA112





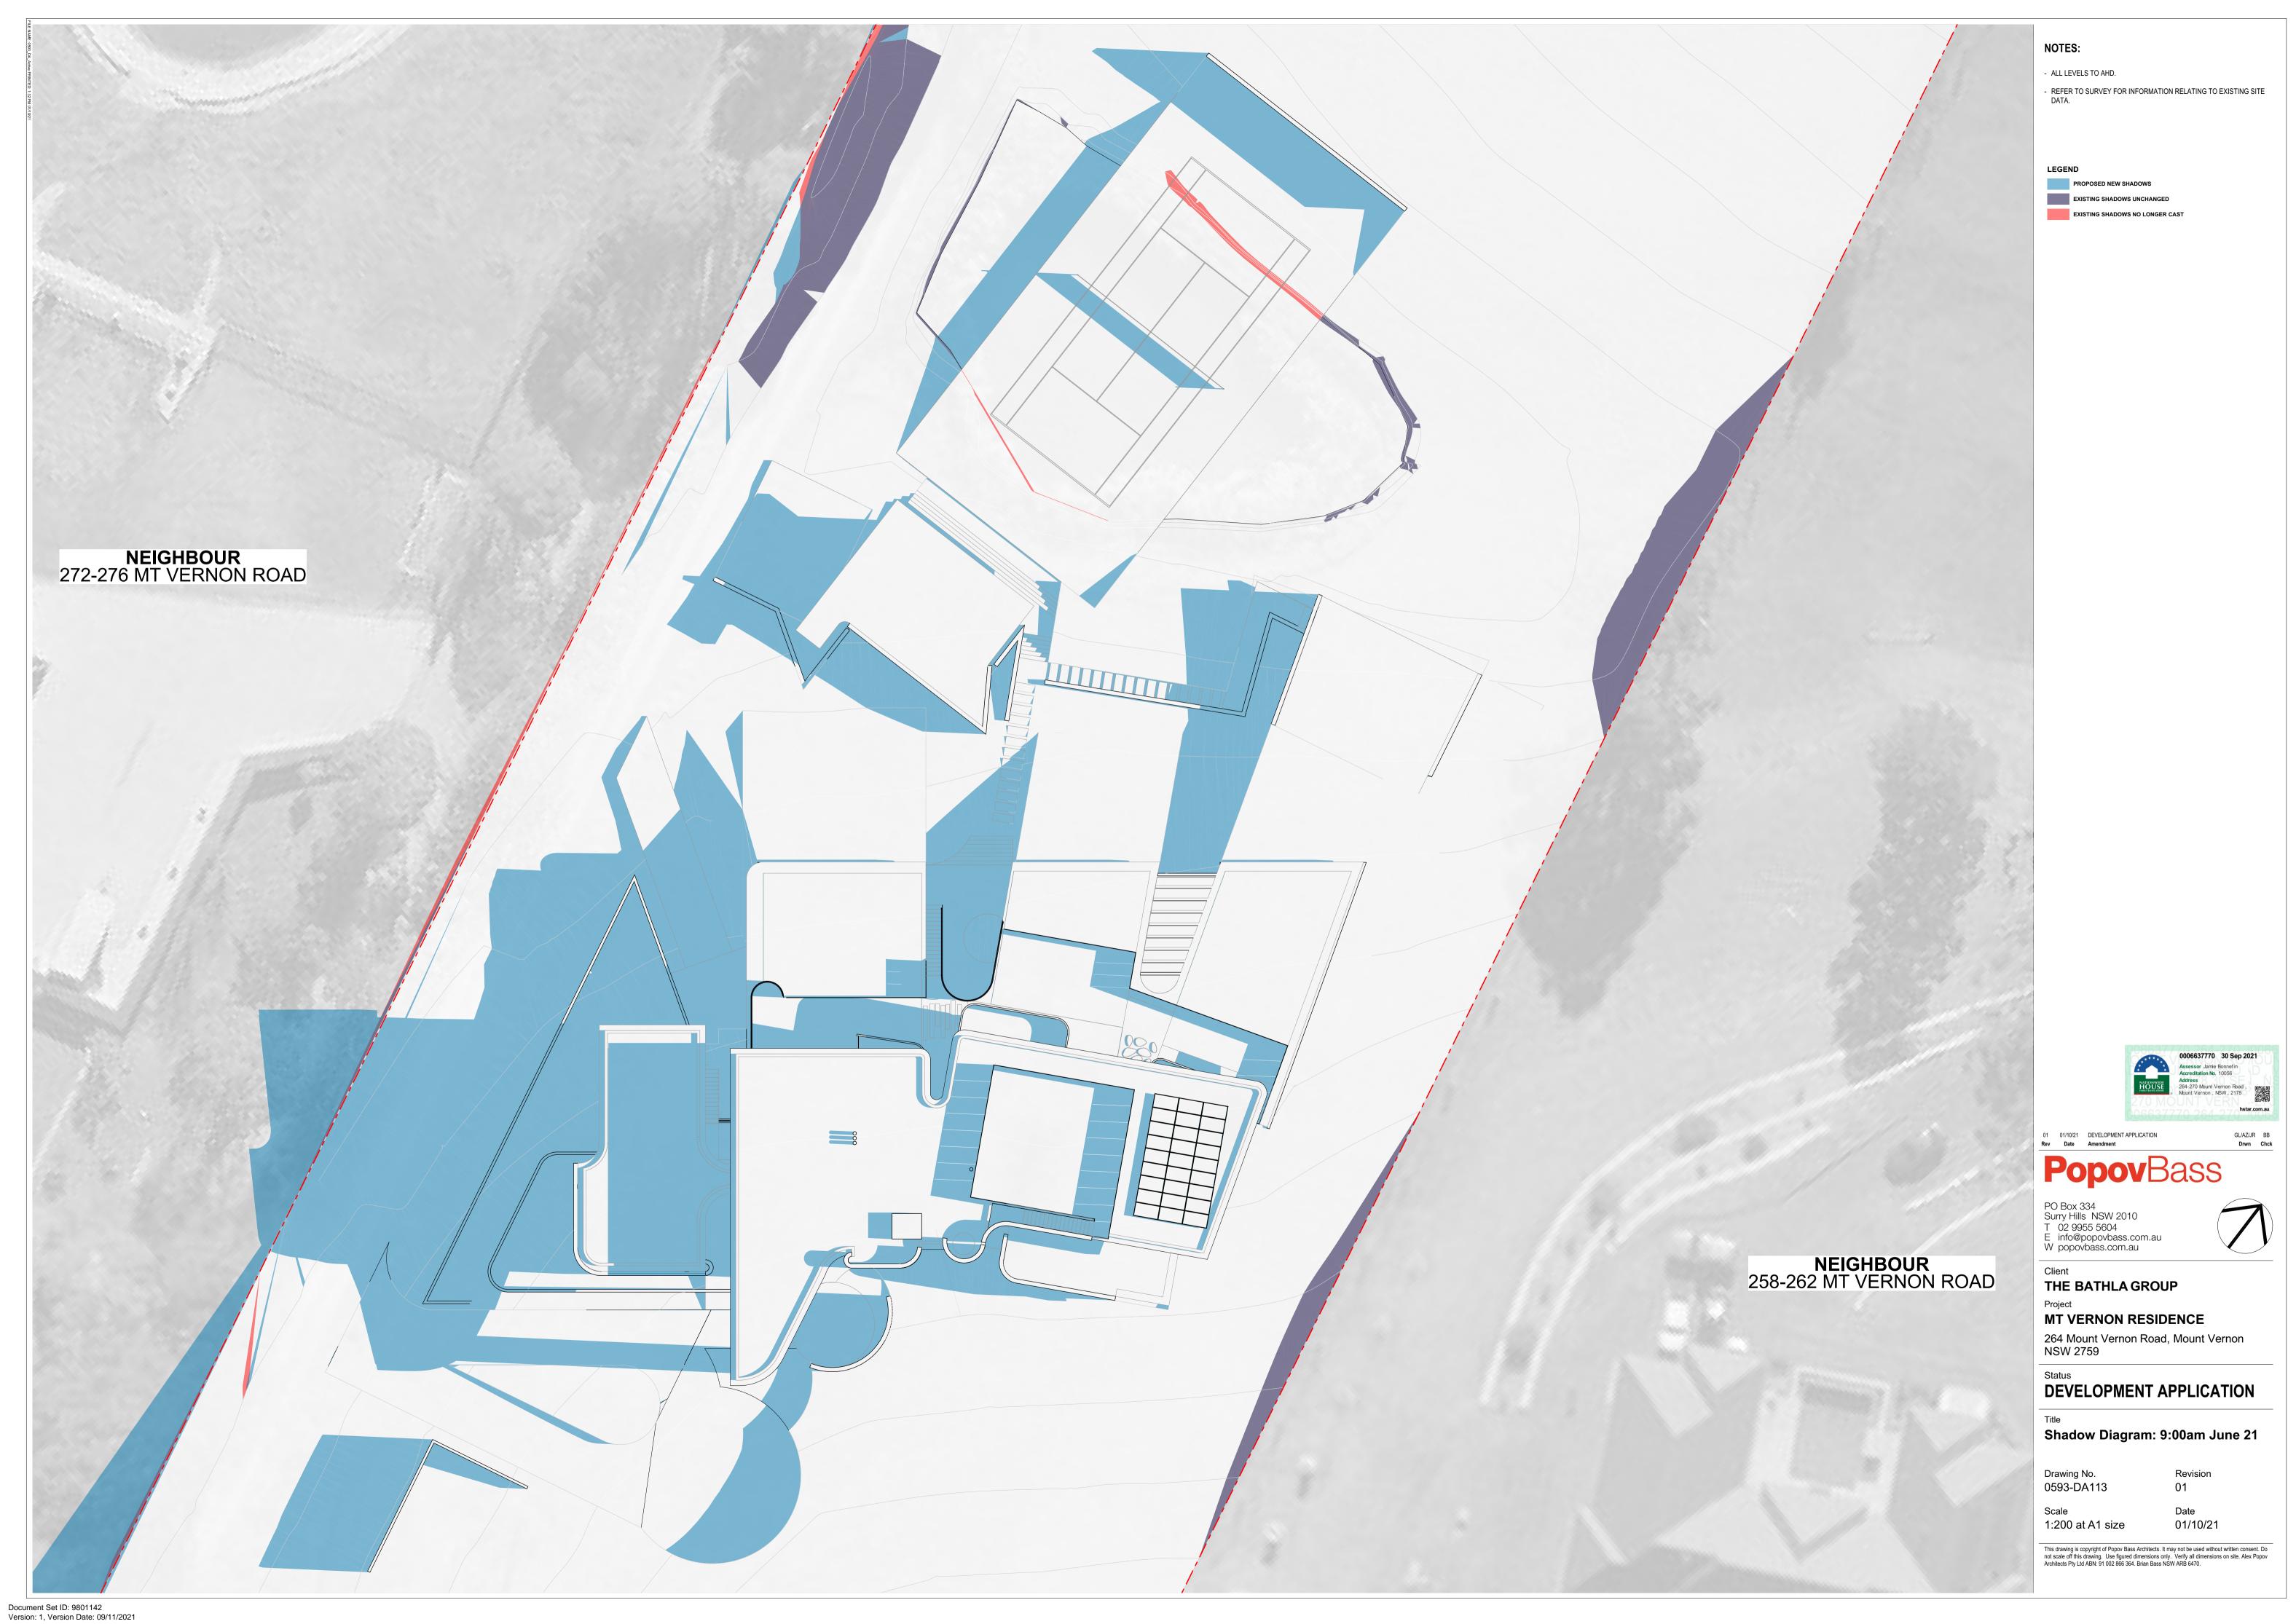

Version: 1, Version Date: 09/11/2021