

LANDSCAPE MAINTENANCE SCHEDULE FOR THE BODY CORPORATE

Action	Description	Bi- monthly	Monthly	Quarterly	Annually	2 years	5 years	10 years
Establishing	1 st 12 months	montany						
Plants	Maintenance Contractor							
Weeding	Manual methods preferred	yes						
Replace dead plants	protestion	yes						
Check irrigation is		yes						
working properly								
Pest control	Use environmentally friendly management methods		yes if needed					
Fertilizer	Osmocote® Native Gardens				yes			
Mulching	Blanket cover				yes keep away from base of plant			
Established Landscape	Maintenance				Pisti			
Trees & shrubs	contractor							
Fertilizer	Osmocote® Native Gardens				yes			
Mulching	75mm depth				yes keep away from base of plant			
Pest control	Use environmentally friendly management methods			yes if needed				
Weeding	Manual methods preferred	yes						
Pruning shrubs	For shape & repair				yes	Prune to improve shape	Remedial pruning to improve shape if needed	Replace shrubs that have died
Pruning trees	Formative pruning, repair & canopy lift				yes	Prune to improve shape	Remedial pruning to improve shape if needed	Replace trees that don't respond to remedial pruning
Groundcovers	Maintenance							
	contractor							
Fertilizer	Osmocote® Native Gardens				yes			
Mulching	Blanket cover				yes keep away from base of plant			
Pest control	Use environmentally friendly management methods			yes if needed				
Weeding	Manual methods preferred	yes						
Pruning	Grasses, remove dead leaves			yes		cut back to 25cm if needed	Replace grasses that have not responded & amend soil	

SPECIFICATION

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Plants are to be supplied true to type free from disease, pests and in a vigorous well developed condition without being root bound. All plants are to receive osmocote 9 mths slow release fertilizer applied according to manufacturers recommended rates. All trees, shrubs and groundcovers are to receive Water Storage Crystals to there root zone area at planting time, refer to manufacturers application rates. Trees are to be staked as indicated and all plants are to be flood watered in there pots prior to planting and within 30 mins after planting. Variations to the plant species and size due to lack of availability are to be discussed with the landscape consultant before any alterations may take place.

Soil Mix

Natural ground soil mix shall consist of the following:

3 parts by volume existing top soil ,1 part by volume double washed river sand, 1 part by volume friable spent mushroom compost. Rip garden beds to a depth of 400mm prior to placing river sand and compost. Rotary hoe the ingredients to a depth of 300mm (twice) to achieve an even mixed tilth. Thoroughly mix all ingredients to acheive a pH 6.5

Planter Boxes on Suspended Concrete Decks:

30% top soil black, 10% graded ash, 10% double washed river sand, 20% composted hardwood sawdust, 20% composted friable mushroom compost, 10% composted pinebark, thoroughly mix all ingredients to achieve a pH

Wood & leaf chip mulch is to be spread to a depth of 75mm, blanket cover to all garden beds. Make sure no part of

the stem is covered by mulch.


Timber edges are to be constructed as detailed. Only treated timber is to be used.


Turf specified is to be cultivated 'Kenda' Kikuyu from an approved turf grower. See turfing details. Turf shall be free from pests, diseases and weeds. Turf is to be laid within 24hrs of lifting. Lay turf with closed butted joints and water thoroughly each section after laying. Top dress joints with one part washed river sand and one part top soil to achieve an even surface free from hollows and ruts. Fertilize the turf with an approved turf fertilizer eg. Shirleys # 18 lawn food and continue to water turf to prevent burning.

Automatic drip-feed irrigation is to be installed to all garden beds and planters. Netafim tech-line '16' or similar product is to be installed prior to mulching and fixed to the soil surfaces with wire 'U' pegs at 1m intervals to prevent drip line from lifting. Automatic flush valves, air relief valves and filters are to be installed and drip spacings of 300mm are recommended. The drip tubes are to be placed as close as possible to the base of each plant. Back-flow prevention valves are to be installed according to the water Boards regulations concerning irrigation systems. The irrigation contractor is responsible for the maintenance of the irrigation system for the entire 26 week maintenance period. This will entail 3 monthly visits to check watering frequency or adjust watering requirements where there appears a need for reduction or additional watering of specific areas where necessary to maintain optimum plant growth. Drip-feed pipe to be buried 50mm deep into soil, after testing for any malfuctions. Apply 75mm depth of mulch afterwards.


The landscape contractor is to maintain the site in its entirety for a period of 52 weeks from the date of practical completion. This is to include maintenance on a weekly basis for a period of 3 months, afterwards fortnightly thereafter for the memainder of the maintenance period. The maintenance period shall include the following items :- Ensure there is sufficient soil moisture in all garden beds and planter boxes to sustain optimum plant growth. Plants shall be inspected by the contractor on a fortnightly basis and any plant that has died or is failing to thrive shall be replaced at the contractors own expense, at the next inspection. Replacement of plants are to be carried out with plants of the same genus, species and container size. The contractor is not held responsible for plants that are subject to vandalism or theft. However, the contractor is to notify the landscape consultant prior to any plant replacements or variations to the contract. Spraying to control pests and diseases is to be carried out be a certified person. Top up any mulched areas to attain a depth of 75mm and reinstate and repair any erosion or subsidence which may occur. Rectify any defects or faults that may arise due to failure of materials or workmanship.

The landscape contractor and his staff must have an up to date Occupational Health and Safety General Induction Card for construction work in NSW.

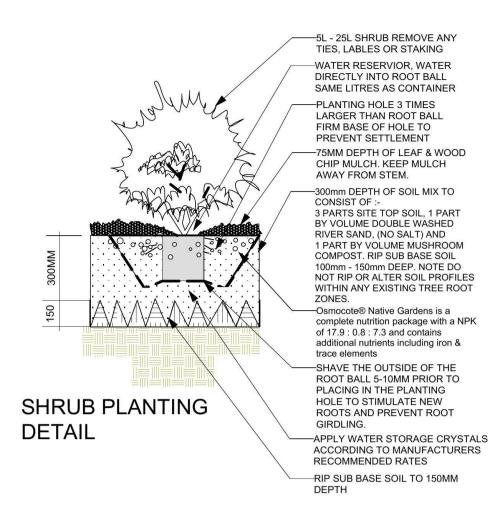

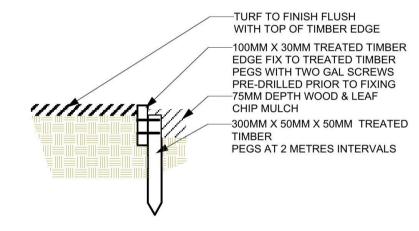


TIMBER EDGE DETAIL

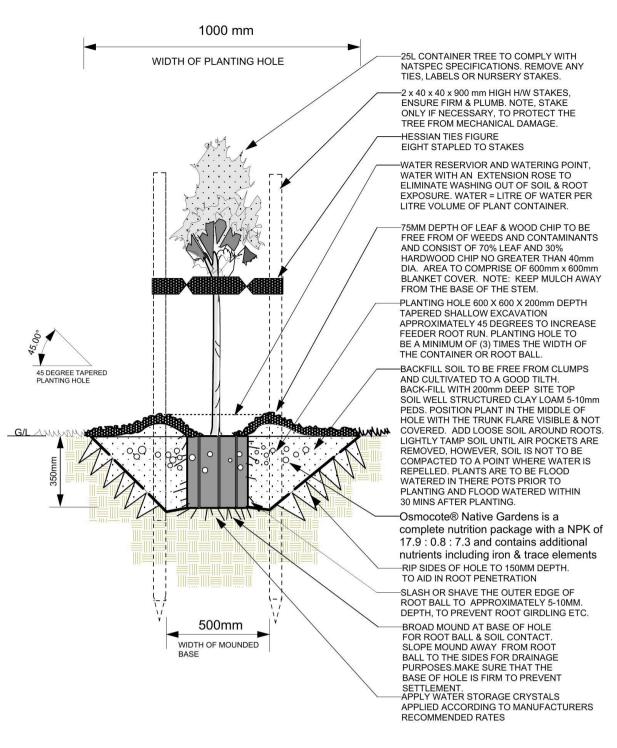


25L TREE PLANTING DETAIL

NOTE: All trees supplied are to comply with NATSPEC's "Specifying Trees a guide to assessment of tree quality" and written certification of compliance from the supply nursery. Text references: NATSPEC Clarke, R (2006, P. 6) See Spec. Watson G, Himelick E (1997, p. 37,114) Fakes, J (2004, p. 150).

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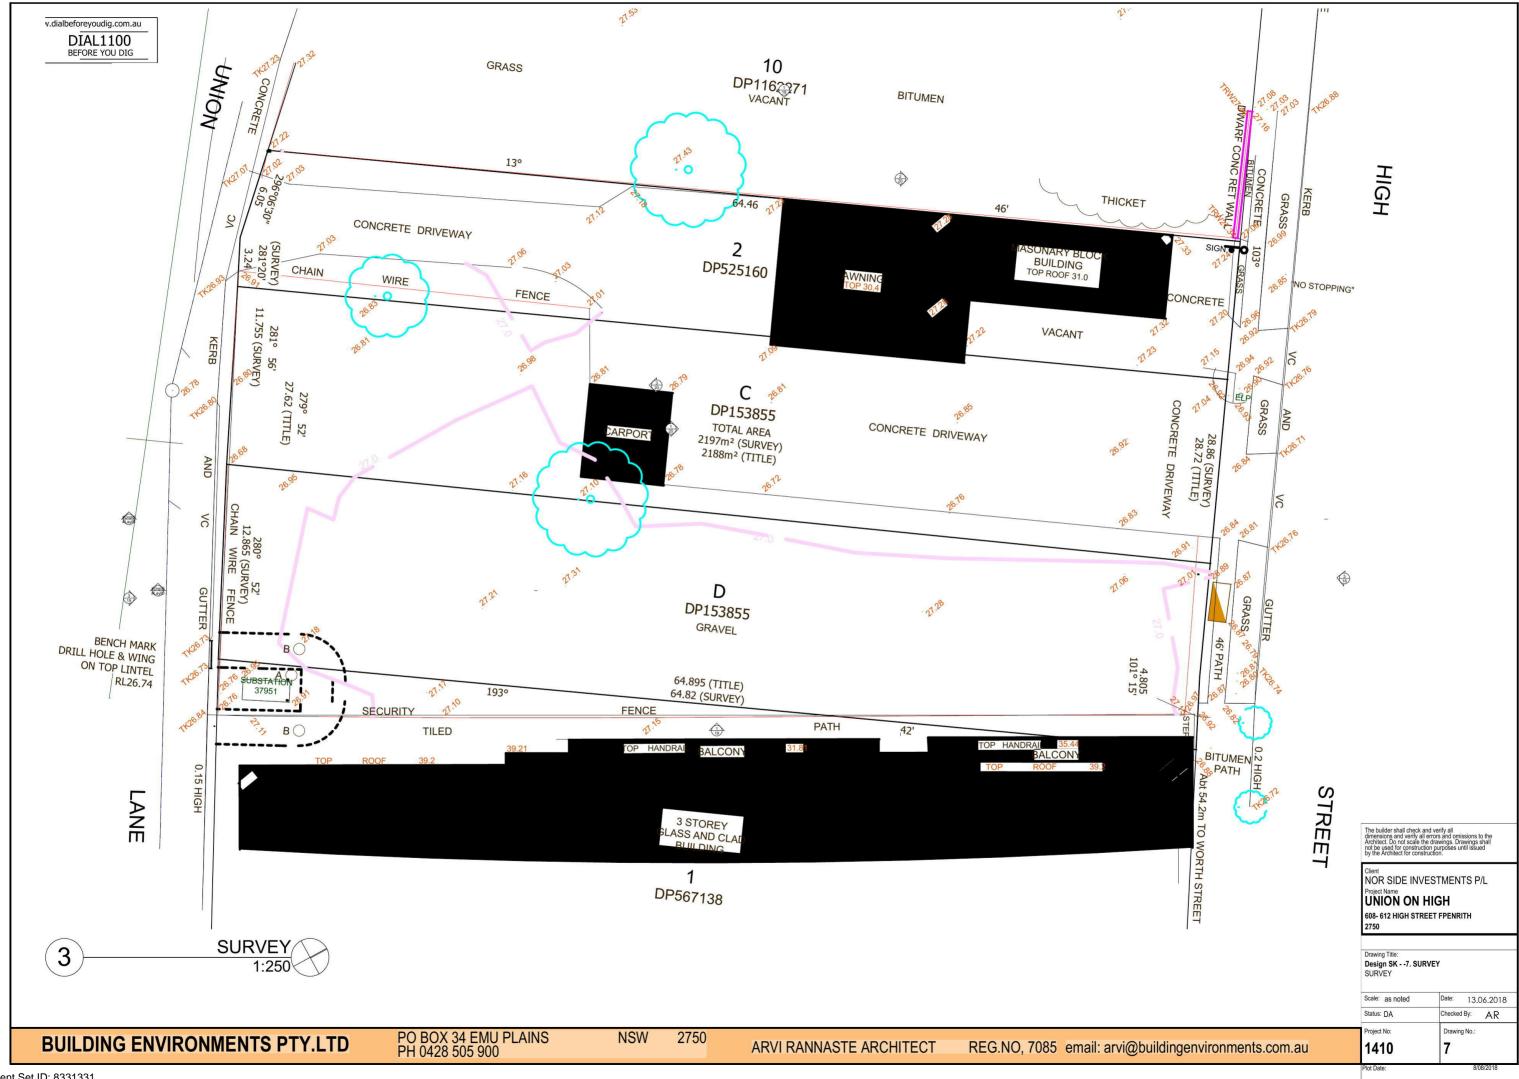
PAVING DETAIL

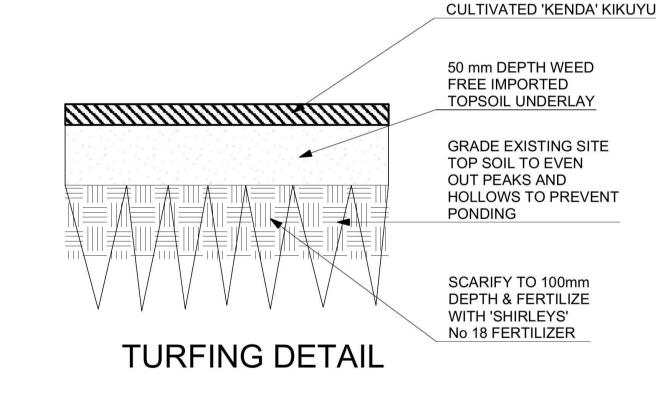
LANDSCAPE DETAIL SHEET UNION ON HIGH 608-612 HIGH STREET, PENRITH, NSW

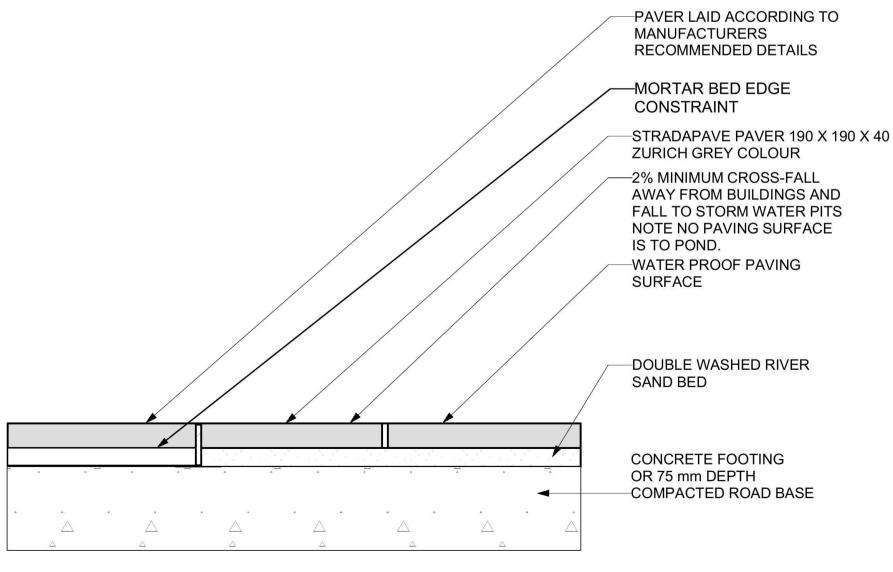



Landscape, Arboriculture & Horticulture Consultants Mobile: 0418696382. Email: ulp6@bigpond.com Terrence Machin. MAILDM & MAIH Post Grad Landscape Design Distinctions Aust Dip. Hort. (Arboriculture) (AQF5) Ryde Nat. Dip. Hort UK. Horticulture Cert, Ryde


DATE: 08/05/2018 **SCALE**: 1.100 DWG #: 002044/TM ISSUE 'A' SHEET 2-2 AMENDMENTS:



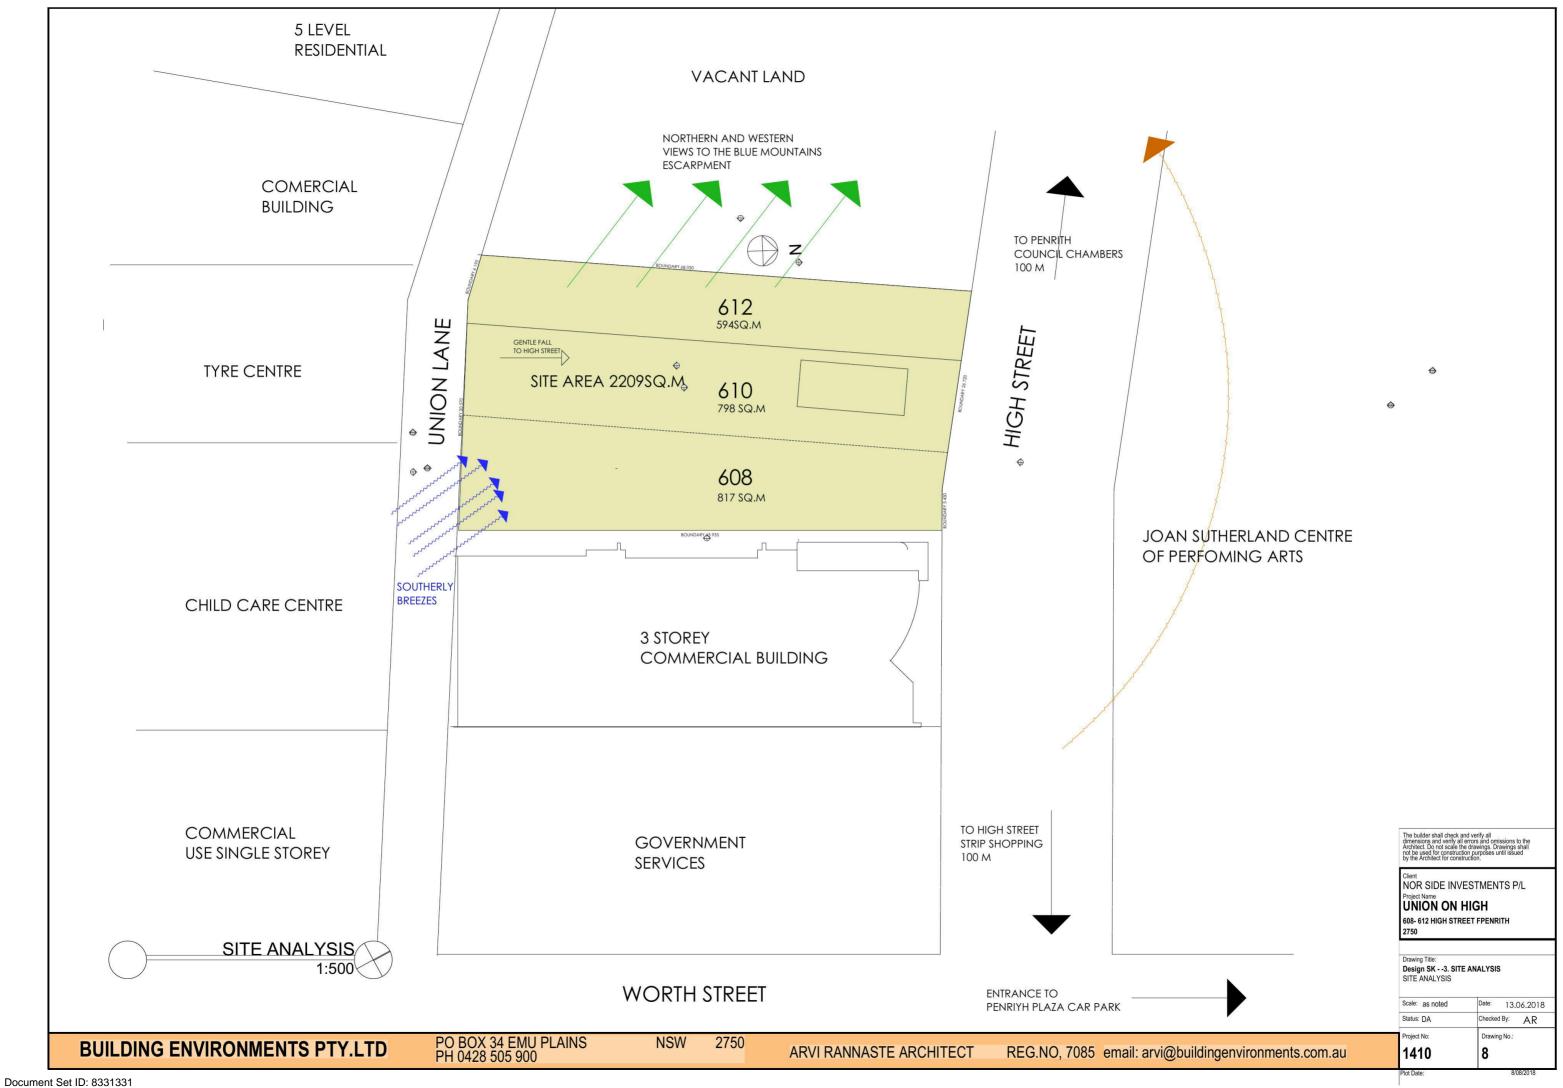

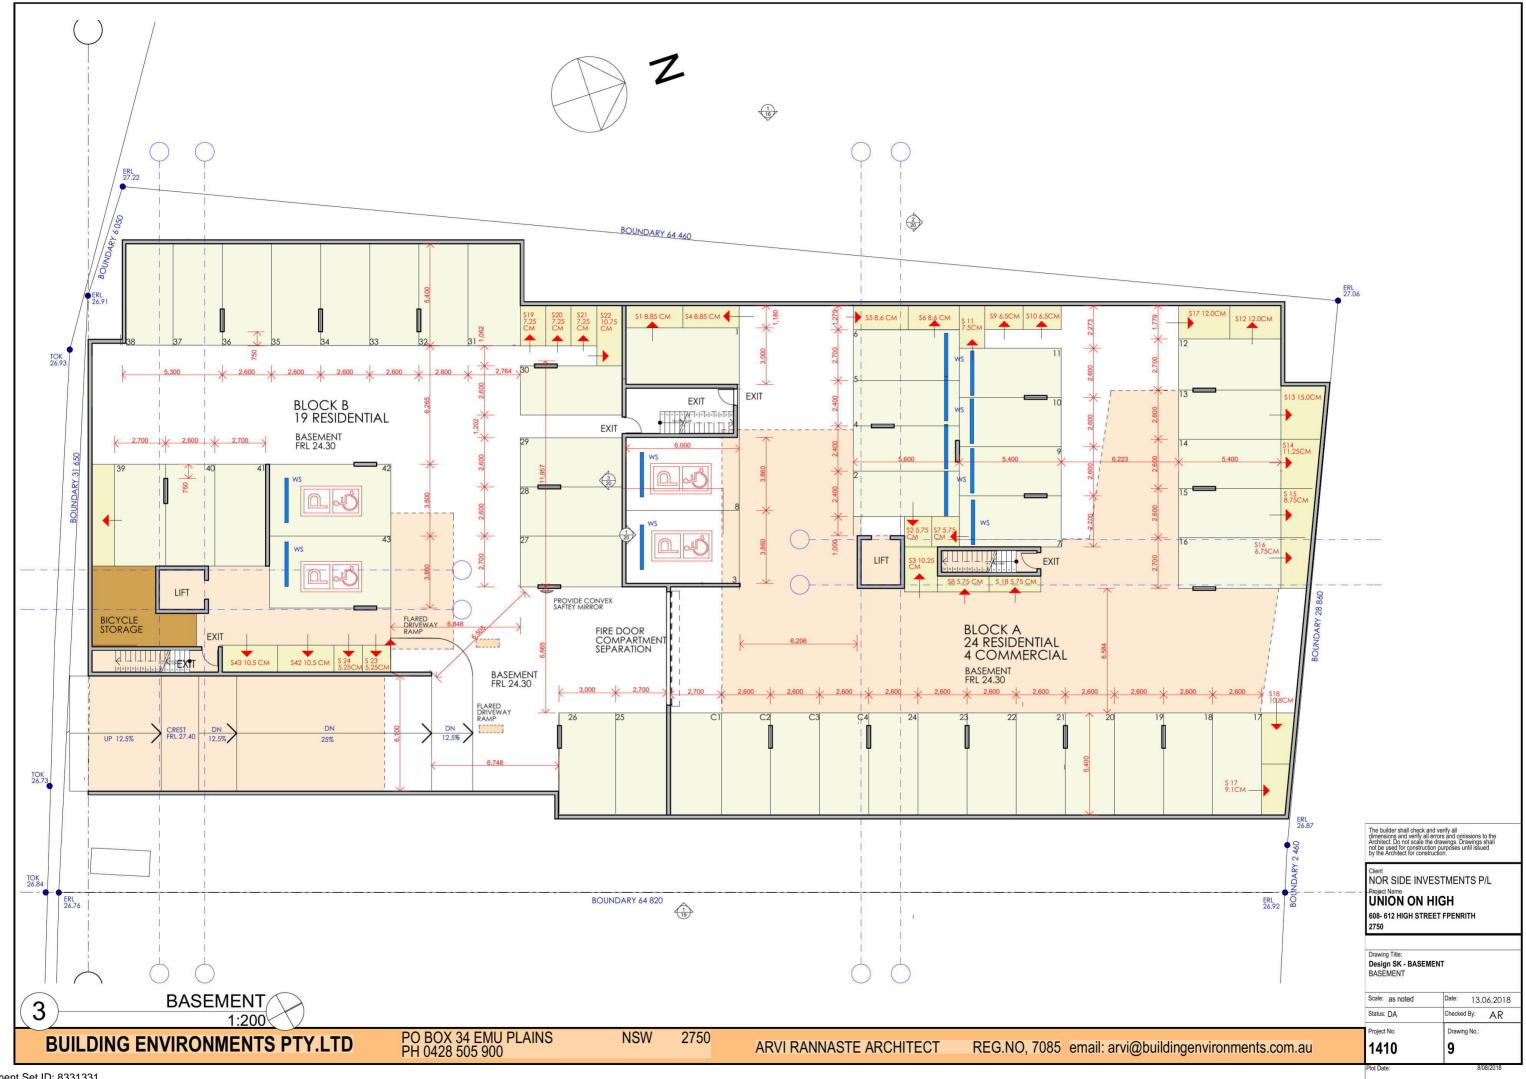

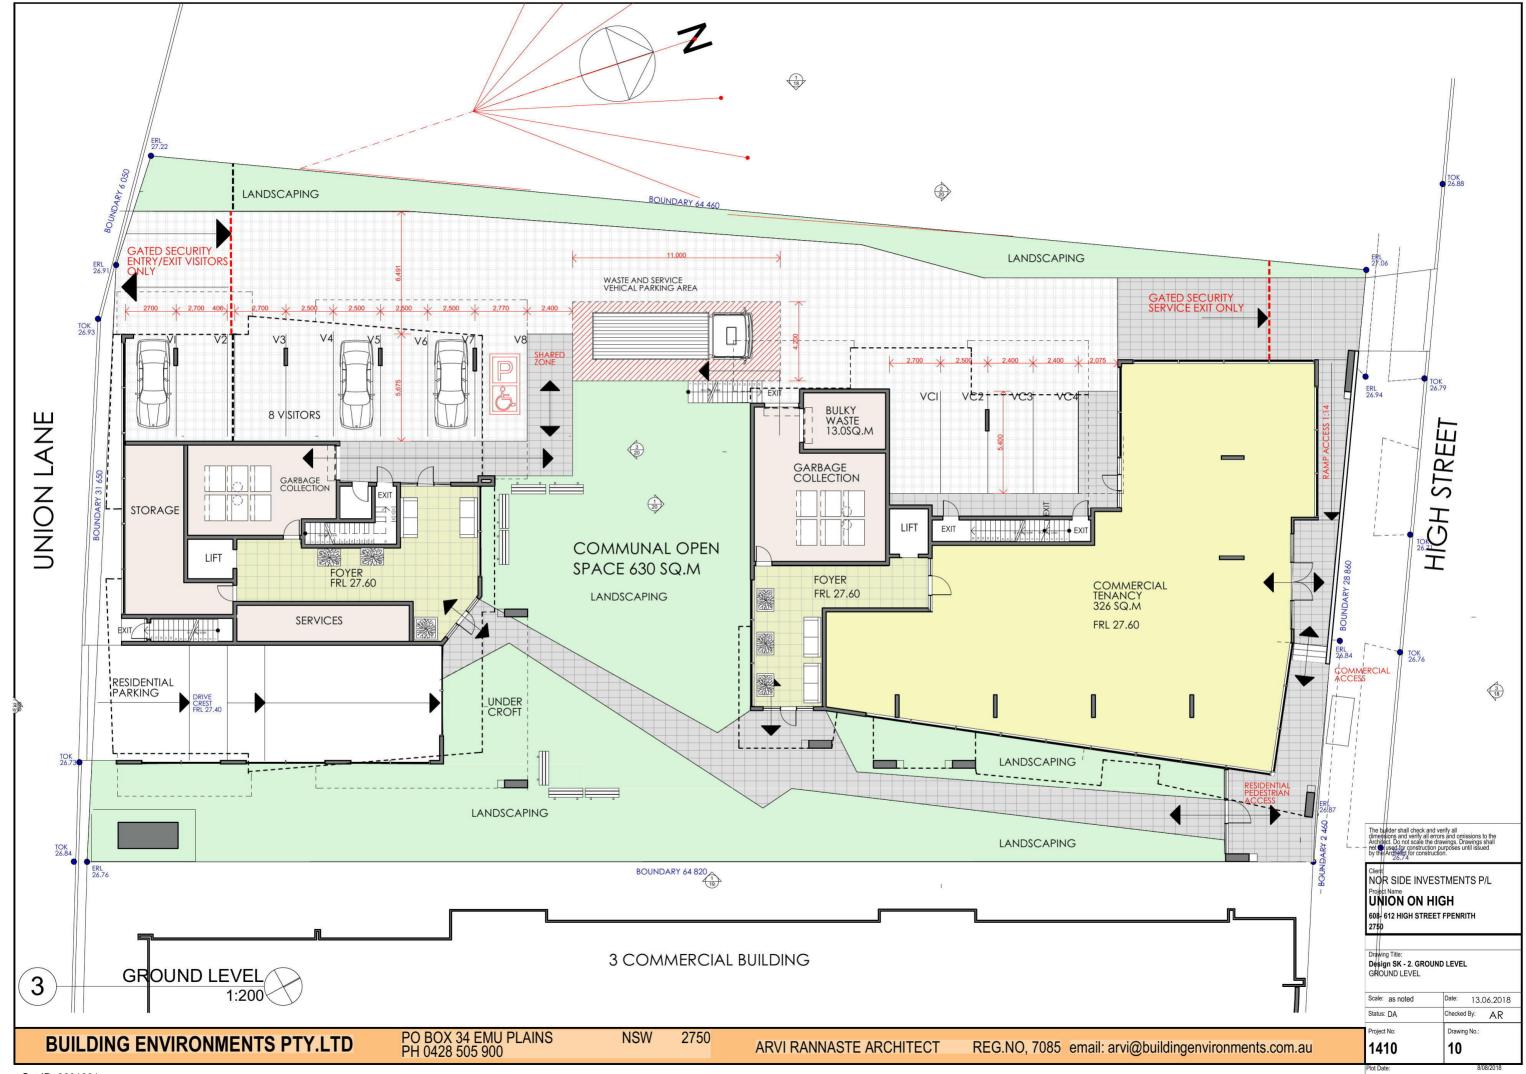

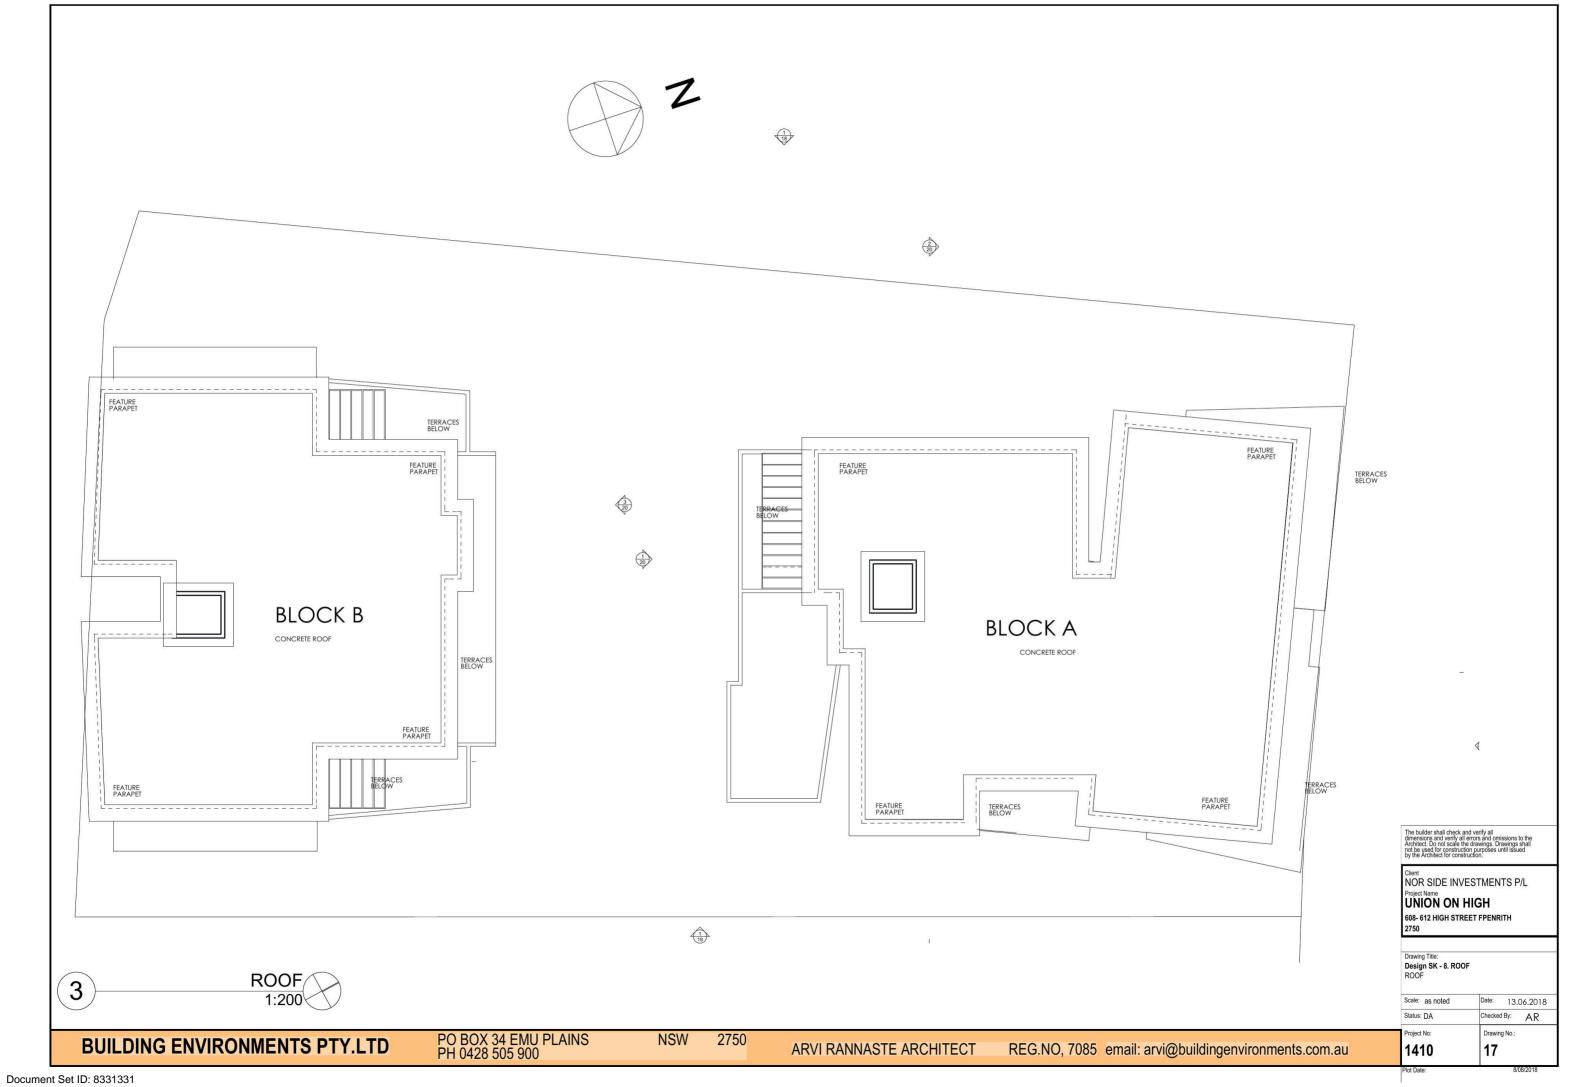





#46.040
ROOF
#40.330
IEVEL 5
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The builder shall check and verify all dimensions and verify all errors and omissions to Architect. Do not scale the drawings. Drawings sir not be used for construction purposes until issued by the Architect for construction.

NOR SIDE INVESTMENTS P/L
Project Name

UNION ON HIGH 608- 612 HIGH STREET FPENRITH

Drawing Title:
Design SK - E4 SOUTH ELEVATION
SOUTH ELEVATION, EAST ELEVATION

 Scale:
 as noted
 Date:
 13.06.2018

 Status:
 DA
 Checked By:
 AR

 Project No:
 Drawing No.:

 1410
 19


BUILDING ENVIRONMENTS PTY.LTD

SOUTH ELEVATION

PO BOX 34 EMU PLAINS PH 0428 505 900 NSW 2750

ARVI RANNASTE ARCHITECT

REG.NO, 7085 email: arvi@buildingenvironments.com.au

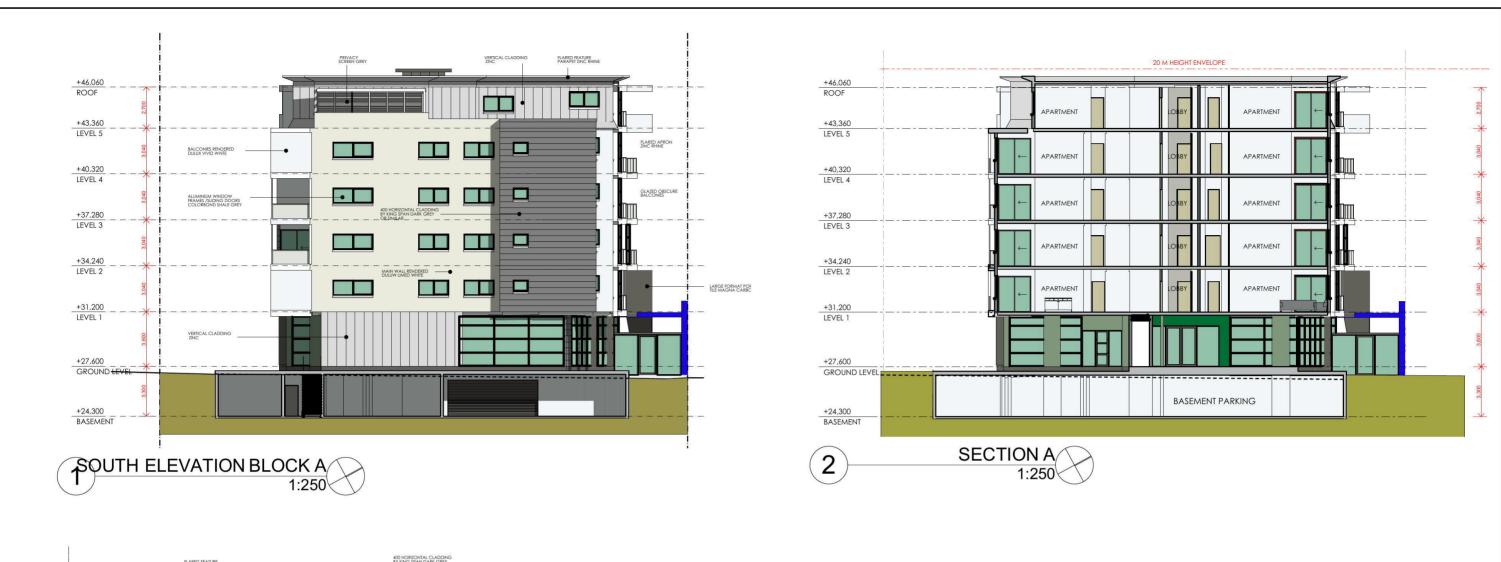



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Design SK - E5 SOUTH ELEVATION BLOCK A SOUTH ELEVATION BLOCK A, NORTH

ELEVATION BLOCK B, SECTION A


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3 ORTH ELEVATION BLOCK B

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Drawing Title: Design SK - 9. 9.0 AM 9am Scale: as noted Date: 13.06.2018


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608- 612 HIGH STREET FPENRITH 2750

Drawing Title:

Design SK - 10. 10.0 AM

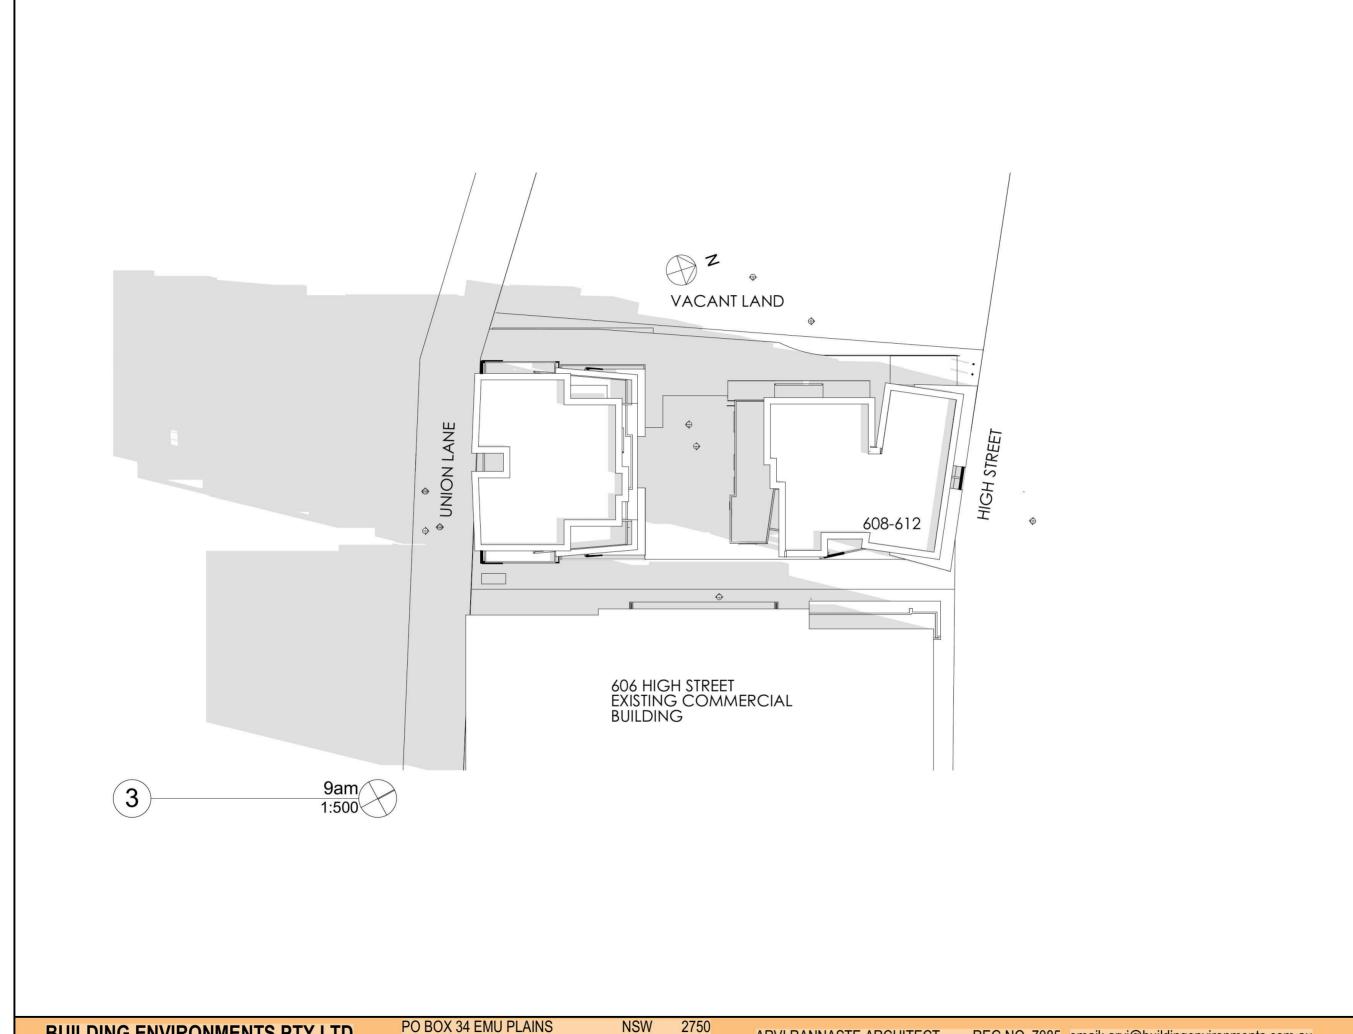10am

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 as noted
 Date:
 13.06.2018
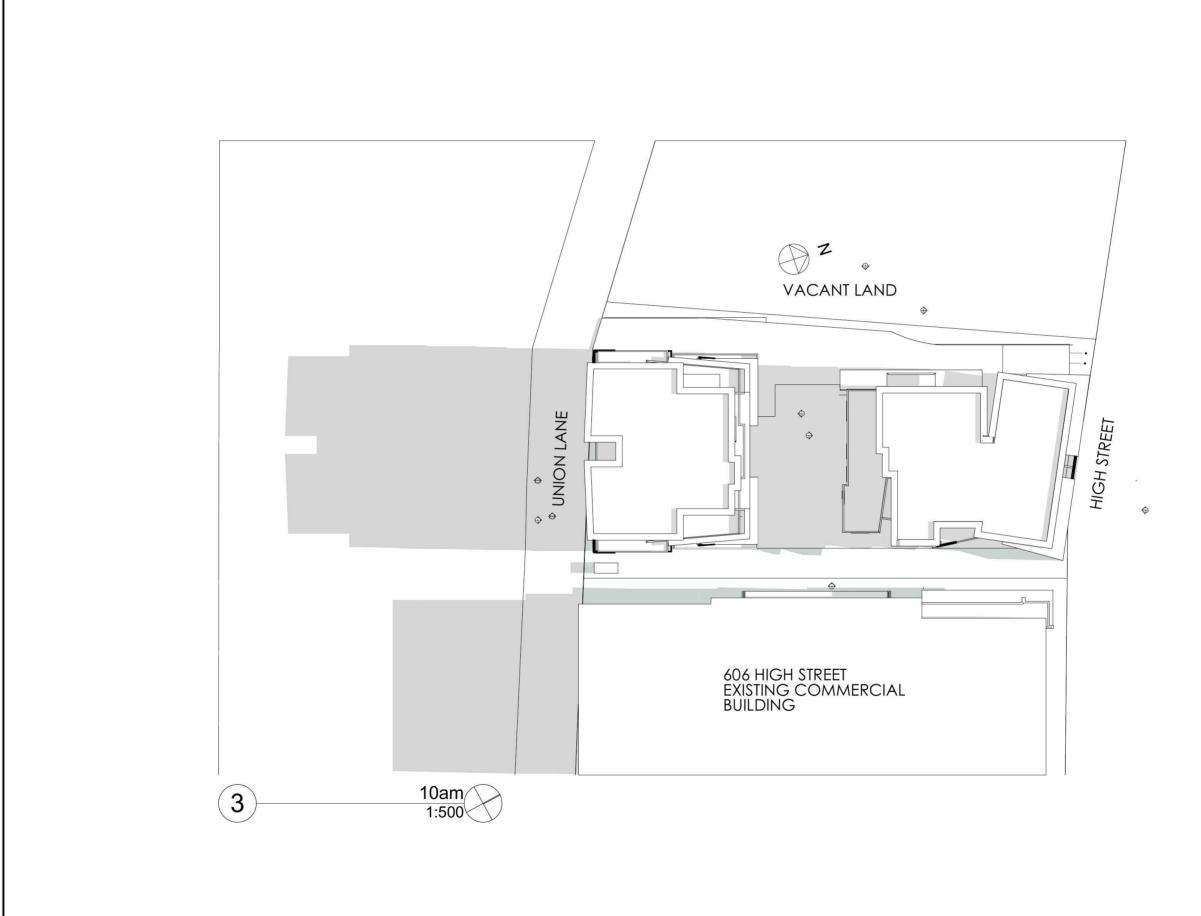
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 Project No:
 Drawing No.:

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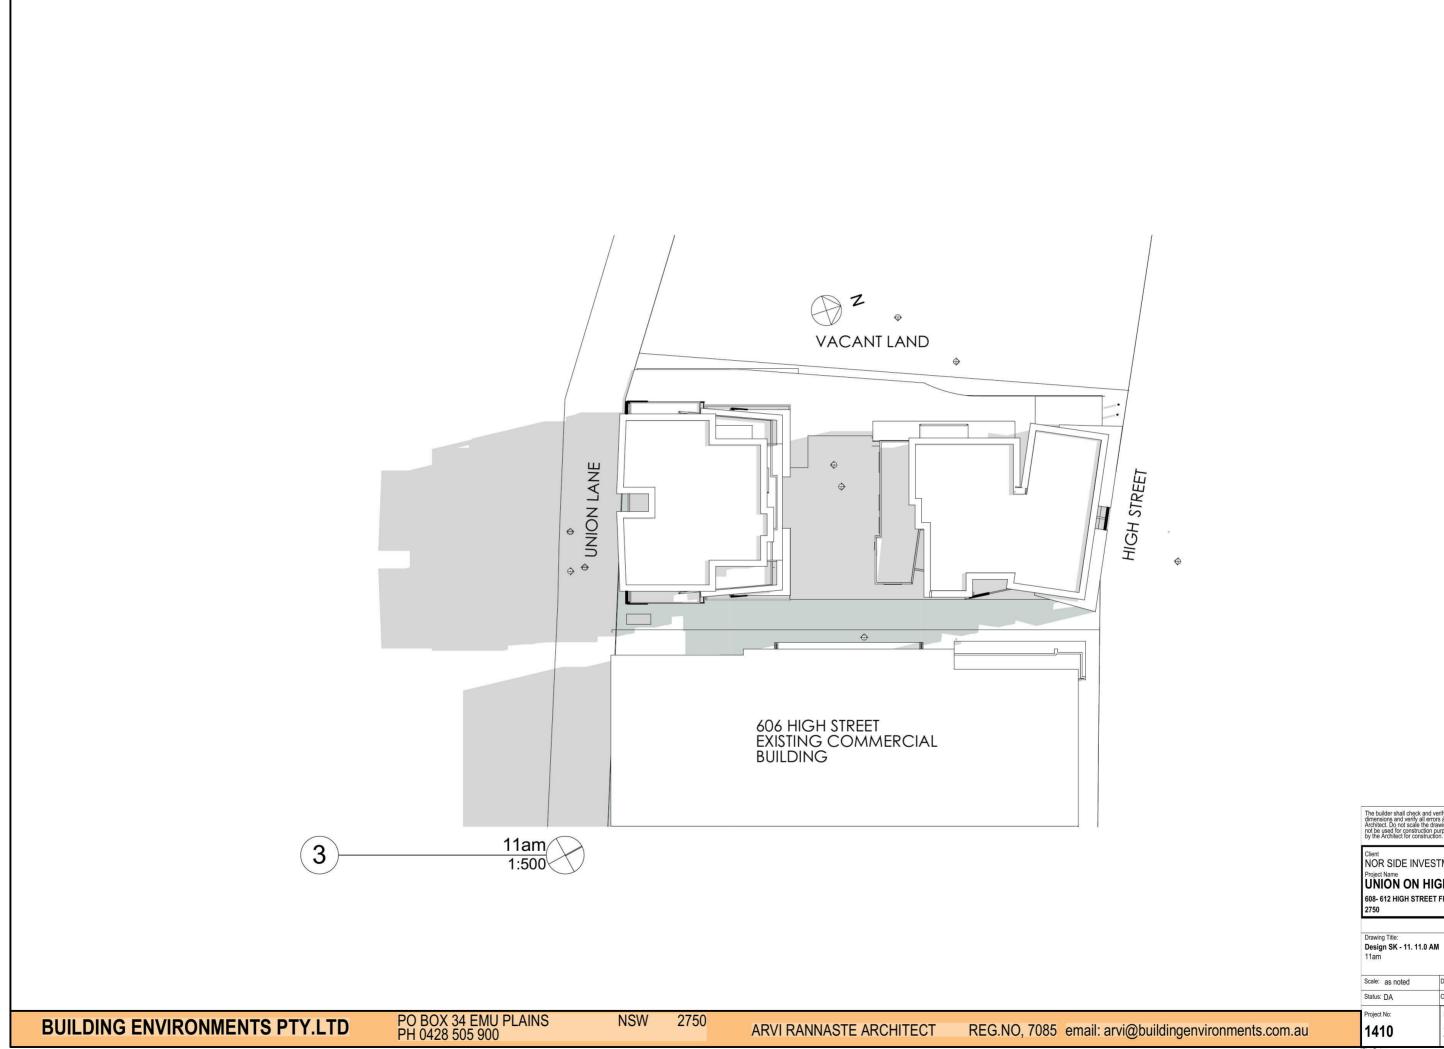
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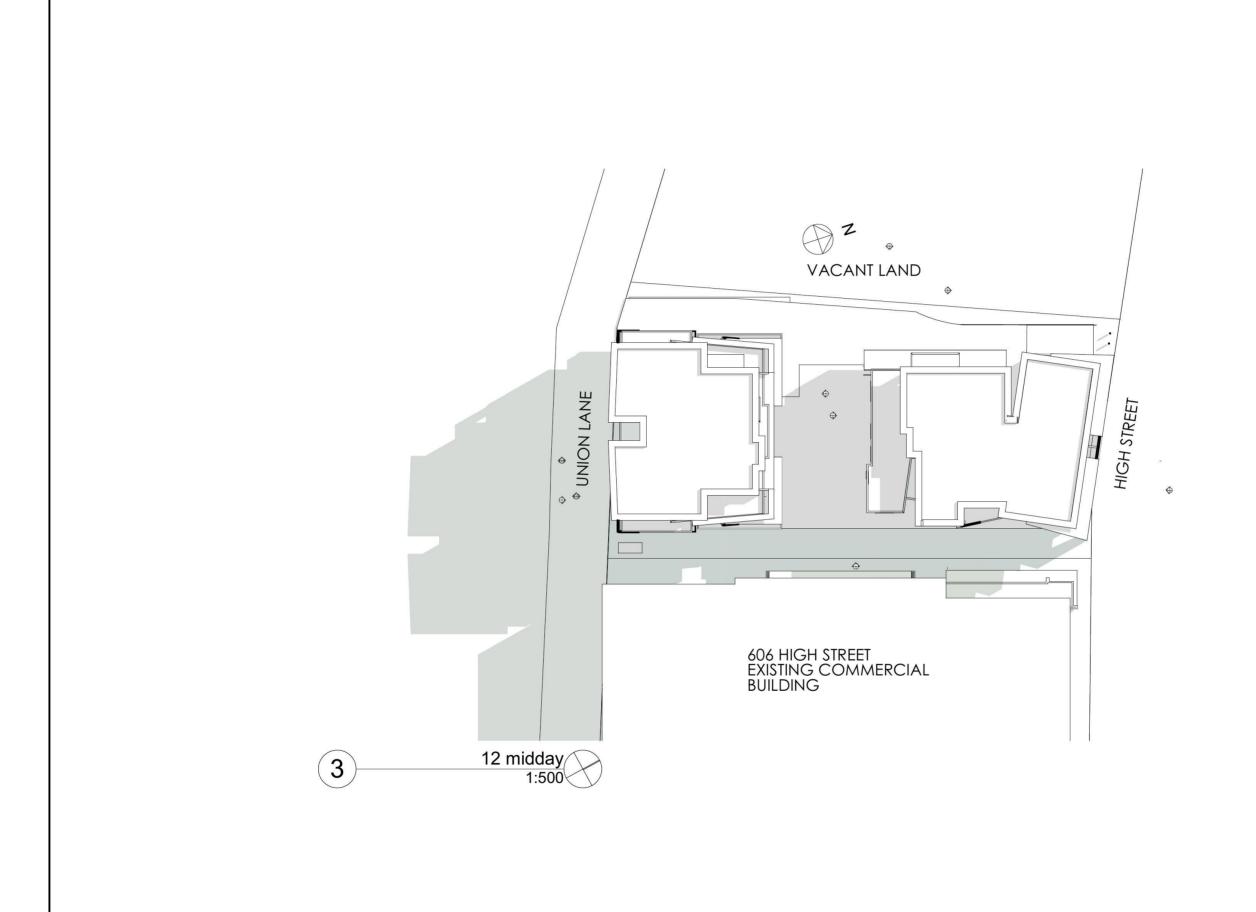
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Project Name
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608- 612 HIGH STREET FPENRITH 2750

Drawing Title:

Design SK - 12. 12.0 MIDDAY
12 midday

Scale: as noted

Date: 13.06.2018

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 Status: DA
 Checked By:
 AR


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 Drawing No.:

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Drawing Title:
Design SK - 1.0 PM
1.00PM

Scale: as noted Date: 13.06.2018 Checked By: AR

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NSW 2750


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Document Set ID: 8331331

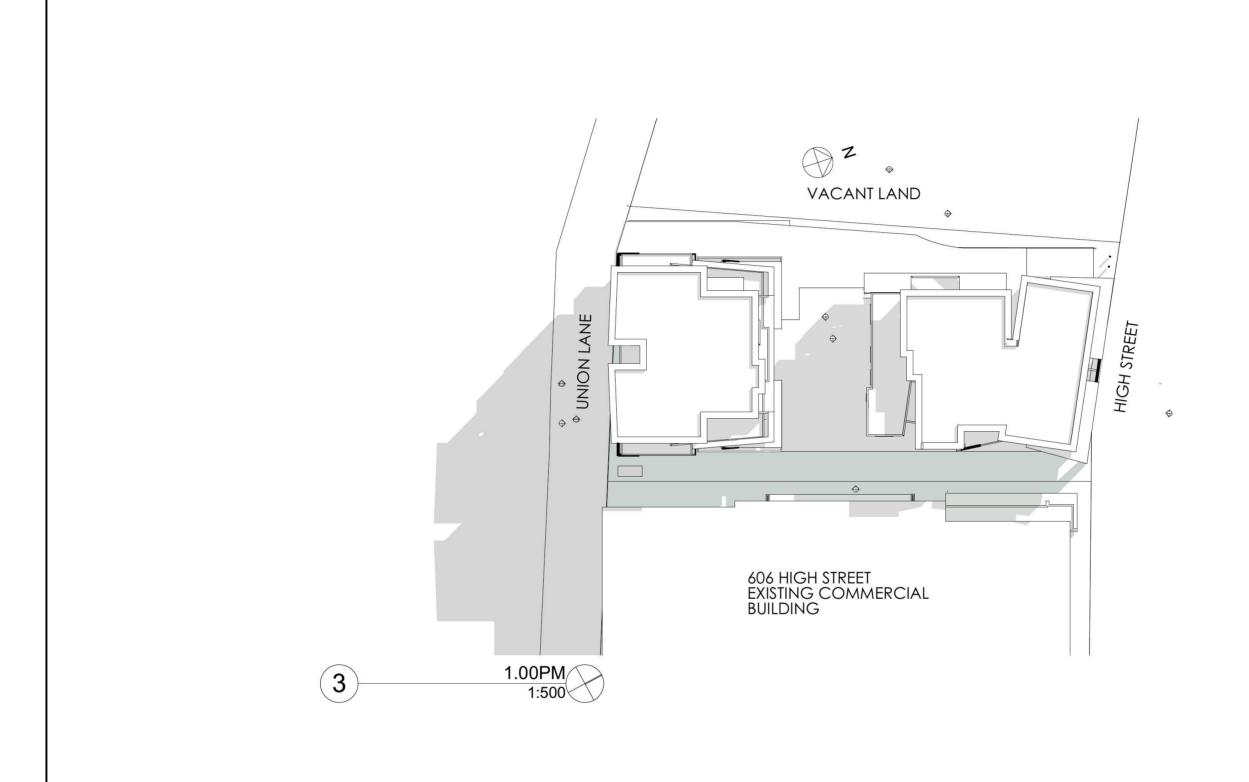Version: 1, Version Date: 09/08/2018



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Client
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Project Name

Project Name
UNION ON HIGH
608- 612 HIGH STREET EPE

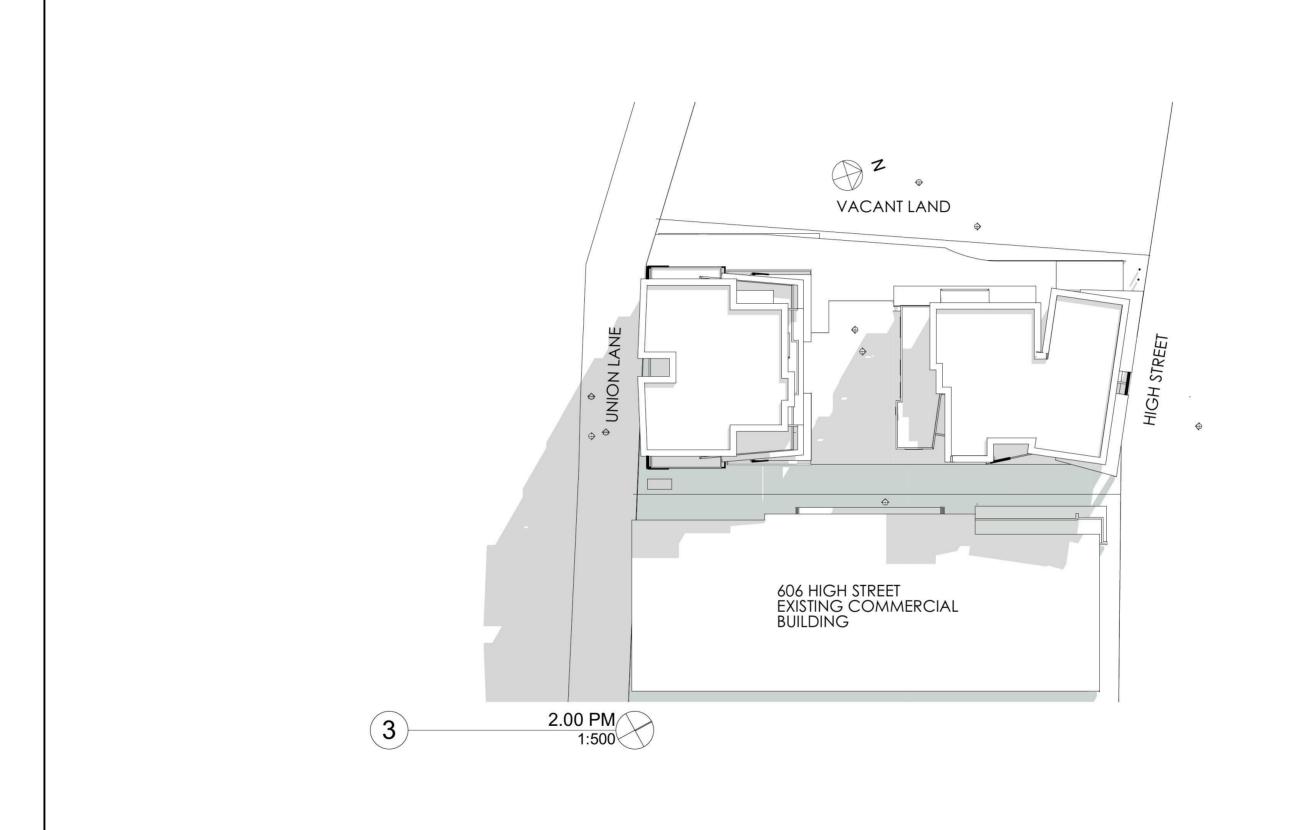608- 612 HIGH STREET FPENRITH 2750

Drawing Title:
Design SK - 14. 2.0 PM
2.00 PM


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Project Name
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Drawing Title:
Design SK - 15. 3.0 PM
3.00 PM

Scale: as noted Date: 13.06.2018 27 1410

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HIGH STREET N



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Project Name
UNION ON HIGH

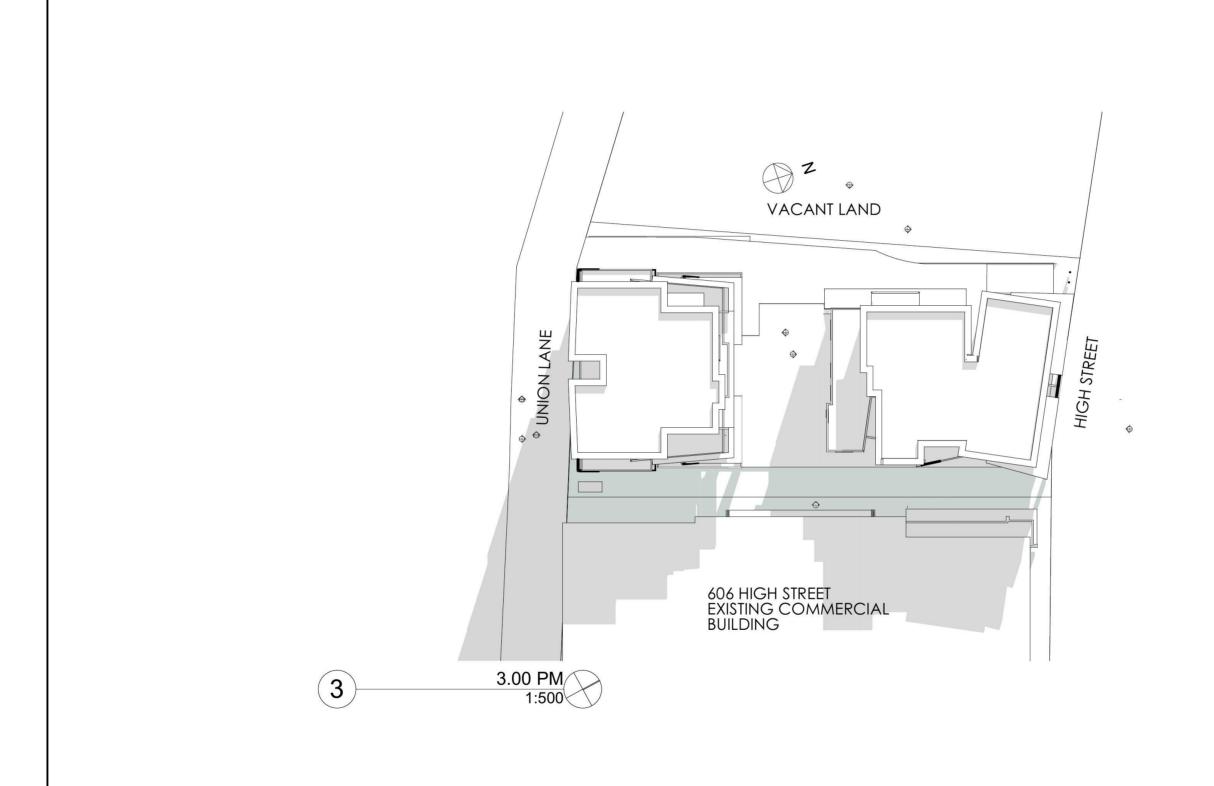608- 612 HIGH STREET FPENRITH

Drawing Title:

Design SK - 3D VIEWS

VIEW A, VIEW C, HIGH STREET N, HIGH STREET

Date: 13.06.2018

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UNION ON HIGH

608- 612 HIGH STREET FPENRITH

Drawing Title:
Design SK - 3D VIEWS
VIEW E, VIEW F, WESTVIEW FROM UNION

LANE, UNION LANE

Date: 13.06.2018 1410

Document Set ID: 8331331

Version: 1, Version Date: 09/08/2018

