# **RESIDENTIAL DEVELOPMENT** 36-38 RODLEY AVENUE, PENRITH STORMWATER CONCEPT DESIGN





### PREPARED BY:

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Document Set ID: 8369398 Version: 1, Version Date: 05/09/2018 LOCALITY PLAN NOT TO SCALE COPYRIGHT OF SIX MAPS

### **ARCHITECT:**



NOMINATED ARCHITECT - P F MORSON REGISTRATION NUMBER 8100 ACN 159 480 056, ABN 41 159 480 056 www.morsongroup.com (02) 9380 4946 PO Box 170, Potts Point, NSW 1335

## INGLOW INVESTMENT TWO PTY LTD

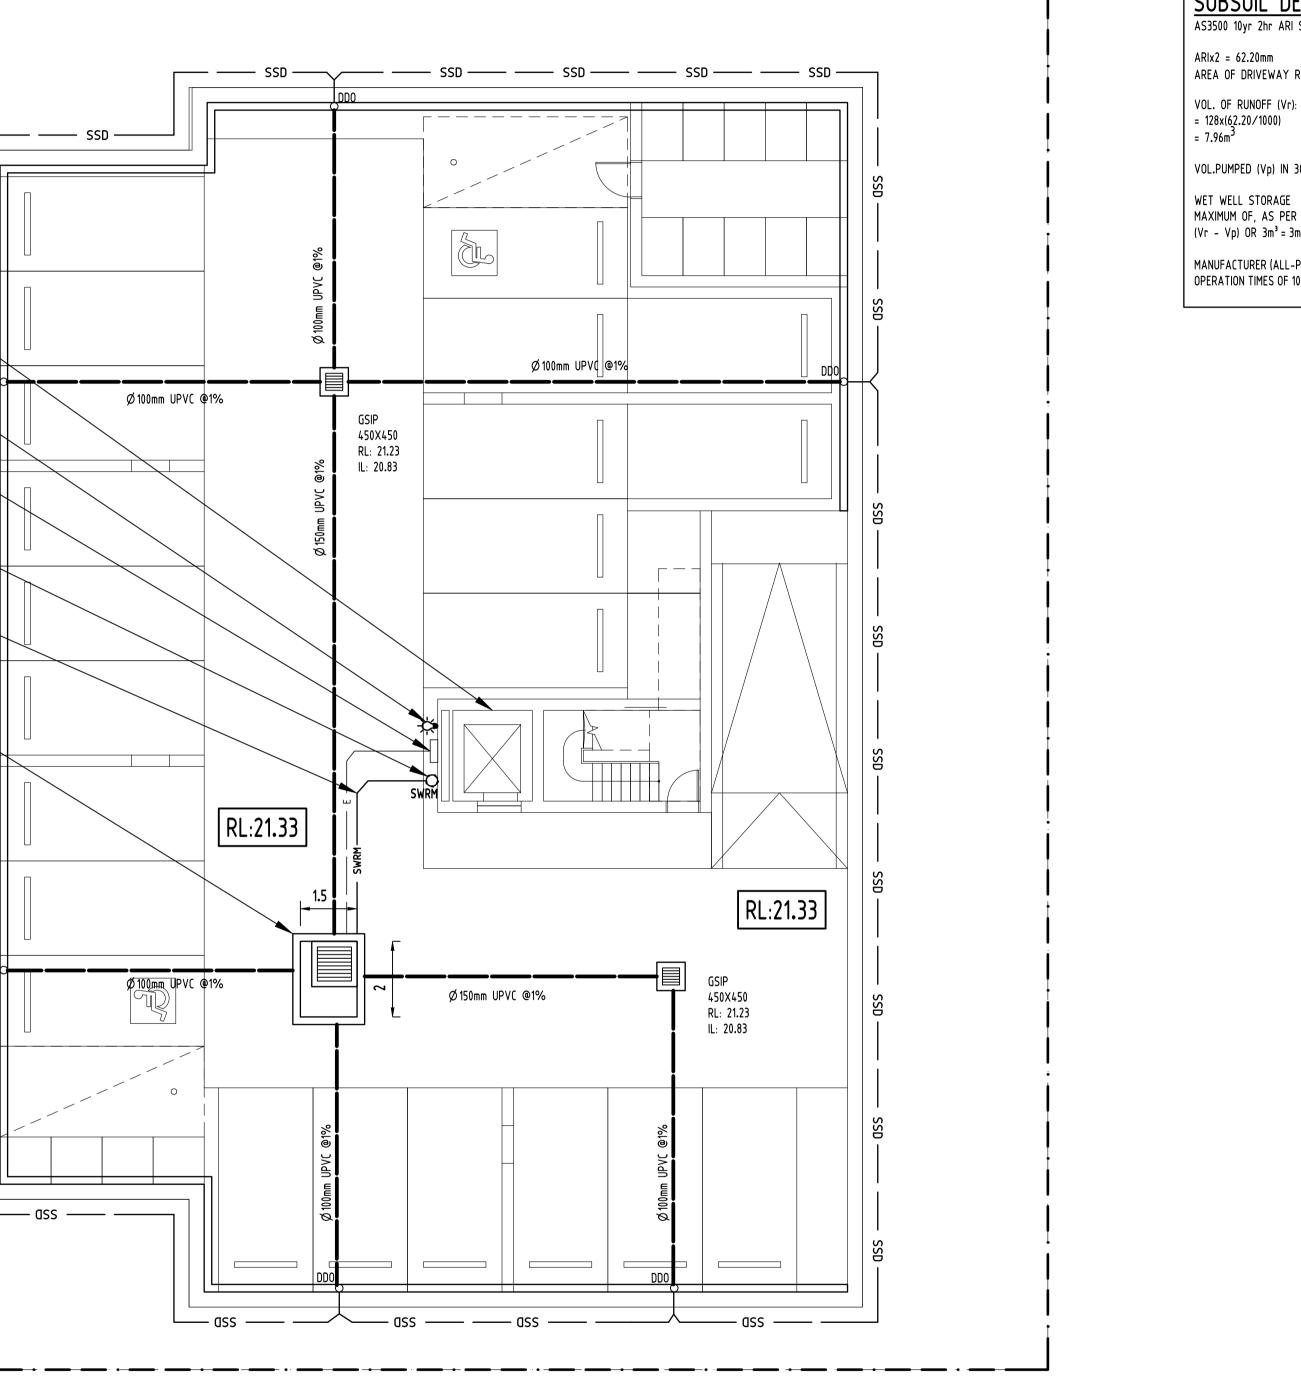
### CLIENT:

		DRAWINGS LIST	
SHEET No.	DWG No.	TITLE	REV
1	SW100	COVER SHEET	A
2	SW200	STORMWATER CONCEPT DESIGN - BASEMENT PLAN	A
3	SW201	STORMWATER CONCEPT DESIGN - GROUND FLOOR PLAN	A
4	SW202	STORMWATER CONCEPT DESIGN - ROOF PLAN	A
5	SW300	STORMWATER CONCEPT DESIGN - DETAILS SHEET	A
6	SW400	EROSION AND SEDIMENT CONTROL - PLAN AND DETAILS	A
7	SW500	STORMWATER CONCEPT DESIGN - MUSIC CATCHMENT PLAN	A

Drawing Number: SW100 Revision Number: Þ

LIFT TO BE TANKED BY OTHERS	_		
		- SSD -	
INSTALL WARNING FLASH LIGHT TO PROVIDE	$\sim$		
PUMPOUT PIT CONTROL BOX TO MANUFACTURERS-			
SPECIFICATIONS. LOCATIONS TO BE CONFIRMED WITH ARCHITECT.			
STORMWATER RISING MAIN	_		
		SSD -	
Ø80 mm CLASS 12 UPVC			
SUBSOIL PUMP OUT PIT COMPLETE WITH 2x		ssD	
10.0m HEAD VOLUME REQUIRED: 3m³			
VOLUME PROVIDED: 3.6m³ INTERNAL AREA: 3m²			
HEIGHT:1.2m RL:21.23			
TWL:20.93 IL:19.73		SSD	
OUTLINE OF BOUNDARY	$\neg$		``
		- SSD -	
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					Reference	Coordination Drawing		-	ENGINEERS		QUALITY CONTROL	WARNING: THE DESIGN COPYRIGHT HEREIN RE OF S&G CONSULTANT
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					ARCH ARCH							PTY LTD
									dimensions not shown to be checked on site. Do not scale of this drawing, positions of	CHECKED	DATE	
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CAD	4-tender 5-construction 6-ot	ner			SURVEY							



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### SUBSOIL DESIGN CALCS: AS3500 10yr 2hr ARI STORM= 31.10 mm/hr

AREA OF DRIVEWAY RAMP UNCOVERED =  $128m^2$ 

VOL.PUMPED (Vp) IN 30min@10L/S = 18m3

WET WELL STORAGE MAXIMUM OF, AS PER AS3500: (Vr - Vp) OR  $3m^3 = 3m3$ 

MANUFACTURER (ALL-PUMPS) RECOMMENDS MAX. OPERATION TIMES OF 10/HR

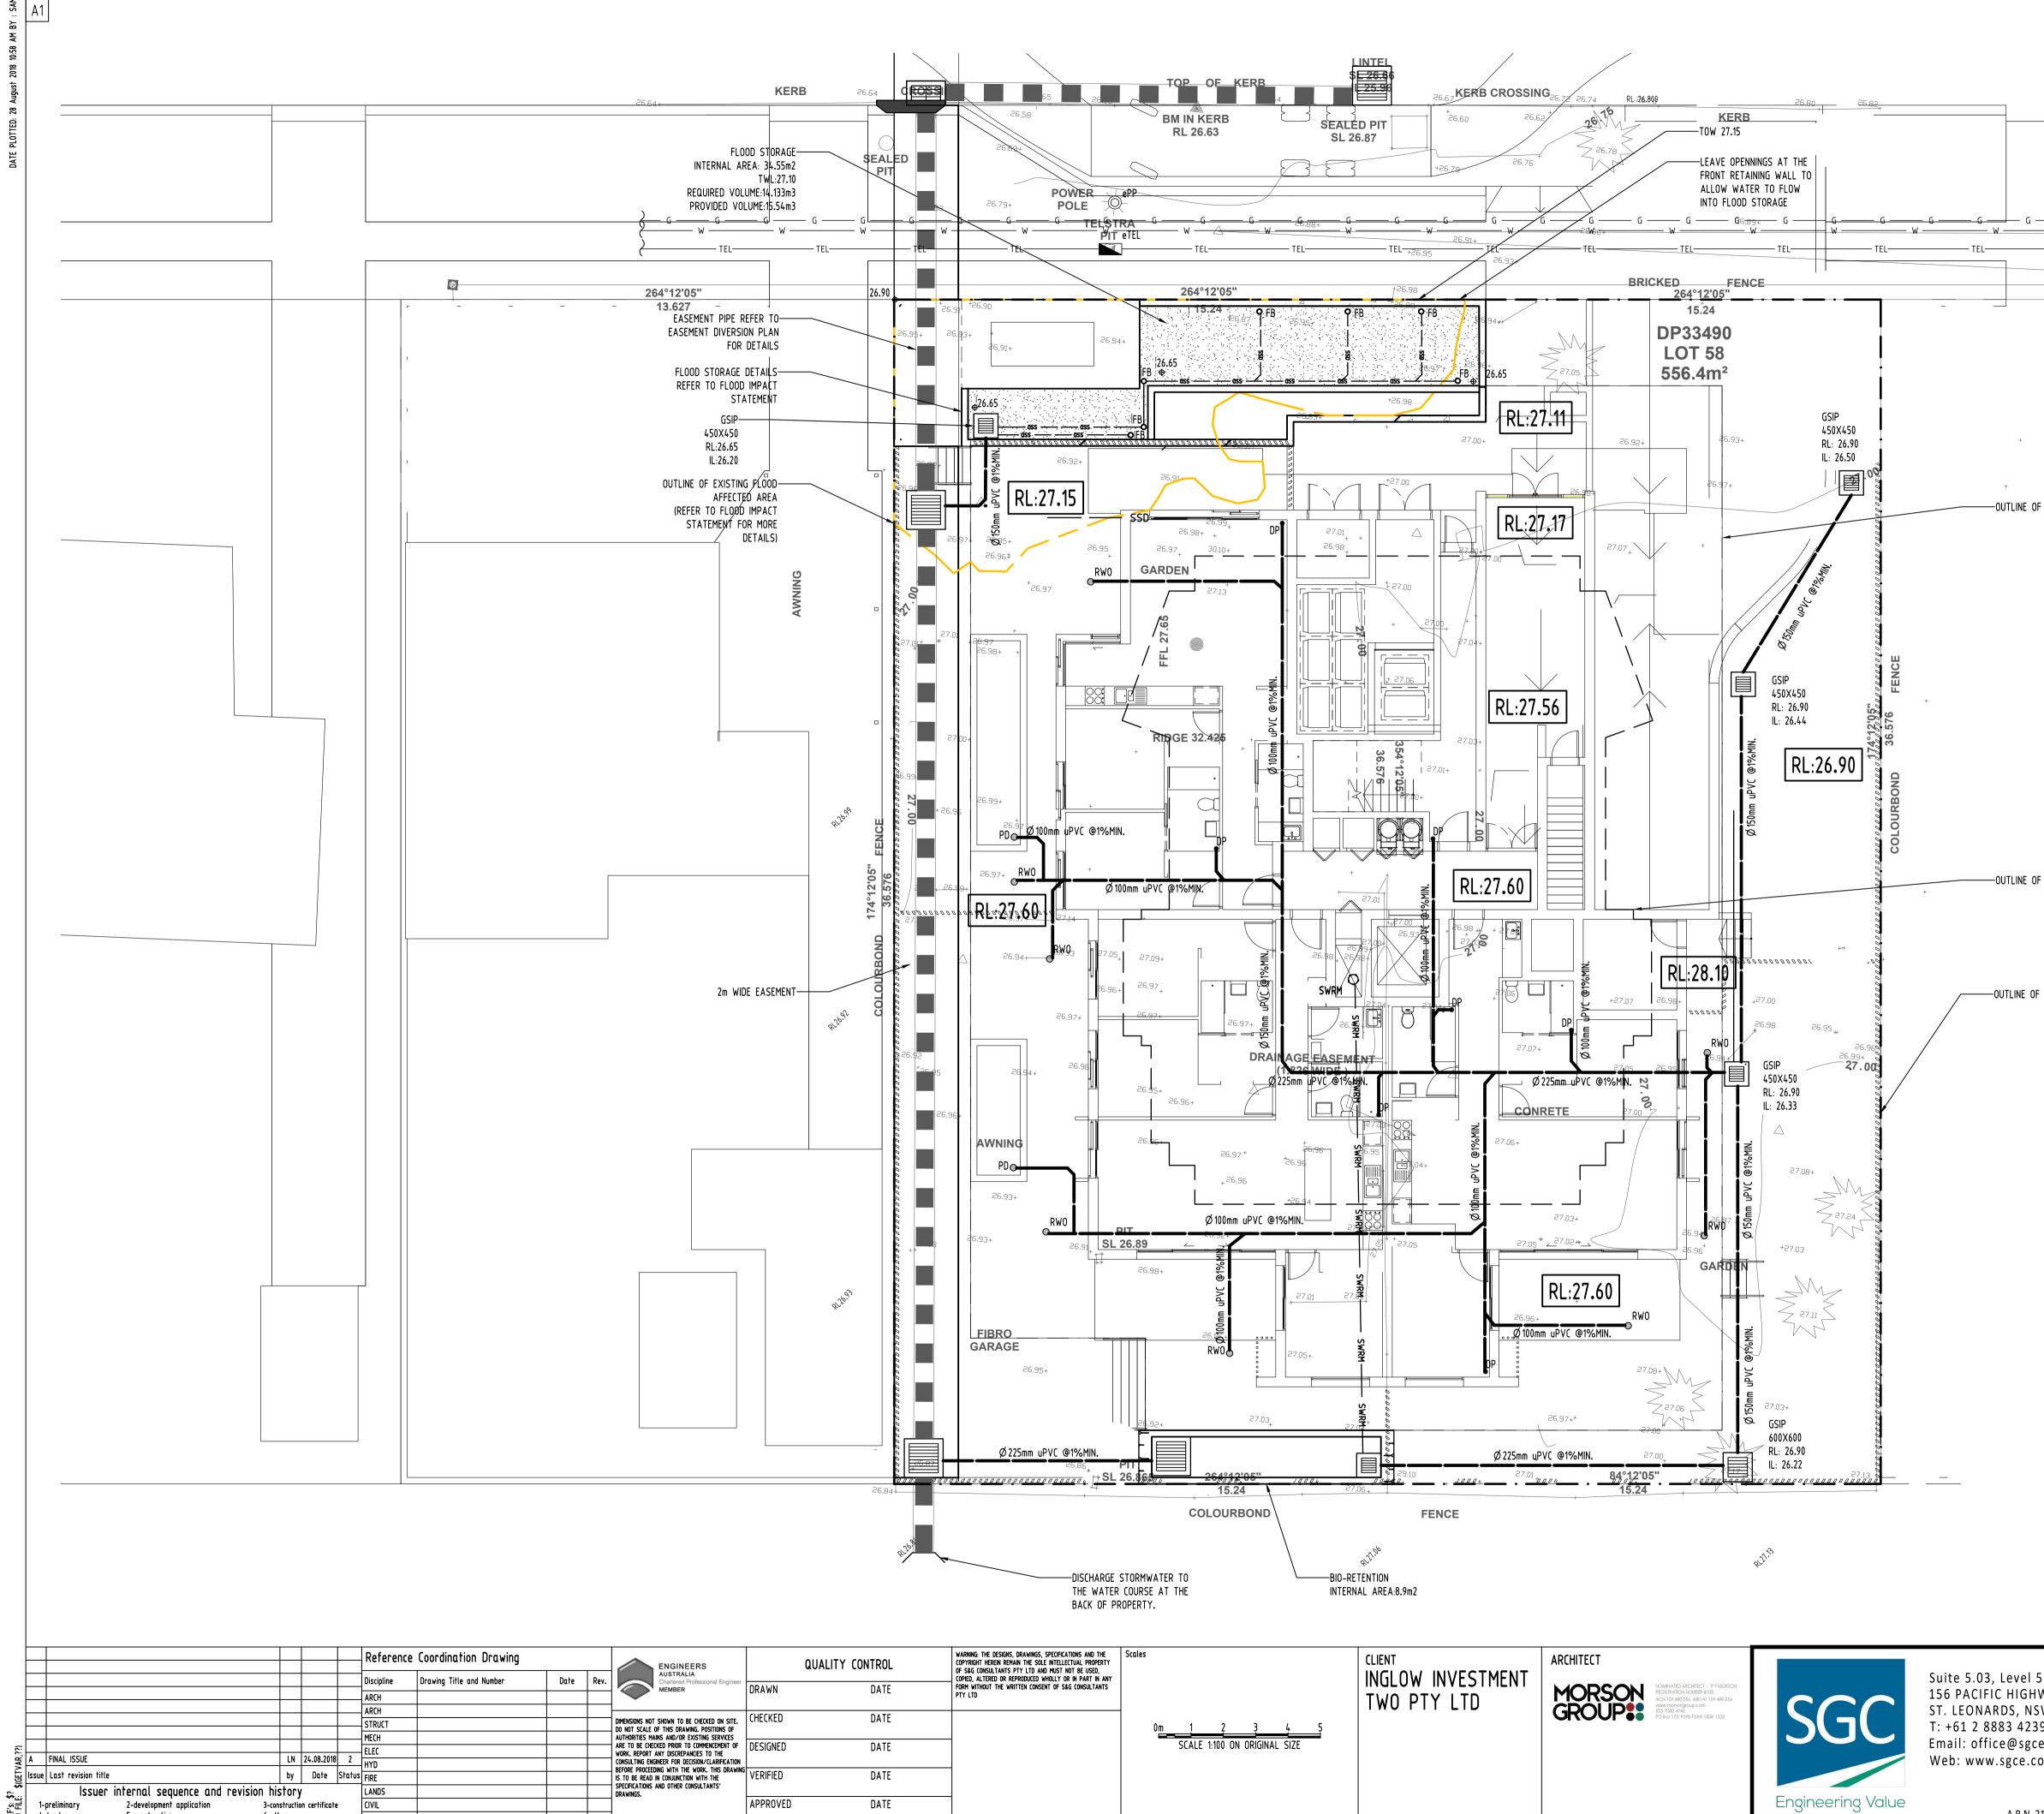
### <u>NOTES</u>

BASEMENT DRAINAGE DESIGN SUBJECT TO GEOTECHNICAL INVESTIGATION AND STRUCTURAL DESIGN OF WALLS AND SLABS IN CC STAGE.

ALL SUBSOIL DRAINAGE (SSD) TO BE 100AG AND ALL DISH DRAIN OUTLETS (DDO) TO BE  $ot\! {\oslash} 100 \, \text{mm}$ U.N.0



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1-preliminary

4-tender

<u>88</u>

2-development application

5-construction

3-construction certificate

SURVEY

6-other

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	15.24		

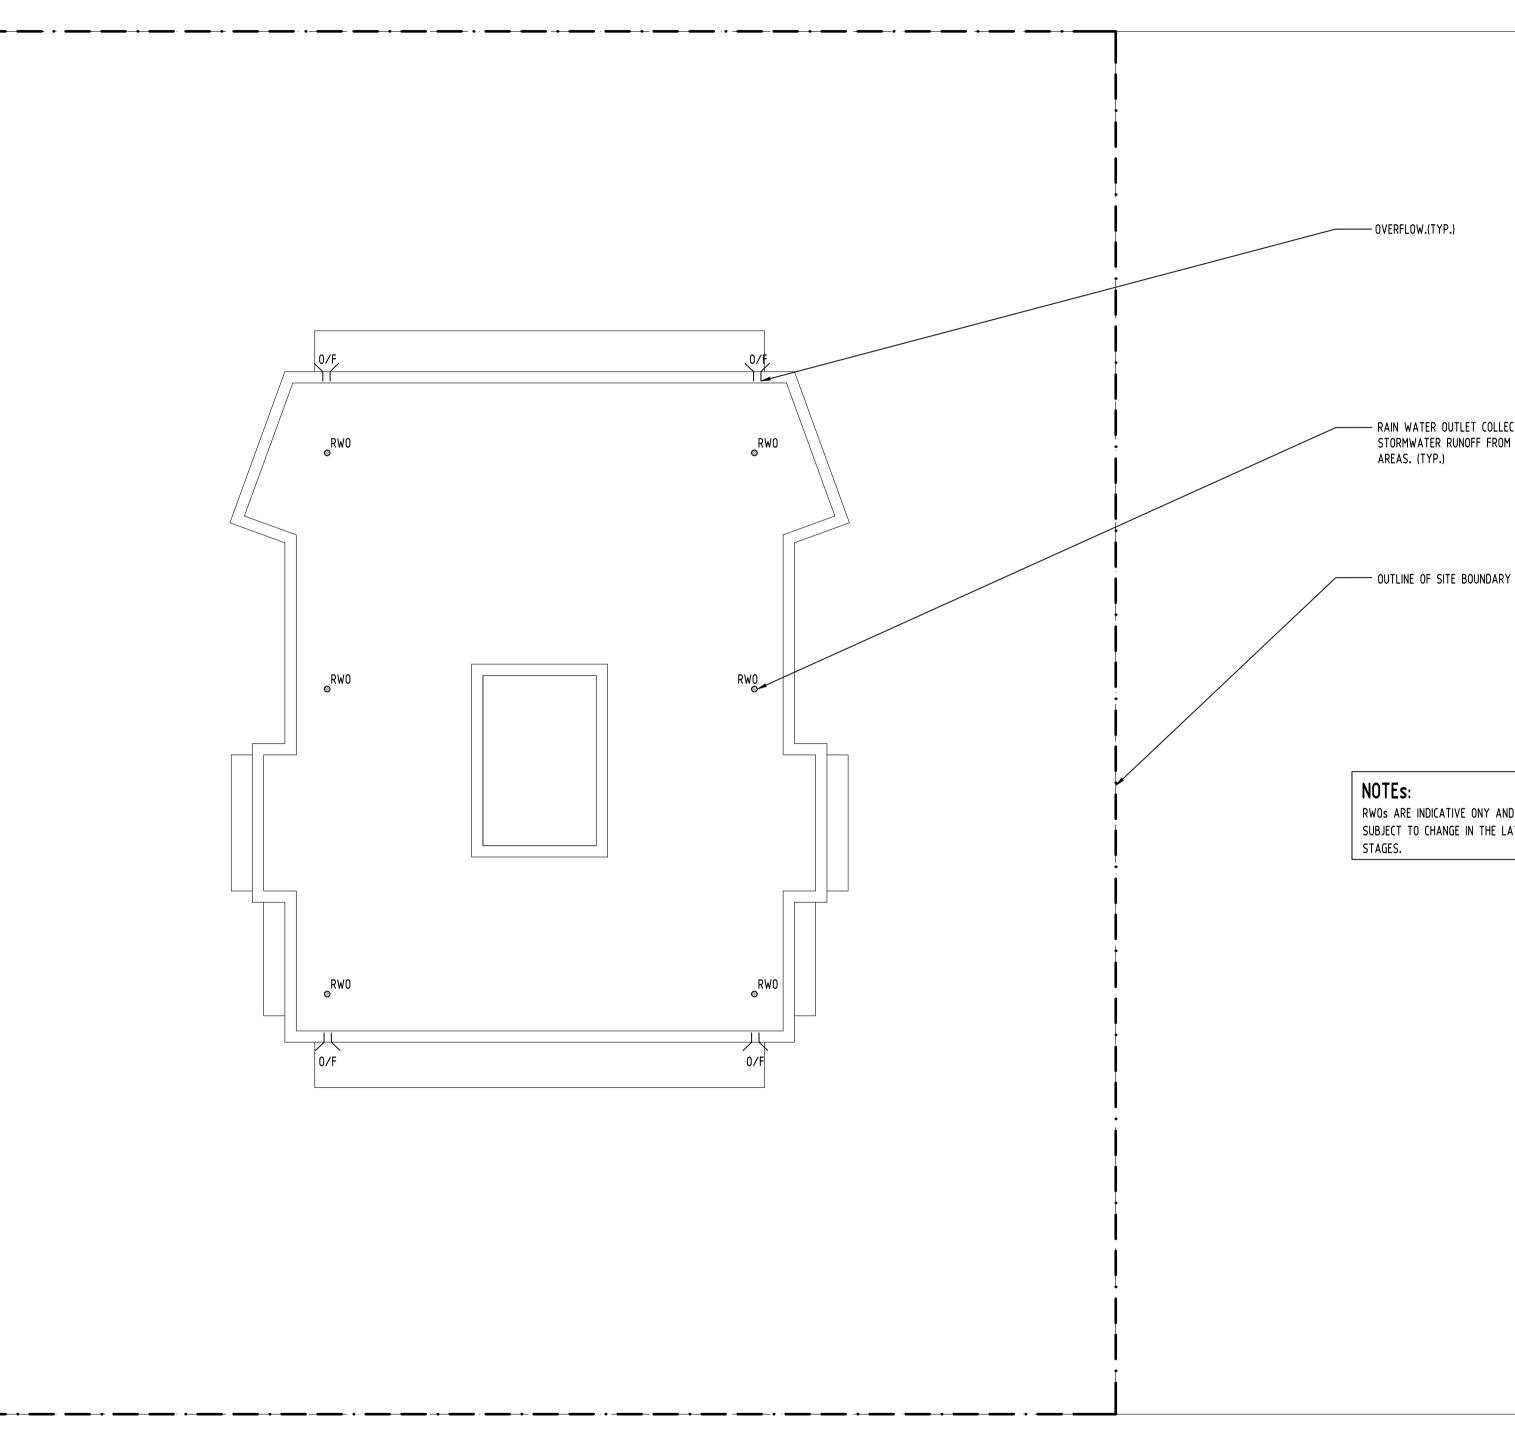
-OUTLINE OF ROOF ABOVE

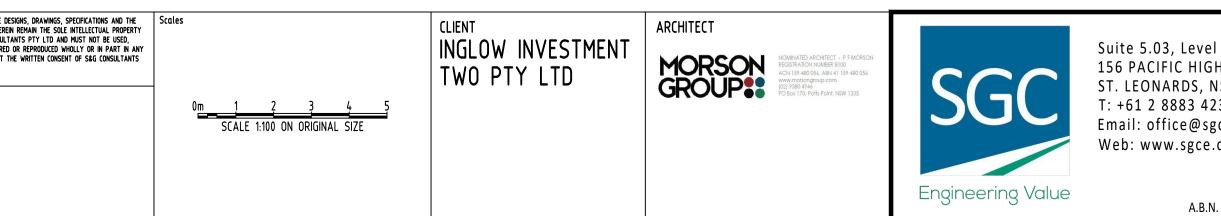


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# RODLEY AVENUE



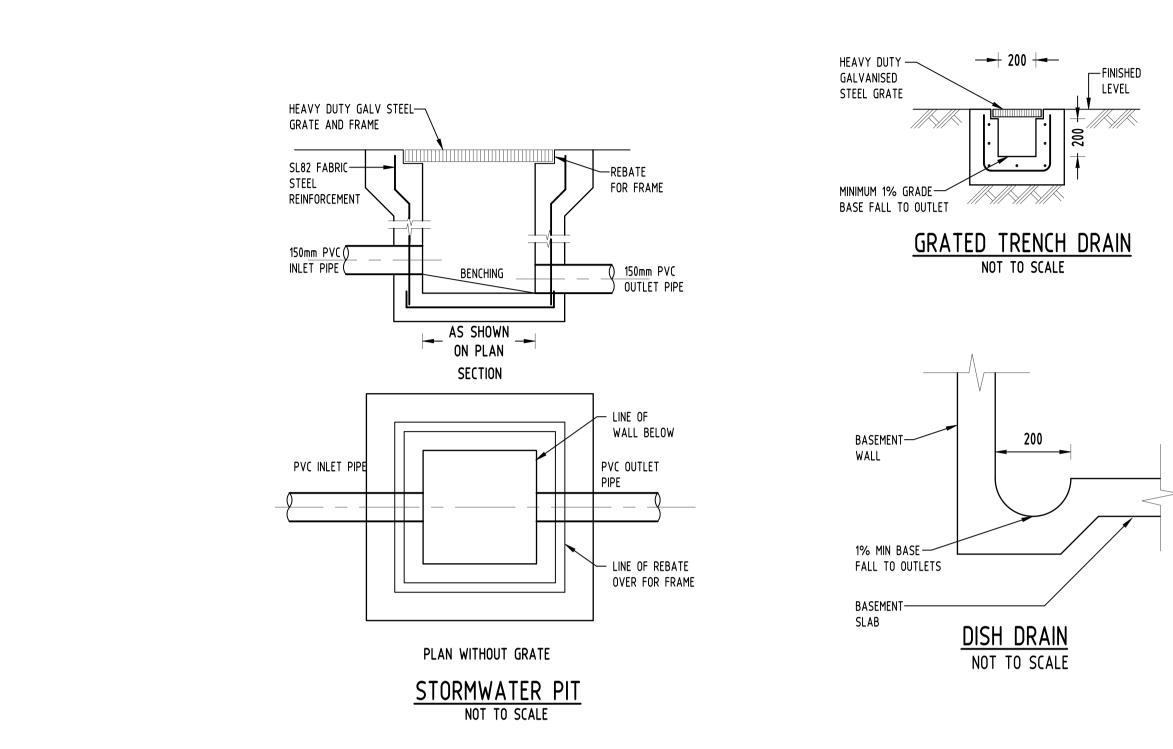


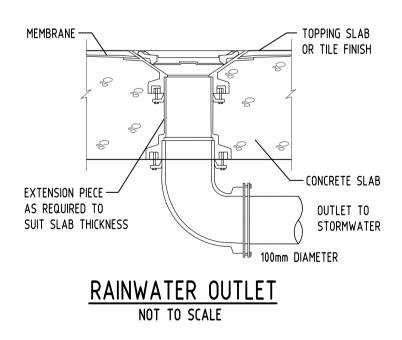
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RWOS ARE INDICATIVE ONY AND SUBJECT TO CHANGE IN THE LATER

RAIN WATER OUTLET COLLECTING STORMWATER RUNOFF FROM ROOF AREAS. (TYP.)

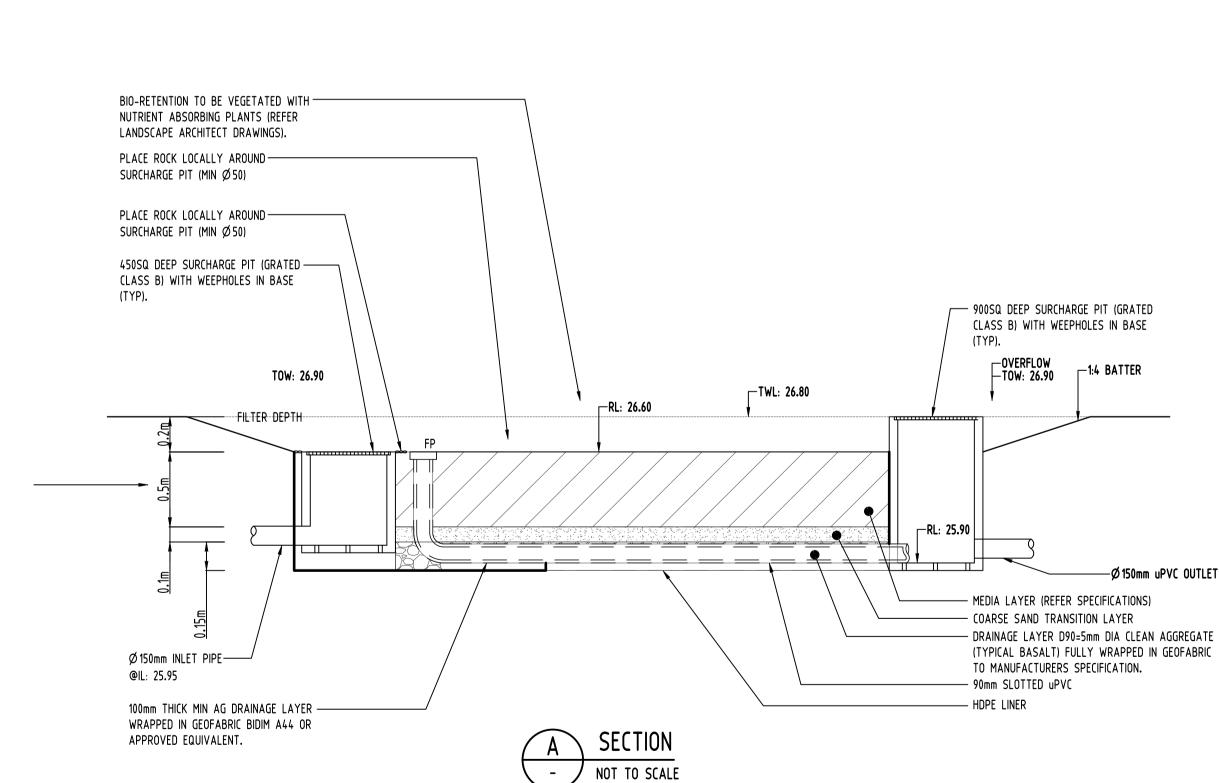


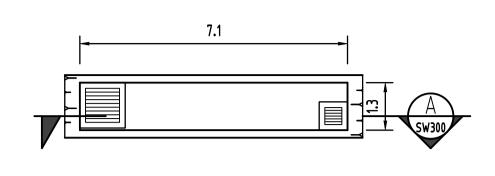




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	Status FIRE LANDS			DIMENSIONS NOT SHOWN TO BE CHECKED ON SITE. DO NOT SCALE OF THIS DRAWING. POSITIONS OF AUTHORITIES MAINS AND/OR EXISTING SERVICES ARE TO BE CHECKED PRIOR TO COMMENCEMENT OF WORK. REPORT ANY DISCREPANCIES TO THE CONSULTING ENGINEER FOR DECISION/CLARIFICATION BEFORE PROCEEDING WITH THE WORK. THIS DRAWIN IS TO BE READ IN CONJUNCTION WITH THE SPECIFICATIONS AND OTHER CONSULTANTS' DRAWINGS.	DESIGNED	DATE		0 <u>m 1 2 3 4 5</u> SCALE 1:100 ON ORIGINAL SIZE		PO Box 1/0, Potts Point, NW 1335	SGC Engineering Value	T: +61 2 8883 4239 Email: office@sgce. Web: www.sgce.con A.B.N. 211

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**BIO-RETENTION PLAN** 

TWO LAYERS OF COUNCIL-----APPROVED FILTER FABRICTURN

AUSTRALIAN DRAINAGE ——\_\_

UP SIDES 300mm MIN.

MODULES (OR EQUAL)

WITH GEOFABRIC LAID

OVER & DRAIN LAID ON

THE BASE OF PLANTER

BOX ON BENCHING WITH

WATERPROOF MEMBRANE

REFER TO ARCHITECTS

DRAWINGS FOR DETAILS

CONCRETE BENCHING-

SPS BD50/65 CAST IRON ROOF-----

DRAIN WITH MEMBRANE CLAMP.

PIPE & BODY CAST INTO SLAB

FALLS

(SPD)

NOT TO SCALE

promit Minorm Milling

PLANTER DRAIN DETAIL

NOT TO SCALE

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-ONE LAYER OF COUNCIL APPROVED FILTER FABRIC

BETWEEN GARDEN MIX &

- MIN. 200mm GRANULAR FILL

AT BASE OF PLANTER BOX

GRANULAR FILL

— GARDEN MIX

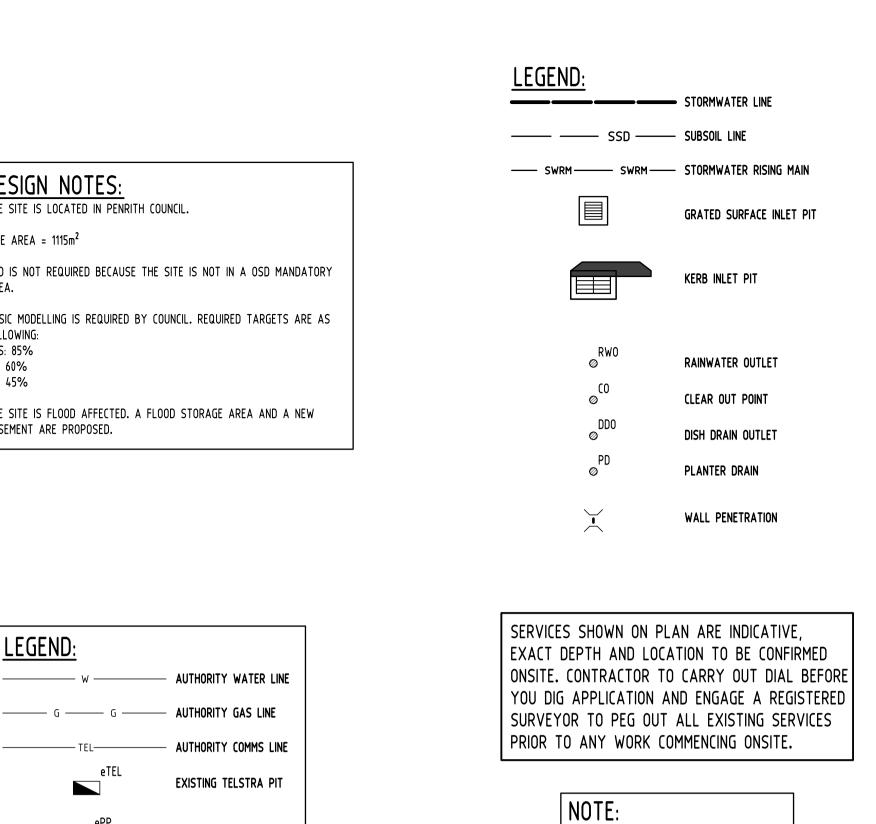
DESIGN NOTES: The site is located in penrith council.
SITE AREA = 1115m <sup>2</sup>
OSD IS NOT REQUIRED BECAUSE THE SITE IS AREA.
MUSIC MODELLING IS REQUIRED BY COUNCIL. R FOLLOWING: TSS: 85% TP: 60% TN: 45%
THE SITE IS FLOOD AFFECTED. A FLOOD STOR EASEMENT ARE PROPOSED.

LEGEND:

eTEL

ePP

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EXISTING POWER POLE

NOTES: FINAL SUBSOIL DESIGN TO BE CARRIED OUT

BASEMENT DRAINAGE DESIGN SUBJECT TO

STRUCTURAL DESIGN OF WALLS AND SLABS.

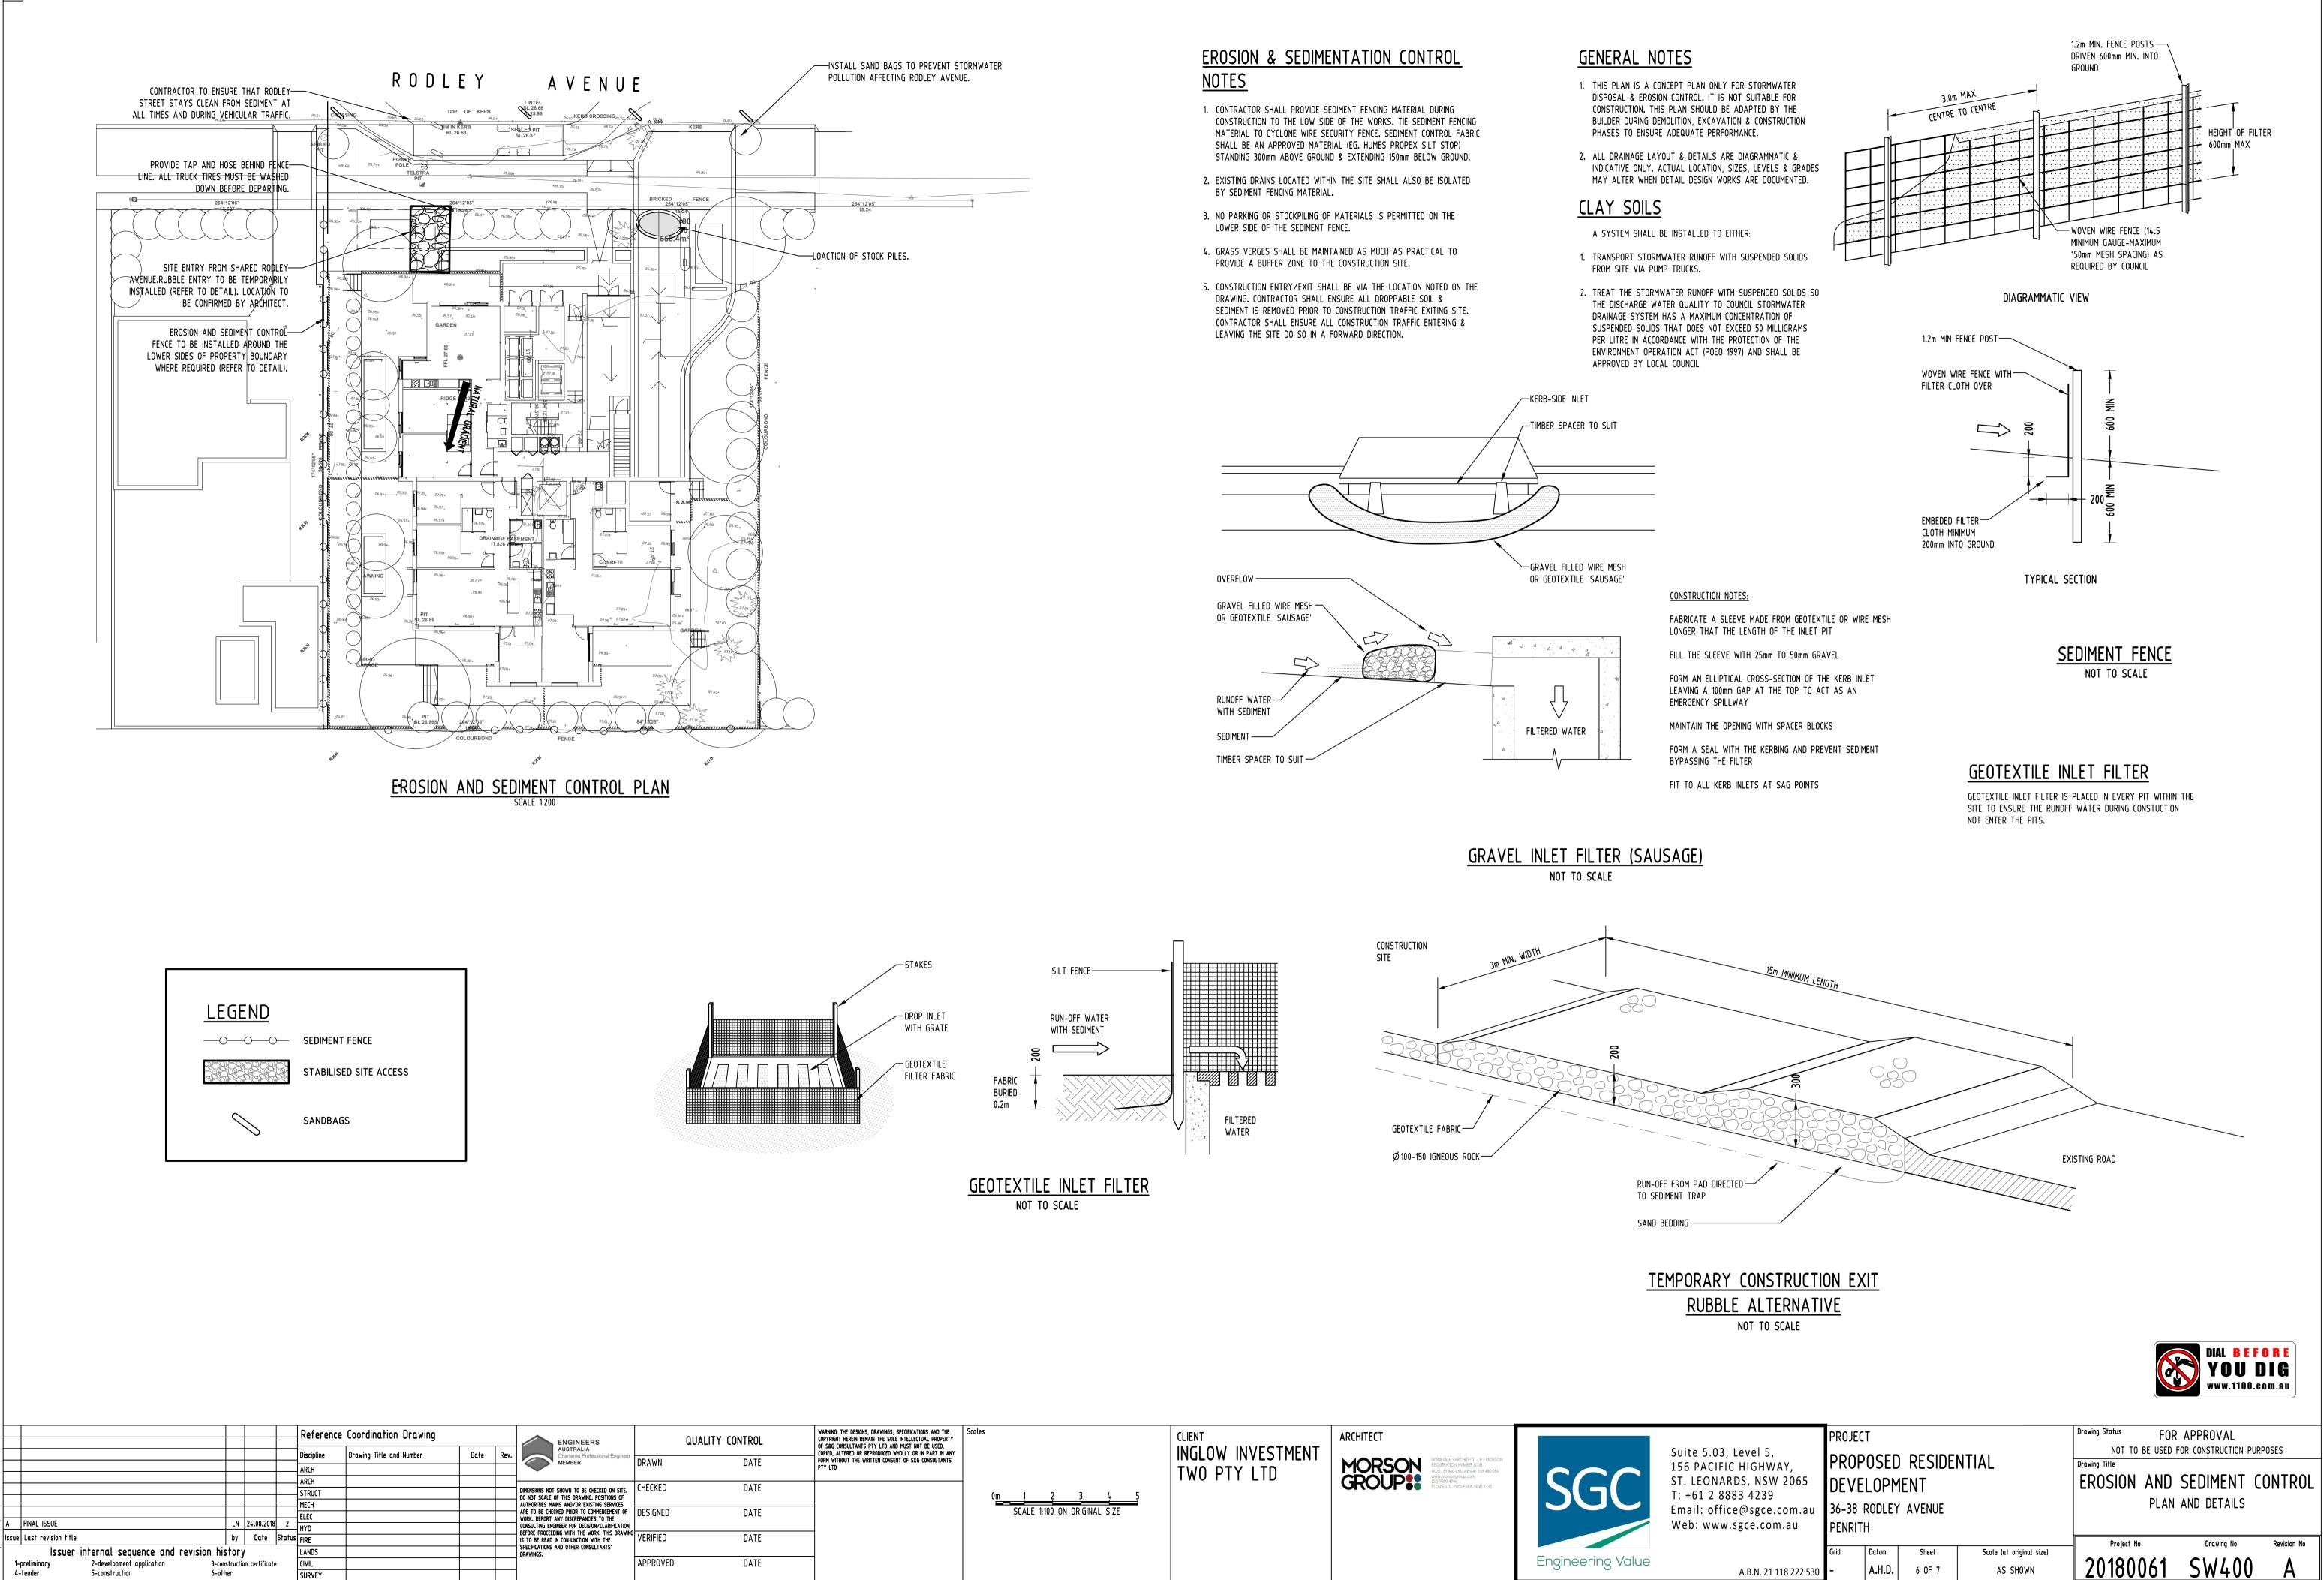
GEOTECHNICAL INVESTIGATION AND

ONCE GEOTECHNICAL REPORT AND WATER TABLE LEVEL IS CONFIRMED.

-Ø150mm uPVC OUTLET PIPE



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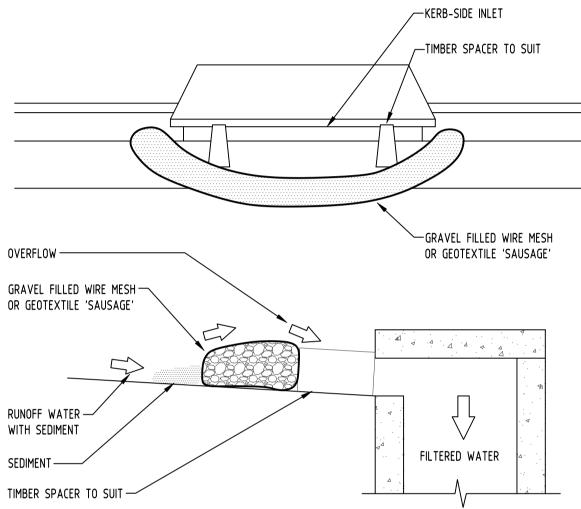


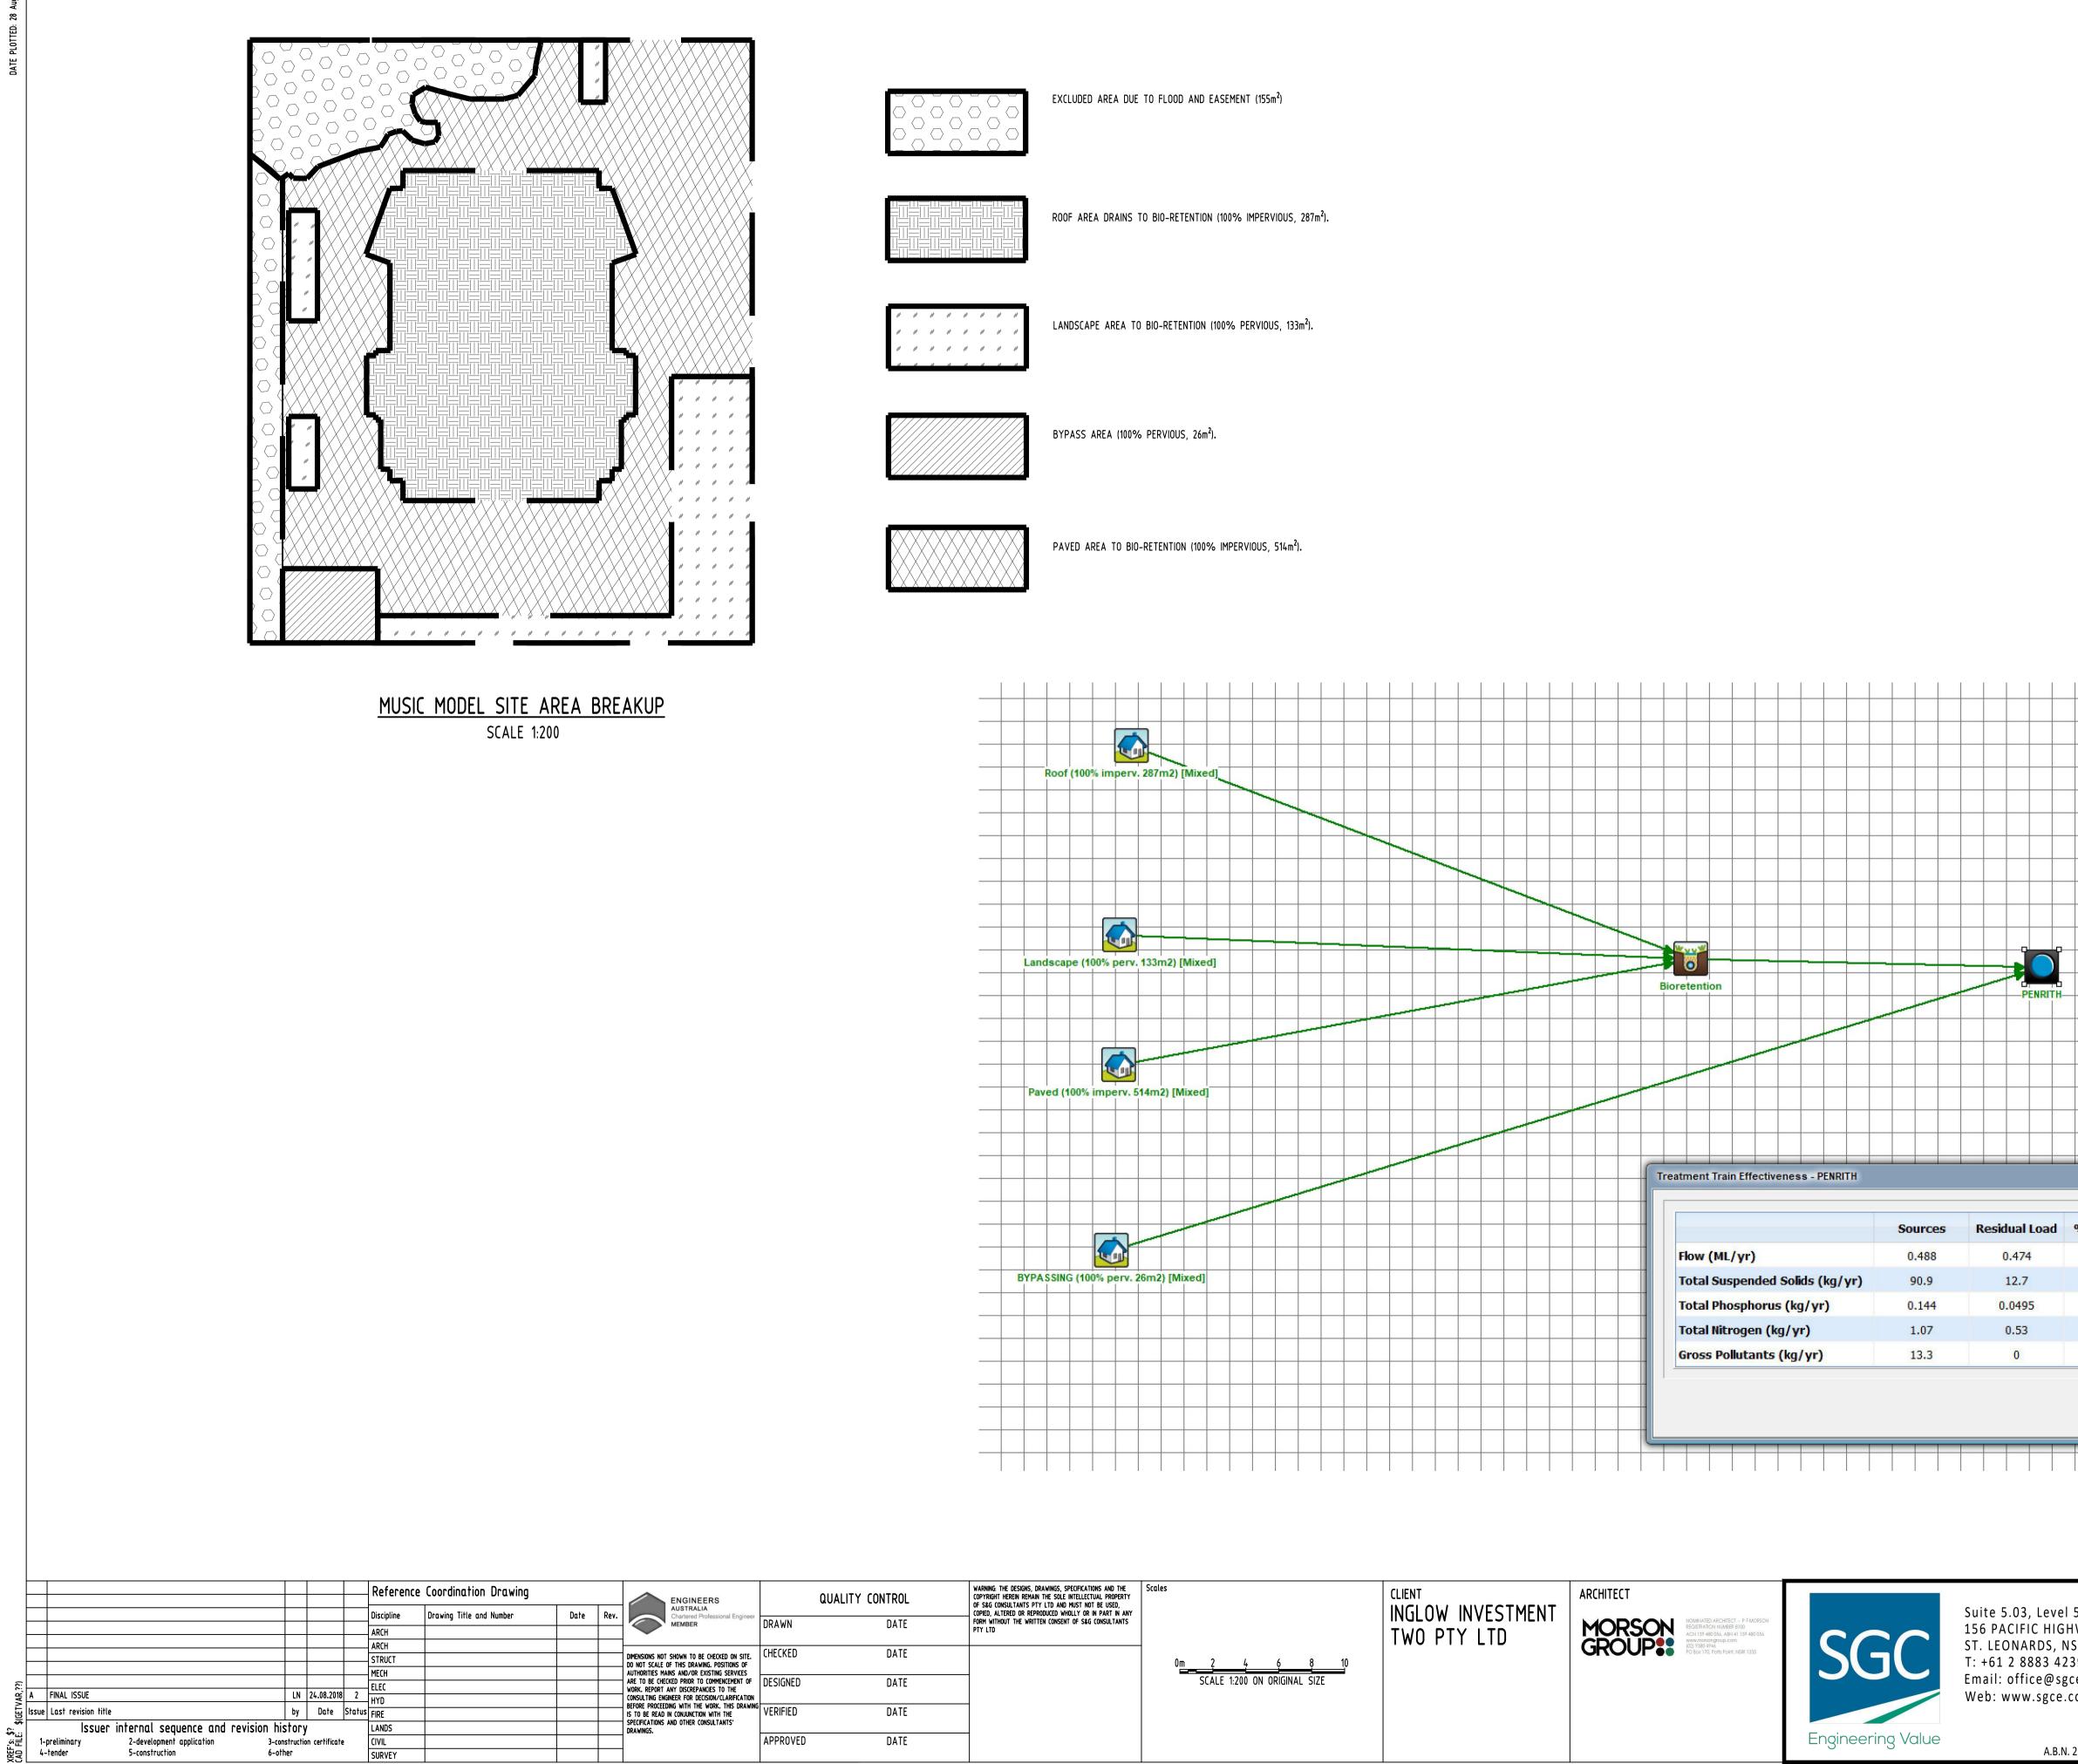
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