75-87 Dunheved Circuit, St Marys, NSW 2760

Landscape Documentation for Documentation Application



IMAGE TAKEN FROM NEARMAP 2020

Drawing Register

Dwg No.	Drawing Name
LDA-00	Landscape Cover Sheet
LDA-01	Landscape Masterplan
LDA-02	Landscape Detail Plan
LDA-03	Landscape Sections
LDA-04	Typical Specifications & Details
LDA-05	Planting Schedule & Imagery



KEY



PROPOSED FUTURE WAREHOUSE



SITE BOUNDARY

SITE PLAN

Drawing Title: **Landscape Cover Sheet**DWG No:

Suite 215, 284 Victoria Ave, Chatswood NSW 2067 Ph. (02) 9411 1485 www.geoscapes.com.au ABN 84 620 205 781 ACN 620 205 781



Client:	
Pipe	Makers

cale:	Date:	Job Number:	North:	Revision			FOR DEVELOPMENT APPLICATION			
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		St Mary's, NSW 2760		E	14.10.21	FOR DA		KC	BG	



Landscape Masterplan

DWG No:

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Pipe Makers

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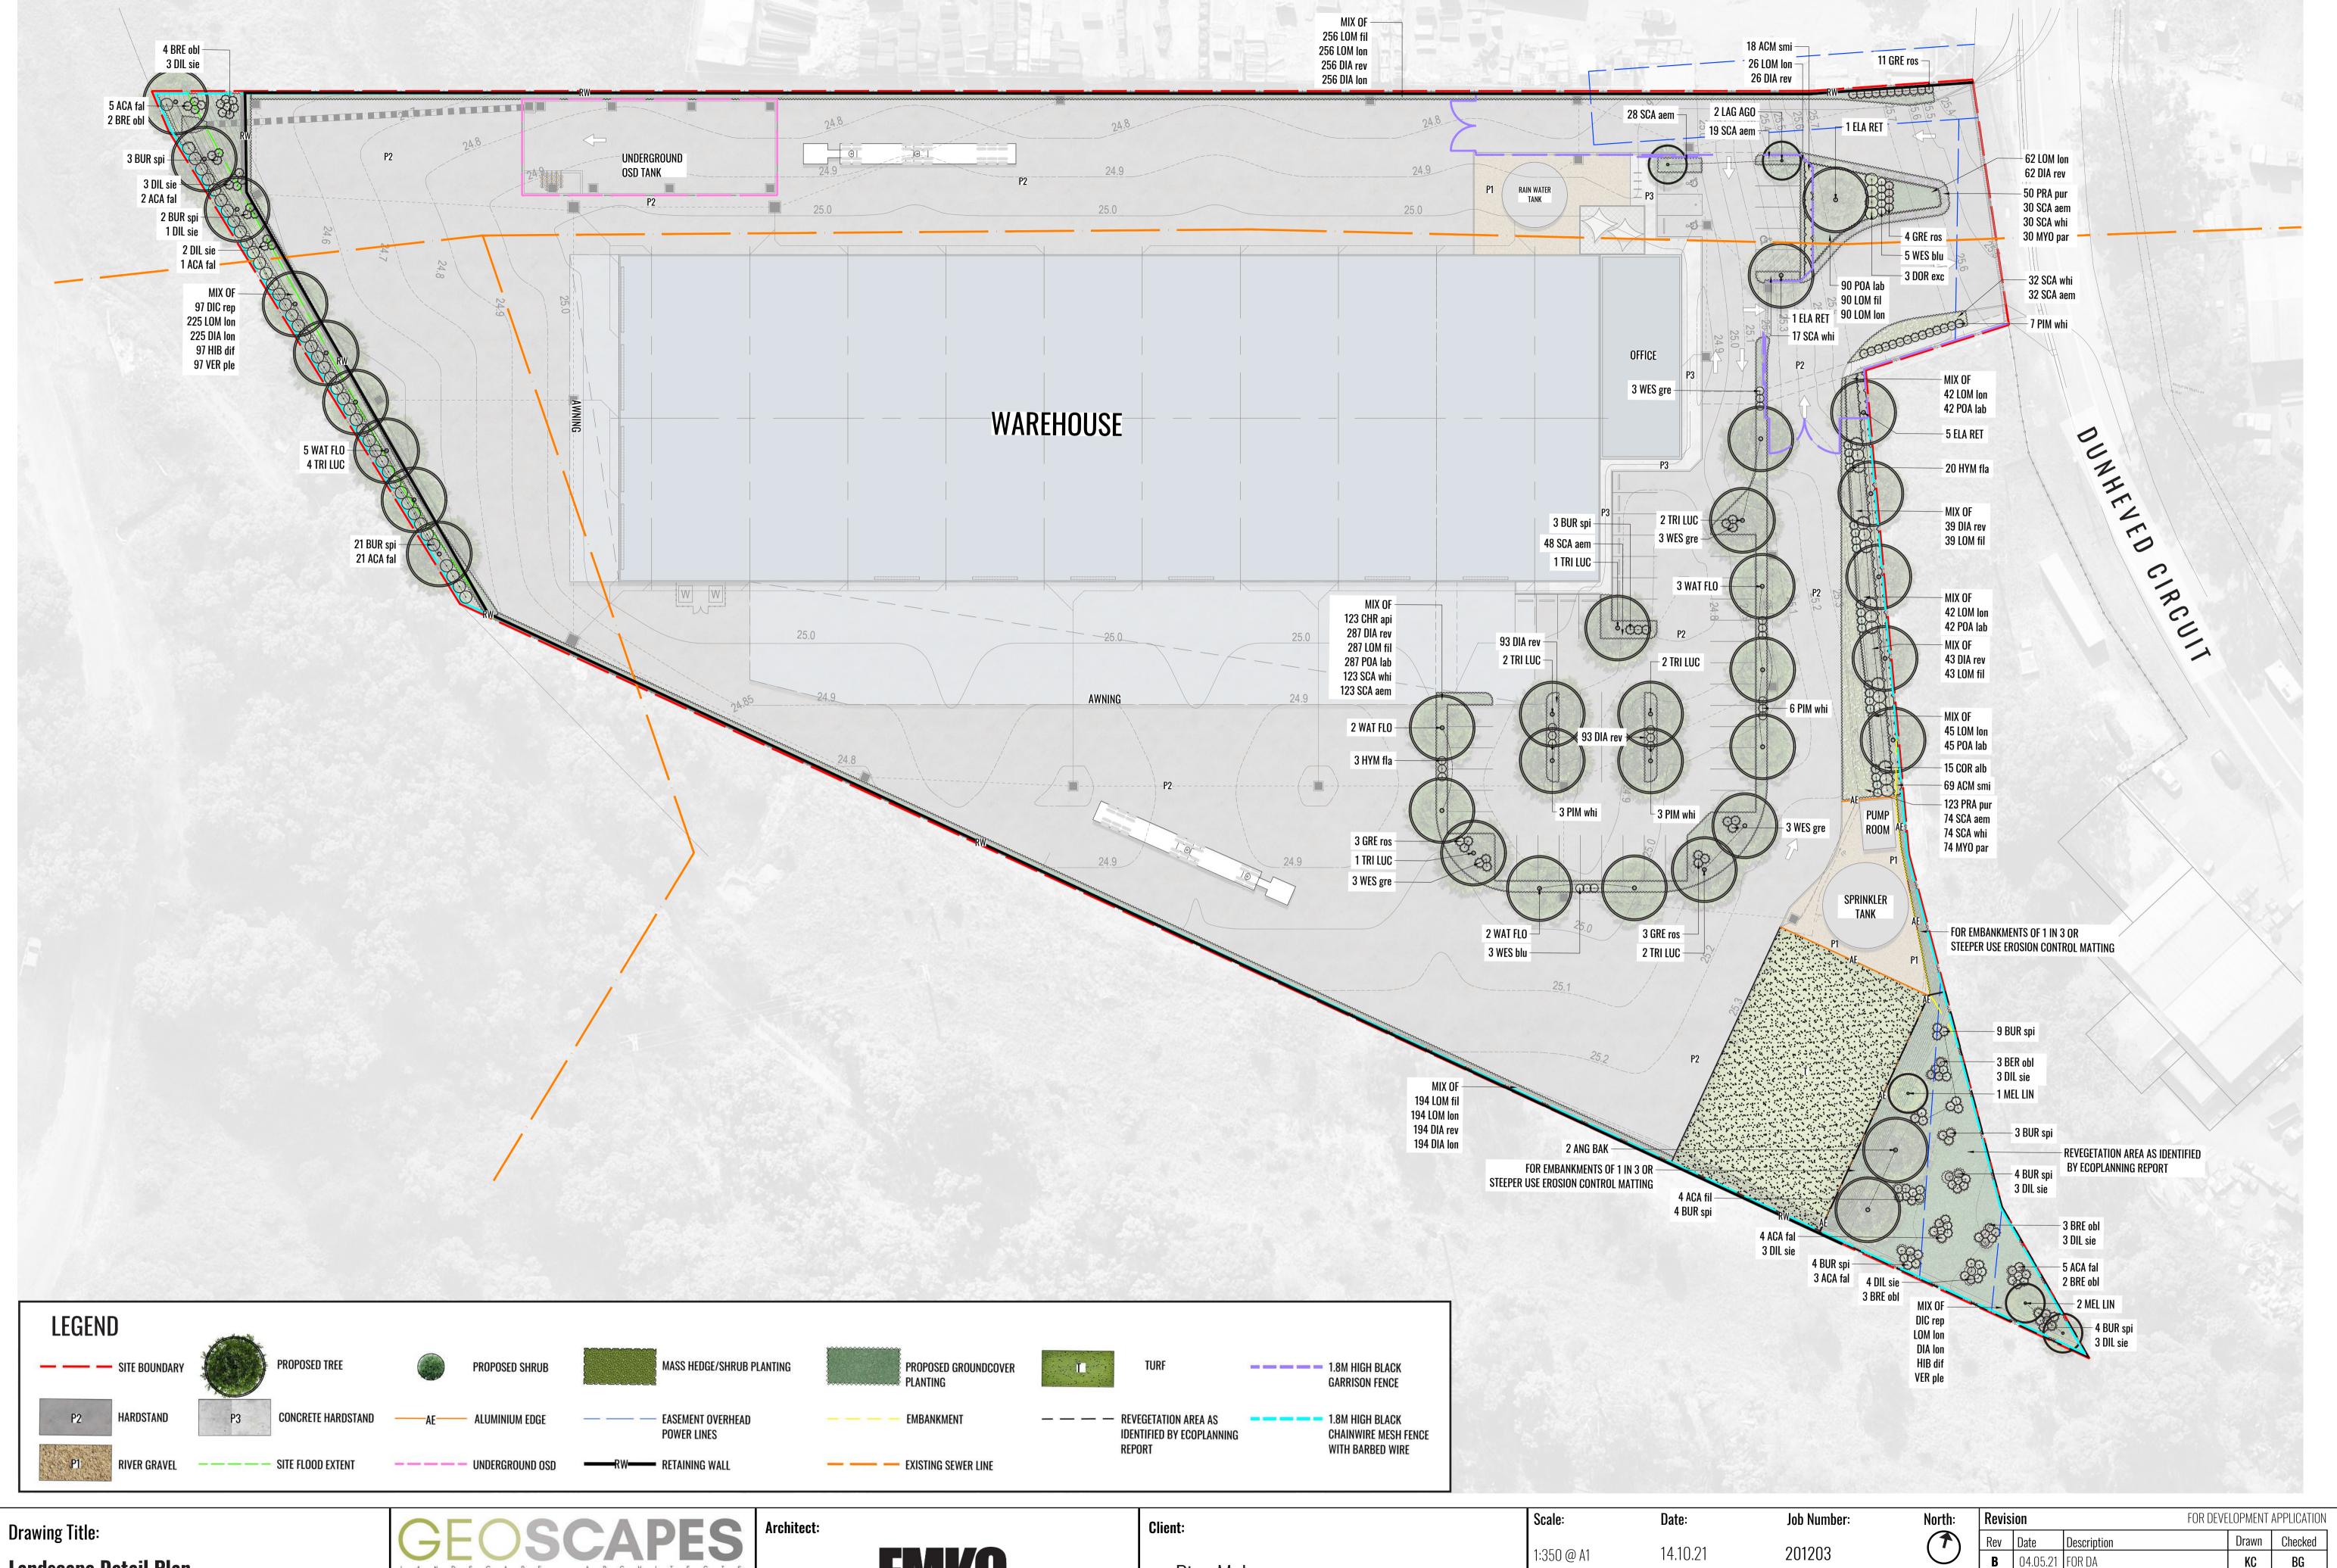
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Landscape Detail Plan

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Pipe Makers


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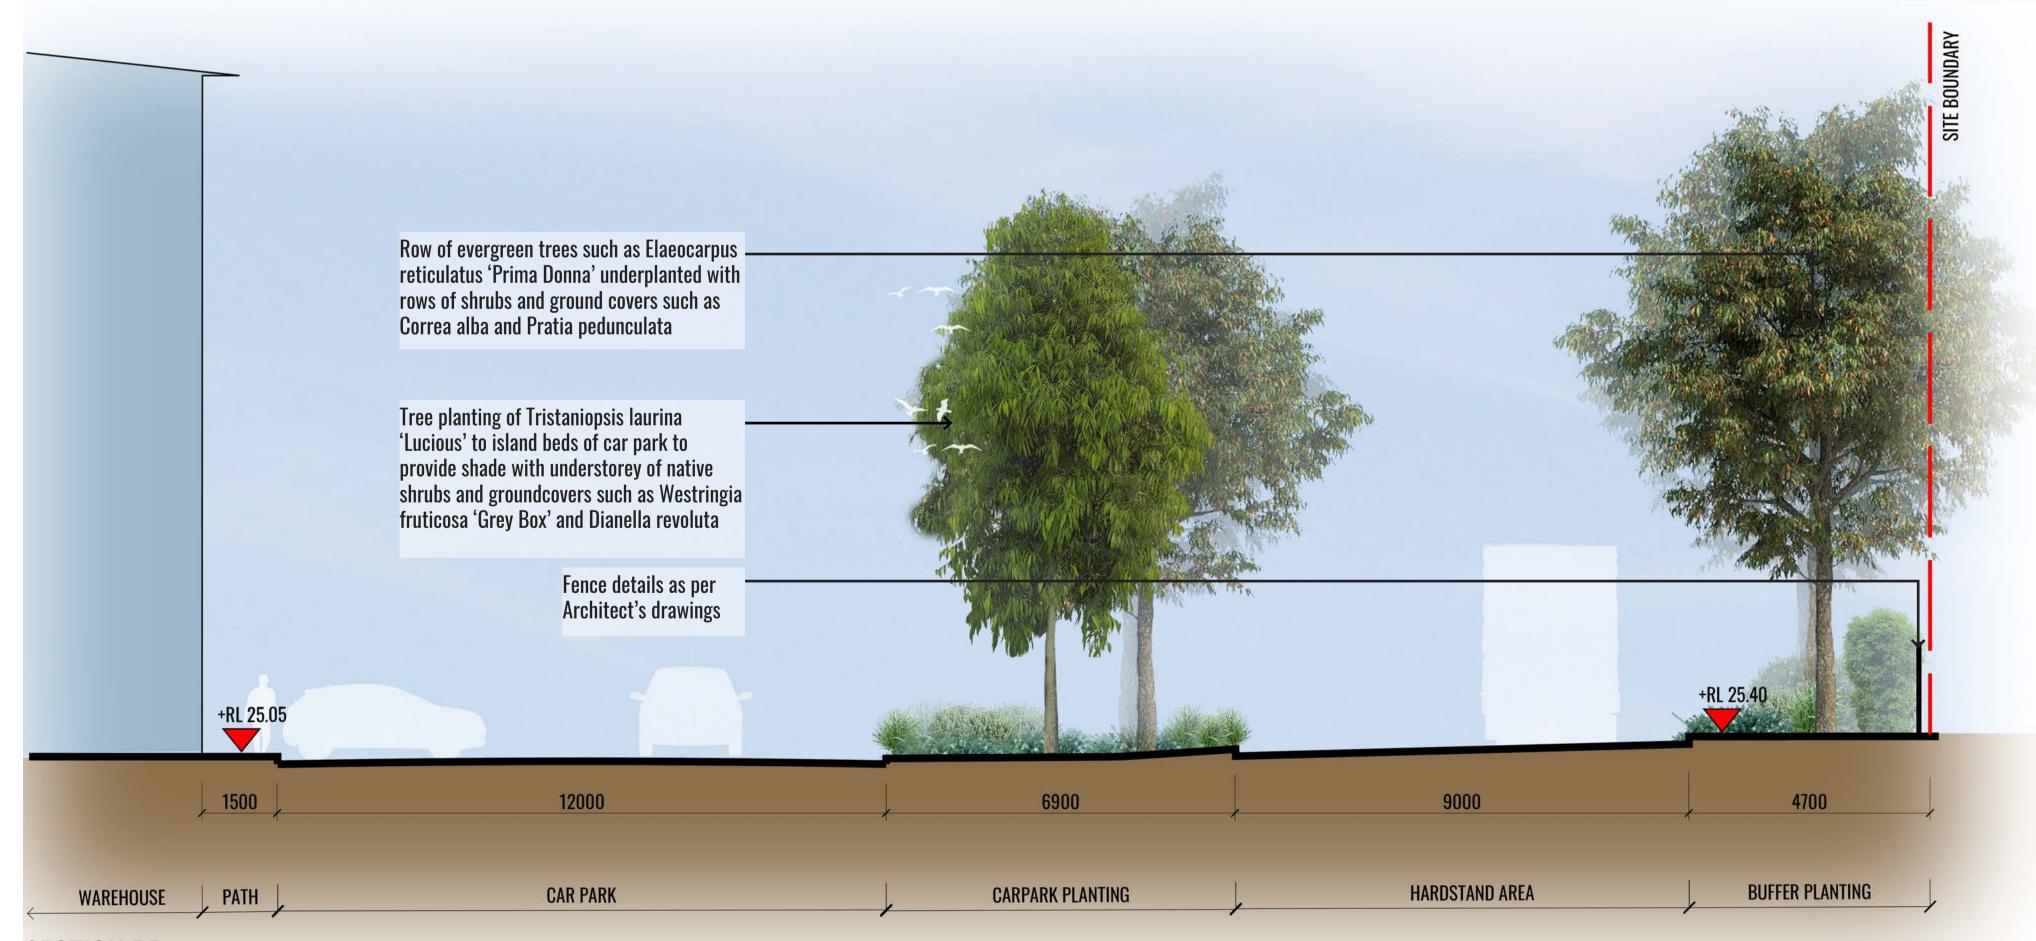
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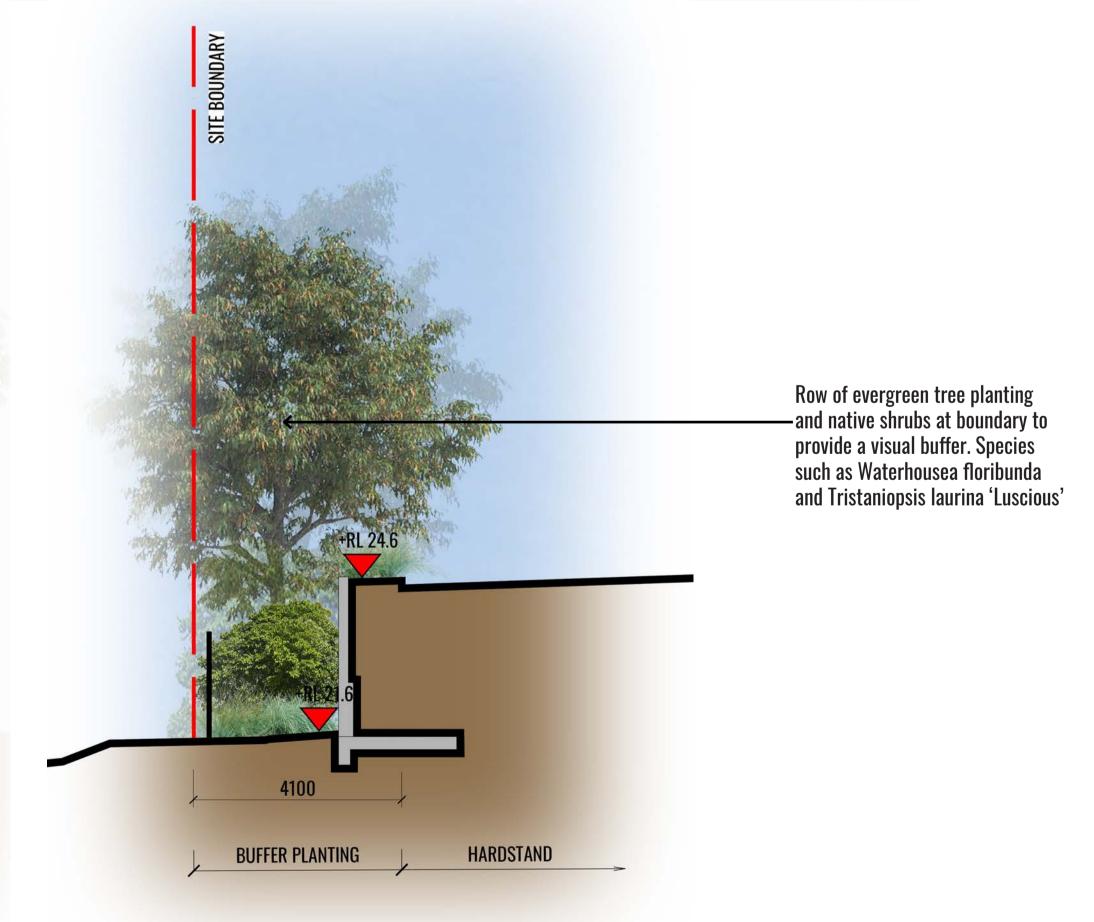
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 BG St Mary's, NSW 2760 **E** 14.10.21 FOR DA KC



SECTION AA



Architect:

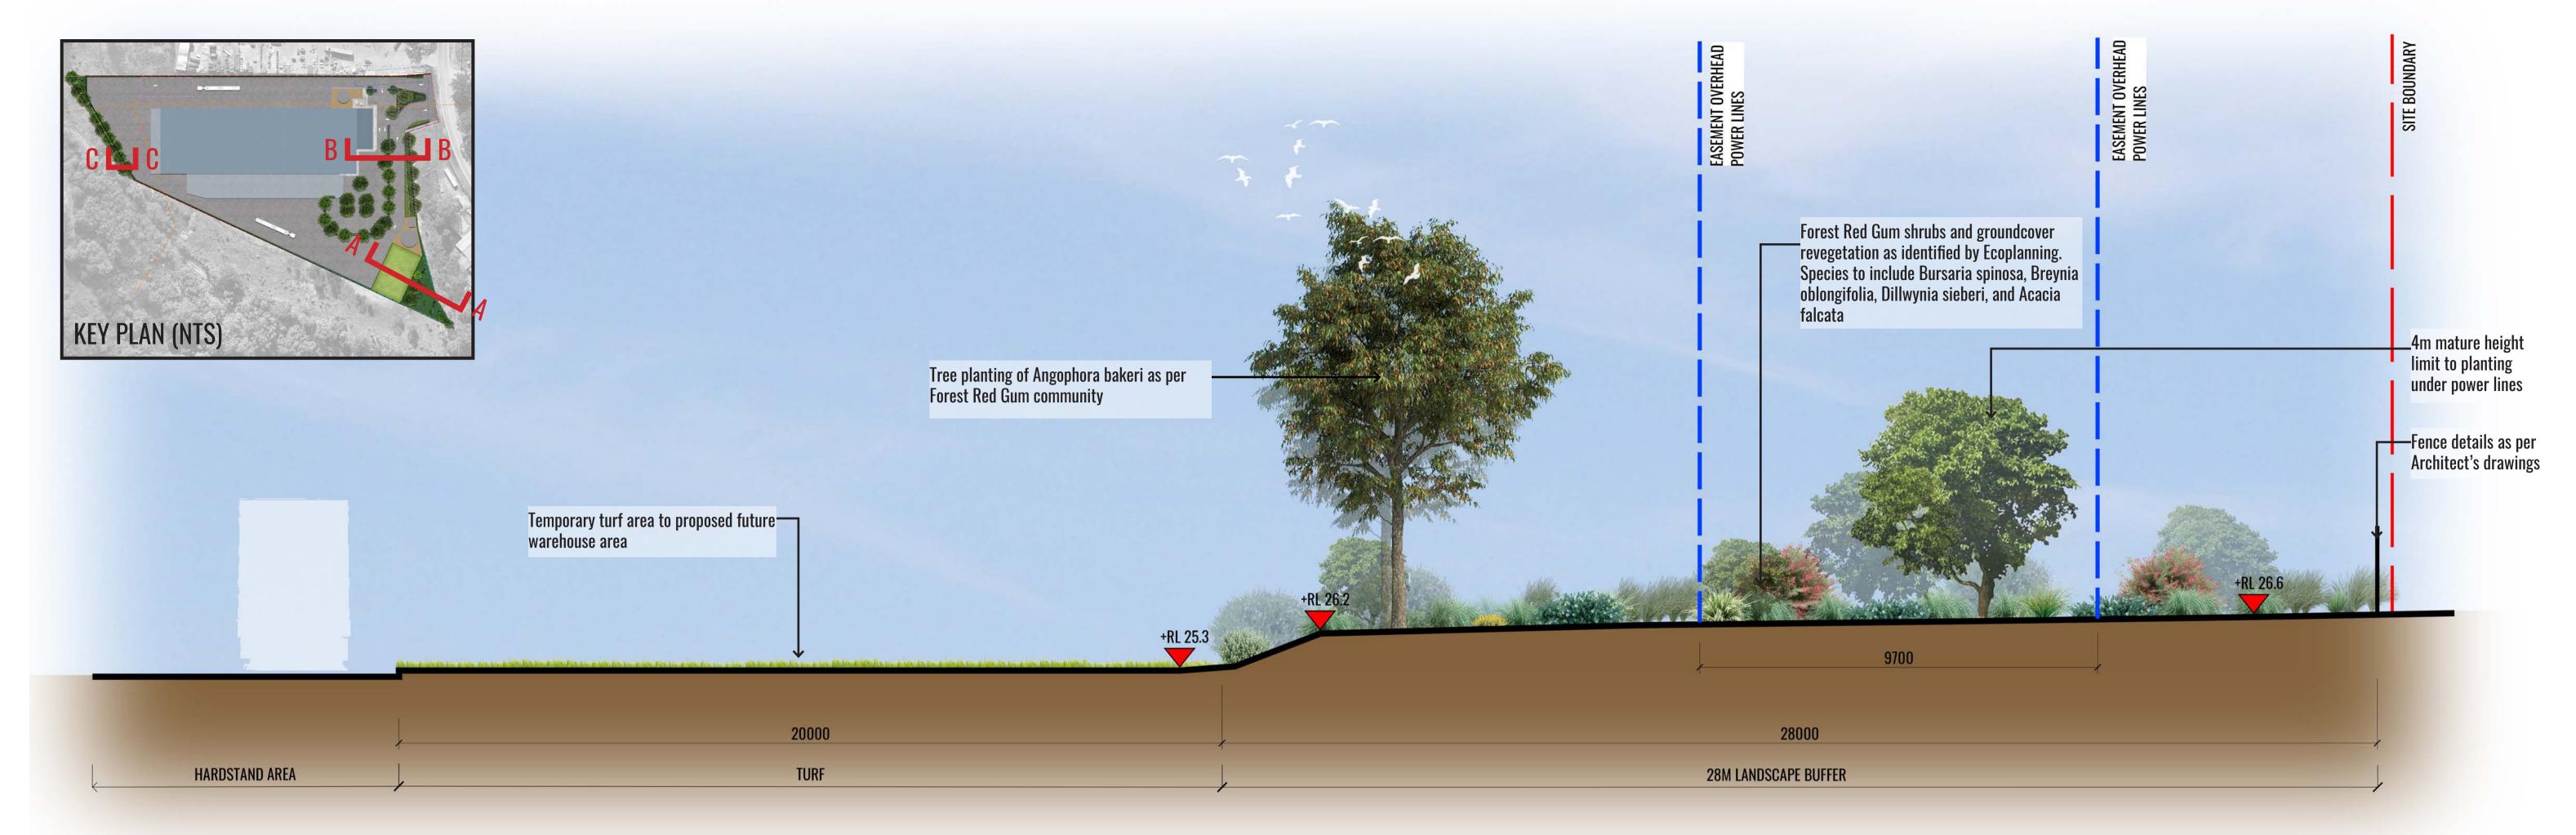

SECTION BB

Drawing Title:

Landscape Sections

DWG No:

LDA-03

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Client:
Pipe Makers

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SECTION CC

MAINTENANCE PLAN

Maintenance shall mean the care and maintenance of the landscape works by accepted horticultural practice as rectifying any defects that become apparent in the landscape works under normal use. The landscape contractor shall attend the site on a **weekly basis** to maintain the landscape works commencing from practical completion.

Rubbish Removal

The Landscape Contractor shall undertake rubbish removal from the site on a **weekly basis** to ensure the site remains in tidy condition.

Weed Eradication

Weed growth that may occur in grassed, planted or mulched areas is to be removed using environmentally acceptable methods i.e. non-residual glyphosate herbicide (e.g. 'Roundup', applied in accordance with the manufacturer's direction.

Tree Replacement

Trees shall show signs of healthy vigorous growth and be free from disease and not exhibit signs of stress prior to handover to the client. Any trees or plant that die or fail to thrive, or are damaged or stolen will be replaced. Replacement material shall have the initial maintenance period extended in accordance with the landscape contract conditions. Trees and plant materials shall be equal to the minimum requirements of species specified and approved material delivered to site. Should the condition decline from the approved sample the Superintendent reserves the right to reject the tree / plants. Frequency: as required.

Stakes

Adjust and/or replace stakes and ties where required. Remove staking and guying when instructed by the Superintendent

Pruning

Selective pruning may be required during the establishment period to promote a balanced canopy structure. These activities shall be carried out to the best horticultural and industry practice. All pruned material is to be removed from site.

Mulched Surfaces

All planter beds and garden areas shall have a minimum depth of 75mm organic mulch. All mulch is to be free of deleterious matter such as soil, weeds, sticks and should conform to AS 4454.

Mulched surfaces are to be kept clean and tidy and free of any deleterious material and foreign matter. Reinstate depths to a uniform level of 75mm with mulch as specified, mulch to be free of any wood material impregnated with CCA or similar toxic treatment. Top up mulch levels prior to handover to client & estate management.

Watering

Implement an appropriate hand watering regime in areas not irrigated in association with current watering programme to maintain plant health and vigour. The program shall reflect seasonal conditions and plant species.

Frequency: Weekly or as required.

Soil In Natural Ground

Non-Australian native garden beds to have soil installed consisting of 50% existing site topsoil and 50% new topsoil equal or equivalent to 'Organic Garden Mix' as supplied by Australian Native Landscapes. Australian native garden beds to have soil installed consisting of 50% existing site topsoil and 50% new topsoil equal or equivalent to 'Native Low 'P' Mix' as supplied by Australian Native Landscapes. Soil to conform to AS4419 refer to typical detail.

Pest and Disease Control

The Landscape Contractor shall spray for pests and disease infestations when the pest and fungal attack has been positively identified and when their populations have increased to a point that will become detrimental to plant growth. Apply all pesticides to manufacturer's directions. Frequency: weekly inspection

Fertilising

Generally check for signs of nutrient deficiencies (yellowing of leaves, failure to thrive), and adapt fertiliser regime to suit. Fertiliser should be applied at the beginning and the end of the (summer) growing season

Irrigation


A sub surface dripper style, electrically automated self timed irrigation system is recommended to be supplied to all garden bed areas and planter container. Regular checks are to be made to ensure continued successful operation. The Landscape Contractor shall be responsible for coordination and engagement of a specialist irrigation designer and installation contractor to design, supply and install an automatic subterranean drip irrigation system to all raised planter beds.

The irrigation system will need to provide designated landscaped areas with enough water for vigorous healthy plant growth. As a general rule landscaped areas will need 20-25mm, species dependant, of water per week. The landscape Contractor will need to monitor natural rainfall using a rain switch in order to set irrigation flow rates accordingly on a monthly basis.


Standards

All grown or purchased plant stock must conform to all the conditions and requirements given in NATSPEC Guide: Specifying Trees. Soils to be in accordance with AS4419, mulching composts and conditioners to be in accordance with AS4454. Soils should conform to best practice specifications as listed in the Landscape Soils Handbook (Simon Leake & Elke Haege 2017).

TYPICAL LANDSCAPE DETAILS

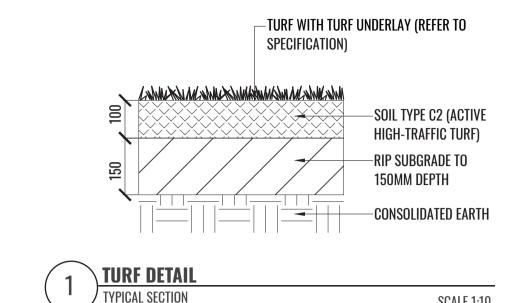

NATSPEC QUALITY PLANTS TO BE INSTALLED. FOR PLANT SPECIES, QUANTITIES AND SIZE, REFER TO LANDSCAPE PLAN AND

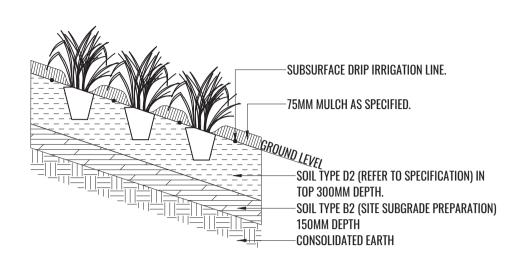


SLOPE PLANTING 1 IN 3 TYPICAL DETAIL SCALE 1:20

TREE/SHRUB SIZE AND QUALITY TO BE TO NATSPEC STANDARD. SPECIES IS TO BE AS PER PLAN AND PLANT SCHEDULE. ENSURE ONLY HEALTHY AND VIGOROUS, DISEASE FREE, WELL MAINTAINED PLANTS ARE USED.

SCALE 1:10

TAKE CARE TO ENSURE FOLIAGE, BRANCHES, TRUNKS AND ROOT CROWNS ARE NOT DAMAGED BEFORE, DURING AND AFTER PLANTING ENSURE OPTIMUM MAINTENANCE AND ESTABLISHMENT OF TREES/SHRUBS OCCURS AS SOON AS THEY ARE AT SITE

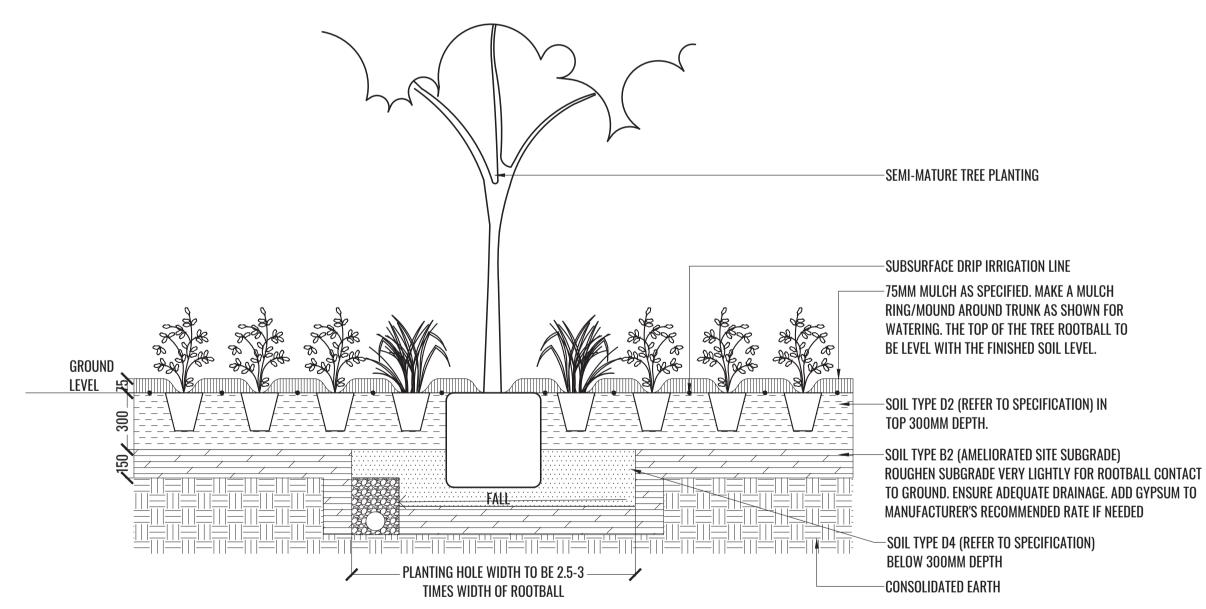

REMOVE ANY STAKES, TIES AND LABELS. WATER ROOTBALL THOROUGHLY TOP OF ROOTBALL TO FINISH FLUSH WITH TOP OF SOIL

MASS PLANTING AND TREE DETAIL

SCALE 1:20

Drawing Title:

Typical Specifications & Details





Architect:

Client:

Pipe Makers

FOR DEVELOPMENT APPLICATION Job Number: Revision Scale: Date: Drawn | Checked 14.10.21 201203 As Shown @ A1 **B** 04.05.21 FOR DA BG KC 18.05.21 FOR DA BG 75-87 Dunheved Circuit D 24.09.21 FOR DA Project: KC BG St Mary's, NSW 2760 **E** 14.10.21 FOR DA KC

DWG No:

PLANTING SCHEDULE

Code	Botanical Name	Common Name	Mature Height	Native	Spacing	Pot Size	Qty**
Trees							
ANG BAK	Angophra bakeri	Narrow-leaved Apple	10m	✓	As Shown	75L	2
ELA RET	Elaeocarpus reticulatus 'Prima Donna'	Blueberry Ash	9m	✓	As Shown	75L	7
LAG AGO	Lagerstroemia indica 'Acoma'	White Crepe Myrtle	3.5m		As Shown	75L	2
MEL LIN	Melaleuca linariifolia	Narrow-leaved paperbark	8m	✓	As Shown	75L	4
TRI LUC	Tristaniopsis laurina 'Lucious'	Water Gum	8m		As Shown	75L	14
WAT FLO	Waterhousea floribunda	Weeping Lily Pilly	15m	✓	As Shown	75L	12
Shrubs							
ACA fal	Acacia falcata	Sickle Wattle	5m	✓	As Shown	200mm	43
ACM smi	Acmena smithii 'Sublime'	Lilly Pilly	3m	✓	750mm Ctrs	200mm	87
BRE obl	Breynia oblongifolia	Coffee Bush	3m	✓	As Shown	200mm	10
BUR spi	Bursaria spinosa	Boxthorn	4m	✓	As Shown	200mm	57
COR alb	Correa alba	White Correa	1.2m	✓	As Shown	200mm	15
DIL sie	Dillwynia sieberi	Prickly Parrot Pea	2.5m	✓	As Shown	200mm	28
DOR exc	Doryanthes excelsa	Gymea Lilly	1.5m	✓	As Shown	200mm	3
GRE ros	Grevillea rosmarinifolia 'Crimson Villea'	Crimson Villea Grevillea	0.7m	✓	As Shown	200mm	21
HYM fla	Hymenosporum flavum 'Lushious'	Lushious Native Frangipani	0.5m	✓	As Shown	200mm	23
PIM whi	Pimelea 'White Jewel'	White Jewel Rice Flower	0.4m	✓	As Shown	200mm	19
WES blu	Westringia 'Blue Gem' [WES03]	Native Rosemary	1-1.5m	✓	As Shown	200mm	11
WES gre	Westringia fruticosa 'Grey Box' [WES04]	Grey Box Native Rosemary	0.4m	✓	As Shown	200mm	12
Grasses + G	roundcover						
CHR api	Chrysocephalum apiculatum	Yellow Button	0.3m	✓	3/m2	Tubestock	123
DIC rep	Dichondra repens	Kidney Plant	0.1m	✓	3/m2	Tubestock	97*
DIA Ion	Dianella longifolia	Flax Lily	1.5m	✓	7/m2	Tubestock	675*
DIA rev	Dianella revoluta	Flax Lily	0.5m	✓	7/m2	Tubestock	1093
HIB dif	Hibbertia diffusa	Wedge Guinea Flower	0.5m	✓	3/m2	Tubestock	97*
LOM fil	Lomandra filiformis	Wattle Mat Rush	0.5m	✓	7/m2	Tubestock	909
LOM Ion	Lomandra longifolia	Spiny Mat Rush	0.8m	✓	7/m2	Tubestock	982*
MYO par	Myoporum parvifolia 'Yareena' [PARV01]	Creeping Boobialla	0.1m	✓	3/m2	140mm	104
POA lab	Poa labilladeri	Tussock Grass	0.5m	✓	7/m2	Tubestock	506
PRA pur	Pratia pedunculata	Blue Star Creeper	0.2m	✓	5/m2	Tubestock	173
SCA aem	Scaevola aemula	Fan Flower	0.5m	✓	3/m2	140mm	354
SCA whi	Scaevola albida 'White Carpet'	White Fan Flower	0.1-0.2m	✓	3/m2	140mm	276
VER ple	Veronica plebeia	Trailing Speedwell	0.1m	✓	3/m2	Tubestock	97*


^{*} Numbers to be advised by Ecologist during construction

PLANT IMAGES







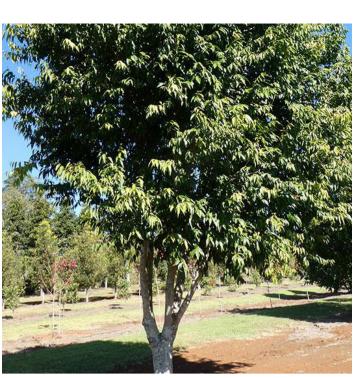



Elaeocarpus reticulatus 'Prima Donna'

Lagerstroemia indica 'Acoma'


Melaleuca linariifolia

Waterhousea floribunda

Acmena smithii 'Sublime'





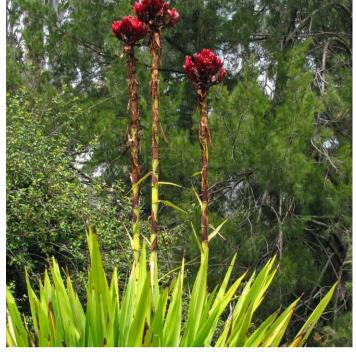





Bursaria spinosa

Correa alba

Doryanthes excelsa

Pimelea 'White Jewel'

Westringia fruticosa 'Grey Box'











Dianella revoluta

Scaevola aemula

Lomandra longifolia

Drawing Title:

Planting Schedule & Imagery DWG No:





Client:
Pipe Makers

Scale:	Date:	Job Number:	North:	Revision			FOR DEVE	DEVELOPMENT APPLIC		
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^{**} Final numbers to be confirmed at Construction Certificate Stage