
# 44-50 TENCH AVENUE, JAMISONTOWN NSW 2750 PROPOSED MUD MAP: THE ORANGE GROVE

### STORMWATER MANAGEMENT PLANS - CONSTRUCTION CERTIFICATE

### STORMWATER NOTES

- CONTRACTOR MUST VERIFY ALL DIMENSIONS & EXISTING LEVELS, SERVICES & STRUCTURES ON SITE PRIOR TO COMMENCEMENT OF WORK.
- THESE PLANS SHALL BE READ IN CONJUNCTION WITH APPROVED ARCHITECTURAL LANDSCAPE, STRUCTURAL, HYDRAULIC, & OTHER SERVICES DRAWINGS & SPECIFICATIONS. IF THERE EXISTS AND DISCREPANCIES BETWEEN THE DRAWINGS, THE BUILDER SHALL REPORT THE DISCREPANCIES TO THE ENGINEER PRIOR TO COMMENCEMENT OF ANY
- EQUIVALENT STRENGTH REINFORCED CONCRETE PIPES MAY BE USED
- WHERE SUBSOIL DRAINAGE LINES PASS UNDER FLOOR SLABS & VEHICULAR PAVEMENTS, UNSLOTTED uPVC SEWER GRADE PIPE SHALL BE USED.
- 5. CHARGED LINES TO BE SEWER GRADE & SEALED.
- 6. ALL PIPES TO HAVE MIN 150mm COVER IF LOCATED WITHIN PROPERTY.
- 7. ALL PITS IN DRIVEWAYS TO BE CONCRETE & ALL PITS IN LANDSCAPED AREAS TO BE PLASTIC.
- 8. PITS LESS THAN 600mm DEEP MAY BE BRICK, PRECAST OR CONCRETE.
- 9. ALL BALCONIES & ROOFS TO BE DRAINED & TO HAVE SAFETY OVERFLOWS IN ACCORDANCE WITH RELEVANT AUSTRALIAN STANDARDS.
- 10. ALL GRATES TO HAVE CHILD PROOF LOCKS
- 11. ALL DRAINAGE WORKS TO AVID TREE ROOTS
- 12. ALL DOWNPIPES & GUTTERS TO HAVE LEAF GUARDS.
- 13. COUNCIL'S ISSUED FOOTWAY DESIGN LEVELS TO BE INCORPORATED INTO THE FINISHED LEVELS ONCE ISSUED BY COUNCIL.
- 14. ALL WORKS SHALL BE IN ACCORDANCE WITH B.C.A. & A.S.3500.3.
- 15. CARE TO BE TAKEN AROUND EXISTING SEWER. STRUCTURAL ADVICE REQUIRED FOR SEWER PROTECTION AGAINST ADDITIONAL LOADING FROM NEW PITS, PIPES, RETAINING WALLS & OSD BASIN WATER LEVELS.
- 16. ALL Ø300 DRAINAGE PIPES & LARGER SHALL BE CLASS 2 APPROVED SPIGOT & SOCKET RCP PIPES WITH RUBBER RING JOINTS (U.N.O.). ALL DRAINAGE PIPES UP TO & INCLUDING Ø225 SHALL BE SEWER GRADE uPVC WITH SOLVENT WELD JOINTS (U.N.O.).
- 17. EQUIVALENT STRENGTH FRC PIPES MAY BE USED.
- 18. ALL PIPE JUNCTIONS, BENDS & TAPERS UP TO & INCLUDING Ø450 SHALL BE VIA PURPOSE
- 19. CONTRACTOR TO SUPPLY & INSTALL ALL FITTINGS & SPECIALS INCLUDING VARIOUS PIPE ADAPTORS TO ENSURE PROPER CONNECTION BETWEEN DISSIMILAR PIPE WORK.
- 20. ALL CONNECTIONS TO EXISTING DRAINAGE PITS SHALL BE MADE IN A TRADESMAN-LIKE MANNER. & THE INTERNAL WALL OF THE PIT AT THE POINT OF ENTRY SHALL BE CEMENT RENDERED TO ENSURE A SMOOTH FINISH
- 21. WHERE TRENCHES ARE IN ROCK, THE PIPE SHALL BE BEDDED ON A MIN. 50mm CONCRETE BED (OR 75mm THICK BED OF 12mm BLUE METAL) UNDER THE BARREL OF THE PIPE. THE PIPE COLLAR AT NO POINT SHALL BEAR ON THE ROCK. IN OTHER THAN ROCK, PIPES SHALL BE LAID ON A 75mm THICK SAND BED. IN ALL CASES, BACKFILL THE TRENCH WITH SAND TO 200mm ABOVE THE PIPE. WHERE THE PIPE IS UNDER PAVEMENTS BACKFILL REMAINDER OF TRENCH WITH SAND OR APPROVED GRANULAR BACKFILL COMPACTED IN 150mm LAYERS TO 98% STANDARD MAX. DRY DENSITY.
- 22. BEDDING SHALL BE TYPE H1 (U.N.O.), IN ACCORDANCE WITH CURRENT RELEVANT AUSTRALIAN STANDARDS.
- 23. WHERE STORMWATER LINES PASS UNDER FLOOR SLABS, SEWER GRADE RUBBER RING JOINTS ARE TO BE USED.
- 24. ALL PIPES IN BALCONIES TO BE Ø65 uPVC CAST IN CONCRETE SLAB.
- 25. Ø65 PVC @ MIN 1.0% Ø90 PVC @ MIN 1.0% Ø100 PVC @ MIN 1.0% Ø225 PVC @ MIN 0.5% Ø300 PVC @ MIN 0.4% Ø150 PVC @ MIN 1.0% UNLESS NOTED OTHERWISE
- 26. CONTRACTOR TO PROVIDE A BREAK / OPEN VOID IN RAIL / BALLUSTRADE FOR STORMWATER EMERGENCY OVERFLOW.
- 27. ALL ENCLOSED AREAS/PLANTER BOXES BE FITTED WITH FLOOR WASTES & TO DRAINED TO
- 28. DOWNPIPES TO BE CHECKED BY ARCHITECT & PLUMBER PRIOR TO CONSTRUCTION.
- 29. PROVIDE 3.0m LENGTH OF Ø100 SUBSOIL DRAINAGE PIPE WRAPPED IN FABRIC SOCK, AT UPSTREAM END OF EACH PIT.
- 30. ALL THE CLEANING EYES (OR INSPECTION EYES) FOR THE UNDERGROUND PIPES HAVE TO BE TAKEN UP TO THE FINISHED GROUND LEVEL FOR EASY IDENTIFICATION & MAINTENANCE
- 31. ALL SUB-SOIL DRAINAGE SHALL BE A MIN OF Ø65 & SHALL BE PROVIDED WITH A FILTER SOCK THE SUBSOIL DRAINAGE SHALL BE INSTALLED IN ACCORDANCE WITH DETAILS TO BE PROVIDED BY THE LANDSCAPE ARCHITECT.
- 32. PRIOR TO COMMENCING ANY WORKS, THE BUILDER SHALL ENSURE THAT THE INVERT LEVELS OF WHERE THE SITE STORMWATER SYSTEM CONNECTS INTO THE COUNCILS KERB/DRAINAGE SYSTEM MATCHED THE DESIGN LEVELS. ANY DISCREPANCIES SHALL BE REPORTED TO THE DESIGN ENGINEER IMMEDIATELY.

DRAWING	INDEX
Drawing No.	DESCRIPTION
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MBR19039 - 102	STORMWATER LAYOUT PLAN - GROUND LEVEL PLAN - SHEET 2 OF 2
MBR19039 - 103	STORMWATER LAYOUT PLAN - ROOF PLAN - SHEET 1 OF 2
MBR19039 - 104	STORMWATER LAYOUT PLAN - ROOF PLAN - SHEET 1 OF 2
MBR19039 - 105	OSD & WSUD CATCHMENT PLANS
MBR19039 - 106	OSD & WSUD DETAILS & CALCULATION SHEETS - SHEET 1 OF 4
MBR19039 - 107	OSD & WSUD DETAILS & CALCULATION SHEETS - SHEET 2 OF 4
MBR19039 - 108	OSD & WSUD DETAILS & CALCULATION SHEETS - SHEET 3 OF 4
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MBR19039 - 112	CUT - FILL PLAN
MBR19039 - 113	MISCELLANEOUS DETAILS SHEET - SHEET 1 OF 2
MBR19039 - 114	MISCELLANEOUS DETAILS SHEET - SHEET 2 OF 2

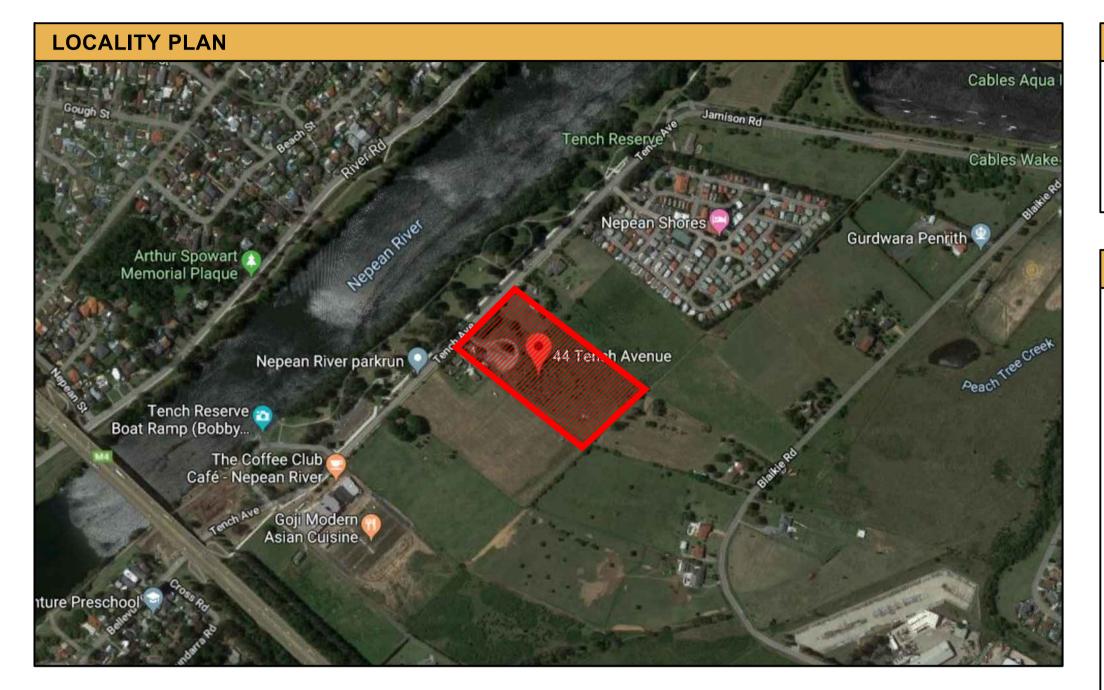

# PERSPECTIVE PLAN

### DIAL BEFORE YOU DIG NOTE



MAINTAIN A SET OF 'DIAL ON SITE AT ALL TIMES.

### SITEWORKS NOTES

- ORIGIN OF LEVELS: AUSTRALIAN HEIGHT DATUM (A.H.D.)
- CONTRACTOR MUST VERIFY ALL DIMENSIONS & EXISTING LEVELS ON SITE
- ALL WORKS ARE TO BE UNDERTAKEN IN ACCORDANCE WITH THE DETAILS SHOWN ON THE DRAWINGS. THE SPECIFICATIONS & THE DIRECTIONS OF THE PRINCIPAL'S REPRESENTATIVE.
- DISCREPANCIES SHALL BE REPORTED TO THE PRINCIPAL'S REPRESENTATIVE CLEARANCES SHALL BE OBTAINED FROM THE RELEVANT SERVICE
- WHERE NEW WORKS ABUT EXISTING, THE CONTRACTOR SHALL ENSURE THAT A SMOOTH EVEN PROFILE, FREE FROM ABRUPT CHANGES IS OBTAINED.
- 6. THE CONTRACTOR SHALL ARRANGE ALL SURVEY SETOUT TO BE CARRIED **OUT BY A REGISTERED SURVEYOR**
- CARE IS TO BE TAKEN WHEN EXCAVATING NEAR EXISTING SERVICES. NO MECHANICAL EXCAVATIONS ARE TO BE UNDERTAKEN OVER COMMUNICATIONS OR ELECTRICAL SERVICES. HAND EXCAVATE IN THESE
- ALL SERVICE TRENCHES UNDER VEHICULAR PAVEMENTS SHALL BE BACKFILLED WITH AN APPROVED NON-NATURAL GRANULAR MATERIAL & COMPACTED TO 98% STANDARD MAXIMUM DRY DENSITY IN ACCORDANCE
- DENSITY AS THE ADJACENT MATERIAL. 10. ON COMPLETION OF PIPE INSTALLATION, ALL DISTURBED AREAS MUST BE

9. ALL TRENCH BACKFILL MATERIAL SHALL BE COMPACTED TO THE SAME

- RESTORED TO ORIGINAL, INCLUDING KERBS, FOOTPATHS, CONCRETE AREAS, GRAVEL & GRASSED AREAS & ROAD PAVEMENTS.
- 11. PROVIDE 12mm WIDE EXPANDING CORK JOINTS BETWEEN CONCRETE PAVEMENTS & ALL BUILDINGS, WALLS, FOOTINGS, COLUMNS, KERBS, DISH DRAINS, GRATED DRAINS, BOLLARD FOOTINGS ETC
- 12. CONTRACTOR TO OBTAIN ALL AUTHORITY APPROVALS.
- 13. ALL BATTERS TO BE GRASSED LINED WITH MIN 100mm TOPSOIL & APPROVED COUCH LAID AS TURF.
- 14. MAKE SMOOTH TRANSITION TO EXISTING SERVICES & MAKE GOOD.
- 15. THE CONTRACTOR SHALL PROVIDE ALL TEMPORARY DIVERSION DRAINS & MOUNDS TO ENSURE THAT, AT ALL TIMES, EXPOSED SURFACES ARE FREE DRAINING &, WHERE NECESSARY, EXCAVATE SUMPS & PROVIDE PUMPING EQUIPMENT TO DRAIN EXPOSED AREAS.
- 16. THESE PLANS SHALL BE READ IN CONJUNCTION WITH APPROVED ARCHITECTURAL, LANDSCAPE, STRUCTURAL, HYDRAULIC & ELECTRICAL DRAWINGS & SPECIFICATIONS. IF THERE EXISTS AND DISCREPANCIES BETWEEN THE DRAWINGS, THE BUILDER SHALL REPORT THE DISCREPANCIES TO THE ENGINEER PRIOR TO COMMENCEMENT OF ANY WORKS.
- 17. TRENCHES THROUGH EXISTING ROAD & CONCRETE PAVEMENTS SHALL BE SAWCUT TO FULL DEPTH OF CONCRETE & A MIN 50mm IN BITUMINOUS PAVING.
- 18. ALL BRANCH GAS & WATER SERVICES UNDER DRIVEWAYS & BRICK PAVING SHALL BE LOCATED IN Ø80 uPVC SEWER GRADE CONDUITS EXTENDING A MIN OF 500mm PAST PAVING.
- 19. ALL WORKS WITHIN COUNCIL RESERVE TO BE INSPECTED BY COUNCIL PRIOR
- 20. COUNCIL'S ISSUED FOOTWAY DESIGN LEVELS TO BE INCORPORATED INTO THE FINISHED LEVELS ONCE ISSUED BY COUNCIL

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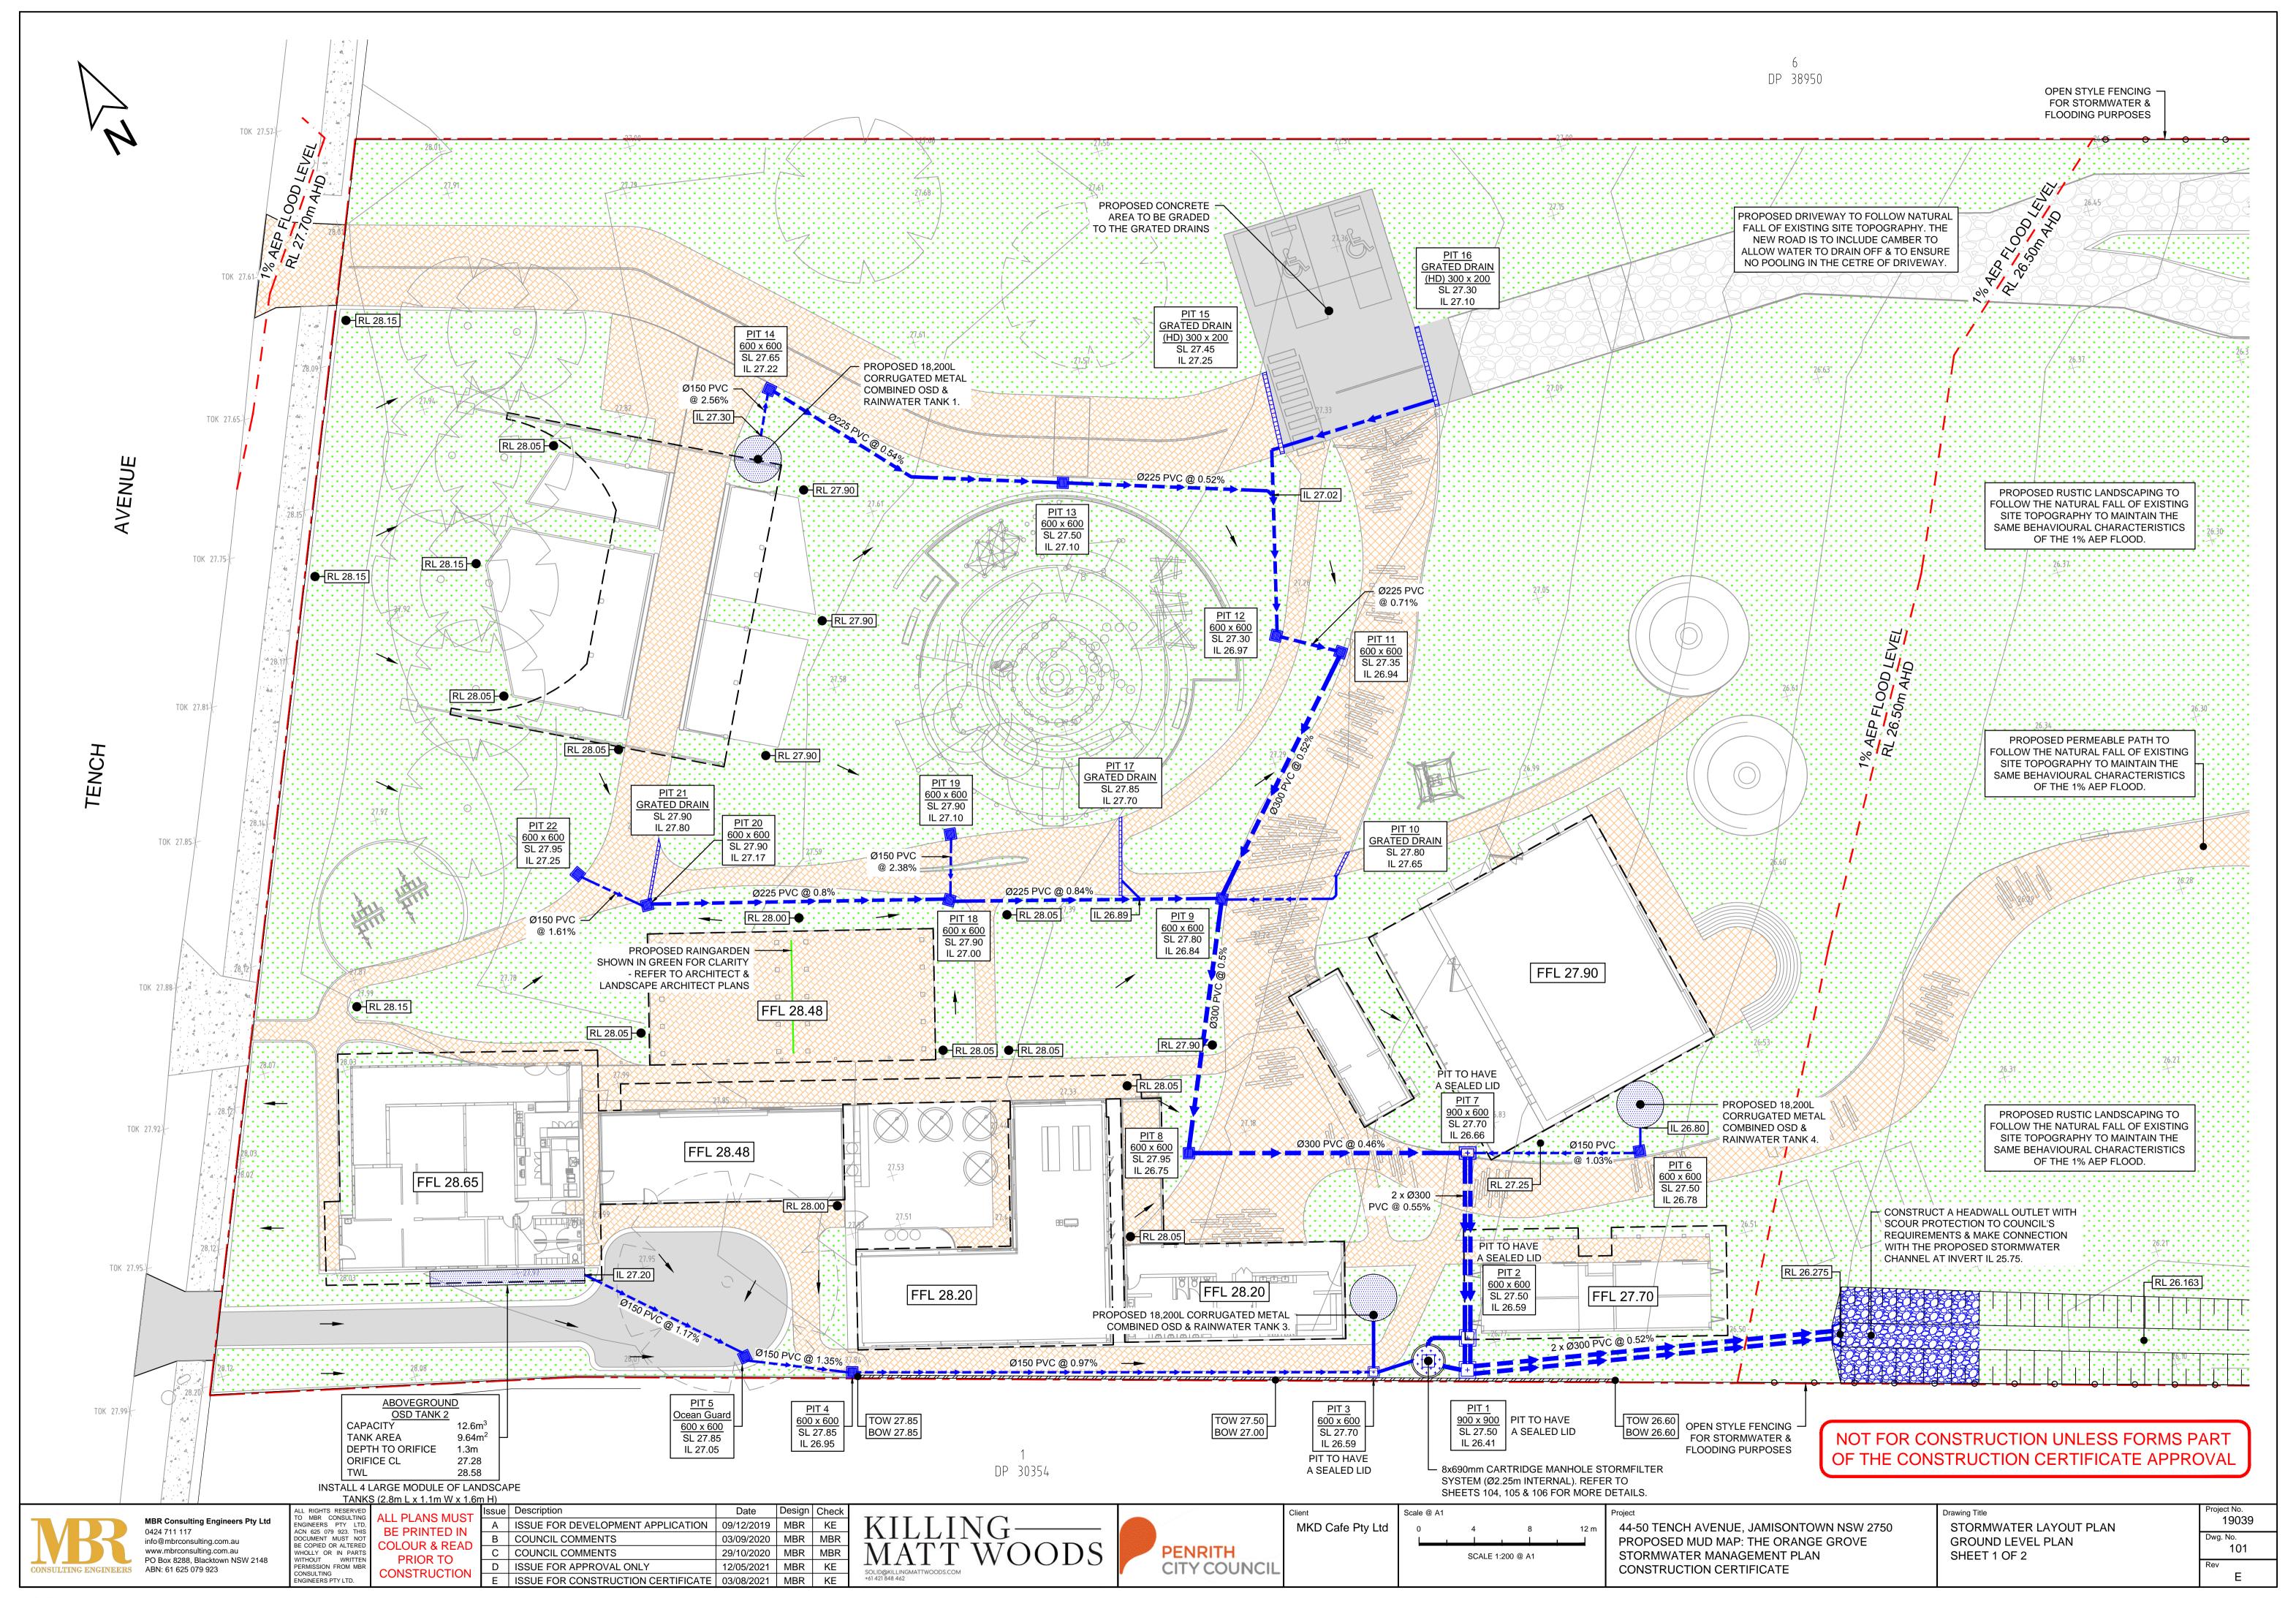
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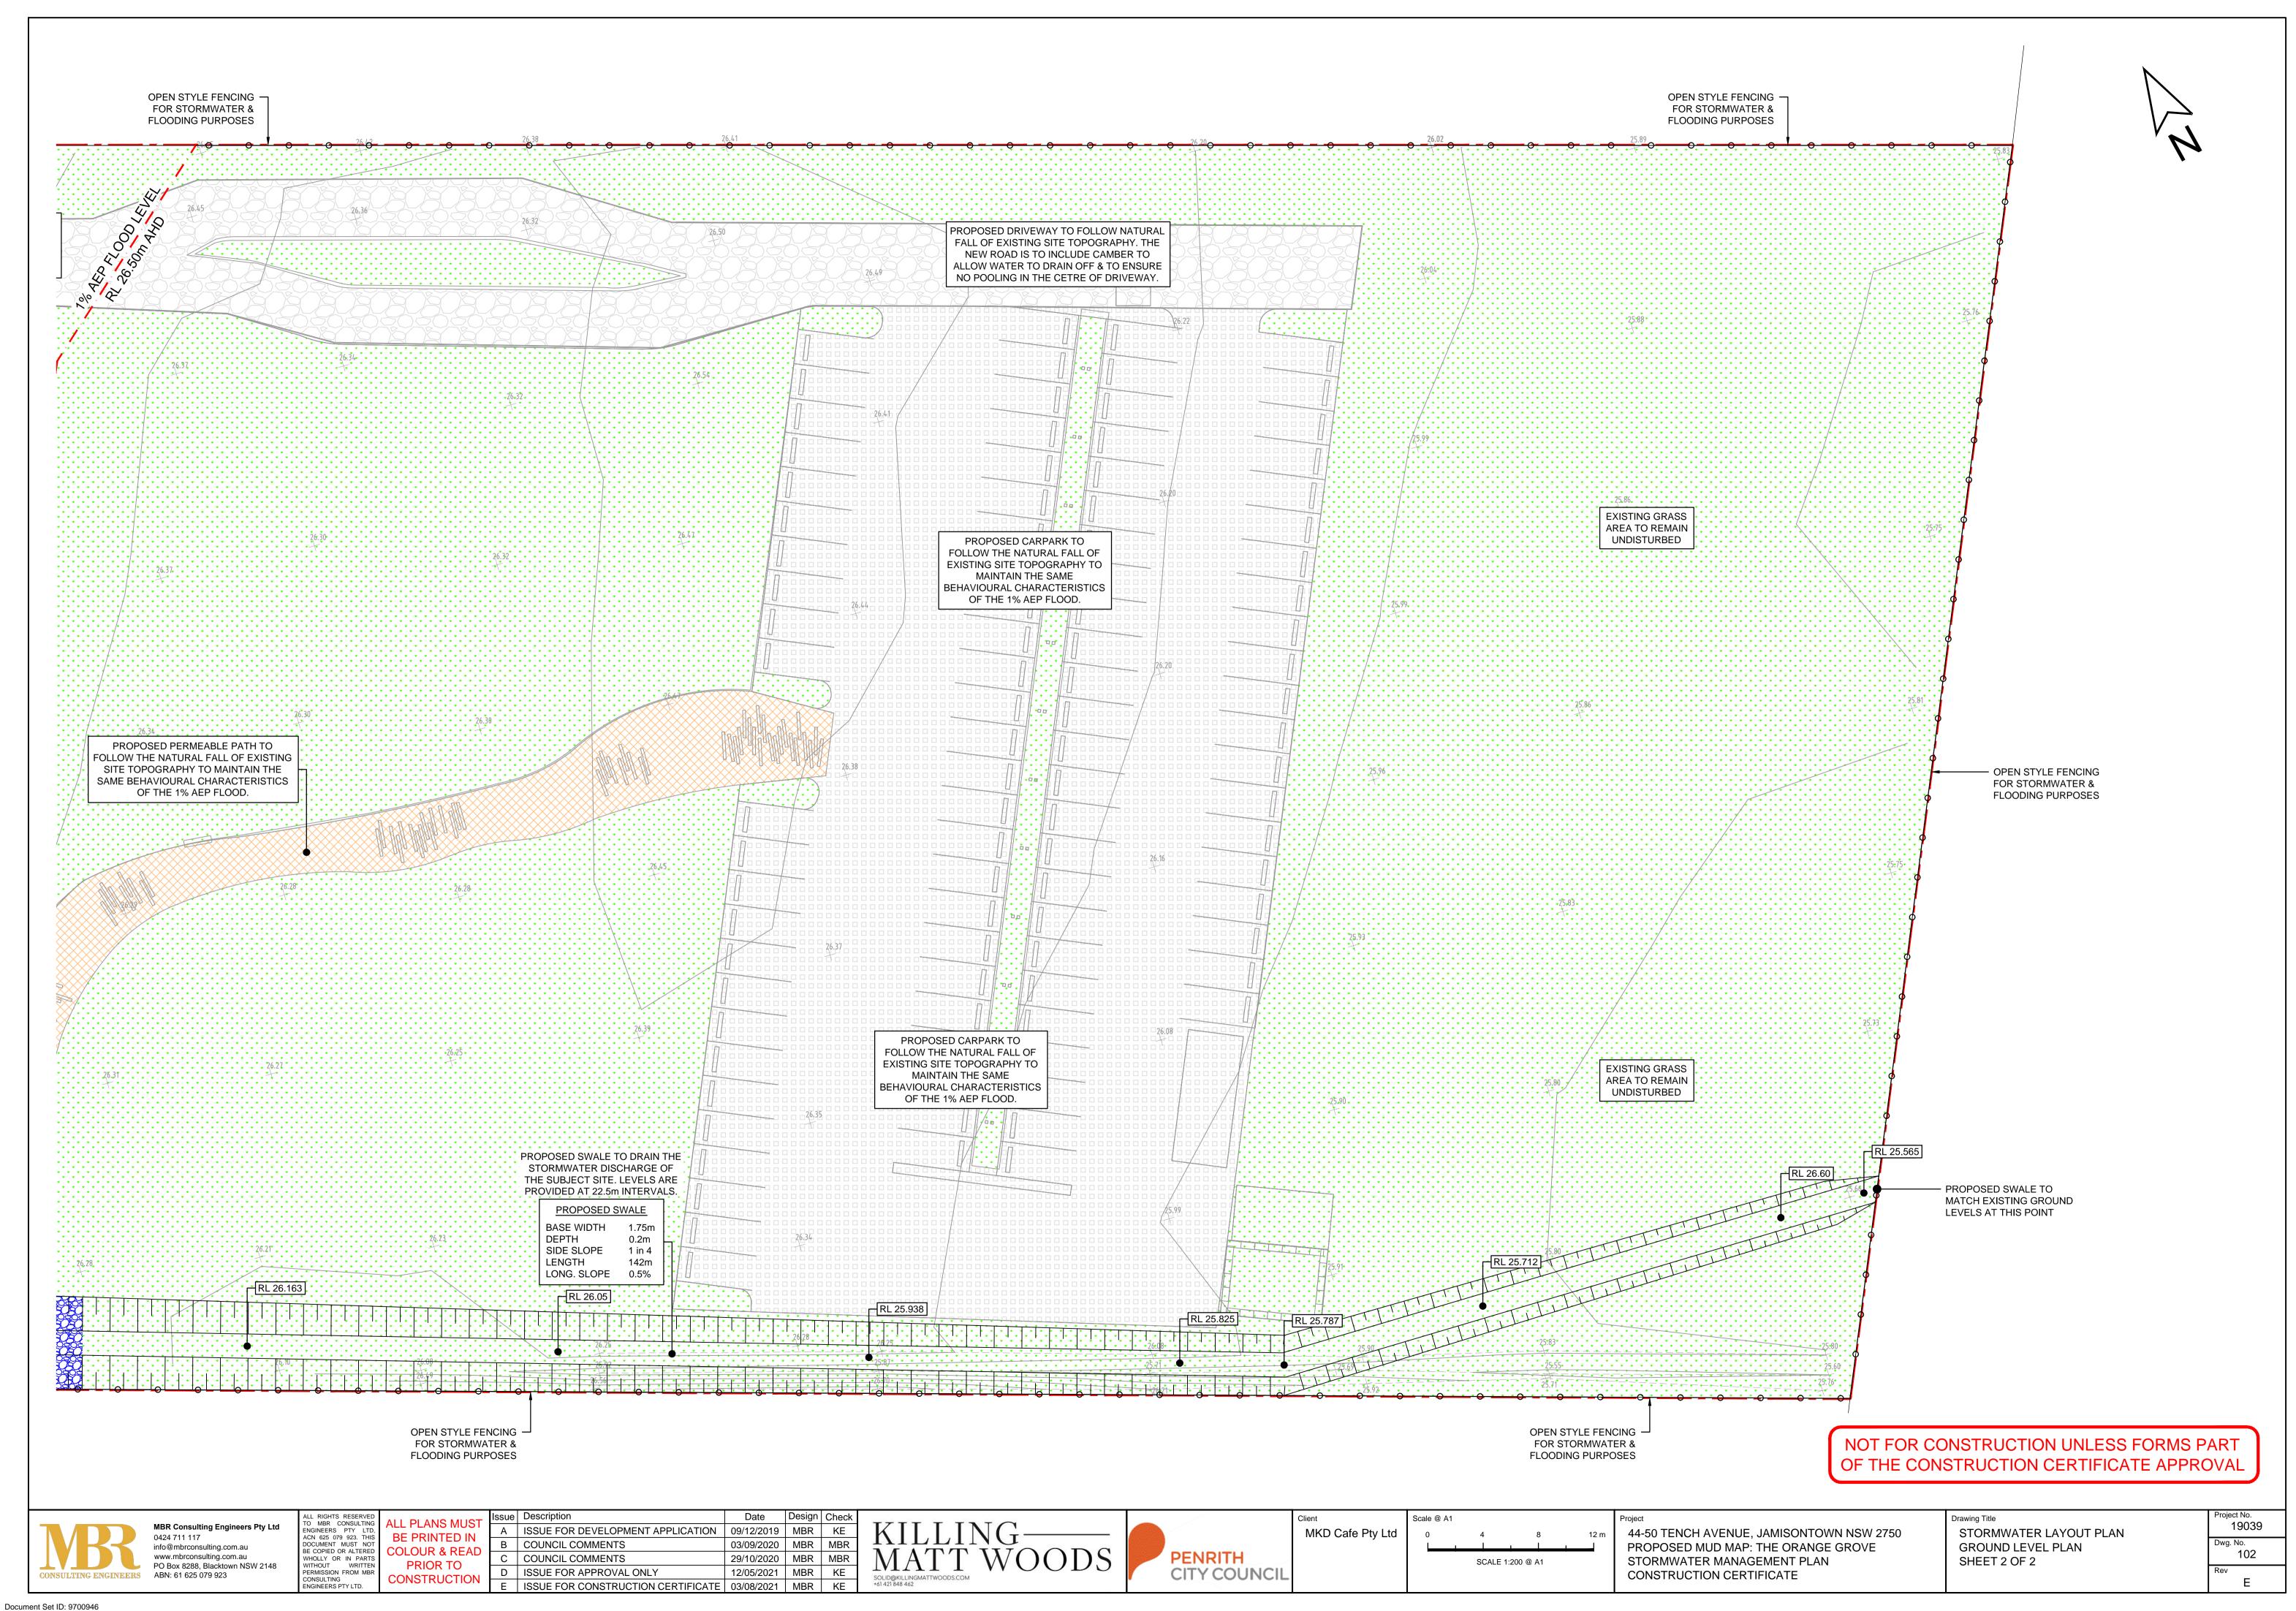
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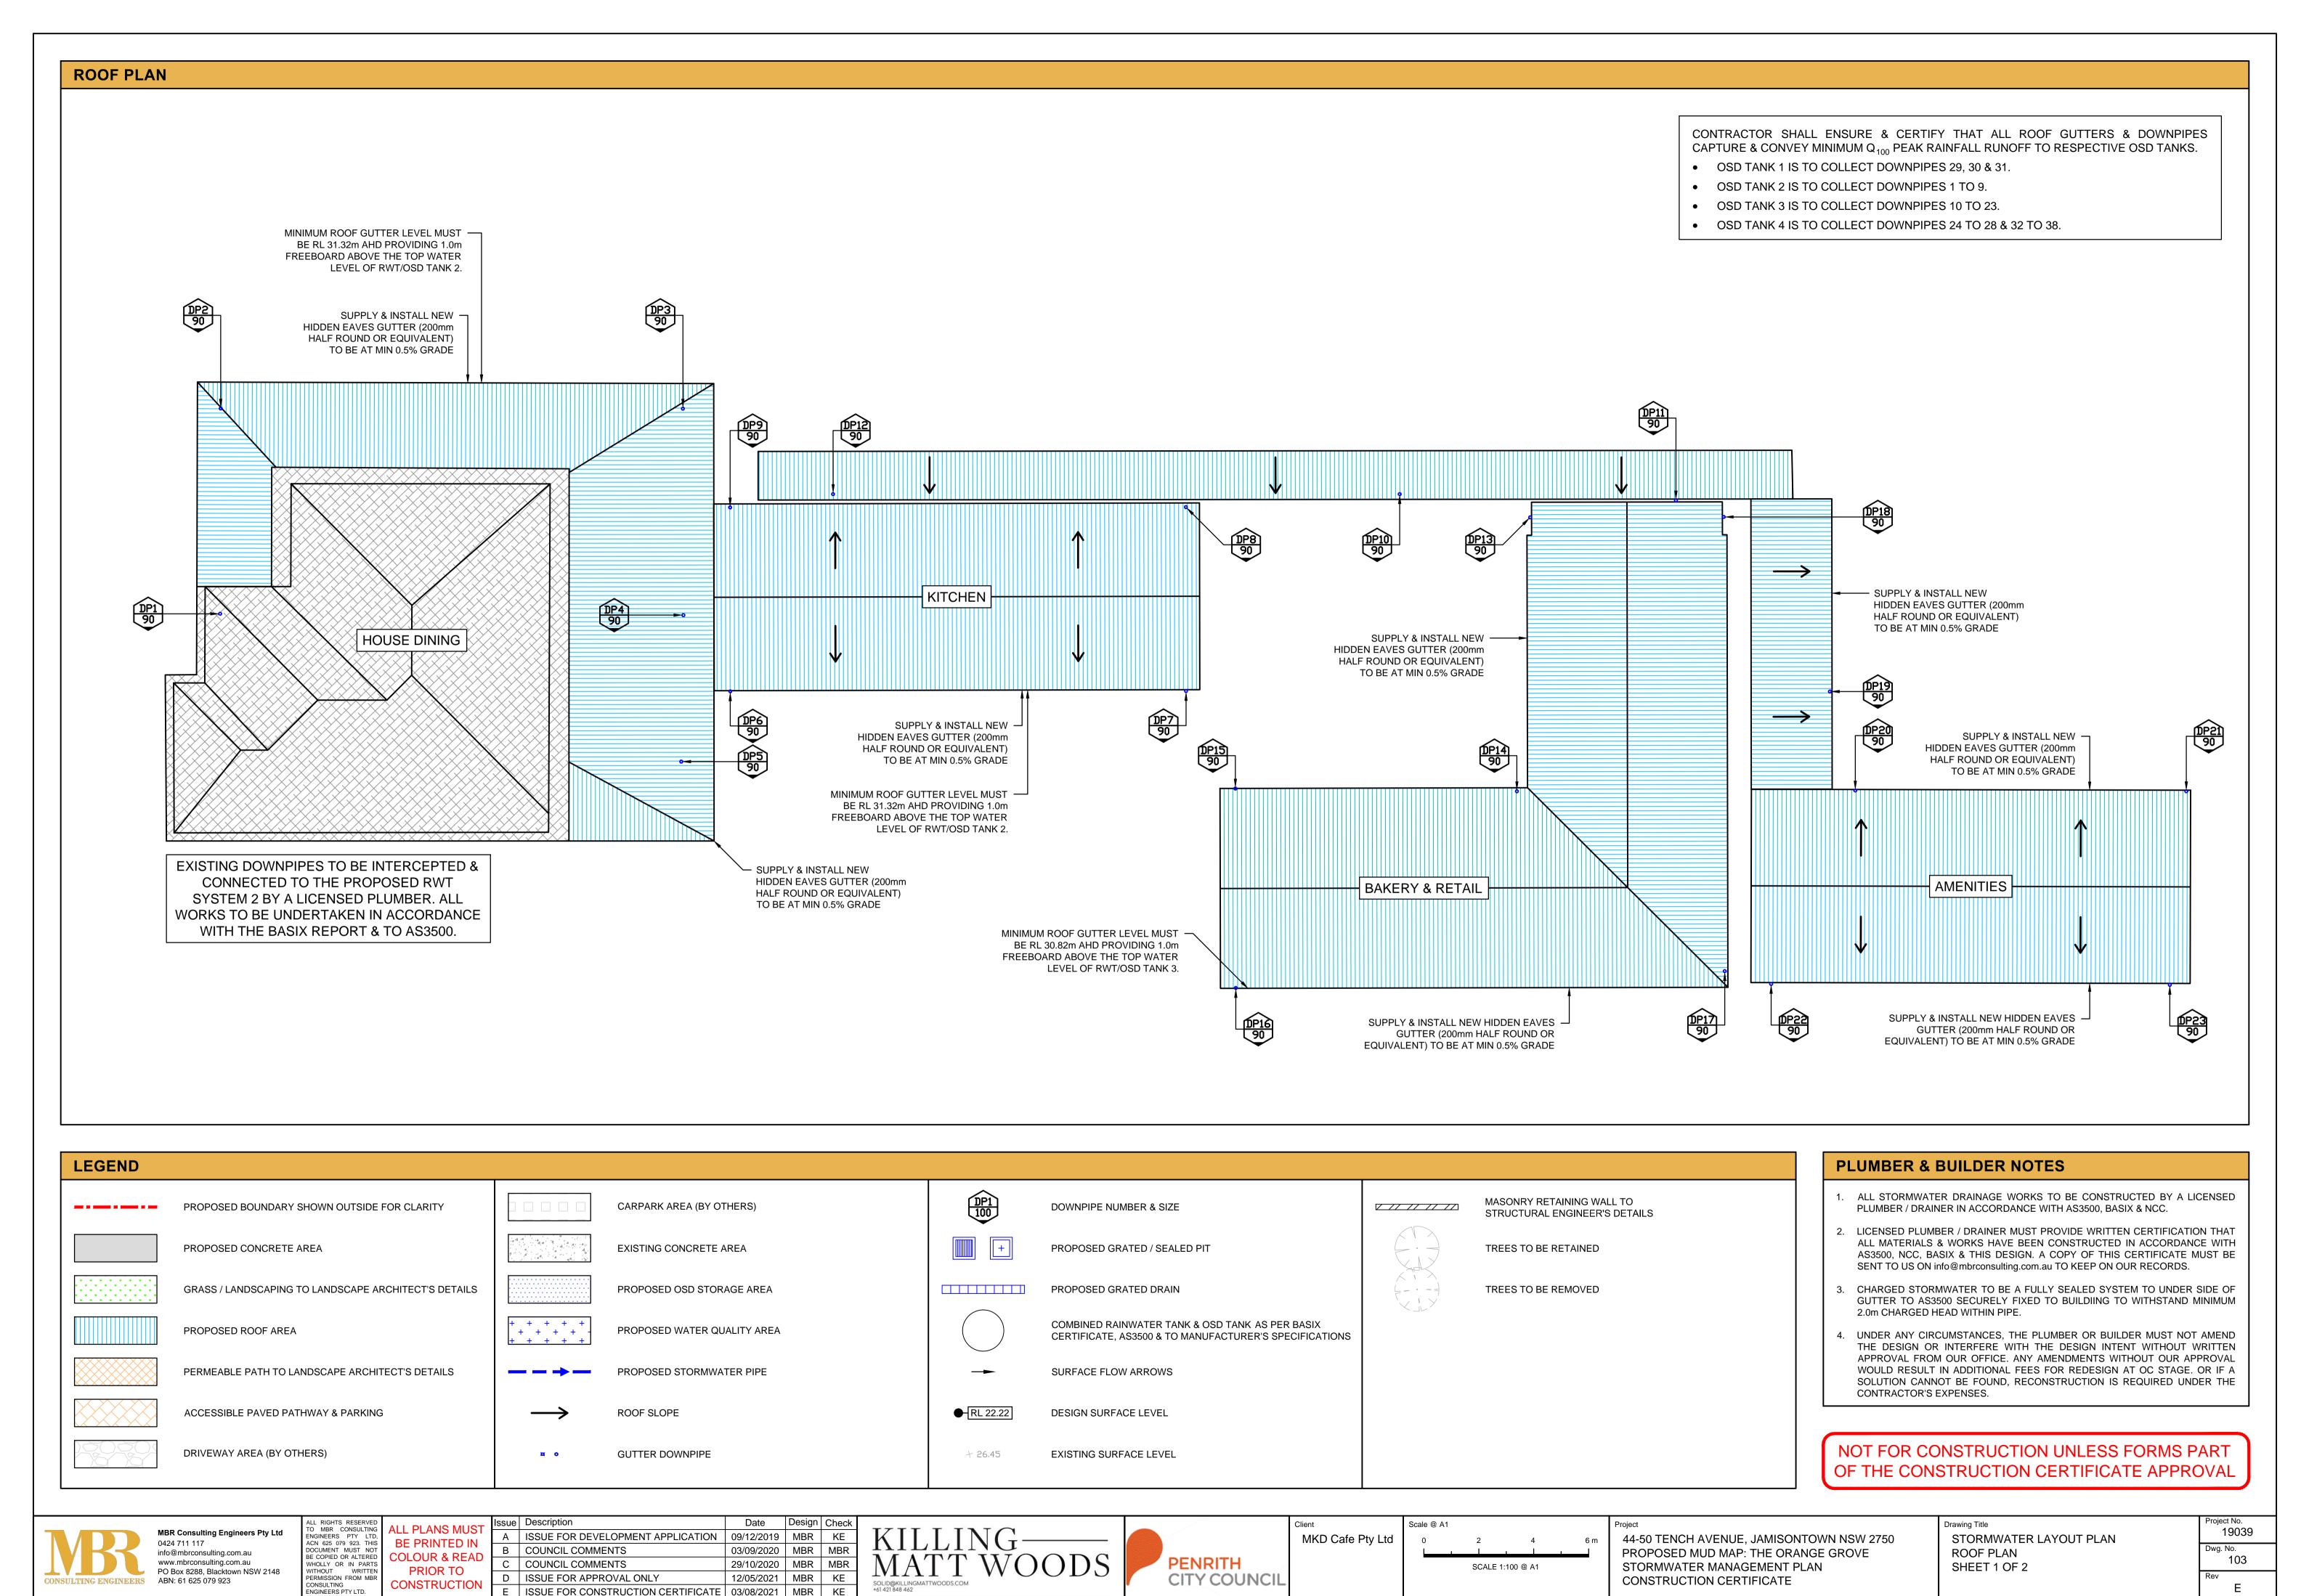
44-50 TENCH AVENUE, JAMISONTOWN NSW 2750 PROPOSED MUD MAP: THE ORANGE GROVE STORMWATER MANAGEMENT PLAN CONSTRUCTION CERTIFICATE

COVER SHEET, NOTES & DRAWING INDEX


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### RAINWATER TANK NOTES

- THE RAINWATER TANK(s) IS TO BE:
- ERECTED ON A SELF-SUPPOSTING BASE IN THE APPROVED LOCATION ON THE PROPERTY IN ACCORDANCE WITH THE

STAMPED-APPROVED SITE PLANS FOR THE DEVELOPMENT,

- STRUCTURALLY SOUND & CONSTRUCTED IN ACCORDANCE WITH AS/NZS 3500 1.2 - 1998: NATIONAL PLUMBING & DRAINAGE -WATER SUPPLY - ACCEPTABLE SOLUTIONS,
- FULLY ENCLOSED & ALL OPENINGS SEALED TO PREVENT ACCESS BY MOSQUITOES,
- FITTED WITH A FIRST FLUSH DEVICE, FITTED WITH A TRICKLE SYSTEM TO TOP UP FROM MAINS
- WATER, PROVIDED WITH AN AIR GAP,
- INSTALLED BY A LICENSED PLUMBER IN ACCORDANCE WITH SYDNEY WATER'S 'PLUMBING REQUIREMENTS INFORMATION FOR RAINWATER TANK SUPPLIERS & PLUMBERS APRIL 2003' & THE NSW CODE OF PRACTICE: PLUMBING & DRAINAGE.
- ADDITIONALLY, THE FOLLOWING ARE TO BE PROVIDED: A BACK FLOW PREVENTION DEVICE SHALL BE PROVIDED AT THE WATER METER IN ACCORDANCE WITH SYDNEY WATER
- REQUIREMENTS. IN THE EVENT OF A POWER FAILURE, A BACK UP SUPPLY OF MAINS WATER SHALL BE PROVIDED TO AT LEAST ONE TOILET IN THE BUILDINGS.

- THE RAINWATER TANKS & ASSOCIATED PIPING ARE TO BE LABELLED 'RAINWATER - NOT FOR DRINKING' IN ACCORDANCE WITH SYDNEY WATER REQUIREMENTS.
- THE RAINWATER TANKS & PIPEWORK ARE TO BE PAINTED IN COLOURS MATCHING THE EXTERNAL FINISHES OF THE BUILDINGS & ARE TO BE OF NON-REFLECTIVE FINISH.
- THE OVERFLOW FOR THE RAINWATER TANKS ARE TO BE CONNECTED INTO THE EXISTING STORMWATER DISPOSAL SYSTEM ON THE SITE.

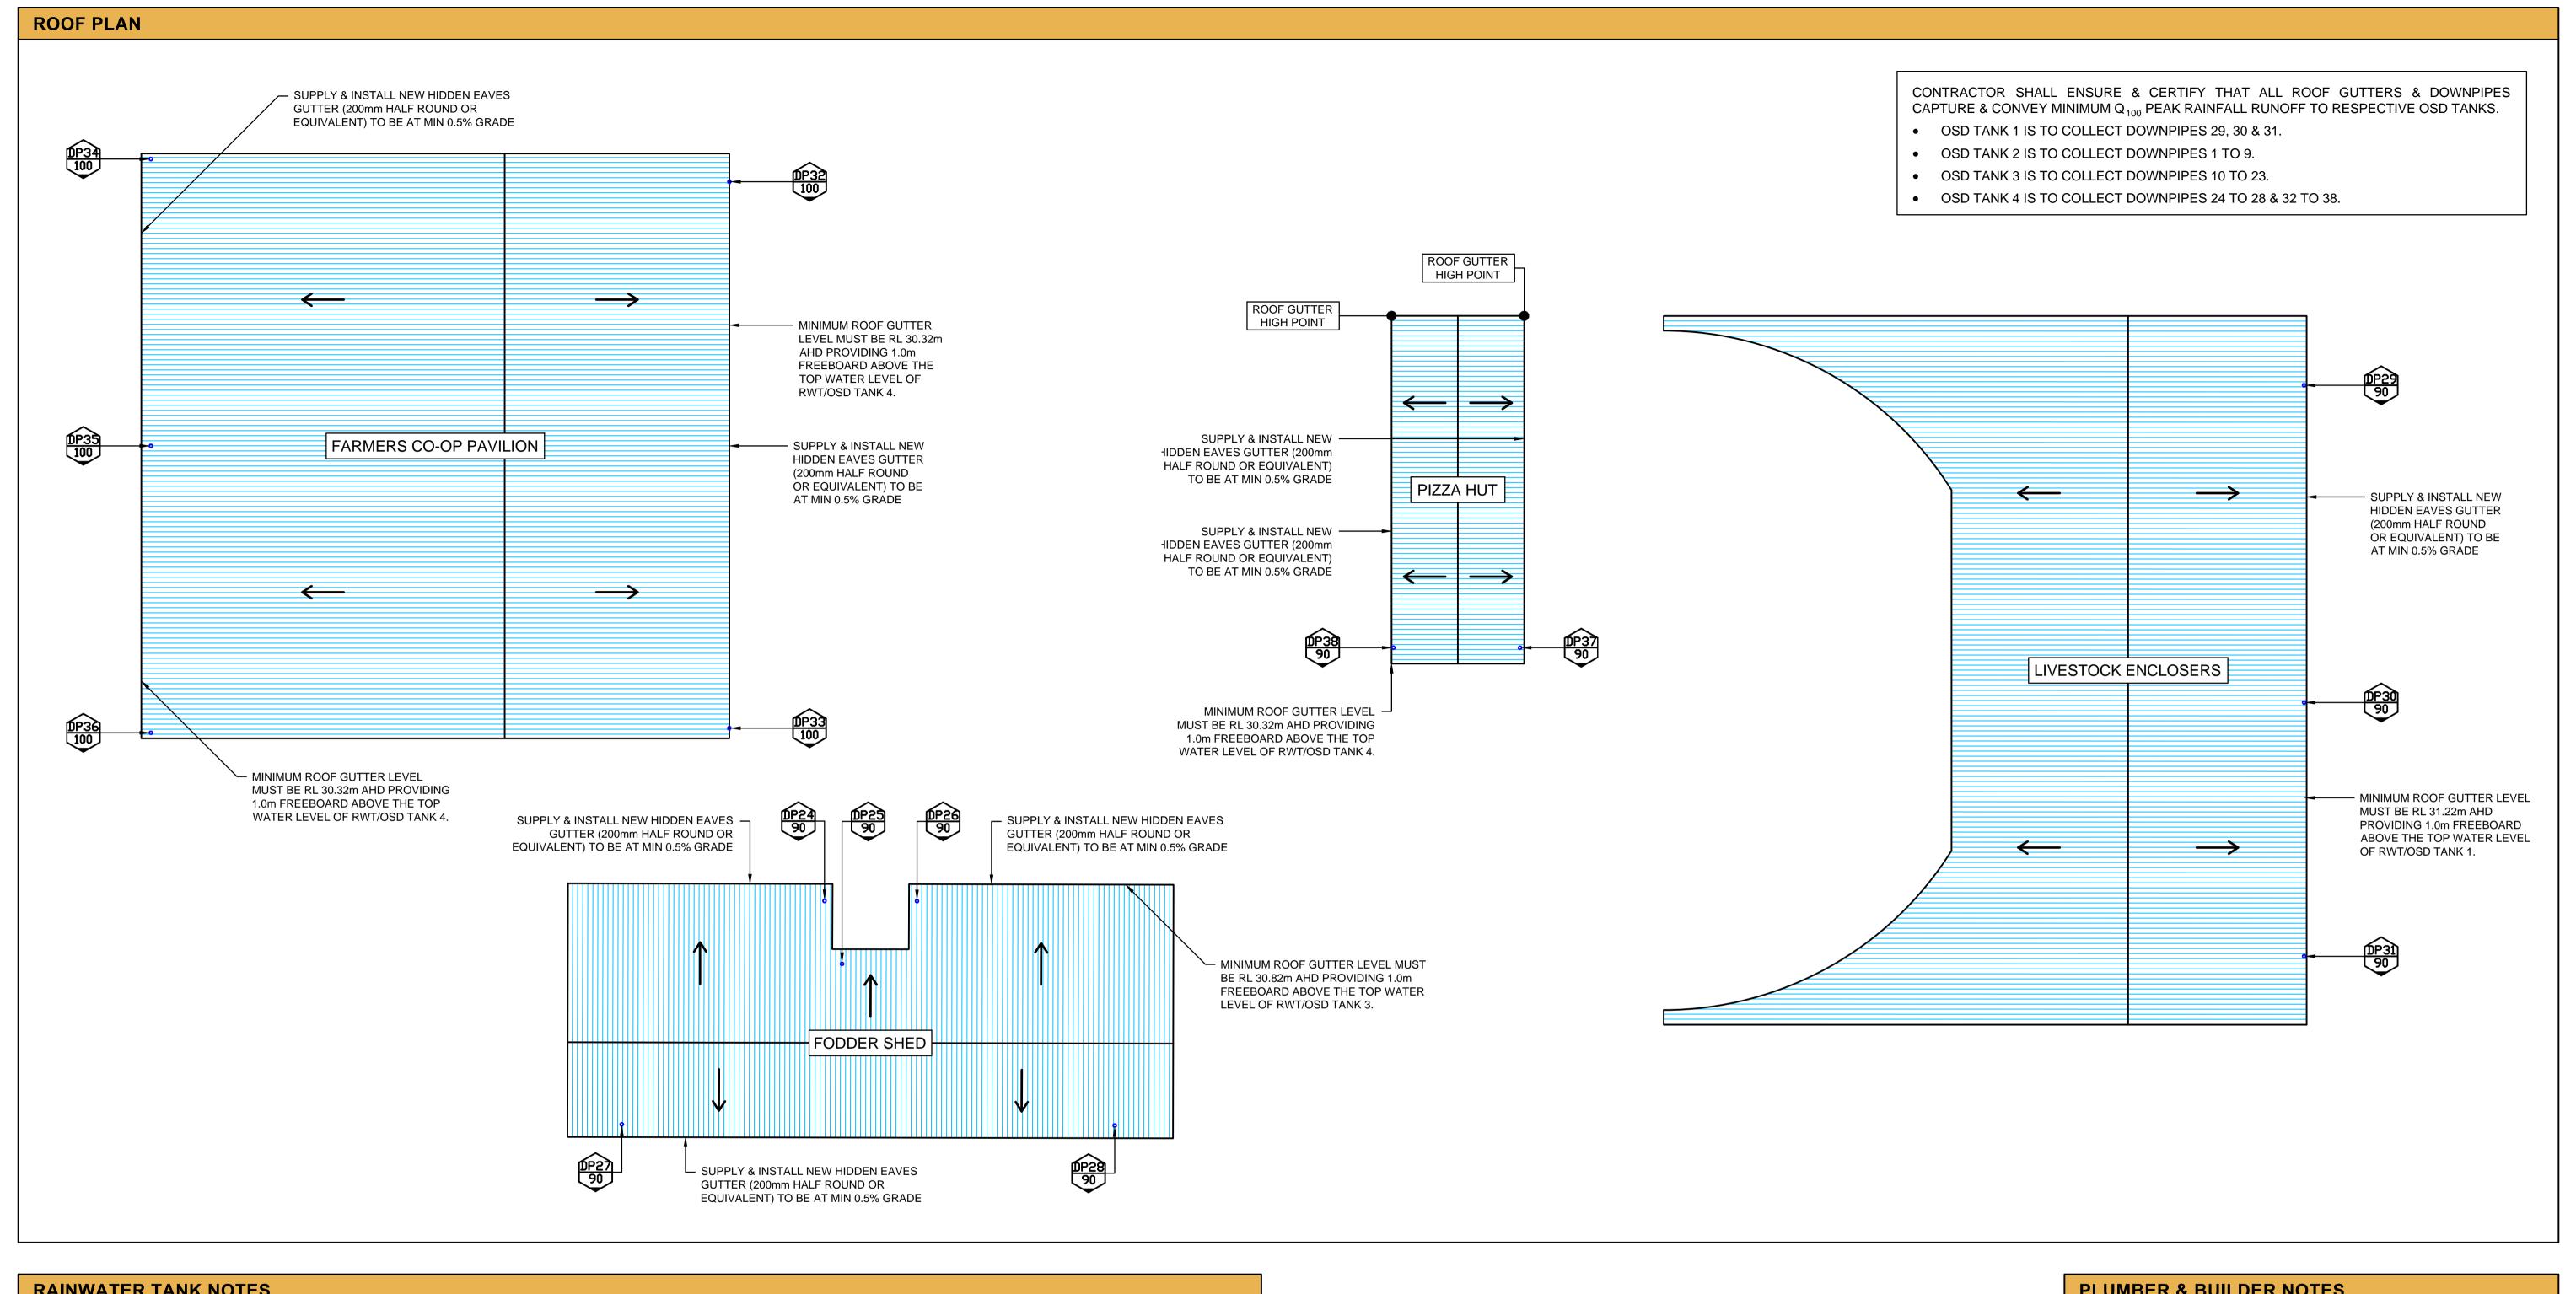BEFORE THE RAINWATER TANK CAN BE USED, A CERTIFICATE OR SUITABLE DOCUMENT IS TO BE SUBMITTED TO THE PRINCIPAL CERTIFYING AUTHORITY STATING THAT THE RAINWATER TANKS HAVE BEEN INSTALLED IN ACCORDANCE WITH:

 THE MANUFACTURER'S SPECIFICATIONS, & SYDNEY WATER & NSW HEALTH REQUIREMENTS.

OCCUPATION CERTIFICATE.

THIS CERTIFICATE OR DOCUMENTATION IS TO BE PROVIDED BY THE LICENSED PLUMBER WHO INSTALLED THE RAINWATER TANKS ON THE PROPERTY, & IS TO BE SUBMITTED PRIOR TO THE ISSUE OF THE

THE CATCHMENT AREA (FOR THE RAINWATER TANKS) INCLUDE THE PART OF THE ROOF OF THE DWELLINGS FROM WHICH WATER IS COLLECTED & INCLUDES GUTTERS. TO ENSURE A SAFE SUPPLY OF

- ROOF CATCHMENT AREAS MUST BE KEPT CLEAR OF OVERHANGING VEGETATION:
- GUTTERS MUST HAVE SUFFICIENT FALL TO DOWNPIPES TO PREVENT POOLING OF WATER;
- OVERFLOW, DISCHARGE FROM BLEED OFF PIPES FROM ROOF MOUNTED APPLIANCES SUCH AS AIR CONDITIONERS, HOT WATER SERVICES & SOLAR HEATERS MUST NOT BE
- DISCHARGED INTO THE RAINWATER CATCHMENT AREA; • FOR ROOFS CONTAINING LEAD BASED, TAR BASED OR ASBESTOS MATERIAL, THE TANK SUPPLY MUST NOT BE CONNECTED TO DRINKING, BATHING & GARDENING TAP WATER
- OUTLETS; • APPROPRIATE MEASURES MUST BE INSTALLED TO PREVENT FOREIGN MATERIALS FROM CONTAMINATING THE WATER WHICH ENTERS THE RAINWATER TANK.

THE RAINWATER TANKS' SUPPLY MUST NOT BE CONNECTED TO DRINKING & BATHING WATER TAP OUTLETS.

THE RAINWATER TANKS' PUMPS MUST NOT EXCEED 5dBA ABOVE AMBIENT BACKGROUND NOISE LEVEL AT THE NEAREST RESIDENTIAL PROPERTY BOUNDARY. THE PROVISIONS OF THE PROTECTION OF THE ENVIRONMENT OPERATIONS ACT 1997 APPLY TO THE DEVELOPMENT, IN TERMS OF REGULATING OFFENSIVE NOISE.

### **PLUMBER & BUILDER NOTES**

- 1. ALL STORMWATER DRAINAGE WORKS TO BE CONSTRUCTED BY A LICENSED PLUMBER / DRAINER IN ACCORDANCE WITH AS3500, BASIX & NCC.
- 2. LICENSED PLUMBER / DRAINER MUST PROVIDE WRITTEN CERTIFICATION THAT ALL MATERIALS & WORKS HAVE BEEN CONSTRUCTED IN ACCORDANCE WITH AS3500, NCC, BASIX & THIS DESIGN. A COPY OF THIS CERTIFICATE MUST BE SENT TO US ON info@mbrconsulting.com.au TO KEEP ON OUR RECORDS.
- 3. CHARGED STORMWATER TO BE A FULLY SEALED SYSTEM TO UNDER SIDE OF GUTTER TO AS3500 SECURELY FIXED TO BUILDIING TO WITHSTAND MINIMUM 2.0m CHARGED HEAD WITHIN PIPE.
- 4. UNDER ANY CIRCUMSTANCES, THE PLUMBER OR BUILDER MUST NOT AMEND THE DESIGN OR INTERFERE WITH THE DESIGN INTENT WITHOUT WRITTEN APPROVAL FROM OUR OFFICE. ANY AMENDMENTS WITHOUT OUR APPROVAL WOULD RESULT IN ADDITIONAL FEES FOR REDESIGN AT OC STAGE. OR IF A SOLUTION CANNOT BE FOUND, RECONSTRUCTION IS REQUIRED UNDER THE CONTRACTOR'S EXPENSES.

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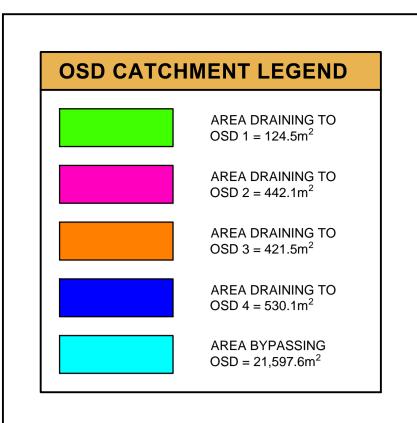
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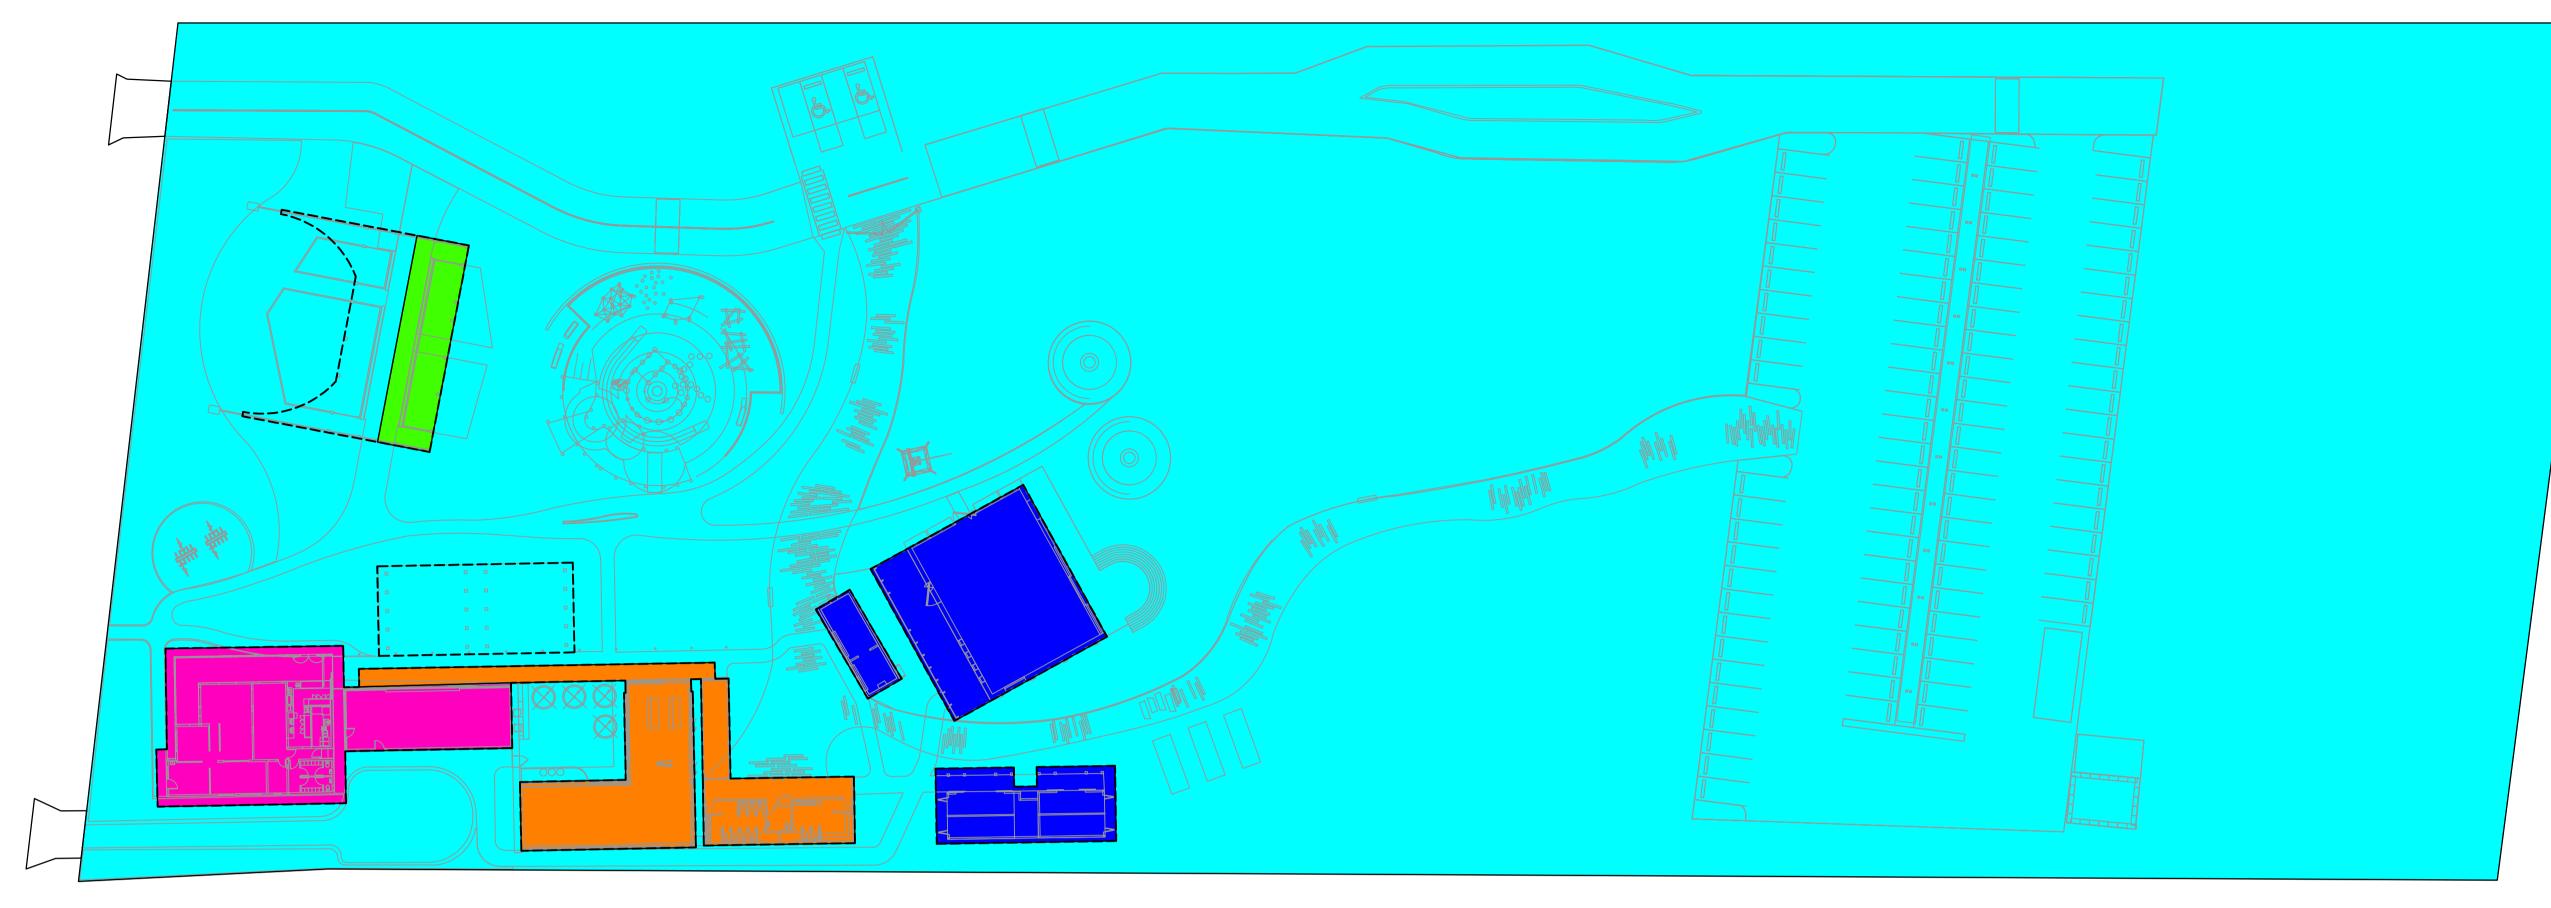
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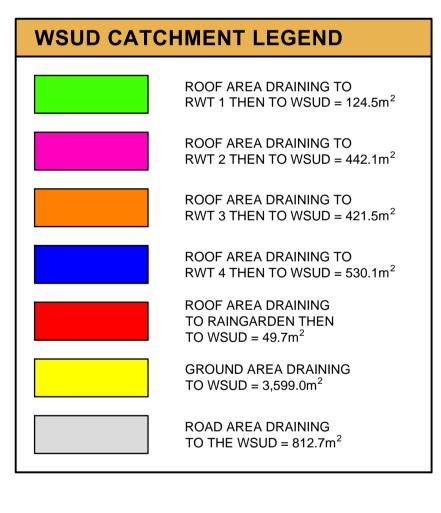
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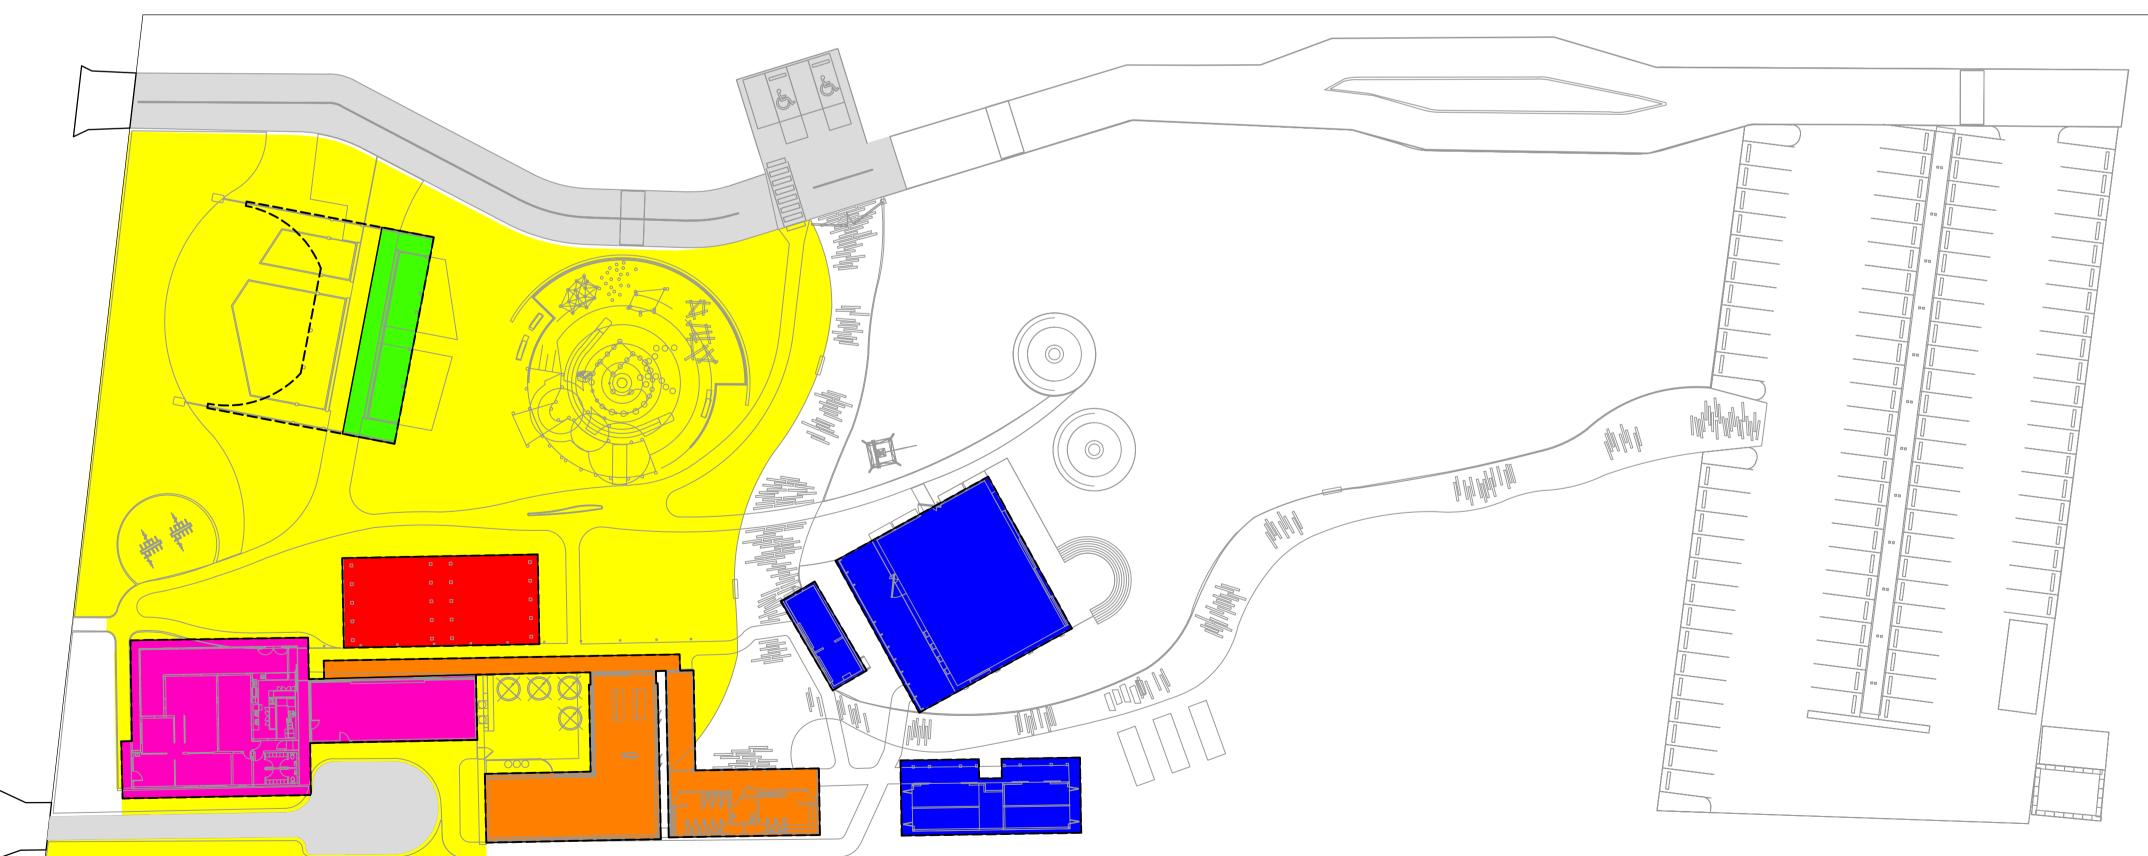
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### OSD CATCHMENT PLAN SCALE 1:400





WSUD CATCHMENT PLAN SCALE 1:400

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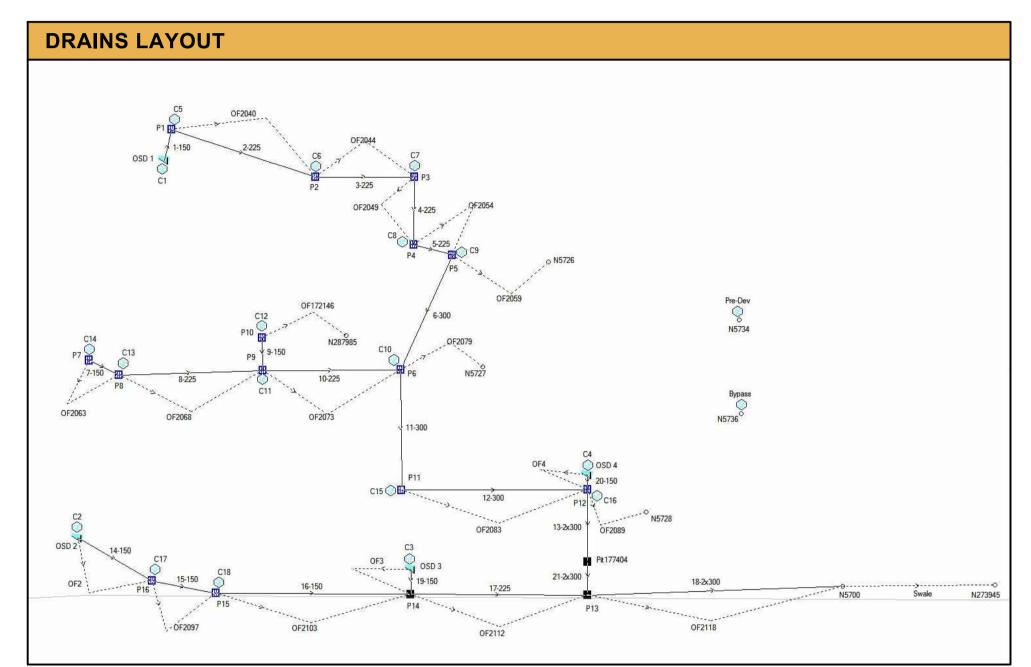
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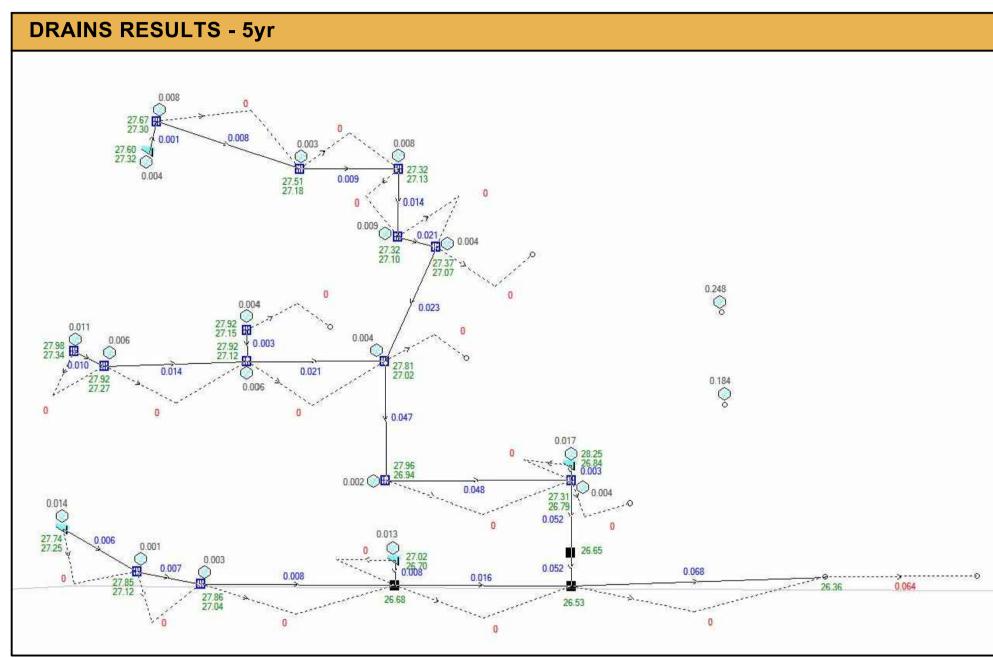
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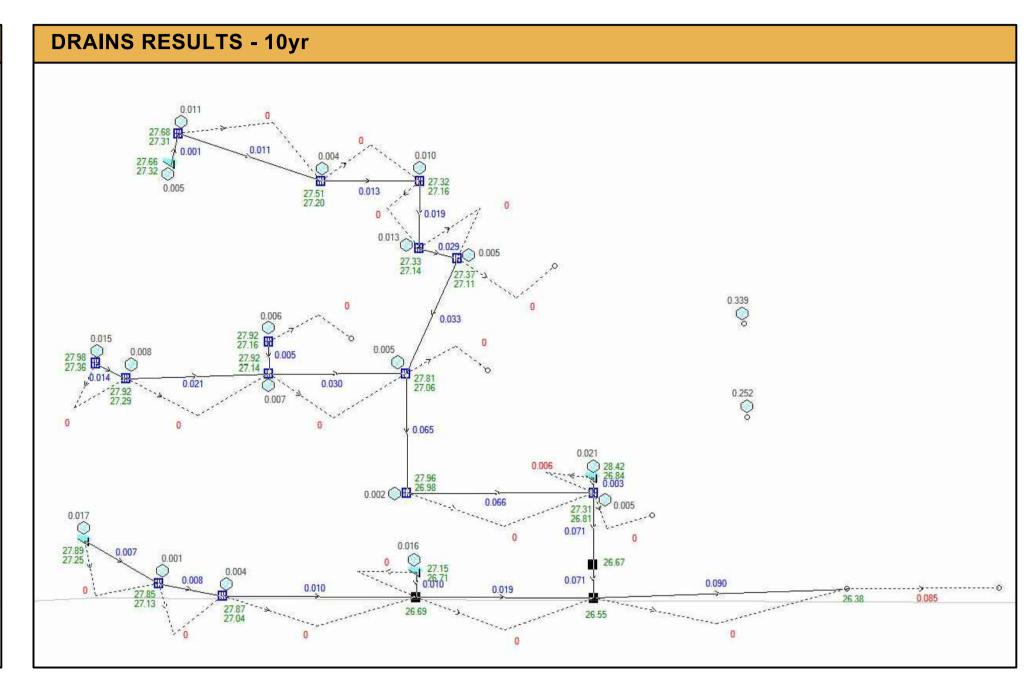
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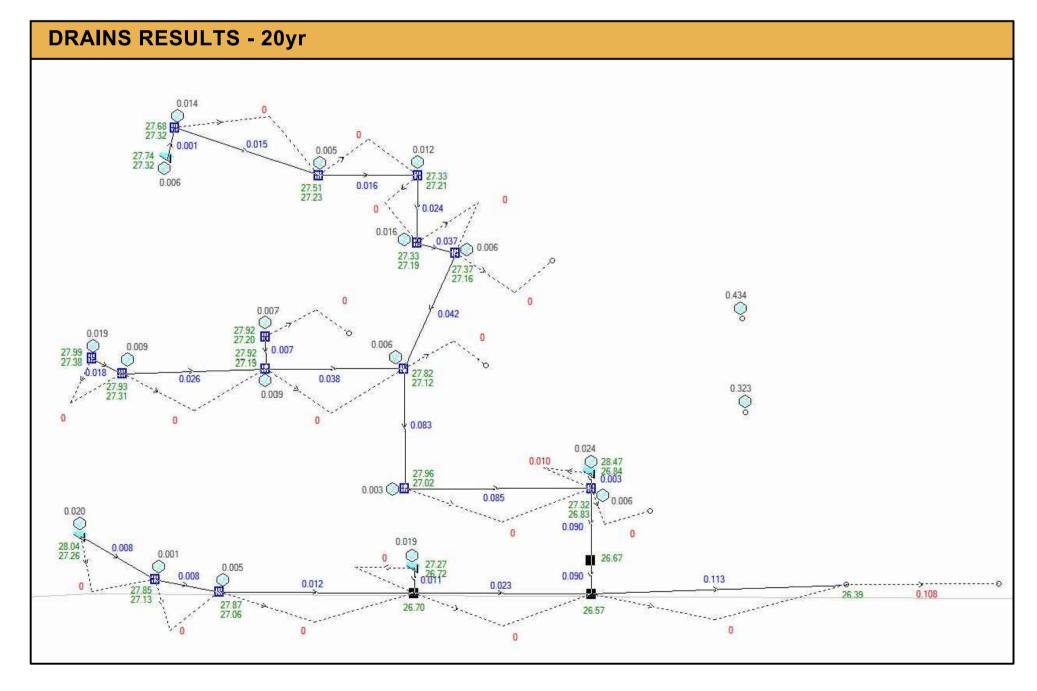
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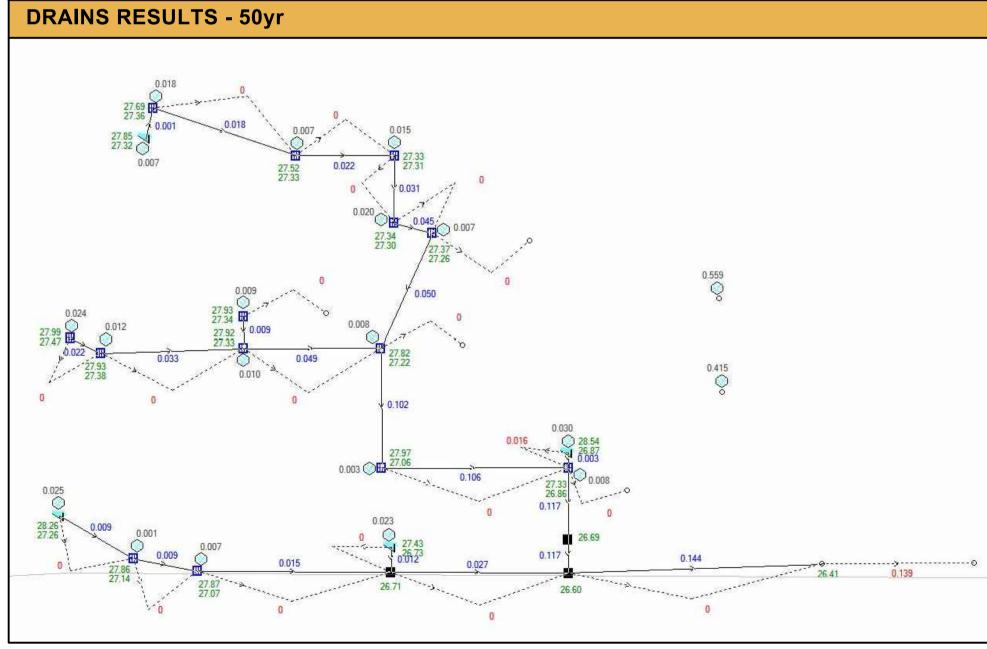
ON-SITE DETENTION PERFORMANCE SUMMARY															
STORM	PRE-	DEVELOPMENT	POST-DEVELOPMENT												
EVENT	DISCHARGE (l/s)	DOWNSTREAM WATER LEVEL (m AHD)	ORIFICE 1 DISCHARGE (I/s)	ORIFICE 2 DISCHARGE (I/s)	ORIFICE 3 DISCHARGE (I/s)	ORIFICE 4 DISCHARGE (I/s)	TOTAL SITE DISCHARGE (I/s)	VOLUME 1 (m <sup>3</sup> )	VOLUME 2 (m <sup>3</sup> )	VOLUME 3 (m <sup>3</sup> )	VOLUME 4 (m <sup>3</sup> )	TWL 1 (m AHD)	TWL 2 (m AHD)	TWL 3 (m AHD)	TWL 4 (m AHD)
$Q_5$	248	26.20	1	6	8	3	248	2.40	5.04	2.89	11.61	28.805	27.740	28.766	28.823
Q <sub>10</sub>	339	26.25	1	7	10	3	337	2.87	6.43	3.92	12.94	28.864	27.889	28.897	28.990
Q <sub>20</sub>	434	26.35	1	8	11	3	431	3.44	7.88	4.87	13.37	28.937	28.045	29.018	29.043
Q <sub>50</sub>	559	26.40	1	9	12	3	554	4.32	9.89	6.14	13.88	29.048	28.260	29.179	29.107
Q <sub>100</sub>	654	26.50	2	10	13	4	642	5.0	11.58	7.36	14.21	29.134	28.441	29.333	29.148












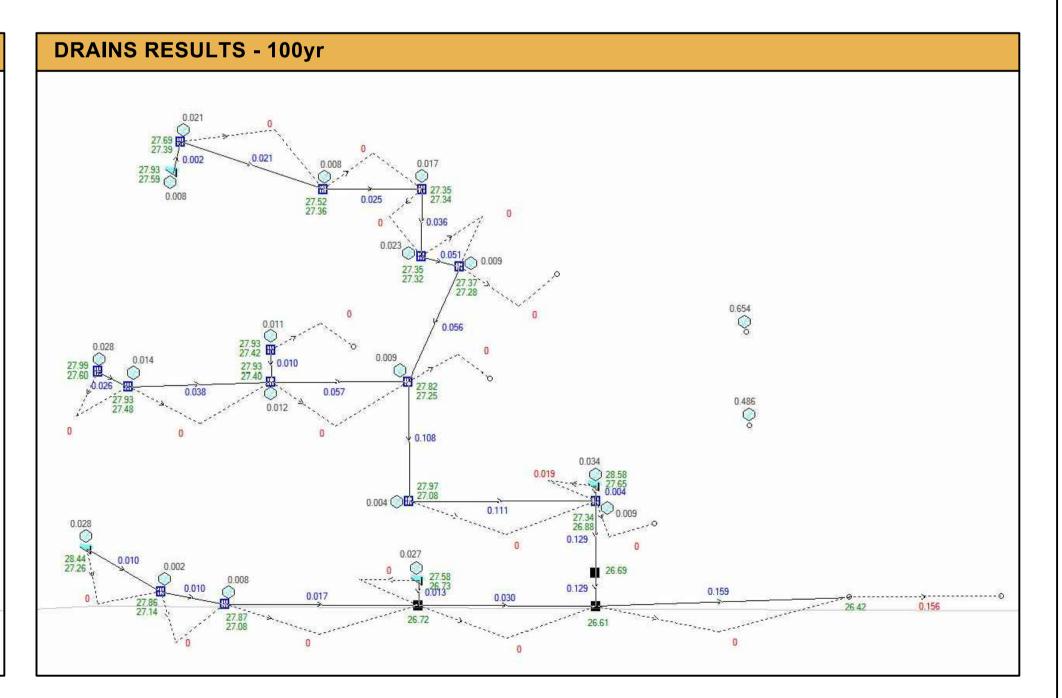

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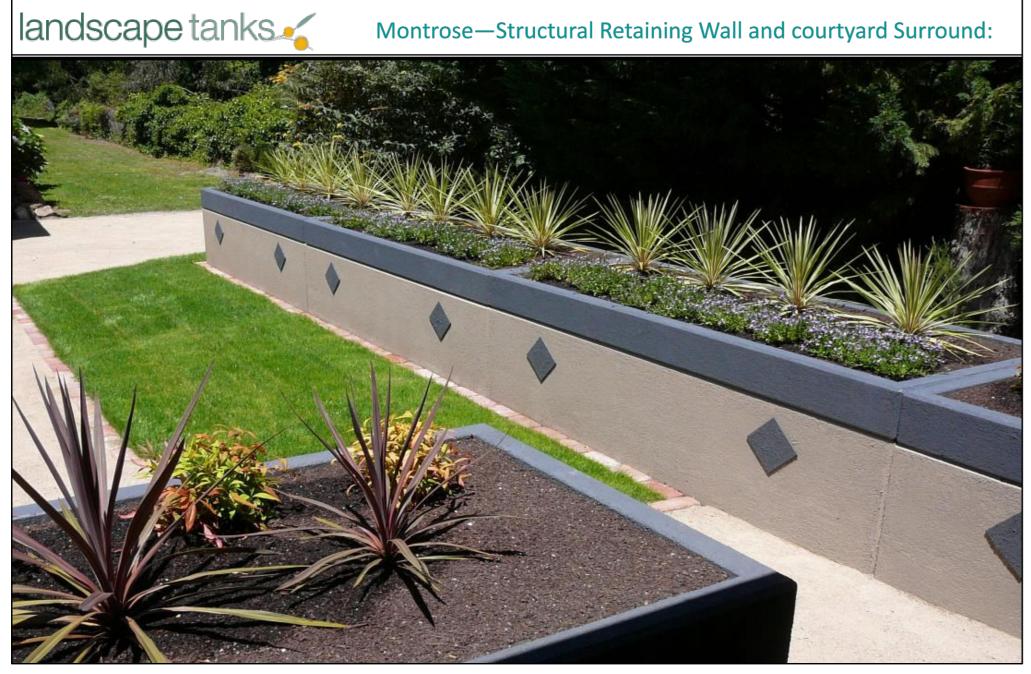
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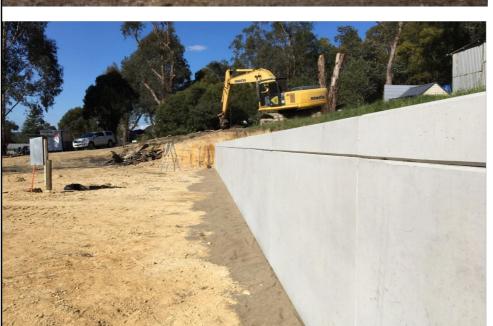
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Drawing Title OSD & WSUD DETAILS & CALCULATION SHEETS SHEET 1 OF 4 Project No. 19039 106


### LANDSCAPE TANKS DETAILS









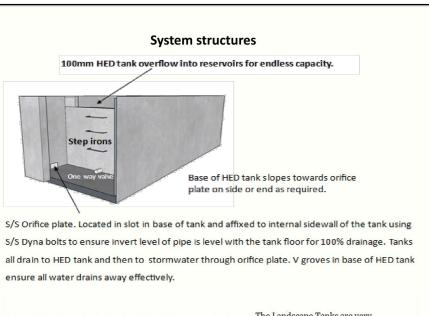


The Landscape Tanks are very versatile and there are many and varied ways of configuring them to suit your project. The options offer endless water storage reservoir capacity. Place the HED unit (incorporating a pit and mesh filter) anywhere in the system to suit. Handy, lockable, easy access cover is standard


### Commercial and high flow environments.


4 1° decline - eliminates ponding



The Landscape Tanks can also be "open vented" to allow the tanks to take as much water as possible or when full, the excess stormwater (1/100 year storm) will flow to stormwater LPD. Large sized piping can be accommodated in this

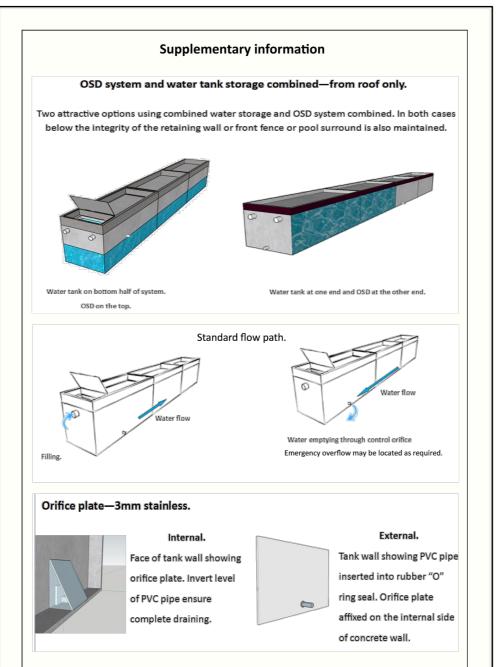

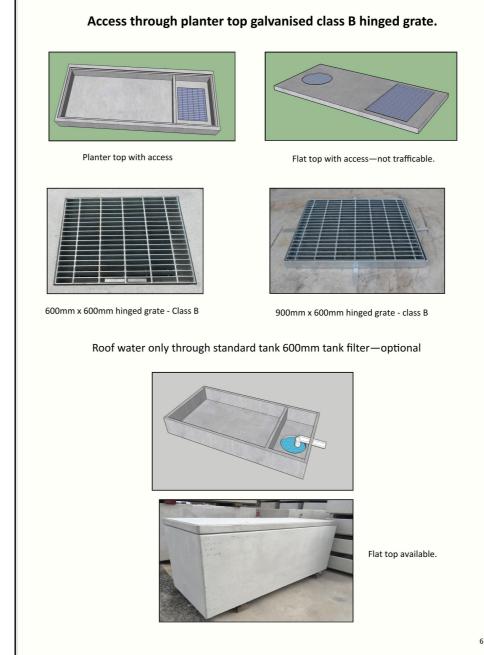

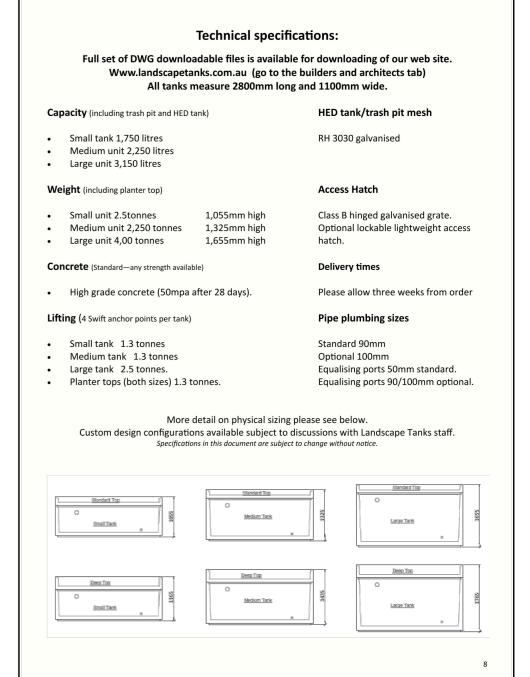

## **ON-SITE DETENTION NOTES**

- 1. THESE PLANS SHALL BE READ IN CONJUNCTION WITH APPROVED ARCHITECTURAL, LANDSCAPE, STRUCTURAL, HYDRAULIC, & OTHER SERVICES DRAWINGS & SPECIFICATIONS. IF THERE EXISTS AND DISCREPANCIES BETWEEN THE DRAWINGS, THE BUILDER SHALL REPORT THE DISCREPANCIES TO THE ENGINEER PRIOR TO COMMENCEMENT OF ANY WORKS.
- 2. THE OSD BASIN / TANK IS TO BE BUILT TO THE CORRECT LEVELS & SIZE AS PER THIS DESIGN. ANY VARIATIONS ARE TO BE DONE UNDER CONSULTATION FROM OUR OFFICE ONLY. ANY AMENDMENTS WITHOUT OUR APPROVAL WOULD RESULT IN ADDITIONAL FEES FOR REDESIGN AT OC STAGE OR IF A SOLUTION CANNOT BE FOUND, RECONSTRUCTION IS REQUIRED UNDER THE CONTRACTOR'S EXPENSES.


OSD 1 DESIGN PARAMETERS							
ORIFICE INVERT LEVEL	28.50	m AHD					
ORIFICE CENTERLINE	28.55	m AHD					
ORIFICE DIAMETER	30	mm					
DESIGN TOP WATER LEVEL	29.92	m AHD					
HEAD TO ORIFICE	1.37	m					
BASE AREA	8.20	$m^2$					
VOLUME PROVIDED	11.20	m <sup>3</sup>					

OSD 2 DESIGN PARAMETERS						
ORIFICE INVERT LEVEL	27.20	m AHD				
ORIFICE CENTERLINE	27.25	m AHD				
ORIFICE DIAMETER	65	mm				
DESIGN TOP WATER LEVEL	28.55	m AHD				
HEAD TO ORIFICE	1.3	m				
BASE AREA	9.64	$m^2$				
VOLUME PROVIDED	12.6	$m^3$				

PROPOSED RAINWATER TANKS MUST BE INSTALLED TO BE RE-USED FOR IRRIGATION & FOR TOILET FLUSHING (10 TOILETS IN TOTAL AT 100 litres/day PER TOILET).

### **COMBINED TANK 1**

7.0m<sup>3</sup> FOR BASIX & EFFECTIVE 11.20m<sup>3</sup> FOR OSD. USE 18.2m<sup>3</sup> ROUND RAINWATER TANK, TO MANUFACTURER'S & SYDNEY WATER'S SPECIFICATIONS.

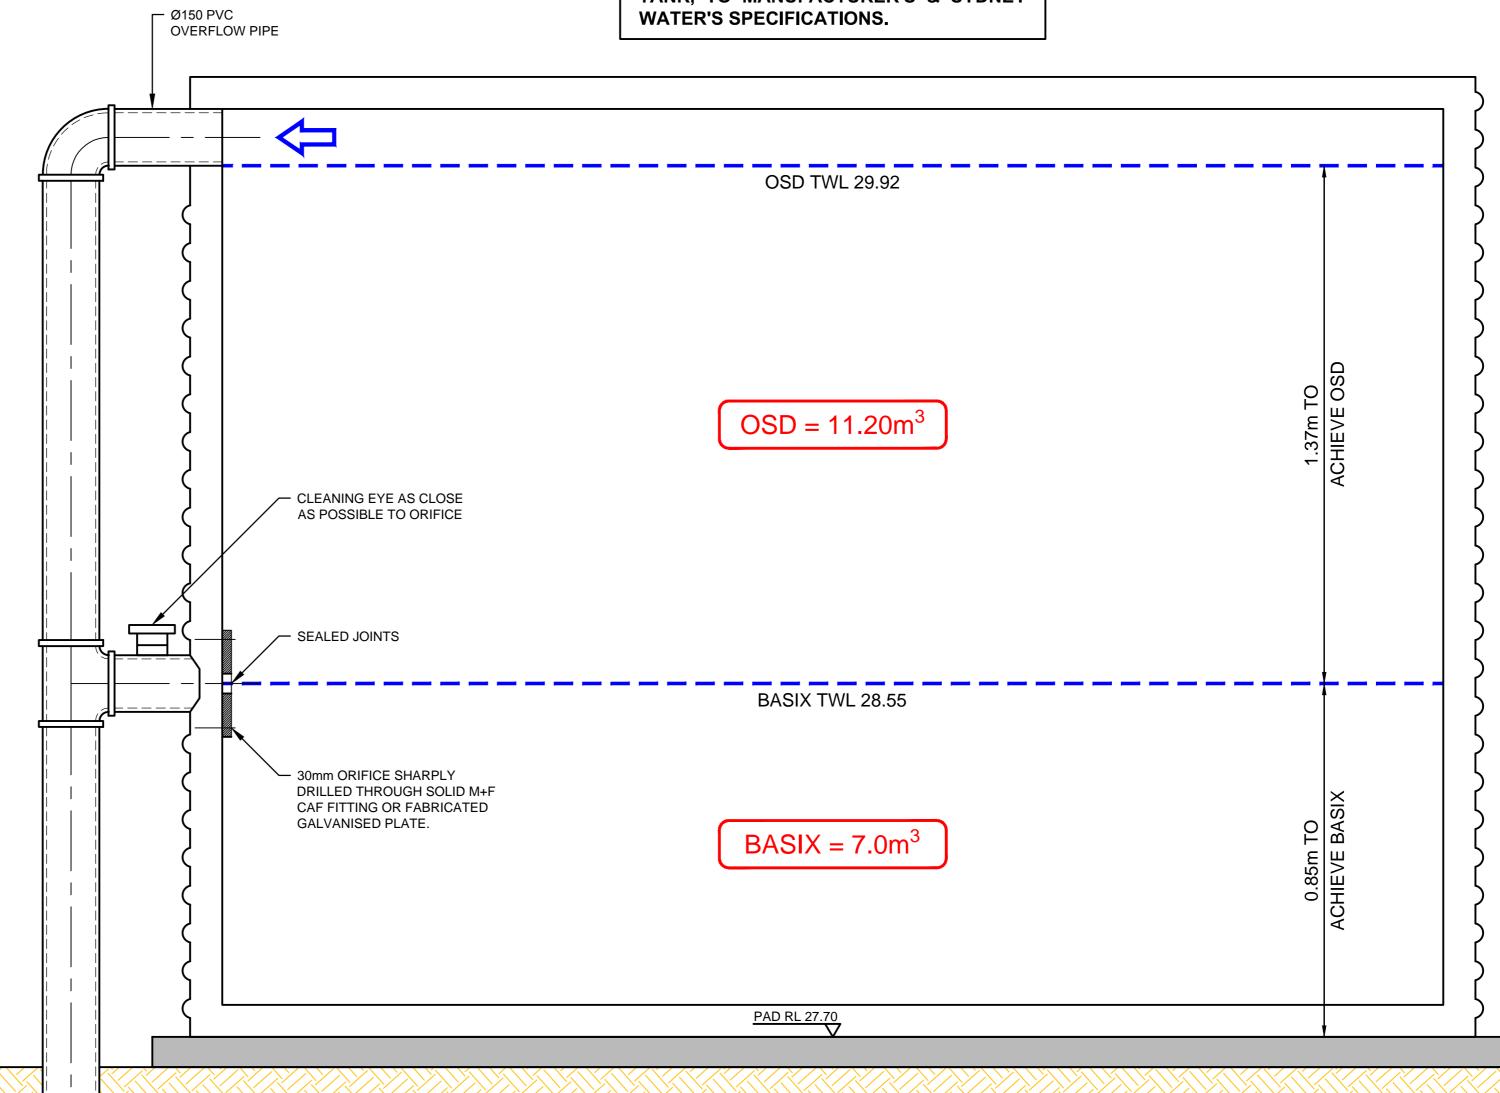

**PIPE IL 27.30** 

COMBINED OSD/BASIX 1 DETAIL SCALE 1:10

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ALL PLANS MUST BE PRINTED IN **COLOUR & READ** PRIOR TO CONSTRUCTION

Issue Description Design Check ISSUE FOR DEVELOPMENT APPLICATION 09/12/2019 MBR COUNCIL COMMENTS 03/09/2020 MBR COUNCIL COMMENTS MBR 29/10/2020 D ISSUE FOR APPROVAL ONLY 12/05/2021 MBR ISSUE FOR CONSTRUCTION CERTIFICATE | 03/08/2021 MBR

400 200 600mm SCALE 1:10 @ A1

Scale @ A1

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44-50 TENCH AVENUE, JAMISONTOWN NSW 2750 PROPOSED MUD MAP: THE ORANGE GROVE STORMWATER MANAGEMENT PLAN CONSTRUCTION CERTIFICATE


Drawing Title OSD & WSUD DETAILS & CALCULATION SHEETS SHEET 2 OF 4

19039

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Dwg. No.



### **ON-SITE DETENTION NOTES**

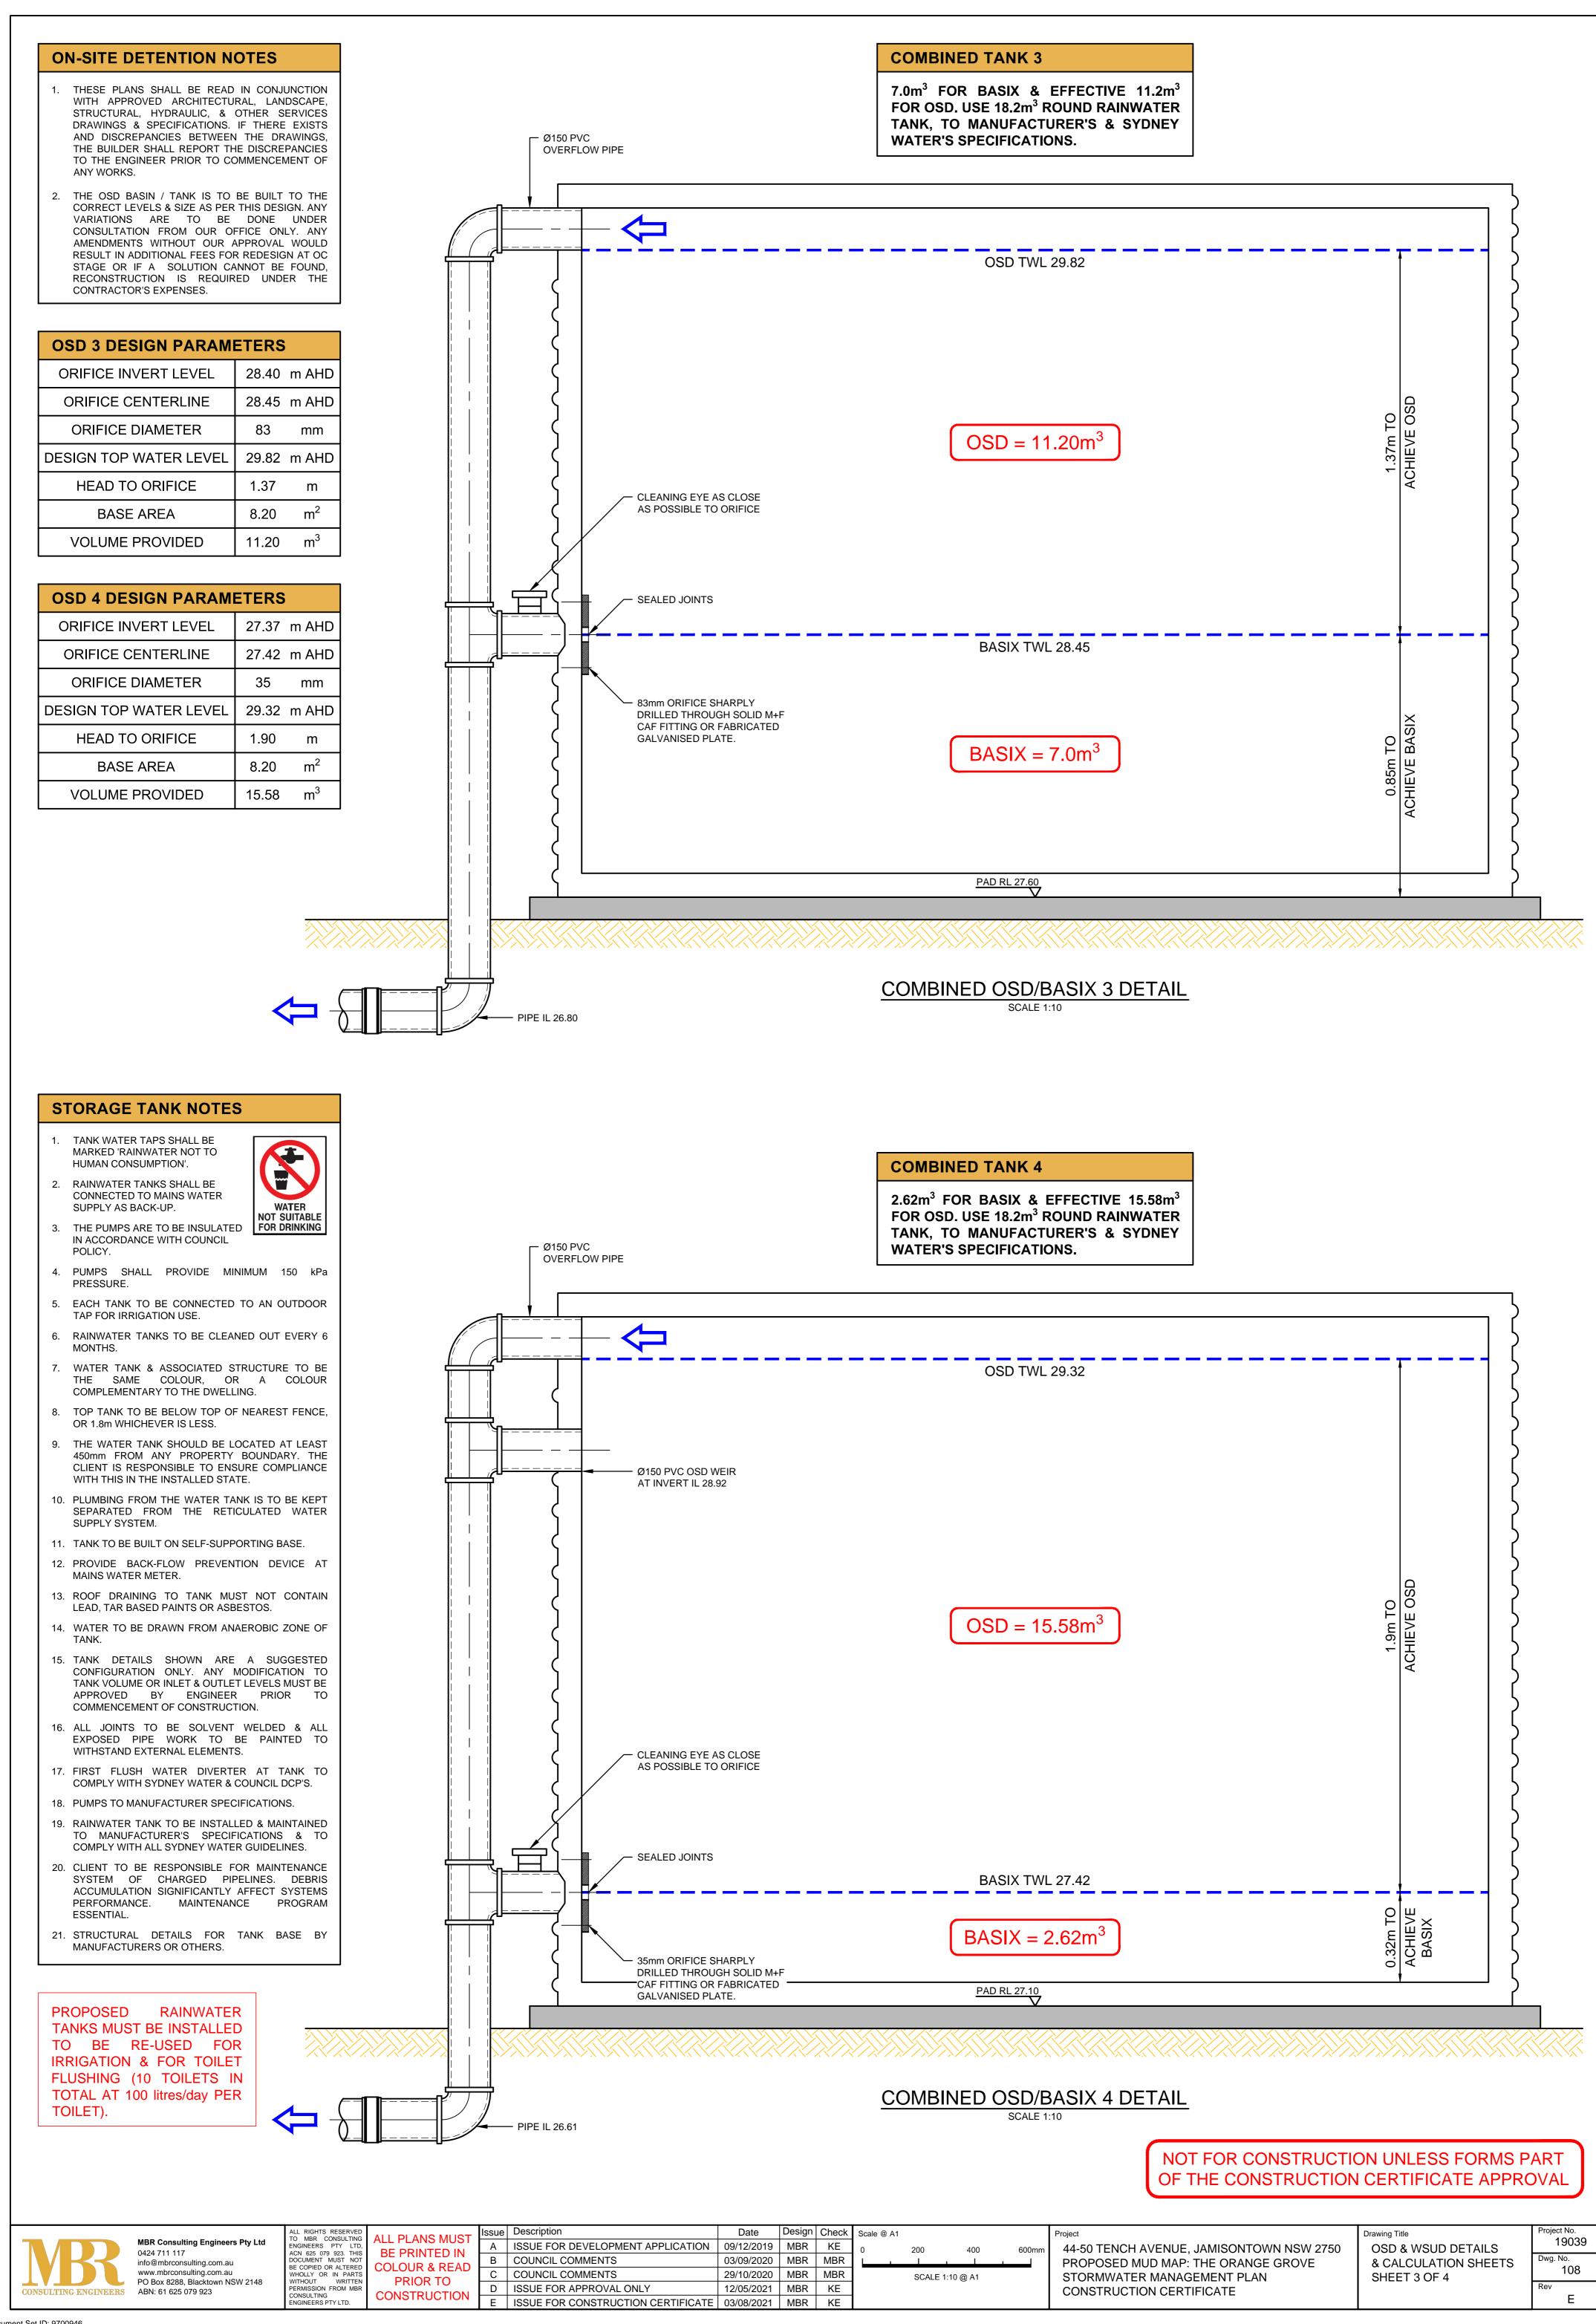- THESE PLANS SHALL BE READ IN CONJUNCTION WITH APPROVED ARCHITECTURAL, LANDSCAPE, STRUCTURAL, HYDRAULIC, & OTHER SERVICES DRAWINGS & SPECIFICATIONS. IF THERE EXISTS AND DISCREPANCIES BETWEEN THE DRAWINGS, THE BUILDER SHALL REPORT THE DISCREPANCIES TO THE ENGINEER PRIOR TO COMMENCEMENT OF ANY WORKS.
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### **OCEAN PROTECT NOTES**

PRECAST STRUCTURE SUPPLIED WITH CORE HOLES TO SUIT OUTER DIAMETER OF NOMINATED PIPE SIZE / MATERIAL.



- 2. IF THE PEAK FLOW RATE, AS DETERMINED BY THE SITE CIVIL ENGINEER, EXCEEDS THE PEAK HYDRAULIC CAPACITY OF THE PRODUCT, AN UPSTREAM BYPASS STRUCTURE
- 3. PRECAST STRUCTURE SHALL MEET W80 WHEEL LOAD RATING ASSUMING A MAXIMUM EARTH COVER OF 2.0m & A GROUND WATER ELEVATION AT OR BELOW THE OUTLET PIPE INVERT ELEVATION. CERTIFYING ENGINEER TO CONFIRM ACTUAL GROUNDWATER ELEVATION. PRECAST STRUCTURE SHALL BE IN ACCORDANCE WITH AS3600.
- 4. ALL WATER QUALITY TREATMENT DEVICES REQUIRE PERIODIC MAINTENANCE AS OUTLINED IN THE O&M GUIDELINES.
- 5. SITE SPECIFIC PRODUCTION DRAWING WILL BE PROVIDED ON PLACEMENT OF
- 6. ANY BACKFILL DEPTH, SUB-BASE, & OR ANTI-FLOTATION PROVISIONS ARE SITE-SPECIFIC DESIGN CONSIDERATIONS & SHALL BE SPECIFIED BY SITE CIVIL
- CONTRACTOR TO PROVIDE ALL EQUIPMENT WITH SUFFICIENT LIFTING & REACH CAPACITY TO LIFT & SET THE STORMFILTER STRUCTURE (LIFTING DETAIL PROVIDED SEPARATELY).

FILTRATION UNIT

— FALSE FLOOR

8. CONTRACTOR TO APPLY SEALANT TO ALL JOINTS & TO PROVIDE, INSTALL & GROUT INLET & OUTLET PIPES.

PRECAST PIT BASE



1. A CONFINED SPACE DANGER SIGN SHALL BE POSITIONED IN A LOCATION AT ALL ACCESS POINTS, SUCH THAT IT IS CLEARLY VISIBLE TO PERSONS PROPOSING TO ENTER THE BELOW GROUND TANK/S CONFINED SPACE.


**CONFINED SPACE DANGER SIGN** 

- 2. MINIMUM DIMENSIONS OF THE SIGN 300mm x 450mm (LARGE ENTRIES, SUCH AS DOORS) -250mm x 180mm (SMALL ENTRIES SUCH AS GRATES & MANHOLES).
- 3. THE SIGN SHALL BE MANUFACTURED FROM COLOUR BONDED
- 4. SIGN SHALL BE AFFIXED USING SCREWS AT EACH CORNER OF THE
- "DANGER" & BACKGROUND = WHITE ELLIPTICAL AREA = RED RECTANGLE CONTAINING ELLIPSE = BLACK BORDER AND OTHER LETTERING = BLACK

ALUMINUM OR POLYPROPYLENE.



WSUD DATA REQUIREMENTS								
STRUCTURE ID								
WATER QUALITY FLOW RATE (L/S)								
PEAK FLOW RATE (L/S)								
RETURN PERIOD OF PEAK FLOW (yrs)								
No OF CARTRIDGES REQUIRED								
CARTRIDGE HEIGHT (310, 460 or 690mm)								
MEDIA TYPE (PERLITE, PERLITE/ZEOLITE OR ZPG)								
PRECAST VAULT WEIGHT								
PRECAST LID WEIGHT								
PIPE DATA	INVERT IL	MATERIAL	DIAMETER					
INLET PIPE 1	26.55	PVC	300					
INLET PIPE 2	26.55	PVC	225					
OUTLET PIPE	26.45	PVC	300					

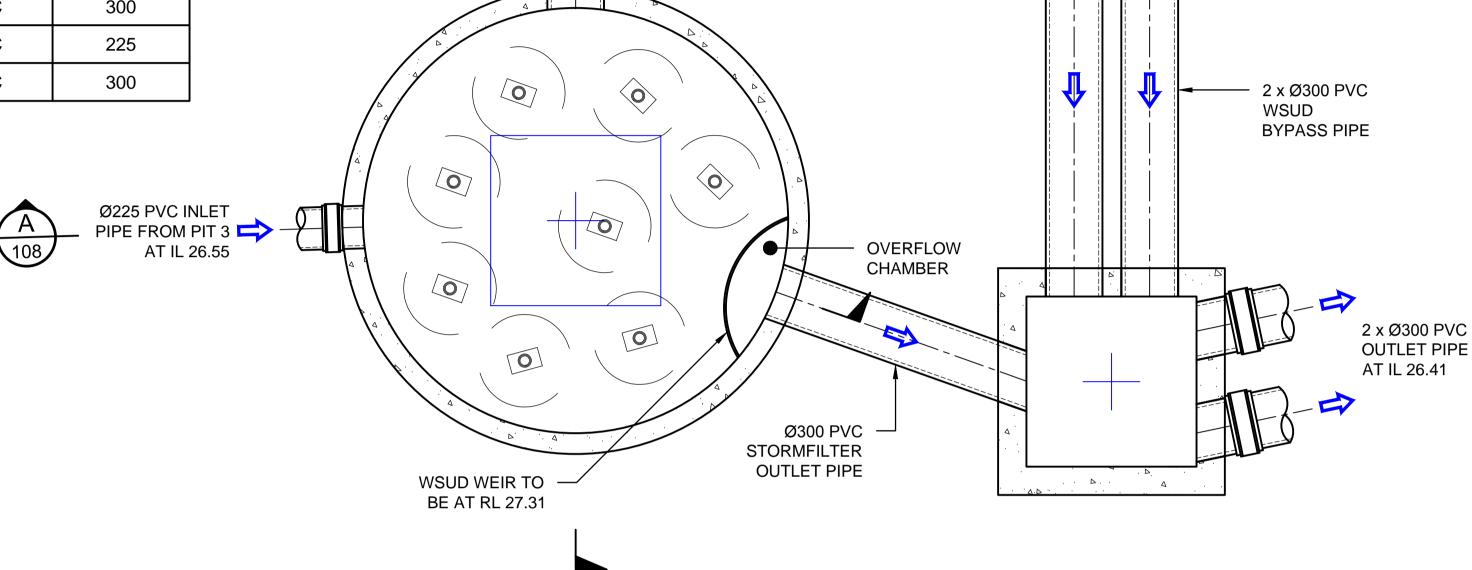



FOR WSUD & PIT STRUCTURAL DETAIL,

REFER TO STRUCTURAL ENGINEER'S DETAILS.

Ø300 PVC WSUD -


LOW FLOW PIPE

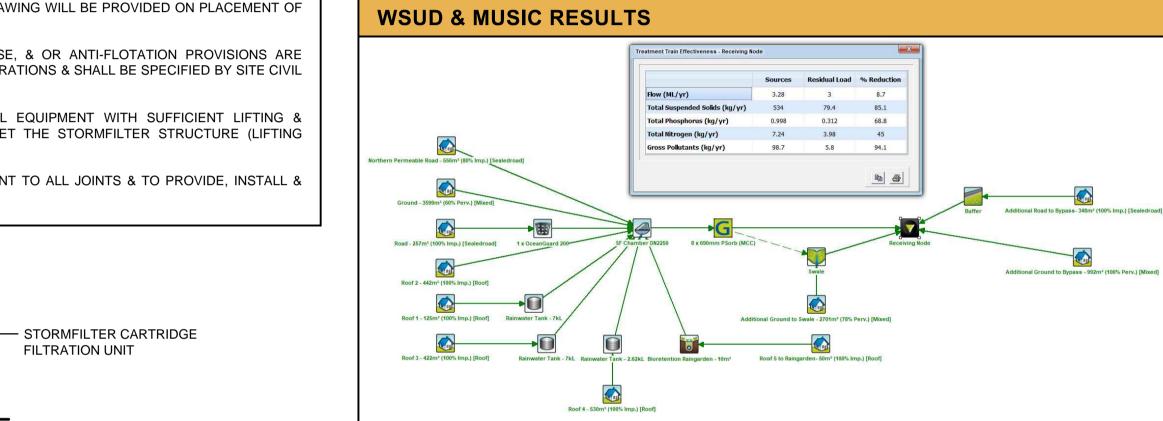

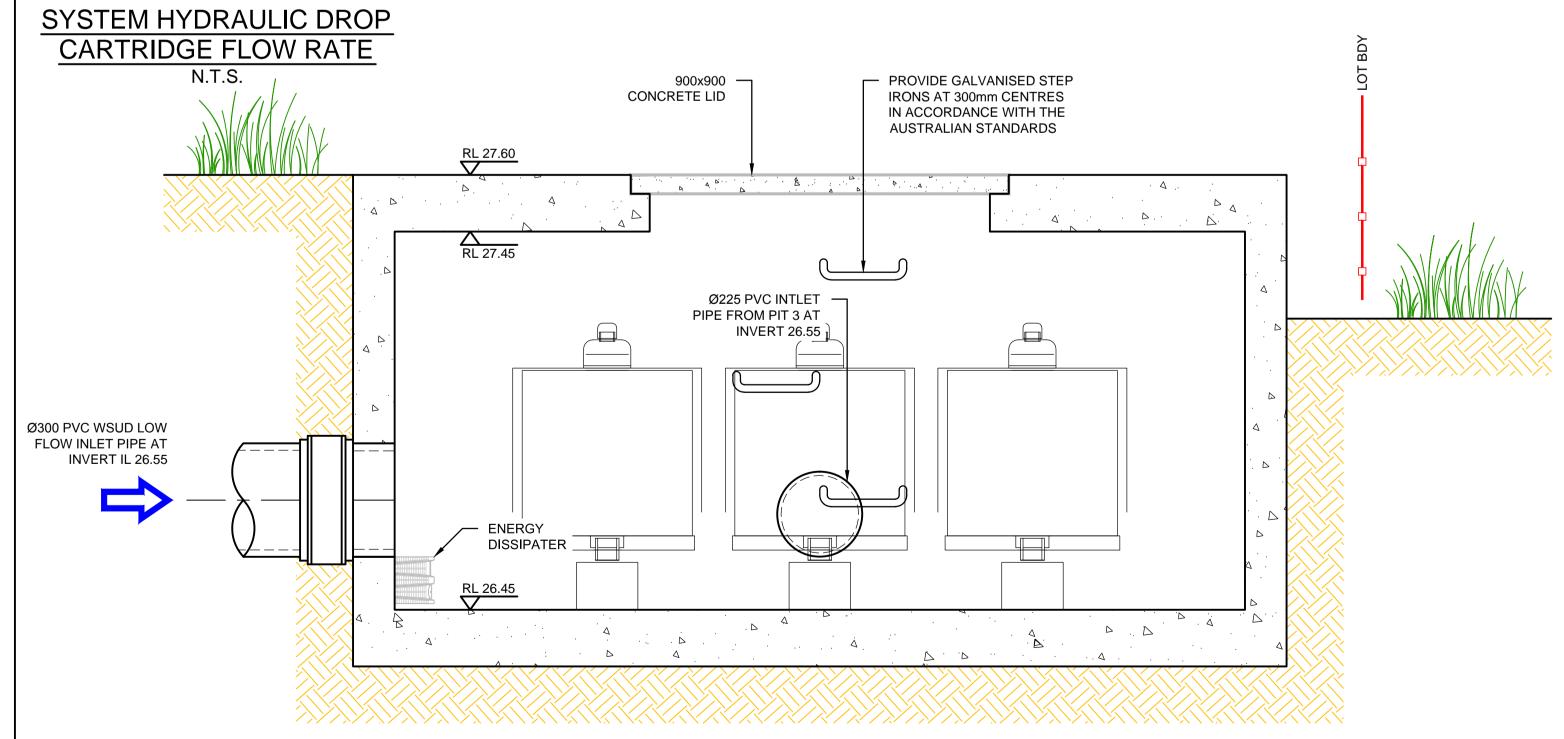

FOR WSUD TANK STRUCTURAL DETAIL, REFER TO STRUCTURAL ENGINEER'S DETAILS

SECTION B WSUD STORMFILTER MANHOLE DETAIL

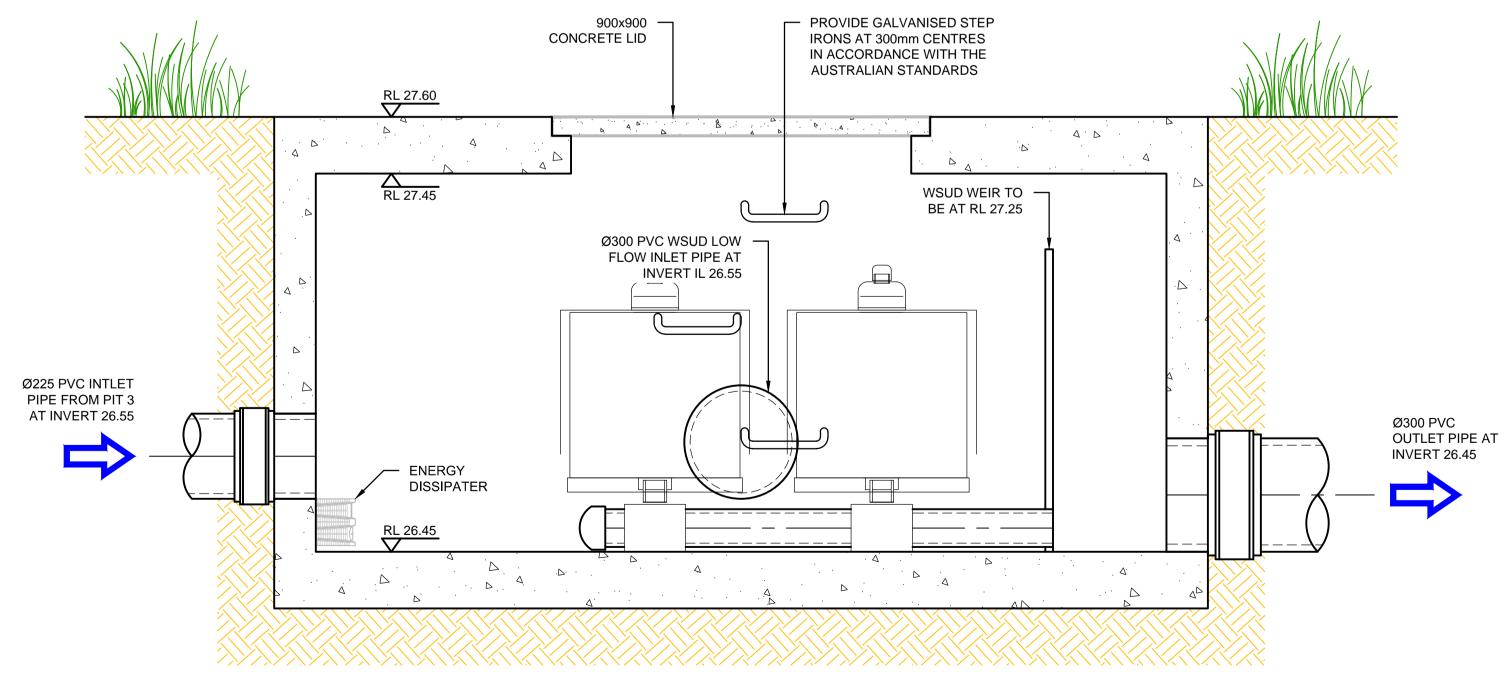

**SECTION A** WSUD STORMFILTER MANHOLE DETAIL

SCALE 1:25 @ A1

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ssue Description Date Design Check 09/12/2019 MBR KE A | ISSUE FOR DEVELOPMENT APPLICATION | COUNCIL COMMENTS 03/09/2020 | MBR | MBR 29/10/2020 MBR MBR COUNCIL COMMENTS D | ISSUE FOR APPROVAL ONLY ISSUE FOR CONSTRUCTION CERTIFICATE | 03/08/2021 | MBR | KE



MKD Cafe Pty Ltd SCALE 1:10 @ A1 0 0.2 0.4 0.6 0.8 1.0 1.2m

PROPOSED 8 x 690mm

CARTRIDGE STORMFILTER

CHAMBER TO BE:

Ø2.25m INTERNAL

& Ø2.47m EXTERNAL

44-50 TENCH AVENUE, JAMISONTOWN NSW 2750 PROPOSED MUD MAP: THE ORANGE GROVE STORMWATER MANAGEMENT PLAN CONSTRUCTION CERTIFICATE

Drawing Title OSD & WSUD DETAILS & CALCULATION SHEETS SHEET 4 OF 4


2 x Ø300 PVC


**INLET PIPE FROM** PIT 2 AT IL 26.59

> DIVERSION WEIR TO BE AT RL 27.35. ALTERNATIVELY, LIFT THE BYPASS PIPE

200mm FROM INVERT.


19039 109

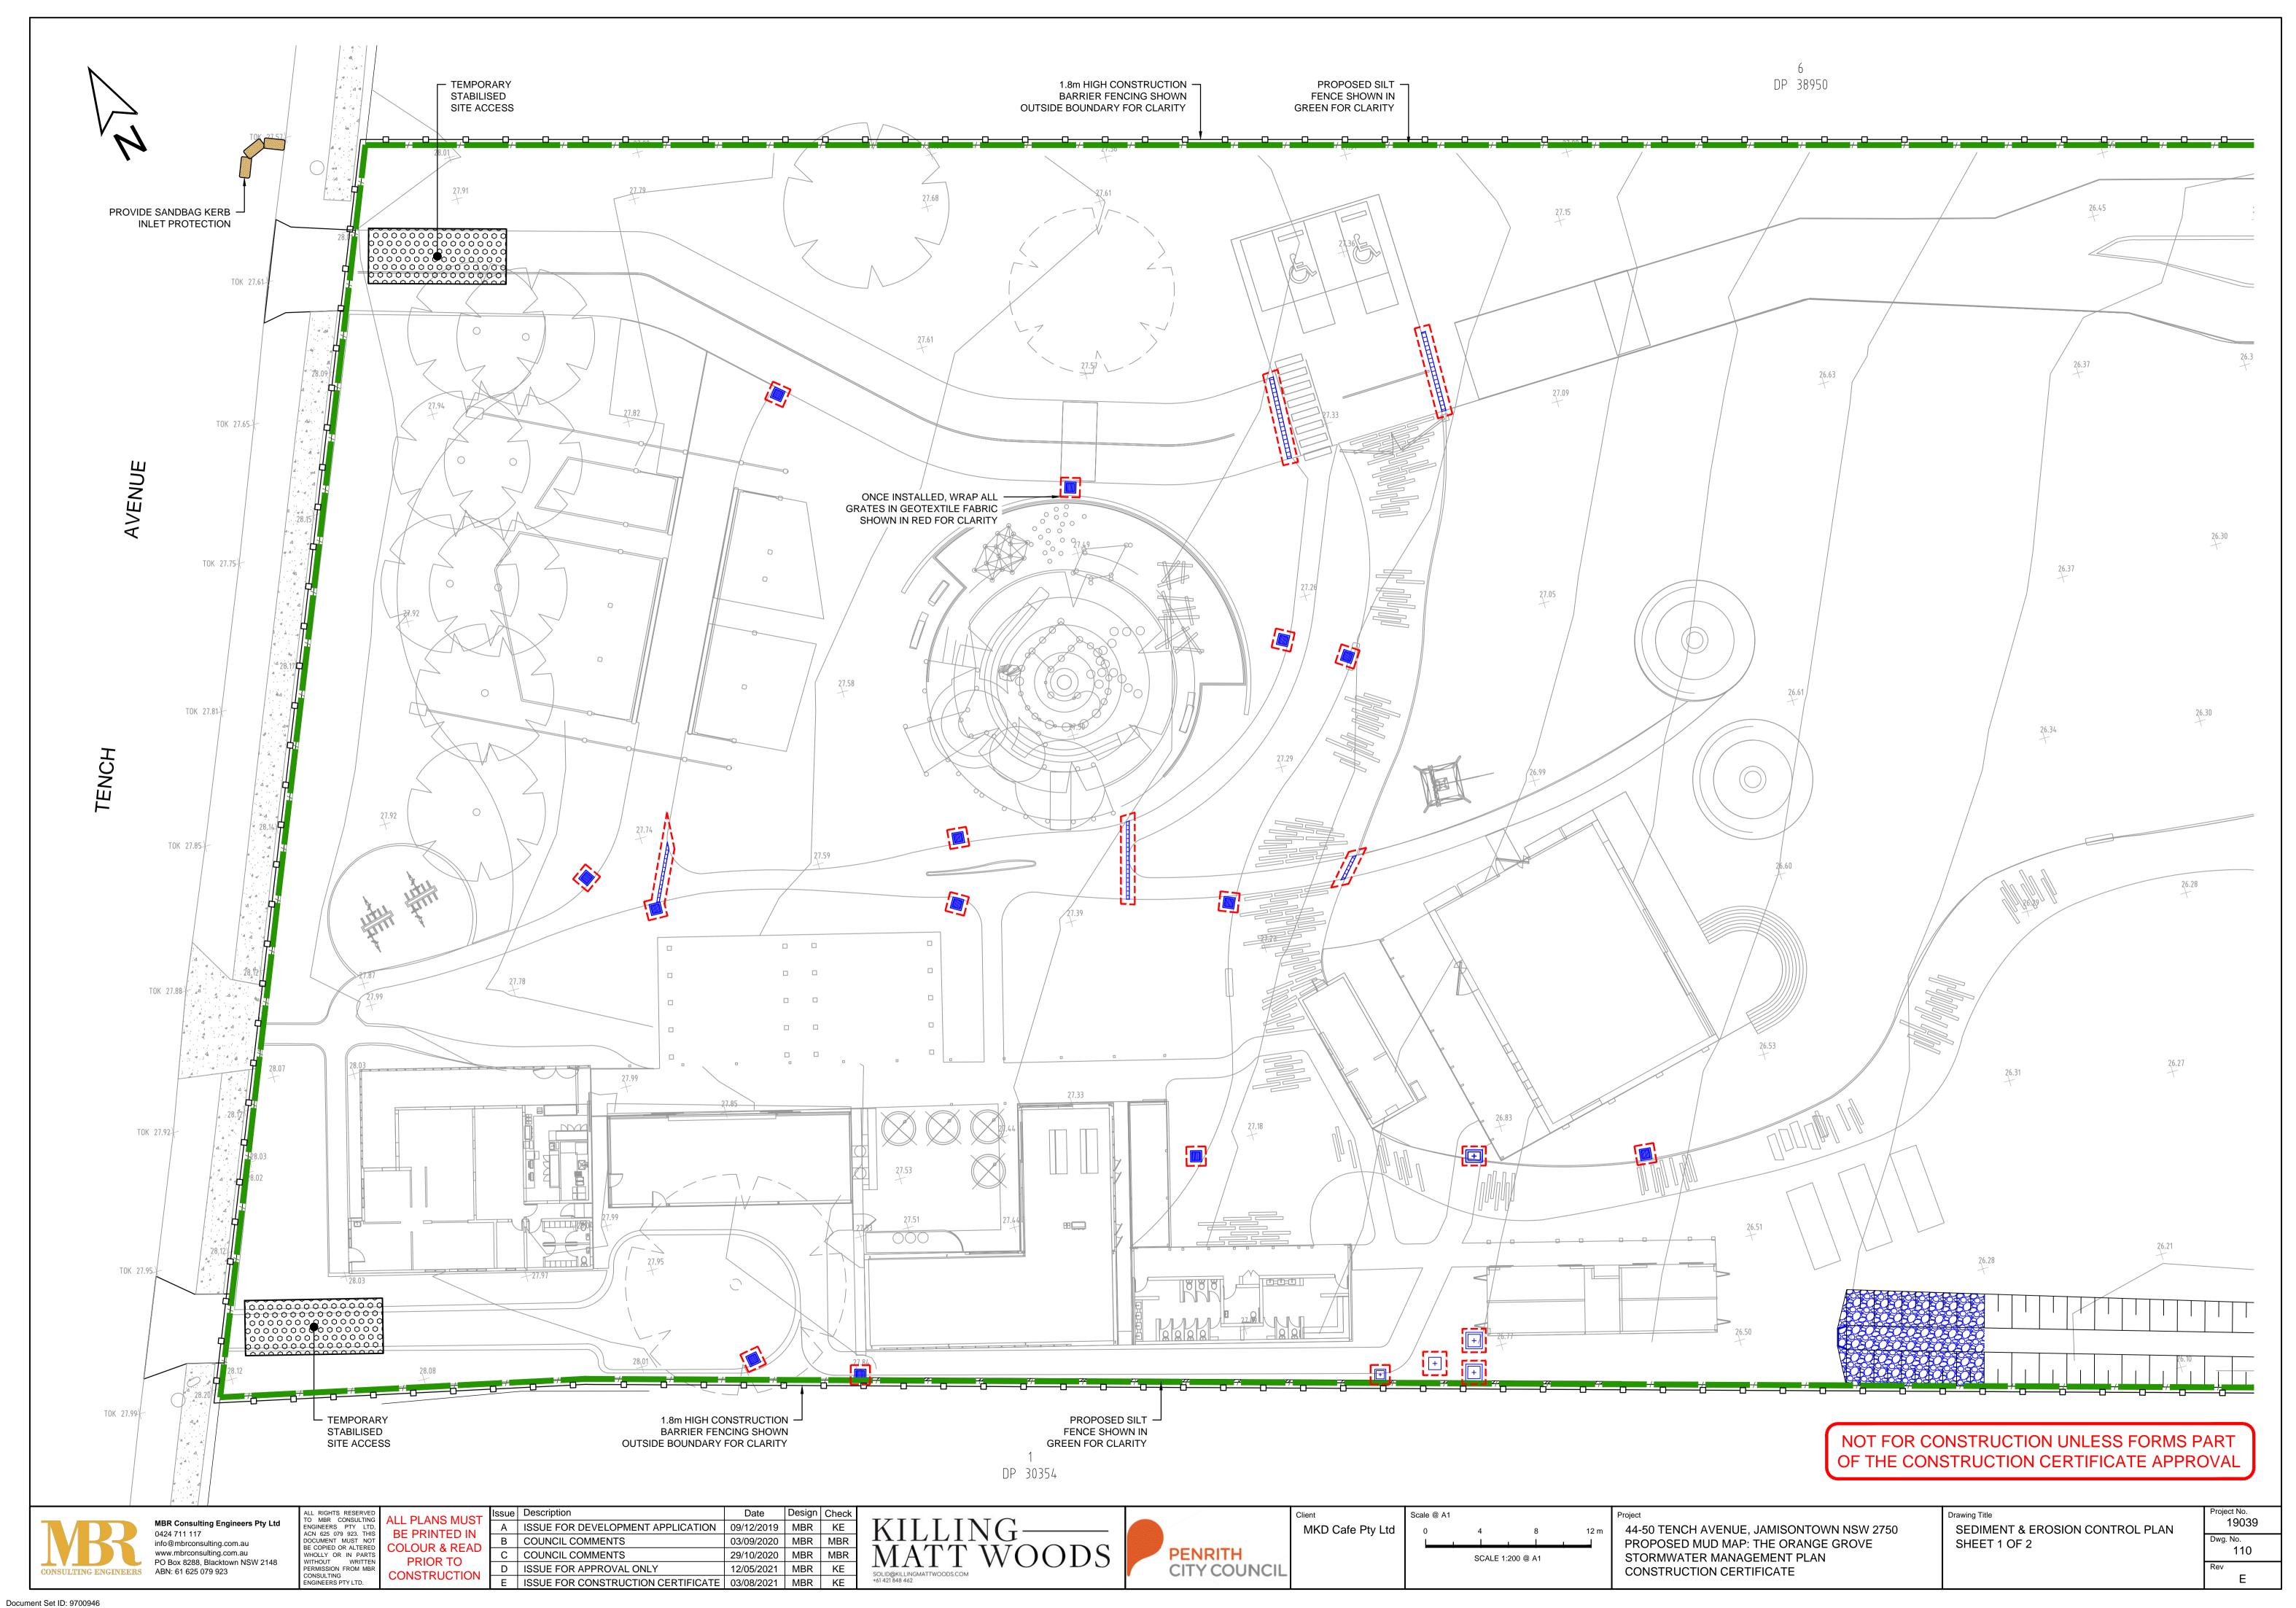

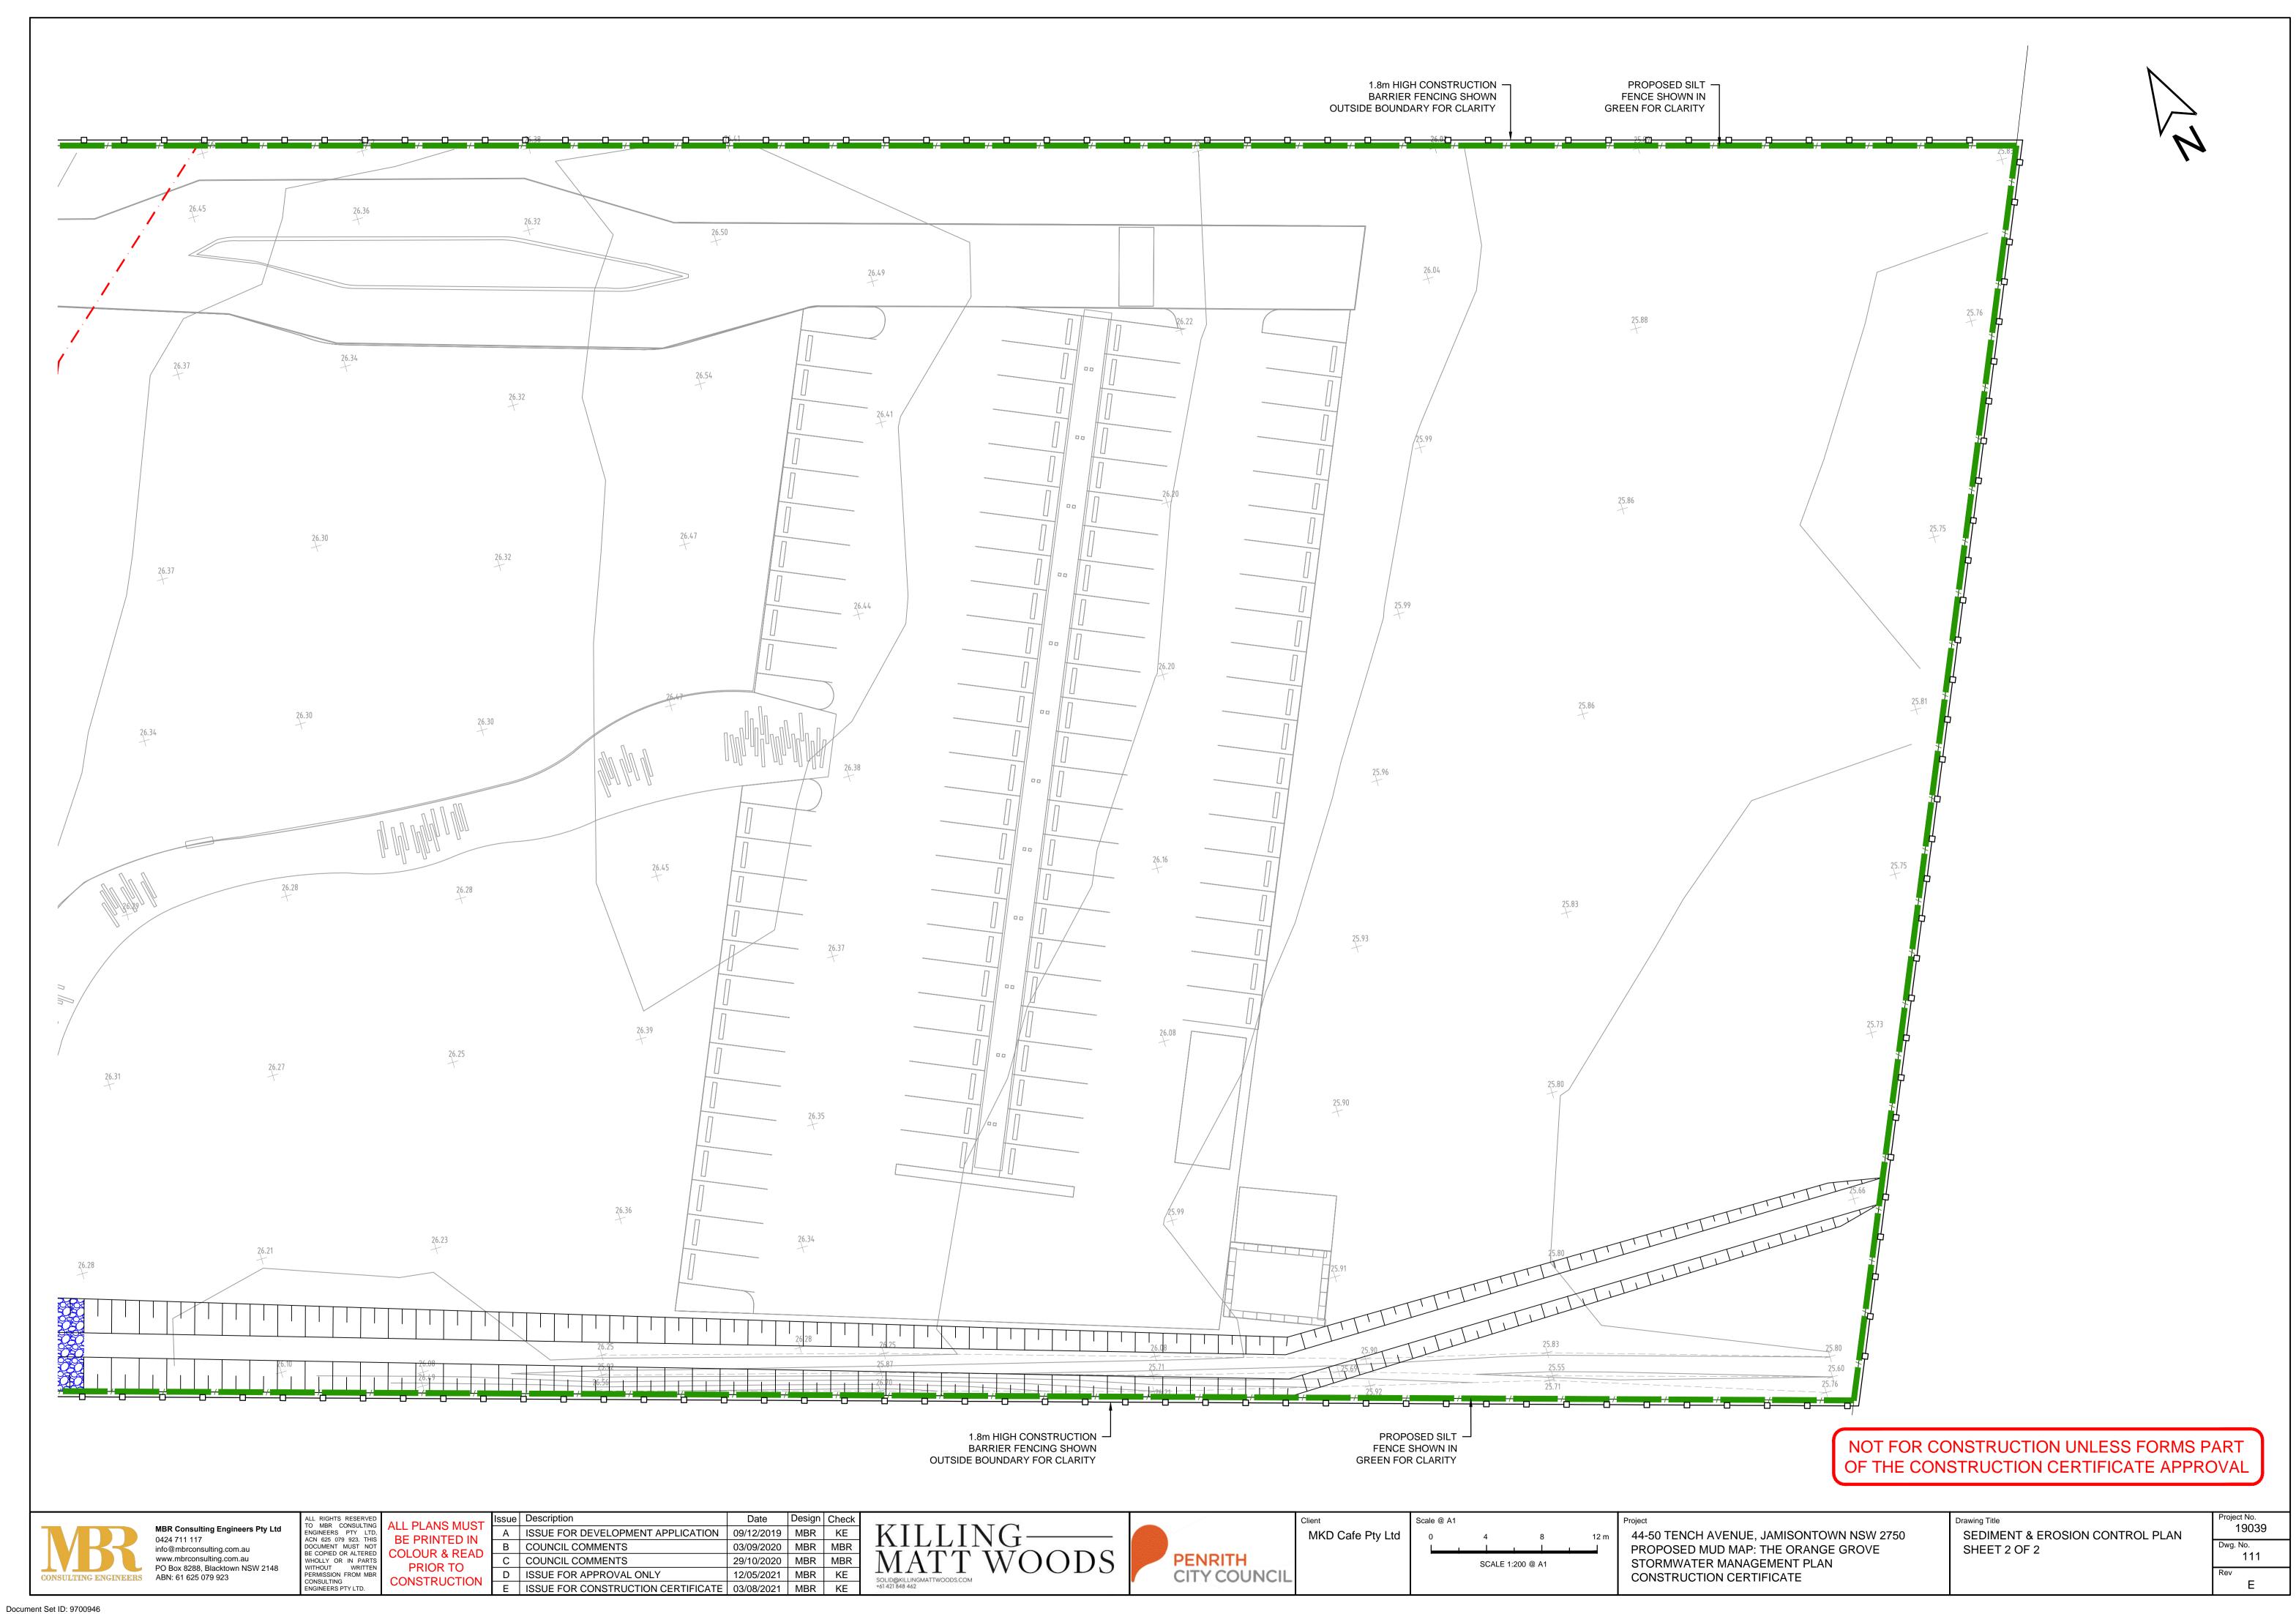



**CUT-FILL PLAN** 

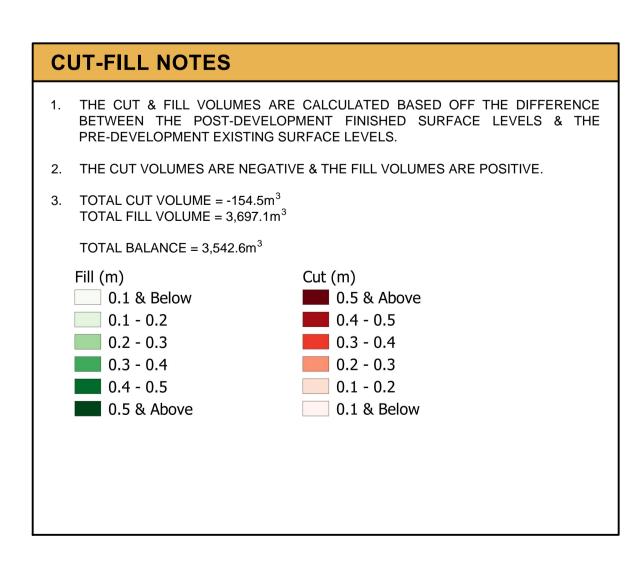

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Date Design Check Issue Description A ISSUE FOR DEVELOPMENT APPLICATION 09/12/2019 MBR KE B COUNCIL COMMENTS 03/09/2020 | MBR | MBR C COUNCIL COMMENTS 29/10/2020 MBR MBR D ISSUE FOR APPROVAL ONLY 12/05/2021 MBR KE E ISSUE FOR CONSTRUCTION CERTIFICATE 03/08/2021 MBR KE





Scale @ A1 MKD Cafe Pty Ltd SCALE 1:400 @ A1

44-50 TENCH AVENUE, JAMISONTOWN NSW 2750 PROPOSED MUD MAP: THE ORANGE GROVE STORMWATER MANAGEMENT PLAN CONSTRUCTION CERTIFICATE

Drawing Title 19039 **CUT-FILL PLAN** Dwg. No. 112

### **EROSION & SEDIMENT CONTROL NOTES**

### **GENERAL INSTRUCTIONS:**

- E1. THIS PLAN IS TO BE READ IN CONJUNCTION WITH THE ENGINEERING PLANS, & ANY OTHER PLANS OR WRITTEN INSTRUCTIONS THAT MAY BE ISSUED & RELATING TO DEVELOPMENT AT THE SUBJECT SITE.
- E2. THE SITE SUPERINTENDENT WILL ENSURE THAT ALL SOIL & WATER MANAGEMENT WORKS ARE LOCATED AS INSTRUCTED IN THIS SPECIFICATION.
- E3. ALL BUILDERS & SUB-CONTRACTORS WILL BE INFORMED OF THEIR RESPONSIBILITIES IN MINIMISING THE POTENTIAL FOR SOIL EROSION & POLLUTION TO DOWNSLOPE LANDS & WATERWAYS.

### **CONSTRUCTION SEQUENCE:**

- E4. THE SOIL EROSION POTENTIAL ON THIS SITE SHALL BE MINIMISED. HENCE, WORKS SHALL BE UNDERTAKEN IN THE FOLLOWING SEQUENCE:
- a. INSTALL SEDIMENT FENCES, TEMPORARY CONSTRUCTION EXIT & SANDBAG KERB INLET SEDIMENT TRAP
- b. UNDERTAKE SITE DEVELOPMENT WORKS IN ACCORDANCE WITH THE ENGINEERING PLANS. PHASE DEVELOPMENT SO THAT LAND DISTURBANCE IS CONFINED TO AREAS OF WORKABLE SIZE.

### **EROSION CONTROL**

- E5. DURING WINDY CONDITIONS, LARGE, UNPROTECTED AREAS WILL BE KEPT MOIST (NOT WET) BY SPRINKLING WITH WATER TO KEEP DUST UNDER CONTROL.
- E6. FINAL SITE LANDSCAPING WILL BE UNDERTAKEN AS SOON AS POSSIBLE & WITHIN 20 WORKING DAYS FROM COMPLETION OF CONSTRUCTION ACTIVITIES.

### **FENCING:**

- E7. STOCKPILES WILL NOT BE LOCATED WITHIN 2m OF HAZARD AREAS, INCLUDING LIKELY AREAS OF CONCENTRATED OR HIGH VELOCITY FLOWS SUCH AS WATERWAYS. WHERE THEY ARE BETWEEN 2 & 5m FROM SUCH AREAS, SPECIAL SEDIMENT CONTROL MEASURES SHOULD BE TAKEN TO MINIMISE POSSIBLE POLLUTION TO DOWNSLOPE WATERS, E.G. THROUGH INSTALLATION OF SEDIMENT
- E8. ANY SAND USED IN THE CONCRETE CURING PROCESS (SPREAD OVER THE SURFACE) WILL BE REMOVED AS SOON AS POSSIBLE & WITHIN 10 WORKING DAYS FROM PLACEMENT.
- E9. WATER WILL BE PREVENTED FROM ENTERING THE PERMANENT DRAINAGE SYSTEM UNLESS IT IS RELATIVELY SEDIMENT FREE, I.E. THE CATCHMENT AREA HAS BEEN PERMANENTLY LANDSCAPED AND/OR ANY LIKELY SEDIMENT HAS BEEN FILTERED THROUGH AN APPROVED STRUCTURE.
- E10. TEMPORARY SOIL & WATER MANAGEMENT STRUCTURES WILL BE REMOVED ONLY AFTER THE LANDS THEY ARE PROTECTING ARE REHABILITATED.

### **OTHER MATTERS:**

- E11. ACCEPTABLE RECEPTORS WILL BE PROVIDED FOR CONCRETE & MORTAR SLURRIES, PAINTS, ACID WASHINGS, LIGHT-WEIGHT WASTE MATERIALS & LITTER.
- E12.RECEPTORS FOR CONCRETE & MORTAR SLURRIES, PAINTS, ACID WASHINGS, LIGHT-WEIGHT WASTE MATERIALS & LITTER ARE TO BE EMPTIED AS NECESSARY. DISPOSAL OF WASTE SHALL BE IN A MANNER APPROVED BY THE SITE SUPERINTENDENT.

### SITE INSPECTION & MAINTENANCE:

E13.EROSION & SEDIMENT CONTROL MEASURES SHALL BE INSPECTED AFTER RAINFALL EVENTS TO ENSURE THAT THEY OPERATE EFFECTIVELY. REPAIR & OR MAINTENANCE SHALL BE UNDERTAKEN AS REQUIRED.

### **DUST CONTROL NOTES**

- 1. PHYSICAL BARRIERS SHALL BE ERECTED AT RIGHT ANGLES & SHALL BE PLACED AROUND OR OVER DUST SOURCES TO PREVENT WIND FROM GENERATING DUST.
- 2. EARTHWORKS & SCHEDULING ACTIVITIES SHALL BE MANAGED TO COINCIDE WITH THE NEXT STAGE OF DEVELOPMENT TO MINIMISE THE AMOUNT OF TIME THE SITE IS LEFT TO CUT OR EXPOSED.
- 3. ALL MATERIALS SHALL BE STORED OR STOCKPILED AT THE BEST LOCATIONS.
- 4. THE GROUND SURFACE SHOULD BE DAMPENED SLIGHTLY TO PREVENT DUST FROM BECOMING AIRBORNE & SHOULD NOT BE WET ENOUGH TO PRODUCE RUN-OFF.
- 5. AT ALL TIMES, ALL VEHICLES CARRYING SOIL OR RUBBLE TO OR FROM THE SITE SHALL BE COVERED TO PREVENT THE ESCAPE OF DUST.
- 6. ALL EQUIPMENT WHEELS SHALL BE WASHED BEFORE EXITING THE SITE USING MANUAL OR AUTOMATED SPRAYERS & DRIVE - THROUGH WASHING BAYS.
- 7. GATES SHALL BE CLOSED BETWEEN VEHICLE MOVEMENTS & SHALL BE FITTED WITH SHADE CLOTH.
- 8. CLEANING OF FOOTPATHS & ROADWAYS SHALL BE CARRIED OUT DAILY.
- 9. ALL SPOIL & MATERIAL UNSUITABLE FOR USE IN LANDSCAPE AREAS SHALL BE REMOVED FROM SITE UPON COMPLETION OF WORKS.

### **CONSTRUCTION SEQUENCE**

- 1. INSTALL SEDIMENT FENCING & CUT DRAINS TO MEET THE REQUIREMENTS O THE SEDIMENT & EROSION CONTROL PLAN. WASTE COLLECTION BINS SHALL BE INSTALLED ADJACENT TO THE SITE
- 2. CONSTRUCT STABILISED SITE ACCESS IN ACCORDANCE WITH COUNCIL'S REQUIREMENTS.
- 3. REDIRECT CLEAN WATER AROUND THE CONSTRUCTION SITE.
- 4. INSTALL SEDIMENT CONTROL PROTECTION MEASURES AT ALL NATURAL & MAN-MADE DRAINAGE STRUCTURES. MAINTAIN UNTIL ALL THE DISTURBED AREAS ARE STABILISED.
- 5. CLEAR & STRIP THE WORK AREAS. MINIMISE THE DAMAGE TO THE GRASS & LOW GROUND COVER OF NON-DISTURBED AREAS.
- ANY DISTURBED AREAS, OTHER THAN BUILDING PAD AREAS, SHALL IMMEDIATELY BE COVERED WITH SITE TOPSOIL WITHIN 7 DAYS OF CLEARING. BUILDING PAD AREAS SHALL BE COVERED WITH BITUMEN EMULSION AS SPECIFIED.
- 7. APPLY PERMANENT STABILISATION TO SITE (LANDSCAPING).

### SILT FENCE NOTES

- FILTER CLOTH TO BE FASTENED SECURELY TO POSTS WITH GALVANISED WIRE TIES, STAPLES OR ATTACHMENT BELTS.
- 2. POSTS SHOULD NOT BE SPACED MORE THAN 3.0m APART.
- WHEN TWO SECTIONS OF FILTER CLOTH ADJOIN EACH OTHER, THEY SHALL BE OVERLAPPED BY 150mm & FOLDED.
- FOR EXTRA STRENGTH TO SILT FENCE, WOVEN WIRE (14mm GAUGE, 150mm MESH SPACING) TO BE FASTENED SECURELY BETWEEN FILTER CLOTH & POSTS BY WIRE TIES OR STAPLES.
- INSPECTIONS SHALL BE PROVIDED ON A REGULAR BASIS, ESPECIALLY AFTER RAINFALL & EXCESSIVE SILT DEPOSITS REMOVED WHEN "BULGES" DEVELOP IN SILT FENCE.
- SEDIMENT FENCES SHALL BE CONSTRUCTED WITH SEDIMENT TRAPS & EMERGENCY SPILLWAYS AT SPACING NO GREATER THAN 40m ON FLAT TERRAIN DECREASING TO 20m SPACING ON STEEP TERRAIN.

### GEOTEXTILE FILTER FABRIC WIRE OR STEEL MESH DISTURBED AREA POSTS DRIVEN 0.6m INTO GROUND **OVERLAP** UNDISTURBED AREA 0.2mDRAPE BOTTOM 150mm OF SILT FENCE IN TRENCH, BACKFILL WITH SOIL AND COMPACT TO ENSURE ANCHORAGE.

SANDBAGS OVERLAP ONTO KERB **GAP BETWEEN BAGS** TRREE LAYERS OF SANDBAGS TO ACT AS SPILLWAY WITH ENDS OVERLAPPED

SILT FENCE DETAIL

KERB INLET PROTECTION - ON GRADE GULLY PIT

### PLACE STOCKPILES MORE THAN 2.0m (PREFERABLY 5.0m) FROM EXISTING VEGETATION, CONCENTRATED WATER FLOW,

STOCKPILE NOTES


DOWNSTREAM.


- ROADS & HAZARD AREAS. 2. CONSTRUCT ON THE CONTOUR AS LOW, FLAT
- & ELONGATED MOUNDS.
- WHERE THERE IS SUFFICIENT AREA, TOPSOIL STOCKPILES SHALL BE LESS THAN 2.0m IN WHERE THEY ARE TO BE PLACED FOR MORE

THAN 10 DAYS, STABILISE FOLLOWING THE


APPROVED E.S.C.P. OR S.W.M.P. TO REDUCE

THE C-FACTOR TO LESS THAN 0.1. CONSTRUCT EARTH BANKS ON THE UPSTREAM SIDE TO DIVERT WATER AROUND STOCKPILES & SEDIMENT FENCES 1.0 TO 2.0m

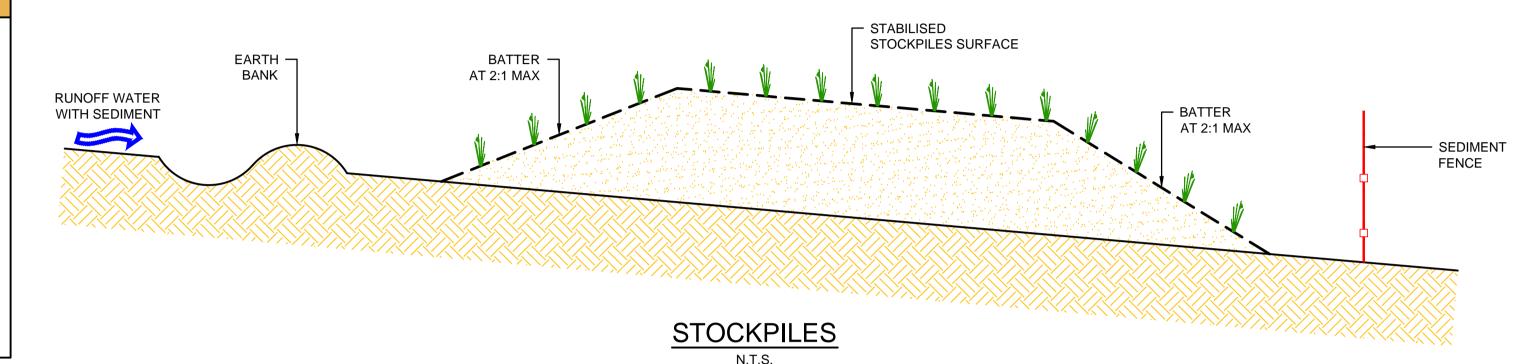


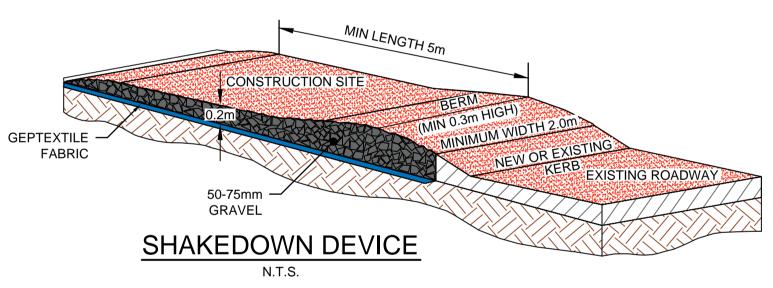

**MAINTENANCE NOTES:** THE ENTRANCE SHALL BE MAINTAINED IN A CONDITION WHICH PREVENTS TRACKING OR FLOWING OF SEDIMENT ONTO PUBLIC RIGHTS OF WAY. THIS MAY REQUIRE PERIODIC TOP DRESSING WITH ADDITIONAL GRAVEL AS CONDITIONS DEMAND & REPAIR AND/OR CLEANOUT OF ANY MEASURES USED TO TRAP SEDIMENT. ALL SEDIMENT SPILLED, DROPPED, WASHED OR TRACKED ONTO PUBLIC RIGHTS OF WAY MUST BE REMOVED IMMEDIATELY.

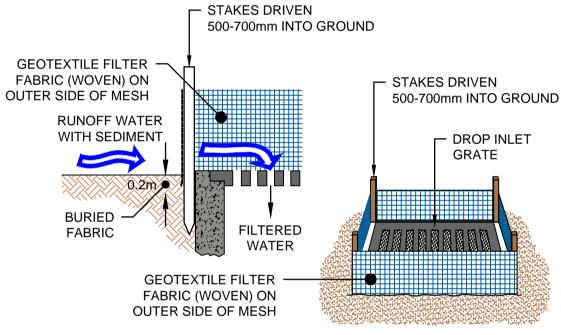

FIELD INLET SEDIMENT TRAP

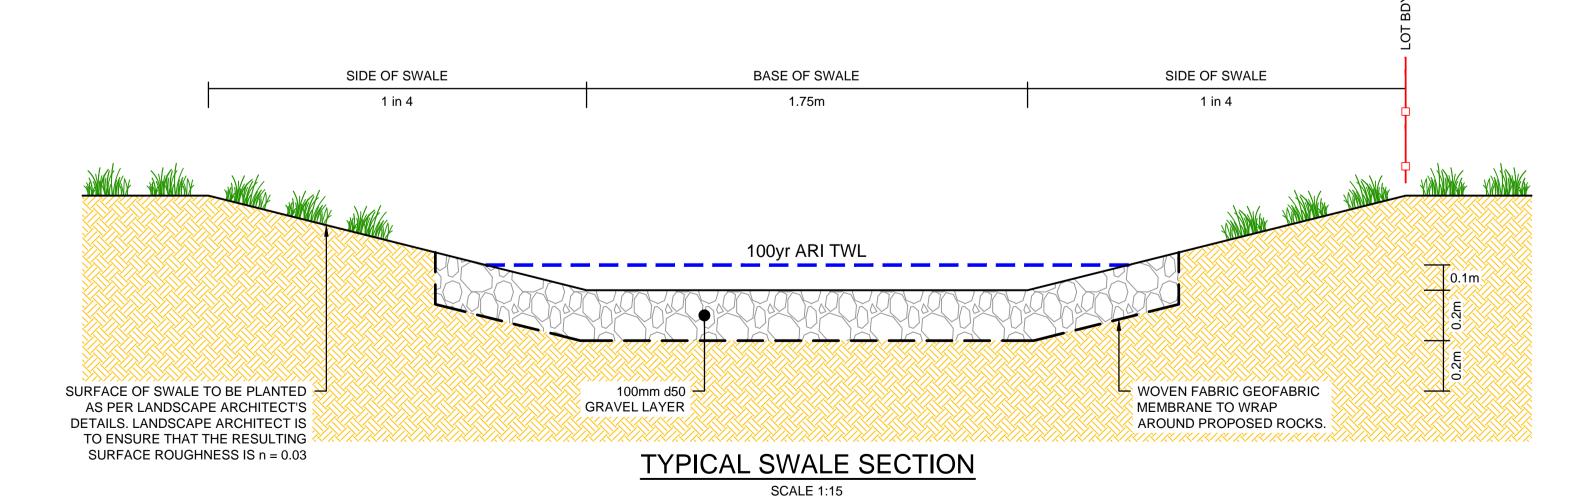

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PENRITH CITY COUNCIL

Sçale @ A1 400 600mm MKD Cafe Pty Ltd SCALE 1:10 @ A1 1200 mr 400 800 SCALE 1:20 @ A1

44-50 TENCH AVENUE, JAMISONTOWN NSW 2750 PROPOSED MUD MAP: THE ORANGE GROVE STORMWATER MANAGEMENT PLAN CONSTRUCTION CERTIFICATE

Drawing Title MISCELLANEOUS DETAILS SHEET SHEET 1 OF 2

19039 Dwg. No. 113

