PROPOSED 2 STOREY ATTACHED DUAL OCCUPANCY

No. 41 SUNBURST DRIVE, CADDENS, NSW 2747 (ISSUE FOR DA)

Site Details

41 Sunburst Drive, Caddens 1229232

Site Area: 451.60 sqm Zone R2

(Low density Residential)

Calculations

Total Ground Floor Area 138.00 sgm (garage not included) 141.00 sqm (garage not included) Total First Floor Area 279.00 sqm (garage not included) **Total Floor Area** 194.45 sqm (43%) Total Landscaped Area

18.15 sqm

60.00 sqm


Garage Floor Area Ground Floor Area


First Floor Area 69.00 sqm **Total Floor Area** 129.00 sqm (garage not included) P.O.S Area 18.50 sqm


Garage Floor Area 16.50 sqm **Ground Floor Area** 78.00 sqm First Floor Area 72.00 sqm


150.00 sqm (garage not included) **Total Floor Area**

64.00 sqm P.O.S Area

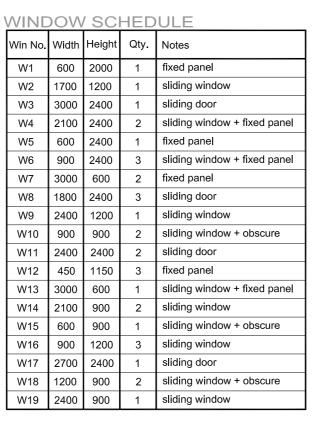


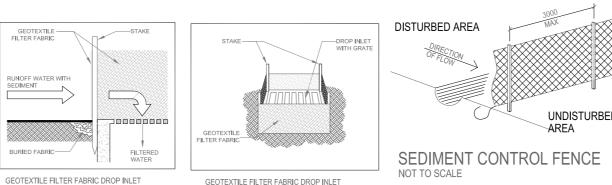


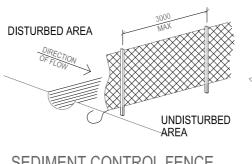

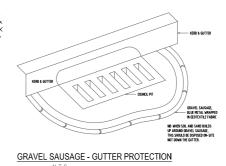



ALL STOCKPILES OF BUILDING MATERIAL SUCH AS SAND AND SOIL MUST I PROTECTED TO PREVENT SCOUR AND EROSION THEY SHOULD NEVER BE PLACED IN THE STREET GUTTER WHERE THEY WIL

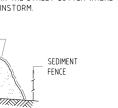

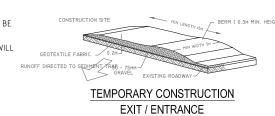

T	GEOTEXTILE	AREA	US, HET FLA, WARMING NO CONTINUE FRANCE IN CONTINUE FRANCE FRANCE FRANCE FRANCE FRANCE FRANCE FRANCE FRAN	COVERING EARTH BANK TO
FILTERED WATER ABRIC DROP INLET T TRAP	GEOTEXTILE FILTER FABRIC DROP INLET SEDIMENT TRAP	SEDIMENT CONTROL FENCE NOT TO SCALE	UP HANDE PAIR LINES AT THE THE THE THE THE THE THE THE THE TH	PREVENT SCOUR OF STOCKPILE
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SHADOW PLAN

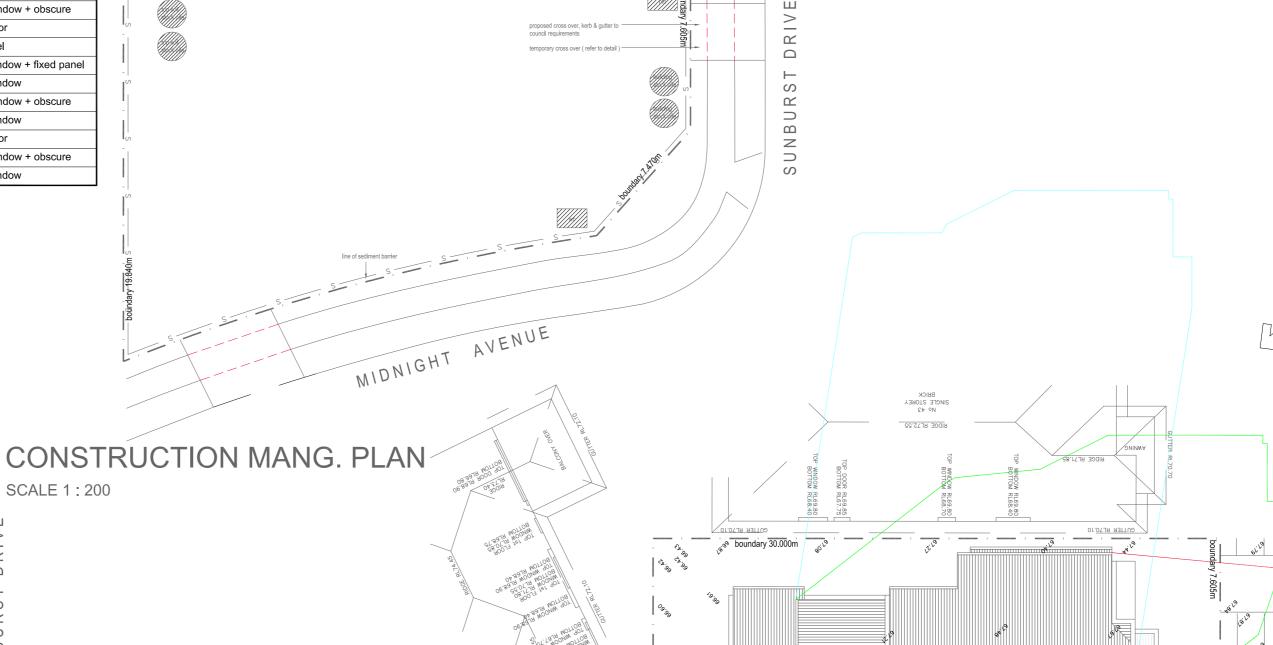SCALE 1:200

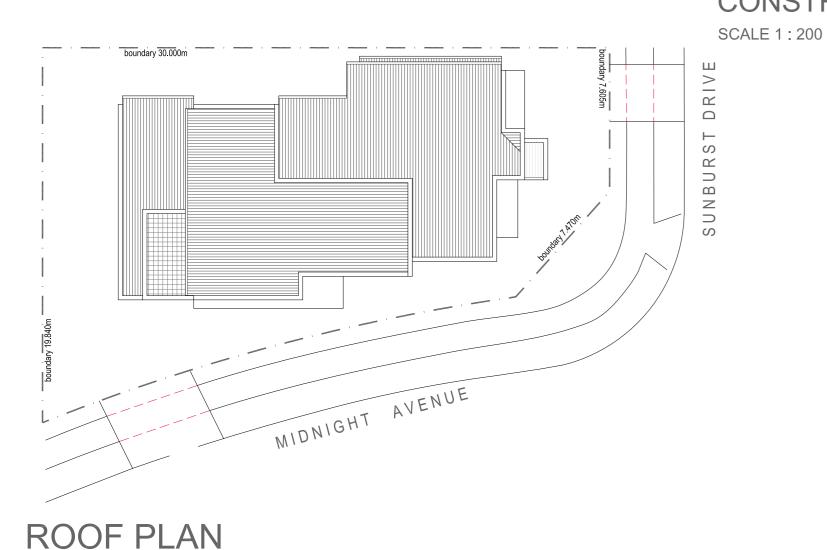SCALE 1:200


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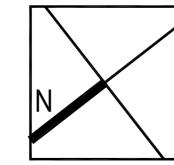
DAIDESIGNWOR X

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- BASIX o 3D PERSPECTIVES
- **BUILDING DESIGNERS** ASSOCIATION OF AUSTRALIA

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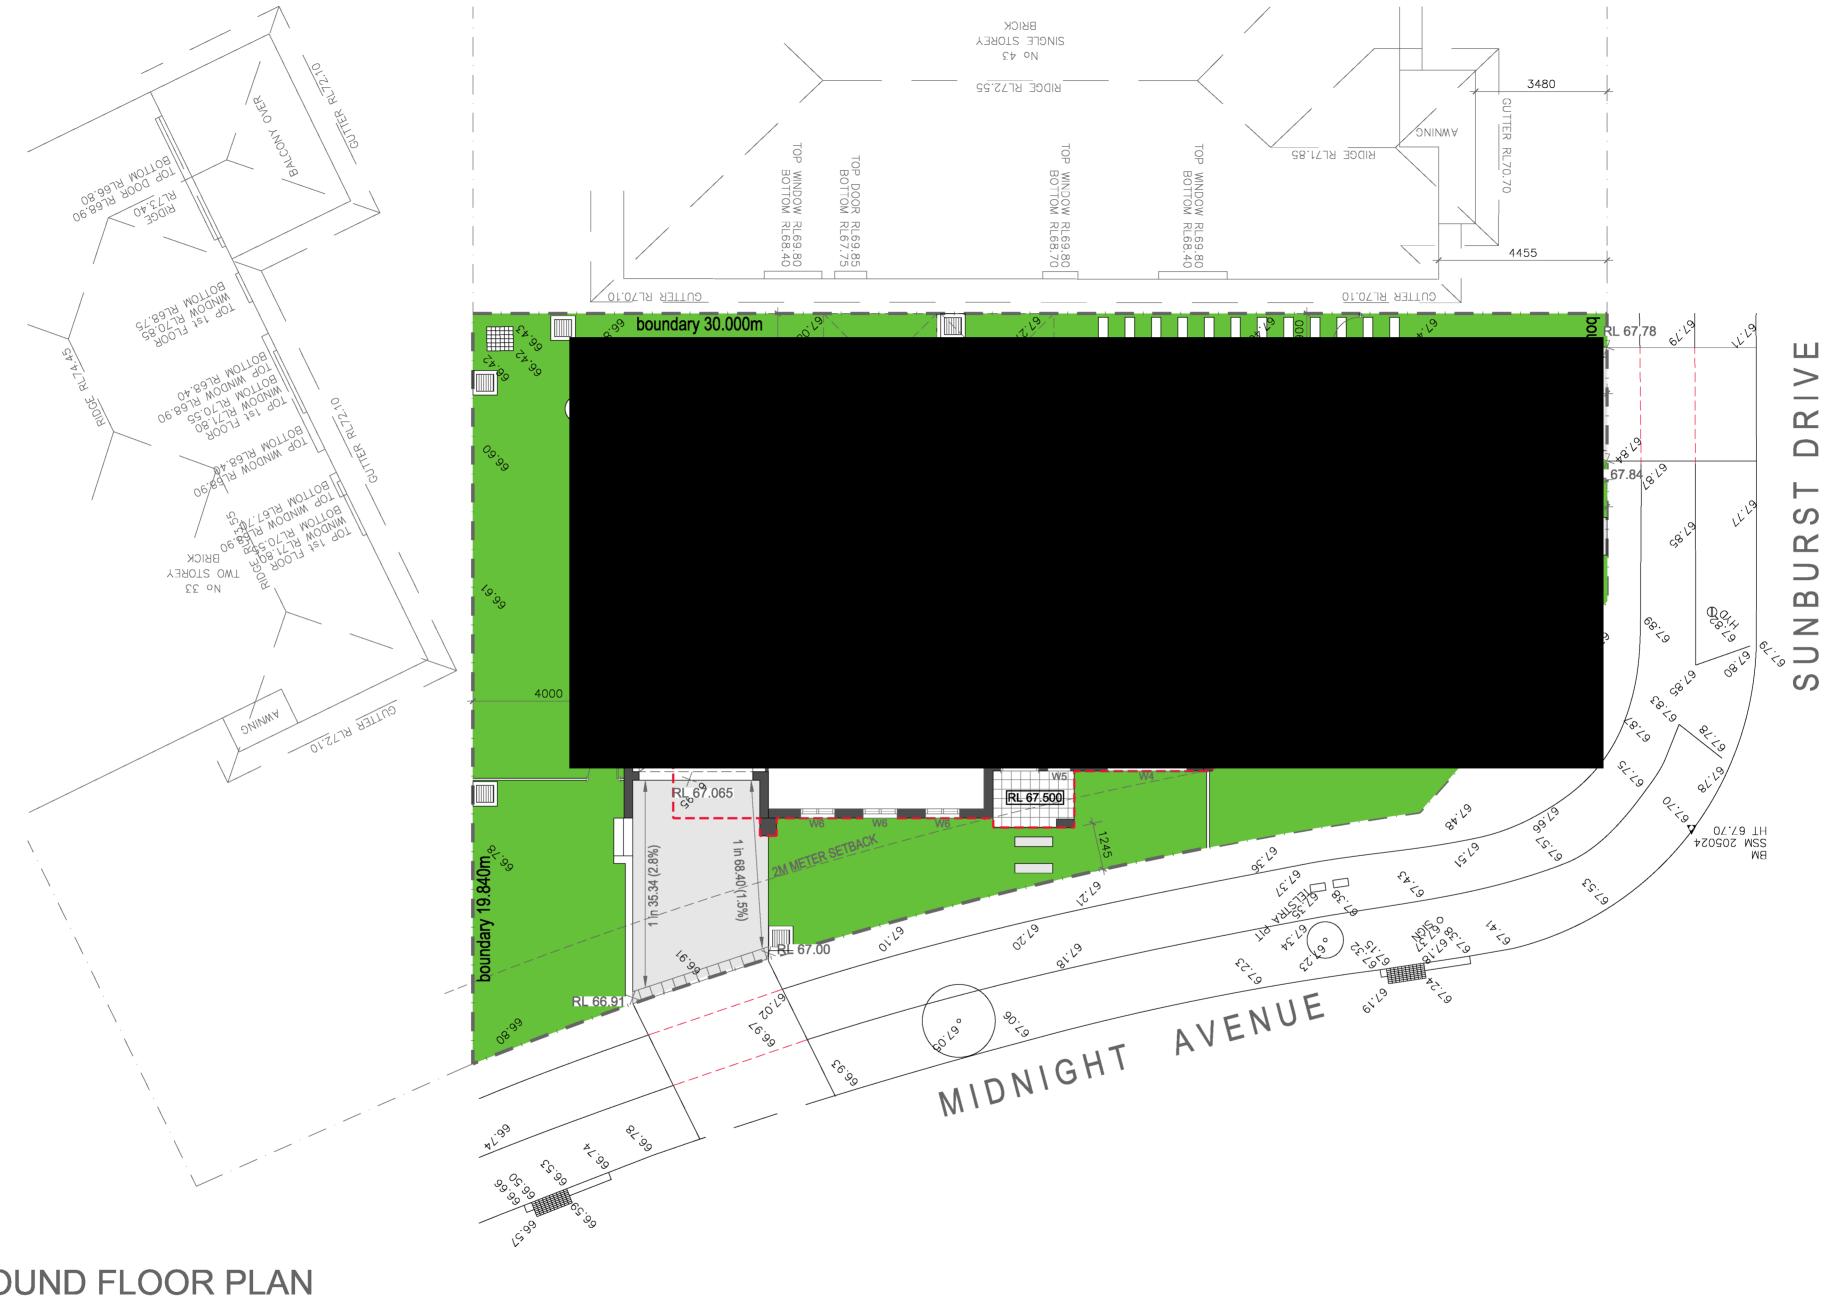
- North Parramatta, NSW 2151 t. 0411 983 593 e. danny@dadesignworx.com.au
- O Builder/Contractor must verify all dimensions on site prior to commencement of any construction work or shop drawings.
- O Only figured dimensions to be used.
- O All scaled dimensions must be verified. O Copyright DA DESIGNWORX pty ltd.
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Zedcorp Developments	Title: ROOF PLAN / SH	IADOW PLAN	1 / CON	NSTRU(CTION PLAN
Address: 41 Sunburst Drive, Caddens, N.S.W		Drawn: A.B. Checked: D.B.		12-21 ale:	Project No. 21-045 Draw. No.
Project: PROPOSED 2 STOREY ATTACHED DUAL C	OCCUPANCY	Sheet of 01	04	Issue A	DA-01

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SITE & GROUND FLOOR PLAN

SCALE 1:100
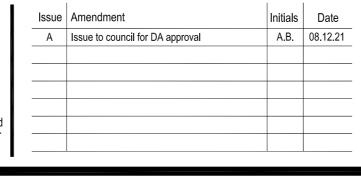
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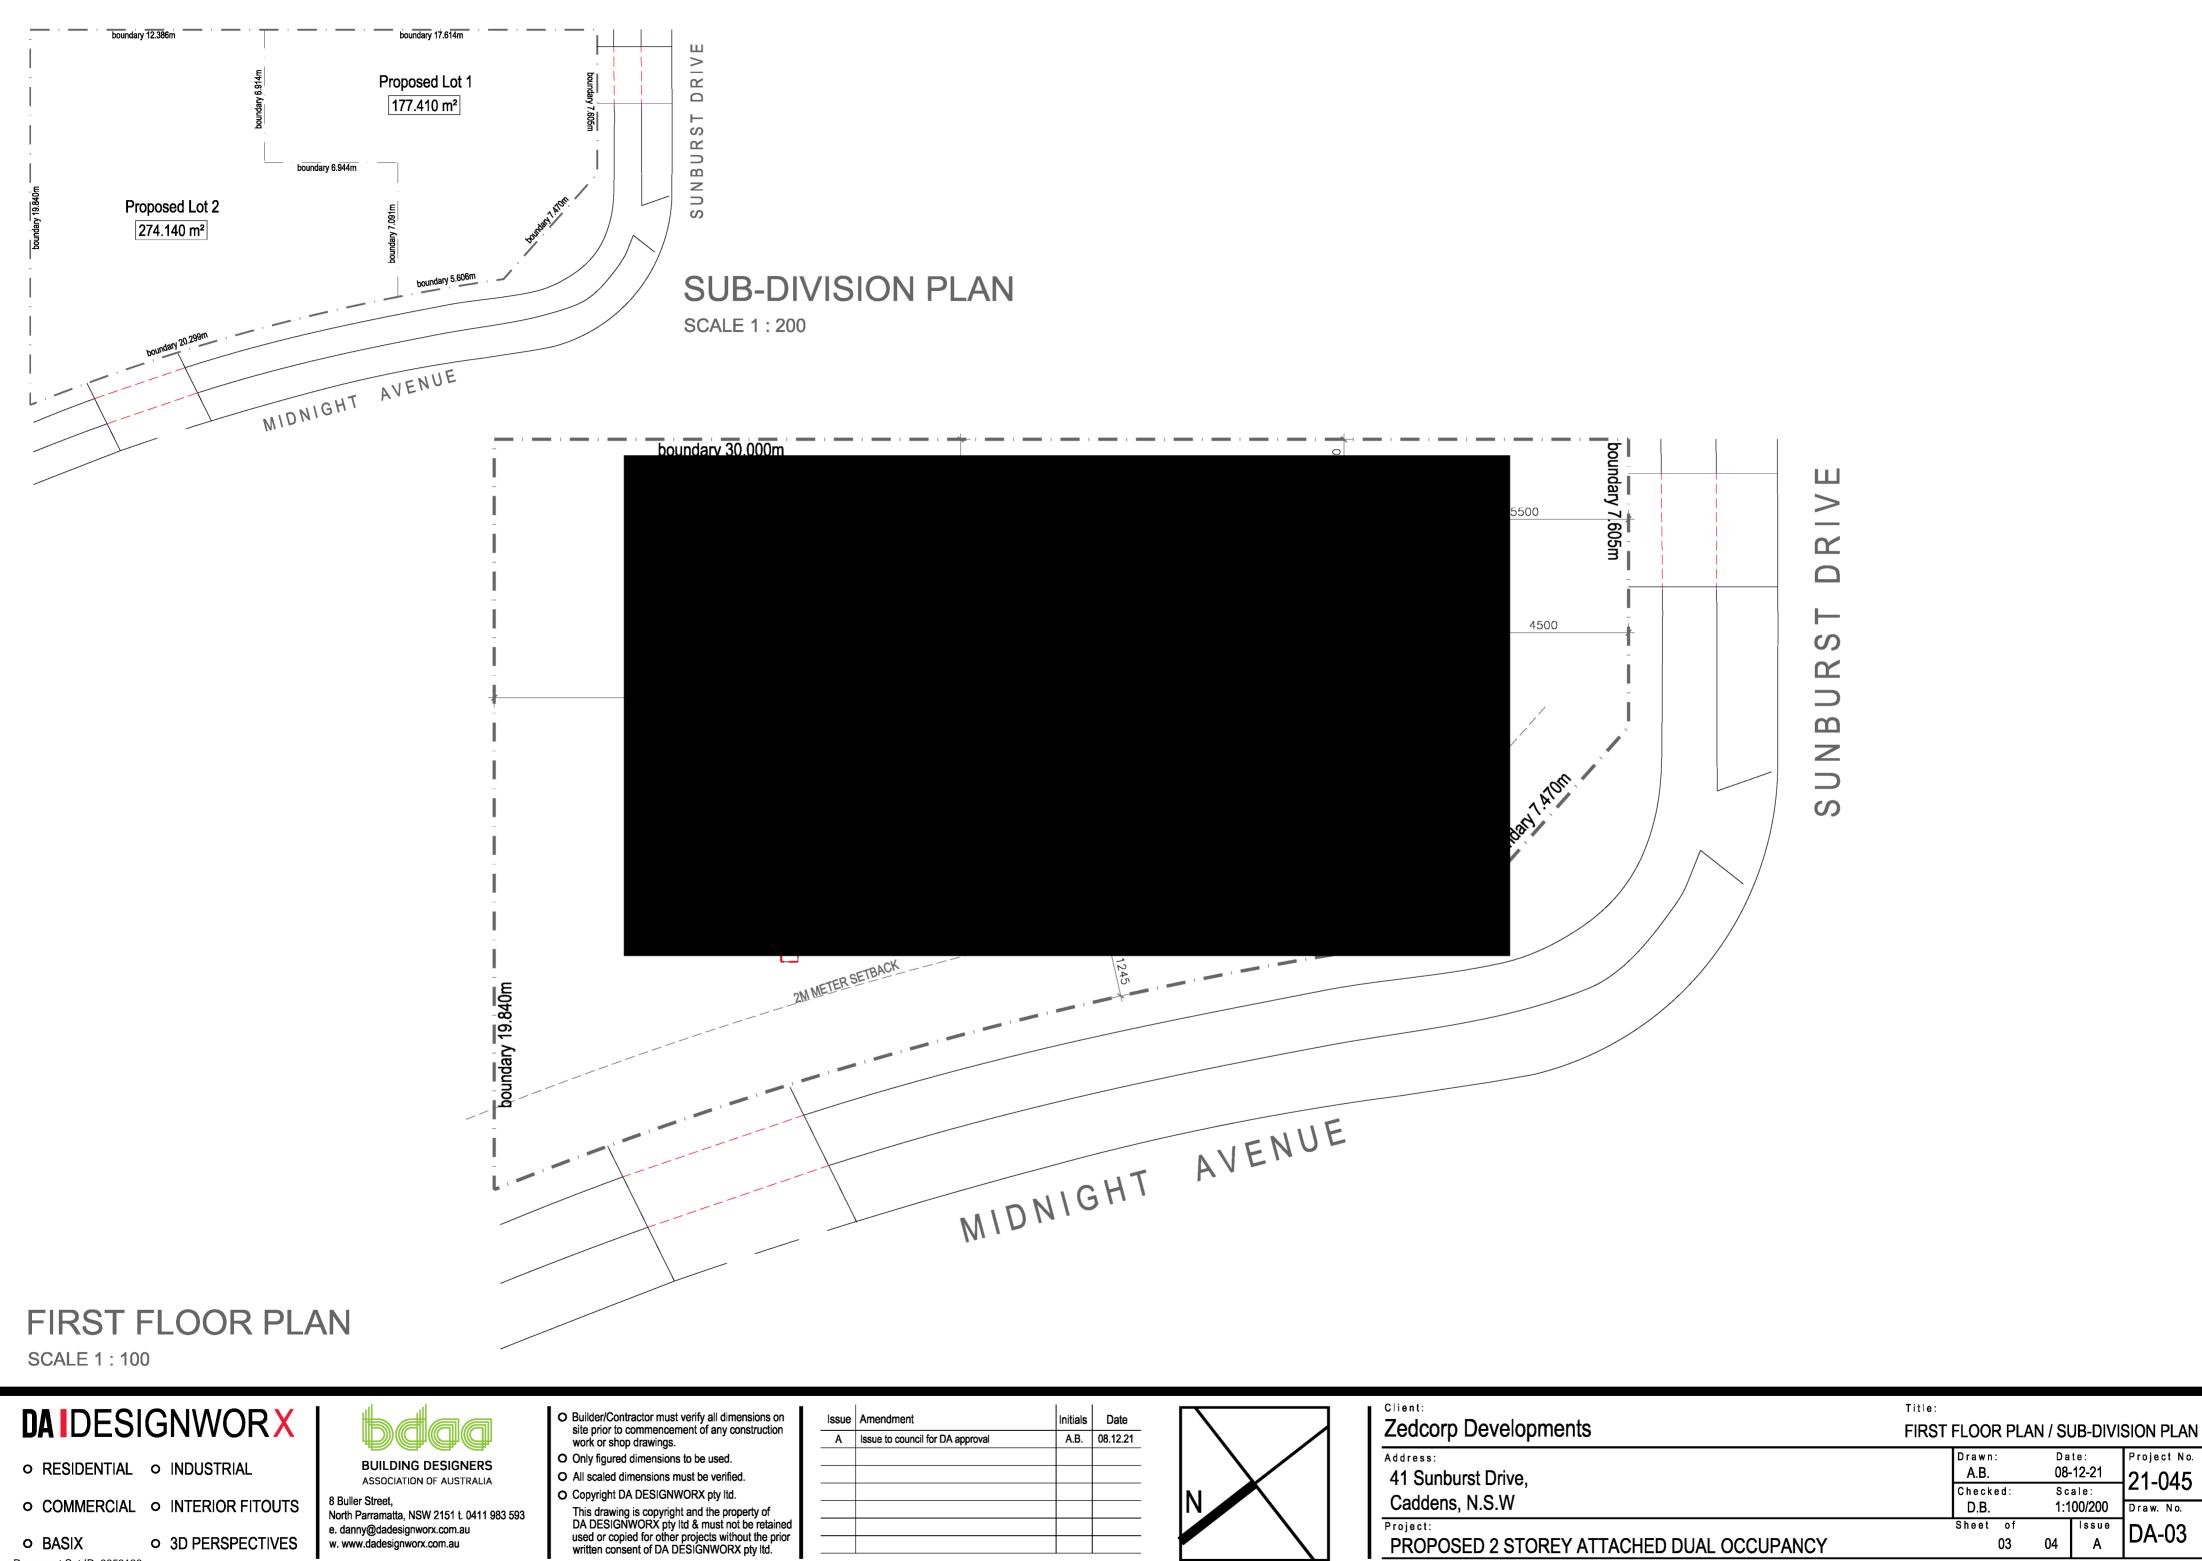
Issue Amendment

A Issue to council for DA approval

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Client:	Title:							
Zedcorp Developments	SITE &	SITE & GROUND FLOOR PLAN						
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Caddens, N.S.W	Checked: D.B.	Scale: 1:100		Draw. No.				
Project: PROPOSED 2 STOREY ATTACHED DUAL OCCUPANCY	Sheet of 02	04	Issue A	DA-02				



Project No.

21-045

Draw. No.

Date:

08-12-21

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Issue


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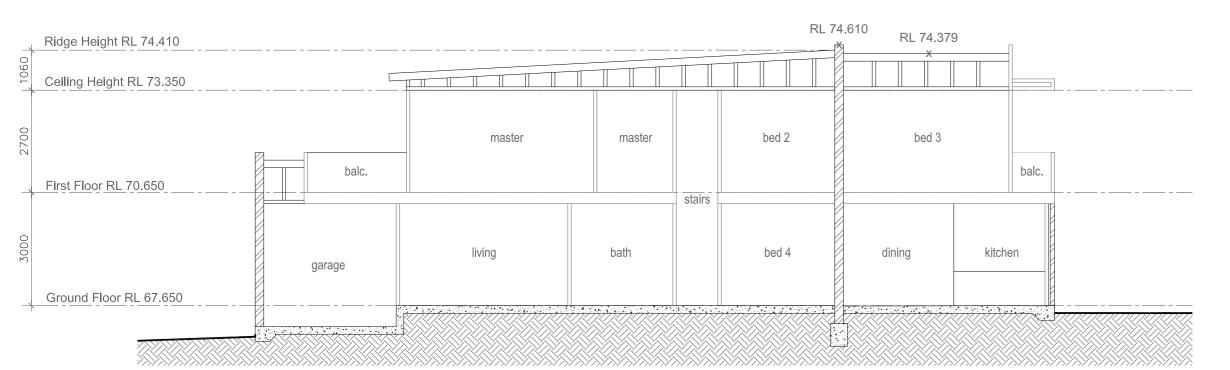
WEST ELEVATION

SCALE 1:100



EAST ELEVATION

SCALE 1:100

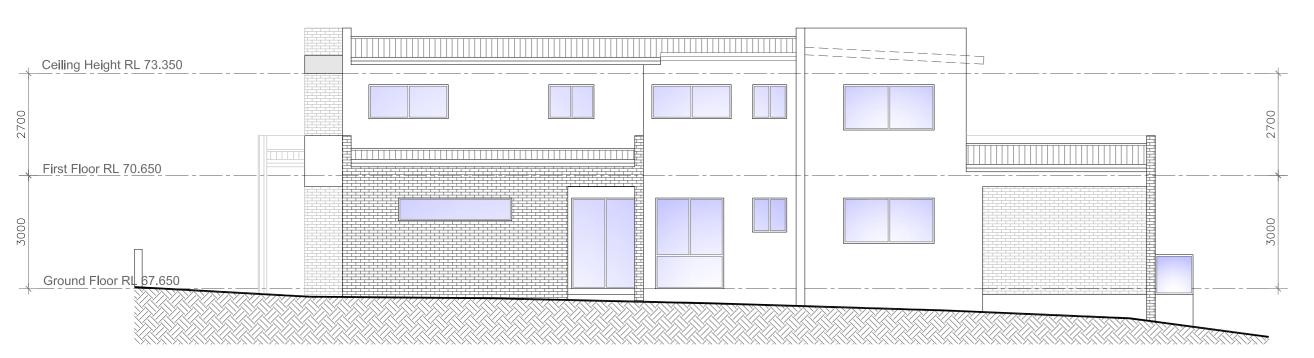

SECTION A-A

SCALE 1:100


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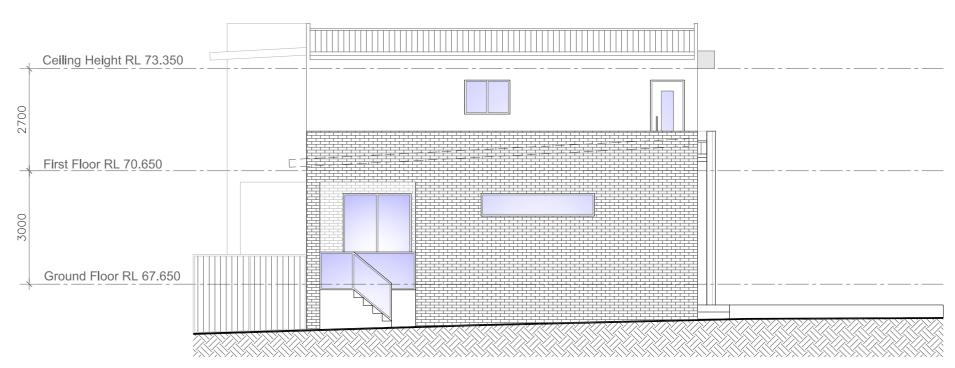
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NORTH ELEVATION

SCALE 1:100



SOUTH ELEVATION

SCALE 1:100

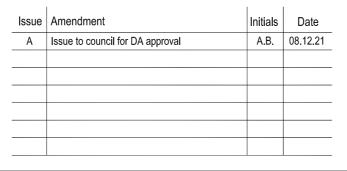Client:	Title:						
Zedcorp Developments	ELEVATIONS / SECTION A-A						
Address: 41 Sunburst Drive, Caddens, N.S.W	Drawn: A.B. Checked: D.B.	Date 08-12 Scal 1:100	2-21 e:	Project No. 21-045 Draw. No.			
Project: PROPOSED 2 STOREY ATTACHED DUAL OCCUPANCY	Sheet of 04	04	ssue A	DA-04			

(i) Water								how on A plans	Show on CC/CDC plans & specs	Certifier		Co	oling	He	ating			Artificia	Artificial lighting N.							
(a) The applicant must comply with the commitments listed below in carrying out the development of a dwelling listed in a table below.								A plans	pians & specs	CHECK	no.	ng living areas	bedroom areas	living areas	bedroom areas	No. of bedrooms	No. of living &/or	Each kitchen	All bathrooms	Each laundry	All hallways	No. of bathroom	Main ns kitcher			
(b) The applicant must plant indigenous or low water use species of vegetation throughout the area of land specified for the dwelling in the "Indigenous species" column of the table below, as private landscaping for that dwelling. (This area of indigenous vegetation is to be contained within the "Area of garden and lawn" for the dwelling specified in the "Description of Project" table).								>	~		U1	1-phase	1-phase	1-phase	1-phase	&/or study	rooms	yes	toilets	yes	yes	&/or toilets	yes			
(c) If a rating is specified in the table below for a fixture or appliance to be installed in the dwelling, the applicant must ensure that each such fixture and appliance meets the rating specified for it.							t		¥	~		airconditioning 3 star (average	airconditioning 3 star (average	g airconditioning 3 star (average	airconditioning 3 star (average	(dedicated)	(dedicated)	(dedicated)	(dedicated)	(dedicated)	(dedicated)					
(d) The applicant must install an on demand hot water recirculation system which regulates all hot water use throughout the dwelling, where indicated for a dwelling in the "HW recirculation or diversion" column of the table below.						lling,		~	-	All	zone) (zoned) 1-phase	zone) (zoned) 1-phase	zone) (zoned) 1-phase	zone) (zoned) 1-phase	1	1	ves	ves	ves	ves	2	yes				
(e) The applic	ant must instal	II:										other	airconditioning			airconditioning 3 star	(dedicated)	(dedicated)		(dedicated)	(dedicated)	(dedicated)	2	yes		
tr	e "HW recircul	ation or div	version" column	, kitchen sinks and all basi of the table below; and						~	~		(average zone) (zoned)	(average zone) (zoned)	(average zone) (zoned)	(average										
m	ust connect the	e hot water	diversion tank to	ted to the hot water divers o all toilets in the dwelling. ool or spa for the dwelling,						~	~															
table belo	W.					cuing triat	specified for it in	uic	V	~		Dwelli		Jal pool Timer S	Individual s Spa heating	Timer Kitche	en Re	frigerator \		other efficient		thes Indoor	or Priv	vate		
			specified in the	st have a pool cover or sha table	ading (or bour).					~		no.	system		system		op/oven		ventilated fridge		vasher dry	er shelter clothes	ed outo	door or sheltered thes		
				ernative water supply syste	m, with the specifie	ed size, list	ed for that dwelling	ng in	<u> </u>	V		All				- gas co	oktop & -		yes -			no		ing line		
		er supply s	ystem), and to d	collect run-off from the ar livert overflow as specified	Each system must		cted as specified		_			dwellin	gs			electric			yes				yes			
Dwelling All	All toi		All	HW All	Appliances All dish-	Volume	Individu Pool Po		Pool	Volume Spa	l spa Spa								Alt	ternative ener	gy					
no. she	ower- flushi ads system			recirculation clother or diversion washed		(max volume		ation	shaded	(max cover volume)	shaded	Dwelli	ng no.				ovoltaic systen	n (min rated e	electrical outpu	rt in peak kW)						
All 4 s dwellings 4.5	but	4 sta	r 4 star	no -	-	-	- -		-	-	-	All dwe				0.0					Chaw an	Shaw on CC	one e			
L/n													ermal Comfort	-#b-##6	ata antonna dita con		ilell on the form	t name of this !	DAOIV	- 41	Show on DA plans	Show on CC/ plans & spec		ertifier neck		
					A.V							th	ne applicant must a Assessor Certificat De applicant is appl	e") to the develop ying for a comply	oment application a ring development of	and construction of certificate for the p	certificate applic proposed devel	cation for the p opment, to that	proposed develo at application). T	pment (or, if the applicant						
Dwelling no.	Alternative v	water	Size	Configuration	Alternative w	vater sour		oilet	Laund	lry Pool	Spa top-u		ust also attach the ne Assessor Certif		- 11											
	supply syste	ems						onnections)	n conne	ction top-up			ne details of the pre					t with the deta	ails shown in this	BASIX						
All dwellings	individual wa 1)	iter tank (no	o. Tank size (min) 2000. litres	To collect run-off from 80.0 square metres of 0.0 square metres of	of roof area;		yes	10	no	no	no	11 ' '	ne applicant must s		. , ,						V					
			liues	0.0 square metres of and	garden and lawn a	rea;						the Accredited Assessor, to certify that this is the case. (e) The applicant must show on the plans accompanying the application for a construction certificate (or complying development														
				0.0 square metres of	planter box area.								certificate, if applicable), all thermal performance specifications set out in the Assessor Certificate, and all aspects of development which were used to calculate those specifications.							the proposed						
None	-		-	-			- -		-	-	-	`` c	(f) The applicant must construct the development in accordance with all thermal performance specifications set out in the Assessor Certificate, and in accordance with those aspects of the development application or application for a complying development certificate which were used to calculate those specifications.								~					
(ii) Energy									how on A plans	Show on CC/CDC plans & specs	Certifier check		(g) Where there is an in-slab heating or cooling system, the applicant must:								J					
V. Z				sted below in carrying out t			2002 102 103 10 10						(aa) Install insulation with an R-value of not less than 1.0 around the vertical edges of the perimeter of the slab; or													
supplied b	y that system.	If the table	specifies a cent	ecified for the dwelling in t ral hot water system for th s hot water is supplied by t	e dwelling, then the				~	~	~	/b\ T	(bb) On a suspended floor, install insulation with an R-value of not less than 1.0 underneath the slab and around the vertical edges of the perimeter of the slab.													
				n and laundry of the dwelli have the operation control			cified for that roo	n in		~	v	11	(h) The applicant must construct the floors and walls of the development in accordance with the specifications listed in the table below.							~						
areas" hea	adings of the "C	Cooling" an	d "Heating" colu	ystem/s specified for the di	for at least 1 living/b	pedroom a	rea of the dwelling	g. If		•	-															
any such a		m "zoned"	is specified besi	e for "Living areas" or "Bed ide an air conditioning syst														Т	Thermal loads							
(ii) Energy									Show on OA plans	Show on CC/CDC plans & specs	Certifie	Dwelli	ng no.		a adjusted heatir	g load (in mJ/m²	/yr)			djusted coolin	g load (in mJ/	m²/yr)				
				e dwelling which is referre hat room or area). The ap				nn of			J	— U1	er dwellings	50.0 54.0					43.0 50.0							
lighting" fo specified f	r each such roo or a particular r	om in the d room or are	lwelling is fluore: ea, then the light	scent lighting or light emitt fittings in that room or are	ing diode (LED) ligh	nting. If the	e term "dedicated	" is		,	'							uction of floo								
(f) This comm	itment applies	to each roo		ung. e dwelling which is referred hat room or area). The ap					<u> </u>		<u> </u>	Dwellii U1	ng no. Concre	te slab on groun	na(m²) Suspen subfloo	ded floor with op r (m²)		ended floor w osed subfloo	or (m²) g	Suspended flo garage (m²) 18	or above	mudbrick	ammed ear walls	tn or		
fitted with	a window and/o	or skylight.		rater heating system for the				.415		<u> </u>	<u> </u>	All othe	er 79				-		2			No No				
(aa) in:	stall the system	n specified	for the pool in th	ne "Individual Pool" columnoplicant must install a time	of the table below	(or alterna	atively must not in	stall				dwellin	ys													
(bb) in:	stall the system	n specified	for the spa in the	e "Individual Spa" column	of the table below (or alternati		tall		Į į																
any system for the spa). If specified, the applicant must install a timer to control the spa's pump. (h) The applicant must install in the dwelling:						.																				
(aa) the kitchen cook-top and oven specified for that dwelling in the "Appliances & other efficiency measures" column of the table below;							~																			
(bb) each appliance for which a rating is specified for that dwelling in the "Appliances & other efficiency measures" column of the table, and ensure that the appliance has that minimum rating; and							~	~																		
(cc) any clothes drying line specified for the dwelling in the "Appliances & other efficiency measures" column of the table.								~																		
(i) If specified in the table, the applicant must carry out the development so that each refrigerator space in the dwelling is "well ventilated". (j) The applicant must install the photovoltaic system specified for the dwelling under the "Photovoltaic system" heading of the								~																		
				connect the system to tha					~	~	~															
Hot water Bathroom ventilation system Kitchen ventilation system										aundry ventilation sy	rstem															
The second secon	t water syster	m Ea	ch bathroom	Operation control			Operation cor	itrol	Each laun		on control															
no.																										

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