

NOTES: USE FIGURED DIMENSIONS ONLY, DO NOT SCALE.

CHECK ALL DIMENSIONS PRIOR STARTING ANY WORK REPORT ANY DISCREPANCIES FINISHED GROUND LEVELS SHOWN ON PLAN ARE SUBJECT TO SITE CONDITIONS

\* ALL CALCULATED DIMENSIONS ARE SUBJECT TO SITE MEASURE DURING

NO ALLOWANCE HAS BEN MADE FOR SHRINKAGE OR MILLING POSITION OF ELECTRICAL METER TO BE DETERMINED ON SITE

PROOF OF EXISTENCE OF ALL SERVICES IS THE CONTRACTOR'S RESPONSIBILITY. CURRENT "DIAL BEFORE YOU DIG" SERIVCES PLANS MUST BE OBTAINED PRIOR TO COMMENCING ANY EXCAVATION



AREAS:	
Site Plan:	428.70m <sup>2</sup>
Living Area:	167.86m <sup>2</sup>
Porch:	3.12m <sup>2</sup>
Alfresco:	25.78m <sup>2</sup>
Garage:	33.09m <sup>2</sup>
TOTAL:	229.85m²
Courtyard:	
Required:	64.30m <sup>2</sup>
Proposed:	119.40m <sup>2</sup>
Provide 6 x 4 Dim:	Yes

General Notes:

1. All work to be carried out in accoradnce with the requirements of the Building Code of Australia and the relevant local authority.

2. All timber framing to be carried out to the requirements of Australian Standards (as 1684) as a minimum.

3. All reinforced concrete, steel beams including supports, and nominated beams including supports to Engineer's details.

4. Sturctural Engineer to check, detail and certify brickwork to garage area with a height greater than 3000mm between horizontal supports.
5. All brickwork to be constructed in accordance with the requirements of the Building Code of Australia.

6. Control joints in brickwork to be provided in accordance with the requirements of the Building Code of Australia.

7. Doorway openings with inward opening doors to room containing toilets which are closer than 1200mm to the toilet are to be fitted with hinges to allow the door to be removed from the outside when the door is closed.

Construction Notes:
\* R2.20 External Wall Insulation (Including Construction)

\* R3.0 Ceiling Insulation

\* Provide Foil & Sarking to Roof

Control Joints to be checked in accordance with


engineers plans
\* Centre of kitchen Sink, Vanity, WC, Range Hood, to
be confirmed with owner & Manufacturer Details.

\* All windows, Insulation requirements, lighting to comply with Basix Certificate Approvde by council.


Structural slab to engineer details.


Metre Box, Gas Metre to be confirmed with Builder on site.

Downpipes to be confirmed with plumber on site.

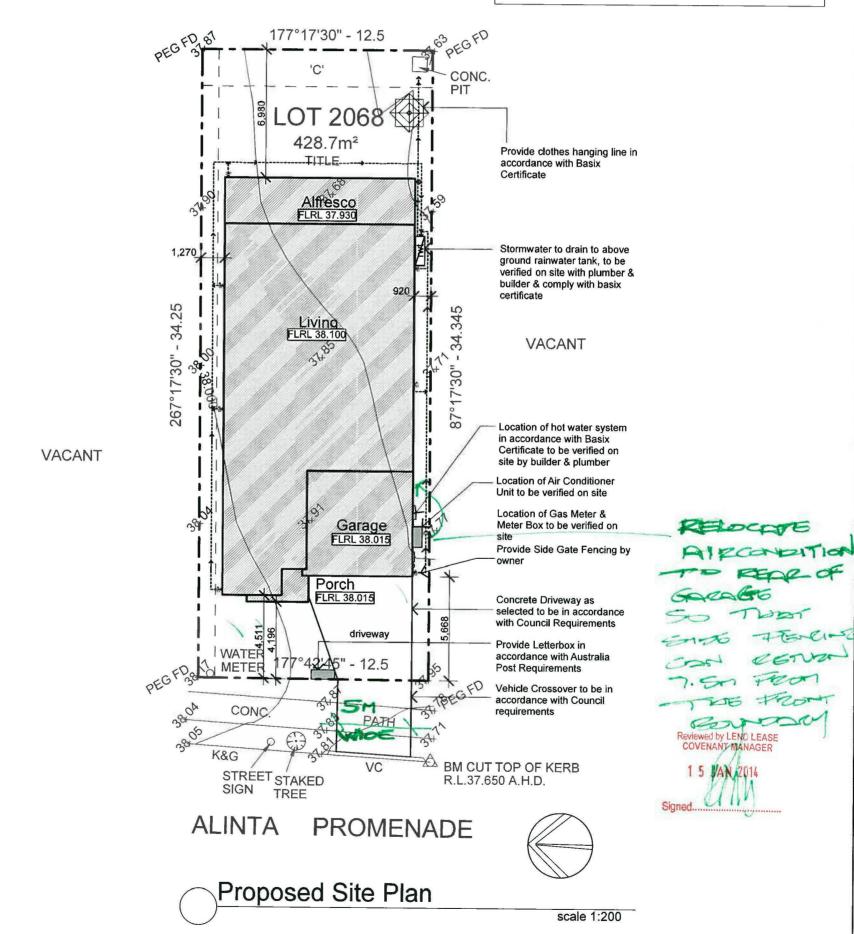

Issue Amendment Date Proposed: Preliminary Sketch Plans 25,10,13 Proposed Site Plan / Preliminary Sketch Plans New Single Storey Residence 28,11,13 Concept Drainage Plan В DESIGN & DRAFTING ocation: Lot 2068 Alinta Promenade, Phone: (02) 9757 - 4002 Fax: (02) 9757 - 4003 Email: jr.design.drafting@gmail.com Address: 448 - 452 Victoria Street, Wetherlit Park, NSW 2164 Job No Jordan Springs, NSW Date 28.11.2013 LB1329 **LB Homes** 

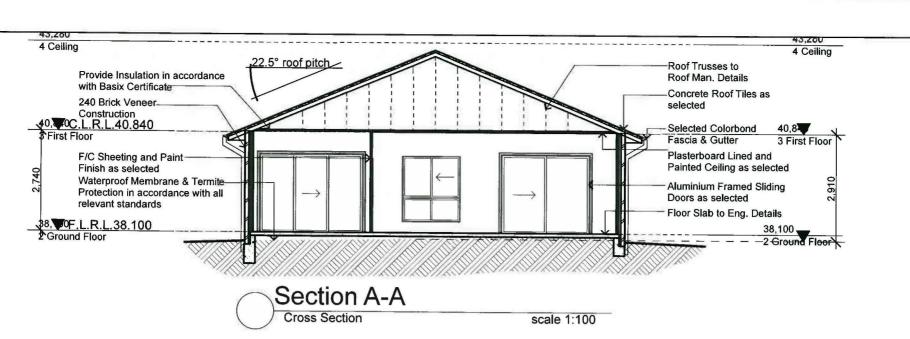

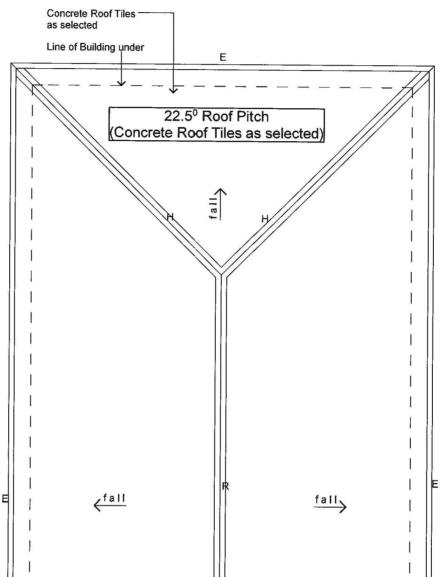

## Window Schedule

WINDOW NUMBER	WIDTH (mm)	HEIGHT (mm)	COMMENT
W1	610	1800	Aluminium Double Hung
W2	850	1800	Aluminium Double Hung
W3	2050	860	Aluminium Sliding
W4	610	860	Aluminium Sliding Obscure
W5	1570	600	Aluminium Sliding
W6	2410	2140	Aluminium Sliding Door
W7	1570	1800	Aluminium Sliding
W8	1810	600	Aluminium Sliding
W9	1810	600	Aluminium Sliding
W10	610	860	Aluminium Sliding Obscure
W11	1570	860	Aluminium Sliding Obscure
W12	1810	860	Aluminium Stiding

Note: \* All Windows are to Dowell Windows Spec.
\*All Windows to be counted & checked
Before Ordering

LEGEND:

Fall - DIRECTION OF FALL PROPOSED ROOF - EAVES LINE

R - RIDGE


H - HIP V - VALLEY


Reviewed by LEND LEASE COVENANT MANAGER

1 5 JAN 2014 Signed......

Roof Plan


Issue Amendment  A Preliminary Sketch Plans	Date		North:	Propose	d:	Drawin	Title:		Revision:
Preliminary Sketch Plans	25.10.13 28.11.13		Location		First Floor Plan		В		
		Phone: (02) 9757 - 4002 Fax: (02) 9757 - 4003 Email: jr.design.drafting@gmail.com Address: 448 - 452 Victoria Street, Wetherill Park. NSW 2164		Client:	Lot 2068 Alinta Promenade, Jordan Springs. NSW	Drawa		Tou	Job No:
		Note. Builder shall check and verify all dimensions prior to the commencement of any work	Copyright This plan is the exclusive property of JR Design & Drafting, and must not be used, reproduced or copied wholly or partly in any way without permission		LB Homes	Drawn Scale	JR 1:100	Date 28.11.2013 Sheet 4 of 8	LB1329

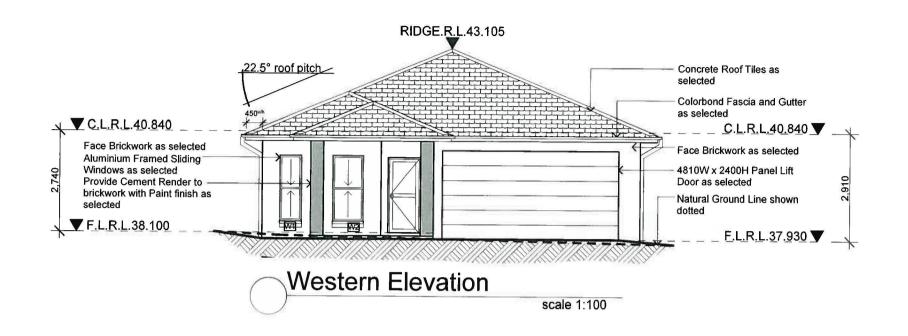


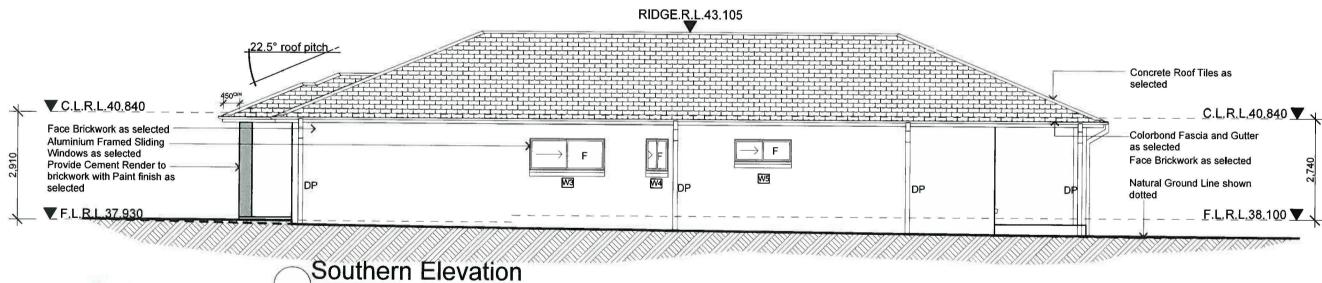

Reviewed by LEND LEASE COVENANT MANAGER

Issue Amendment Date:	#	North:	General Notes		Proposed:	Drawing Title:	Revision:
A Preliminary Sketch Plans 25.10.13  B Preliminary Sketch Plans 28.11.13	Phone: (02) 9757 - 4002 Fax: (02) 9757 - 4003		All work shall be carried out strictly in accordance with The Building Code Of Australia, relevant S.A.A. codes & to the satisfaction of the regulatory authority. All levels, dimensions & areas are to be verified by the Builder, prior to the preparation of contracts	Levels shown are approximate unless accompanied by reduced levels or Australian Height Datum Levels. Figured dimensions to be taken in preference to scaling.	New Single Storey Residence Location: Lot 2068 Alinta Promenade,	Southern Elevation Eastern Elevation	B
	Email: jr.design.drafting@gmail.com Address: 448 - 452 Victoria Street, Wetherill Park, NSW 2164		& the commencement of any building works.  Any discrepancies are to be brought to the attention	Stormwater to be disharged to Councils requirements	Jordan Springs. NSW	Drawn Date	
	Note: Builder shall check and verify all dimensions prior to the commencement of any work	Copyright: This plan is the exclusive property of JR Design & Orafling, and must not be used, reproduced or copies wholly or partly in any way without permission	(100	before any work commences. All services to be located & verified by the Builder with relevant Authorities before any work commences.	LB Homes	Scale 1:100 Sheet 5 of 8	LB1329

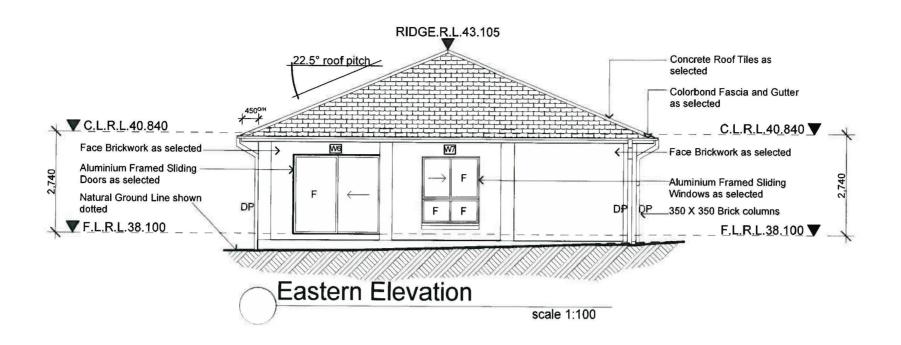

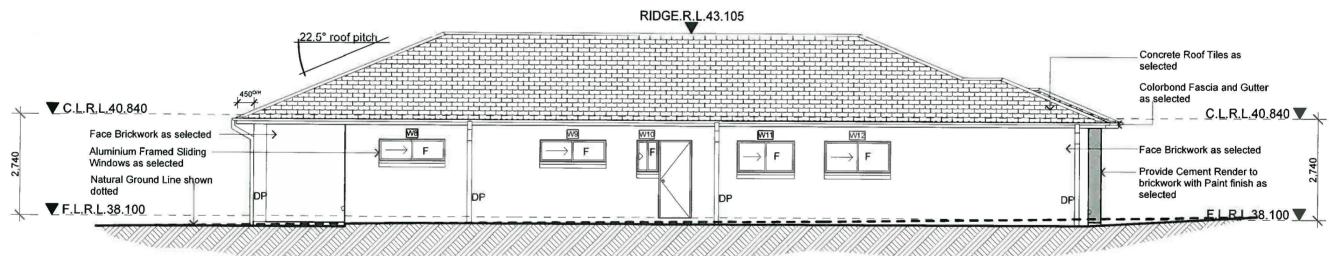


Northern Elevation

scale 1:100

Reviewed by LEND LEASE COVENANT MANAGER

1 5 JAN 2014 Signed.....

Issue Amendment	Date:		North:	General Notes		Proposed:	Drawing Title:	Revision:
	25.10.13 28.11.13	Phone: (02) 9757 - 4002 Fax: (02) 9757 - 4003 Email: jr.design.drafting@gmail.com		All work shall be carried out strictly in accordance with		New Single Storey Residence  Location: Lot 2068 Alinta Promenade, Jordan Springs. NSW	Southern Elevation Eastern Elevation L.G.A	B
	Address. 448 - 452 Victoria Street, Wetherill Park. NSW 2164  Note Builder shall check and verify all dimensions prior to the commencement of any work  This plan is the exclusive property of JR Design the exclusive property of JR Design the property of JR Design the property of JR Design that the property of	Any discrepancies are to be brought to the attention of JR Design & Drafting, prior to the commencement of any building works.  Any discrepancies are to be brought to the attention before any work commences.  All services to be located & verified by the Builder with relevant Authorities before any work commences.	Client:  LB Homes	Drawn JR Date 28.11.20 Scale 1:100 Sheet 6 of 6	LB1329			

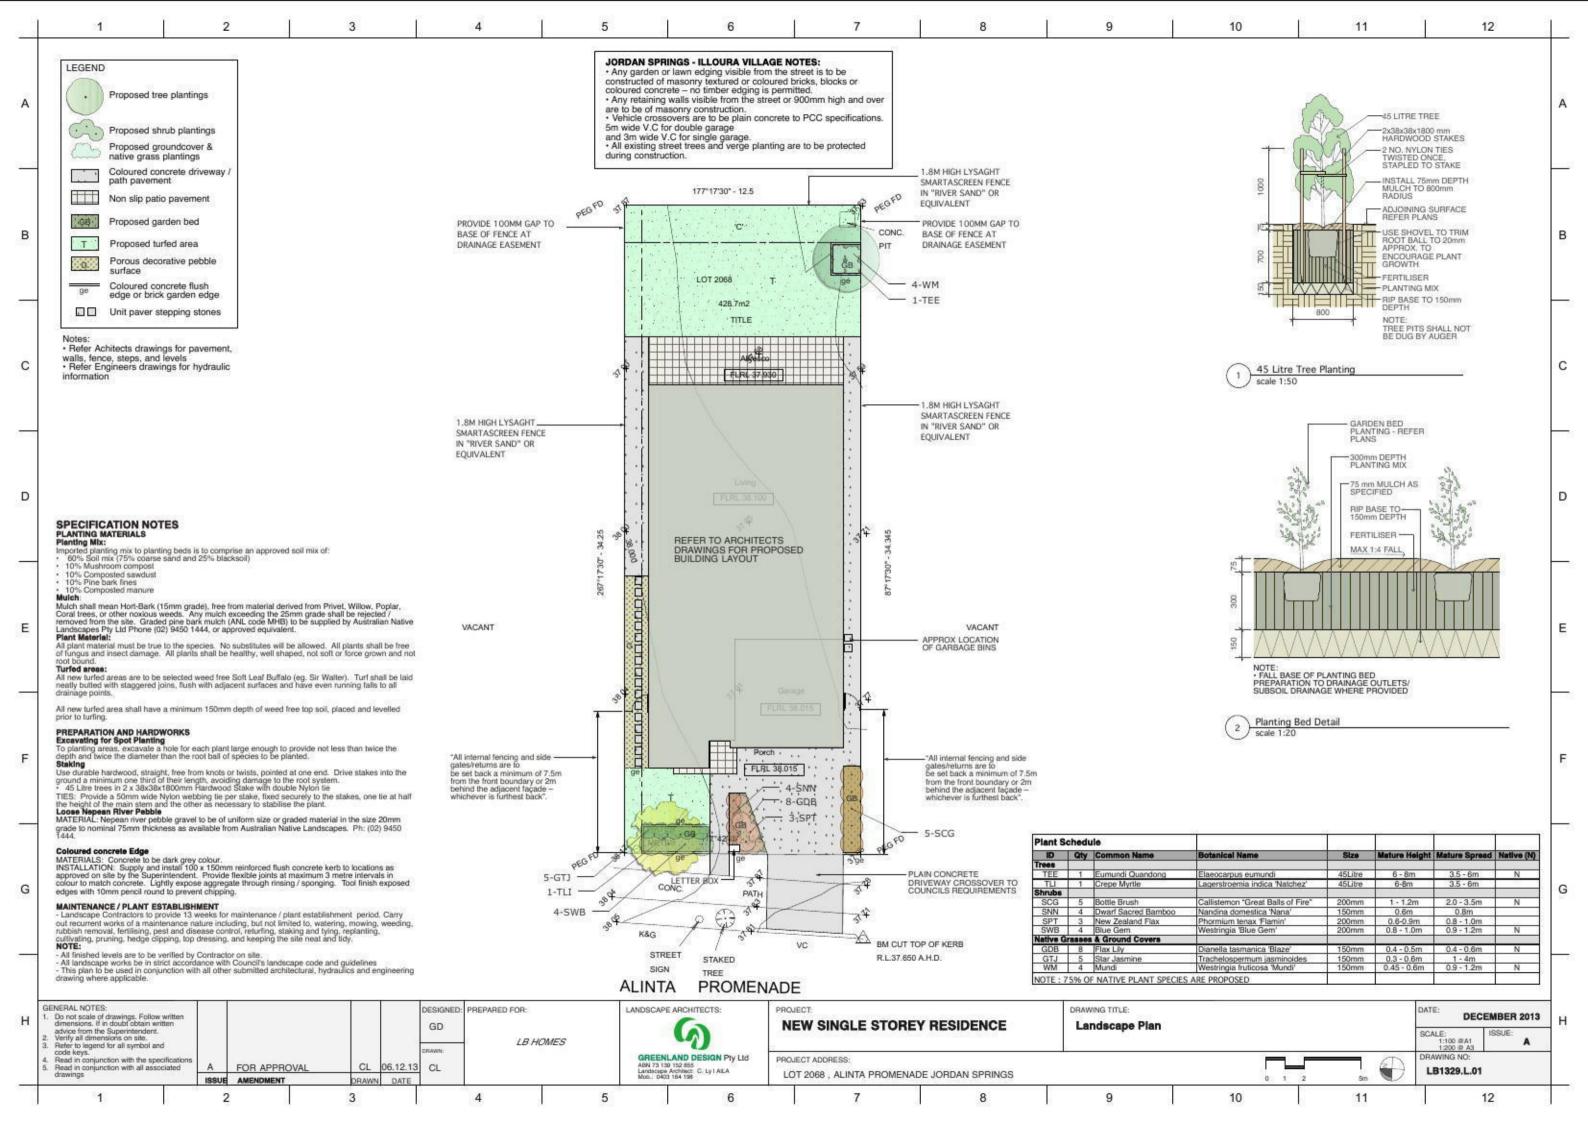

# Proposed New Single Storey Residence Located At: Lot 2068 Alinta Promenade, Jordan Springs. NSW

### Schedule of BASIX commitments

The commitments set out below regulate how the proposed development is to be carried out. It is a condition of any development consent granted, or complying development certificate issued, for the proposed development, that BASIX commitments be complied with

The applicant must install showerheads with a minimum rating of 3 star (> 4.5 but <= 6 L/min) in all showers in the development.

The applicant must install a toilet flushing system with a minimum rating of 1 star in each toilet in the development.

The applicant must install taps with a minimum rating of 3 star in the kitchen in the development.

The applicant must install basin taps with a minimum rating of 3 star in each bathroom in the development.

Rainwater tank

The applicant must install a rainwater tank of at least 2000 litres on the site. This rainwater tank must meet, and be installed in accordance with, the requirements of all applicable regulatory authorities.

The applicant must configure the rainwater tank to collect rain runoff from at least 270.68 square metres of the roof area of the development (excluding the area of the roof which drains to any stormwater tank or private dam).

The applicant must connect the rainwater tank to:

· all toilets in the development

· at least one outdoor tap in the development (Note: NSW Health does not recommend that rainwater be used for human

consumption in areas with potable water supply.) Floor, walls and ceiling/roof

The applicant must construct the floor(s), walls, and ceiling/roof of the dwelling in accordance with the specifications listed in the table below.

Construction Additional insulation required (R-Value) Other specifications

floor - concrete slab on ground nil

external wall - brick veneer 1.66 (or 2.20 including construction)

internal wall shared with garage - plasterboard nil

ceiling and roof - flat ceiling / pitched roof ceiling: 3 (up), roof: foil/sarking unventilated; medium (solar absorptance 0.475-0.70) Note Insulation specified in this Certificate must be installed in accordance with Part 3.12.1.1 of the Building Code of Australia. Windows, glazed doors and skylights

The applicant must install the windows, glazed doors and shading devices described in the table below, in accordance with the specifications listed in the table. Relevant overshadowing specifications must be satisfied for each window and glazed door. The dwelling may have 1 skylight (<0.7 square metres) and up to 2 windows/glazed doors (<0.7 square metres) which are not listed in

The following requirements must also be satisfied in relation to each window and glazed door:

- · Except where the glass is 'single clear' or 'single toned', each window and glazed door must have a U-value no greater than that listed and a Solar Heat Gain Coefficient (SHGC) +/-10% of that listed. Total system U-values and SHGC must be calculated in accordance with National Fenestration Rating Council (NFRC) conditions.
- . The leading edge of each eave, pergola, verandah, balcony or awning must be no more than 500 millimetres above the head of the window or glazed door, except that a projection greater than 500 mm and up to 1500 mm above the head must be twice the value in the table.
- · Pergolas with polycarbonate roof or similar translucent material must have a shading coefficient of less than 0.35.
- . Unless they have adjustable shading, pergolas must have fixed battens parallel to the window or glazed door above which they are situated, unless the pergola also shades a perpendicular window. The spacing between battens must not be more than 50 mm.

Window/glazed door no. Orientation Maximum area (square metres)

Type Shading Overshadowing W1 W 1.09 standard aluminium, single clear (or

U-value:7.63, SHGC:0.75)

eave/verandah/pergola/balcony 451-600 mm

not overshadowed

W2 W 1.53 standard aluminium, single clear (or U-value:7.63, SHGC:0.75)

eave/verandah/pergola/balcony

901-1,200 mm not overshadowed

W3,W4,W5 S 2.66 standard aluminium, single clear (or

U-value:7.63, SHGC:0.75) eave/verandah/pergola/balcony

451-600 mm

not overshadowed

W6 E 5.04 standard aluminium, single clear (or

U-value:7.63, SHGC:0.75)

eave/verandah/pergola/balcony >2.000 mm

not overshadowed

W7 E 2.82 standard aluminium, single clear (or

U-value:7.63. SHGC:0.75) eave/verandah/pergola/balcony

>2,000 mm

not overshadowed

W8,W9,W10,W11,W12 N 5.57 standard aluminium, single clear (or U-value:7.63, SHGC:0.75)

eave/verandah/pergola/balcony

451-600 mm

not overshadowed

The applicant must install the following hot water system in the development, or a system with a higher energy rating: gas

instantaneous with a performance of 3 stars.

Cooling system

The applicant must install the following cooling system, or a system with a higher energy rating, in at least 1 living area: 3-phase

airconditioning; Energy rating: EER 2.5 - 3.0

The applicant must install the following cooling system, or a system with a higher energy rating, in at least 1 bedroom: 3-phase

airconditioning; Energy rating: EER 2.5 - 3.0

The cooling system must provide for day/night zoning between living areas and bedrooms.

The applicant must install the following heating system, or a system with a higher energy rating, in at least 1 living area: 3-phase airconditioning; Energy rating: EER 2.5 - 3.0

The applicant must install the following heating system, or a system with a higher energy rating, in at least 1 bedroom: 3-phase airconditioning; Energy rating: EER 2.5 - 3.0

The heating system must provide for day/night zoning between living areas and bedrooms. Ventilation

The applicant must install the following exhaust systems in the development:

At least 1 Bathroom: no mechanical ventilation (ie. natural); Operation control: n/a Kitchen: individual fan, not ducted; Operation control: manual switch on/off Laundry: natural ventilation only, or no laundry; Operation control: n/a

Natural lighting The applicant must install a window and/or skylight in the kitchen of the dwelling for natural lighting.

The applicant must install a window and/or skylight in 2 bathroom(s)/toilet(s) in the development for natural lighting.

The applicant must install a gas cooktop & electric oven in the kitchen of the dwelling.

The applicant must construct each refrigerator space in the development so that it is "well ventilated", as defined in the BASIX

The applicant must install a fixed outdoor clothes drying line as part of the development

Issue	Amendment Preliminary Sketch Plans	Date		North:	Proposed:	Drawing 7 Cover		Basix	Revision:
В	Preliminary Sketch Plans Preliminary Sketch Plans	25.10.13 28.11.13			New Single Storey Residence	Requir			B
	1.6		Phone: (02) 9757 - 4002 Fax: (02) 9757 - 4003 Email: jr.design.drafting@gmail.com	12-	Location: Lot 2068 Alinta Promenade, Jordan Springs. NSW	L.G.A			Job No:
	8		Address: 448 - 452 Victoria Street, Wetherill Park. NSW 2164		Client:	Drawn	JR	Date 28.11.2013	LB1329
			Note: Builder shall check and verify all dimensions prior to the commencement of any work	Copyright: This plan is the exclusive property of JR Design & Drafting, and must not be used, reproduced or copied	LB Homes	Scale		Sheet 1 of 8	20.020

NOTES: USE FIGURED DIMENSIONS ONLY, DO NOT SCALE.

CHECK ALL DIMENSIONS PRIOR STARTING ANY WORK REPORT ANY DISCREPANCIES FINISHED GROUND LEVELS SHOWN ON PLAN ARE SUBJECT TO SITE CONDITIONS ALL CALCULATED DIMENSIONS ARE SUBJECT TO SITE MEASURE DURING CONSTRUCTION

NO ALLOWANCE HAS BEN MADE FOR SHRINKAGE OR MILLING POSITION OF ELECTRICAL METER TO BE DETERMINED ON SITE


PROOF OF EXISTENCE OF ALL SERVICES IS THE CONTRACTOR'S RESPONSIBILITY. CURRENT "DIAL BEFORE YOU DIG" SERIVCES PLANS MUST BE OBTAINED PRIOR TO COMMENCING ANY EXCAVATION.



AREAS:			
Site Plan:	428.70m <sup>2</sup>		
Living Area:	167.86m <sup>2</sup>		
Porch:	3.12m <sup>2</sup>		
Alfresco:	25.78m <sup>2</sup>		
Garage:	33.09m <sup>2</sup>		
TOTAL:	229.85m²		
Courtyard:			
Required:	64.30m <sup>2</sup>		
Proposed:	119.40m <sup>2</sup>		
Provide 6 x 4 Dim:	Yes		

- 1. All work to be carried out in accoradnce with the requirements of the Building Code of Australia and the relevant local authority. 2. All timber framing to be carried out to the requirements of Australian Standards (as 1684) as a minimum.
- 3. All reinforced concrete, steel beams including supports, and nominated beams including supports to Engineer's details.
- 4. Sturctural Engineer to check, detail and certify brickwork to garage area with a height greater than 3000mm between horizontal supports. 5. All brickwork to be constructed in accordance with the requirements of the Building Code of Australia.
- 6. Control joints in brickwork to be provided in accordance with the requirements of the Building Code of Australia.
- 7. Doorway openings with inward opening doors to room containing toilets which are closer than 1200mm to the toilet are to be fitted with hinges to allow the door to be removed from the outside when the door is closed.

- Construction Notes:
  \* R2.20 External Wall Insulation (Including Construction)
- \* R3.0 Ceiling Insulation
- \* Provide Foil & Sarking to Roof
- \* Control Joints to be checked in accordance with engineers plans
- \* Centre of kitchen Sink, Vanity, WC, Range Hood, to be confirmed with owner & Manufacturer Details.
- \* All windows, Insulation requirements, lighting to
- comply with Basix Certificate Approvde by council. Structural slab to engineer details.
- \* Metre Box, Gas Metre to be confirmed with Builder
- \* Downpipes to be confirmed with plumber on site.

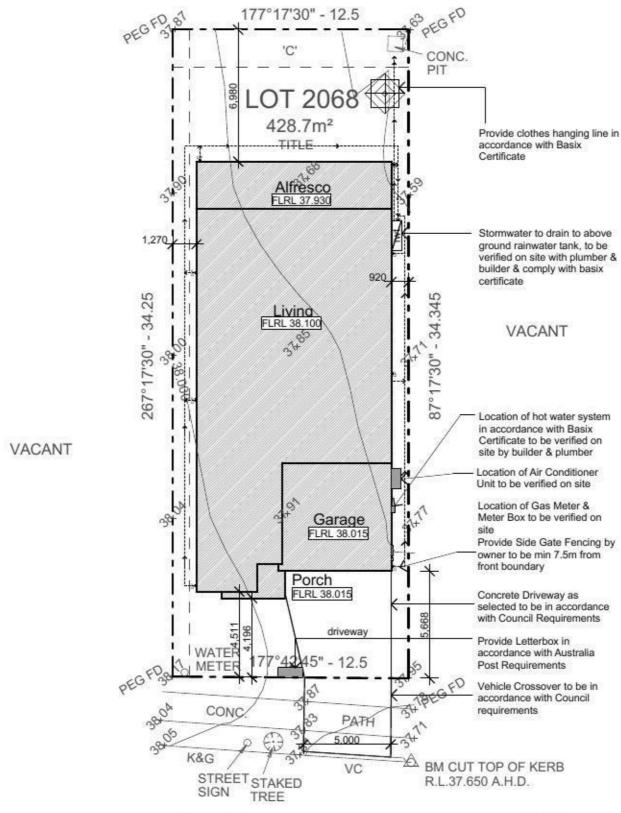



ALINTA **PROMENADE** 




Proposed Site Plan

Issue	Amendment	Date	#	North:	Proposed:	Drawing Title:	M84572446444	Revision:
A B	Preliminary Sketch Plans Preliminary Sketch Plans	25.10.13 28.11.13			New Single Storey Residence	Proposed S Concept Dra		B
			DESIGN & DRAFTING RESIDENTIAL DESIGN & DRAFTING SERVICES	(-Z-	Location: Lot 2068 Alinta Promenade,	L.G.A	370	Job No:
			Phone: (02) 9757 - 4002 Fax: (02) 9757 - 4003 Email: jr.design.drafling@gmail.com Address: 448 - 452 Victoria Street, Wetherill Park. NSW 2184		Jordan Springs. NSW	Drawn ID	Date 28.11.2013	
			Note: Builder shall check and verify all dimensions prior to the commencement of any work	Copyright: This plan is the exclusive property of JR Design & Draffing, and must not be used, reproduced or copied wholly or partly in any very without permission.	LB Homes	Scale 1:200	26.11.2013 Sheet 2 of 8	LD1329

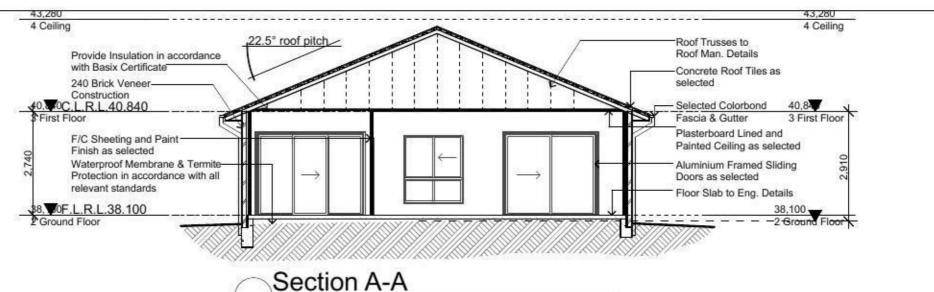

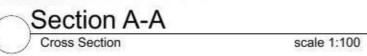

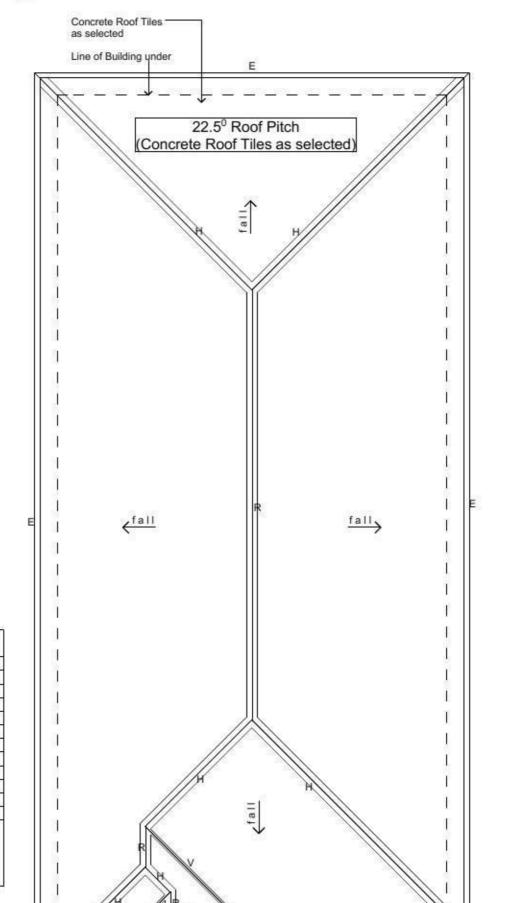

# Window Schedule

WINDOW NUMBER	WIDTH (mm)	HEIGHT (mm)	COMMENT
W1	610	1800	Aluminium Double Hung
W2	850	1800	Aluminium Double Hung
W3	2050	860	Aluminium Sliding
W4	610	860	Aluminium Sliding Obscure
W5	1570	600	Aluminium Sliding
W6	2410	2140	Aluminium Sliding Door
W7	1570	1800	Aluminium Sliding
W8	1810	600	Aluminium Sliding
W9	1810	600	Aluminium Sliding
W10	610	860	Aluminium Sliding Obscure
W11	1570	860	Aluminium Sliding Obscure
W12	1810	860	Aluminium Sliding


Note: \* All Windows are to Dowell Windows Spec. \*All Windows to be counted & checked Before Ordering


### LEGEND:

fall - DIRECTION OF FALL PROPOSED ROOF - EAVES LINE R - RIDGE Н - HIP - VALLEY


Roof Plan scale 1:100


Issu	e Amendment	Date	II.	North:	Proposed:	Drawing Title:	Revision:
A B	Preliminary Sketch Plans Preliminary Sketch Plans	25.10.13 28.11.13			New Single Storey Residence	ce First Floor Plan	B
8	4		DESIGN & DRAFTING RESIDENTIAL DESIGN & CHAPTING SERVICES	<b>←</b> Z-	Location:	L.G.A	
ŝ		8	Phone: (02) 9757 - 4002 Fax: (02) 9757 - 4003 Email: jr.design.drafting@gmail.com		Lot 2068 Alinta Promenade, Jordan Springs. NSW		Job No:
2	1	80	Address: 448 - 452 Victoria Street, Wetherill Park. NSW 2164		Client:	Drawn JR Date 28.11.2013	LB1329
8		3	Builder shall check and verify all dimensions prior to the commencement of any work	Copyright: This plan is the exclusive property of JR Design & Drafting, and must not be used, reproduced or copied wholly or party in any way without namelosism.	LB Homes	Scale 1:100 Sheet 4 of 8	

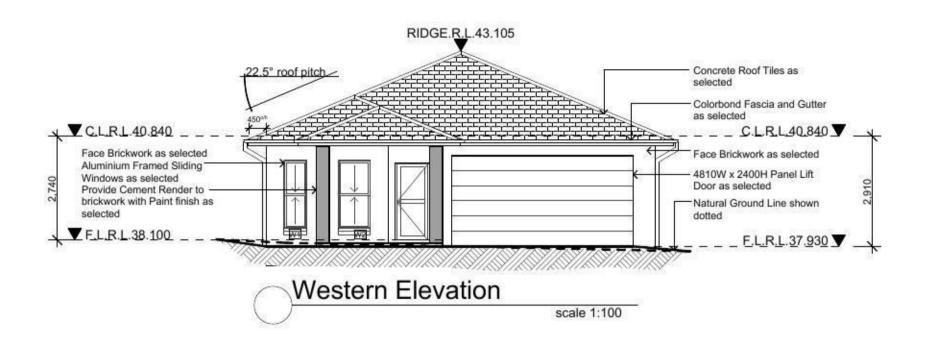

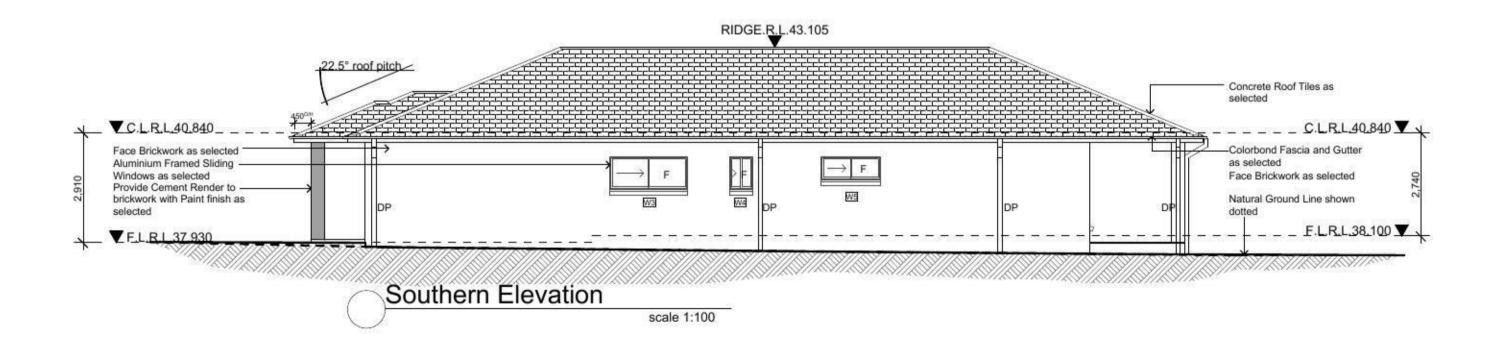


A Preliminary Sketch Plans  B Preliminary Sketch Plans	Date: 25.10.13 28.11.13		North:	General Notes  All work shall be carried out strictly in accordance with		Proposed:  New Single Storey Residence	Drawing Title: Southern Elevation Eastern Elevation	Revision:
		Phone: (02) 9757 - 4002 Fax: (02) 9757 - 4003 Email: jr.design.draftng@gmail.com Address: 448 - 452 Victoria Street. Wetherfil Park, NSW 2164		& to the satisfaction of the regulatory authority.  All levels, dimensions & areas are to be verified by the Builder, prior to the preparation of contracts & the commencement of any building works.  Any discrepancies are to be brought to the attention of JR Design & Drafting, prior to the commencement of any building works.	Levels shown are approximate unless accompanied by reduced levels or Australian Height Datum Levels. Figured dimensions to be taken in preference to scaling. All Boundary clearances must be verified by Survey. Stormwater to be disharged to Councils requirements before any work commences. All services to be located & verified by the Builder with relevant Authorities before any work commences.	Location:  Lot 2068 Alinta Promenade,  Jordan Springs. NSW  Client:	L.G.A	Job No:
	1 1 1 1 1 1 1 1 1 1 1 1 1 1 1 1 1 1 1	Note: Builder shall check and verify all dimensions prior to the commencement of any work	to the commencement			LB Homes	Scale 1:100 Sheet 5 of 8	LB1329

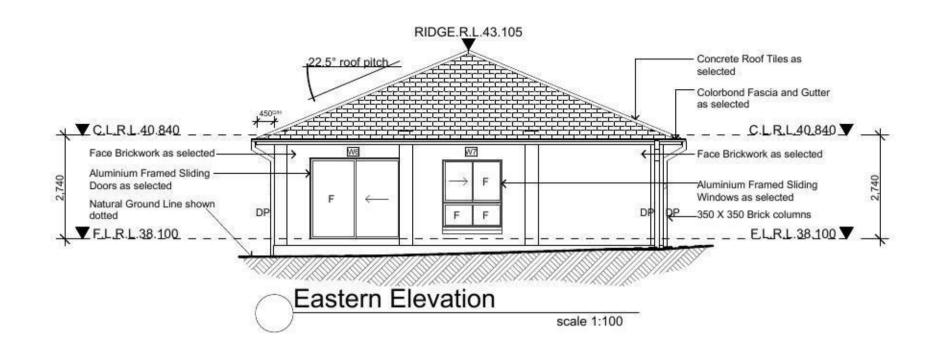


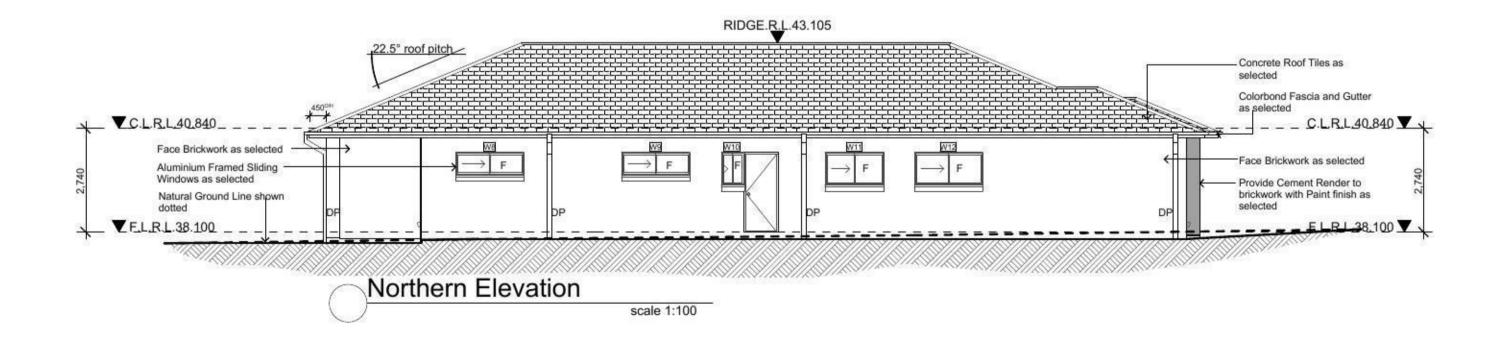



Issue Amendment A Preliminary Sketch Plans	Date: 25.10.13		North:	General Notes  All work shall be carried out strictly in accordance with	Where Engineering Detail Plans are required, such must take preference to this drawing.	Proposed:	Drawing Title: Southern Elevation	Revision:
B Preliminary Sketch Plans	28.11.13	DESIGN & DRAFTING RESIDENTIAL DESIGN & GRAPTING SERVICES Phone: (02) 9757 - 4002 Fax: (02) 9757 - 4003	}			New Single Storey Residence Location: Lot 2068 Alinta Promenade, Jordan Springs. NSW	Eastern Elevation	Job No:
		Email: jr.design.drafting@gmail.com Address: 448 - 452 Victoria Street, Wetherill Park. NSW 2164 Note: Builder shall check and verify all dimensions prior to the commencement of any work		& the commencement of any building works.  Any discrepancies are to be brought to the attention of JR Design & Drafting, prior to the commencement of any building works.	Stormwater to be disharged to Councils requirements before any work commences. All services to be located & verified by the Builder with relevant Authorities before any work commences.	Client:	Drawn JR Date 28.11.2 Scale 1:100 Sheet 6 of	LB1329

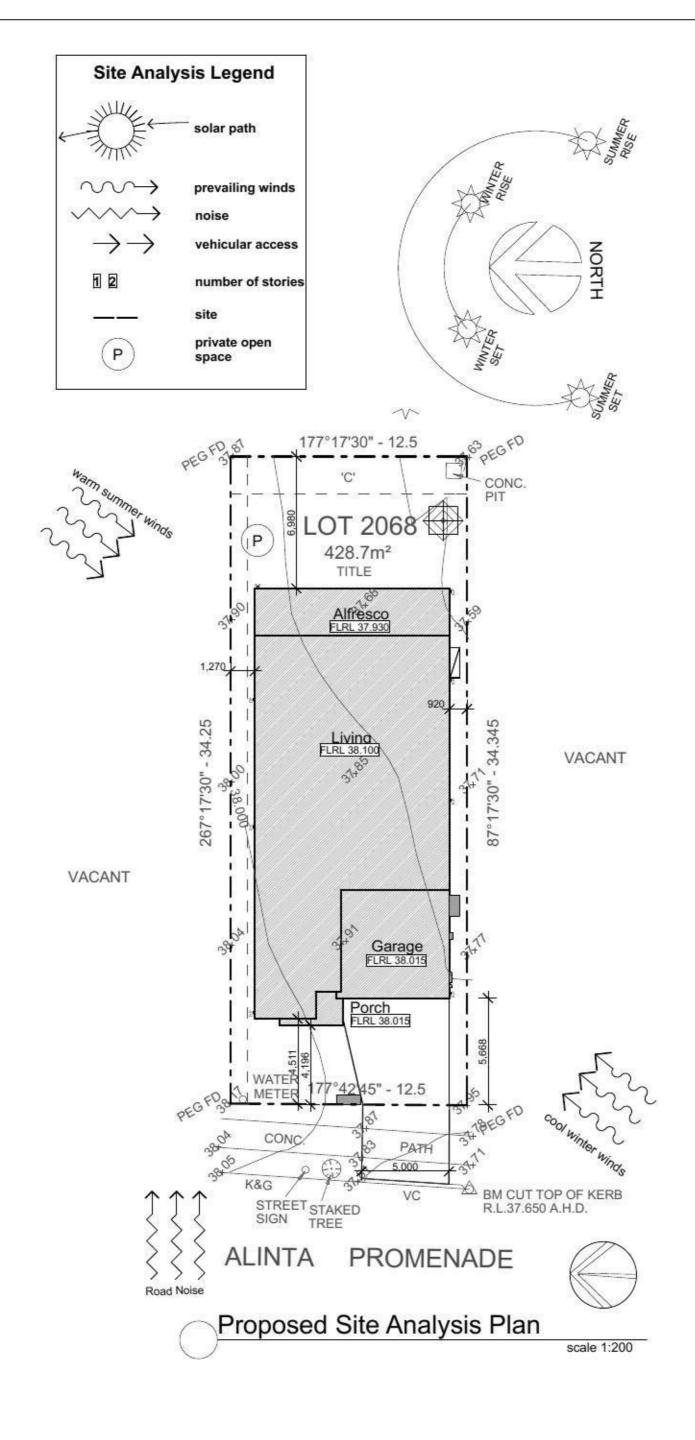


Issu	Amendment	Date	<b>I</b>	North:	Proposed:	Drawing Title:		Revision:
A B	Preliminary Sketch Plans Preliminary Sketch Plans	25.10.13 28.11.13			New Single Storey Residence	Site Analys	sis Plan	B
	Ca.	2 7	DESIGN & DRAFTING RESIDENTIAL DESIGN & DRAFTING SERVICES	(-Z-	Location: Lot 2068 Alinta Promenade,	L.G.A		
		- 5	Phone: (02) 9757 - 4002 Fax: (02) 9757 - 4003 Email: jr.design.drafting@gmail.com		Jordan Springs. NSW		200000	Job No:
	18	8	Address: 448 - 452 Victoria Street, Wetherill Park. NSW 2164	Countrit	Client:	Drawn JR	Date 28.11.2013	LB1329
	8		Builder shall check and verify all dimensions prior to the commencement of any work	This plan is the exclusive property of JR Design & Drafting, and must not be used, reproduced or copied whole or cards in any way without permission.	LB Homes	Scale 1:200	Sheet 7 of 8	

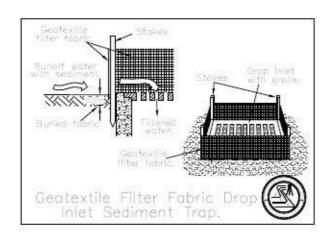

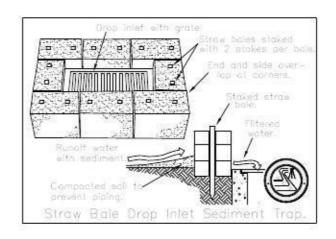

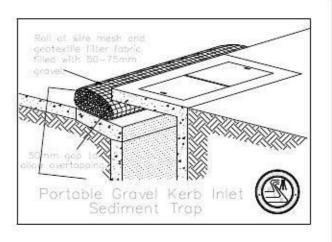


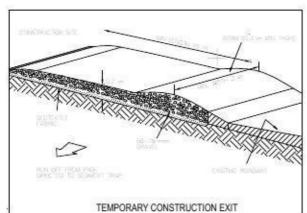


### **Erosion Control**

Temporary sediment and erosion control and measures are to be installed prior to commencement of any worls on the site. these measures must be maintained in working order during construction works up to completion. All sediment traps must be cleared on a regular basis and after major storm and/or as directed by the Principal Certifying Authority and Council officers.

PROOF OF EXISTENCE OF ALL SERVICES IS THE CONTRACTOR'S RESPONSIBILITY. CURRENT "DIAL BEFORE YOU DIG" SERIVCES PLANS MUST BE OBTAINED PRIOR TO COMMENCING ANY EXCAVATION.

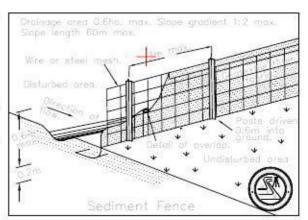



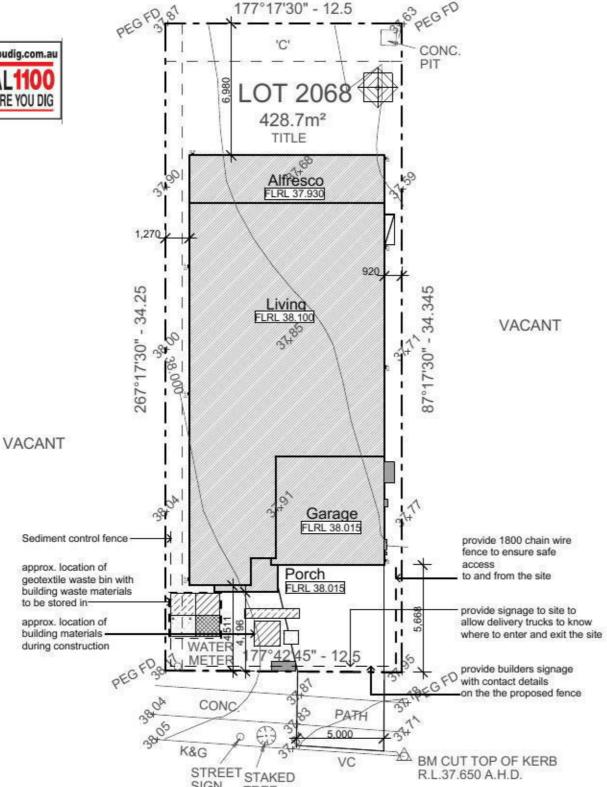

**ALINTA PROMENADE** 

TREE



### Sedimentation & Waste Management Plan scale 1:200

SIGN

Date Proposed: Issue Amendment North: Soil Sedimentation & Preliminary Sketch Plans 25.10.13 New Single Storey Residence Waste Management В Preliminary Sketch Plans 28.11.13 DESIGN & DRAFTING Lot 2068 Alinta Promenade, ne: (02) 9757 - 4002 Fax: (02) 9757 - 4003 Job No: Jordan Springs, NSW Date 28.11.2013 LB1329 Sheet 8 of 8 Scale LB Homes

NOTES: USE FIGURED DIMENSIONS ONLY, DO NOT SCALE.

CHECK ALL DIMENSIONS PRIOR STARTING ANY WORK REPORT ANY DISCREPANCIES FINISHED GROUND LEVELS SHOWN ON PLAN ARE SUBJECT TO SITE CONDITIONS ALL CALCULATED DIMENSIONS ARE SUBJECT TO SITE MEASURE DURING CONSTRUCTION

NO ALLOWANCE HAS BEN MADE FOR SHRINKAGE OR MILLING POSITION OF ELECTRICAL METER TO BE DETERMINED ON SITE


PROOF OF EXISTENCE OF ALL SERVICES IS THE CONTRACTOR'S RESPONSIBILITY. CURRENT "DIAL BEFORE YOU DIG" SERIVCES PLANS MUST BE OBTAINED PRIOR TO COMMENCING ANY EXCAVATION.



AREAS:			
Site Plan:	428.70m <sup>2</sup>		
Living Area:	167.86m <sup>2</sup>		
Porch:	3.12m <sup>2</sup>		
Alfresco:	25.78m <sup>2</sup>		
Garage:	33.09m <sup>2</sup>		
TOTAL:	229.85m²		
Courtyard:			
Required:	64.30m <sup>2</sup>		
Proposed:	119.40m <sup>2</sup>		
Provide 6 x 4 Dim:	Yes		

- 1. All work to be carried out in accoradnce with the requirements of the Building Code of Australia and the relevant local authority. 2. All timber framing to be carried out to the requirements of Australian Standards (as 1684) as a minimum.
- 3. All reinforced concrete, steel beams including supports, and nominated beams including supports to Engineer's details.
- 4. Sturctural Engineer to check, detail and certify brickwork to garage area with a height greater than 3000mm between horizontal supports. 5. All brickwork to be constructed in accordance with the requirements of the Building Code of Australia.
- 6. Control joints in brickwork to be provided in accordance with the requirements of the Building Code of Australia.
- 7. Doorway openings with inward opening doors to room containing toilets which are closer than 1200mm to the toilet are to be fitted with hinges to allow the door to be removed from the outside when the door is closed.

- Construction Notes:
  \* R2.20 External Wall Insulation (Including Construction)
- \* R3.0 Ceiling Insulation
- \* Provide Foil & Sarking to Roof
- \* Control Joints to be checked in accordance with engineers plans
- \* Centre of kitchen Sink, Vanity, WC, Range Hood, to be confirmed with owner & Manufacturer Details.
- \* All windows, Insulation requirements, lighting to
- comply with Basix Certificate Approvde by council. Structural slab to engineer details.
- \* Metre Box, Gas Metre to be confirmed with Builder
- \* Downpipes to be confirmed with plumber on site.

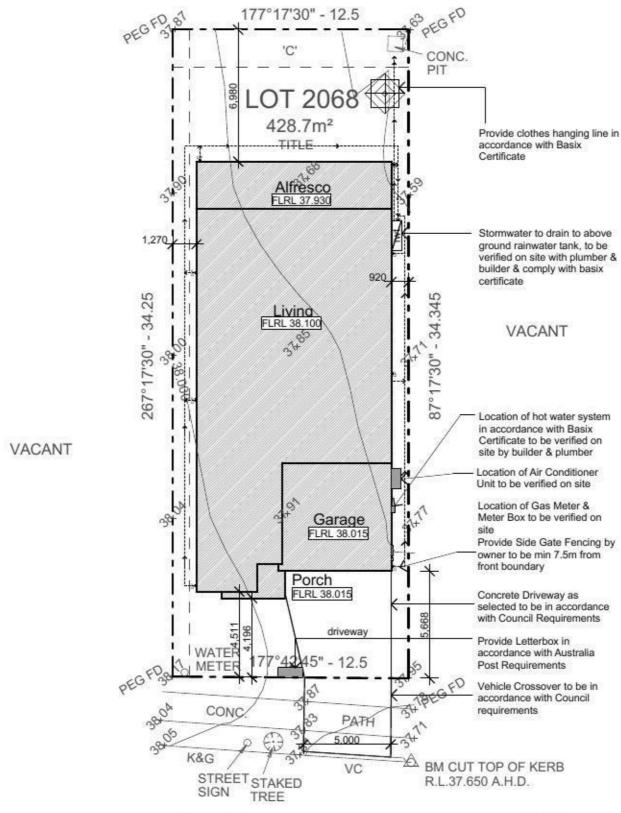



ALINTA **PROMENADE** 




Proposed Site Plan


Issue	Amendment	Date	#	North:	Proposed:	Drawing Title:	M84572446444	Revision:
	Preliminary Sketch Plans Preliminary Sketch Plans	25.10.13 28.11.13			New Single Storey Residence	Proposed S Concept Dra		B
	(4)	RESIDENTIA	DESIGN & DRAFTING  REBIDENTIAL DEBIGN & DAFFTINE SERVICES  Phone: (02) 9757 - 4002 Fax: (02) 9757 - 4003	(-2-	Location: Lot 2068 Alinta Promenade,	L.G.A		Job No:
			Email: jr.design.drafting@gmail.com Address: 448 - 452 Victoria Street, Wetherill Park. NSW 2164		Jordan Springs, NSW Client:	Drawn ID	Date 28.11.2013	
			Note: Builder shall check and verify all dimensions prior to the commencement of arty work	Copyright: This plan is the exclusive property of JR Design & Draffing, and must not be used, reproduced or copied wholly or partly in any very without permission.	LB Homes	Scale 1:200	26.11.2013 Sheet 2 of 8	LD1329

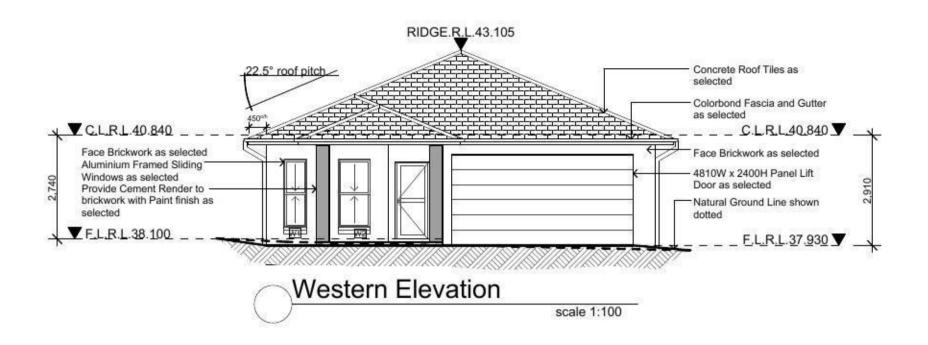

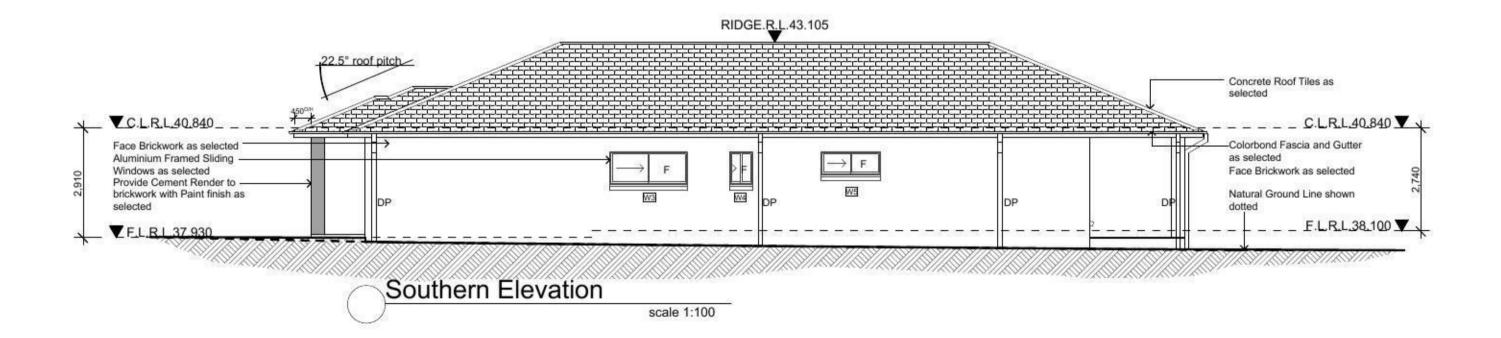


Issue Amendment	Date:	Ĭ	North:	General Notes	This is the come about the combined to be a combined the street and a company to come of	Proposed:	Drawing Title:	Revision:
Preliminary Sketch Plans Preliminary Sketch Plans	25.10.13 28.11.13			All work shall be carried out strictly in accordance with The Building Code Of Australia, relevant S.A.A. codes		New Single Storey Residence	Southern Elevation Eastern Elevation	B
To the information and advantage and the factor of	10 (0.00 (0.	Phone: (02) 9757 - 4002 Fax: (02) 9757 - 4003 Email: jr.design.draffing@gmail.com		& to the satisfaction of the regulatory authority.  All levels, dimensions & areas are to be verified by the Builder, prior to the preparation of contracts & the commencement of any building works.	reduced levels or Australian Height Datum Levels. Figured dimensions to be taken in preference to scaling. All Boundary clearances must be verified by Survey. Stommater to be disharged to Councils requirements	Location: Lot 2068 Alinta Promenade, Jordan Springs. NSW	L.G.A	Job No:
1	Address: 448 - 452 Victoria Street, Wetherill Park. NSW 2164  Note:  Builder shall check and verify all dimensions prior to the commencement of any work.		Any discrepancies are to be brought to the attention of JR Design & Drafting, prior to the commencement of any building works.	before any work commences.  All services to be located & verified by the Builder with relevant Authorities before any work commences.	LB Homes	Drawn JR Date 28.11.2 Scale 1:100 Sheet 5 of	LB132	

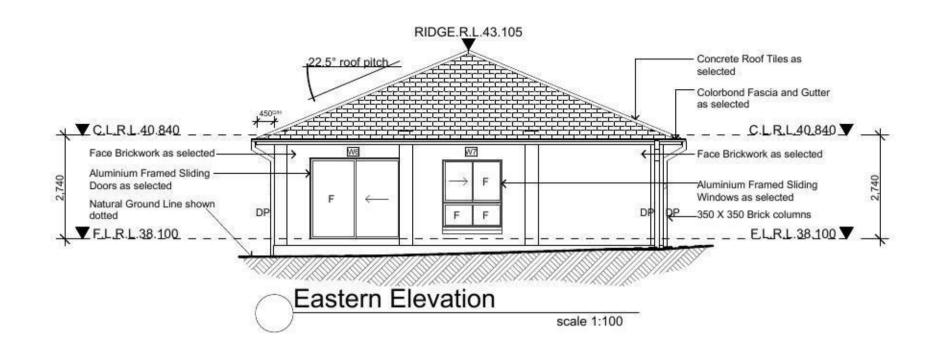

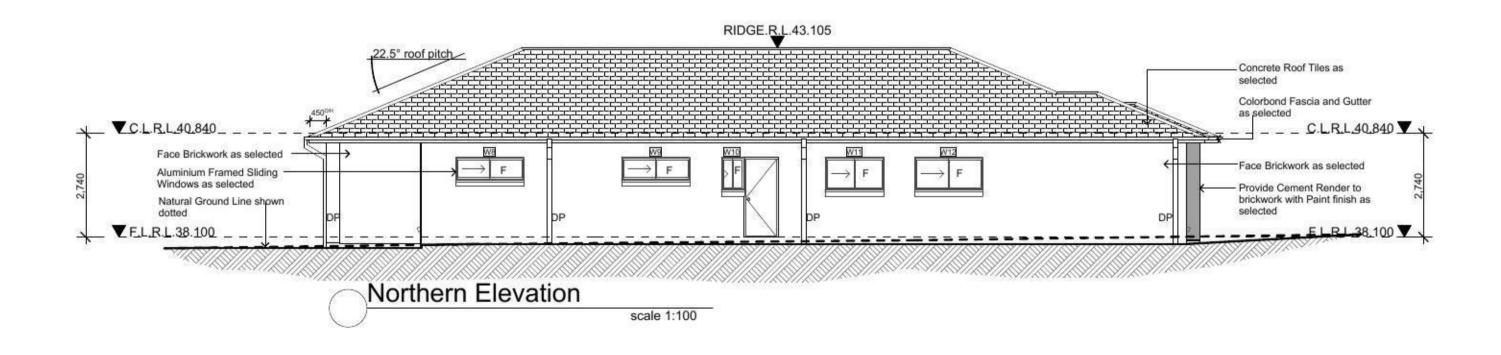

Issue Amendment A Preliminary Sketch Plans	Date: 25.10.13		North:	General Notes  All work shall be carried out strictly in accordance with	Where Engineering Detail Plans are required, such must take preference to this drawing.	Proposed:	Drawing Title: Southern Elevation	Revision:
B Preliminary Sketch Plans	28.11.13	DESIGN & DRAFTING RESIDENTIAL DESIGN & GRAPTING SERVICES Phone: (02) 9757 - 4002 Fax: (02) 9757 - 4003	The Building Code Of Austra & to the satisfaction of the re All levels, dimensions & area by the Builder, prior to the pr & the commencement of any Any discrepancies are to be of JR Design & Drafting, pric			New Single Storey Residence Location: Lot 2068 Alinta Promenade, Jordan Springs. NSW	Eastern Elevation	Job No:
		Email: jr.design.drafting@gmail.com  Address: 448 - 452 Victoria Street, Wetherill Park. NSW 2164  Note:  Builder shall check and verify all dimensions prior to the commencement of any work		& the commencement of any building works.  Any discrepancies are to be brought to the attention	Stormwater to be disharged to Councils requirements before any work commences. All services to be located & verified by the Builder with relevant Authorities before any work commences.	Client:  LB Homes	Drawn JR Date 28.11.2 Scale 1:100 Sheet 6 of	LB1329

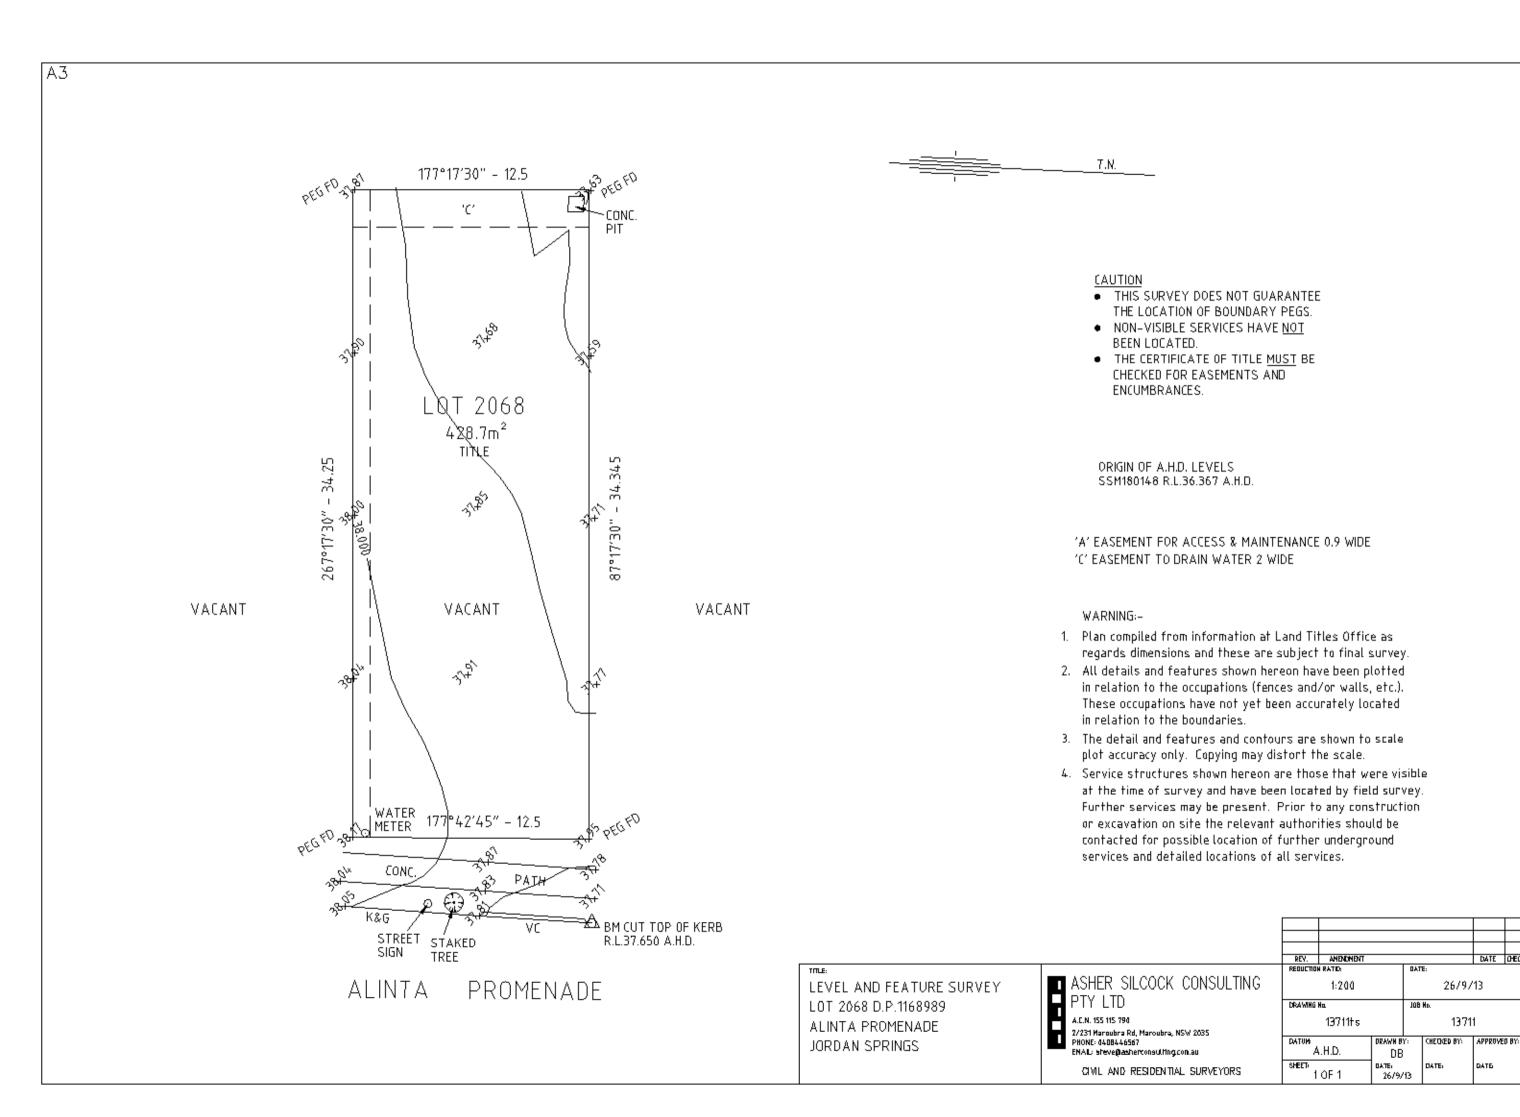

DATE CHEC

DATE

26/9/13