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Notes

С	amend driveway & dwelling location	bL	aug,21
В	for DA	bL	apr,21
Α	issue to consultants	bL	apr,21 jan,21
issue	details	by	date
amendments			

location
Lot 1 D.P.1221353, 14 Mt Vernon Road

MOUNT VERNON


client
T.Benjamin & G.Lozelle

drawing title
Site Plan

Proposed Residence

date 21.01.21	checked	project arch.	drawn _{bL}
scale as shown	no 2025	4 01	issue C



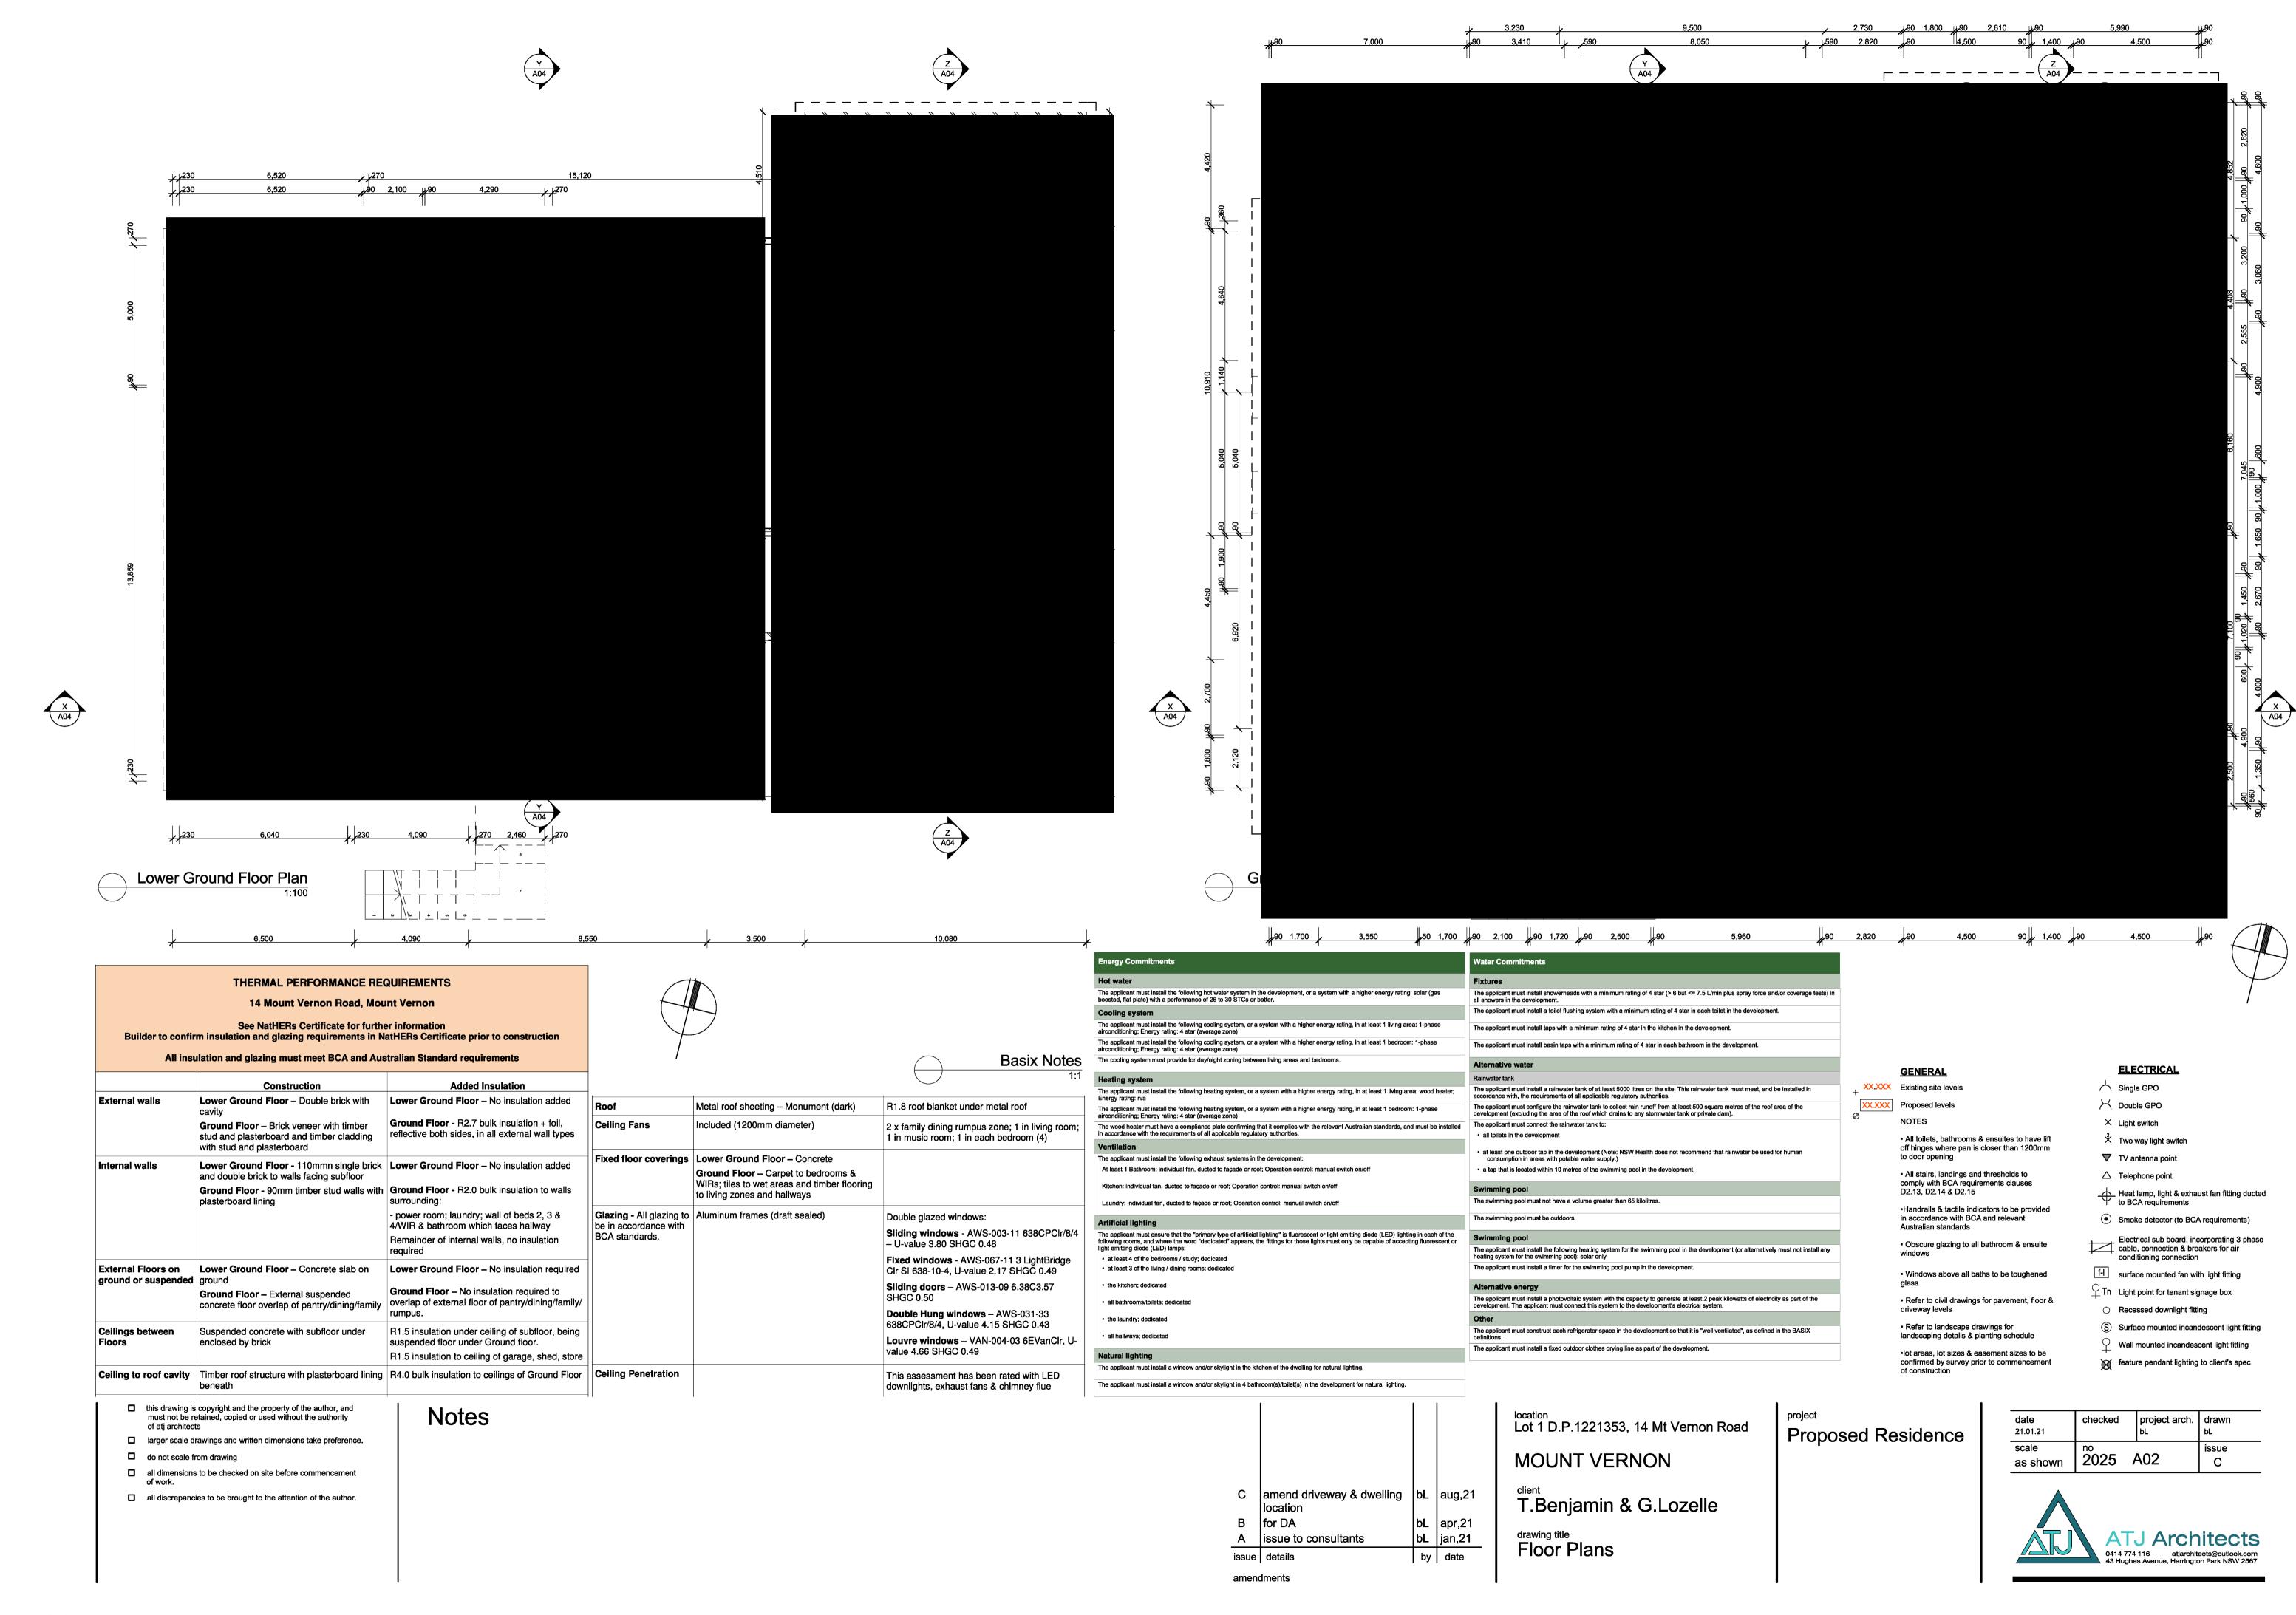





3.1 Façade Glazing Requirements

Acoustic glazing for the apartments are given in Table 3 are required to reduce noise impact on the internal occupants and should result in noise levels within such units in accordance with the Penrith DCP and the Australian Standards for aircraft noise intrusion.

Table 3 – Schedule of Window and Glazing (Rw)

Space	Glazing Thickness	Minimum R _w (Glazing+Frame)
Kitchen/Living/Dining/Family	6.38mm laminated	30
Music	6.38mm laminated	30
Bed 1, 2 3 & Bed 4	10.38mm laminated	32

All Windows/doors should be well sealed (air tight) when closed with good acoustic seals around the top and bottom sliders. Mohair seals are not considered to be acoustic seals.



Acoustic Requirements

3.2 Building Façade Construction

To provide sufficient acoustic attention of noise, the general external construction of the proposed building would need to be constructed as detailed in Table 4.

Table 4 – External Façade Construction (Rw)

Proposed Construction	Minimum R _w
External brick veneer.	
Internal 1x13mm plasterboard lining on 90mm timber stud.	50
Cavity filled with 75mm thick acoustic insulation.	
Tiled or metal/Colorbond roof on timber frame.	
Internal 1x13mm fire-rated plasterboard ceiling.	45
Cavity filled with 75mm thick acoustic insulation	
35mm solid core door.	
Acoustic perimeter seals (such Raven RP10) and drop seals (such as Raven RP38) for the bottom of the door with a compatible threshold plate.	30
	External brick veneer. Internal 1x13mm plasterboard lining on 90mm timber stud. Cavity filled with 75mm thick acoustic insulation. Tiled or metal/Colorbond roof on timber frame. Internal 1x13mm fire-rated plasterboard ceiling. Cavity filled with 75mm thick acoustic insulation 35mm solid core door. Acoustic perimeter seals (such Raven RP10) and drop seals (such as Raven RP38) for the bottom of the door

C amend driveway & dwelling bL aug,21 location bL apr,21 B for DA bL jan,21 A issue to consultants issue details by date amendments

location Lot 1 D.P.1221353, 14 Mt Vernon Road **MOUNT VERNON** T.Benjamin & G.Lozelle drawing title Elevations & Window

Schedule

Proposed Residence

Aluminium Door List

checked project arch. 21.01.21 scale no 2025 A03 as shown




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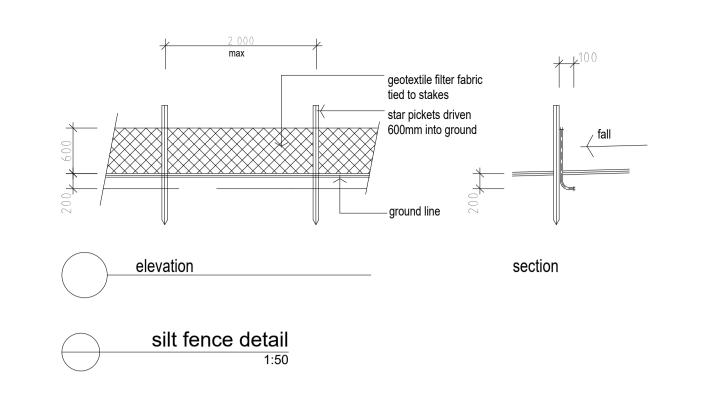
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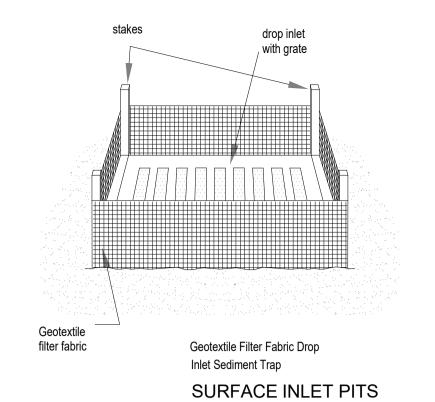
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Notes









detail 1- sediment fence.

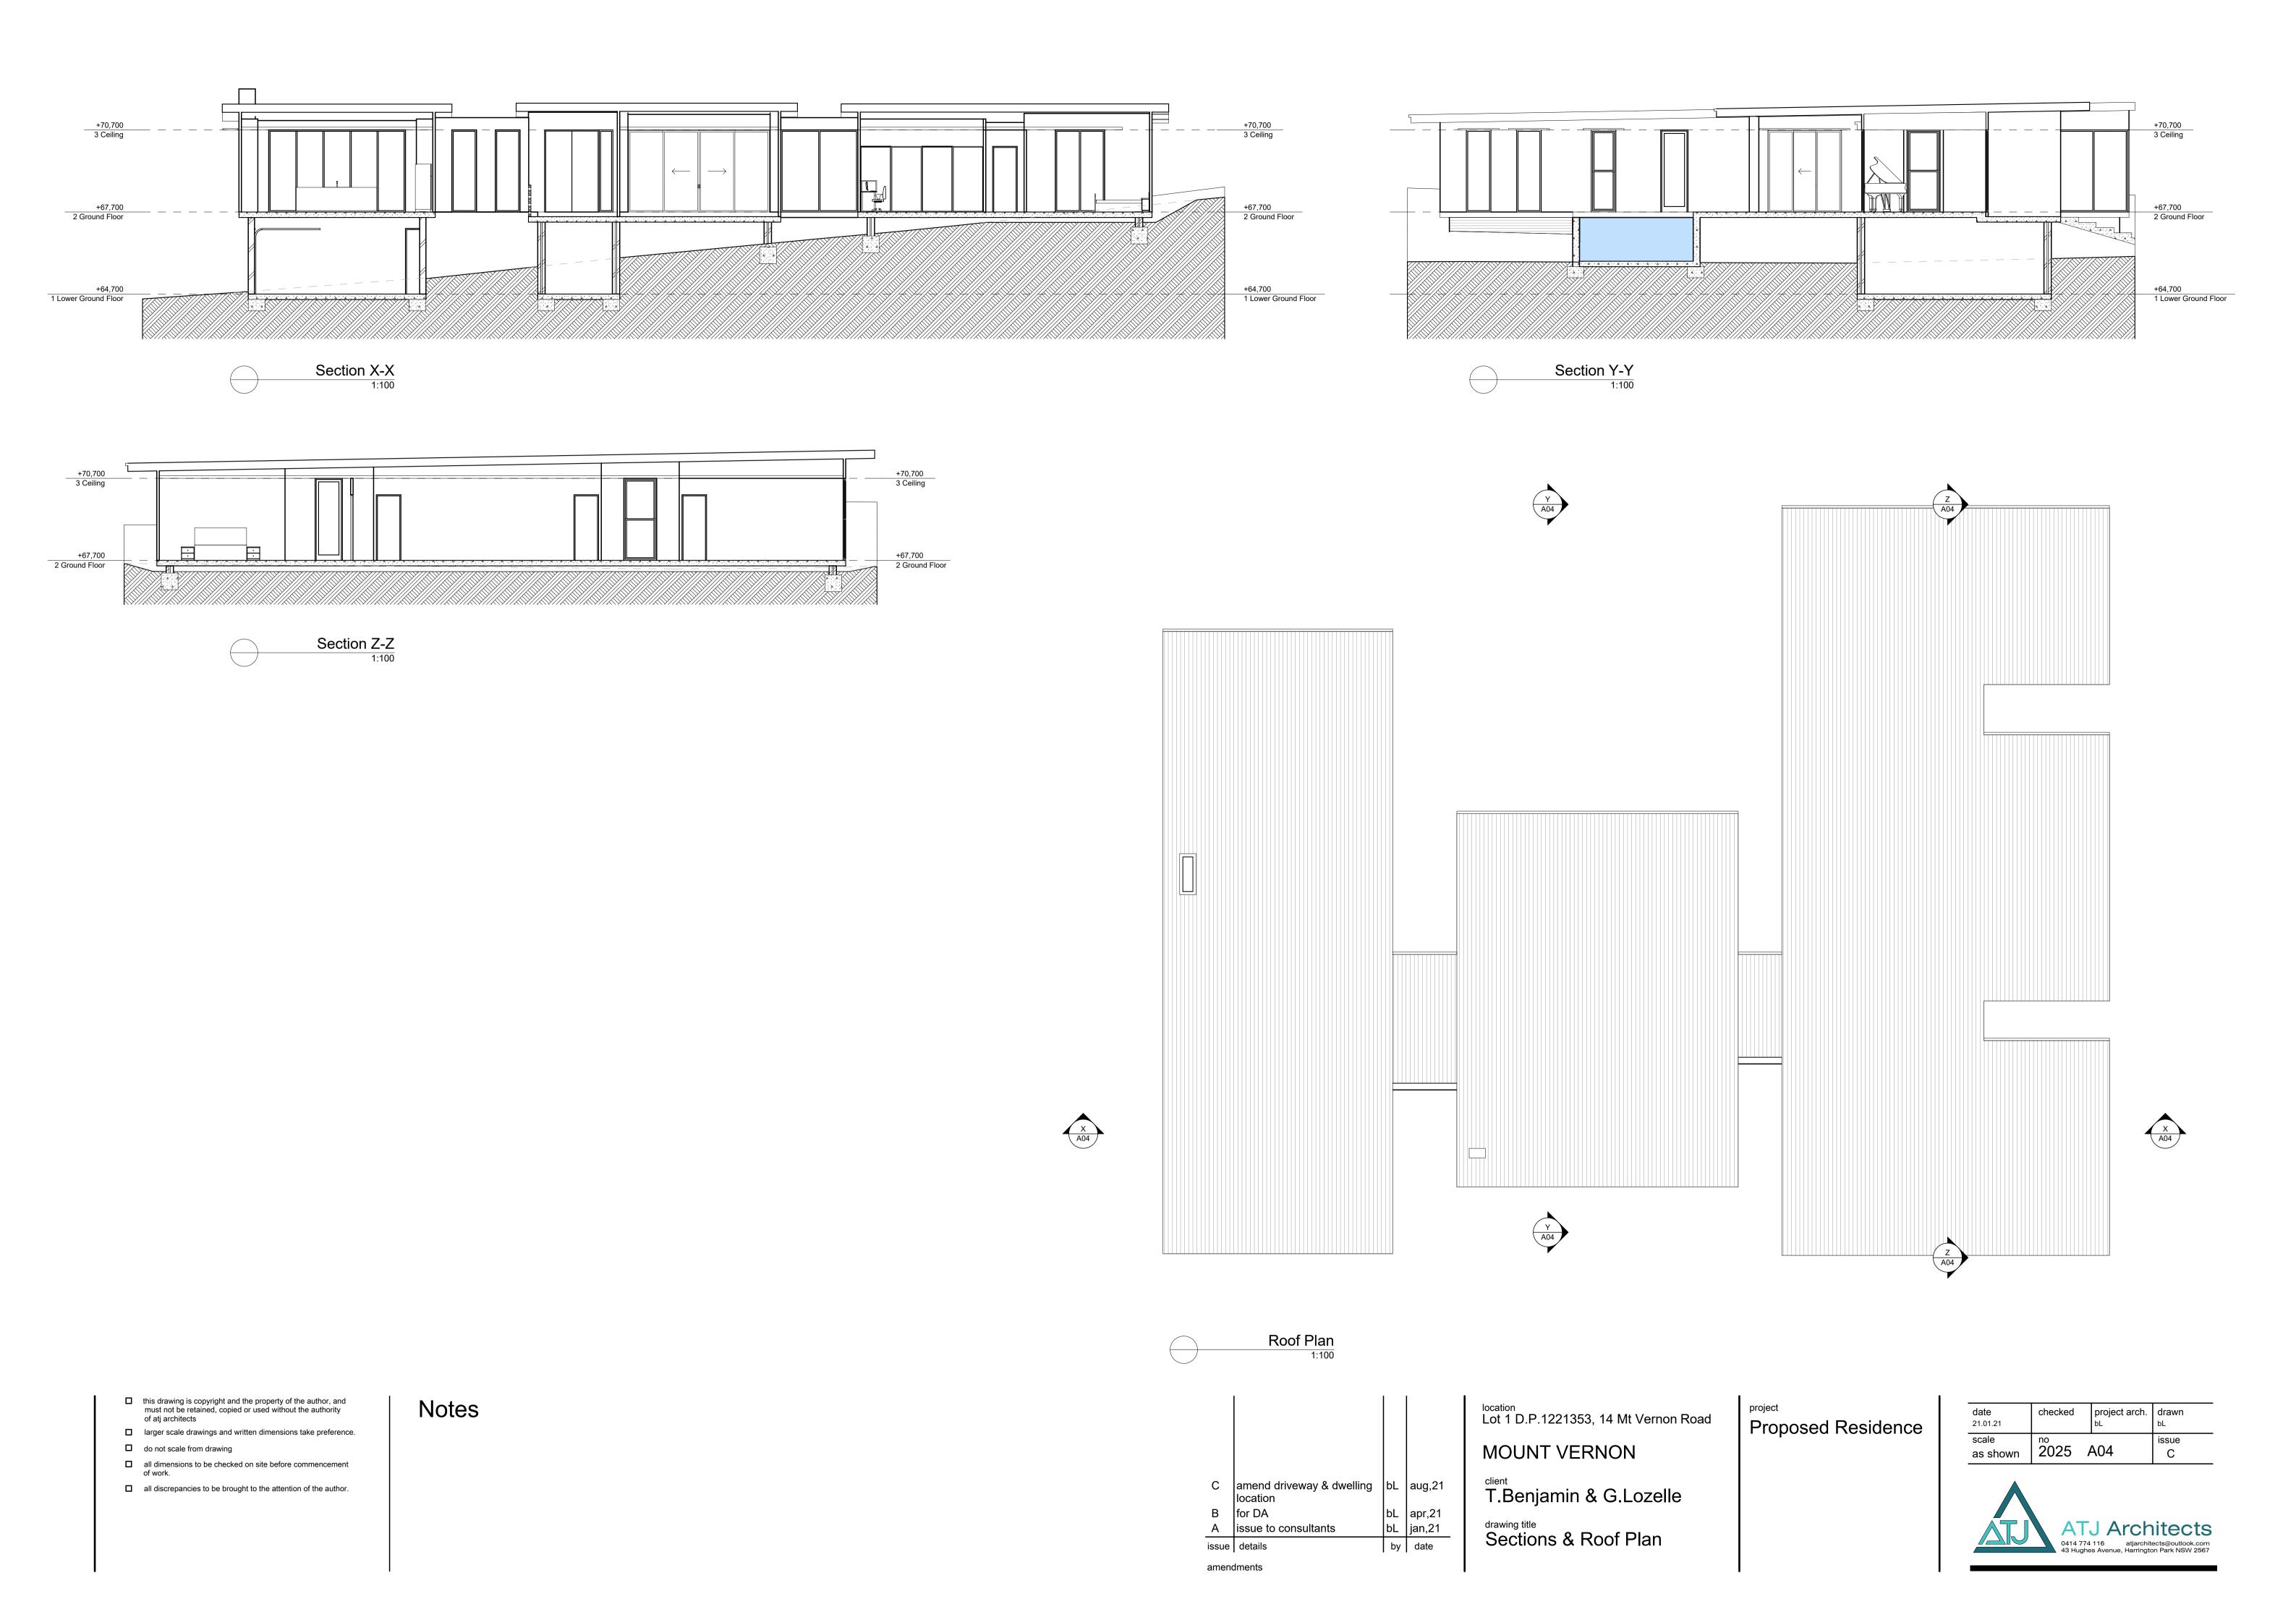Extracts from "managing Urban Stormwater- Soils and Construction' August 1988 produced by the Department of Housing

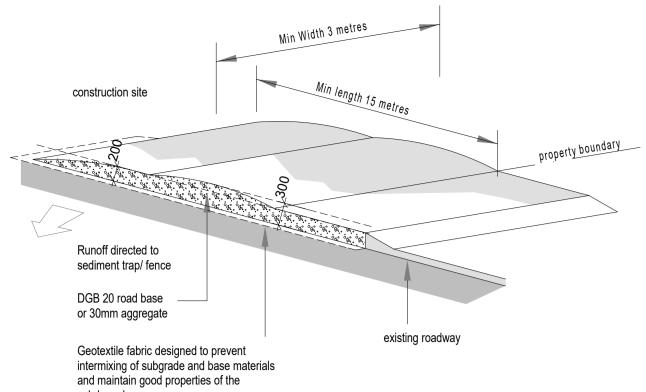

sub-base layers.

Geotextile may be a woven ot needle punched product with a minimum CBR burst strength detail 2- stabilised site access. (AS 3706.4-90) of 2500N

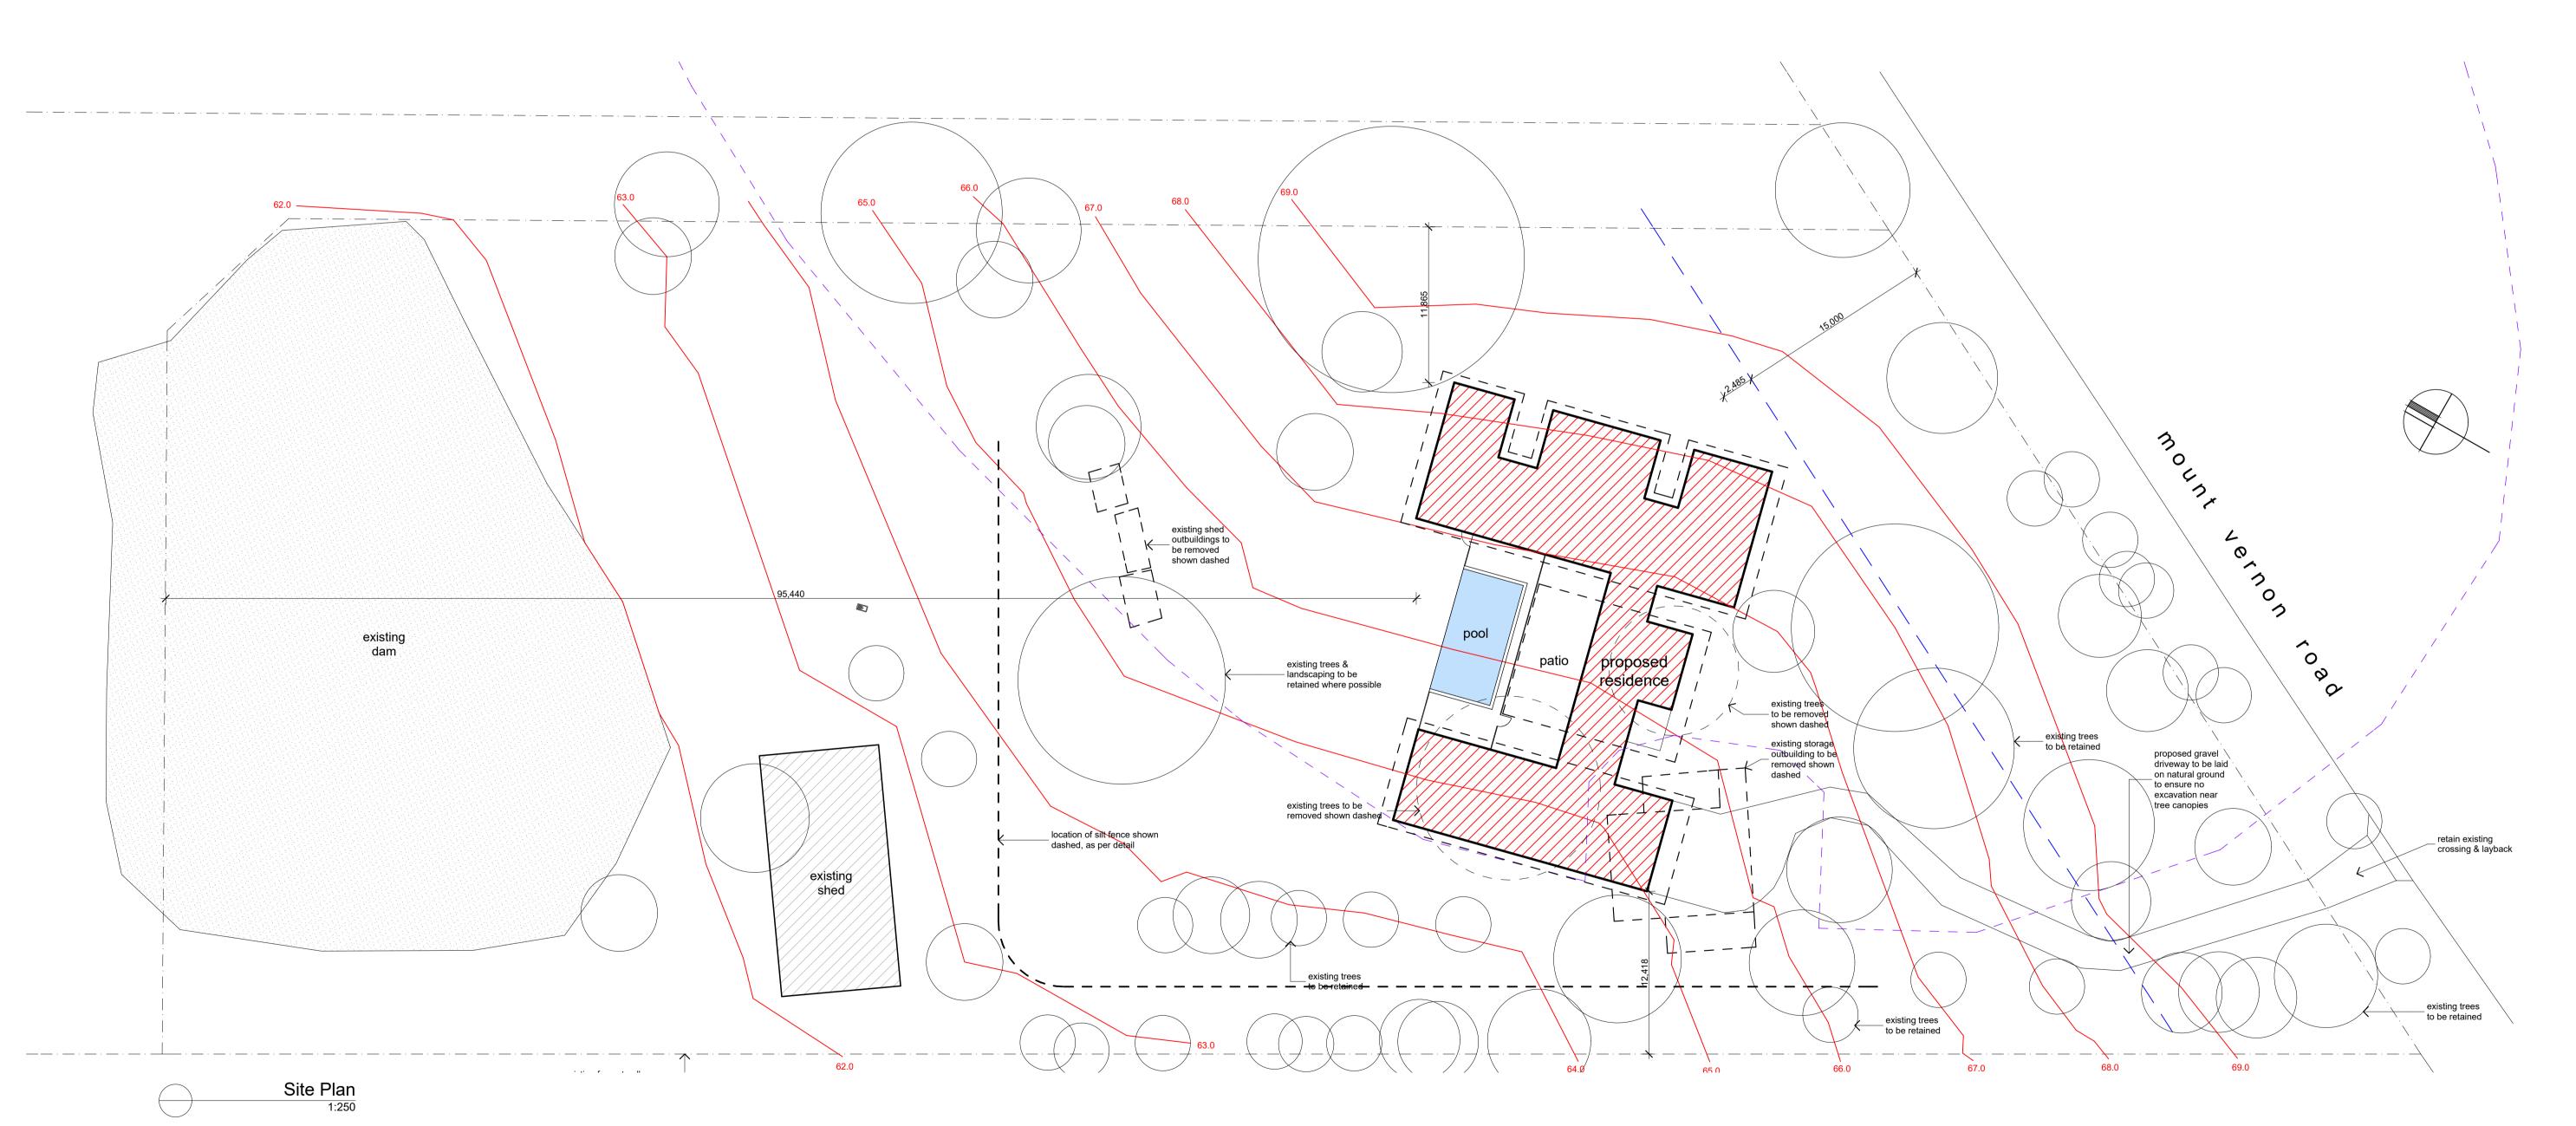

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location Lot 1 D.P.1221353, 14 Mt Vernon Road **MOUNT VERNON**

T.Benjamin & G.Lozelle drawing title
Erosion & Sediment Control Proposed Residence

21.01.21 scale	no	project arch.	bL
as shown	2025	A05	C



NOTES

GENERAL:

- * ALL LEVELS ARE TO A.H.D. * EXISTING LEVELS BASED ON SURVEY BY
- CHADWICK CHENG SURVEYORS DATE: 12/01/21 * ALL WORK TO COMPLY WITH AS 3500.3 & OTHER RELEVANT AUS STANDARDS &
- REQUIREMENTS OF COUNCIL. * ALL STORMWATER PIPES TO BE UPVC
- LAID WITH 1.0% FALL U.N.O. * ALL DOWNPIPES CONNECTED TO STORMWATER SYSTEM TYPICAL (APPROXIMATE POSITIONS SHOWN).
- * THE STORMWATER SYSTEM IS DESIGNED TO COMPLY WITH COUNCIL'S DESIGN CRITERIA.

 * THE STORMWATER SYSTEM HAS BEEN DESIGNED TO APPROXIMATELY MAINTAIN
- EXISTING FLOW PATTERNS.

RAINWATER COLLECTION:

- * TO BE CONNECTED TO ALL TOILETS, ONE TAP WITHIN 10m OF THE SWIMMING POOL & AT LEAST ONE OUTDOOR TAP
- AS REQUIRED BY BASIX. * OVERFLOW FROM RAINWATER TANK DIRECTED
- TO STORMWATER SYSTEM. * RAINWATER TANKS COLLECT 150sq.m. OF ROOF AREA PER LOT. STORMWATER QUALITY:
- * STORMWATER TREATMENT MEASURES ARE NOT REQUIRED BY COUNCIL

EXISTING STORMWATER PIPES. PROPOSED STORMWATER PIPES. IN GROUND 1500 uPVC U.N.O. PROPOSED CHARGED STORMWATER PIPES. PROPOSED STORMWATER PIPES. AERIAL 150¢ uPVC U.N.O. AGRICULTURAL SUB SOIL LINE - - - INSPECTION OPENING DIRECTION OF FALL

EXISTING STORMWATER PIT


<u>KEY</u>

PROPOSED GRATED DRAIN COMPLETE WITH SELECTED PAVED/TILED AREAS LOCKDOWN GRATE - 61.80 PROPOSED SURFACE LEVEL OVERLAND FLOW PATH INVERT LEVEL BALCONY FLOOR WASTE → 61.17 EXISTING SURFACE LEVEL PBW PLANTER BOX FLOOR WASTE --- 59.5 --- EXISTING CONTOUR DOWNPIPE 100¢ U.N.O. FINISHED FLOOR LEFEL DESIGNATED 0.S.D AREA.

DOWNPIPE WITH SPITTER

HORIZONTAL DOWNPIPE EAVES GUTTER EXISTING EAVES GUTTER ΒG BOX GUTTER

RWH & DP RAINWATER HEAD & DOWNPIPE

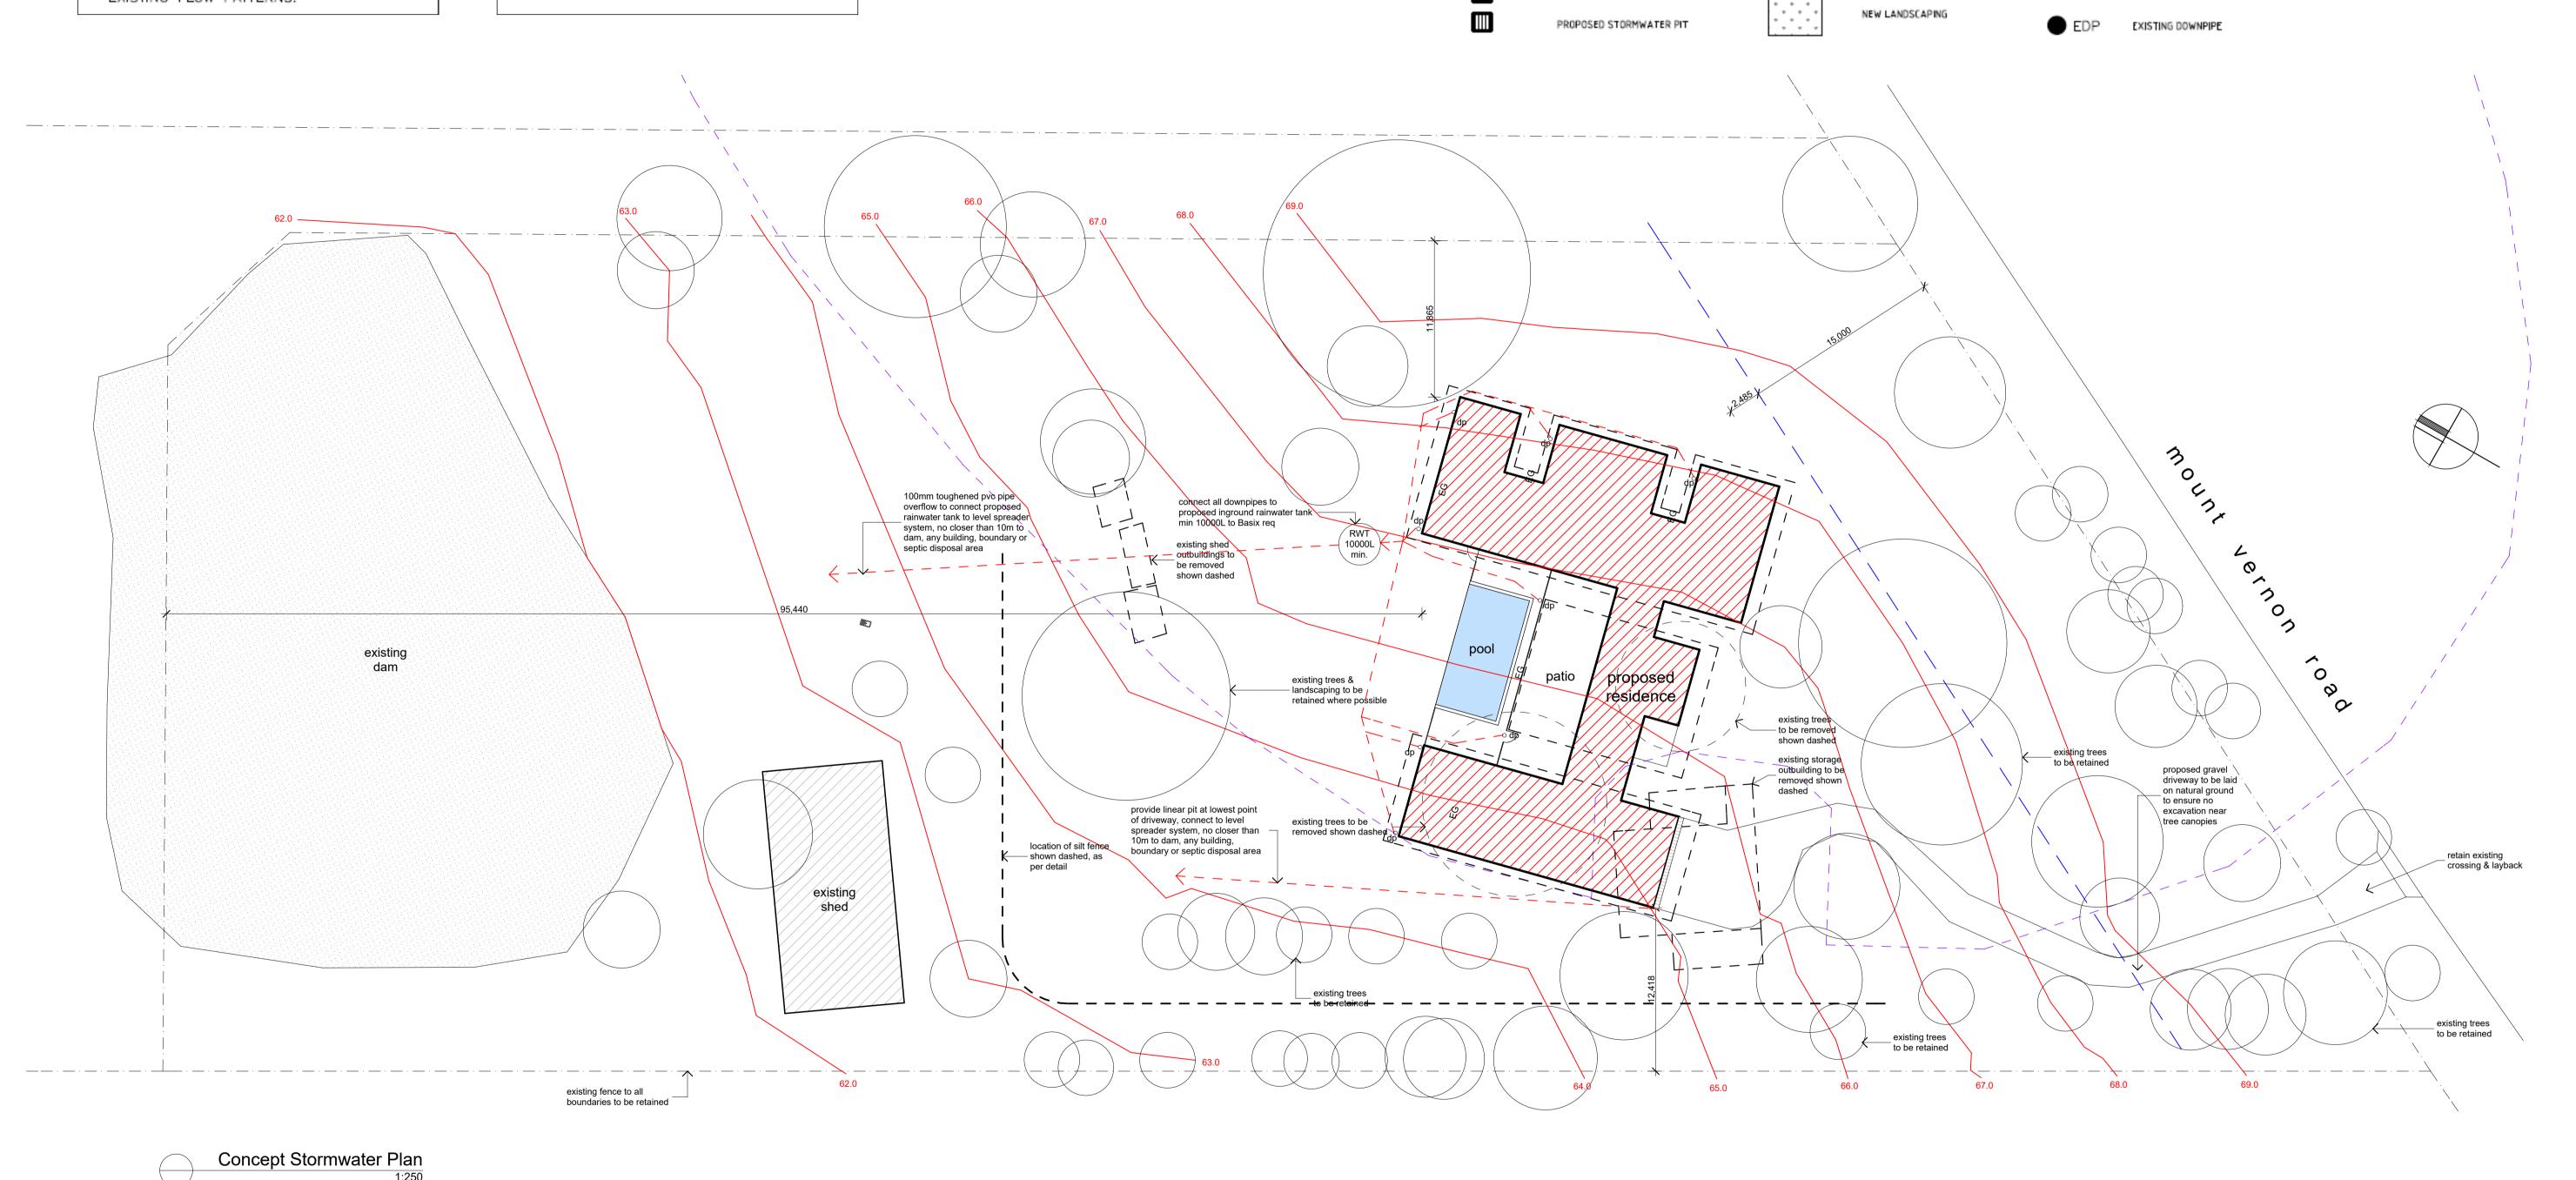

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amendments

location Lot 1 D.P.1221353, 14 Mt Vernon Road **MOUNT VERNON** T.Benjamin & G.Lozelle

Stormwater Concept Plan

Proposed Residence

checked project arch. 21.01.21 scale 2025 A06 as shown

