



# PROPOSED RESIDENTIAL DEVELOPMENT

## 71 ALBERT STREET, WERRINGTON

### STORMWATER CONCEPT DESIGN



LOCALITY PLAN  
NOT TO SCALE  
COPYRIGHT OF SIXMAP, VERSION



#### PREPARED BY:

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#### ARCHITECT:





#### CLIENT:

CAZ BUILD

DRAWINGS LIST			
SHEET No.	DWG No.	TITLE	REV
1	SW100	COVER SHEET	A
2	SW200	STORMWATER CONCEPT DESIGN - GROUND FLOOR PLAN - SHEET 1 OF 2	A
3	SW201	STORMWATER CONCEPT DESIGN - GROUND FLOOR PLAN - SHEET 2 OF 2	A
4	SW202	STORMWATER CONCEPT DESIGN - ROOF PLAN	A
5	SW300	STORMWATER CONCEPT DESIGN - DETAILS SHEET	A
6	SW400	EROSION AND SEDIMENT CONTROL - PLAN AND DETAILS	A
7	SW500	STORMWATER CONCEPT DESIGN - MUSIC CATCHMENT PLAN	A



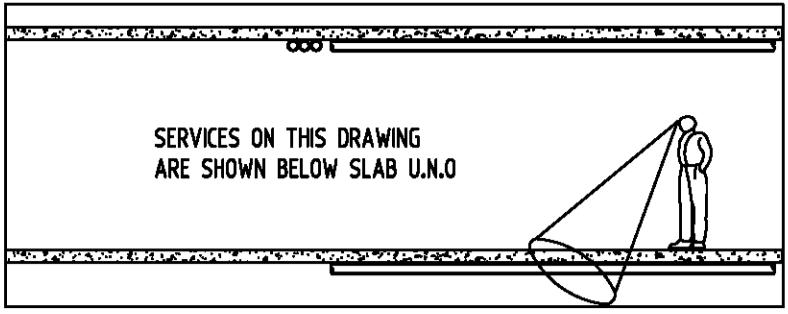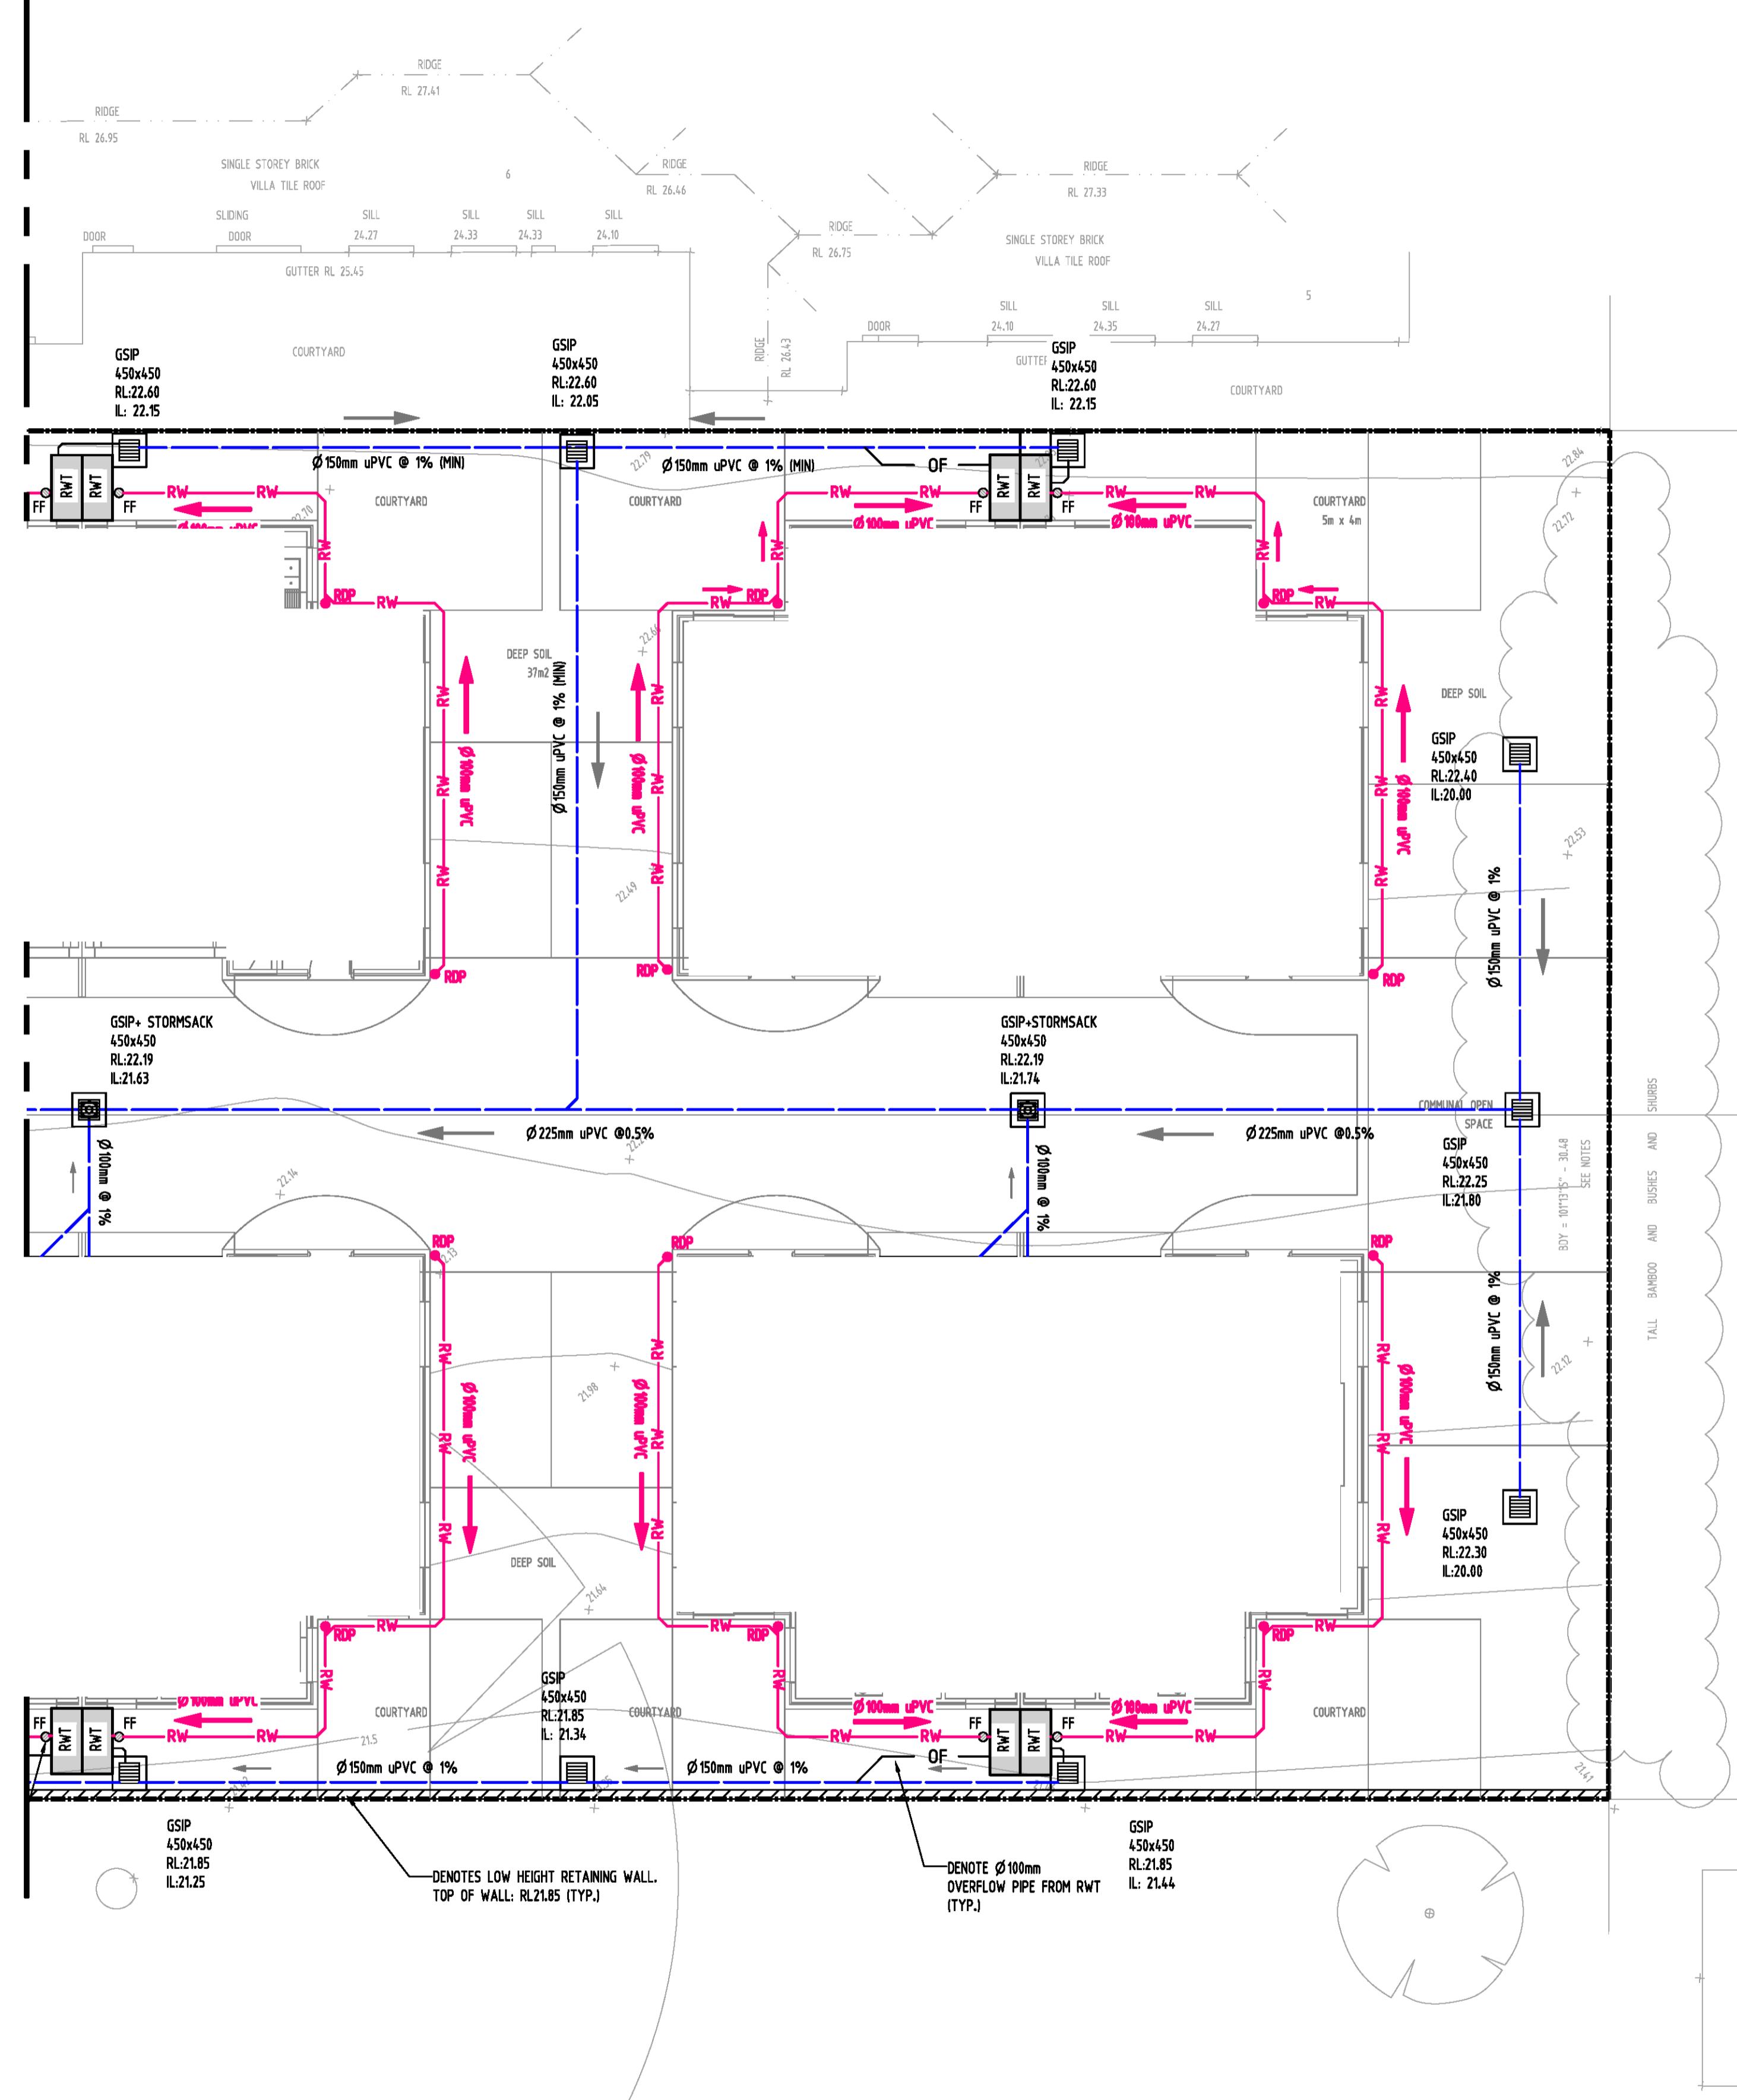

## GUTTER NOTE

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ALL GUTTER TO BE INSTALLED WITH LEAF GUARDS  
AVOID ANY BLOCKAGE.

**NOTE**

ALL GUTTERS AND DOWNPPIPES ARE JUST INDICATIVE.  
EXACT SIZE AND LOCATION OF GUTTERS AND DOWNPPIPES  
TO BE CONFIRMED AT CC STAGE.

This architectural diagram illustrates a complex roof system with multiple gables and valleys. The roof is designed with a primary fall direction indicated by a large arrow pointing downwards. Four specific downspout locations are marked with the label 'RDP' and a small black dot. The diagram also shows the installation of eaves gutters with guards at the lower edges of the roof. A legend in the top right corner provides the following definitions:

- DENOTES DOWNPipe COLLECTING ROOFWATER ONLY (TYP.)
- INSTALL EAVES GUTTER WITH GUARD AT THE LOWER EDGE OF ROOF (TYP.)
- DENOTES EAVES GUTTER

The diagram illustrates a complex structure composed of several rectangular and triangular components. Four points on the structure are marked with the label 'RDP' and a black dot. Four arrows, each labeled 'FALL', point towards these RDP points: one arrow points upwards from the bottom center, one points leftwards from the left side, one points rightwards from the right side, and one points downwards from the top center. The structure is defined by a light blue outline.

ARROWS DENOTE FALL OF ROOF (TYP.)

The diagram illustrates a roof structure with a central peak and multiple gables. Four arrows labeled 'FALL' indicate the direction of roof fall: one pointing down from the peak, one pointing left from the left gable, one pointing right from the right gable, and one pointing down from the rightmost eave. The letters 'RDP' are placed at the vertices of the roof structure, specifically at the peak and the four corners (left, right, top, and bottom).

The diagram illustrates a complex truss structure, likely a roof or floor joist system. The truss is composed of numerous beams forming a triangular grid. Several points on the structure are marked with labels: 'RDP' is marked at the top left, top right, bottom left, and bottom right corners; 'FALL' is marked with arrows pointing in various directions (up, down, left, right) at several internal nodes and along the edges of the truss. The truss is set against a light blue background, and the labels are in black text with black outlines.

The diagram illustrates a complex safety circuit layout. It features a central rectangular area with a stepped top and bottom, and a central horizontal line. Four diagonal lines extend from the corners of this central area to the outer boundaries. The outer boundaries are defined by a thick grey line, with a light blue border. Four 'RDP' (Return-to-Program) points are marked with black dots on the grey line: one at the top-left corner, one at the bottom-left corner, one at the top-right corner, and one at the bottom-right corner. Four arrows labeled 'FALL' indicate potential failure or trip points: one arrow pointing upwards from the top-left RDP, one arrow pointing downwards from the bottom-left RDP, one arrow pointing to the right from the bottom-right RDP, and one arrow pointing to the left from the top-right RDP.

The diagram illustrates a complex logic circuit structure. It features four vertical columns of logic, each ending in a rectangular block labeled "RDP". The circuit is interconnected by a network of diagonal and horizontal lines. Four outputs, labeled "FALL", are positioned at the top, bottom, left, and right ends of the circuit. Each "FALL" label is accompanied by an arrow indicating the direction of the output signal.

					Reference Coordination Drawing	
					Discipline	Drawing Title and Number
					ARCH	
					ARCH	
					STRUCT	
A ISSUEFOR DA					MECH	
P2 PRELIMINARY ISSUE					ELEC	
P1 PRELIMINARY ISSUE					HYD	
Issue	Last revision title		by	Date	Status	FIRE
Issuer internal sequence and revision history						
1-preliminary	2-development application	3-construction certificate		LANDS		
4-tender	5-construction	6-other		CIVIL		
				SURVEY		

		 <p><b>ENGINEERS AUSTRALIA</b> Chartered Professional Engineer <b>MEMBER</b></p>	QUALITY CONTROL				WARNING: THE DESIGNS, THE COPYRIGHT HEREIN IS PROPERTY OF S&G CONS NOT BE USED, COPIED, A WHOLLY OR IN PART IN WRITTEN CONSENT OF SE
Date	Rev.		DRAWN	DR	DATE	13.09.21	
		DIMENSIONS NOT SHOWN TO BE CHECKED ON SITE. DO NOT SCALE OF THIS DRAWING. POSITIONS OF AUTHORITIES MAINS AND/OR EXISTING SERVICES ARE TO BE CHECKED PRIOR TO COMMENCEMENT OF WORK. REPORT ANY DISCREPANCIES TO THE CONSULTING ENGINEER FOR DECISION/CLARIFICATION BEFORE PROCEEDING WITH THE WORK. THIS DRAWING IS TO BE READ IN CONJUNCTION WITH THE SPECIFICATIONS AND OTHER CONSULTANTS' DRAWINGS.	CHECKED	SH	DATE	13.09.21	
		DESIGNED	DR	DATE	13.09.21		
		VERIFIED	SH	DATE	13.09.21		
		APPROVED	SH	DATE	13.09.21		

<p>DRAWINGS, SPECIFICATIONS AND REMAIN THE SOLE INTELLECTUAL ULTANTS PTY LTD AND MUST ALTERED OR REPRODUCED ANY FORM WITHOUT THE G CONSULTANTS PTY LTD</p> 	<p>Scales</p>  <p>0m 1 2 3 4</p> <p>SCALE 1:100 ON ORIGINAL SIZE</p>
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CLIENT  
CAZ BUILD

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1

ARCHITECT




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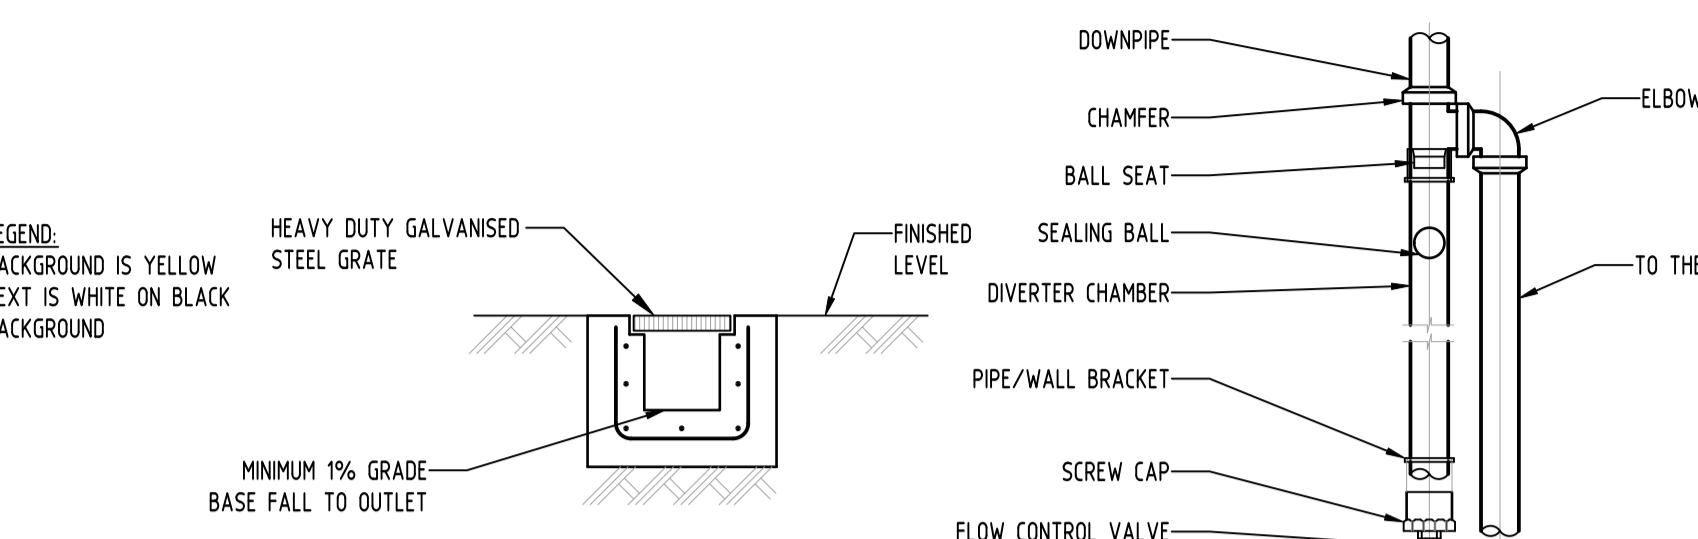
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PROJECT  
**PROPOSED MULTI-DEWLLING  
DEVELOPMENT  
1 ALBERT STREET,**

Drawing Status	<b>FOR APPROVAL</b> <b>NOT TO BE USED FOR CONSTRUCTION PURPOSES</b>		
Drawing Title	<b>STORMWATER CONCEPT DESIGN</b> <b>ROOF PLAN</b>		
size)	Project No	Drawing No	Revision No
	20210155	SW202	A




RAINWATER SIGN  
SCALE 1:20

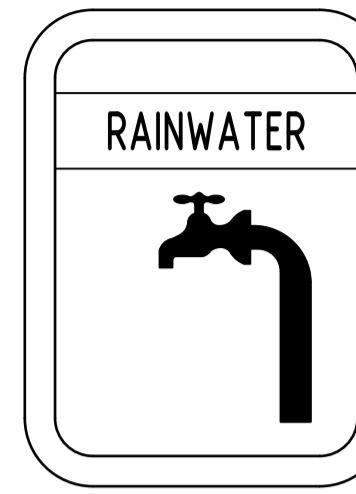


GRATED TRENCH DRAIN  
SCALE 1:20



FIRST FLUSH DIVERTER  
SCALE 1:20

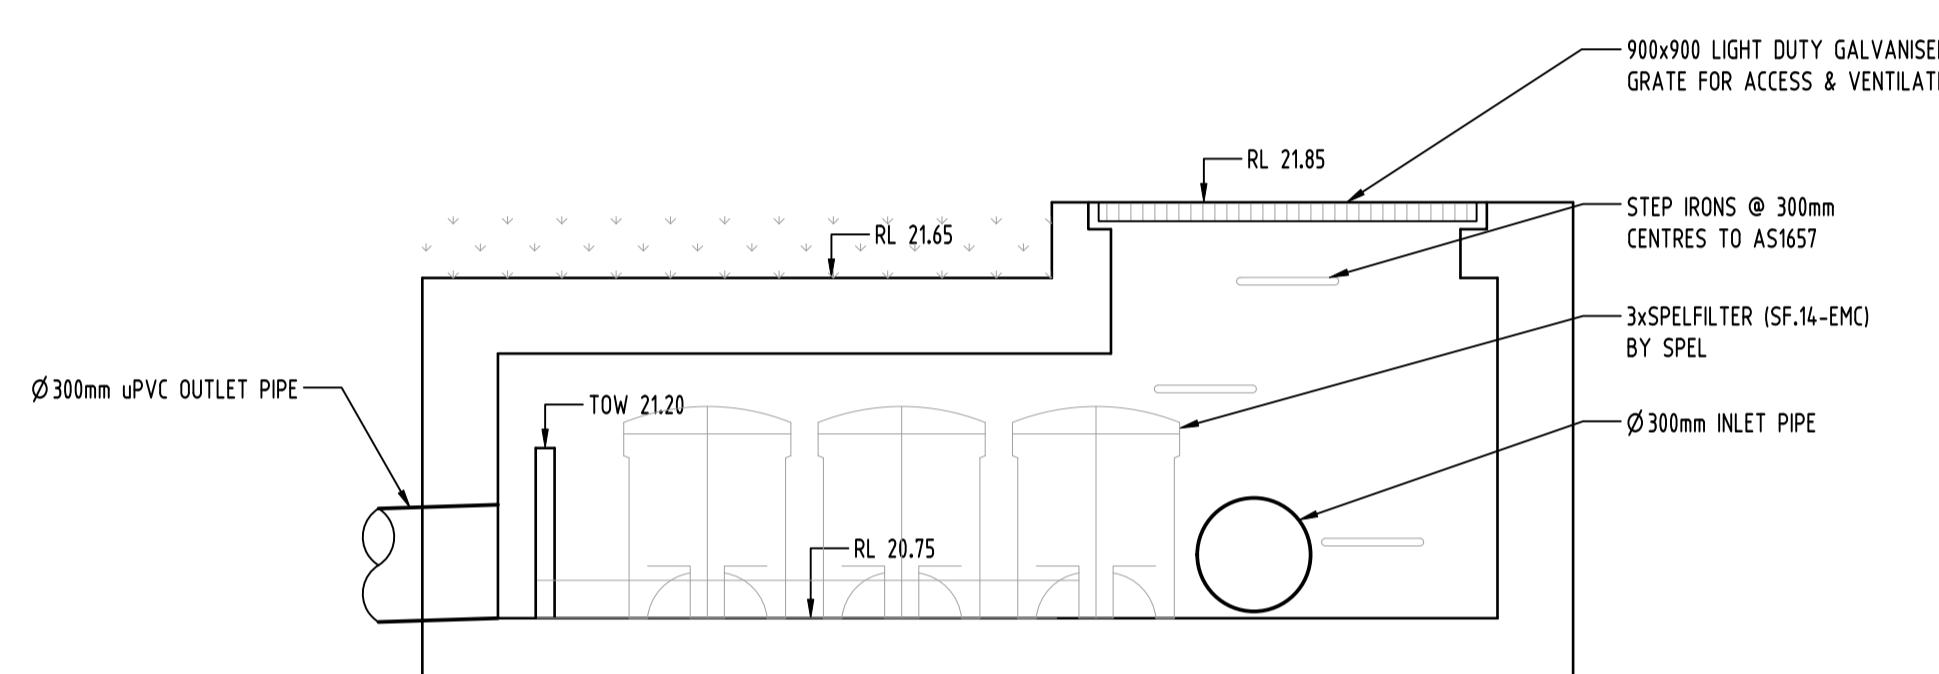


SECTION  
SW200  
FILTER TANK  
SCALE 1:20

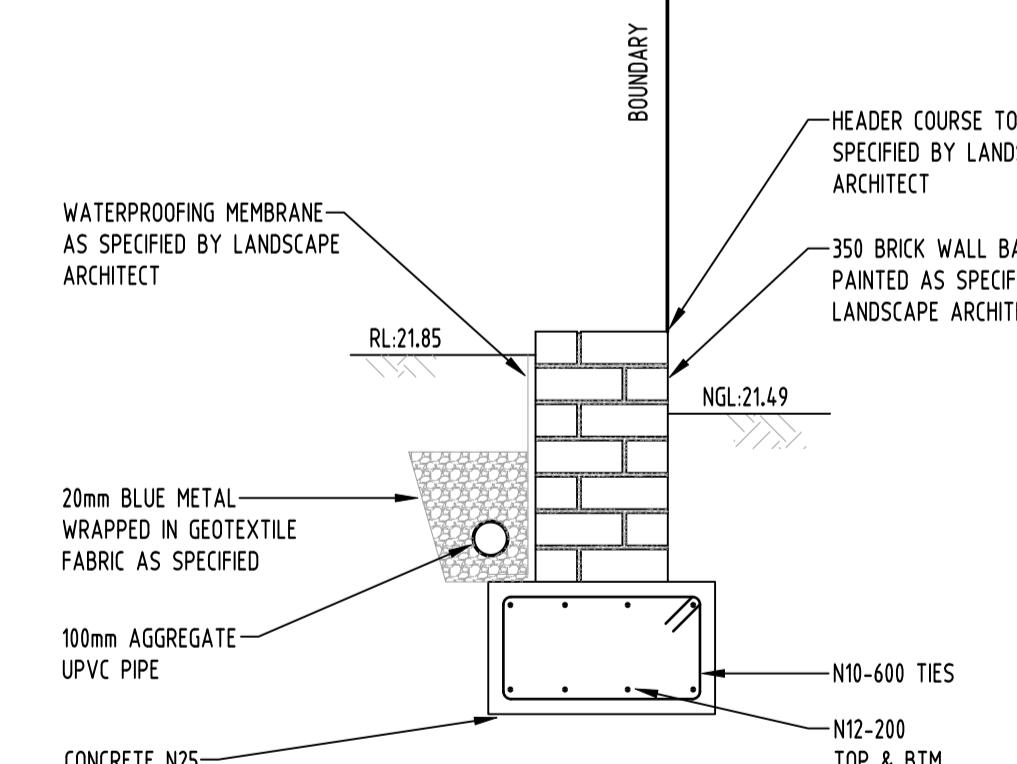

GRAVITY RETAINING WALL  
NTS



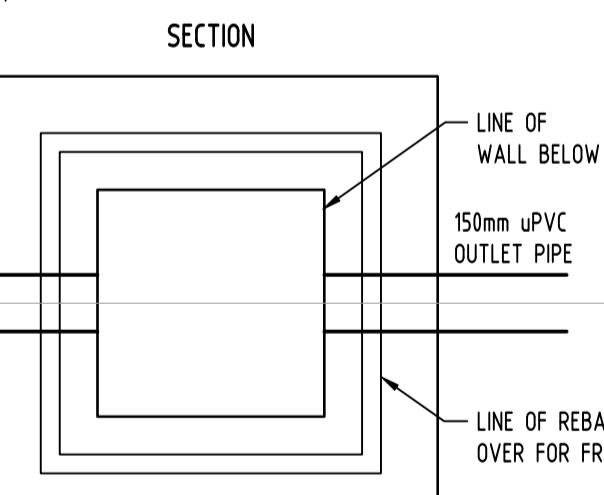
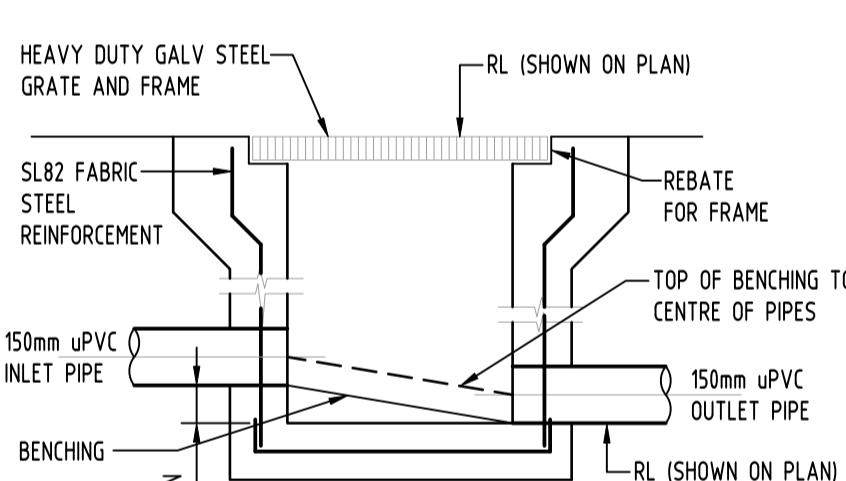


STORMWATER PIT  
SCALE 1:20

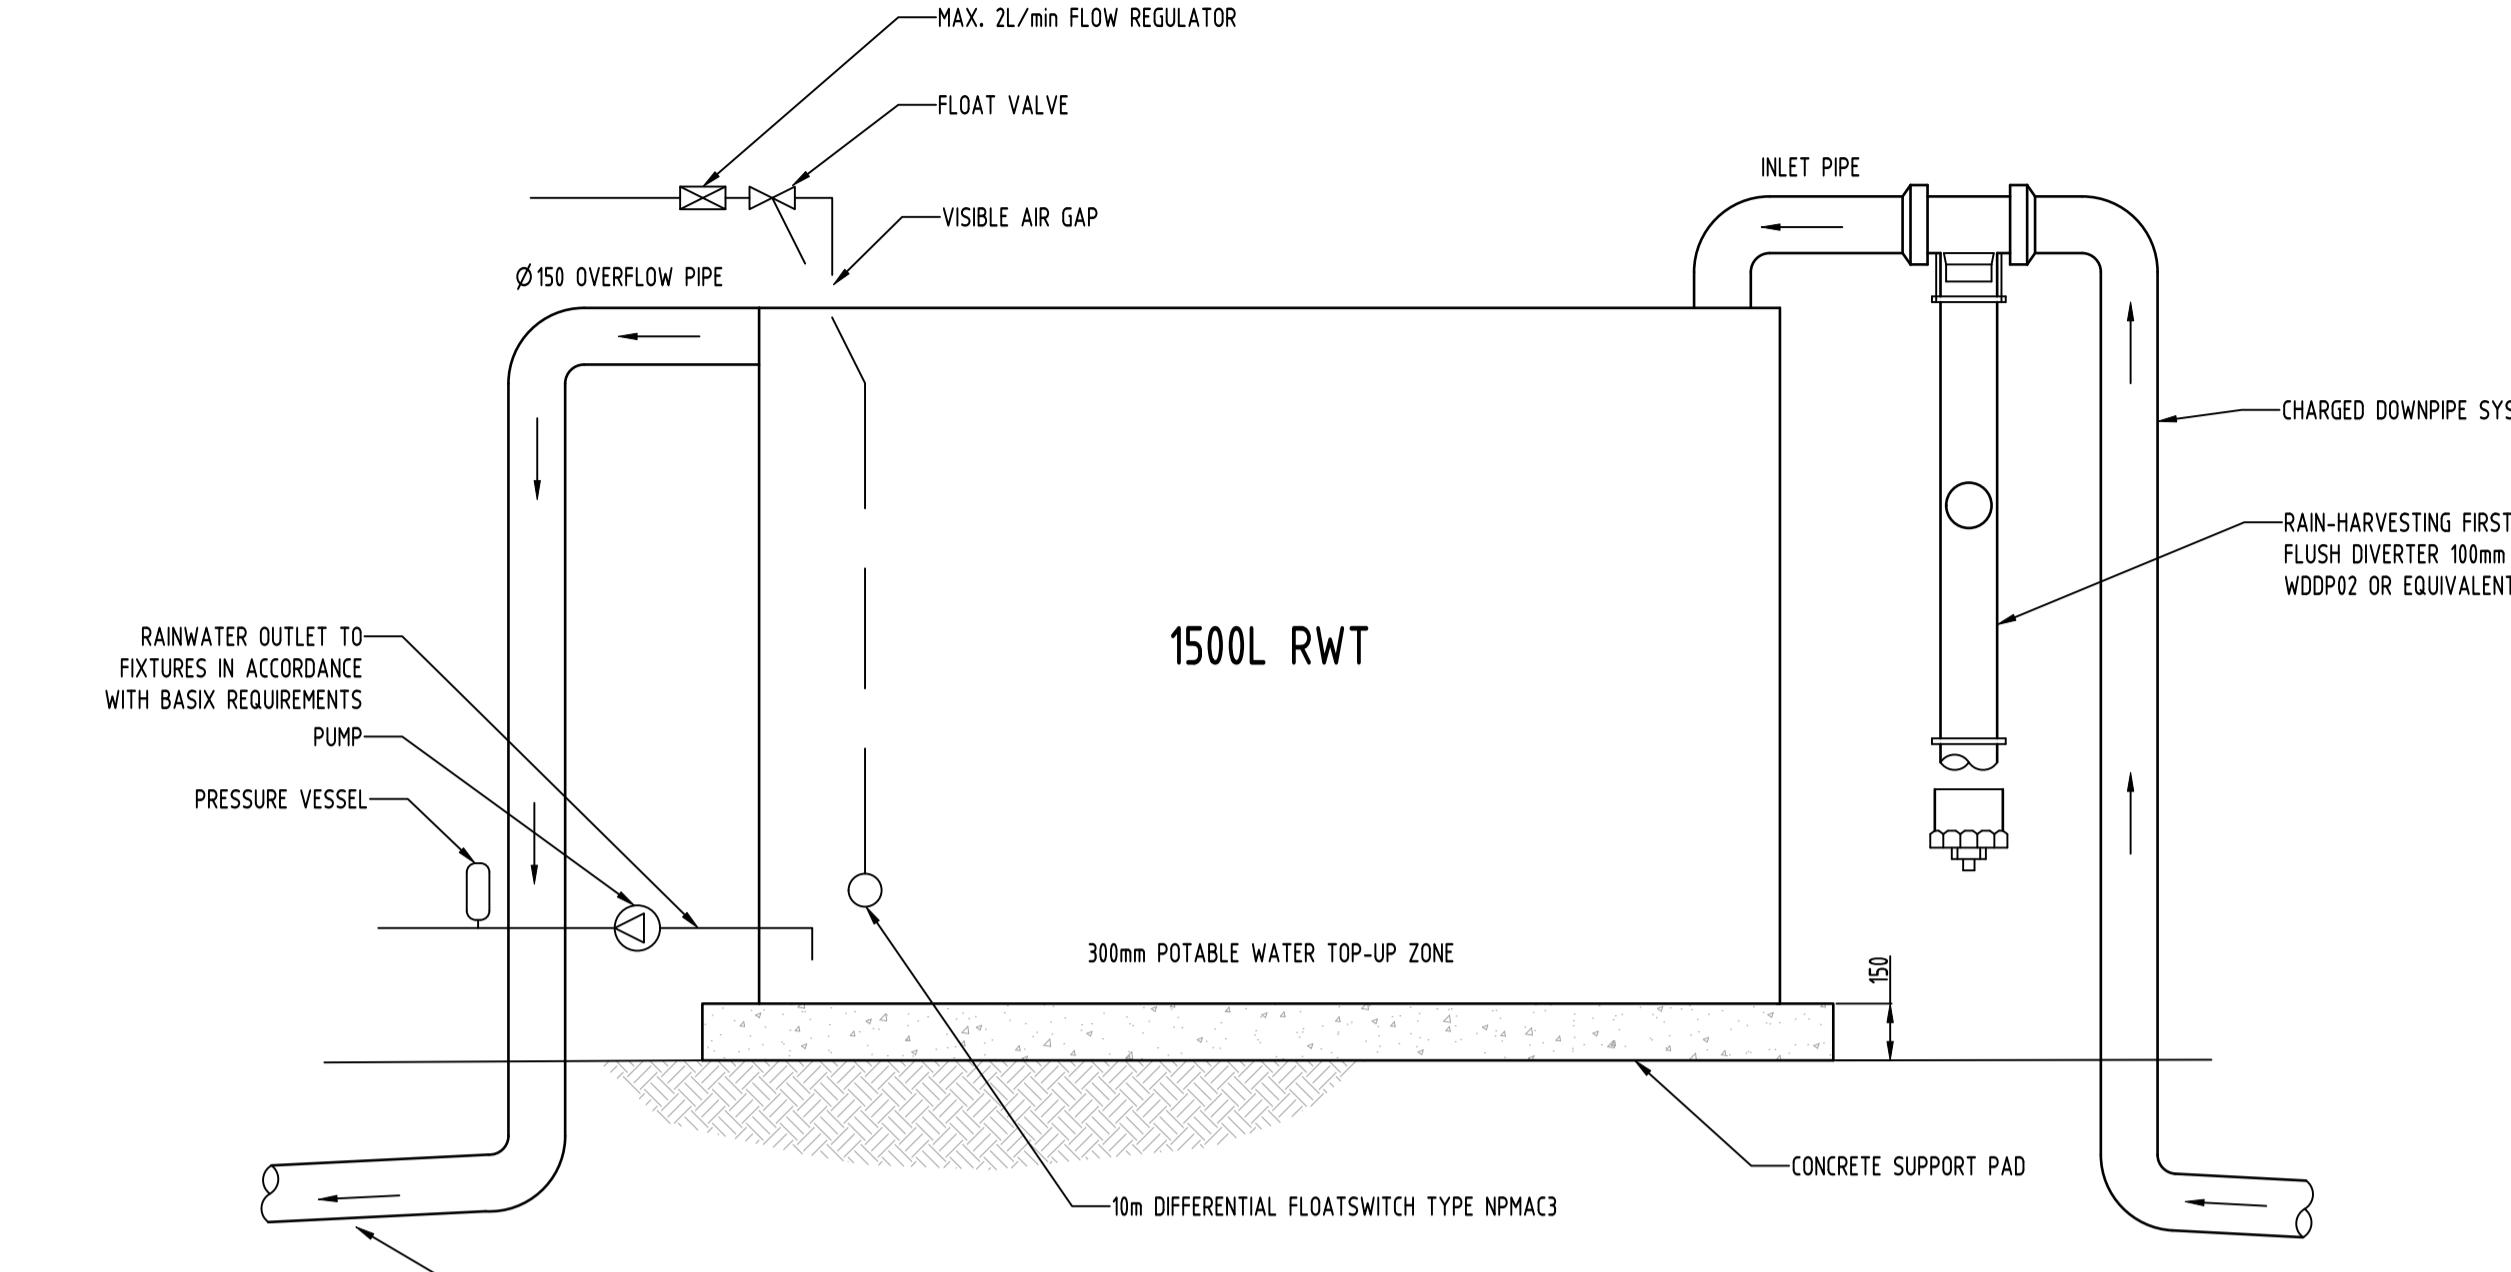


1500L RWT

STANDARD RAINWATER TANK DETAIL  
SCALE 1:20

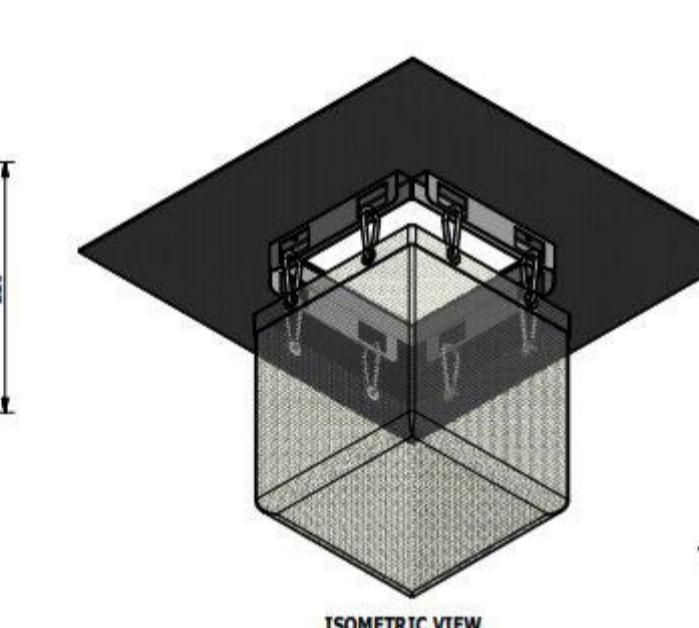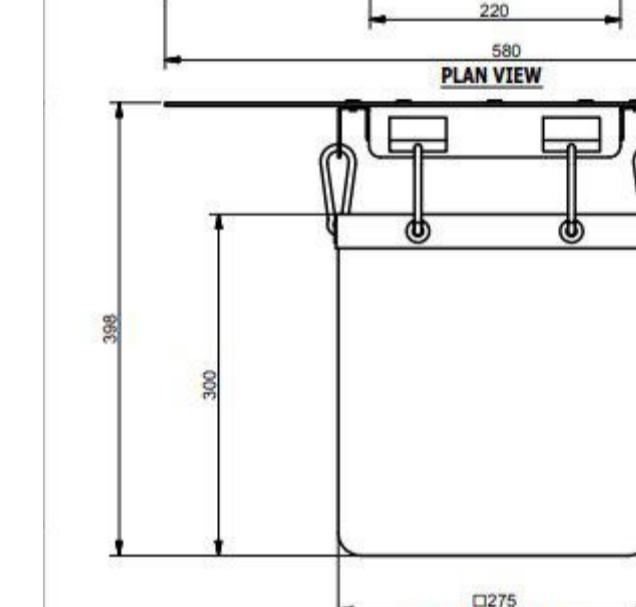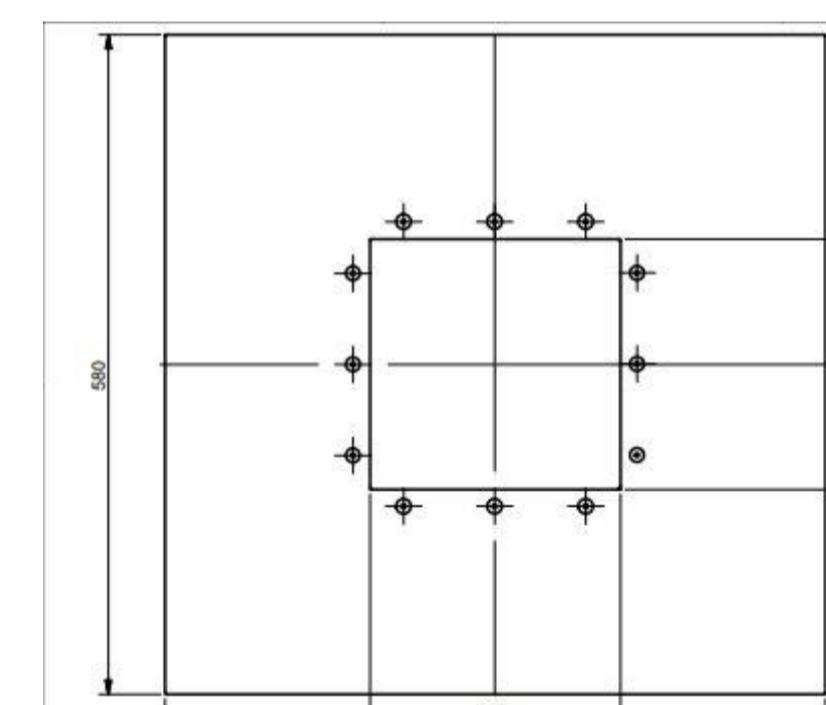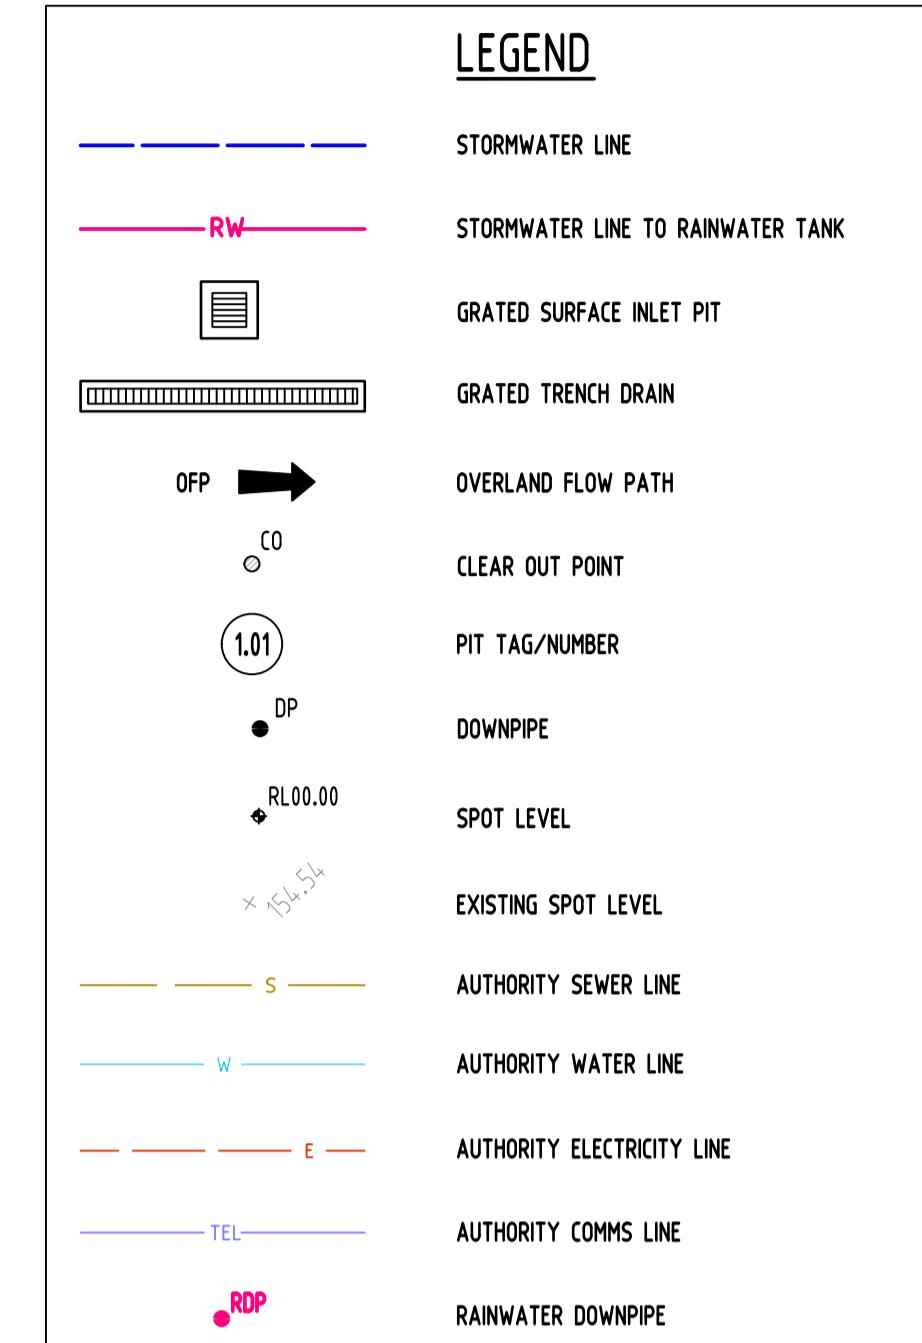

PARTS LIST			
ITEM	QTY	PART NUMBER	DESCRIPTION
1	1	PLASTIC SHEETING	HOPE
2	4	SHEET METAL BENDING	STAINLESS STEEL 304
3	1	TEXTILE FABRIC	HOPE
4	16	BLIND RIVET 7 DIA.	STAINLESS STEEL 304
5	8	CARABINER CLIP 6	ALUMINUM

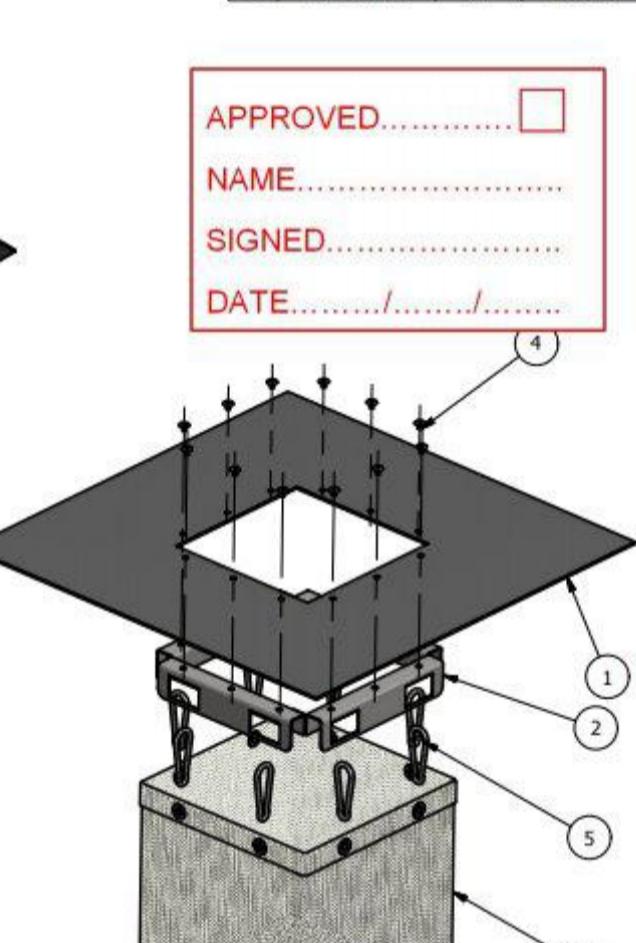

ISSUE FOR APPROVAL  
NOT FOR CONSTRUCTION

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Checked by:	Date:	Drawn by: SPEL ENVIRONMENTAL
Verified by:	Date:	Reviewed by:
Approved by:	Date:	Approved by:

REQUEST No. 020194 SIZE A3 SHEET 1 REV 1  
Customer Code: 100 Silverwater Road Silverwater NSW 2128  
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Email: office@sgc.com.au  
Web: www.sgc.com.au

PROJECT  
PROPOSED MULTI-DEWLLING  
DEVELOPMENT  
71 ALBERT STREET,  
WERRINGTON

Grid: Datum: Sheet: Scale (at original size)  
A.H.D. 5 OF 7 AS SHOWN



Project No. Drawing No. Revision No.  
20210155 SW300 A



obrien  
design+drafting



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#### EROSION & SEDIMENTATION CONTROL NOTES

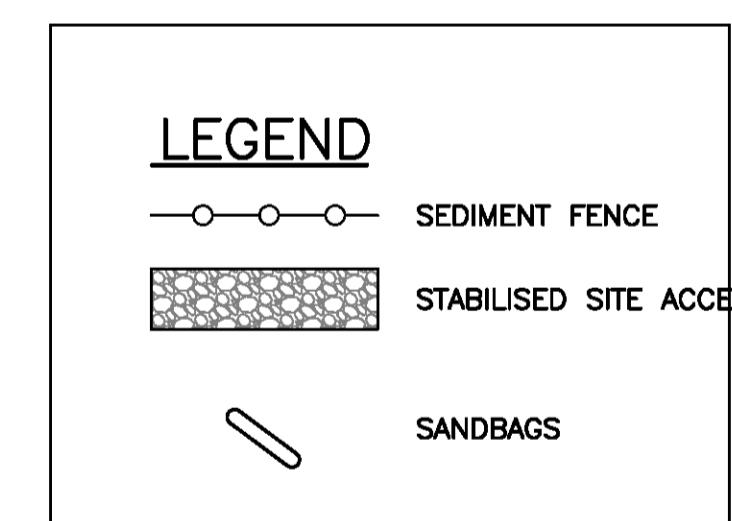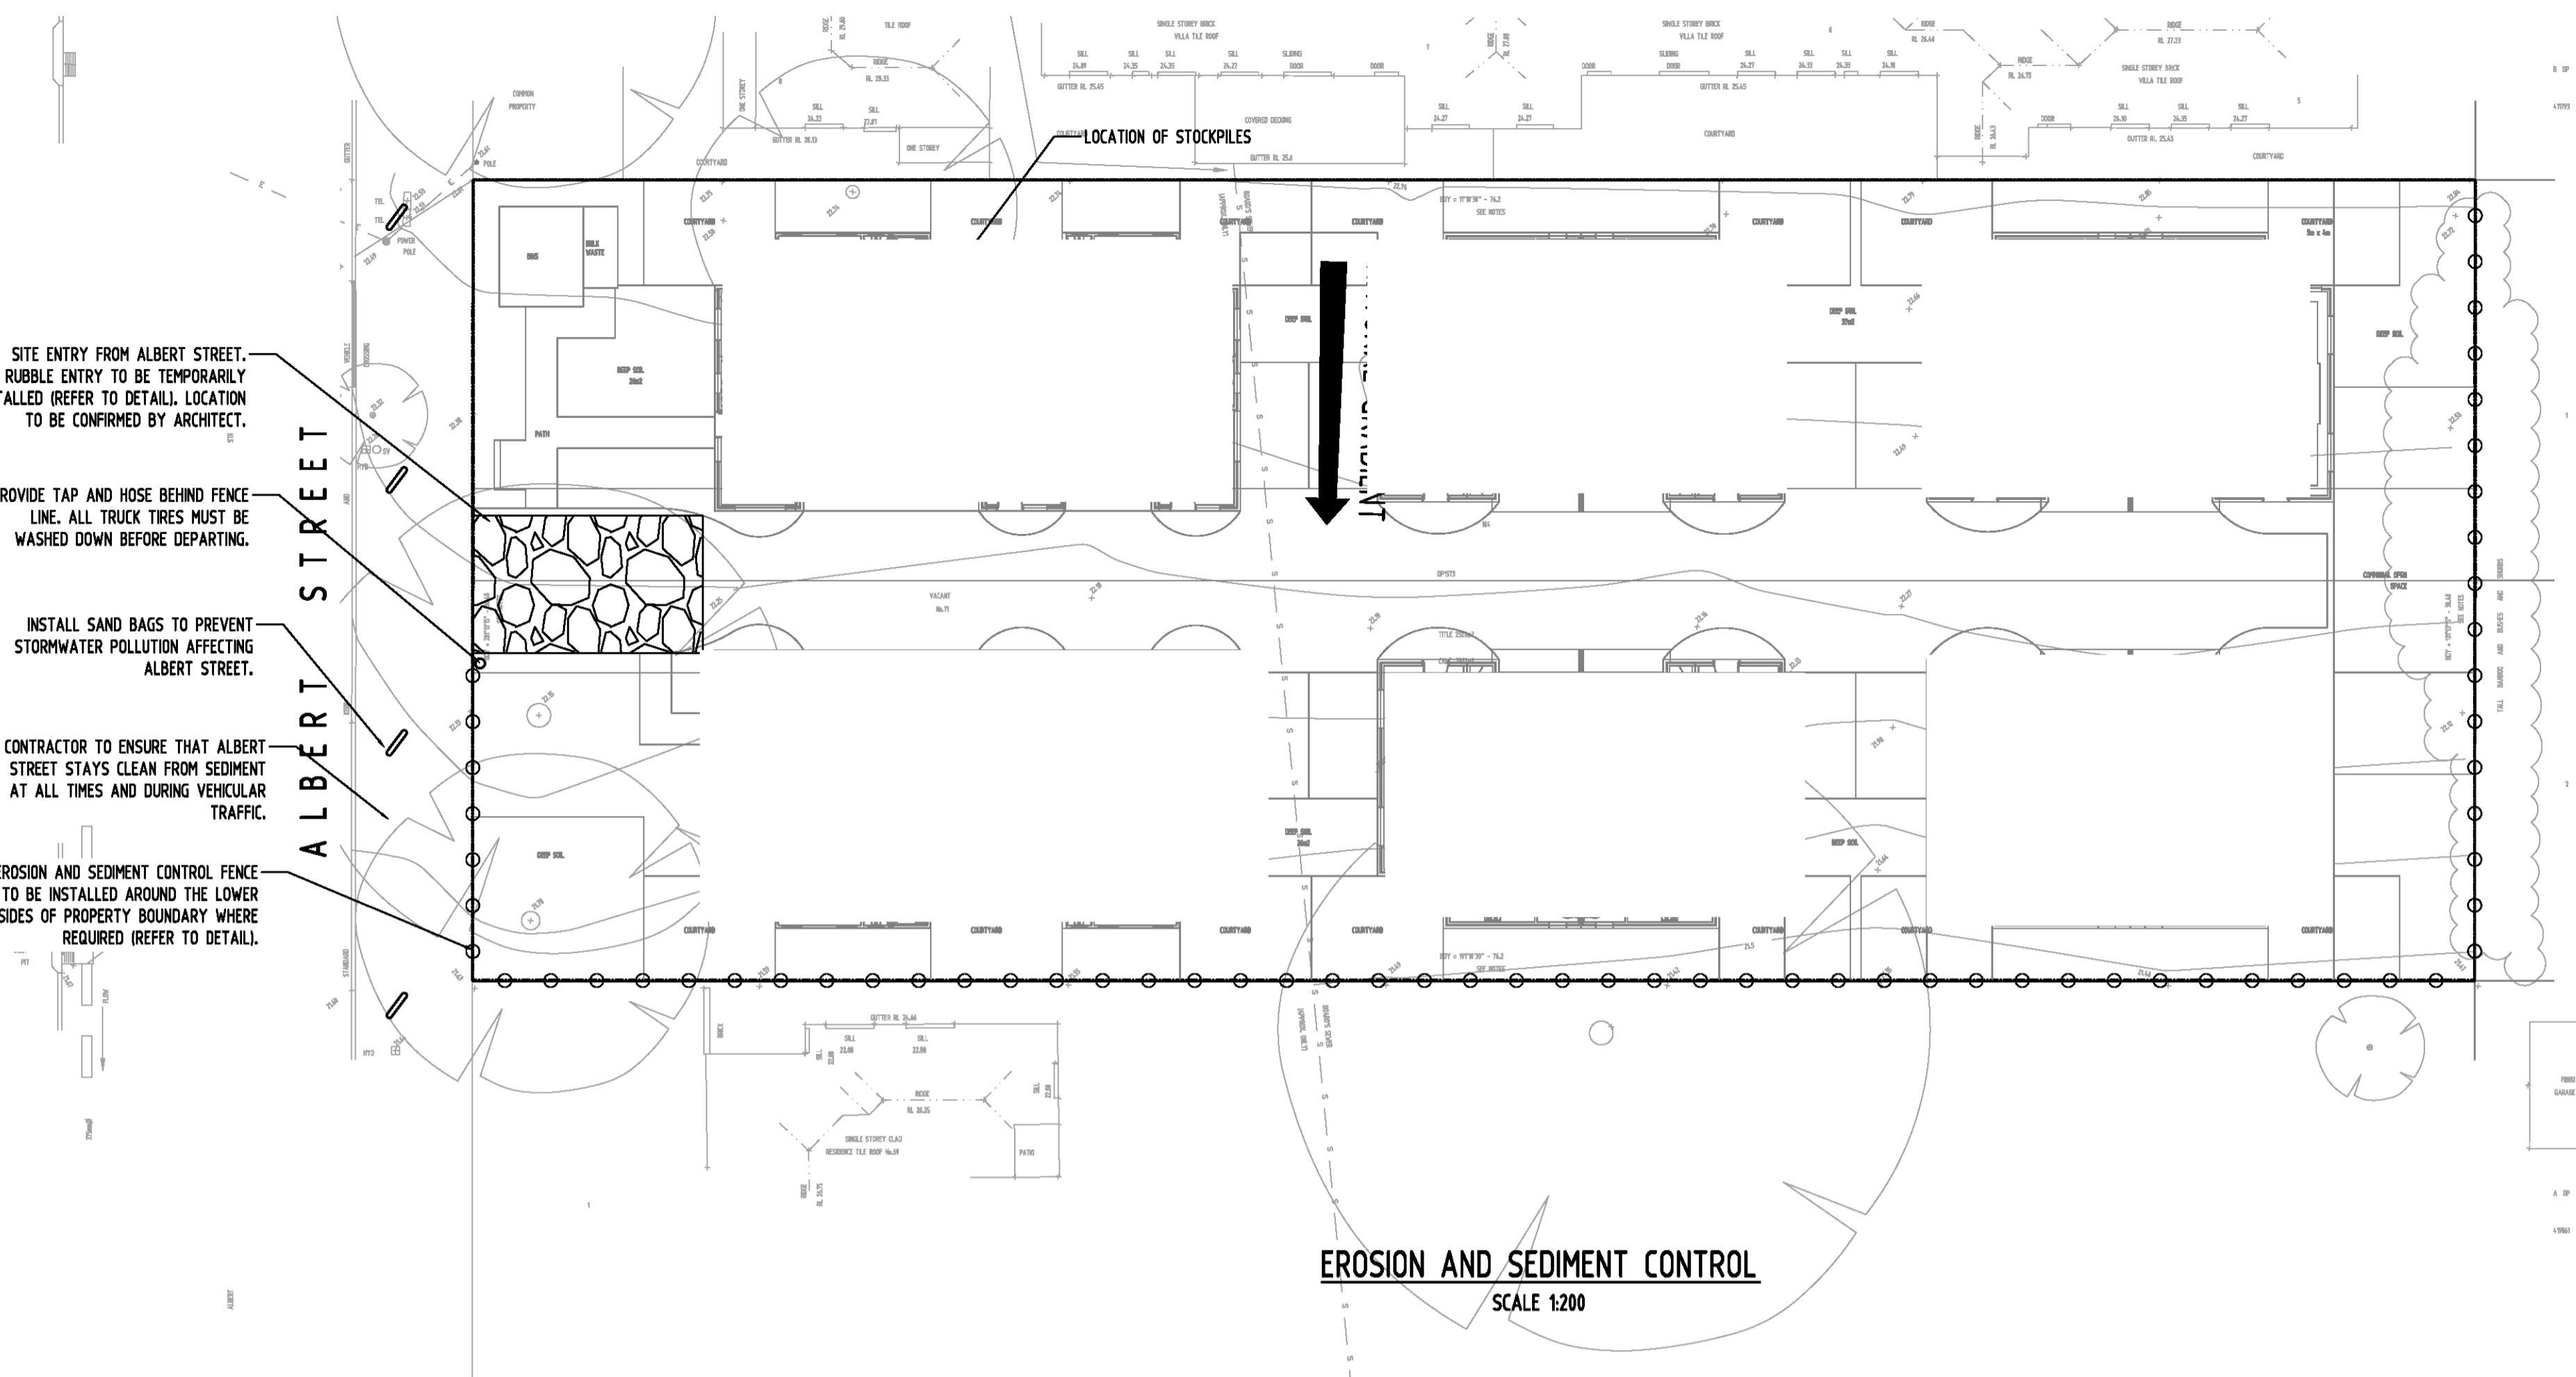- CONTRACTOR SHALL PROVIDE SEDIMENT FENCING MATERIAL DURING CONSTRUCTION TO THE LOW SIDE OF THE WORKS. TIE SEDIMENT FENCING MATERIAL TO CYCLONE WIRE SECURITY FENCE. SEDIMENT CONTROL FABRIC SHALL BE AN APPROVED MATERIAL (E.G. HUMES PROPEX SILT STOP) STANDING 300mm ABOVE GROUND & EXTENDING 150mm BELOW GROUND.
- EXISTING DRAINS LOCATED WITHIN THE SITE SHALL ALSO BE ISOLATED BY SEDIMENT FENCING MATERIAL.
- NO PARKING OR STOCKPILING OF MATERIALS IS PERMITTED ON THE LOWER SIDE OF THE SEDIMENT FENCE.
- GRASS VERGES SHALL BE MAINTAINED AS MUCH AS PRACTICAL TO PROVIDE A BUFFER ZONE TO THE CONSTRUCTION SITE.
- CONSTRUCTION ENTRY/EXIT SHALL BE VIA THE LOCATION NOTED ON THE DRAWING. CONTRACTOR SHALL ENSURE ALL DROPPABLE SOIL & SEDIMENT IS REMOVED PRIOR TO CONSTRUCTION TRAFFIC EXITING SITE. CONTRACTOR SHALL ENSURE ALL CONSTRUCTION TRAFFIC ENTERING & LEAVING THE SITE DO SO IN A FORWARD DIRECTION.



#### GENERAL NOTES

- THIS PLAN IS A CONCEPT PLAN ONLY FOR STORMWATER DISPOSAL & EROSION CONTROL. IT IS NOT SUITABLE FOR CONSTRUCTION. THIS PLAN SHOULD BE ADAPTED BY THE BUILDER DURING DEMOLITION, EXCAVATION & CONSTRUCTION PHASES TO ENSURE ADEQUATE PERFORMANCE.
- ALL DRAINAGE LAYOUT & DETAILS ARE DIAGRAMMATIC & INDICATIVE ONLY. ACTUAL LOCATION, SIZES, LEVELS & GRADES MAY ALTER WHEN DETAIL DESIGN WORKS ARE DOCUMENTED.


**CLAY SOILS**

A SYSTEM SHALL BE INSTALLED TO EITHER:

- TRANSPORT STORMWATER RUNOFF WITH SUSPENDED SOLIDS FROM SITE VIA PUMP TRUCKS.
- TREAT THE STORMWATER RUNOFF WITH SUSPENDED SOLIDS SO THE DISCHARGE WATER QUALITY TO COUNCIL STORMWATER DRAINAGE SYSTEM HAS A MAXIMUM CONCENTRATION OF SUSPENDED SOLIDS THAT DOES NOT EXCEED 50 MILLIGRAMS PER LITRE IN ACCORDANCE WITH THE PROTECTION OF THE ENVIRONMENT OPERATION ACT (POEO 1997) AND SHALL BE APPROVED BY LOCAL COUNCIL

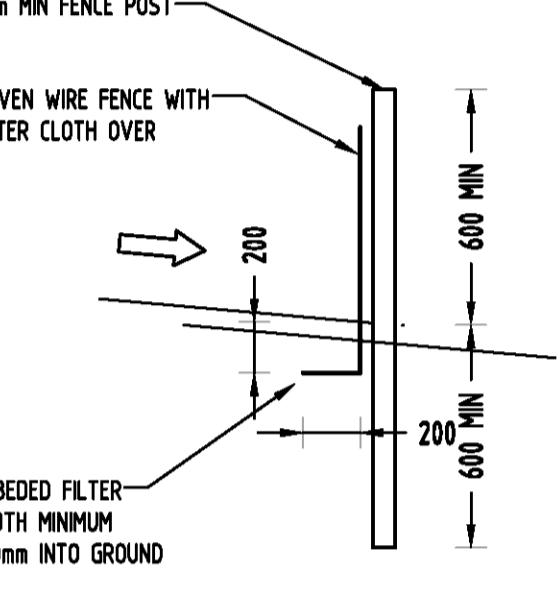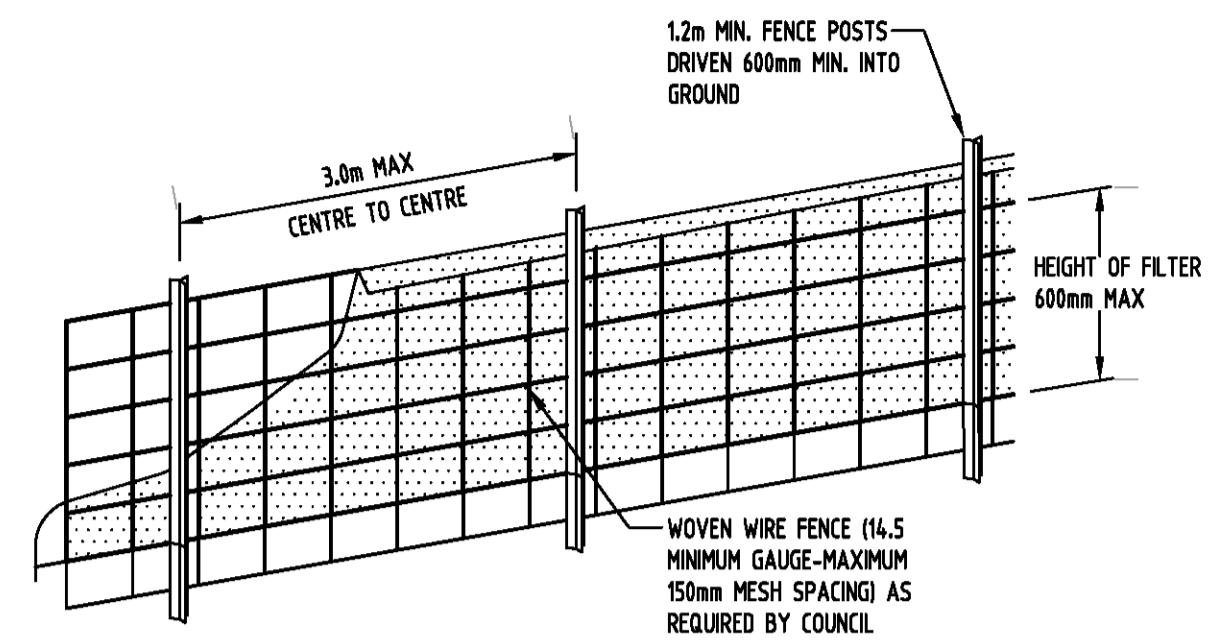

**SEDIMENT FENCE**  
NOT TO SCALE

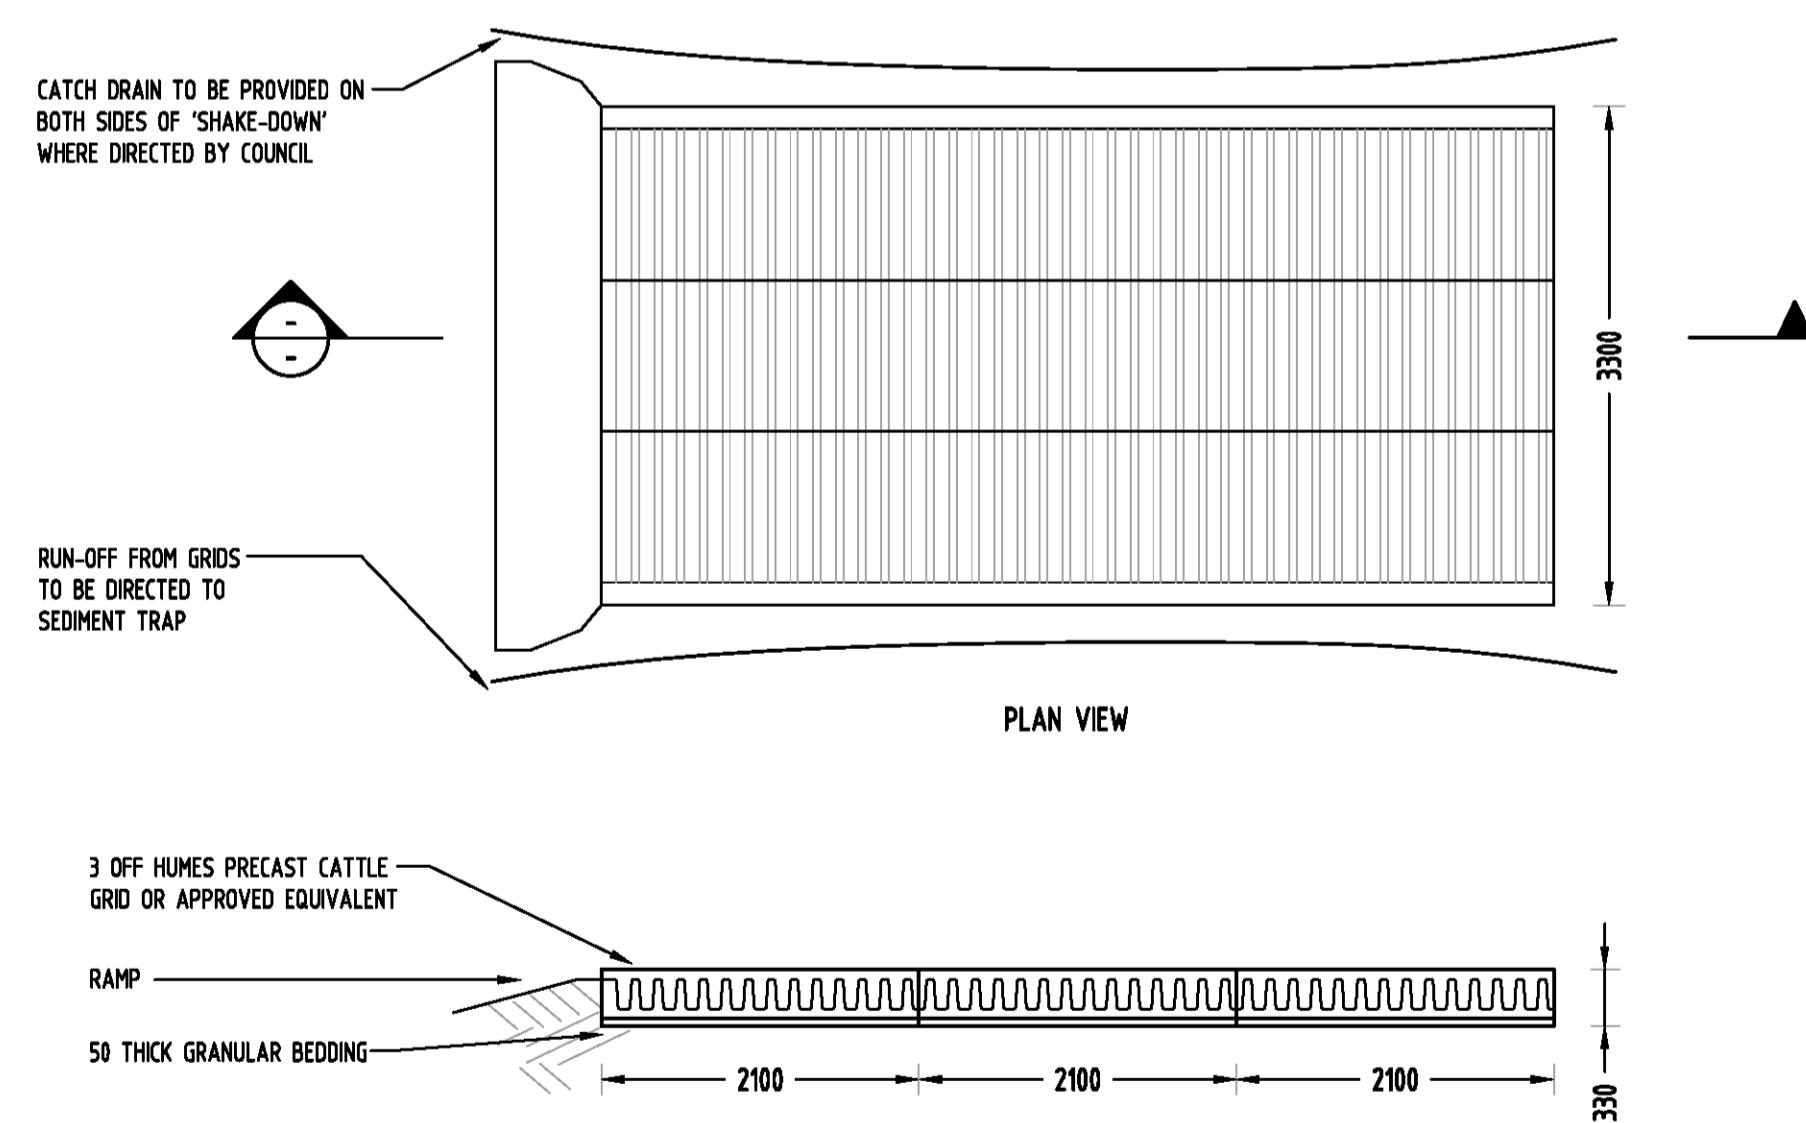

**'CATTLE GRID' ALTERNATIVE**  
TEMPORARY CONSTRUCTION EXIT  
NOT TO SCALE


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Issue	Last revision date	by	Date	Discipline	Drawing Title and Number	Date	Rev.	DRAWN	DR	DATE	13.09.21	FOR APPROVAL
A	ISSUE FOR DA	DR	13.09.21	2	STRUCT	13.09.21		CHECKED	SH	DATE	13.09.21	NOT TO BE USED FOR CONSTRUCTION PURPOSES
P2	PRELIMINARY ISSUE	DR	25.08.21	1	MECH	25.08.21		DESIGNED	DR	DATE	13.09.21	Drawing Title
P1	PRELIMINARY ISSUE	DR	14.08.21	1	ELEC	14.08.21		VERIFIED	SH	DATE	13.09.21	Approved
Issuer internal sequence and revision history				NOTICE: THE DESIGNS, DRAWINGS, SPECIFICATIONS AND THE COPYRIGHT THEREIN REMAIN THE SOLE INTELLECTUAL PROPERTY OF SAG CONSULTANTS PTY LTD AND MUST NOT BE COPIED, REPRODUCED, ALTERED OR USED WHOLLY OR IN PART BY ANY PERSON WITHOUT THE WRITTEN CONSENT OF SAG CONSULTANTS PTY LTD.								
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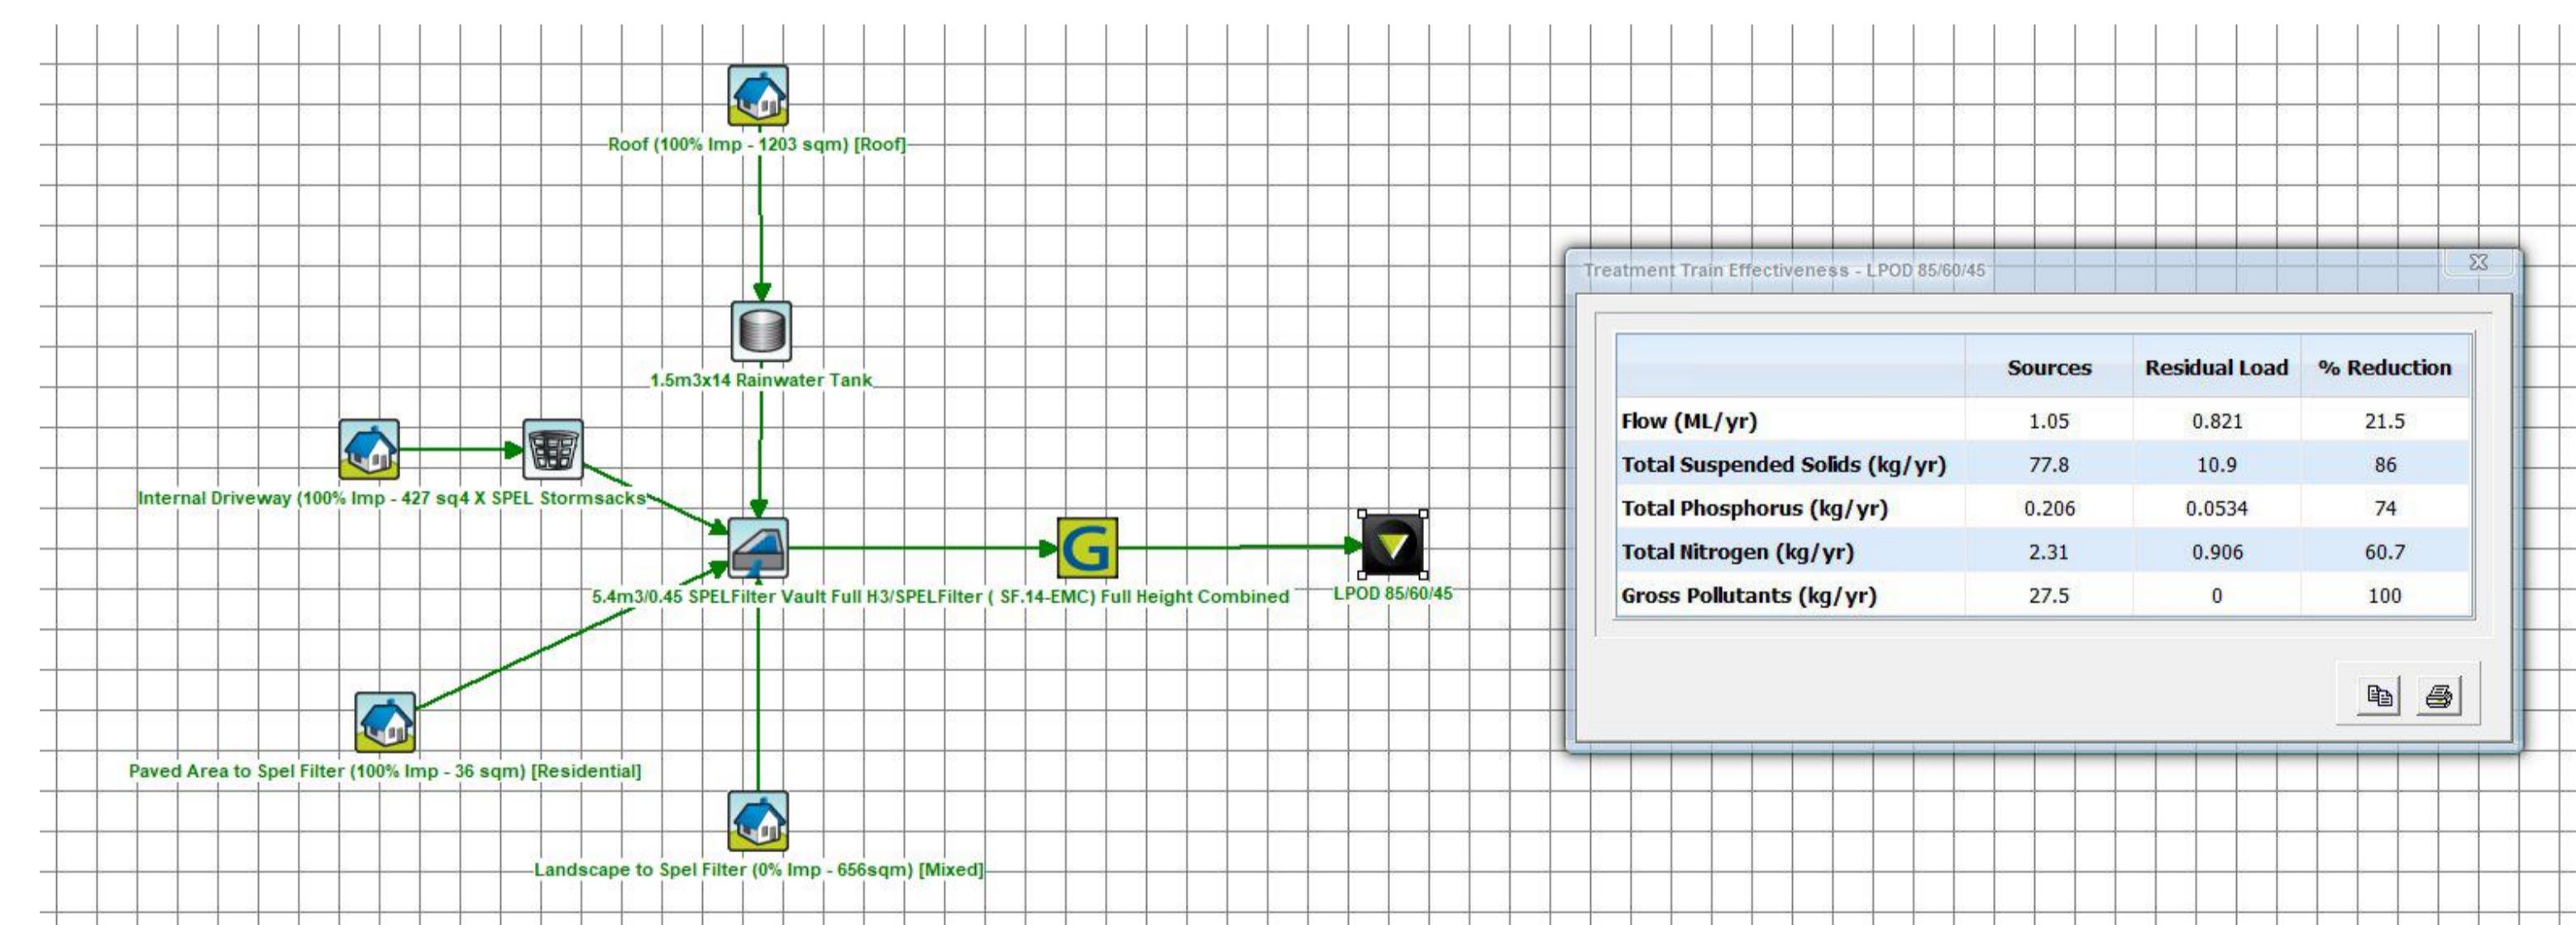
**PROPOSED MULTI-DWELLING DEVELOPMENT**  
71 ALBERT STREET,  
WERRINGTON  
EROSION AND SEDIMENT CONTROL PLAN AND DETAILS  
Project No: 20210155 Drawing No: SW400 Revision No: A

Drawing Status: FOR APPROVAL  
NOT TO BE USED FOR CONSTRUCTION PURPOSES  
Drawing Title: Erosion and Sediment Control Plan and Details  
Grid: 6 Datum: A.H.D. Sheet: 6 of 7 Scale (at original size): AS SHOWN




MUSIC CATCHMENT SITE BREAK UP PLAN

SCALE 1:250

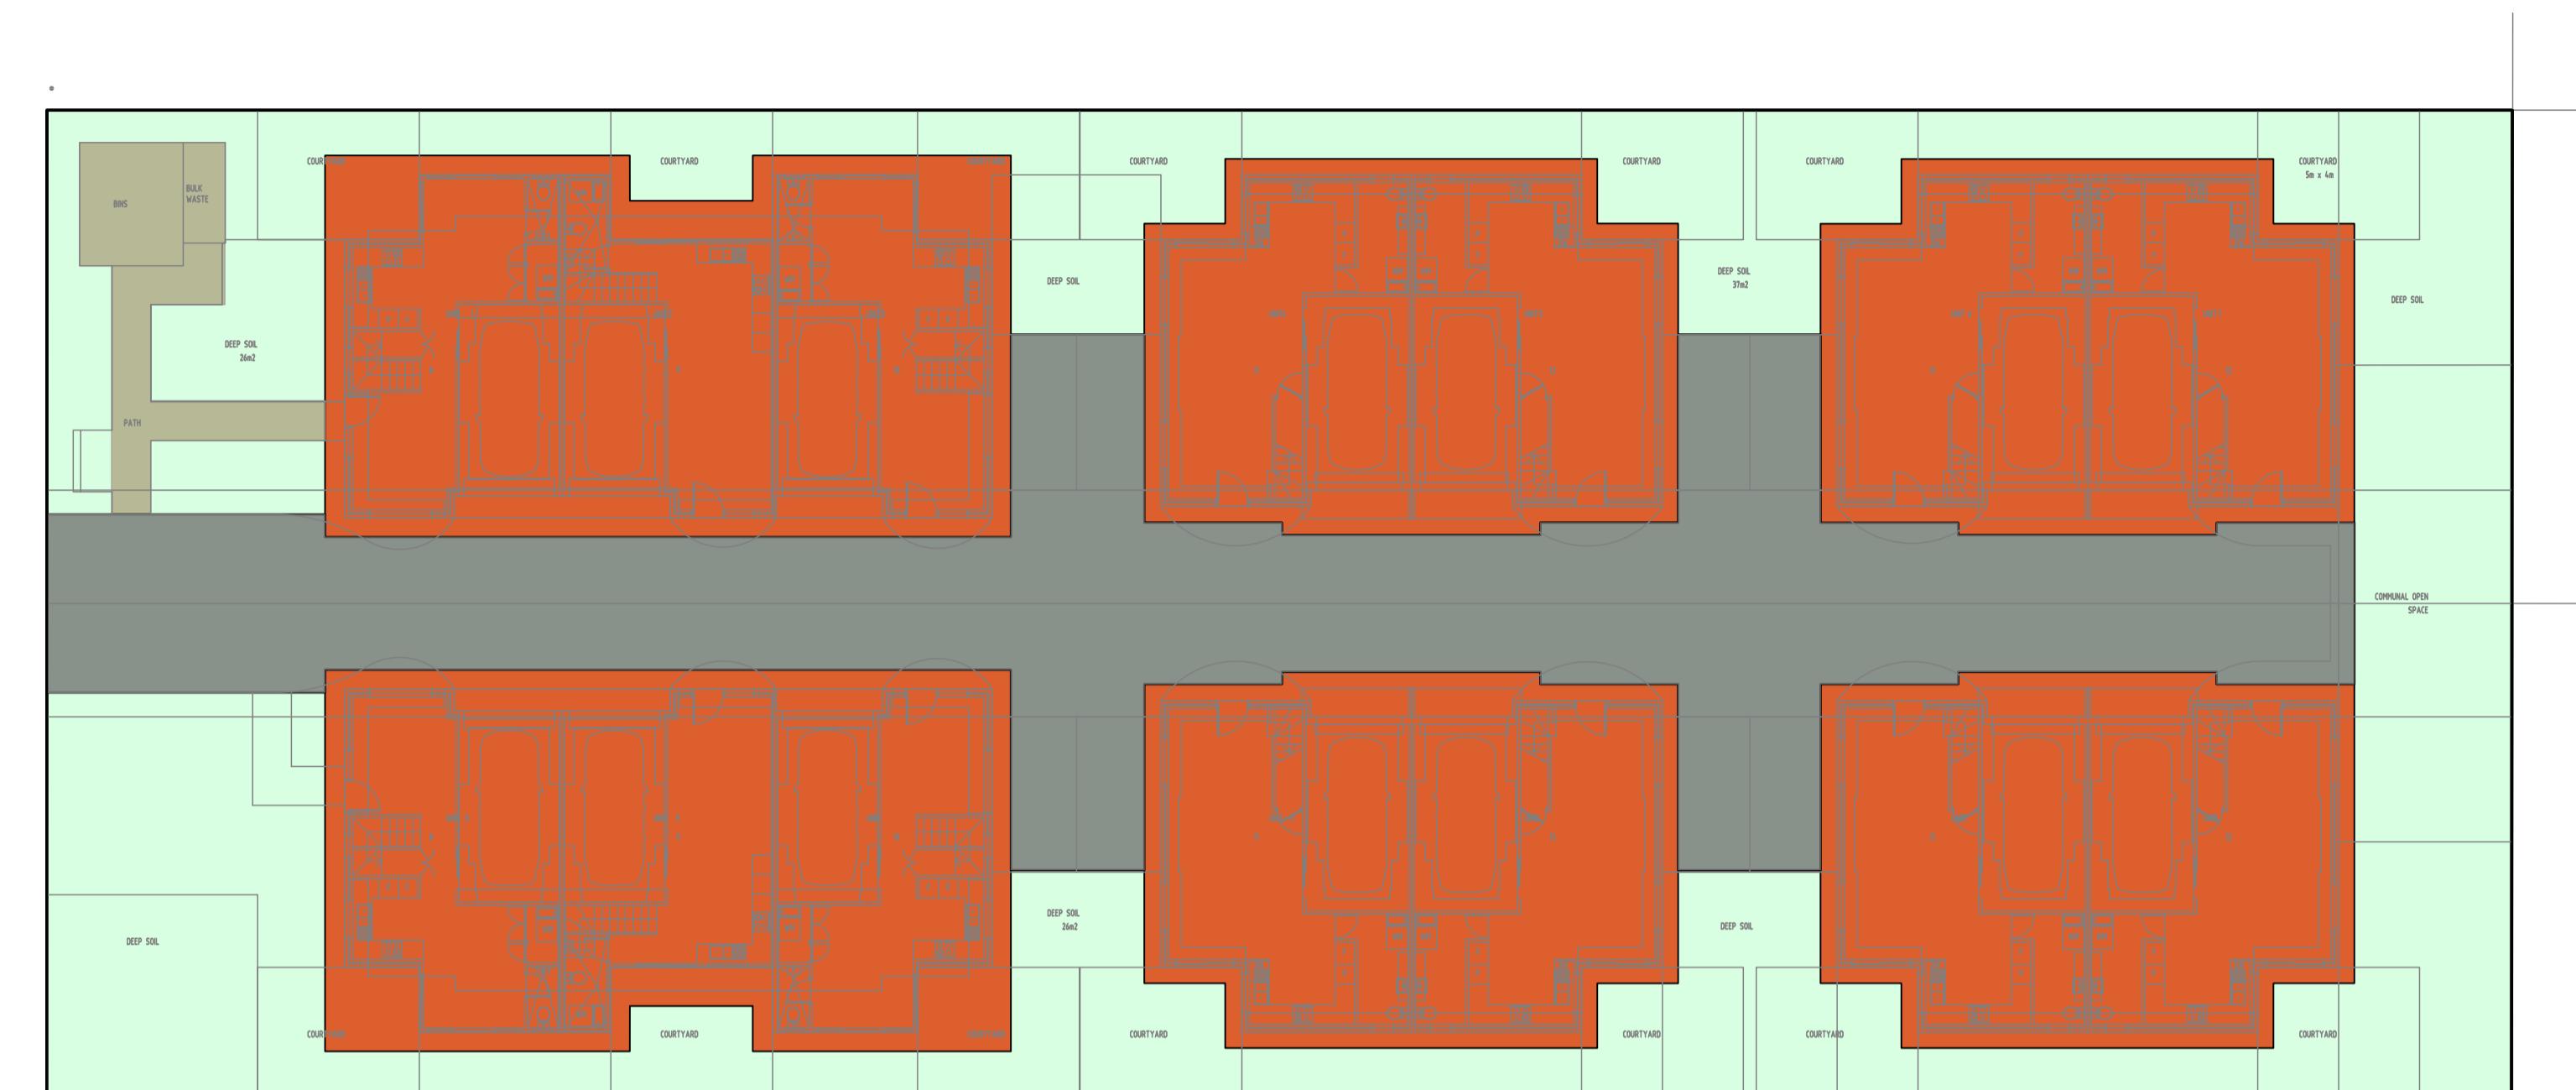

Issuer internal sequence and revision history			
1-preliminary	2-development application	3-construction certificate	4-other
4-tender			

Reference Coordination Drawing			
Discipline	Drawing Title and Number	Date	Rev.
ARCH			
STRUCT			
MECH			
ELEC			
HYD			
FIRE			
LANDS			
CIVIL			
SURVEY			

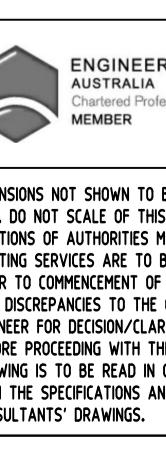

ENGINEERS  
AUSTRALIA  
Professional Engineer  
MEMBER

DRAWN DR DATE 13.09.21

CHECKED SH DATE 13.09.21

DESIGNED DR DATE 13.09.21

VERIFIED SH DATE 13.09.21

APPROVED SH DATE 13.09.21

0m 2.5 5 7.5 10 12.5

SCALE 1:250 ON ORIGINAL SIZE

21

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Scales

0m

2.5

5

7.5

10

12.5

SCALE 1:250 ON ORIGINAL SIZE

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PROJECT  
PROPOSED MULTI-DEWLLING  
DEVELOPMENT  
71 ALBERT STREET,  
WERRINGTON

Drawing Status FOR APPROVAL  
NOT TO BE USED FOR CONSTRUCTION PURPOSES  
Drawing Title  
STORMWATER CONCEPT DESIGN  
MUSIC CATCHMENT PLAN  
Project No 20210155 Drawing No SW500 Revision No A  
Grid Datum Sheet Scale (at original size)  
A.H.D. 7 OF 7 1:250 @ A1