GENERAL NOTES:

- THESE DRAWINGS SHALL BE READ IN CONJUCTION WITH ARCHITECTURAL AND OTHER CONSULTANTS DRAWINGS AND SPECIFICATIONS AND WITH SUCH OTHER WRITTEN INSTRUCTION AS MAY BE ISSUED DURING THE THE COURSE OF THE CONTRACT. ANY DISCREPANCIES IN THESE DOCUMENTS SHALL BE REFERRED TO THE ENGINEER FOR A DECISION BEFORE PROCEEDING WITH THE WORK.
- ALL WORKMANSHIP AND MATERIALS TO BE IN ACCORDANCE WITH CURRENT SAA CODES AND LOCAL GOVERMENT ORDINANCES.
- 3. THE FOOTINGS HAVE BEEN DESIGNED FOR A UNIFORM BEARING INTENSITY OF 150 kPa Foundation Material Shall be approved by an Engineer from this office before placing any concrete.
- SITE CLASSIFICATION M FOOTING SYSTEM WAFFLE DESIGNED IN ACCORDANCE WITH 'AS 2870'. THE OWNER'S ATTENTION IS DRAWN TO APPENDIX A OF 'AS 2870' "PERFORMANCE REQUIREMENTS AND FOUNDATION MAINTENANCE".

FOUNDATION NOTES:

- ALL SOFT FILLING MATERIAL AND TOP SOIL OVER THE NATURAL STRATA IS TO BE REMOVED.
- FOR CLAY FILLING USE 150mm THICK LAYERS TO 300mm MAXIMUM DEPTH. THE CLAY IS TO BE MOIST AND COMPACTED BY MECHANICAL MFANS.
- FOR SAND FILLING USE 150mm THICK LAYERS TO 600mm MAXIMUM DEPTH. THE SAND IS TO BE COMPACTED BY A VIBRATING PLATE OR ROLLER.
- IF EXTENT OF FILL EXCEEDS THE LIMIT OUTLINED ABOVE, THE ENGINEER IS TO BE NOTIFIED FOR FURTHER INSTRUCTION.
- ALL TOP SOIL AND VEGETABLE MATTER ARE TO BE REMOVED FROM THE SITE AND ANY BOULDERS OR ROCKS TO BE REPLACED WITH GRANULAR FILLING.
- SLAB AND FOOTING DETAILS REFER ONLY TO STABLE FOUNDATION MATERIALS NOT SUBJECT TO LOSS OF STABILITY DUE TO CLIMATIC CONDITIONS.

CONCRETE NOTES:

 ALL WORKMANSHIP AND MATERIALS TO BE IN ACCORDANCE WITH "SAA CONCRETE STRUCTURE CODE" AS 3600-2009.

2. CONCRETE QUALITY:

MAX. SIZE AGGREGATE	SLUMP	DESIGN STRENGTH
20mm	80mm	25 MPa
20mm	80mm	25 MPa
20mm	80mm	25 MPa
	AGGREGATE 20mm 20mm	MAX. SIZE SLUMP AGGREGATE 20mm 80mm 20mm 80mm

- ALL READY MIXED CONCRETE IS TO COMPLY WITH AS 1379. NO ADDITIVES TO BE USED WITHOUT APPROVAL.
- 4. PROVIDE BAR SUPPORTS OR SPACERS AT A MAXIMUM SPACING OF 800mm CENTRED TO GIVE THE FOLLOWING CLEAR CONCRETE COVER TO REINFORCEMENT UNLESS NOTED OTHERWISE:

 FOUNDATION BEAMS: 50mm
 SLAB: 20mm TOP AND 30mm BTM.
- ALL CONCRETE SHALL BE COMPACTED BY AN APPROVED IMMERSION TYPE VIBRATOR.
- ALL CONCRETE SHALL BE CURED BY AN APPROVED METHOD FOR A MINIMUM PERIOD OF 7 DAYS IMMEDIATELY AFTER POURING.
- CONDUITS, PIPES ETC MUST NOT BE PLACE IN CONCRET COVER NOR SHALL HOLES OR CHASES BE ALLOWED WITHOUT PRIOR APPROVAL BY THE ENGINEER.
- 8. FIX REINFORCEMENTS AS SHOW ON DRAWINGS.
 THE TYPE AND GRADE IS INDICATED BY A SYMBOL AS SHOWN BELOW
 ON THE DRAWINGS THIS IS FOLLOWED BY A NUMERAL WHICH INDICATES
 THE SIZE IN MILLIMETRES.

N = HOT ROLLED DEFORMED BAR GRADE D500N 500MPa

S = HOT ROLLED RIBBED BAR D250N

R = PLAIN ROUND BAR GRADE R250N 250MPa

SL = SQUARE MESH 500L 500MPa


RL = RECTANGULAR MESH 500L 500MPa

L = TRENCH MESH 500MPa

ALL REINFORCEMENT IS TO COMPLY WITH AS 4671: 2001

 SPLICES IN REINFORCEMENTS SHALL BE MADE ONLY IN THE POSITIONS SHOWN OR OTHERWISE APPROVED IN WRITING BY THE ENGINEER. LAPS SHALL BE IN ACCORDANCE WITH THE FOLLOWING. LAPS IN REINF. SHALL BE AS SHOWN ON DRAWING. LAP LENGTHS SHALL BE 40 BAR DIA. UNLESS NOTED OTHERWISE.

FABRIC LAPS

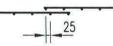

- 10. FOR CONCRETE BEARING, PROVIDE ONE LAYER OF 2-PLY "MALTHOID" MATERIAL BETWEEN CONCRETE AND BRICKWORK. BEFORE PLACING MATERIAL, LEVEL OFF TOP OF BRICKWORK WITH STEEL TROWEL FINISH AND 1:3:12 MORTAR BED OF 10mm MINIMUM THICKNESS.
- 11. ALL BRICKWORK SHALL COMPLY WITH AS 3700.

PIERS:

 IF LOAD BEARING BEAMS ARE BEARING ON NON-STRUCTURAL FILL, THE FOLLOWING PIER ARRANGEMENT SHALL BE USED.

FOR (CLAY STRATUM)

400 DIA. BORED PIERS AT 1800 CTS

FOR (SHALE OR ROCK)

300 DIA. BORED PIERS AT 1800 CTS OR 500x300 BULK PIERS.

BRICKWORK NOTES

- ALL WORKMANSHIP AND MATERIALS SHALL BE IN ACCORDANCE WITH 'AS 3700'.
- 2. ALL BRICKS TO HAVE A MINIMUM COMPRESSIVE STRENGTH OF 20MPa.
- 3. BRICKWORK MORTAR TO BE A MIX 1 CEMENT 1 LIME 4.5 SAND.
- BRICK WALLS TO BE PROVIDED WITH VERTICAL CONTROL JOINTS AT 6 METRE MAX. CTS. (CLASS M) 5 METRE MAX. CTS. (CLASS H).
- ALL CLAY BRICKS SHALL BE EXPOSED TO AMBIENT CONDITIONS FOR MINIMUM OF 3 MONTHS BEFORE USE.
- MAXIMUM 5 YEAR UNRESTRAINED EXPANSION OF CLAY BRICKS SHALL BE 0.8mm PER METRE.
- CLAY BRICKS SHALL NOT BE LAID OVER FLOOR SLAB FOR MINIMUM OF 10 DAYS AFTER CONCRETING THE SLAB.
- 8. ALL BRICKWORK SHALL COMPLY WITH AS/NZS 4455
- BRICKWORK ARTICULATION SHALL BE IN ACCORDANCE WITH THE REQUIREMENTS OF TN61 ARTICULATED WALLING. (CEMENT, CONCRETE AGGREGATE.).
- 10. ALL BRICK WALLS SUPPORTING SLABS AND BEAMS SHALL HAVE 2 LAYERS PLY MALTHOID OR SIMILAR BETWEEN CONCRETE AND BWK. BEFORE PLACING MATERIAL LEVEL OFF TOP OF BRICKWORK WITH STEEL TROWEL FINISH AND A 1:3:12 MORTAR BED OF 10mm THICKNESS.
- 11. NON LOAD BEARING WALLS SHALL BE SEPARATED FROM CONCRETE ABOVE BY 20mm THICK CLOSED CELL POLYETHYLENE STRIP.

STEELWORK NOTES:

- ALL MATERIALS AND WORKMANSHIP SHALL BE OF THE HIGHEST QUALITY AND IN ACCORDANCE WITH 'AS 4100'. IT SHALL ALSO BE TO THE SATISFACTION OF RELEVANT AUTHORITIES AND THE ENGINEER.
- UNLESS NOTED OTHERWISE, ALL STEEL SHALL BE IN ACCORDANCE WITH —

AS 3679 GRADE 300 ROLLED SECTIONS,

AS 1163 GRADE 350 FOR RHS SECTIONS,

AS 1163 GRADE 350 FOR CHS SECTIONS.

- AS 1204 GRADE 350 FOR ALL HIGH STRENGTH STEEL.
- WELDS SHALL BE 6mm CONTINUOUS FILLET WELD (SP), ALL BOLTS 16mm DIAMETER COMMERCIAL GRADE, ALL CLEATS AND GUSSETS 8mm PLATE. UNLESS NOTED OTHERWISE.
- 4. BOLT TYPES SHALL BE AS FOLLOWS -
 - 4.6/S COMMERCIAL BOLTS OF GRADE 4.6 TO 'AS 1111' TIGHTENED TO A SNUG TIGHT FIT.
 - 8.8/S HIGH STRENGTH STRUCTURAL BOLTS OF GRADE 8.8 TO 'AS 1252' TIGHTENED TO A SNUG TIGHT FIT.
 - 8.8/TB HIGH STRENGTH STRUCTURAL BOLTS OF GRADE 8.8 TO
 'AS 1252' FULLY TENSIONED TO 'AS 4100' AS A BEARING
 TYPE JOINT
 - 8.8/TF HIGH STRENGTH STRUCTURAL BOLTS OF GRADE 8.8 TO
 'AS 1252' FULLY TENSIONED TO 'AS 4100' AS A FRICTION
 TYPE JOINT WITH CONTACT SURFACES LEFT UNCOATED.

ALL BOLT HOLES TO BE DRILLED, NO MORE THAN 2mm OVERSIZE U.N.O.

- HIGH STRENGTH TB AND TF BOLTS SHALL BE INSTALLED USING APPROVED LOAD INDICATING WASHERS.
- 6. ALL STEELWORK SHALL BE THOROUGHLY WIRE BRUSHED AND PRIMED WITH RED OXIDE CHROMATE.
- 7. ALL STEEL MEMBERS MUST BE GALVANISED WHEN EXPOSED TO WEATHER
- 8. STEELWORK SHALL BE HANDLED AND STORED BY METHODS AND APPLIANCES THAT WILL NOT OVERSTRESS OR DEFORM IT.
- THE CONTRACTOR SHALL PROVIDE ALL CLEATS AND DRILL ALL HOLES NECESSARY FOR FIXING STEEL TO STEEL AND TIMBER TO STEEL WHETHER OR NOT DETAILED IN THE DRAWINGS.
- WHERE SEALED TUBE MEMBERS ARE TO BE HOT DIPPED GALVANISED, THE FABRICATOR SHALL PROVIDE ALL DRILL HOLES AS NECESSARY.
- 11. THE STRUCTURE SHALL BE MAINTAINED IN A STABLE CONDITION DURING ERECTION. SAFETY REQUIREMENTS, EQUIPMENT AND SCAFFOLDING SHALL MEET THE REQUIREMENTS OF THE REVELANT AUTHORITIES.

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- ALL TRANSPORT AND ERECTION DAMAGE, SITE WELDS ETC. SHALL BE REINSTATED TO AN EQUIVALENT FINISH TO ADJACENT STEELWORK.
- 13. FIXED PLATFORMS, WALKWAYS, STAIRWAYS AND LADDERS TO BE CONSTRUCTED IN ACCORDANCE WITH 'AS 1657-1992.

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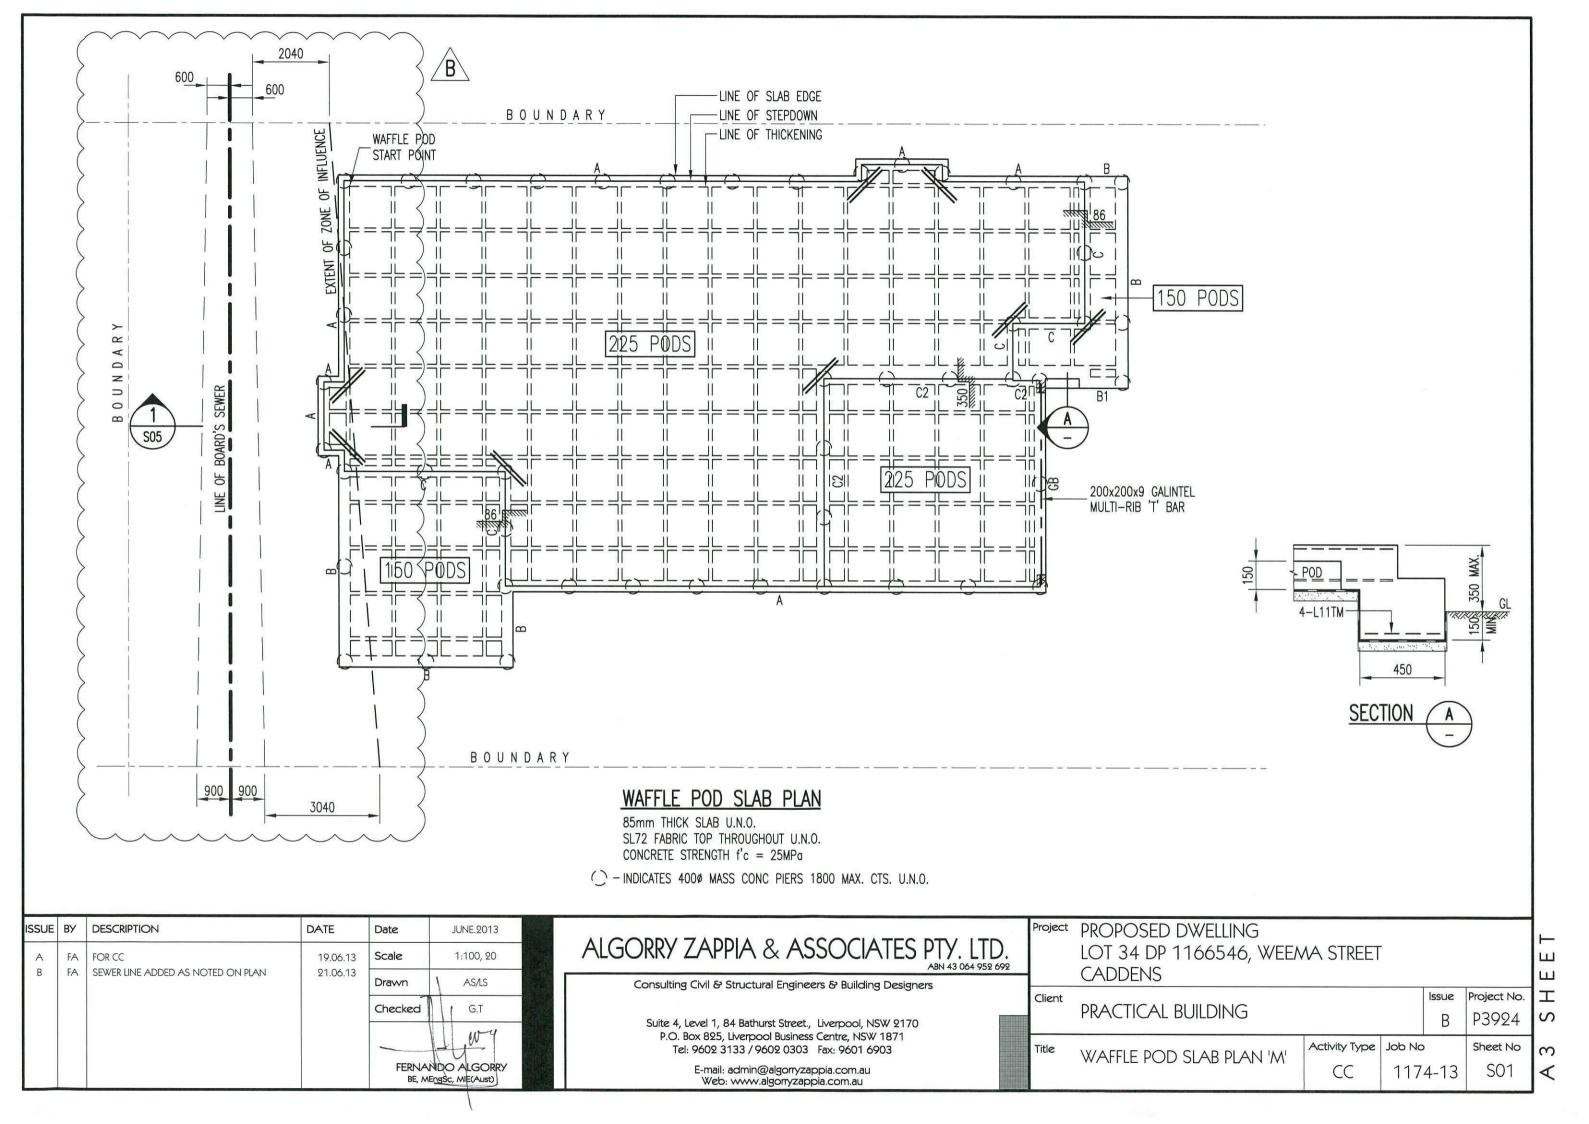
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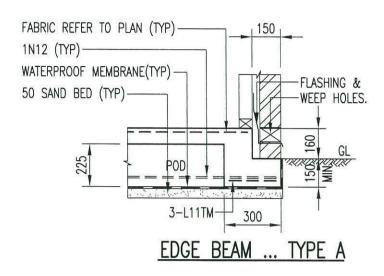
Suite 4, Level 1, 84 Bathurst Street., Liverpool, NSW 2170 P.O. Box 825, Liverpool Business Centre, NSW 1871 Tel: 9602 3133 / 9602 0303 Fax: 9601 6903


> E-mail: admin@algorryzappia.com.au Web: www.algorryzappia.com.au

• 92	Project	PROPOSED DWELLING LOT 34 DP 1166546, WEEMA STREET CADDENS	
	Client	DRACTICAL BLILLDING	

Client	PRACTICAL BUILDING			Issue A	Project No. P3924
Title	GENERAL NOTES 'M'	Activity Type CC	AND DOUBLE DA	4-13	Sheet No





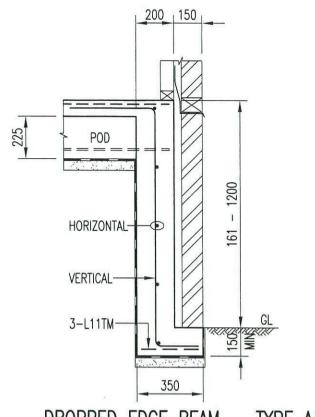



DROPPED EDGE BEAM ... TYPE A1

N12-400 450 LG. __POD 800 N12-300-3-L11TM-300

DROPPED EDGE BEAM REINFORCEMENT

DROPPED EDGE BEAM DEPTH	BEAM REINFORCEMENT
161 - 400mm	R10-400 VERTICAL, 1N12 HORIZONTAL
401 - 800mm	N12-400 VERTICAL, N12-300 HORIZONTAL
801 - 1200mm	N12-300 VERTICAL, N12-300 HORIZONTAL

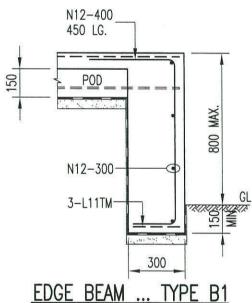

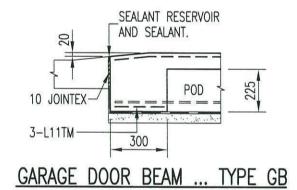

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EDGE BEAM ... TYPE B

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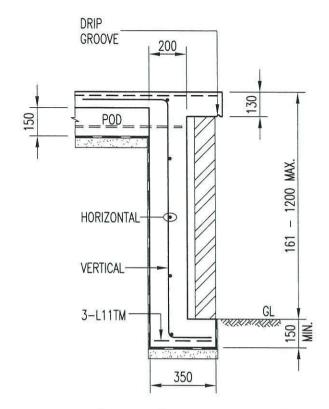
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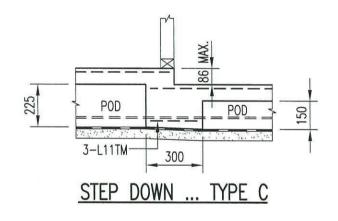
Project	PROPOSED DWELLING
	LOT 34 DP 1166546, WEEMA STREET
	CADDENS

Client	PRACTICAL BUILDING		Issue A	Project No. P3924
Title	WAFFLE POD DETAILS 'M'	Activity Type CC	4-13	Sheet No SO2

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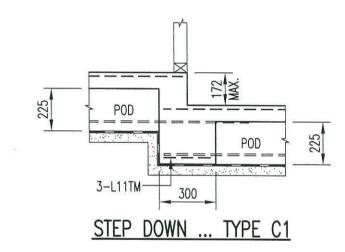


DROPPED EDGE BEAM ... TYPE B2



DROPPED EDGE BEAM REINFORCEMENT

DROPPED EDGE BEAM DEPTH	BEAM REINFORCEMENT
161 – 400mm	R10-400 VERTICAL, 1N12 HORIZONTAL
401 - 800mm	N12-400 VERTICAL, N12-300 HORIZONTAL
801 - 1200mm	N12-300 VERTICAL, N12-300 HORIZONTAL




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Sheet No


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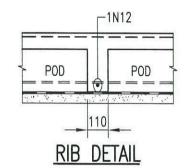
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				Checked	(G.T	Suite 4, Level 1, 84 Bathurst Street., Liverpool, NSW 2170 P.O. Box 825, Liverpool Business Centre, NSW 1871	Client	PRACTICAL BUILDING		A	F
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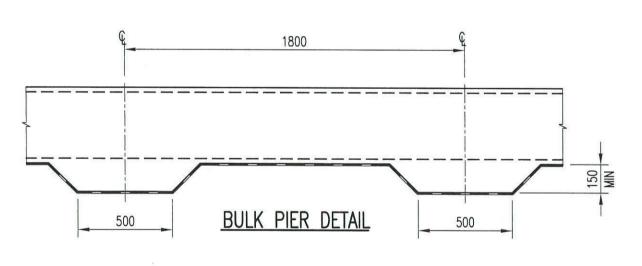



DROPPED STEP BEAM REINFORCEMENT


DROPPED STEP BEAM DEPTH	BEAM REINFORCEMENT
173 - 400mm	R10-400 VERTICAL, 1N12 HORIZONTAL
401 – 800mm	N12-400 VERTICAL, N12-300 HORIZONTAL
801 – 1200mm	N12-300 VERTICAL, N12-300 HORIZONTAL



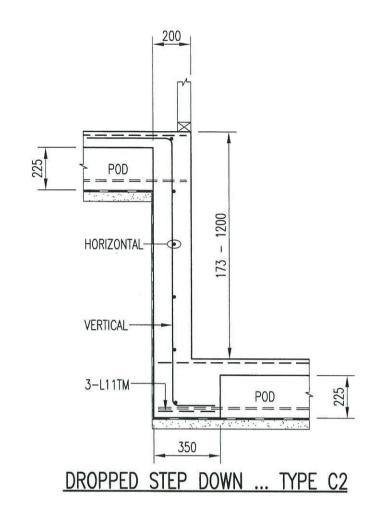

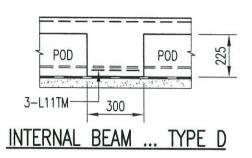

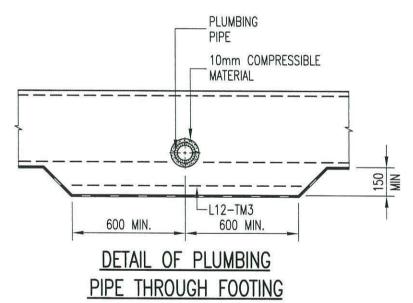

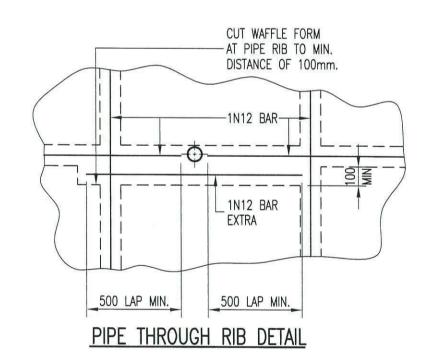

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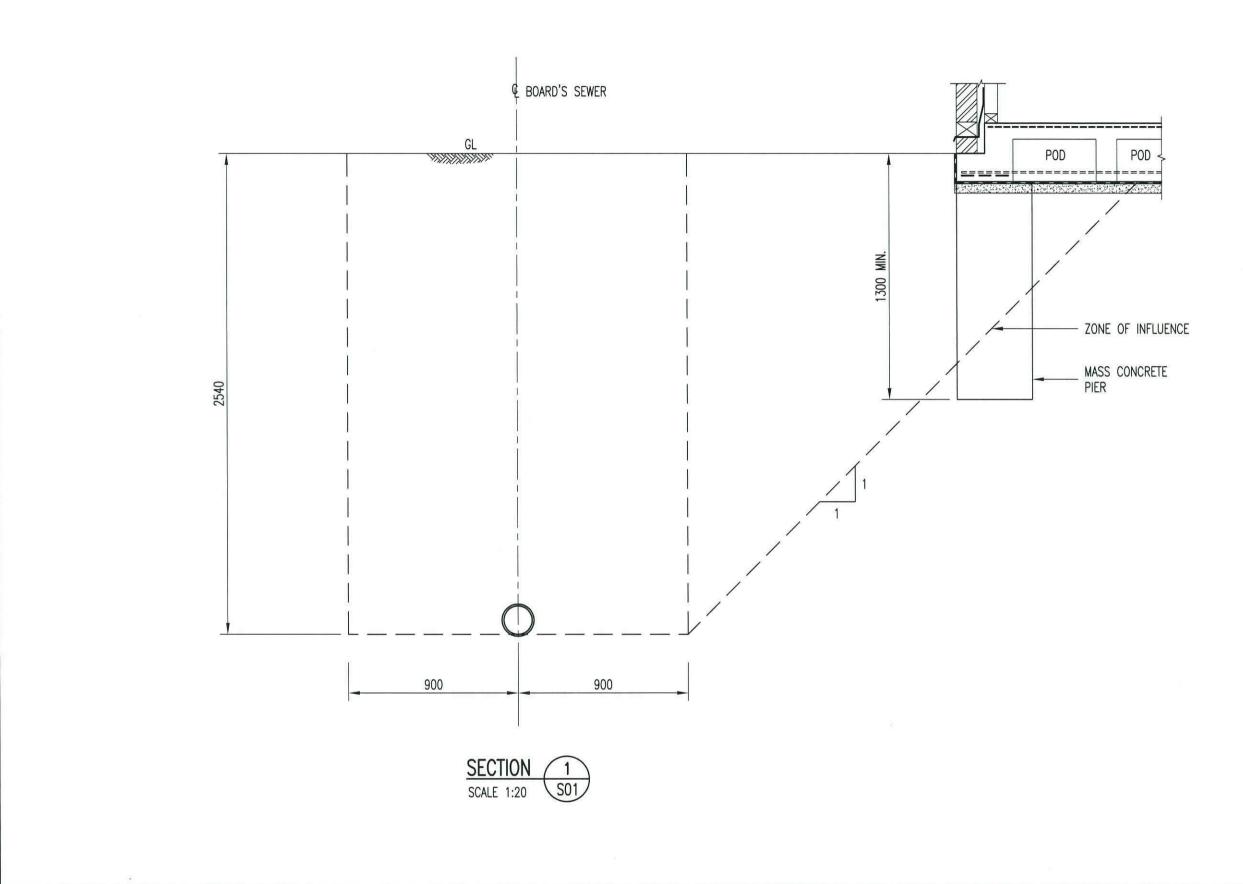
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	Project	PROPOSED DWELLING
		LOT 34 DP 1166546, WEEMA STREET
_		CADDENS

Client	PRACTICAL BUILDING			Issue A	Project No. P3924	U U
Title	WAFFLE POD DETAILS 'M'	Activity Type	Job No)	Sheet No	1
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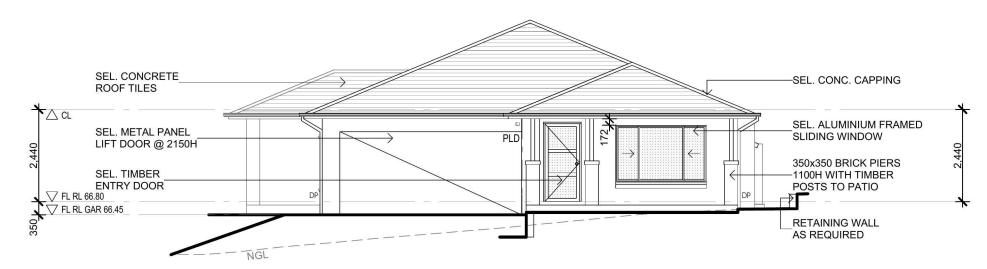
Project	PROPOSED DWELLING
	LOT 34 DP 1166546, WEEMA STREET
	CADDENS

Client				Issue	Project No.]
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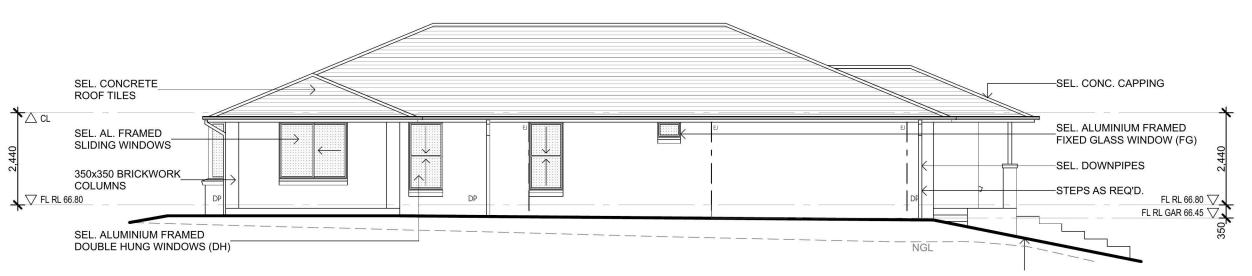
SEWER LINE DETAIL

Activity Type Job No Sheet No CC 1174-13 S05

SHEET




SOUTH ELEVATION




WEST ELEVATION SCALE 1:100

Energy Rating	Certificate Number	14560120
X single-dwelling rating	_	5.0 stars
	heating	59.9 MJ/m ²
	cooling	49.4 MJ/m ²
Recessed downlights confirmation: Rated		thout
Assessor Name/Number Thomas Ruck VIC	/BDAV/12/1456	
Assessor Signature T. Rush	Data	14/02/13

ISS	E BY	DESCRIPTION	DATE	General Notes	Consultants	Date	MAY 2013	ALCORDY 7 ADDIA CO ACCOCIATEC DIVITID	Project PROPOSED DWELLING			
	CZ	FOR DA	31.05.13	 All dimensions and floor areas are to be verified by the Builder Any discrepancies are to be brought to the attention of the designer prior to the commencement of any building work 		Scale	1:100 UNO	ALGORRY ZAPPIA & ASSOCIATES PTY. LTD.	LOT 34 DP 1166546, WEEMA STREET			
				3) Levels shown are approximate unless accompanied by reduced levels. 3) Figured dimensions must be taken in preference to scaling.		Drawn	M. ZAPPIA	Consulting Civil & Structural Engineers & Building Designers	CADDENS			
				 All boundary clearances must be verified by the surveyor prior to the commencement of any building works. 		Checked	C. ZAPPIA		Client PRACTICAL BUILDING		Project No:	
				where engineering calavings are required such must rake preherence to this crawing. Stomwater to be discharged to Councils' requirements and AS 3500.3-1990. Al services to be located and verified by the Builder with relevant authorities before any.		Certified		Suite 4, Level 1, 84 Bathurst Street., Liverpool, NSW 2170	THE REPORT OF THE POPULATION O		P392	4
				building work commences. COPYRIGHT:				Suite 4, Level 1, 84 Bathurst Street, Liverpool, NSW 9170 P.O. Box 825, Liverpool Business Centre, NSW 1871 Tel: 9602 3133 / 9602 0303 Fax: 9601 6903	Title ELEVATIONS	Activity Type Job N	No: Sheet No: I	issue:
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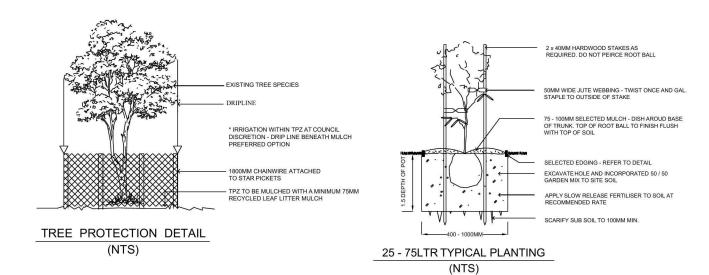
NORTH ELEVATION

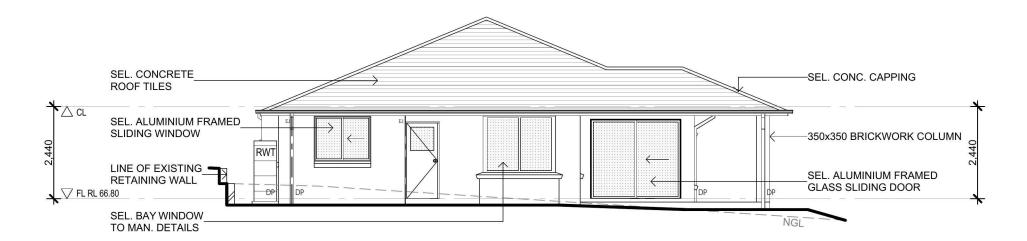


EAST ELEVATION SCALE 1:100

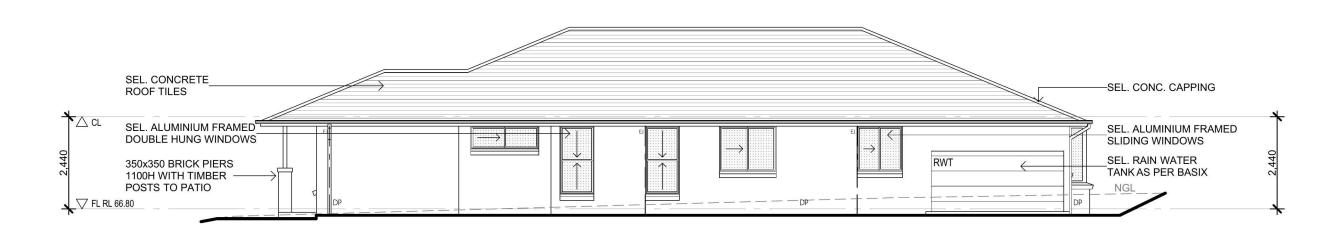


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	C	Z FOR DA	31.05.13	All dimensions and floor areas are to be verified by the Bulder Any discrepancies are to be brought to the attention of the designer prior to the commencement of any building work	Scale	1:100 UNO	ALGORRY ZAPPIA & ASSOCIATES PTY. LTD. ANN ALGORRY AND ALGORDON AND AL
				9) Levels shown are approximate unless accompanied by reduced levels. 3) Figured dimensions must be taken in preference to scaling.	Drawn	M. ZAPPIA	Consulting Civil & Structural Engineers & Building Designers CADDENS
				All boundary clearances must be verified by the surveyor prior to the commercement of any building works. Whose commercement of any building works. Whose commercial reductions are not read work with the preference to this day, and the proof of the commercement of the proof of the commercement of the commerceme	Checked	C. ZAPPIA	Client PRACTICAL BUILDING Project No:
				Stomwater degreening care required such mass lake predenence to an scraving. Stomwater to be discharged to Councils' requirements and AS 3500.3-1990. Al services to be located and varified by the Builder with relevant authorities before any.	Certified		PRACTICAL BUILDING P3924
				building work commences. COPYRGHT:			
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SEDIMENT BARRIER (NTS)

(PROVIDE ON ALL DOWN HILL SLOPES - UNLESS STATED OTHERWISE)

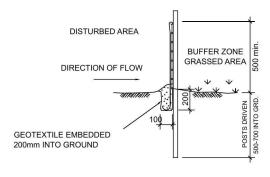



1,370 11,000 Provide Turf as Legend: selected - Decorative Gravel - Hardstand Surface ALFRESCO - Grass Area Provide Turf as Provide Loose Gravel selected as selected PROPOSED DWELLING ADJOINING FL RL 66.80 7 VACANT LOT Lot 34 DOUBLE GARAGE 4,630 FL RL 66.45 Provide Turf as Elaeocarpus Reticulatis selected (Blueberry Ash) BDY LINE WEEMA STREET

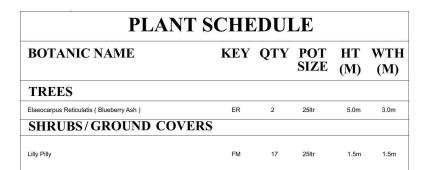Concept Landscaping Plan

scale 1:200

Issue	Amendment	Date	#	North:	Proposed:	Drawing Title:		Revision:
Α	Landscape Plan	08.07.13	RDESTIGN & DRAFTTING		Landscape Plans	L.G.A		A
			RESIDENTIAL DESIGN & DRAFTING SERVICES Phone: (02) 9757 - 4002 Fax: (02) 9757 - 4003 Email: jr.design.drafting@gmail.com		Location: Lot 34 Weema Street Caddens. NSW		th Council	Job No:
			Address: 448 - 452 Victoria Street, Wetherill Park. NSW 2164	Copyright:	Client:	Drawn JR	Date 08.07.2013	1375
			Note: Builder shall check and verify all dimensions prior to the commencement of any work	This plan is the exclusive property of JR Design & Drafting, and must not be used, reproduced or copied wholly in any way without permission	Practical Building	Scale 1:200	Sheet	1070