PROPOSED RESIDENTIAL DWELLING AT 24-30 REYNOLDS ROAD LONDONDERRY, NSW, 2753

GE	NERAL NOTES	LFC	GEND
G1	ALL WORKS SHALL BE IN ACCORDANCE WITH B.C.A AND AS3500.3.		SSURE
G2	ALL EXISTING LEVELS TO BE CONFIRMED BY BUILDER PRIOR TO CONSTRUCTION.	FNE	SSURE
G3	THE BUILDER SHALL ENSURE THAT THE STORMWATER ENGINEERS DRAWINGS CORRESPOND TO THE ARCHITECTURAL, STRUCTURAL, AND LANDSCAPING DRAWINGS. IF THERE EXISTS ANY DISCREPANCIES BETWEEN THE DRAWINGS, THE BUILDER SHALL REPORT THE DISCREPANCIES TO THE ENGINEER PRIOR TO COMMENCEMENT OF ANY WORKS.		VITY PI
G4	PRIOR TO COMMENCING ANY WORKS, THE BUILDER SHALL ENSURE THAT THE INVERT LEVELS OF WHERE THE SITE STORMWATER SYSTEM CONNECTS INTO THE COUNCILS KERB/DRAINAGE SYSTEM MATCHED THE DESIGN LEVELS. ANY DISCREPANCIES SHALL BE REPORTED TO THE DESIGN ENGINEER.	DOWNPIPE	
G5	THE DRAINAGE CONTRACTOR IS TO LOCATE AND RELOCATE AS NECESSARY ALL SERVICES ON SITE.	GRA	
G6	ALL LEVELS SHALL RELATE TO THE ESTABLISHED BENCH MARK. THIS IS TYPICALLY METRES TO AUSTRALIAN HEIGHT DATUM (AHD).	SL: SURFAC	
G7	ALL DOWNPIPES TO BE 100MM DIAMETER UNLESS NOTED OTHERWISE.	CLE	ANING I
G8	ALL DOWN PIPES TO HAVE LEAF GUARDS.		
G9	ALL LINES ARE TO BE 100MM DIAMETER uPVC AT A MINIMUM 1.0% SLOPE UNLESS NOTED OTHERWISE. LINES ARE TO BE SEWER-GRADE AND SEALED.	OVERLAND	
G10	ALL PIPES TO HAVE MINIMUM 150MM COVER IF LOCATED WITHIN PROPERTY.	GRA	
G11	ALL THE CLEANING EYES (OR INSPECTION EYES) FOR THE UNDERGROUND PIPES HAVE TO BE TAKEN UP TO THE FINISHED GROUND LEVEL FOR EASY IDENTIFICATION AND MAINTENANCE PURPOSES.	EXISTING R	
G12	ALL SUB-SOIL DRAINAGE SHALL BE OF A MINIMUM 100MM DIAMETER AND SHALL BE PROVIDED WITH A FILTER SOCK. THE SUBSOIL DRAINAGE SHALL BE INSTALLED IN ACCORDANCE WITH DETAILS TO BE PROVIDED BY THE LANDSCAPE ARCHITECT OR STORMWATER ENGINEER.	DESIGN RL	
G13	ALL RETAINING WALLS SHALL BE CONSTRUCTED COMPLETELY WITHIN THE PROPERTY BOUNDARY LIMITS TO DETAILS PREPARED BY THE STRUCTURAL ENGINEER. WALLS FORMING THE ON-SITE DETENTION SYSTEM SHALL BE OF MASONARY/BRICK/CONCRETE CONSTRUCTION AND WATER TIGHT.	SEI S1	DIMEI PLANS
G14	ALL MULCHING TO BE USED WITHIN THE AREA DESIGNATED AS ON-SITE DETENTION STORAGE SHALL BE OF A NON-FLOTABLE MATERIAL SUCH AS DECORATIVE RIVER GRAVEL. PINE PARK MULCHING SHALL NOT BE USED WITHIN THE DETENTION STORAGE AREA.	S2	SHALL IMMEE OR EA
G15	ALL DRAINAGE WORKS ARE TO AVOID TREE ROOTS. ROOT BARRIER TO BE INSTALLED ADJACENT TO TREE ZONES WHERE DRAINAGE MAY BE AT RISK.		LOCA MEAS THE W
G16	ALL WORK WITHIN COUNCIL RESERVE TO BE INSPECTED BY COUNCIL PRIOR TO CONSTRUCTION.	S3	IMME
G17	COUNCIL'S ISSUED FOOTWAY DESIGN LEVELS TO BE INCORPORATED INTO THE FINISHED LEVELS ONCE ISSUED BY COUNCIL.		OR EA TREES REASO OUTSI RECTI
	INWATER TANKS	S4	PROV
R1	RAINWATER TANK, DRAINED ROOF AREAS AND REUSE PLUMBING TO COMPLY WITH BASIX REQUIREMENTS AND CERTIFICATE.	S5	PROV
R2	ADEQUATE SCREENING TO PREVENT MOSQUITO BREEDING AND ENTRY OF ANIMAL OR FLOATING MATTER.	S6 S7	ADDIT ALTEF
R3	A 'FIRST FLUSH' DIVERSION TO REMOVE ROOF CONTAMINANTS MUST BE PROVIDED.	S8	WASH TRAFF
		S9	NO WO
R4	TANKS TO BE PUMPED TO TOP-UP FROM THE POTABLE WATER SUPPLY DURING DRY PERIOD WHEN THE TANK IS 80% EMPTY.	S10	APPR(THRO
R5	PUMP TO BE SUITABLY SOUNDPROOFED.	S11	IT IS T TO BE
R6	A SIGN IS TO BE INSTALLED NEAR THE RAINWATER TANK HIGHLIGHTING "NOT FOR HUMAN CONSUMPTION".	S12	TO AV THE S

NOTE
DO NOT SCALE OF DRAWINGS. REFER TO
ARCHITECTURAL PLANS FOR LEVELS,
STEPS, DIMENSIONS AND SETOUT. VERIFY
DIMENSIONS ON SITE. THE ENGINEER
SHALL BE NOTIFIED OF ANY VARIATIONS
TO THAT SHOWN ON STRUCTURAL PLANS
BEFORE COMMENCEMENT OF WORKS

REV

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7

E PIPE (CHARGED LINE)		
PIPE AT MIN. 1% SLOPE U.N.O.		
AT MIN. 1% SLOPE		SEDIMENT FENCE/
E MIN. Ø100 U.N.O.	DP	E
PIT ACE LEVEL LEVEL		
BEYE (INSPECTION EYE)		
D FLOW PATH		ROLL OF NETTING FILLED WITH 50mm TO 75mm GRAVEL
RENCH		C KERB INLET PROTEC
RL	+ RL 26.05 + RL 26.05	
L	+ RL 26.05	

ENT & EROSION CONTROL

NS ARE MINIMUM REQUIREMENTS AND ARE TO BE USED AS A GUIDE ONLY. EXACT MEASURES USED ALL BE DETERMINED ON SITE IN CONJUNCTION WITH PROGRAM OF CONTRACTORS WORKS.

EDIATELY FOLLOWING SETTING OUT OF THE WORKS, BUT PRIOR TO COMMENCEMENT OF ANY CLEARING EARTHWORKS, THE CONTRACTOR AND SUPERINTENDENT SHALL WALK THE SITE TO NOMINATE THE ATIONS AND TYPES OF SEDIMENT AND EROSION CONTROL MEASURE TO BE ADOPTED. THESE ASURES SHALL BE IMPLEMENTED PRIOR TO ANY CLEARING OR EARTHWORKS AND MAINTAINED UNTIL WORKS ARE COMPLETED AND NO LONGER POSE AN EROSION HAZARD, UNLESS OTHERWISE PROVED BY THE SUPERINTENDENT.

EDIATELY FOLLOWING SETTING OUT OF THE WORKS. BUT PRIOR TO COMMENCEMENT OF ANY CLEARING EARTHWORKS, THE CONTRACTOR AND SUPERINTENDENT SHALL WALK THE SITE TO IDENTIFY AND MARK ES WHICH ARE TO BE PRESERVED. NOTWITHSTANDING THE ABOVE. THE CONTRACTOR SHALL TAKE ALL SONABLE PRECAUTIONS TO MINIMISE DISTURBANCE TO EXISTING VEGETATION AND GROUND COVER SIDE THE MINIMUM AREAS REQUIRED TO COMPLETE THE WORKS AND SHALL BE RESPONSIBLE FOR CTIFICATION, AT ITS OWN COST, OF ANY DISTURBANCE BEYOND THOSE AREAS.

VIDE GULLY GRATE INLET SEDIMENT TRAPS AT ALL GULLY PITS.

VIDE SILT FENCING ALONG PROPERTY LINE AS DIRECTED BY SUPERINTENDENT.

DITIONAL CONTROL DEVICES TO BE PLACED WHERE DIRECTED BY THE PRINCIPLE.

ERNATIVE DESIGNS TO BE APPROVED BY SUPERINTENDENT PRIOR TO CONSTRUCTION.

SH DOWN/RUMBLE AREA TO BE CONSTRUCTED WITH PROVISIONS RESTRICTING ALL SILT AND AFFICKED DEBRIS FROM ENTERING THE STORMWATER SYSTEM.

WORK OR STOCKPILING OF MATERIALS TO BE PLACED OUTSIDE OF SITE WORK BOUNDARY.

PROPRIATE EROSION AND SEDIMENT CONTROLS TO BE USED TO PROTECT STOCKPILES AND MAINTAINED ROUGHOUT CONSTRUCTION.


THE CONTRACTORS RESPONSIBILITY TO TAKE DUE CARE OF NATURAL VEGETATION. NO CLEARING IS BE UNDERTAKEN WITHOUT PRIOR APPROVAL FROM THE SUPERINTENDENT.

AVOID DISTURBANCE TO EXISTING TREES. EARTHWORKS WILL BE MODIFIED AS DIRECTED ON SITE BY SUPERINTENDENT.

16/06/2021	UPDATED AS PER COUNCIL RFI	M.Y
24/02/2021	ISSUED FOR DEVELOPMENT APPROVAL	A.E
DATE	DESCRIPTION	BY

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SEDIMENT FENCE

- ATTACHMENT BELTS.
- F2 FOLDED.

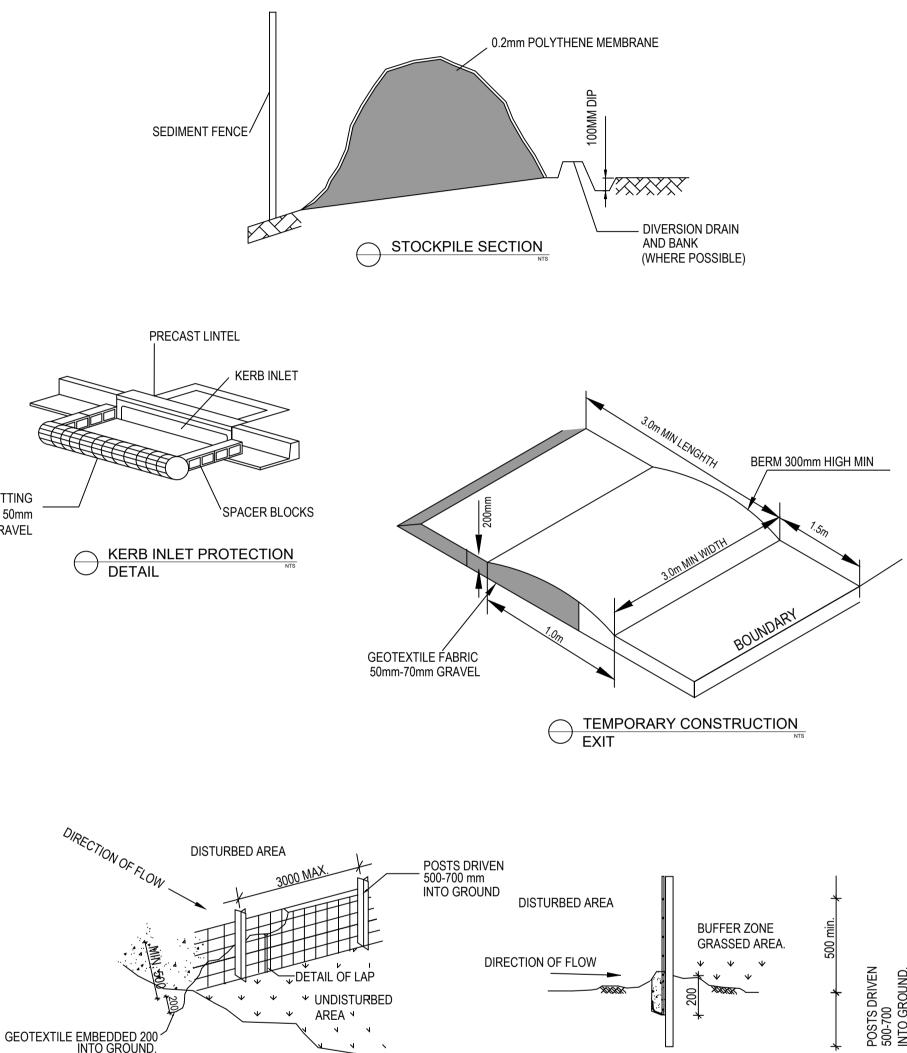PRO AT 24-30 FOR SIG

Norwest, NSW 2153 www.sdsengineering.com.au



SEDIMENT FENCE

F1 FILTER CLOTH TO BE FASTENED SECURELY TO POSTS WITH GALVANISED WIRE TIES, STAPLES OR

WHEN TWO SECTIONS OF FILTER CLOTH ADJOIN EACH OTHER THEY SHALL BE OVERLAPPED BY 150MM AND


F3 POSTS SHALL NOT BE SPACED MORE THAN 3.0 METRES APART.

F4 FOR EXTRA STRENGTH TO SILT FENCE, WOVEN WIRE (14MM GAUGE, 150MM MESH SPACING) TO BE FASTENED SECURELY BETWEEN FILTER CLOTH AND POSTS BY WIRE TIES OR STAPLES

F5 INSPECTIONS SHALL BE PROVIDED ON A REGULAR BASIS, SPECIALLY AFTER RAINFALL AND EXCESSIVE SILT DEPOSITS REMOVED WHEN "BULGES" DEVELOP IN SILT FENCE SEDIMENT FENCES SHALL BE CONSTRUCTED WITH SEDIMENT TRAPS AND EMERGENCY SPILLWAYS AT

SPACINGS NO GREATER THAN 40M ON FLAT TERRAIN DECREASING TO 20M SPACINGS ON STEEP TERRAIN

DREYNOLDS ROAD LONDONDERRY	JOB NUMBER: 20775	DWG NUMBER:	ORIGINAL SIZE:
GNATURE DESIGN AND DRAFTING	DESIGNED BY: A.E	DATE: 24/02/2021	
GENERAL NOTES	DRAWN BY: A.E	SCALE: AS SHOWN	

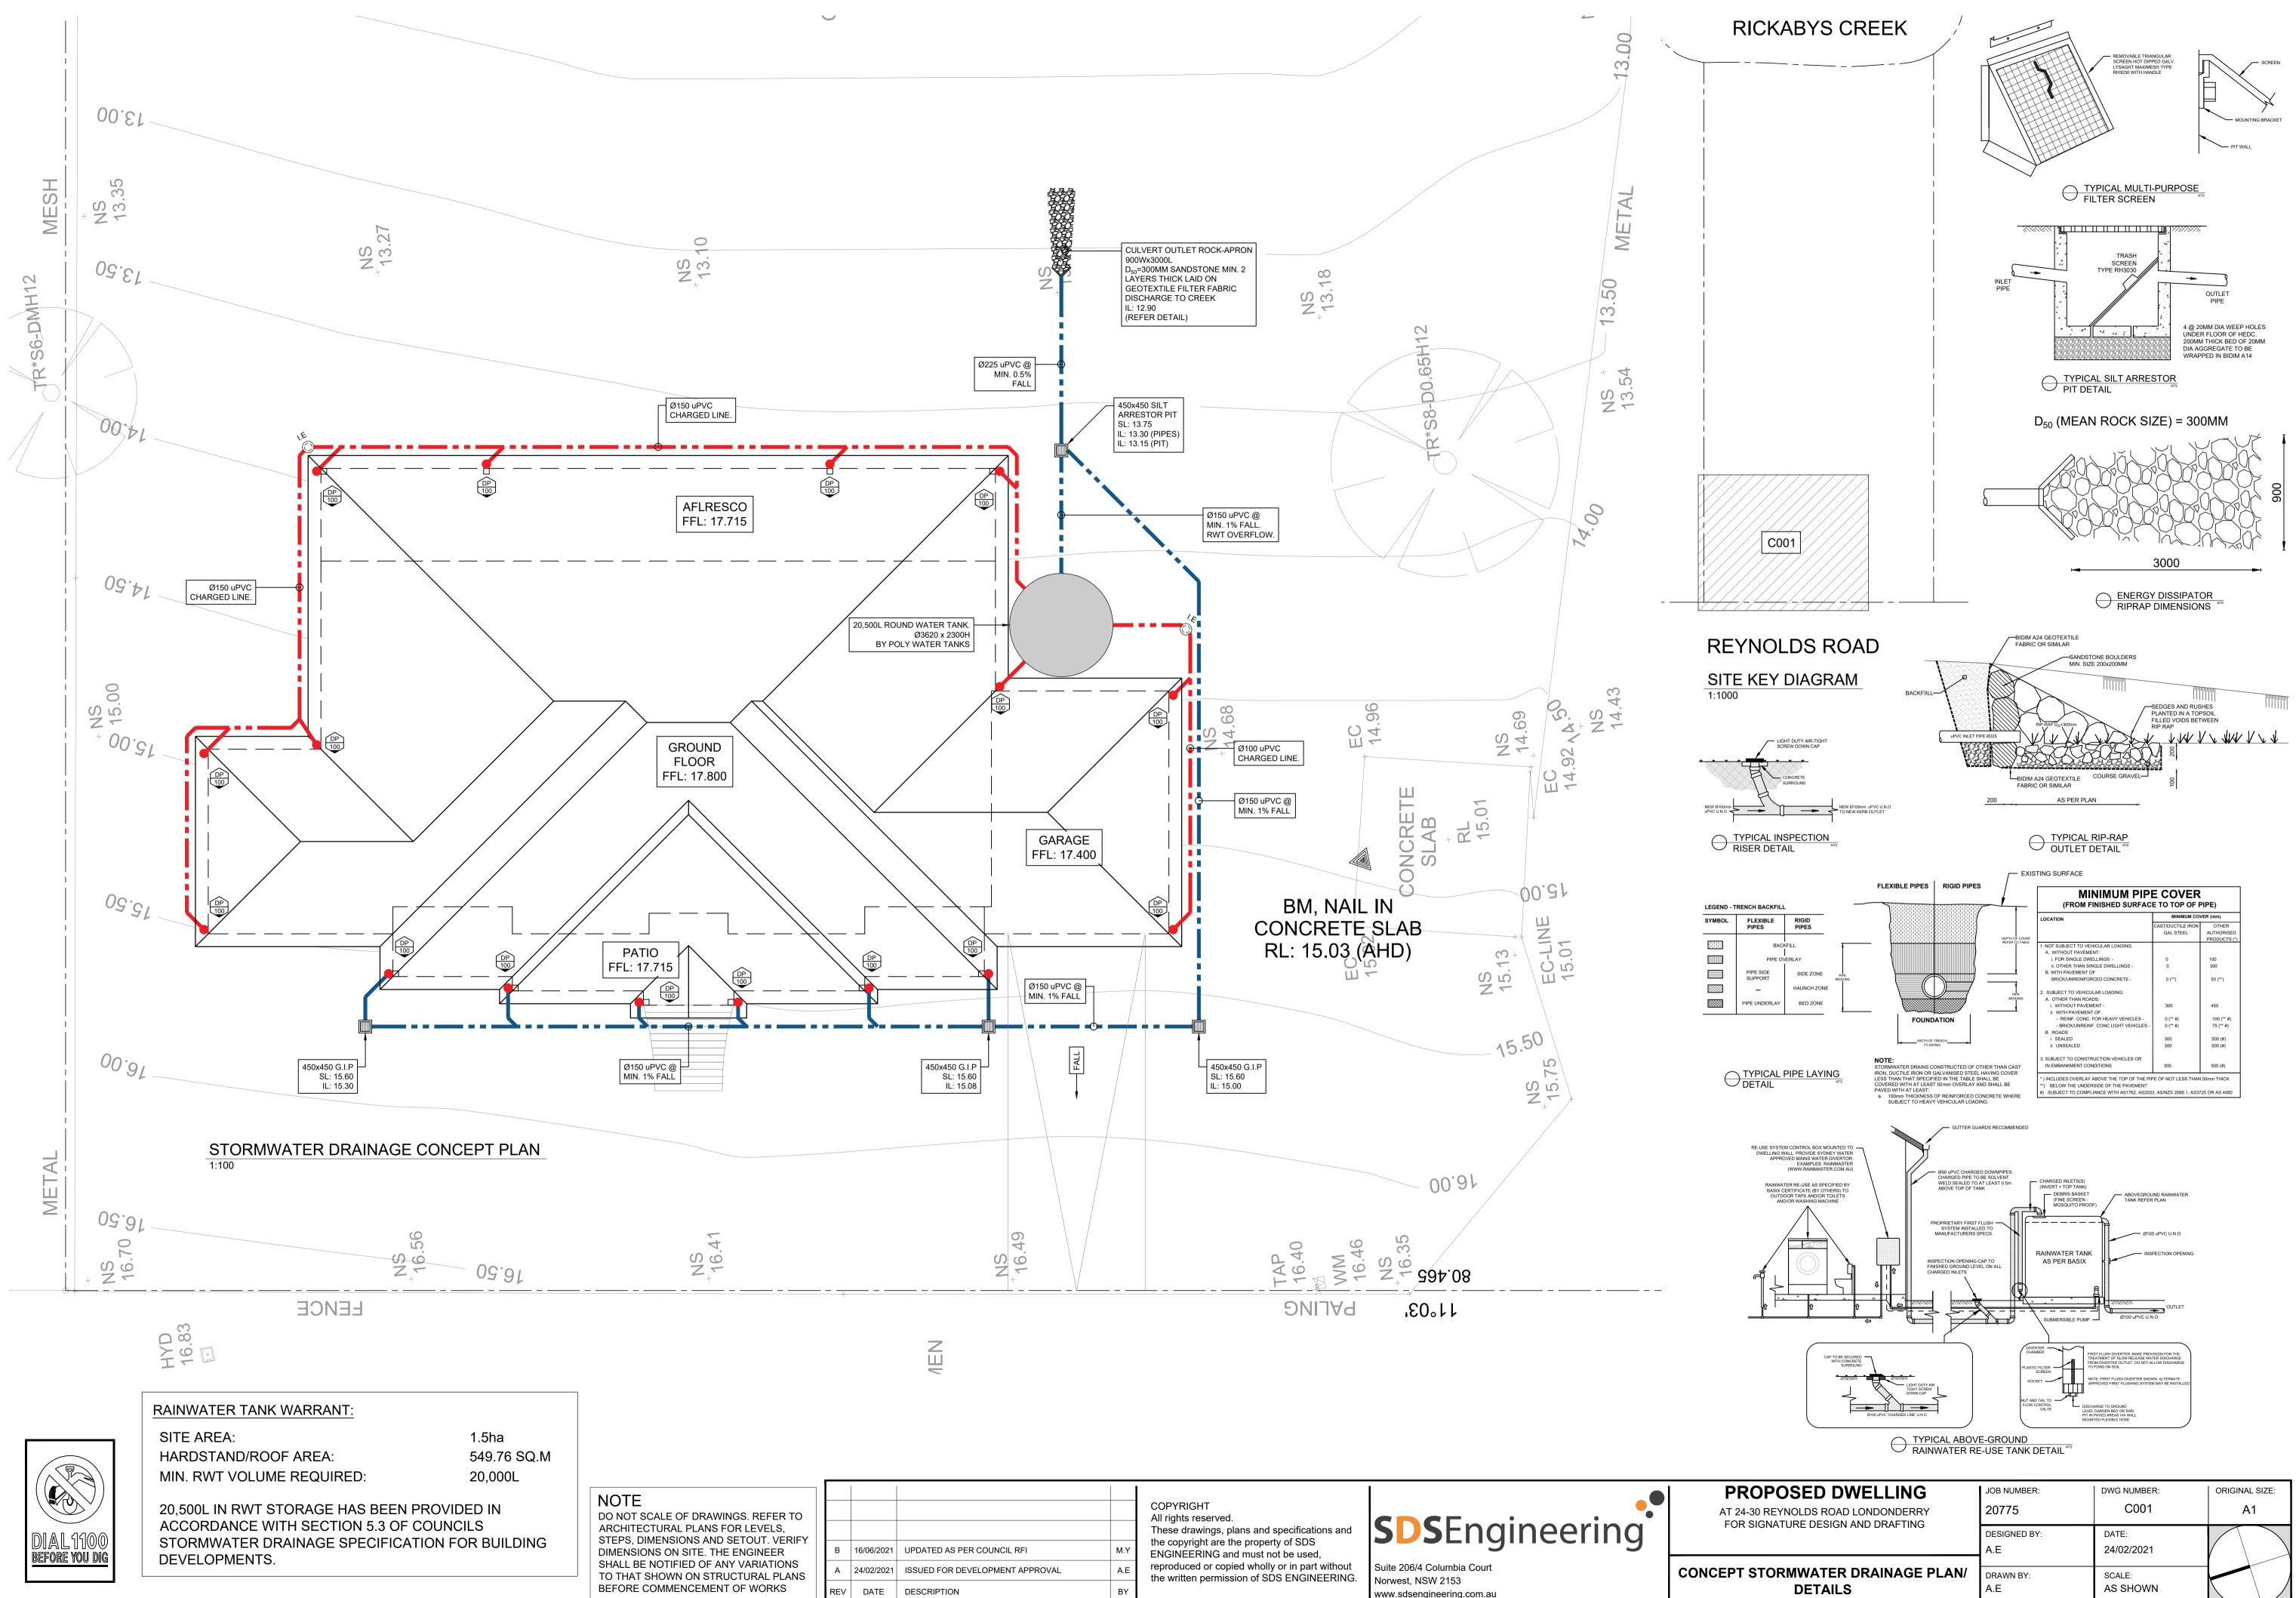

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24/02/2021	ISSUED FOR DEVELOPMENT APPROVAL	A.E			CONCEPT S
DATE	DESCRIPTION	BY			