

EAST TO WEST AND NORTH TO SOUTH OPEN CHANNEL

Jordan Springs Openspace Development

Landscape Drawings

prepare for



Lend Lease

prepare by



Environmental Partnership

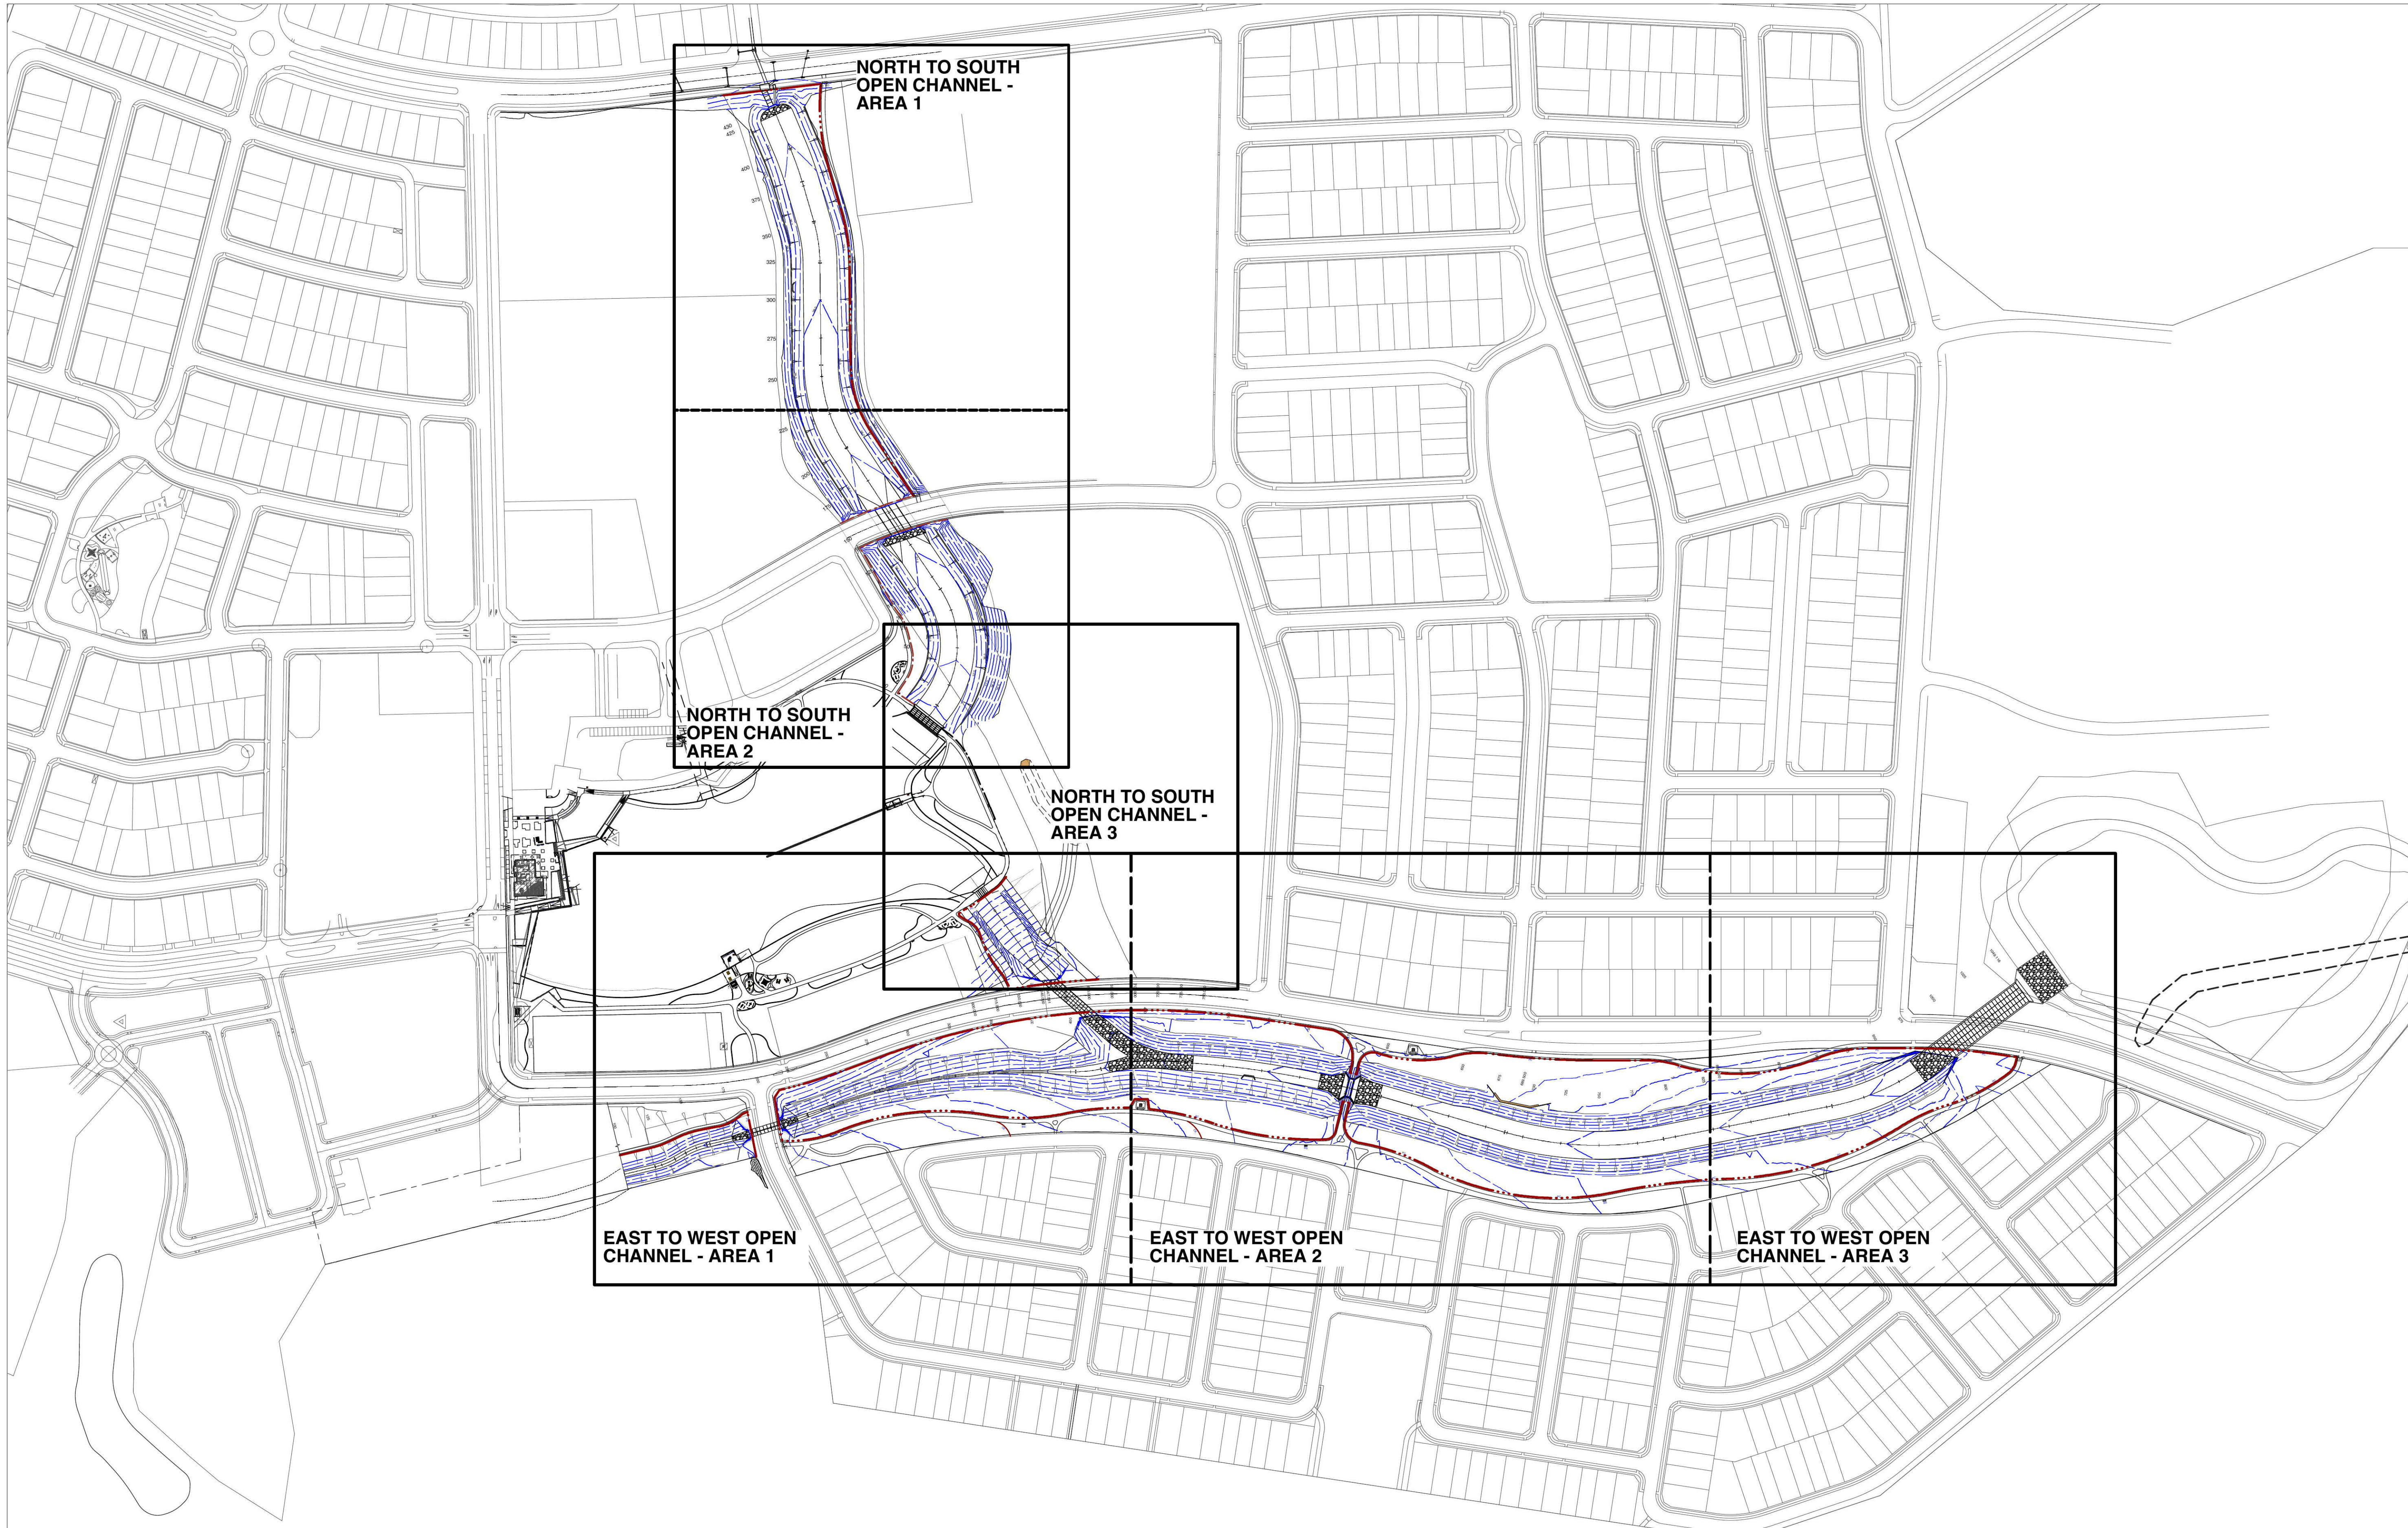
Suite 3.01 22-36 Mountain St Ultimo NSW 2007

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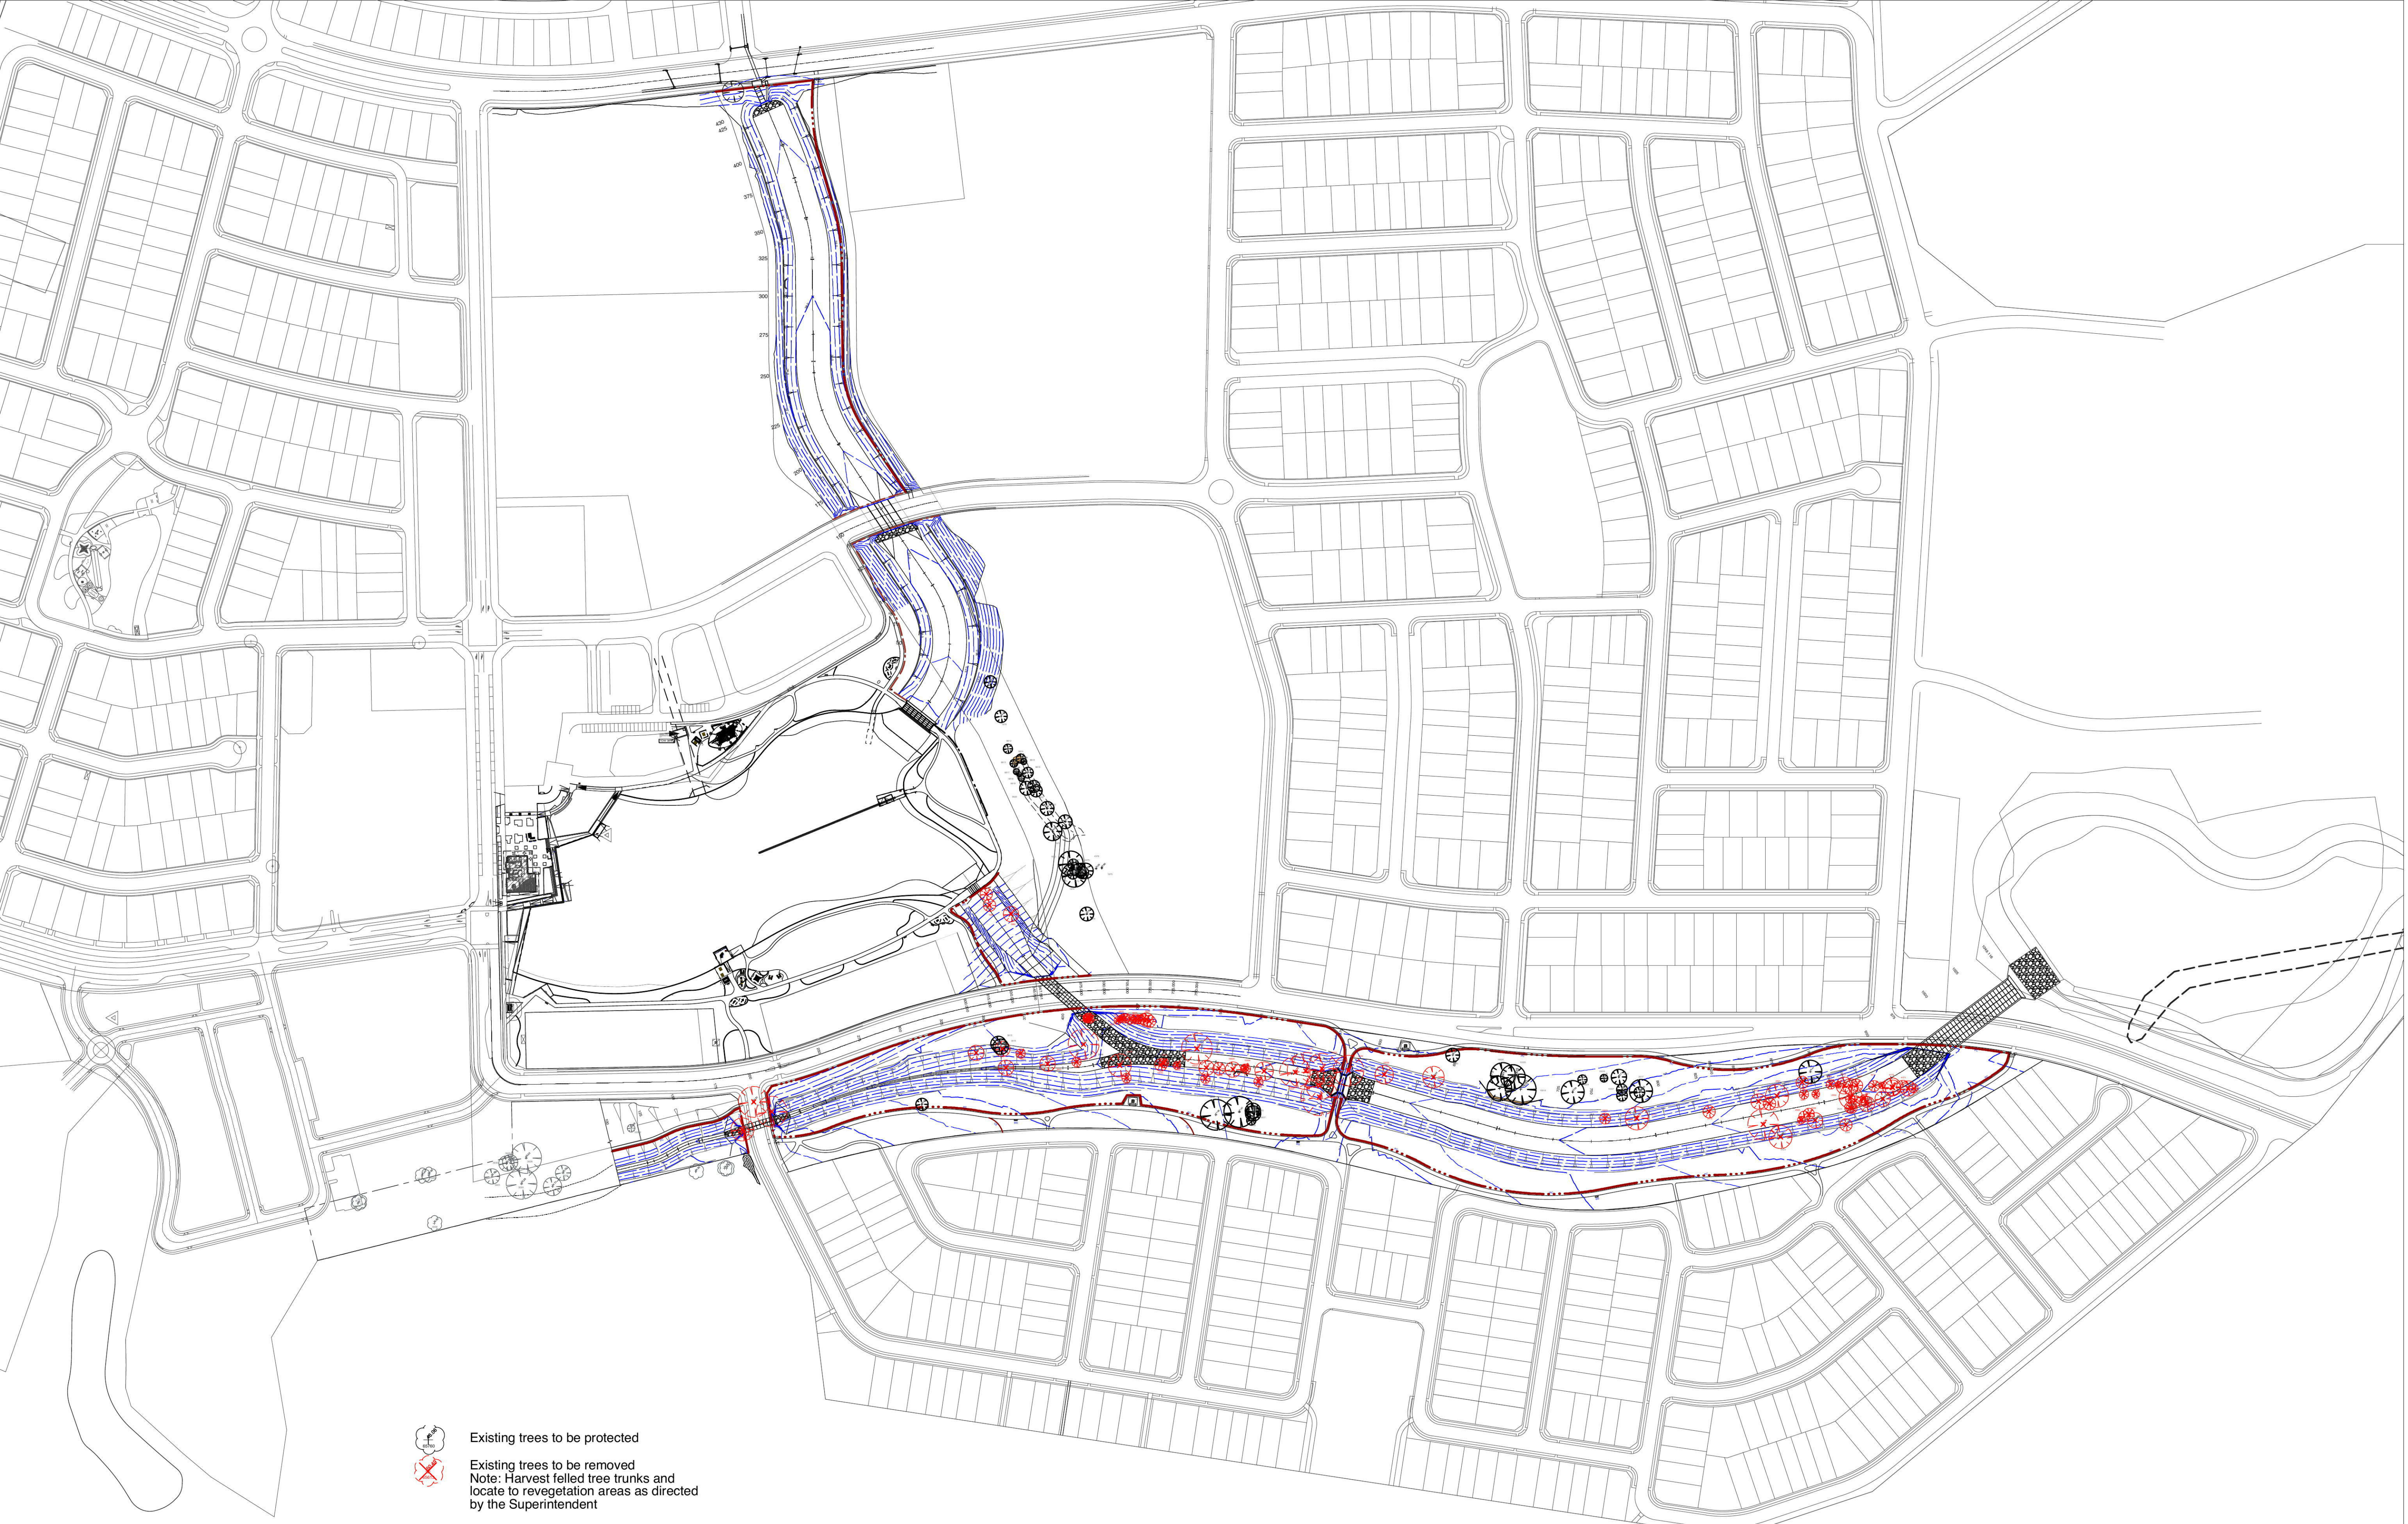
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
DRAWING SCHEDULE		JUNE 14
Drawing	Title	Issue
General		
3306-GE01	Key Plan	D
3306-GE02	Tree Retention and Removal Plan	D
3306-GE03	Legends and Notes	D
East to West Open Channel		
3306-EW01	Construction Works Plan - Area 1	D
3306-EW02	Construction Works Plan - Area 2	D
3306-EW03	Construction Works Plan - Area 3	D
3306-EW04	Planting and Revegetation Plan - Area 1	D
3306-EW05	Planting and Revegetation Plan - Area 2	D
3306-EW06	Planting and Revegetation Plan - Area 3	D
North to South Open Channel		
3306-NS01	Construction Works Plan - Area 1 & 2	D
3306-NS02	Construction Works Plan - Area 3	D
3306-NS03	Planting and Revegetation Plan - Area 1 & 2	D
3306-NS04	Planting and Revegetation Plan - Area 3	D
Landscape Works Details		
3306-D01	Riparian Corridor Details - sheet 1	C
3306-D02	Riparian Corridor Details - sheet 2	C
3306-D03	Riparian Corridor Details - sheet 3	C
3306-D04	Riparian Corridor Details - sheet 4	C
3306-D05	Riparian Corridor Details - sheet 5	C




GENERAL NOTES: 1. Do not scale of drawings. Follow written dimensions. 2. Verify all dimensions on site. 3. Refer to legend for all symbol and code keys. 4. Read in conjunction with the specifications. 5. Read in conjunction with all associated drawings				DESIGNED: EP DATE: FEB 14 APPROVED:		PREPARED FOR:		LANDSCAPE ARCHITECTS AND URBAN DESIGNERS:		PROJECT:		DRAWING TITLE:		DATE:	
				DRAWN: BL DATE: FEB 14 APPROVED:						East to West and North to South Open Channel Jordan Springs Openspace Development		Key Plan		JUNE 2014	
				CHECKED: AH DATE: FEB 14 APPROVED:										SCALE: 1:2000 (@A1)	
														ISSUE: D	
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D C B A				DRAWN: BL DATE: FEB 14 APPROVED:			CHECKED: AH DATE: FEB 14 APPROVED:		SCALE: 1:2000 (@A1)		ISSUE: D		DRAWING NO: 3306.GE02		 	
ISSUE AMENDMENT				DRAWN DATE												
MINOR UPDATES FOR CC FOR CC LIGHTING LOCATIONS ADDED FOR REVIEW				BL 19.06.14 BL 09.04.14 BL 05.03.14 BL 18.02.14												


LEGEND



Generally


Existing trees to be protected


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Note: Harvest felled tree trunks and locate to revegetation areas as directed by the Superintendent


 Spot tree plantings

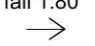
Setout and Levels

Proposed 0.5m design contours
Refer Engineers drawings

 Dimensions in millimetres - setout on site and request approval by Superintendent prior proceeding with works

 Setout coordinates - refer setout schedule GE.03

 Finished levels

 Nominal 1:80 fall to pavement
Note where no fall indicated all pathways to have nominal 1:80 crossfall

Note:

- Existing contours will be supeceded by road (kerbline) design levels along edge of corridor.
- Junction of open space design (proposed) contours with kerbline are based on kerb design levels

Channel Base Zone


- Planted and stabilised channel base ("MaxBio" erosion control matting)


Embankment Zone

- Groundcovers at 6 / m2
- Scattered spot tree planting
- "Jutemaster thick" erosion control matting
- Refer plan labels for plant species


Revegetation Zone


- Groundcovers at 4 / m2
- Scattered spot tree plantings
- Scattered shrubs planting in groups
- Refer plan labels for plant species


 Turfed area - Refer detail 05, drawing D05


 Rock lined area - Refer engineers drawings


Built Elements

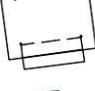
 Proposed shared concrete path - 2.5m wide typically - Refer detail 01, drawing D01
Note grade 1:25 fall maximum


 Proposed concrete path - 1.5m wide typically - Refer detail 01, drawing D01


 Post & cable fencing - refer detail 03, drawing D01


 Concrete edge - refer detail 02, drawing D01


 Rip rap retaining wall
Refer detail 04, drawing D01

 Picnic shelter - Refer detail 04, drawing D02 & detail 01, drawing D03


 Picnic tables - Refer detail 02, drawing D02

 Backed seat on 1.0x2.0m approx. concrete pad - Refer detail 01, drawing D02

 Fixed steel bollards - Refer detail 03, drawing D02

 Removable steel bollards - Refer detail 03, drawing D02

Proposed lighting locations
- Refer Engineers drawings EL00 to EL05

 Extent of works

GENERAL NOTES

- GENERAL**
- Existing survey boxes and marks disturbed during construction shall be replaced to new positions as directed by Superintendent.
 - Do not use vibratory equipment, except for hand held machines, over the subsurface services. It is the Contractor's responsibility to ensure there is no damage to existing services during the works. Replace all materials/ surface damaged to private/ public property. Ensure dated photographs are taken to kerbs and gutters to clearly indicate the existing conditions or any other structures before commencement of construction - supply one set of photographs to The Principal and retain one set on site.
 - The Contractor is to provide temporary silt barriers such as gravel bags/roll, around all stormwater inlet pits to minimise silt and contaminants entering the stormwater lines. During construction the silt traps are to be regularly maintained and any accumulated silt and debris is to be removed from such devices to maintain at least 60% of their capacities.
 - All existing service access pits, inspection pits and valve covers conflicting with finished surface levels are to be raised or lowered. The Contractor is to ensure that these adjustments are undertaken in accordance with engineer's details. Confirm treatment of unknown owner covers with Superintendent prior to undertaking adjustment.
 - Drawings to be read in conjunction with Survey drawings

- SET OUT**
- All dimensions are in millimetres
 - Running measurements may be provided along main setout lines
 - Do not scale off drawings where setout points and dimensions are provided.
 - Setout alignment and levels of all paths, walls and edges for approval by Superintendent prior to commencement of works. If any discrepancy is found or doubt exists between setout and levels as indicated on dwgs and site conditions this shall be referred to the superintendent with adequate notice for provision of advice prior to the continuation of works.
 - Benchmarks will be clearly marked on site by the Contractor. Benchmark shall be maintained by the Contractor during the course of the project
 - All setting out shall be established by the contractor who will be responsible for the accuracy of lines and levels of finished work. If any discrepancy is found or doubt exists between setout and levels as indicated on dwgs and site conditions this shall be referred to the superintendent with adequate notice for provision of advice prior to the continuation of works.
 - Setout of all new tree plantings is to be verified on site by the Superintendent prior to planting.
 - Any setout not approved by the Superintendent may be subject to relocation at the contractors cost.
 - Setout locations of furniture items are to be verified on site by Superintendent prior to the excavation of footings and installation

- LEVELS**
- Setout all levels for construction and approval on site with marker stakes to which levels are notated and clearly marked
 - Adjust all levels as instructed prior to final construction works
 - All falls are to be established as uniform grades between spot heights and contours
 - Paving to be profiled to provide minimum 1:80 fall (unless otherwise noted on plans) for stormwater over land flow.

EROSION AND SEDIMENT CONTROL

- All work shall be generally carried out in accordance with (a) Council specifications and requirements, (b) EPA - Pollution control manual for urban stormwater,
- The contractor shall provide an Erosion and Sediment Control Plan for the works prior to commencement on-site for approval by the superintendent.
- Maintain all erosion and sediment control devices to the satisfaction of the Superintendent and Council.
- When stormwater pits are constructed prevent site runoff entering the pits unless silt fences are erected around pits.
- Minimise the area of site being disturbed at any one time.
- Protect all stockpiles of materials from scour and erosion. Do not stockpile loose material in roadways, near drainage pits or in watercourses.
- All soil and water control measures are to be put back in place at the end of each working day, and modified to best suit site conditions.
- Control water from upstream of the site such that it does not enter the disturbed site.
- All construction vehicles shall enter and exit the site via the designated construction entry / exit.
- All vehicles entering the site shall be cleaned and inspected before leaving.
- Maintain all stormwater pipes and pits clear of debris and sediment. Inspect stormwater system and clean out after each storm event.
- Clean out all erosion and sediment control devices after each storm event.

SEQUENCE OF WORKS

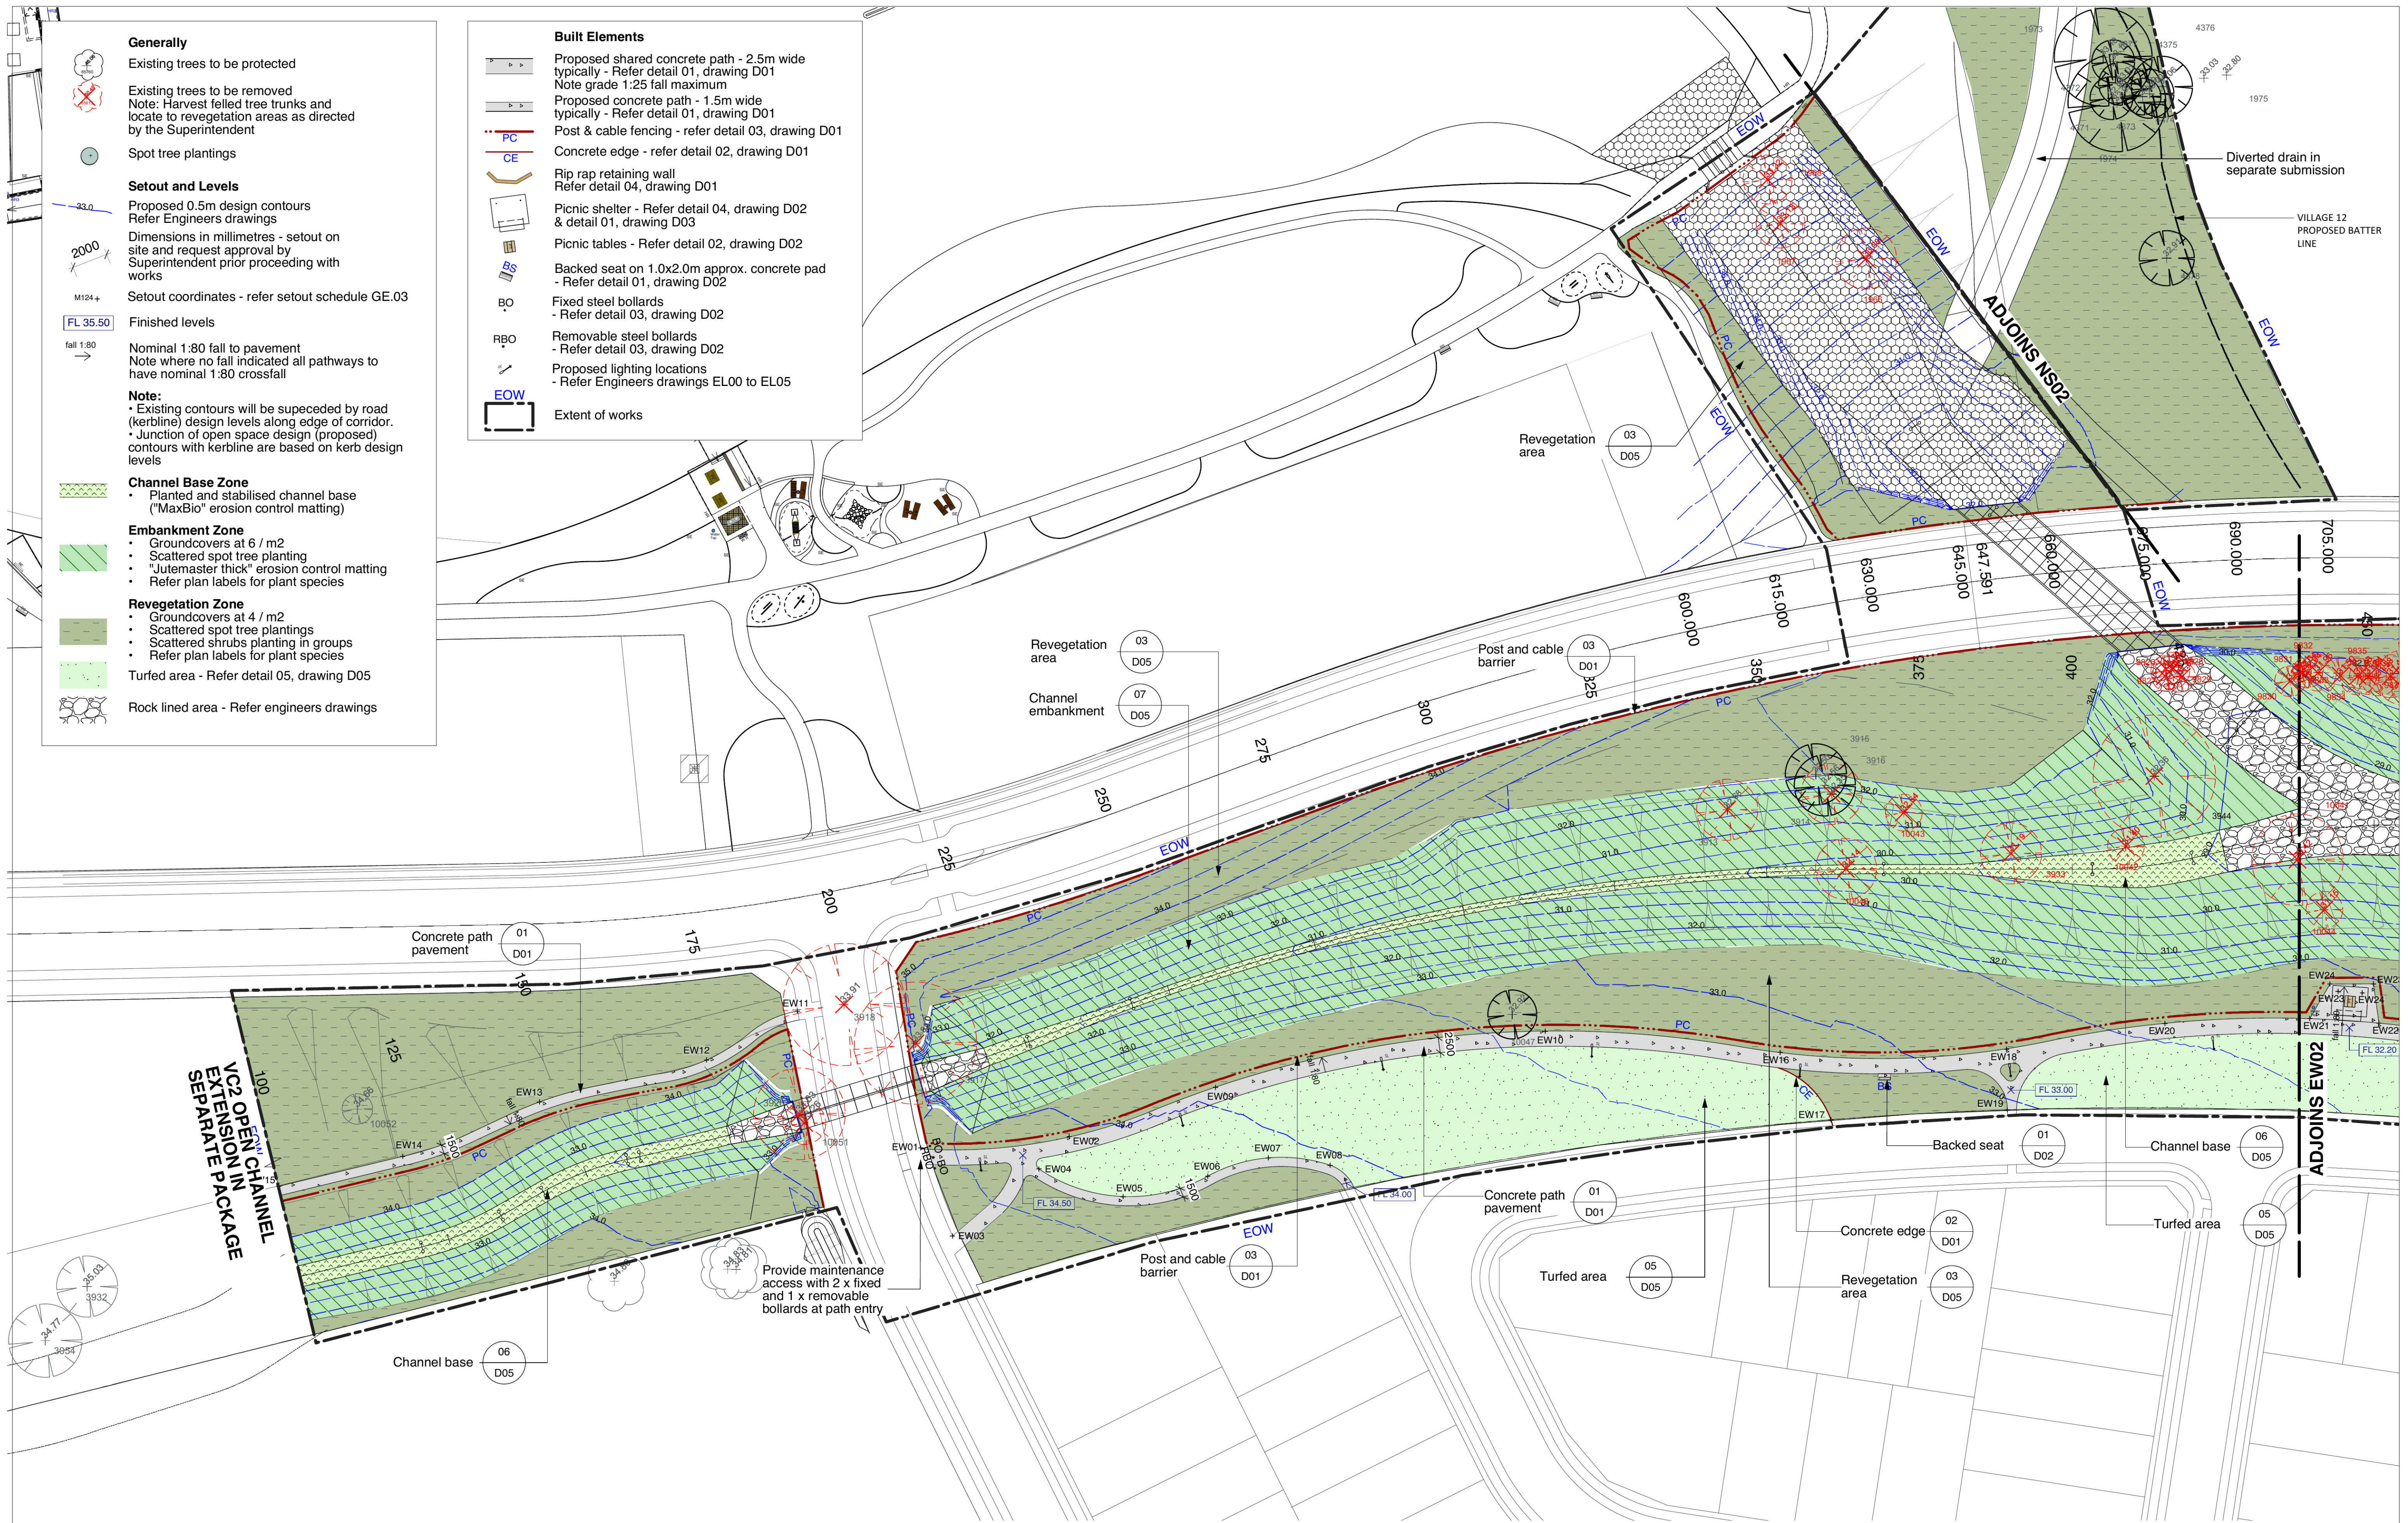
- Prior to commencement of excavation the following soil management devices must be installed.
 - Construct silt fences below the site and across all potential runoff sites.
 - Construct temporary construction entry / exit and divert runoff to suitable control systems
- Construct measures to divert upstream flows into existing stormwater system.
 - Construct sedimentation traps / basins including outlet control and overflow.
 - Construct turf lined swales.
 - Provide sandbag sediment traps upstream of existing pits.
- Construct geotextile filter pit surround around all proposed pits as they are constructed.
- On completion of pavement provide sand bag kerb inlet sediment traps around pits.

DEMOLITION

- Extent of excavations if shown on drawings is indicative only - refer levels, and drainage plans for detailed information.
- Existing items noted for stockpile and removed without breakage shall be stockpiled and transported to the Delfin storage by the Contractor. Damaged items shall be removed from site and disposed of by the Contractor.
- Existing trees to be removed shall be marked on site following approval of setout by superintendent. No trees other than those marked and approved shall be removed or damaged.
- Trees not indicated on the survey or demolition plans shall be retained - seek advise and approval from superintendent prior to removal of any tree not shown on plans.
- Provide protective fencing to all trees to be retained adjoining the works area of the canopy line of these trees. To trees as marked provide timber batten buffer to 1.8m height from base of tree - wire fix on outside for duration of works

Coordinate Marker ID	X Position	Y Position
EW01	289480704	6265549471
EW02	289504992	6265551352
EW03	289485910	6265535107
EW04	289500055	6265546042
EW05	289513794	6265541549
EW06	289527630	6265544860
EW07	289537556	6265547883
EW08	289547625	6265546673
EW09	289528925	6265559400
EW10	289582860	6265568594
EW11	289460558	6265571897
EW12	289445704	6265563893
EW13	289418351	6265557015
EW14	289395991	6265548125
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EW40	289927700	6265521300
EW41	289960851	6265513687
EW42	290001560	6265512840
EW43	290029400	6265517300
EW44	290055828	6265521431
EW45	290093139	6265524499
EW46	290130775	6265528525
EW47	290152754	6265533843
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EW49	290151649	6265527104
EW50	290157651	6265522316
EW51	290159800	6265526600
EW52	290161982	6265534134
EW53	290190775	6265548837
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EW58	290281716	6265596803
EW59	290185300	6265613700
EW60	290168850	6265611931
EW61	290150000	6265605950
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EW66	289927946	6265610541
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EW69	289894800	6265611800
EW70	289888600	6265613100
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EW80	289852185	6265598070
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EW82	289860415	6265607471
EW83	289868435	6265608165
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EW91	290098153	6265575191
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NS06	289527056	6266138798
NS07	289522900	6266156375
NS08	289514300	6266185650
NS09	289510011	6266210106
NS10	289510342	6266238003

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LANDSCAPE ARCHITECTS AND URBAN DESIGNERS:

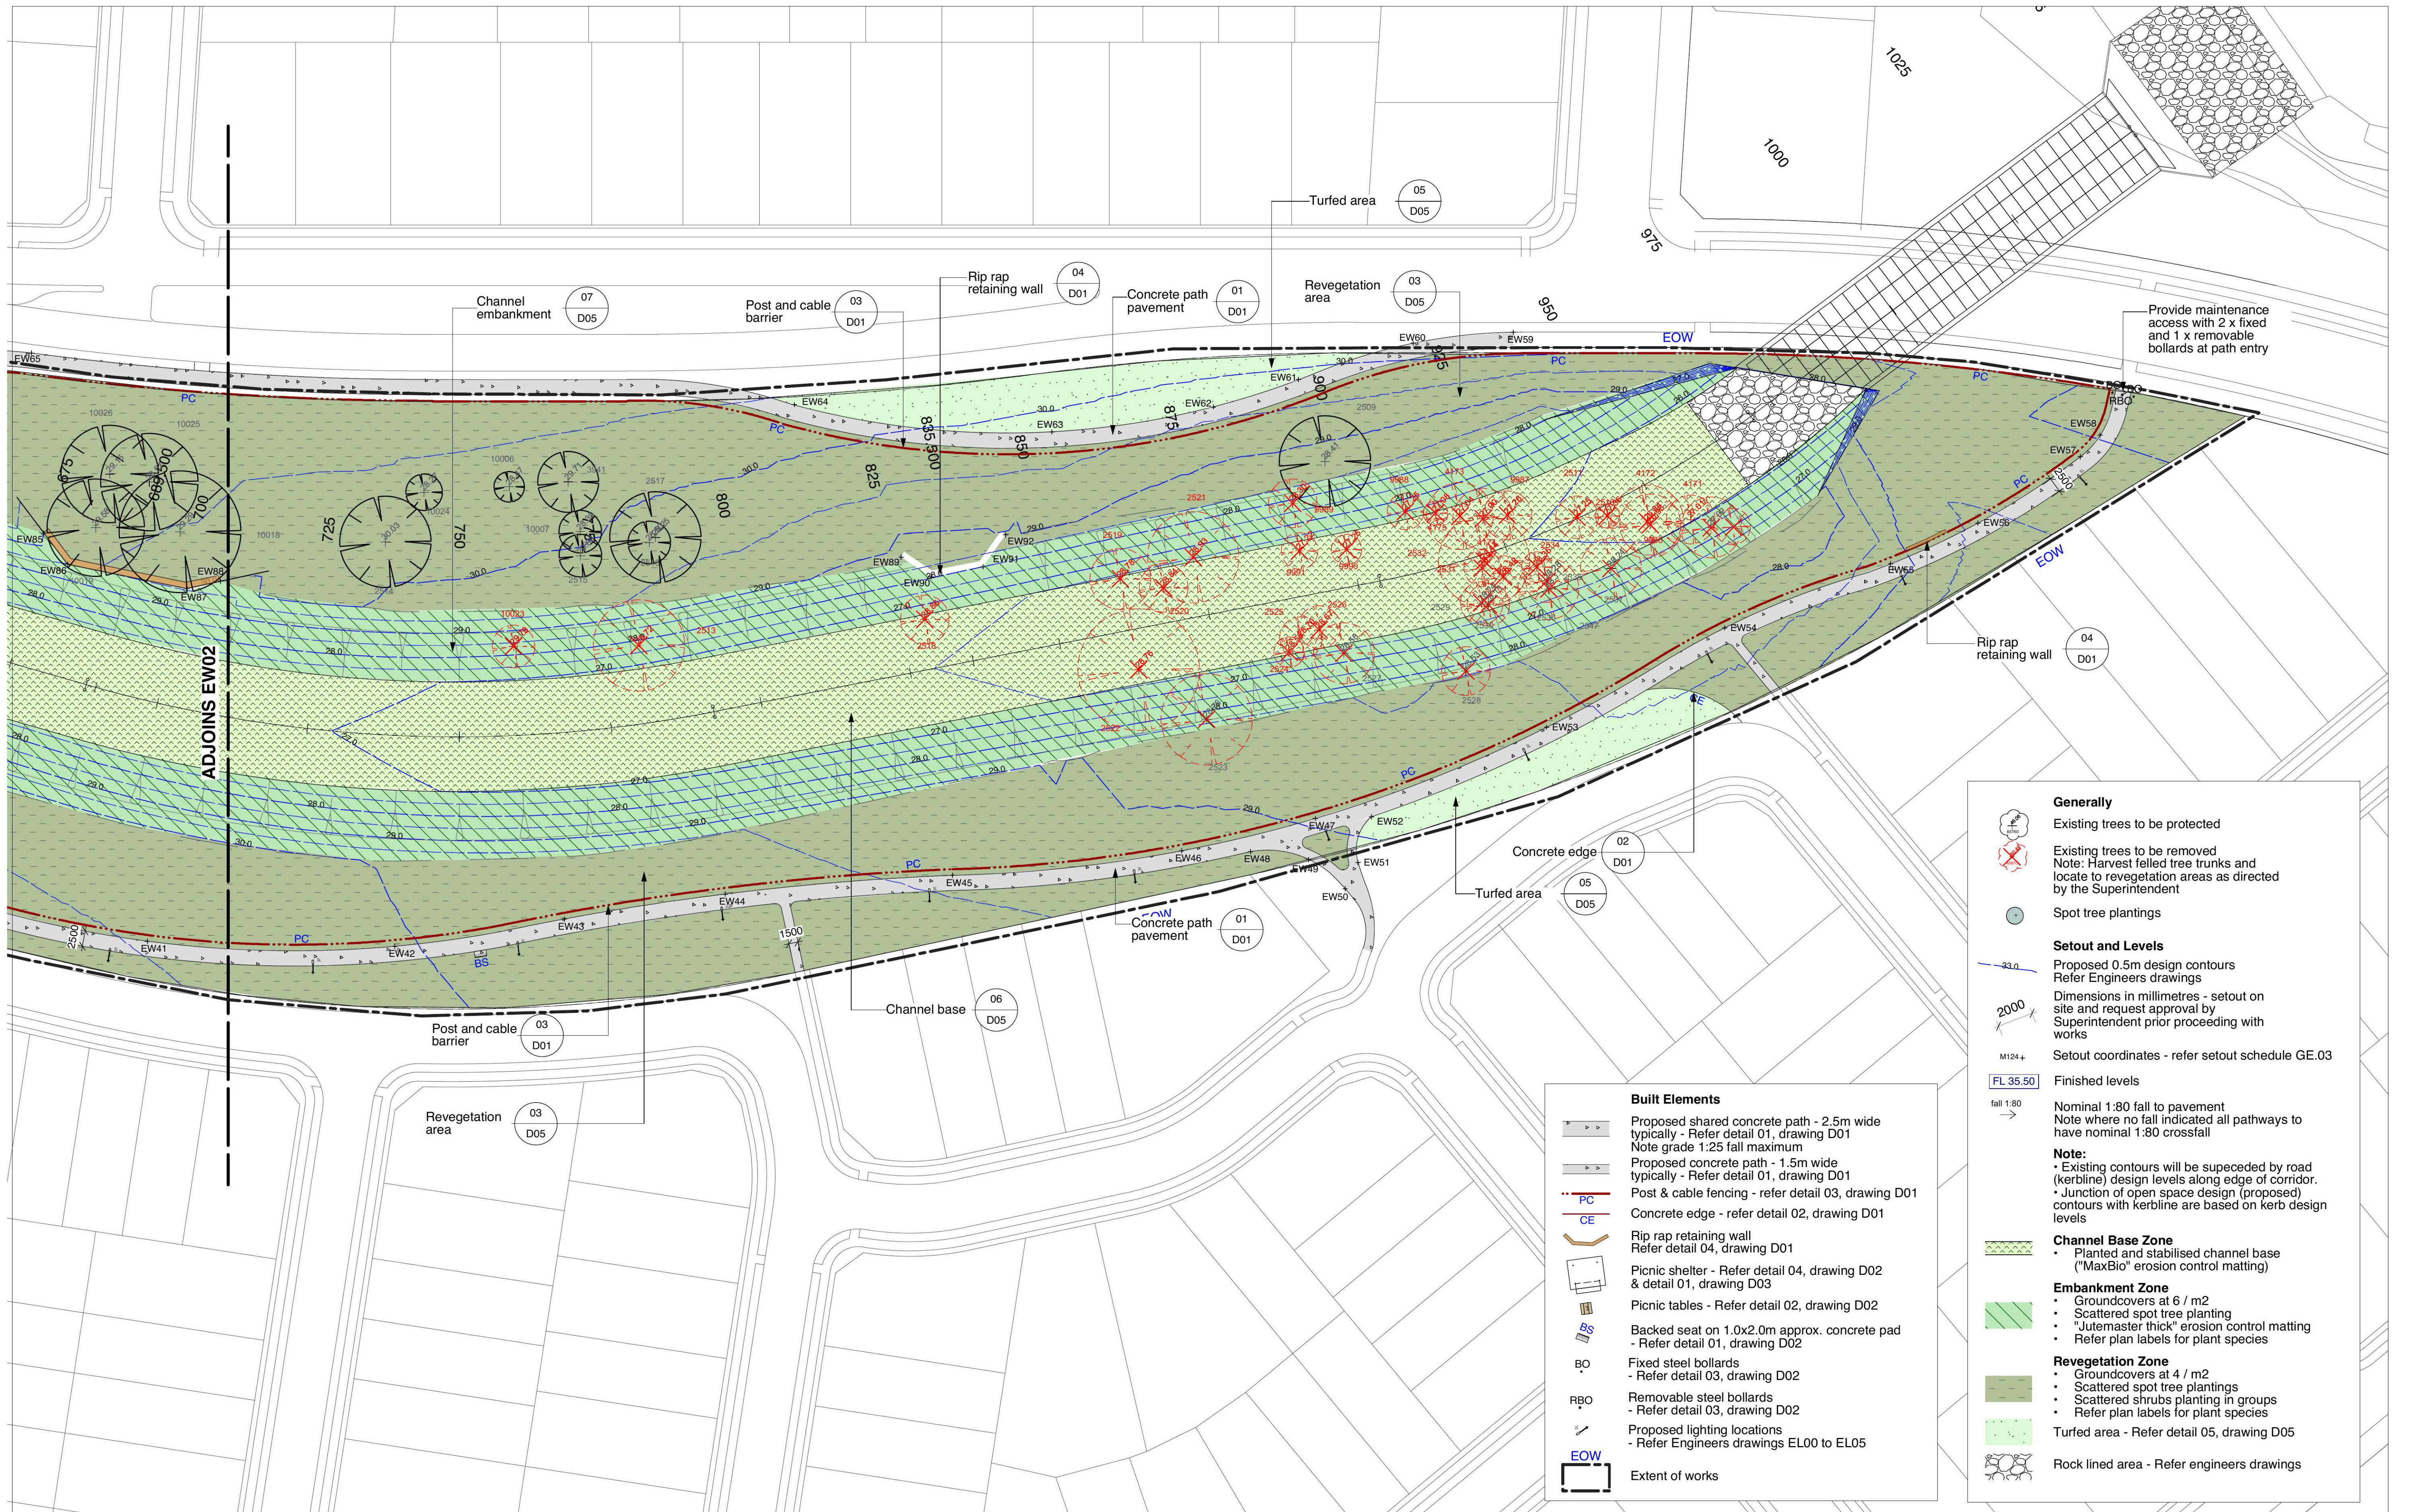
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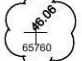
DRAWING TITLE:
**East to West Open Channel
Construction Works Plan - Area 2**

DATE:
JUNE 2014
SCALE:
1:500 (@A1)
ISSUE:
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DRAWING NO:
3306.EW02






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- Planted and stabilised channel base ("MaxBio" erosion control matting)

Embankment Zone

- Groundcovers at 6 / m2
- Scattered spot tree planting
- "Jutemaster thick" erosion control matting
- Refer plan labels for plant species

Revegetation Zone

- Groundcovers at 4 / m2
- Scattered spot tree plantings
- Scattered shrubs planting in groups
- Refer plan labels for plant species

Turfed area - Refer detail 05, drawing D05

Rock lined area - Refer engineers drawings

Built Elements

Proposed shared concrete path - 2.5m wide typically - Refer detail 01, drawing D01

Note grade 1:25 fall maximum

Proposed concrete path - 1.5m wide typically - Refer detail 01, drawing D01

Post & cable fencing - refer detail 03, drawing D01

Concrete edge - refer detail 02, drawing D01

Rip rap retaining wall

Refer detail 04, drawing D01

Picnic shelter - Refer detail 04, drawing D02 & detail 01, drawing D03

Picnic tables - Refer detail 02, drawing D02

Backed seat on 1.0x2.0m approx. concrete pad - Refer detail 01, drawing D02

Fixed steel bollards - Refer detail 03, drawing D02

Removable steel bollards - Refer detail 03, drawing D02

Proposed lighting locations - Refer Engineers drawings EL00 to EL05

Extent of works

Site plan for Area 1 and Area 2, showing proposed paths, contours, and built elements. The plan includes a detailed view of the channel and surrounding areas, with labels for various features such as the channel embankment, channel base, and revegetation area. The plan also shows the extent of works and the location of various built elements.

Labels include: AREA 1, ADJOINS AREA 2 (RIGHT), AREA 2, ADJOINS AREA 1 (LEFT), AREA 3 (NS02), and various elevation points (e.g., 430, 425, 400, 375, 350, 325, 300, 275, 250).











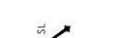

Site plan for Area 2 and Area 3, showing proposed paths, contours, and built elements. The plan includes a detailed view of the channel and surrounding areas, with labels for various features such as the channel embankment, channel base, and revegetation area. The plan also shows the extent of works and the location of various built elements.

Labels include: AREA 2, ADJOINS AREA 1 (LEFT), AREA 3 (NS02), and various elevation points (e.g., 225, 200, 175, 150, 125, 100, 75, 50).

GENERAL NOTES: 1. Do not scale of drawings. Follow written dimensions. 2. Verify all dimensions on site. 3. Refer to legend for all symbol and code keys. 4. Read in conjunction with the specifications. 5. Read in conjunction with all associated drawings				DESIGNED: EP DATE: FEB 14 APPROVED: [Signature] DRAWN: BL DATE: FEB 14 APPROVED: [Signature] CHECKED: AH DATE: FEB 14 APPROVED: [Signature]				PREPARED FOR: Lend Lease LANDSCAPE ARCHITECTS AND URBAN DESIGNERS: Environmental Partnership PROJECT: East to West and North to South Open Channel Jordan Springs Openspace Development DRAWING TITLE: North to South Open Channel Construction Works Plan - Area 1 & 2				DATE: JUNE 2014 SCALE: 1:500 (@A1) ISSUE: D DRAWING NO: 3306.NS01	
D	MINOR UPDATES FOR CC	BL	19.06.14	Lend Lease				Environmental Partnership Suite 3/51 22-36 Mountain St Ultimo NSW 2007 Ph: (02) 9281 7000 Fax: (02) 9281 7222 Email: admin@ep.com.au ABN 53 088 175 437				0 10 20 30 M	
C	FOR CC	BL	09.04.14										
B	LIGHTING LOCATIONS ADDED	BL	05.03.14										
A	FOR REVIEW	BL	18.02.14										
ISSUE	AMENDMENT	DRAWN	DATE										

Document Set ID: 6017577
Version: 1, Version Date: 30/06/2014

Built Elements

	Proposed shared concrete path - 2.5m wide typically - Refer detail 01, drawing D01
	Proposed concrete path - 1.5m wide typically - Refer detail 01, drawing D01
	Post & cable fencing - refer detail 03, drawing D03
	Concrete edge - refer detail 02, drawing D01
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	Extent of works



<div>GENERAL NOTES:</div> <div><div>1. Do not scale of drawings. Follow written dimensions. If in doubt obtain written advice from the Superintendent.</div><div>2. Verify all dimensions on site.</div><div>3. Refer to legend for all symbol and code keys.</div><div>4. Read in conjunction with the specifications.</div><div>5. Read in conjunction with all associated drawings</div></div>				<div>D</div> <div>C</div> <div>B</div> <div>A</div>		<div>MINOR UPDATES FOR CC FOR CC LIGHTING LOCATIONS ADDED FOR REVIEW</div>		<div>BL</div> <div>BL</div> <div>BL</div> <div>BL</div>		<div>19.06.14</div> <div>09.04.14</div> <div>05.03.14</div> <div>18.02.14</div>		<div>DRAWN:</div> <div>BL</div> <div>DATE:</div> <div>FEB 14</div> <div>APPROVED:</div>		<div>CHECKED:</div> <div>DATE:</div> <div>FEB 14</div> <div>APPROVED:</div>		<div>DESIGNED:</div> <div>EP</div> <div>DATE:</div> <div>FEB 14</div> <div>APPROVED:</div>		<div>PREPARED FOR:</div> <div><div><div></div><div>Lend Lease</div></div></div>		<div>LANDSCAPE ARCHITECTS AND URBAN DESIGNERS:</div> <div><div><div></div><div>Environmental Partnership</div><div>Suite 3/01 22-36 Mountain St Ultimo NSW 2007 Ph: (02) 9281 7107 Fax: (02) 9281 7222 Email: admin@epnsw.com.au ABN 53 088 115 437</div></div></div>		<div>PROJECT:</div> <div><div>East to West and North to South Open Channel Jordan Springs Openspace Development</div><div><div><div></div><div>JORDAN SPRINGS</div></div></div></div>				<div>DRAWING TITLE:</div> <div>North to South Open Channel Construction Works Plan - Area 3</div>				<div>DATE:</div> <div>JUNE 2014</div>				<div>SCALE:</div> <div>1:500 (@A1)</div>		<div>ISSUE:</div> <div>D</div>		<div>DRAWING NO:</div> <div>3306.NS02</div>			
<div><div>0102030 M</div><div><div></div><div></div></div></div>																																									

Plant Schedule (North to South Open Channel - Areas 1,2&3)							
ID	Qty	Common Name	Botanical Name	Size	Mature Height	Mature Spread	Spacing
Trees							
TAS	24	Broad Leaved Apple	Angophora subvelutina	5L	15 - 20m	6 - 10m	as shown
TEA	27	Cabbage Gum	Eucalyptus amplifolia	5L	25 - 30m	3.5 - 6m	as shown
TEB	14	Blue Box	Eucalyptus bauerana	5L	25 - 30m	3.5 - 6m	as shown
TWF	10	Weeping Lilly Pilly	Waterhousia floribunda	5L	5 - 6m	3.5 - 6m	as shown
Shrubs							
BS	31	Blackthorn	Bursaria spinosa	150mm	5 - 10m	0.3 - 0.6m	1500mm
CC	113	Scarlet Bottlebrush	Callistemon citrinus	150mm	3 - 5m	2.0 - 3.5m	1500mm
DO	105	Common Hop Bush	Dodonaea triquetra	150mm	1.5 - 3m	1.2 - 2.0m	1500mm
GJ	52	Prickly Grevillea	Grevillea juniperina	150mm	0.6 - 0.75m	2.0 - 3.5m	1500mm
Native Grasses & Ground Covers							
JU	15060	Common Rush	Juncus usitatus	viro tube	0.9 - 1.5m	0.6 - 0.9m	6 per m2
CX	14478	Tall Sedge	Carex appressa	viro tube	0.9 - 1.5m	0.3 - 0.6m	4 /6 per m2
CE	10039	Tall flat segde	Cyperus exalatus	viro tube	0.45 - 0.6m	0.3 - 0.6m	6 per m2
LL	27821	Spiny-headed Mat-Rush	Lomandra longifolia	viro tube	0.75 - 0.9m	0.9 - 1.2m	4 per m2
GS	5019	Ghania	Ghania sieberiana	viro tube	0.75 - 0.9m	0.3 - 0.6m	6 per m2
TA	17782	Kangaroo Grass	Themeda australis	viro tube	0.9 - 1.5m	0.3 - 0.6m	4 per m2
CR	8887	Barbed Wire Grass	Cymbopogon refractus	viro tube	0.6 - 0.75m	0.3 - 0.6m	4 per m2
DA	8887	Long leaved Wallaby Grass	Danthonia longifolia	viro tube	0.9 - 1.5m	0.3 - 0.6m	4 per m2
EE	8887	Lavender Grass	Eragrostis elongata	viro tube	0.3 - 0.45m	0.0 - 0.3m	4 per m2
PL	8887	Tussock Grass	Poa labillardieri	viro tube	0.75 - 0.9m	0.6 - 0.9m	4 per m2
CS	8887	Scented-top Grass	Capillipedium spicigerum	viro tube	0.9 - 1.5m	0.3 - 0.6m	4 per m2
MI	4439	Weeping Grass	Microlaena stipoides	viro tube	0.6 - 0.75m	0.6 - 0.9m	4 per m2



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D
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ISSUE

MINOR UPDATES FOR CC
FOR CC
LIGHTING LOCATIONS ADDED
FOR REVIEW
AMENDMENT

BL
BL
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DRAWN

19.06.14
09.04.14
05.03.14
DATE

DESIGNED:
EP
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FEB 14
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FEB 14

APPROVED:
APPROVED:
APPROVED:

PREPARED FOR:



LANDSCAPE ARCHITECTS AND URBAN DESIGNERS:



PROJECT:

East to West and North to South Open Channel
Jordan Springs Openspace Development



DRAWING TITLE:

North to South Open Channel
Planting Plan - Area 3

DATE:

JUNE 2014

SCALE:

1:500 (@A1)

ISSUE:

D

DRAWING NO:

3306.NS04

