
SILKY PROPERTY GROUP

PROPOSED RESIDENTIAL SUBDIVISION No. 94-100 EXPLORERS WAY, ST. CLAIR

CIVIL ENGINEERING WORKS DRAWINGS

JUNE 2015

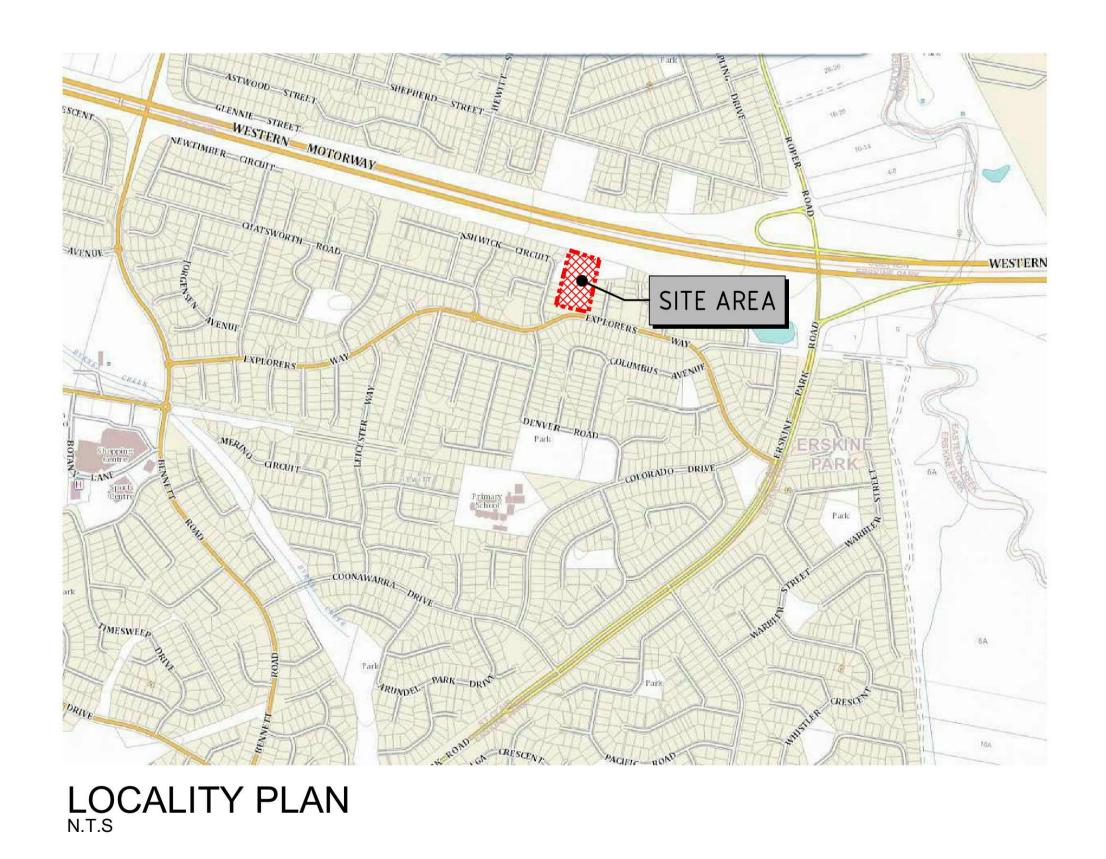

DRAWING LIST FOR DA APPROVAL

DRAWING No.	REV.	DRAWING TITLE
14140-DA00	Α	COVER SHEET, DRAWING LIST AND LOCALITY PLAN
14140-DA01	Α	PLAN OF SUBDIVISION
14140-DA02	Α	BUILDING ENVELOPE & SETBACK PLAN
14140-DA03	Α	ROADWORKS AND STORMWATER DRAINAGE LAYOUT PLAN
14140-DA04	Α	ROAD LONGITUDINAL AND TYPICAL SECTIONS
14140-DA05	Α	SERVICES COORDINATION PLAN
14140-DA06	Α	STORMWATER MANAGEMENT PLAN
14140-DA07	Α	EROSION AND SEDIMENT CONTROL LAYOUT PLAN & DETAILS

opyright © 2014 DIVERSI CONSULTING PTY LTD. THIS DRAWING AND THE INFORMATION IT CONTAINS REMAIN THE PROPERTY OF DIVERSI CONSULTING PTY LTD. THIS DRAWING CANNOT BE COPIED OR REPRODUCED IN ANY FORM OR USED FOR ANY OTHER PURPOSE OTHER THAN THAT ORIGINALLY INTENDED WITHOUT THE PRIOR WRITTEN APPROVAL OF DIVERSI CONSULTING PTY LTD.

NOT FOR CONSTRUCTION DRAWING DIMENSIONS IN MILLIMETRES UNLESS NOTED OTHERWIS

25/05/2015 SUITE 103, 29-31 SOLENT CIRCUIT NORWEST BUSINESS PARK BAULKHAM HILLS, NSW 2153

PROPOSED RESIDENTIAL SUBDIVISION 94-100 EXPLORERS WAY, ST. CLAIR COVER SHEET, DRAWING LIST AND LOCALITY PLAN


F: 02 9659 1800


Document Set ID: 6654728 Version: 1, Version Date: 11/06/2015

5/06/2015 ISSUED FOR DA APPROVAL



Document Set ID: 6654728 Version: 1, Version Date: 11/06/2015

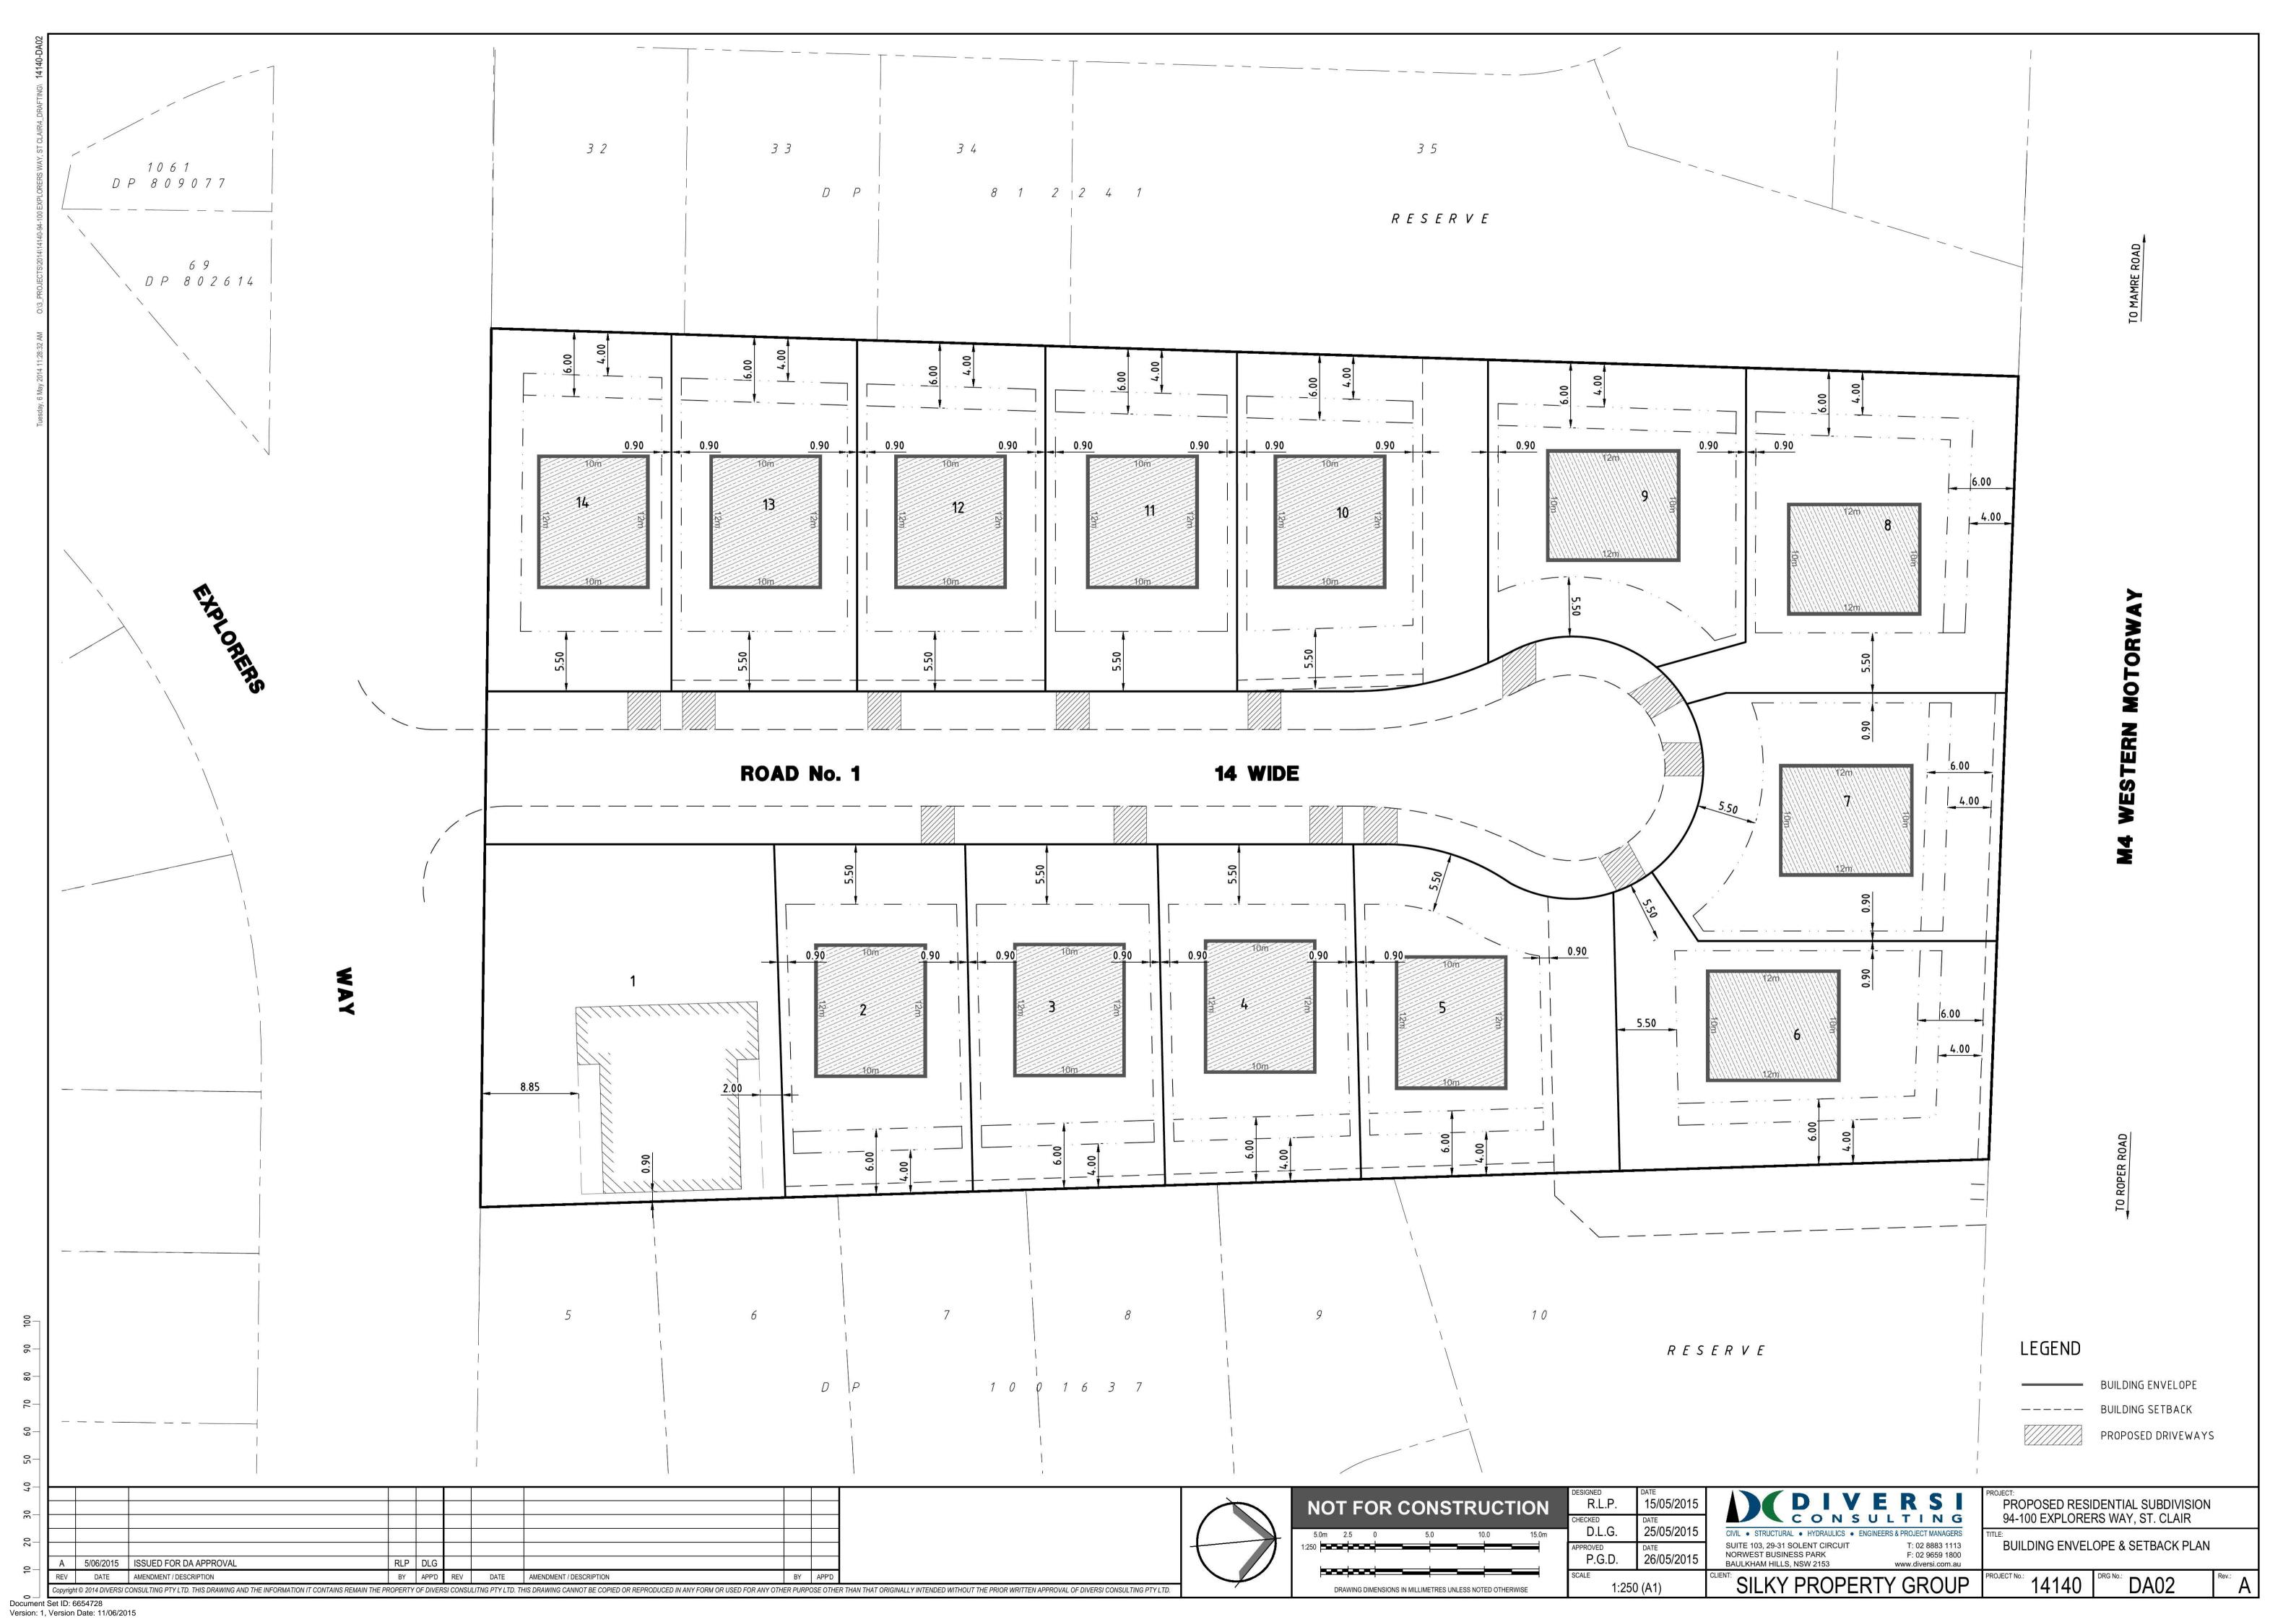

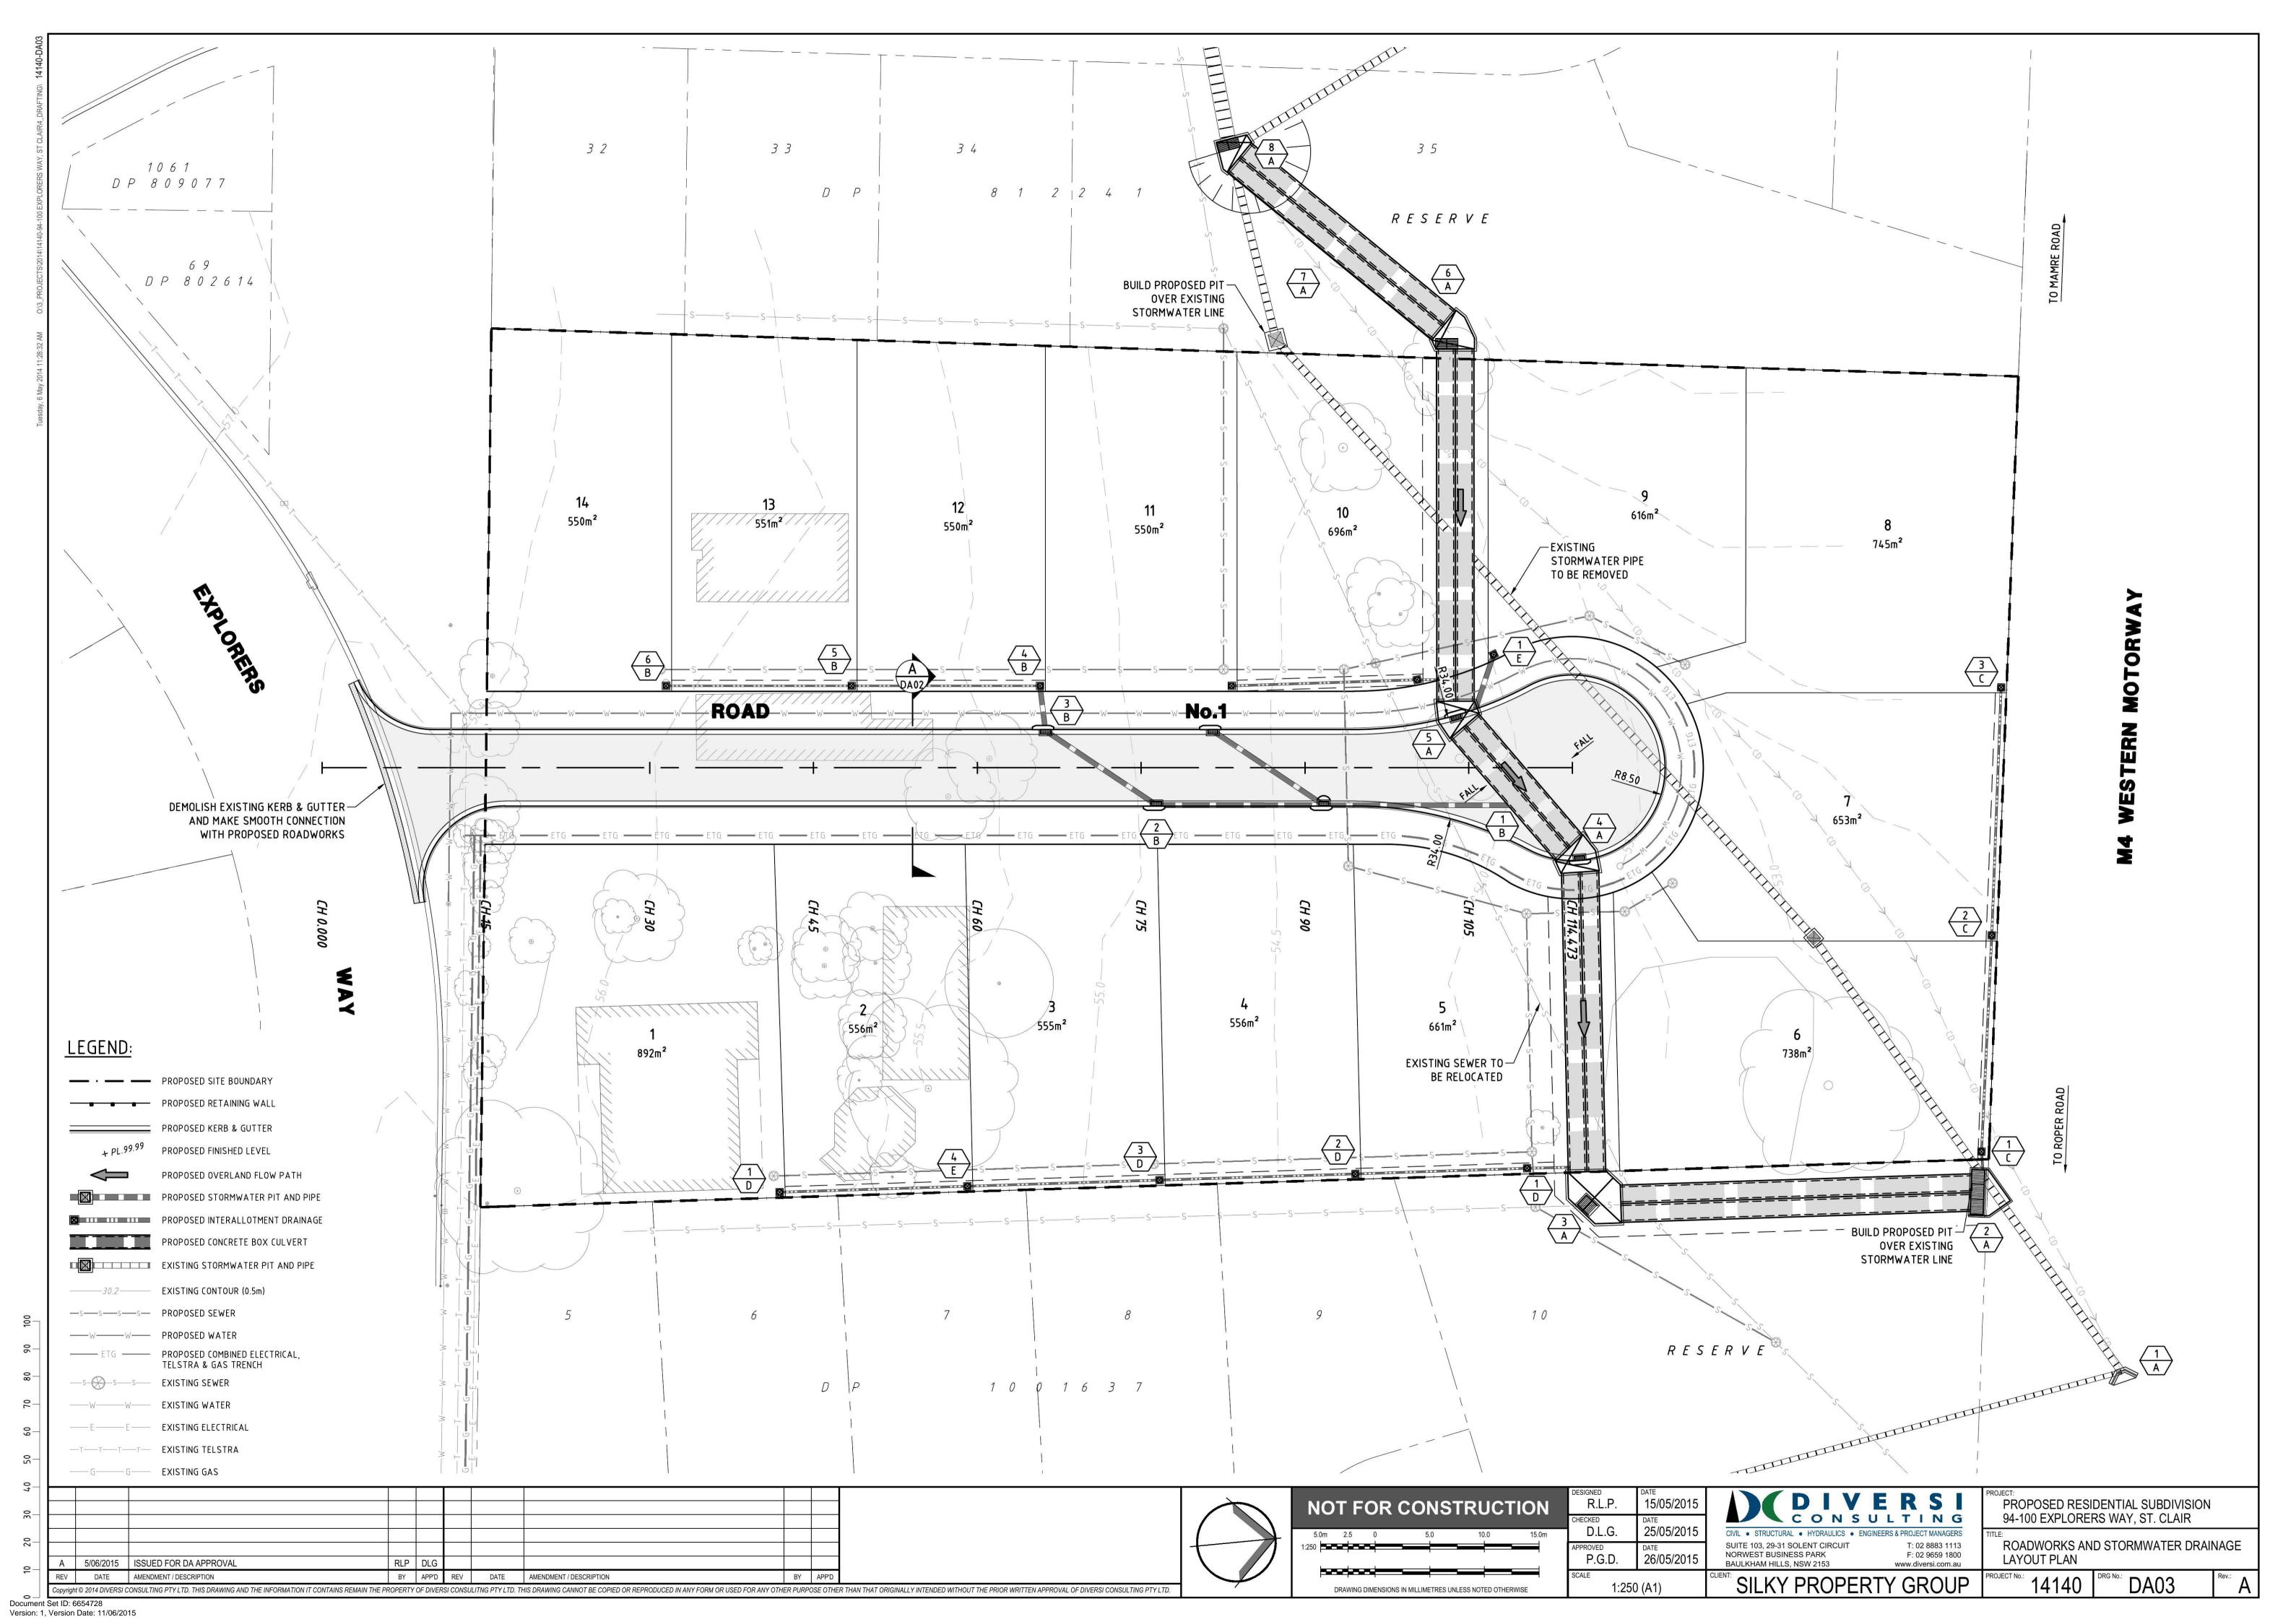




96

80


20

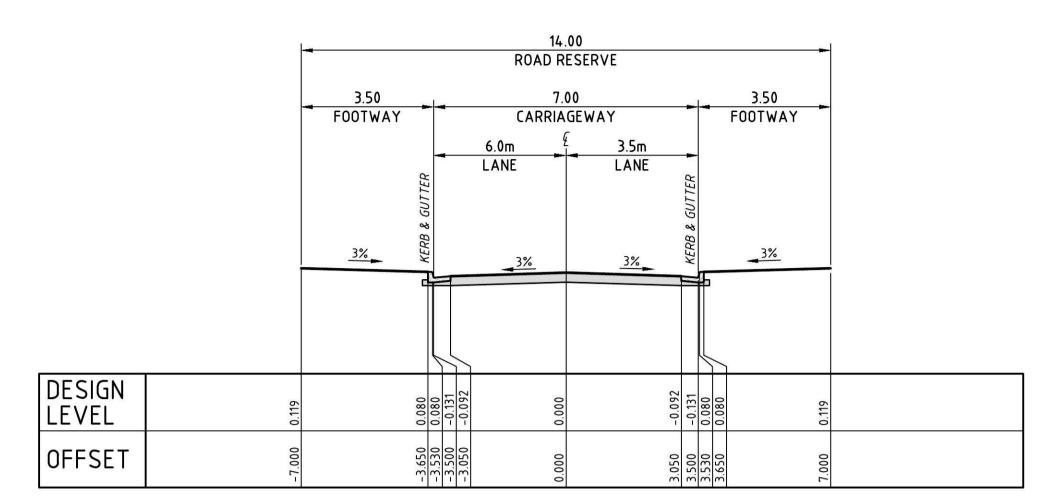

TYPICAL SECTION A

SCALE 1: 100

DA01

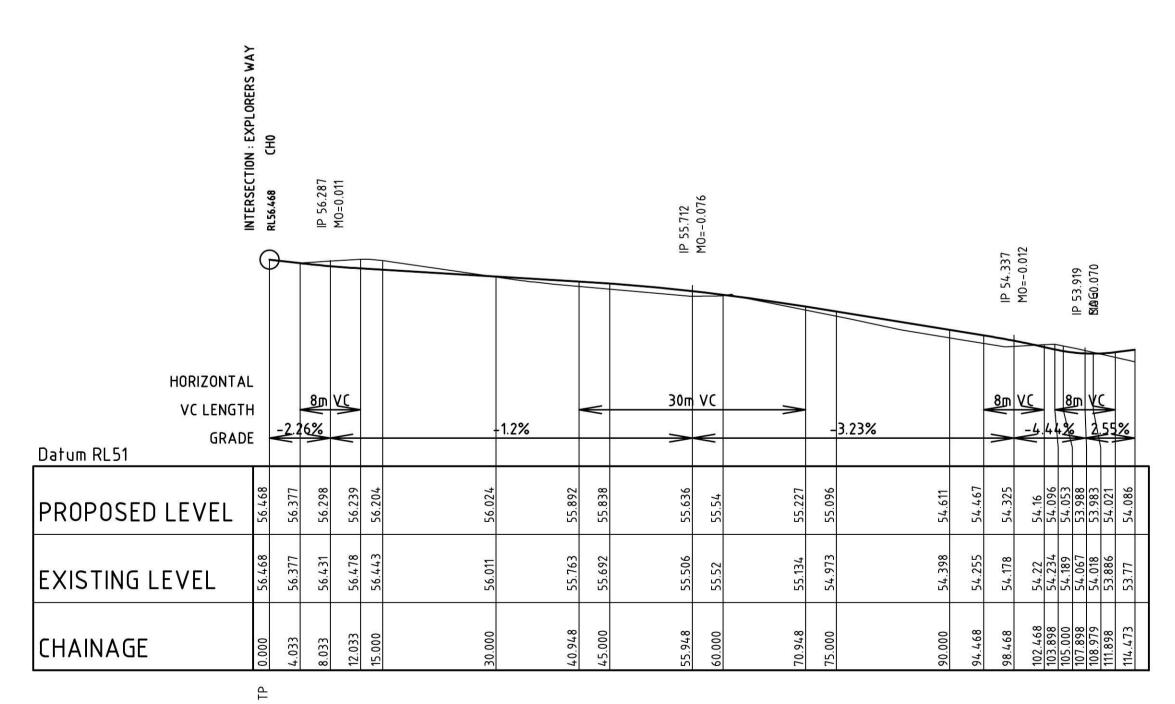

ROAD 1 LONGITUDINAL SECTION SCALE 1:500 HORI. SCALE 1:100 VERT.

A 5/06/2015 ISSUED FOR DA APPROVAL DATE AMENDMENT / DESCRIPTION BY APP'D REV DATE AMENDMENT / DESCRIPTION Copyright © 2014 DIVERSI CONSULTING PTY LTD. THIS DRAWING AND THE INFORMATION IT CONTAINS REMAIN THE PROPERTY OF DIVERSI CONSULTING PTY LTD. THIS DRAWING CANNOT BE COPIED OR REPRODUCED IN ANY FORM OR USED FOR ANY OTHER PURPOSE OTHER THAN THAT ORIGINALLY INTENDED WITHOUT THE PRIOR WRITTEN APPROVAL OF DIVERSI CONSULTING PTY LTD. NOT FOR CONSTRUCTION DRAWING DIMENSIONS IN MILLIMETRES UNLESS NOTED OTHERWISE


15/05/2015 D.L.G. 25/05/2015 CIVIL • STRUCTURAL • HYDRAULICS • ENGINEERS & PROJECT MANAGERS SUITE 103, 29-31 SOLENT CIRCUIT NORWEST BUSINESS PARK F: 02 9659 1800 P.G.D. 26/05/2015 BAULKHAM HILLS, NSW 2153 www.diversi.com.au SILKY PROPERTY GROUP


H 1:500 | V 1:100 (A1)

PROPOSED RESIDENTIAL SUBDIVISION 94-100 EXPLORERS WAY, ST. CLAIR


ROAD LONGITUDINAL AND TYPICAL SECTIONS

Document Set ID: 6654728 Version: 1, Version Date: 11/06/2015

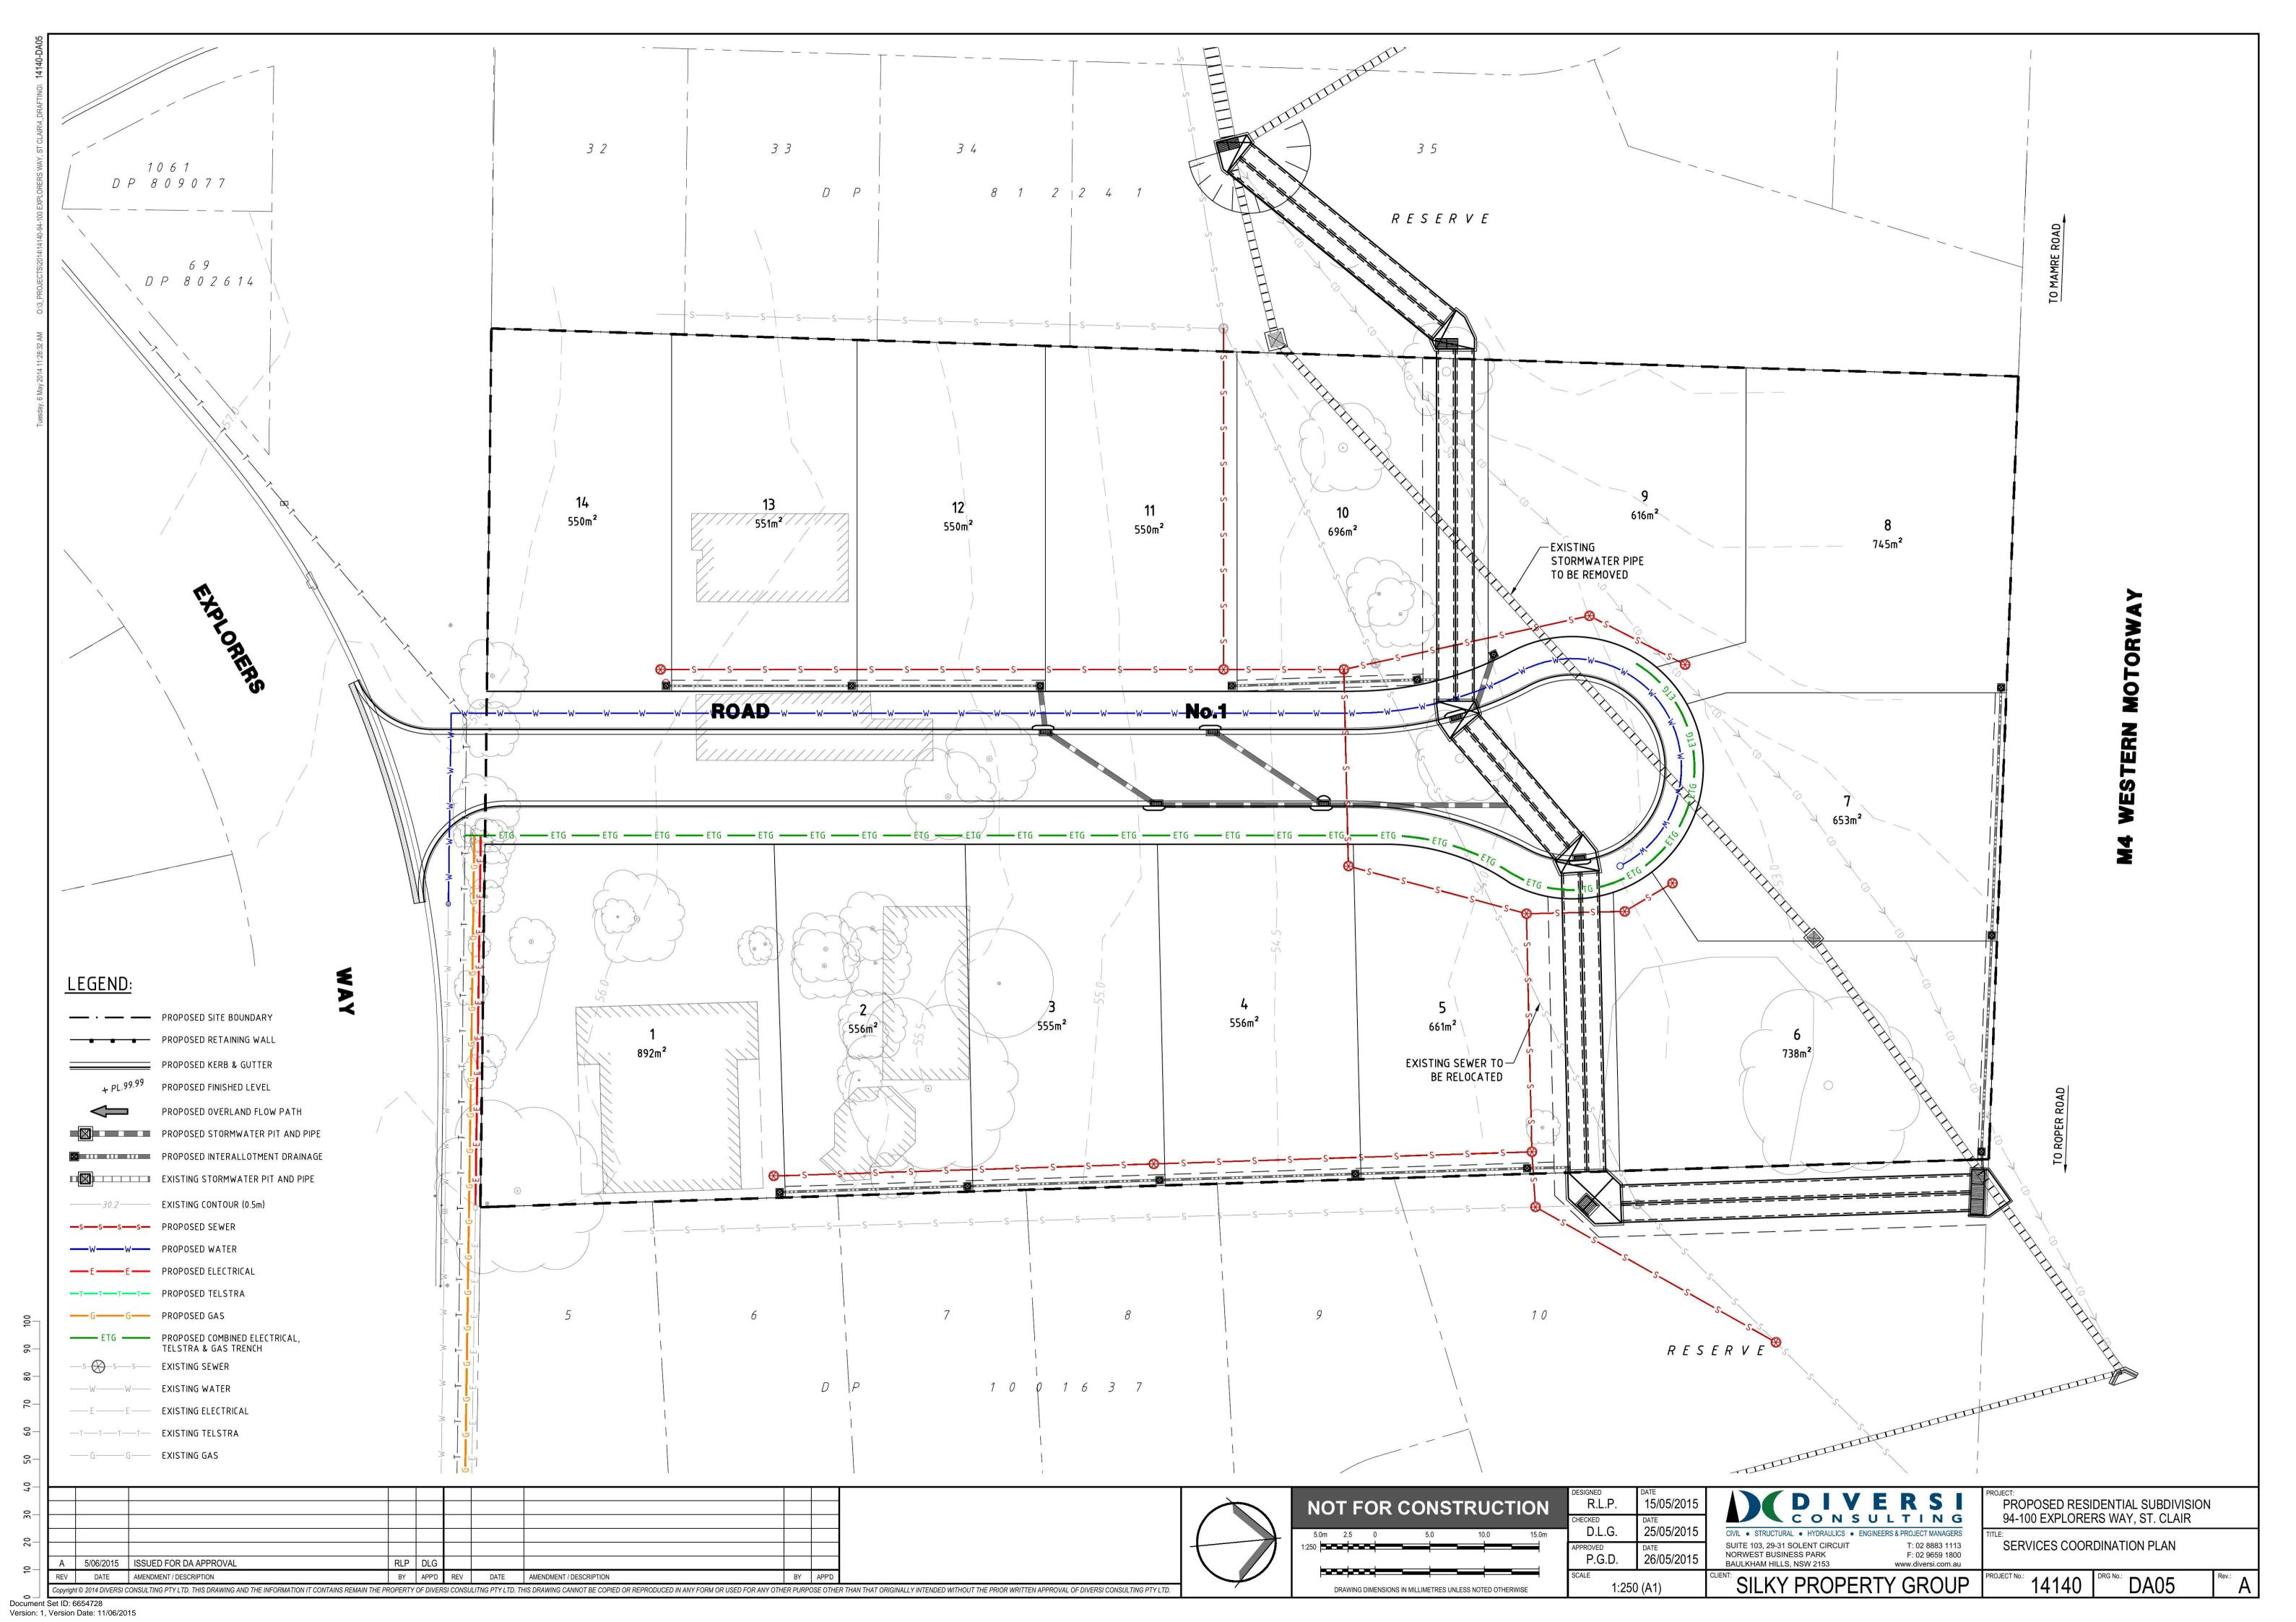

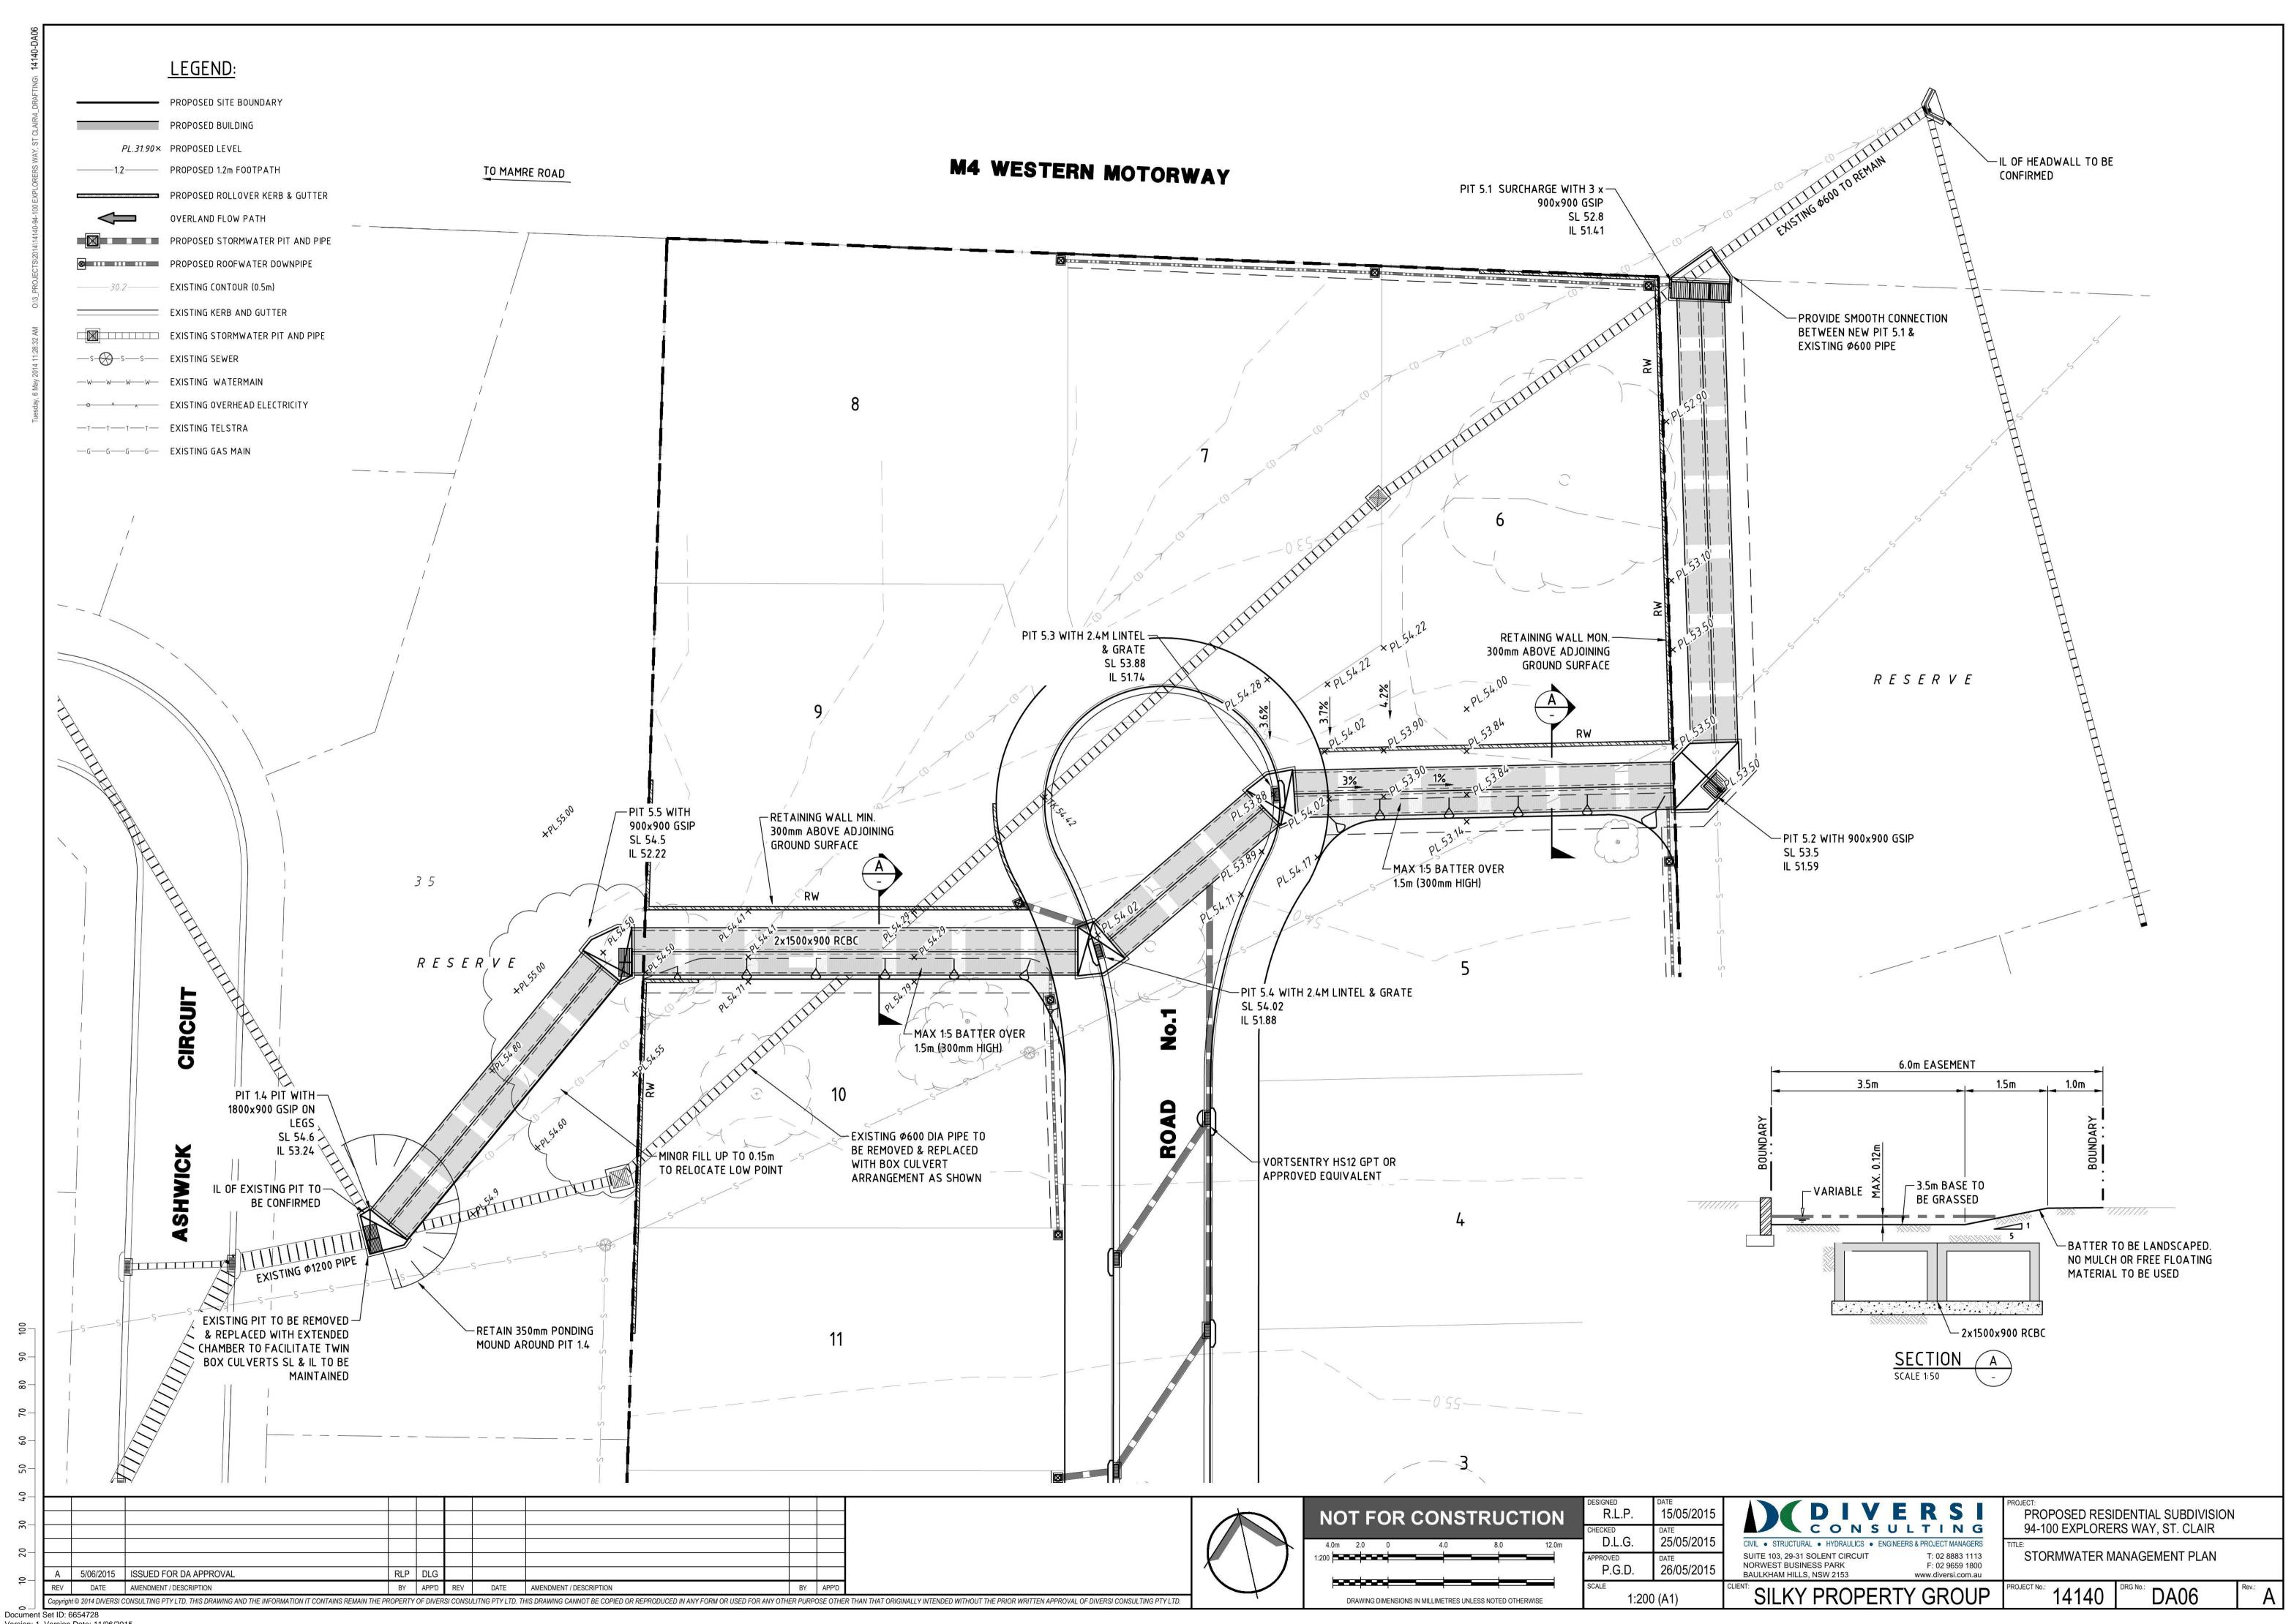


Version: 1, Version Date: 11/06/2015

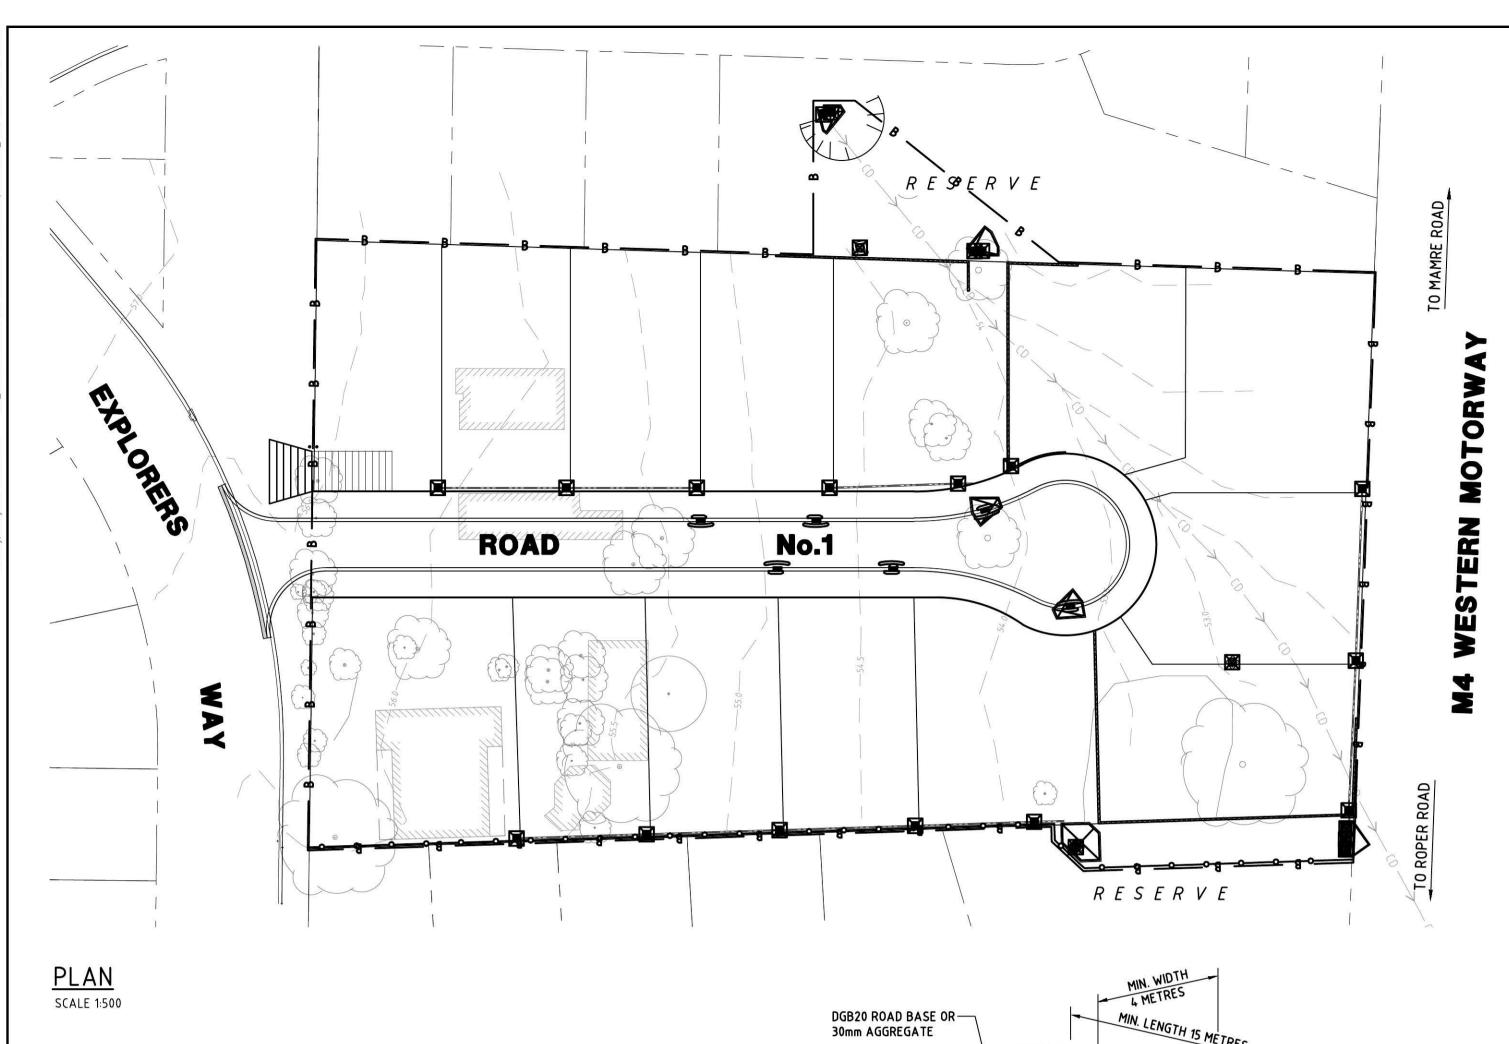


EROSION AND SEDIMENT CONTROLS

- 1. ALL WORK SHALL BE GENERALLY CARRIED OUT IN ACCORDANCE WITH THESE
 - A LOCAL AUTHORITY REQUIREMENTS
 - B EPA REQUIREMENTS NSW DEPARTMENT OF HOUSING MANUAL 'MANAGING
 - URBAN STORM WATER, SOILS AND CONSTRUCTION', 4TH EDITION, MARCH 2004.
- 2. MAINTAIN THE EROSION CONTROL DEVICES INDICATED TO THE SATISFACTION OF THE
- SUPERINTENDENT AND THE LOCAL AUTHORITY. WHEN STORM WATER PITS ARE CONSTRUCTED, PREVENT SITE RUNOFF ENTERING
- UNLESS SILT FENCES ARE ERECTED AROUND THE PITS. 4. CONTRACTOR IS TO ENSURE ALL EROSION AND SEDIMENTATION CONTROL DEVICES ARE MAINTAINED IN GOOD WORKING ORDER AND OPERATE EFFICIENTLY. REPAIRS AND/OR MAINTENANCE SHALL BE UNDERTAKEN AS REQUIRED, PARTICULARLY FOLLOWING STORM EVENTS.
- CONTRACTOR TO PROVIDE 300mm WIDE TURF STRIPED BEHIND ALL KERBS
- 6. GRAVEL SAUSAGES TO BE PROVIDED AT 5m CENTRES.

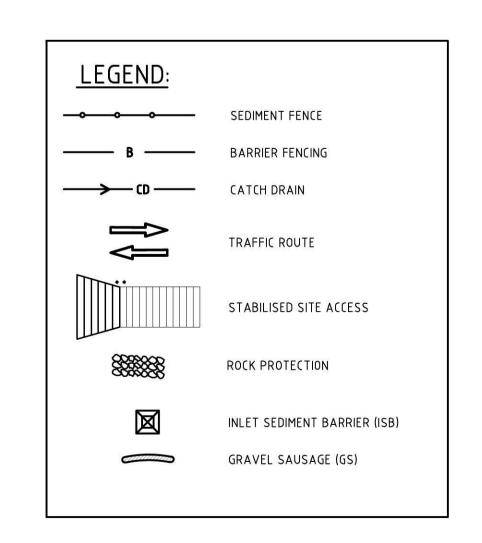

RLP DLG

DATE AMENDMENT / DESCRIPTION

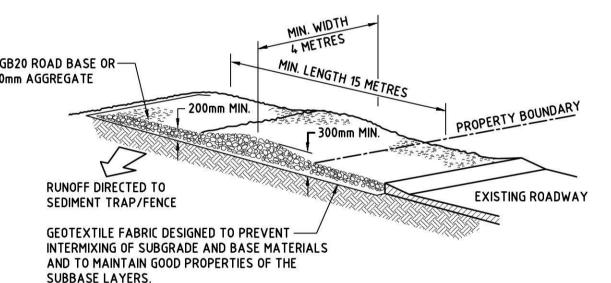


SUBBASE LAYERS.

GEOTEXTILE MAYBE WOVEN OR NEDDLE PUNCHED PRODUCT WITH A MINIMUM CBR BURST STRENGTH (AS3706.4-90) OF 2500 N.


STABILISED SITE ACCESS CONSTRUCTION NOTES:

- 1. STRIP THE TOPSOIL, LEVEL THE SITE AND COMPACT THE SUBGRADE.
- 2. COVER THE AREA WITH NEEDLE PUNCHED GEOTEXTILE.
- 3. CONSTRUCT A 200mm THICK PAD OVER THE GEOTEXTILE USING ROAD BASE OR 30mm 4. ENSURE THE STRUCTURE IS AT LEAST 15 METRES LONG OR TO BUILDING ALIGNMENT
- AND AT LEAST 3 METRES WIDE.
- 5. WHERE A SEDIMENT FENCE JOINS ONTO THE STABILISED ACCESS, CONSTRUCT A HUMP IN THE STABILISED ACCESS TO DIVERT WATER TO SEDIMENT FENCE.


STABILISED SITE ACCESS (SSA)

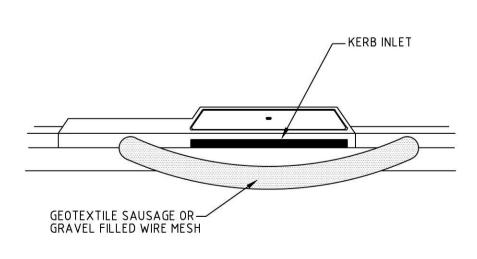


GRAVEL SAUSAGE (GS)

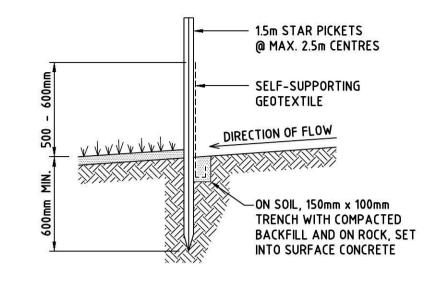

SECTION DETAIL

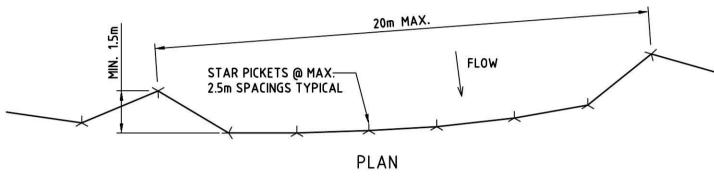


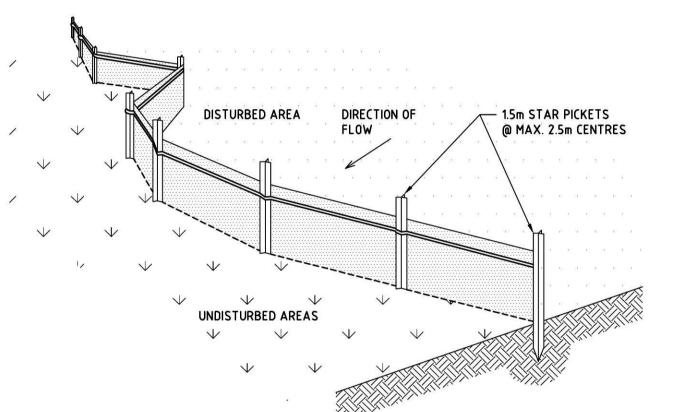

SEDIMENT FENCE (SF)


SEDIMENT FENCE CONSTRUCTION NOTES:


- 1. CONSTRUCT SEDIMENT FENCES AS CLOSE AS POSSIBLE TO BEING PARALLEL TO THE CONTOURS OF THE SITE, BUT WITH SMALL RETURNS AS SHOWN IN THE DRAWING TO LIMIT THE CATCHMENT AREA OF ANY ONE SECTION. THE CATCHMENT AREA SHOULD BE SMALL ENOUGH TO LIMIT WATER FLOW IF CONCENTRATED AT ONE POINT TO 50 LITRES PER SECOND IN THE DESIGN STORM EVENT, USUALLY THE 10-YEAR EVENT.
- 2. CUT A 150mm DEEP TRENCH ALONG THE UPSLOPE LINE OF THE FENCE FOR THE BOTTOM OF THE FABRIC TO BE ENTRENCHED.
- 3. DRIVE 1.5m LONG STAR PICKETS INTO GROUND @ 2.5m INTERVALS (MAX.) AT THE DOWNSLOPE EDGE OF THE TRENCH. ENSURE ANY STAR PICKETS ARE FITTED WITH SAFETY CAPS.
- 4. FIX SELF-SUPPORTING GEOTEXTILE TO THE UPSLOPE SIDE OF THE POSTS ENSURING IT GOES TO THE BASE OF THE TRENCH. FIX THE GEOTEXTILE WITH WIRE TIES OR AS RECOMMENDED BY THE MANUFACTURER. ONLY USE GEOTEXTILE SPECIFICALLY PRODUCED FOR SEDIMENT FENCING. THE USE OF SHADE CLOTH FOR THIS PURPOSE IS NOT SATISFACTORY.
- 5. JOIN SECTIONS OF FABRIC AT A SUPPORT POST WITH A 150mm OVERLAP.
- 6. BACKFILL THE TRENCH OVER THE BASE OF THE FABRIC AND COMPACT IT THOROUGHLY OVER THE

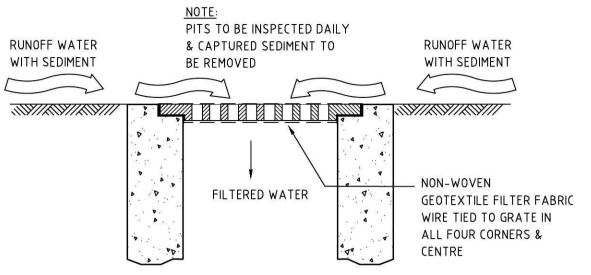

INLET TRAP SCALE N.T.S.

NOTE: TO BE USED IN PAVED AREAS WHERE TRAFFIC ACCESS IS REQUIRED

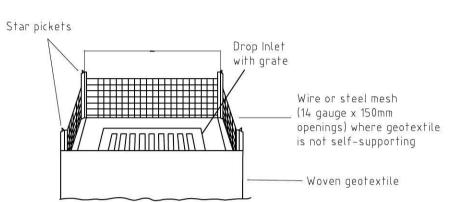

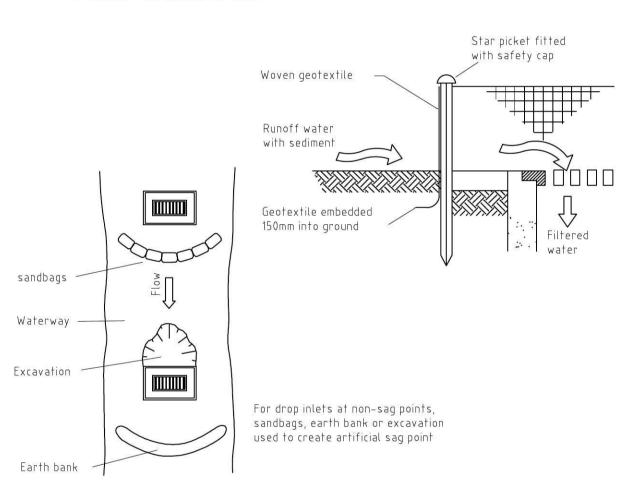

Construction Notes

1. Fabricate a sediment barrier made from geotextile or straw bales. 2. Support geotextile with mesh tied to posts spaced at 1 metre icentres. 3. Do not cover inlet with geotextile.

4. Construction details are similar to Standard Drawing 6–6 and 6–7.

INLET SEDIMENT BARRIER (ISB)

Copyright © 2014 DIVERSI CONSULTING PTY LTD. THIS DRAWING AND THE INFORMATION IT CONTAINS REMAIN THE PROPERTY OF DIVERSI CONSULTING PTY LTD. THIS DRAWING CANNOT BE COPIED OR REPRODUCED IN ANY OTHER PURPOSE OTHER THAN THAT ORIGINALLY INTENDED WITHOUT THE PRIOR WRITTEN APPROVAL OF DIVERSI CONSULTING PTY LTD.

GEOTEXTILE.

NOT FOR CONSTRUCTION 00 DRAWING DIMENSIONS IN MILLIMETRES UNLESS NOTED OTHERWISE

R.L.P. 15/05/2015 D.L.G. 25/05/2015 26/05/2015 P.G.D.

1:500 (A1)

CONSULTING CIVIL • STRUCTURAL • HYDRAULICS • ENGINEERS & PROJECT MANAGERS SUITE 103, 29-31 SOLENT CIRCUIT NORWEST BUSINESS PARK F: 02 9659 1800 BAULKHAM HILLS, NSW 2153 www.diversi.com.au

PROPOSED RESIDENTIAL SUBDIVISION 94-100 EXPLORERS WAY, ST. CLAIR

EROSION AND SEDIMENT CONTROL LAYOUT PLAN & DETAILS


SILKY PROPERTY GROUP

Document Set ID: 6654728

Version: 1, Version Date: 11/06/2015

A 5/06/2015 ISSUED FOR DA APPROVAL

DATE AMENDMENT / DESCRIPTION

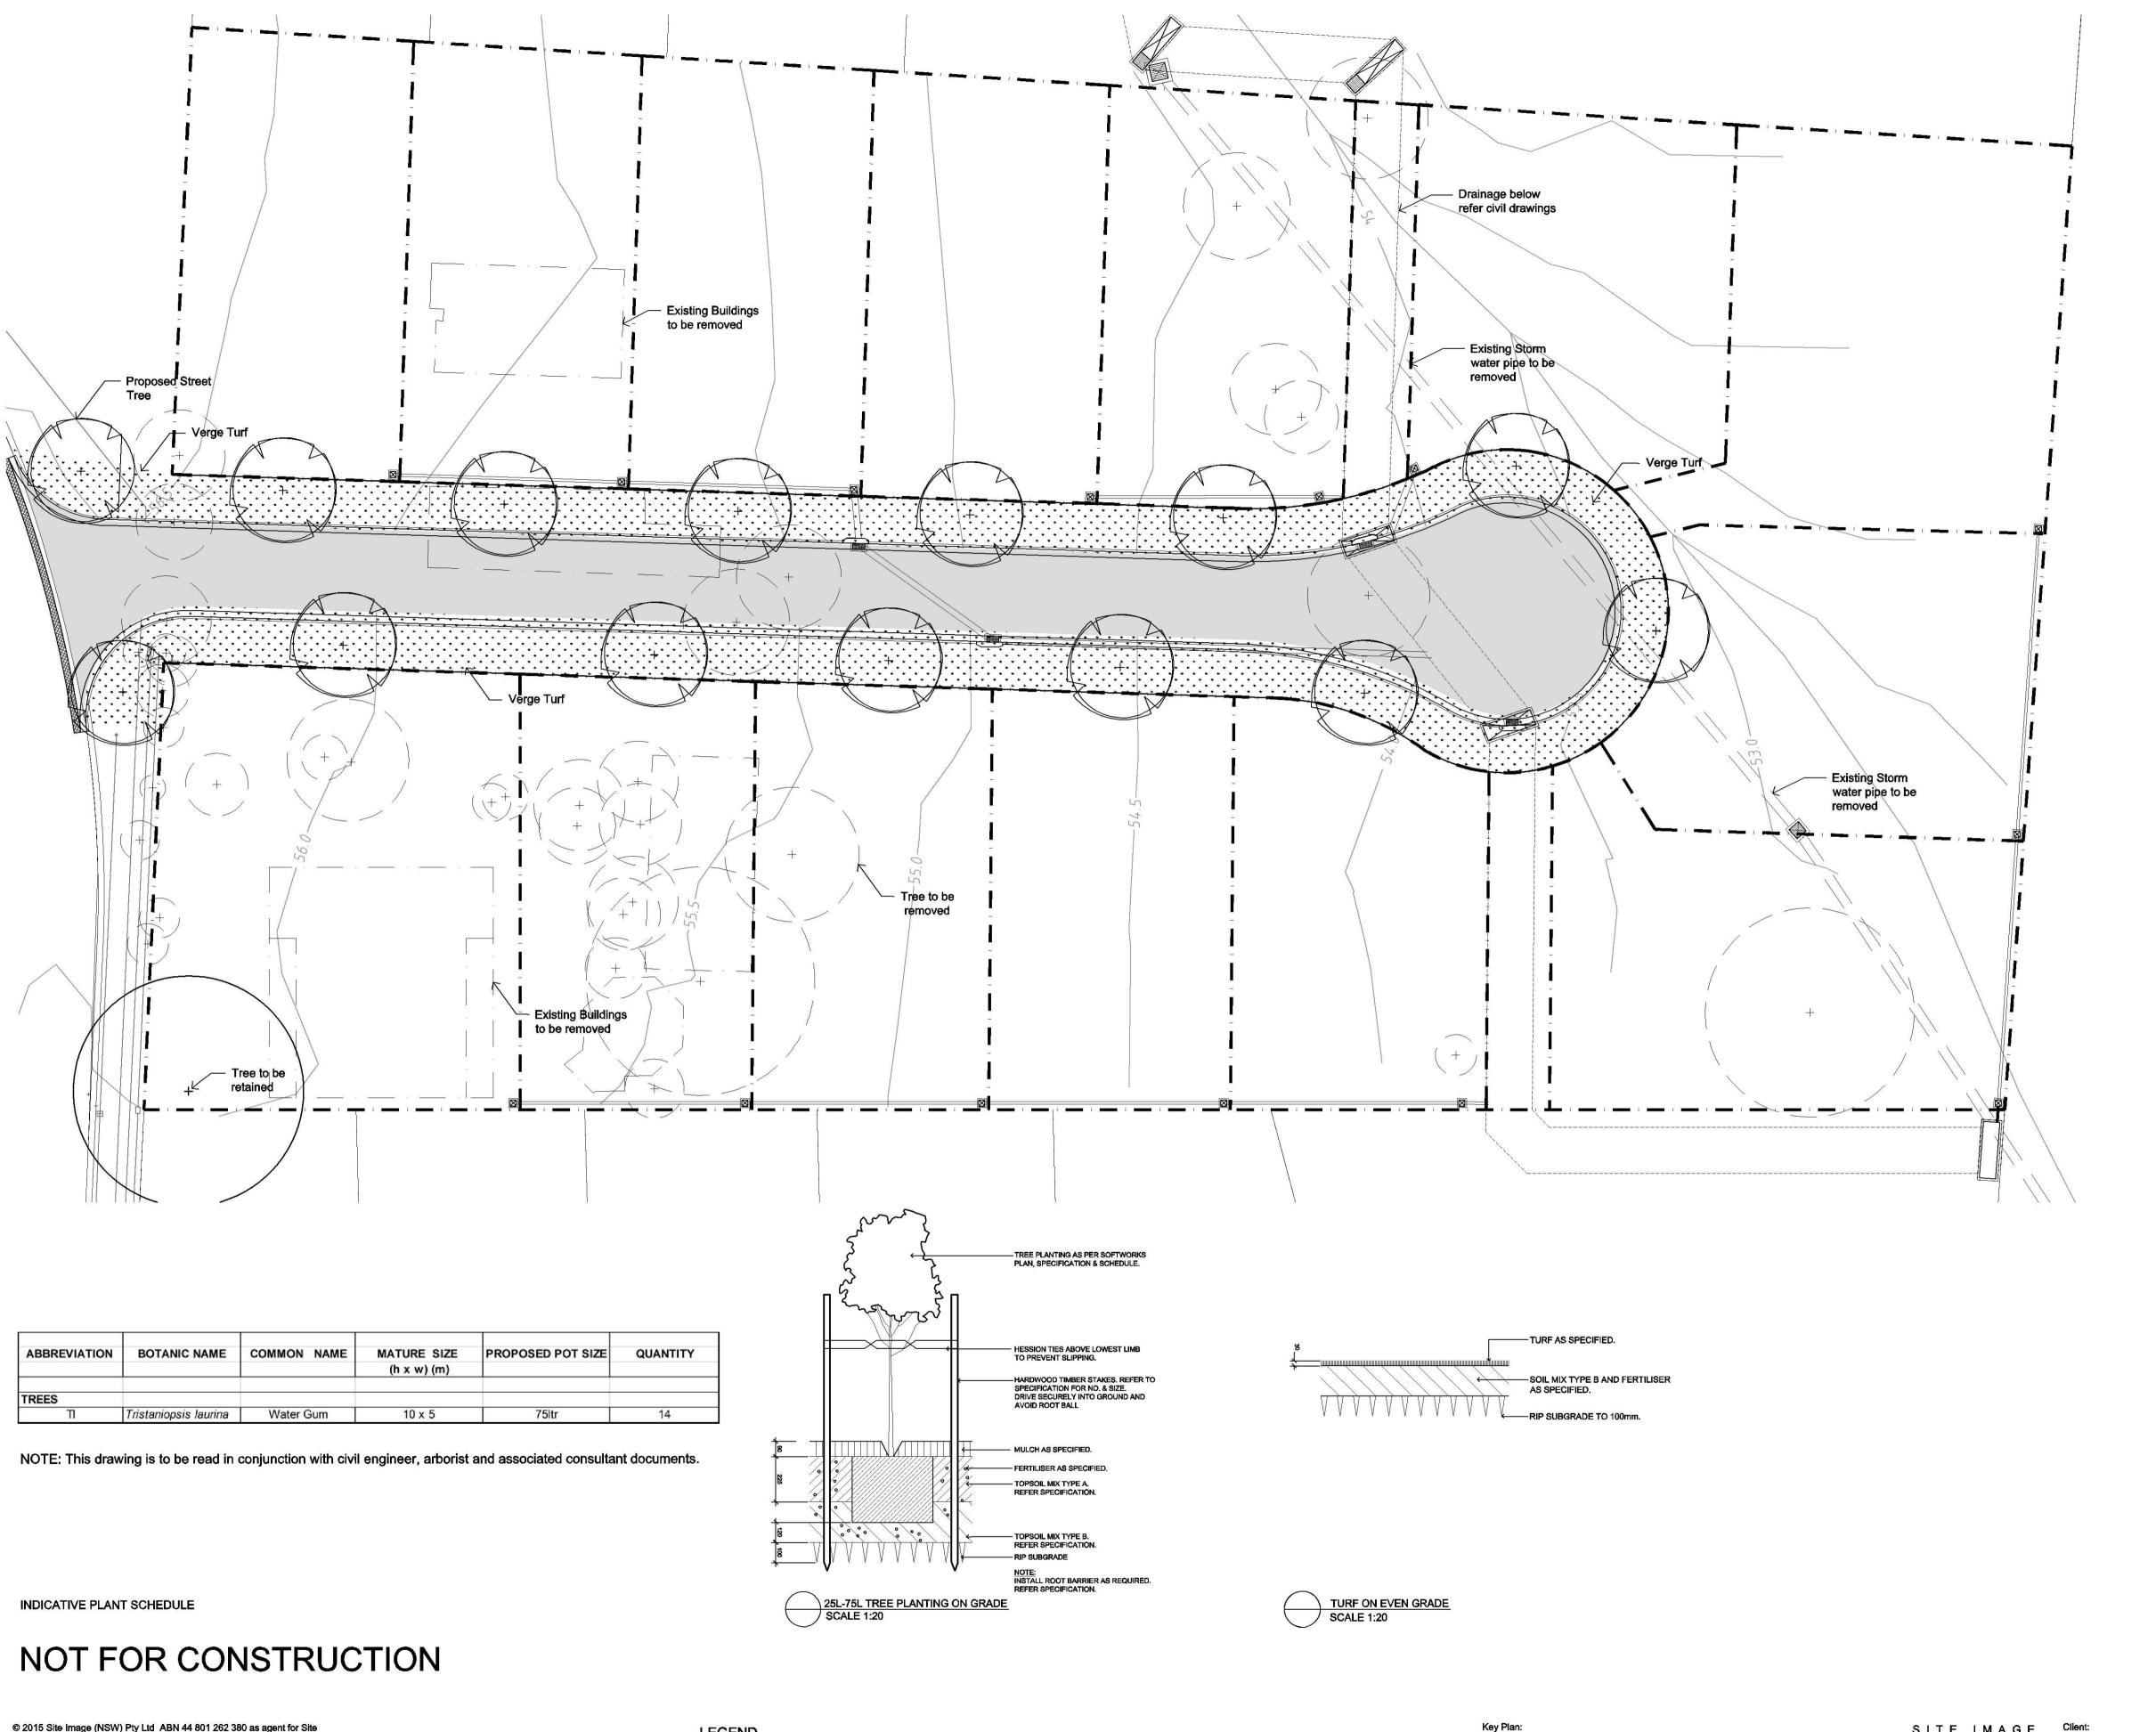

© 2015 Site Image (NSW) Pty Ltd ABN 44 801 262 380 as agent for Site Image NSW Partnership. All rights reserved. This drawing is copyright and shall not be reproduced or copied in any form or by any means (graphic, electronic or mechanical including photocopy) without the written permission of Site Image (NSW) Pty Ltd Any license, expressed or implied, to use this document for any purpose what so ever is restricted to the terms of the written agreement between Site Image (NSW) Pty Ltd and the instructing

The contractor shall check and verify all work on site (including work by others) before commencing the landscape installation. Any discrepancies are to be reported to the Project Manager or Landscape Architect prior to commencing work. Do not scale this drawing. Any required dimensions not shown shall be referred to the Landscape Architect for confirmation.

A Landscape Plan NP RS 02.06.15

Drawn Check

Issue Revision Description

LEGEND Proposed Street Tree (Refer to Landscape Details & Spec) (Refer to Landscape Details & Spec Tree to be removed (Refer to Landscape Details & Spec)

Tree to be retained Site Boundary Existing Building to be removed

SITE IMAGE

Landscape Architects

Level 1, 3-5 Baptist Street Redfern NSW 2016

Tel: (61 2) 8332 5600 Fax: (61 2) 9698 2877

Explorers Way, St Clair NSW 2759

Diversi Consulting

Landscape Plan

Development Application

101 A

SS15-3029

Document Set ID: 6654728 Version: 1, Version Date: 11/06/2015

LANDSCAPE SPECIFICATION NOTES

Excavate all garden beds to bring the subsoil to at least 300mm below finished design levels. Shape the subsoil to fall to subsoil drains where applicable. Do not excavate within the drip line of trees to be retained. Excavate all turf areas to bring the subsoil to at least 100mm below finished design levels. Shape the subsoil to fall to subsoil drains where applicable. Do not excavate within the drip line of trees to be retained. Cultivate the subsoil to a further depth of 100mm. Remove stones exceeding 25mm, clods of earth exceeding 50mm, and weeds, rubbish or other deleterious material brought to the surface during cultivation. Do not disturb services or tree roots, if necessary cultivate these areas by hand. During cultivation, thoroughly mix in materials required to be incorporated into the subsoil, as recommended in the soil testing results and to manufacturer's recommendations. Trim the surface to design levels after cultivation.

Import topsoil for the garden and turf areas, unless the topsoil can be provided from material recovered from the site, as recommended in the soil testing results. Spread the topsoil on the prepared subsoil and grade evenly, compact lightly and uniformly in 150mm layers. Avoid differential subsidence and excess compaction and produce a finished topsoil surface which has the following characteristics:

- Finished to design levels, allowing for mulch or turf, which is to finish flush with adjoining hard surfaces such as paths and edge,
- Smooth and free from stones or lumps of soil,
- Graded to drain freely, without ponding, to catchment points,
- Graded evenly to adjoining surfaces, and
- Ready for planting.

Provide, in accordance with AS 4454, well rotted vegetative material or animal manure, free from harmful chemicals, grass and weed growth.

Fertiliser

Provide proprietary fertilisers, delivered to the site in sealed bags marked to show manufacturer or vendor, weight, fertiliser type, N:P:K ratio, recommended uses and application rates.

Supply plants in accordance with the landscape drawings and schedules, which have the following characteristics:

- Large healthy root systems, with no evidence of root curl, restriction or damage, • Vigorous, well established, free from disease and pests, of good form consistent with the species or variety,
- Hardened off, not soft or forced, and suitable for planting in the natural climatic conditions prevailing at the site, and in particular shade conditions, Grown in their final containers for not less than twelve weeks,
- Trees, unless required to be multi-stemmed, shall have a single leading shoot,
- Containers shall be free from weeds and of appropriate size in relation to their container.

Installation of Plants

Following excavation of the planting hole place and spread 15gms of wetting agent equal to 'terra-sorb', pre-mixed with one (1) litre of water, at the bottom of each planting hole. Backfill the planting holes with topsoil mixture. Lightly tamp and water to eliminate air pockets. Ensure the topsoil is not placed over the top of the rootball, so that the plant stem remains the same height above the ground as it was in the container. Apply fertiliser pellets, as recommended in the soil testing results and in accordance with the manufacturer's recommendations around the plants at the time of planting.

3.7 Mulching

Mulch shall be approved recycled mulch recovered from site clearing, if available, otherwise pine bark equal "Horticultural Graded Pine Bark 15mm" as supplied by Australian Native Landscapes. Place mulch in all garden beds to a depth of 75mm, when all specified plants are installed, clear of all plant stems, and rake to an even surface flush with the surrounding finished levels and evenly graded between design surface levels. The specified depth shall be achieved after the mulch has settled.

Stakes and Ties

Stakes shall be durable hardwood, straight, free from knots or twists, pointed at one end, in the following quantities and sizes for each of the various plant pot sizes:

• Semi-advanced plants (>75L): Two (2) of 50 x 50 x 1800mm, or

Turf shall be Cynodon dactylon or approved equal, delivered to site as 25mm minimum thick cut rolls. Obtain turf from a specialist grower of cultivated turf. Provide turf of even thickness, free from weeds and other foreign matter. Deliver turf to the site within 24 hours of being cut, and lay it within 24 hours of delivery. Prevent it form drying out between cutting and laying. Lay the turf in the following manner:

- In stretcher pattern with the joints staggered and close butted,
- Parallel with the long sides of level areas, and with contours on slopes, and finish flush, after tamping, with adjacent finished surfaces of ground.

Maintenance

3.10 For period of 12 months undertake watering, mowing, weeding, stake repair, insect control and other requirements to ensure landscape is in a healthy condition to the conclusion of the maintenance period.