

Proposed New Single Storey Residence

Located At:

Lot 2108 in DP 1168991 Lakeside Parade, Jordan Springs. NSW 2747

Schedule of BASIX commitments

The commitments set out below regulate how the proposed development is to be carried out. It is a condition of any development consent granted, or complying development certificate issued, for the proposed development, that BASIX commitments be complied with.

Fixtures

The applicant must install showerheads with a minimum rating of 3 star (> 4.5 but <= 6 L/min) in all showers in the development.

The applicant must install a toilet flushing system with a minimum rating of 2 star in each toilet in the development.

The applicant must install taps with a minimum rating of 3 star in the kitchen in the development.

The applicant must install basin taps with a minimum rating of 3 star in each bathroom in the development.

Alternative water

Rainwater tank

The applicant must install a rainwater tank of at least 2000 litres on the site. This rainwater tank must meet, and be installed in accordance with, the requirements of all applicable regulatory authorities.

The applicant must configure the rainwater tank to collect rain runoff from at least 249.76 square metres of the roof area of the development (excluding the area of the roof which drains to any stormwater tank or private dam).

The applicant must connect the rainwater tank to:

- all toilets in the development
- at least one outdoor tap in the development (Note: NSW Health does not recommend that rainwater be used for human consumption in areas with potable water supply.)

Floor, walls and ceiling/roof

The applicant must construct the floor(s), walls, and ceiling/roof of the dwelling in accordance with the specifications listed in the table below.

Construction Additional insulation required (R-Value) Other specifications

floor - concrete slab on ground nil

external wall - brick veneer 1.66 (or 2.20 including construction)

internal wall shared with garage - plasterboard nil

ceiling and roof - flat ceiling / pitched roof ceiling: 3 (up), roof: foil/sarking unventilated; medium (solar absorptance 0.475-0.70)

Note Insulation specified in this Certificate must be installed in accordance with Part 3.12.1.1 of the Building Code of Australia.

Windows, glazed doors and skylights

The applicant must install the windows, glazed doors and shading devices described in the table below, in accordance with the specifications listed in the table. Relevant overshadowing specifications must be satisfied for each window and glazed door.

The dwelling may have 1 skylight (<0.7 square metres) and up to 2 windows/glazed doors (<0.7 square metres) which are not listed in the table.

The following requirements must also be satisfied in relation to each window and glazed door:

- Except where the glass is 'single clear' or 'single toned', each window and glazed door must have a U-value no greater than that listed and a Solar Heat Gain Coefficient (SHGC) +/-10% of that listed. Total system U-values and SHGC must be calculated in accordance with National Fenestration Rating Council (NFRC) conditions.

- The leading edge of each eave, pergola, verandah, balcony or awning must be no more than 500 millimetres above the head of the window or glazed door, except that a projection greater than 500 mm and up to 1500 mm above the head must be twice the value in the table.

- Pergolas with polycarbonate roof or similar translucent material must have a shading coefficient of less than 0.35.

- Unless they have adjustable shading, pergolas must have fixed battens parallel to the window or glazed door above which they are situated, unless the pergola also shades a perpendicular window. The spacing between battens must not be more than 50 mm.

Window/glazed door no. Orientation Maximum area

(square metres)

Type Shading Overshadowing

W1 S 1.53 standard aluminium, single clear (or

U-value:7.63, SHGC:0.75)

eave/verandah/pergola/balcony

901-1,200 mm

not overshadowed

W2 S 2.16 standard aluminium, single clear (or

U-value:7.63, SHGC:0.75)

eave/verandah/pergola/balcony

451-600 mm

not overshadowed

W3,W4,W5 W 4.98 standard aluminium, single clear (or

U-value:7.63, SHGC:0.75)

eave/verandah/pergola/balcony

451-600 mm

not overshadowed

W6 N 5.04 standard aluminium, single clear (or

U-value:7.63, SHGC:0.75)

eave/verandah/pergola/balcony

451-600 mm

not overshadowed

W7 N 2.7 standard aluminium, single clear (or

U-value:7.63, SHGC:0.75)

eave/verandah/pergola/balcony

451-600 mm

not overshadowed

W8 E 6.3 standard aluminium, single clear (or

U-value:7.63, SHGC:0.75)

eave/verandah/pergola/balcony

>2,000 mm

not overshadowed

W9,W10,W11,W12 E 4.49 standard aluminium, single clear (or

U-value:7.63, SHGC:0.75)

eave/verandah/pergola/balcony

451-600 mm

not overshadowed

Hot water

The applicant must install the following hot water system in the development, or a system with a higher energy rating: gas instantaneous with a performance of 5 stars.

Cooling system

The applicant must install the following cooling system, or a system with a higher energy rating, in at least 1 living area: 3-phase airconditioning; Energy rating: EER < 2.5

The applicant must install the following cooling system, or a system with a higher energy rating, in at least 1 bedroom: 3-phase airconditioning; Energy rating: EER < 2.5

The cooling system must provide for day/night zoning between living areas and bedrooms.

Heating system

The applicant must install the following heating system, or a system with a higher energy rating, in at least 1 living area: 3-phase airconditioning; Energy rating: EER < 2.5

The applicant must install the following heating system, or a system with a higher energy rating, in at least 1 bedroom: 3-phase airconditioning; Energy rating: EER < 2.5

The heating system must provide for day/night zoning between living areas and bedrooms.

Ventilation

The applicant must install the following exhaust systems in the development:

At least 1 Bathroom: no mechanical ventilation (ie. natural); Operation control: n/a

Kitchen: individual fan, ducted to façade or roof; Operation control: manual switch on/off

Laundry: natural ventilation only, or no laundry; Operation control: n/a

Natural lighting

The applicant must install a window and/or skylight in the kitchen of the dwelling for natural lighting.

The applicant must install a window and/or skylight in 2 bathroom(s)/toilet(s) in the development for natural lighting.

Other

The applicant must install a gas cooktop & electric oven in the kitchen of the dwelling.

The applicant must construct each refrigerator space in the development so that it is "well ventilated", as defined in the BASIX definitions.

The applicant must install a fixed outdoor clothes drying line as part of the development.


General Notes:

1. All work to be carried out in accordance with the requirements of the Building Code of Australia and the relevant local authority.
2. All timber framing to be carried out to the requirements of Australian Standards (as 1684) as a minimum.
3. All reinforced concrete, steel beams including supports, and nominated beams including supports to Engineer's details.
4. Structural Engineer to check, detail and certify brickwork to garage area with a height greater than 3000mm between horizontal supports.
5. All brickwork to be constructed in accordance with the requirements of the Building Code of Australia.
6. Control joints in brickwork to be provided in accordance with the requirements of the Building Code of Australia.
7. Doorway openings with inward opening doors to room containing toilets which are closer than 1200mm to the toilet are to be fitted with hinges to allow the door to be removed from the outside when the door is closed.

Construction Notes:

- * R2.20 External Wall Insulation (Including Construction)
- * R3.0 Ceiling Insulation
- * Provide Foil & Sarking to Roof
- * Control Joints to be checked in accordance with engineers plans
- * Centre of kitchen Sink, Vanity, WC, Range Hood, to be confirmed with owner & Manufacturer Details.
- * All windows, Insulation requirements, lighting to comply with Basix Certificate Approve by council.
- * Structural slab to engineer details.
- * Metre Box, Gas Metre to be confirmed with Builder on site.
- * Downpipes to be confirmed with plumber on site.

Rev	Date	Amendments	Sheet	Description
			8	Sedimentaion & Waste Plan
			7	Site Analysis Plan
			6	Elevations
			5	Elevations
			4	Roof Plan & Section A-A
			3	Ground Floor Plan
B	20.08.13	Lodgement to Jordan Springs	2	Site Plan
A	03.07.13	Sketch Concept	1	Cover Sheet

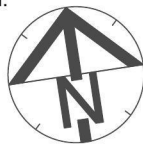Issue	Amendment	Date	North:	Proposed:	Drawing Title:	Revision:
A	Sketch Concept	03.07.13		New Single Storey Residence	Cover Page / Basix Requirements	C
B	Lodgement to Jordan Springs	20.08.13				
C	Council Lodgement	15.10.13				
				Location:	L.G.A	Job No:
				Lot 2108 in DP 1168991 Lakeside Parade, Jordan Springs. NSW		
				Client:	Drawn JR Date 15.10.2013	LB1304
				LB Homes	Scale Sheet 1 of 8	




Note: Builder shall check and verify all dimensions prior to the commencement of any work.

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AREAS:	
Site Plan:	451.70m ²
Living Area:	160.91m ²
Porch:	3.20m ²
Alfresco:	14.25m ²
Garage:	33.09m ²
TOTAL:	22.73SQ 211.45m ²
Courtyard:	
Required:	90.34m ²
Proposed:	138.17m ²
Provide 6 x 4 Dim:	Yes



General Notes:


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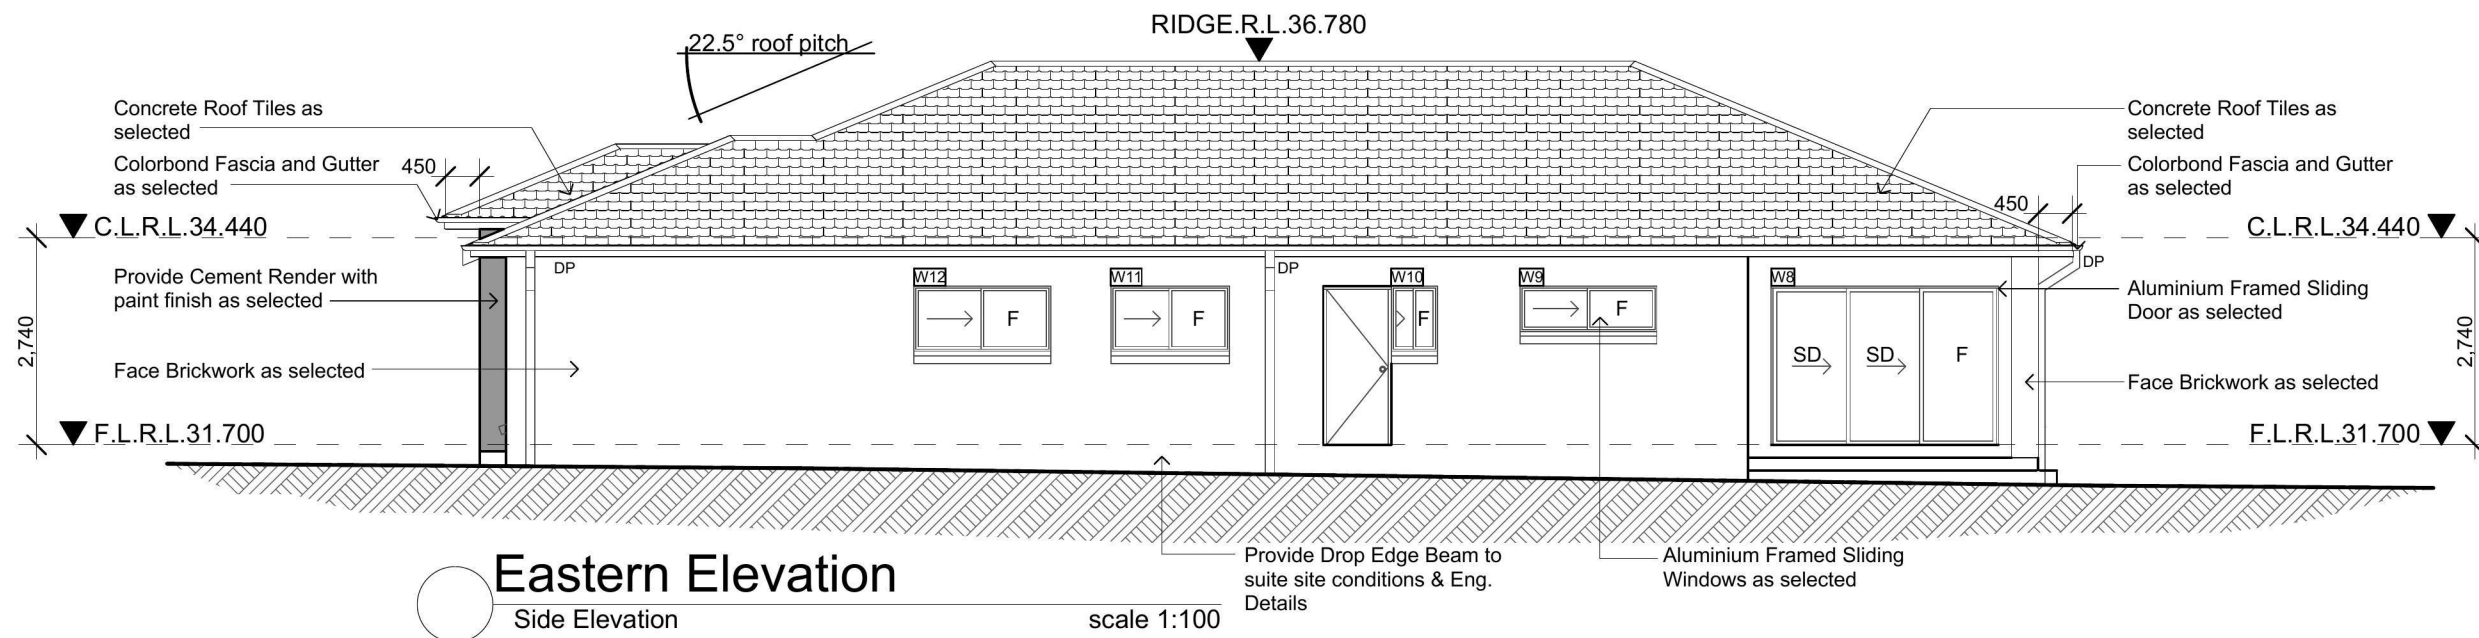
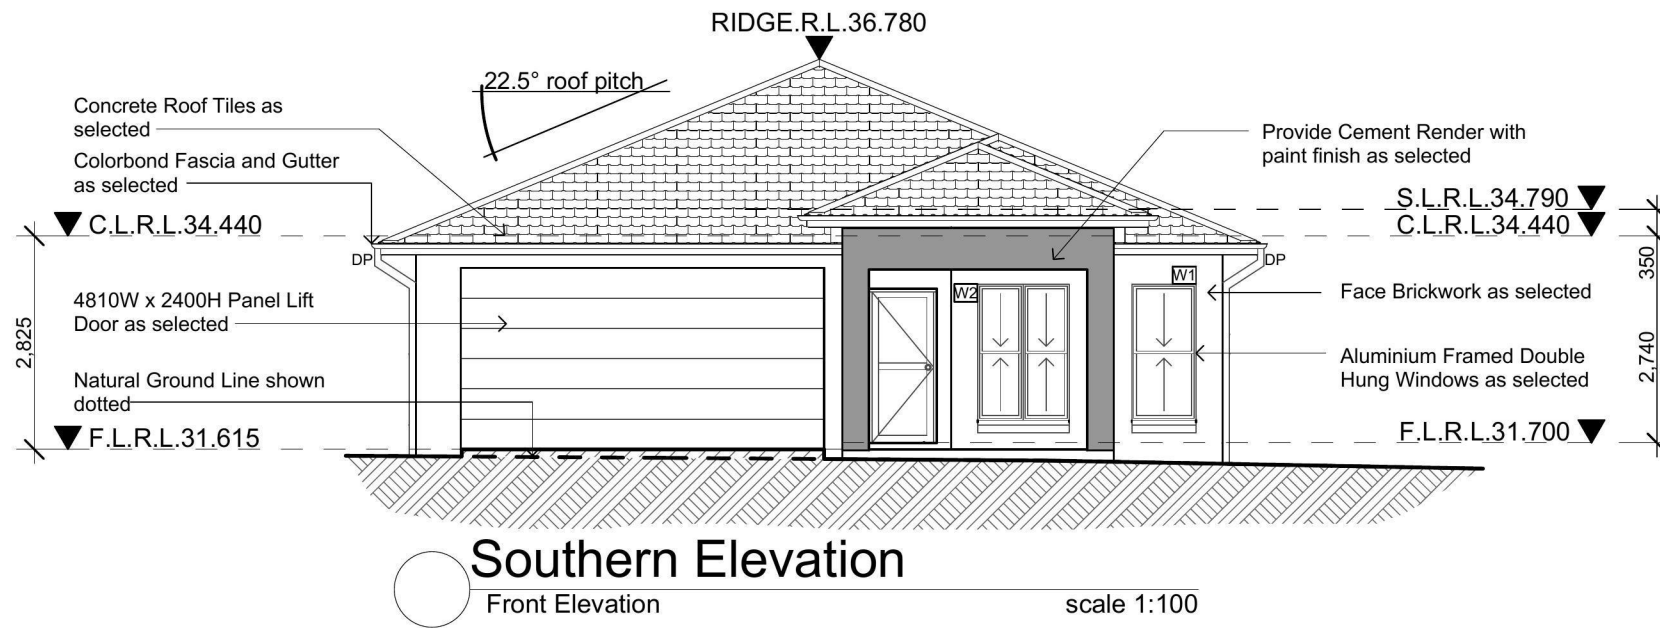
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- * Any retaining walls visible from the street or 900 mm high and over are to be of masonry construction.
- * Vehicle crossovers are to be plain concrete to PCC specifications. 5m wide V.C for double garage and 3m wide V.C for single garage, except where required to meet Australian Standards from corner.
- * All existing street trees and verge planting are to be protected during construction

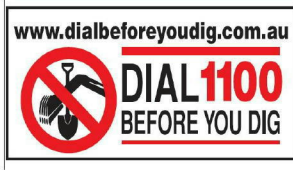

Proposed Site Plan scale 1:200

Issue	Amendment	Date	<p>RESIDENTIAL DESIGN & DRAFTING SERVICES Phone: (02) 9757 - 4002 Fax: (02) 9757 - 4003 Email: jr.design.drafting@gmail.com Address: 448 - 452 Victoria Street, Wetherill Park, NSW 2164</p>		Proposed:	Drawing Title:	Revision:	
A	Sketch Concept	03.07.13			New Single Storey Residence	Proposed Site Plan / Concept Drainage Plan		C
B	Lodgement to Jordan Springs	20.08.13			Location:	L.G.A		Job No:
C	Council Lodgement	15.10.13	Client:	LB Homes	Drawn: JR	Date: 15.10.2013	LB1304	
				Scale: 1:100	Sheet: 2 of 8			

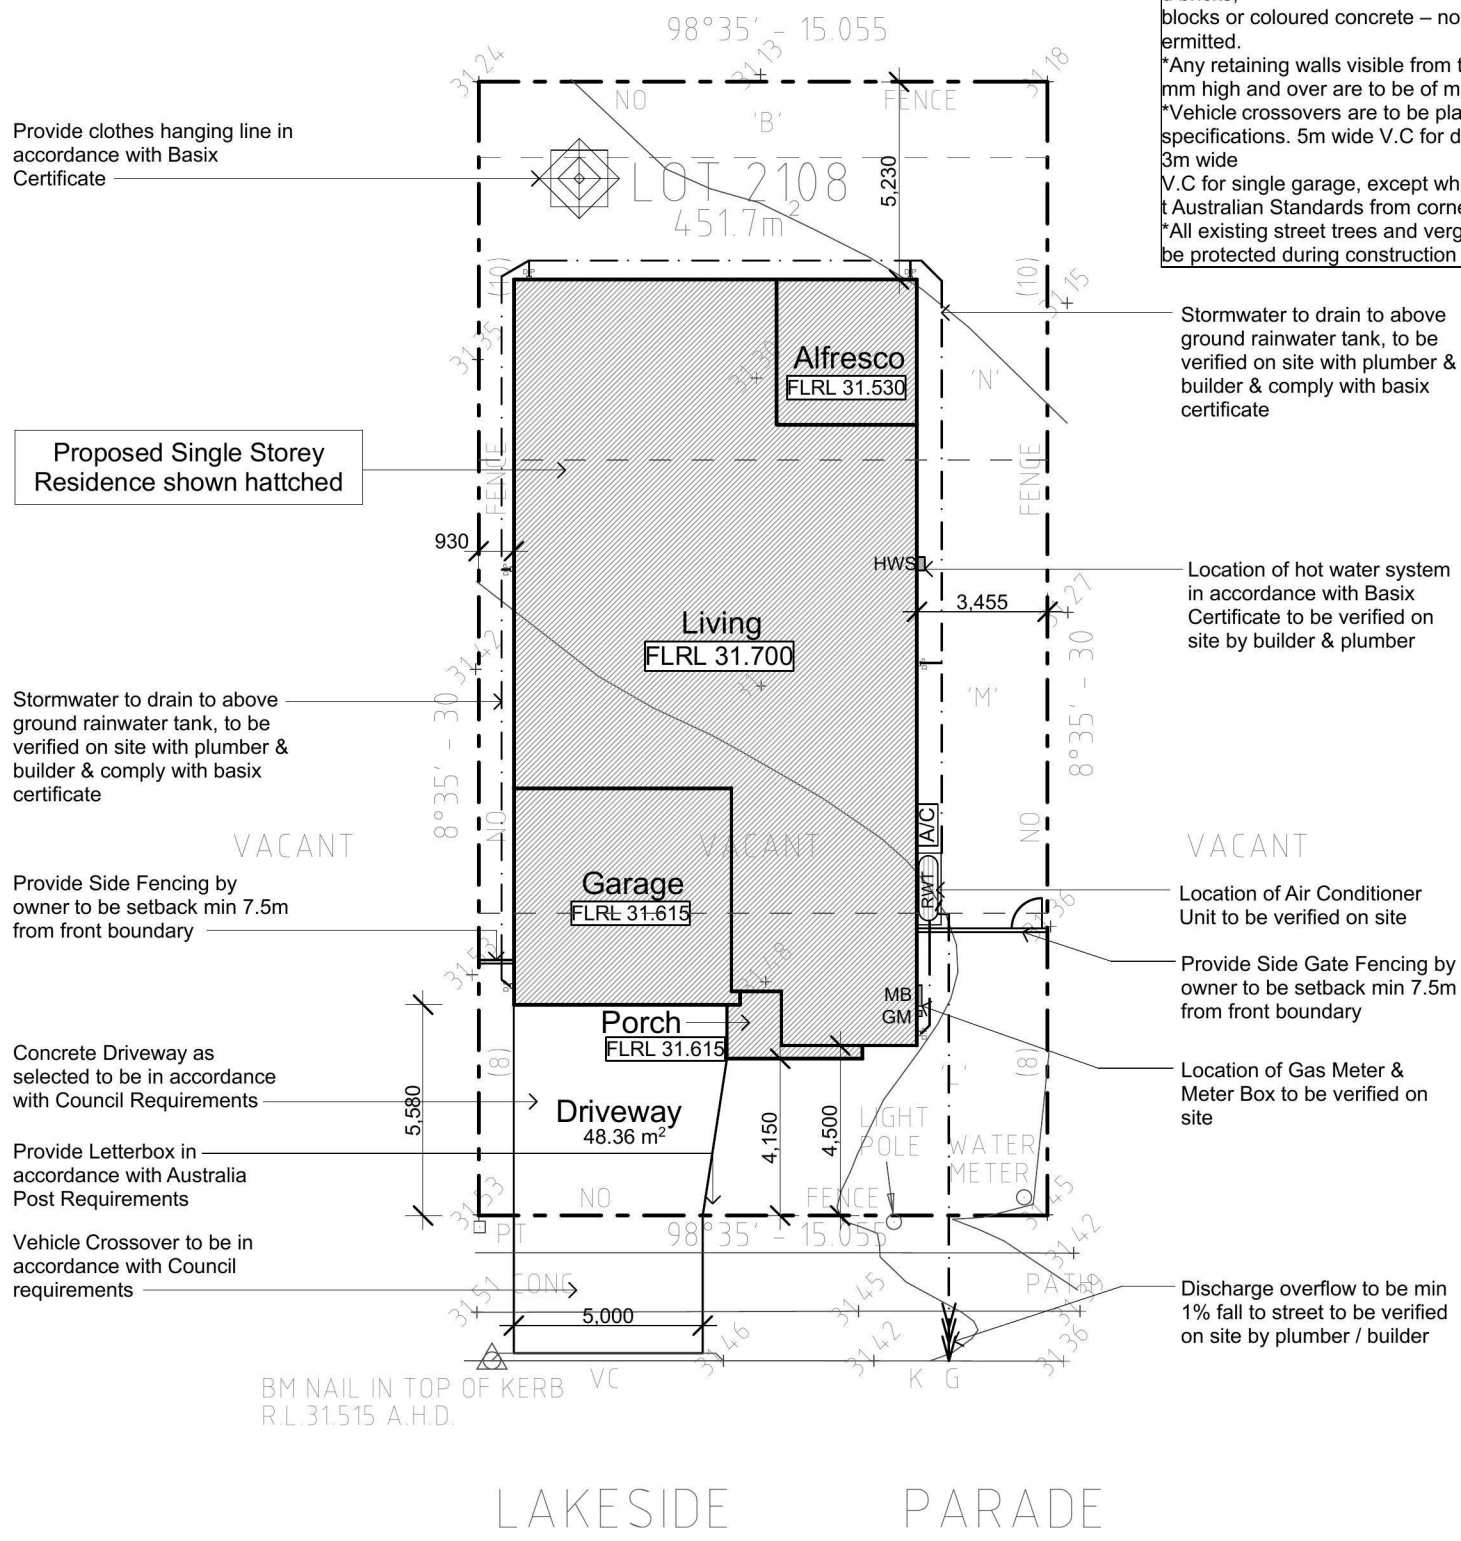

Issue	Amendment	Date:
A	Designs	19.04.13
B	Lodgement to Jordan Springs	20.08.13
C	Council Submission	15.10.13

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RESIDENTIAL DESIGN & DRAFTING SERVICES

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Note:
Builder shall check and verify all dimensions prior to the commencement of any work

North:

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General Notes

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Where Engineering Detail Plans are required, such must take preference to this drawing. Levels shown are approximate unless accompanied by reduced levels or Australian Height Datum Levels. Figured dimensions to be taken in preference to scaling. All Boundary clearances must be verified by Survey. Stormwater to be discharged to Councils requirements before any work commences. All services to be located & verified by the Builder with relevant Authorities before any work commences.

Proposed:
New Single Storey Residence

Location:
Lot 2108 in DP 1168991 Lakeside Parade, Jordan Springs, NSW

Client:
LB Homes



Drawing Title:
Southern Elevation
Eastern Elevation

L.G.A.

Drawn: JR Date: 15.10.2013
Scale: 1:100 Sheet: 5 of 8

Revision:
C

Job No:
LB1304

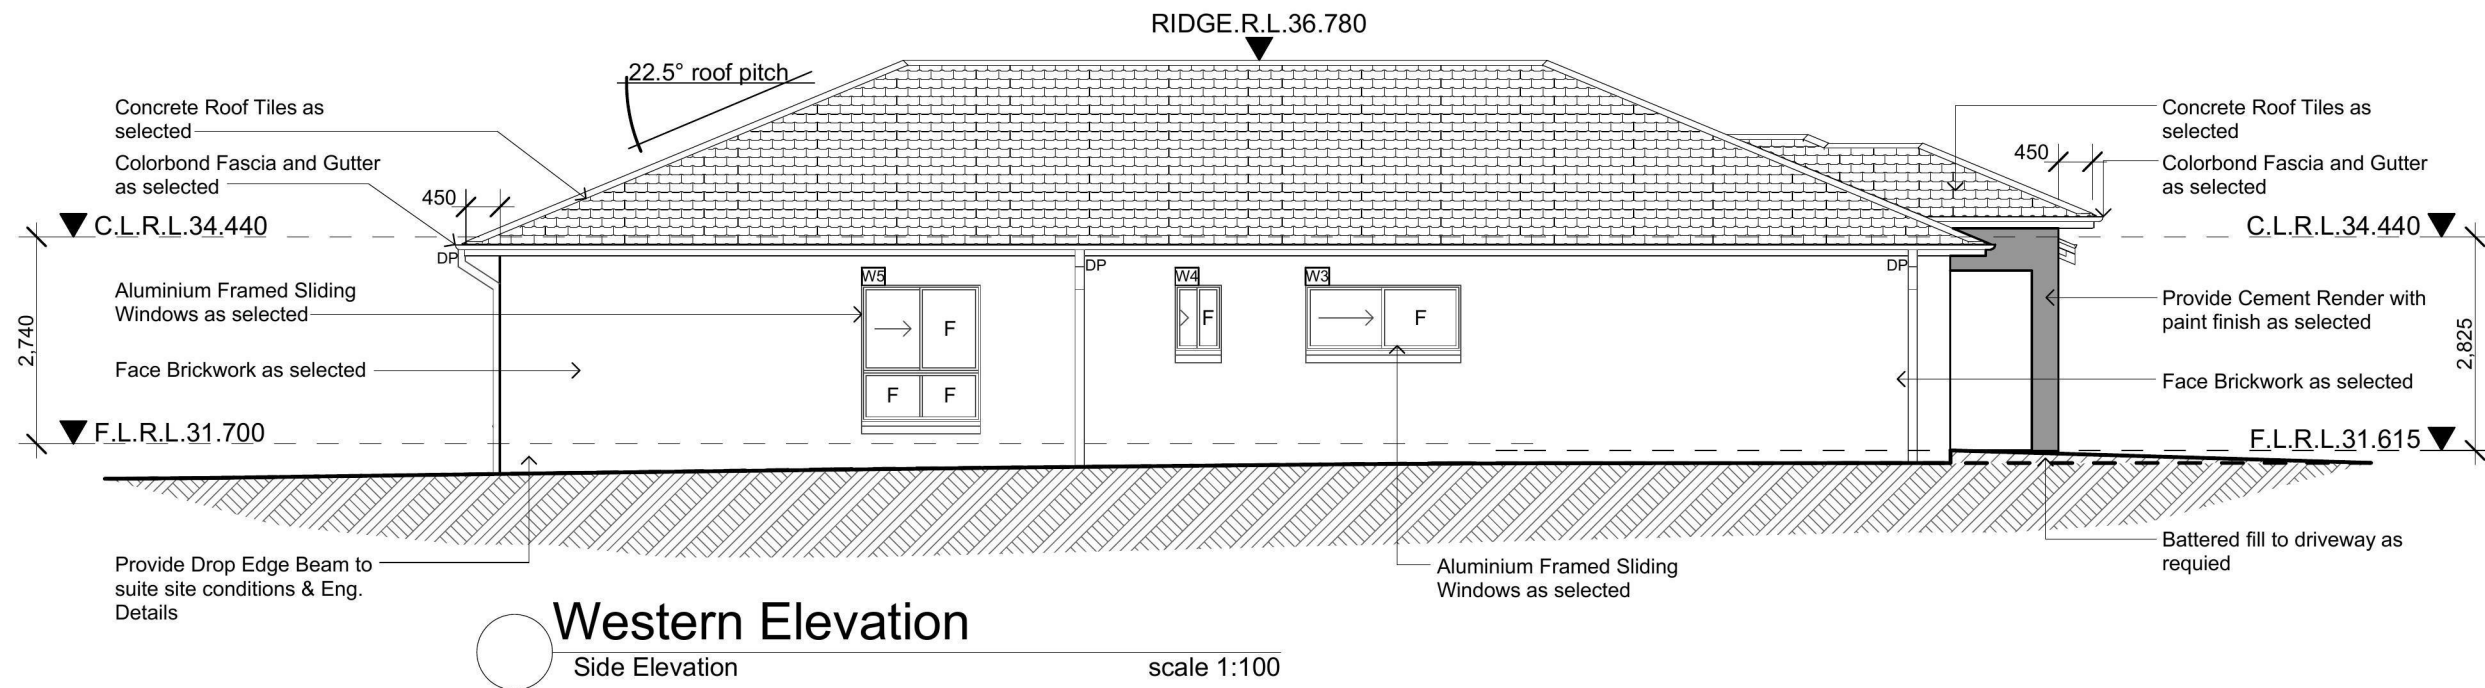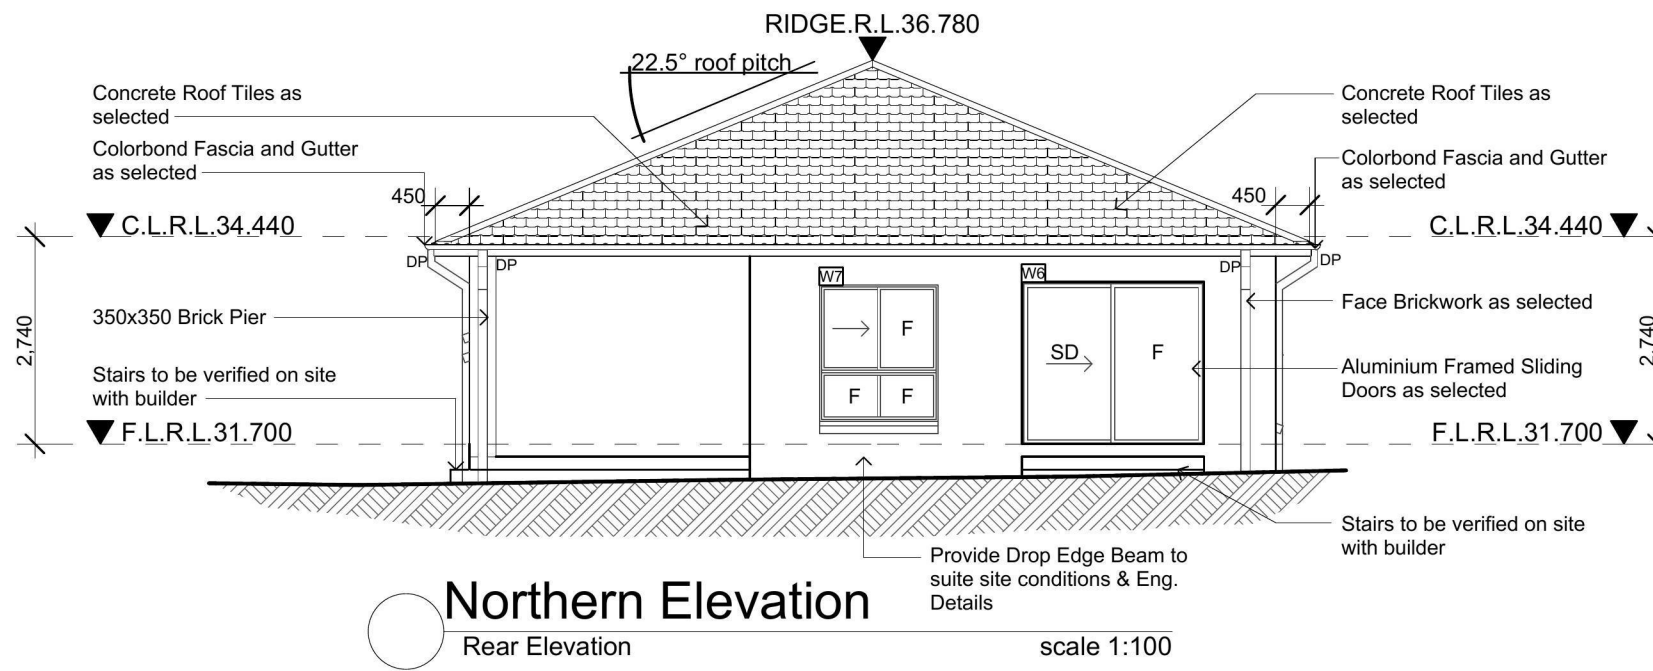

Issue	Amendment	Date:
A	Designs	19.04.13
B	Lodgement to Jordan Springs	20.08.13
C	Council Submission	15.10.13

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 Lot 2108 in DP 1168991 Lakeside Parade, Jordan Springs, NSW

Client:
 LB Homes



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 Southern Elevation
 Eastern Elevation

L.G.A

Drawn: JR Date: 15.10.2013
 Scale: 1:100 Sheet: 6 of 8


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- *All existing street trees and verge planting are to be protected during construction

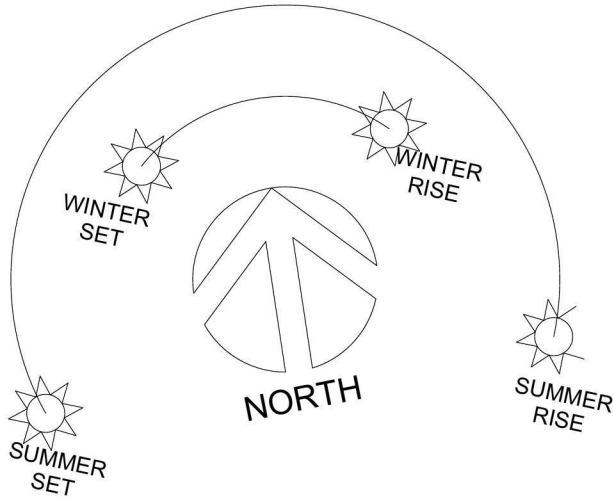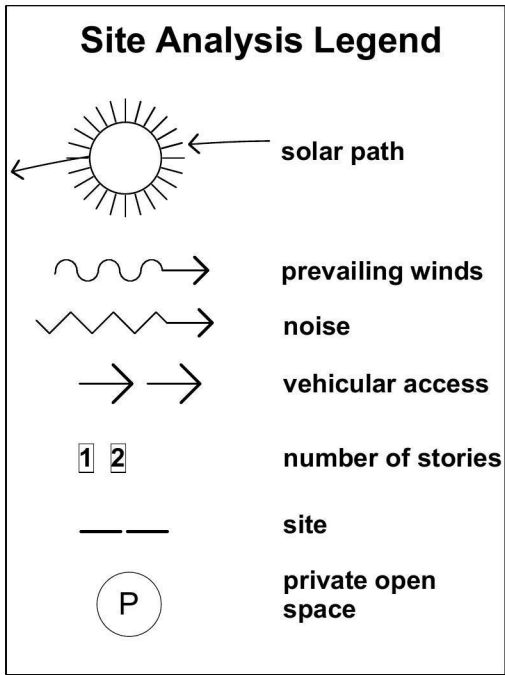

Site Analysis Plan

scale 1:200

Issue	Amendment	Date
A	Sketch Concept	03.07.13
B	Lodgement to Jordan Springs	20.08.13
C	Council Lodgement	15.10.13
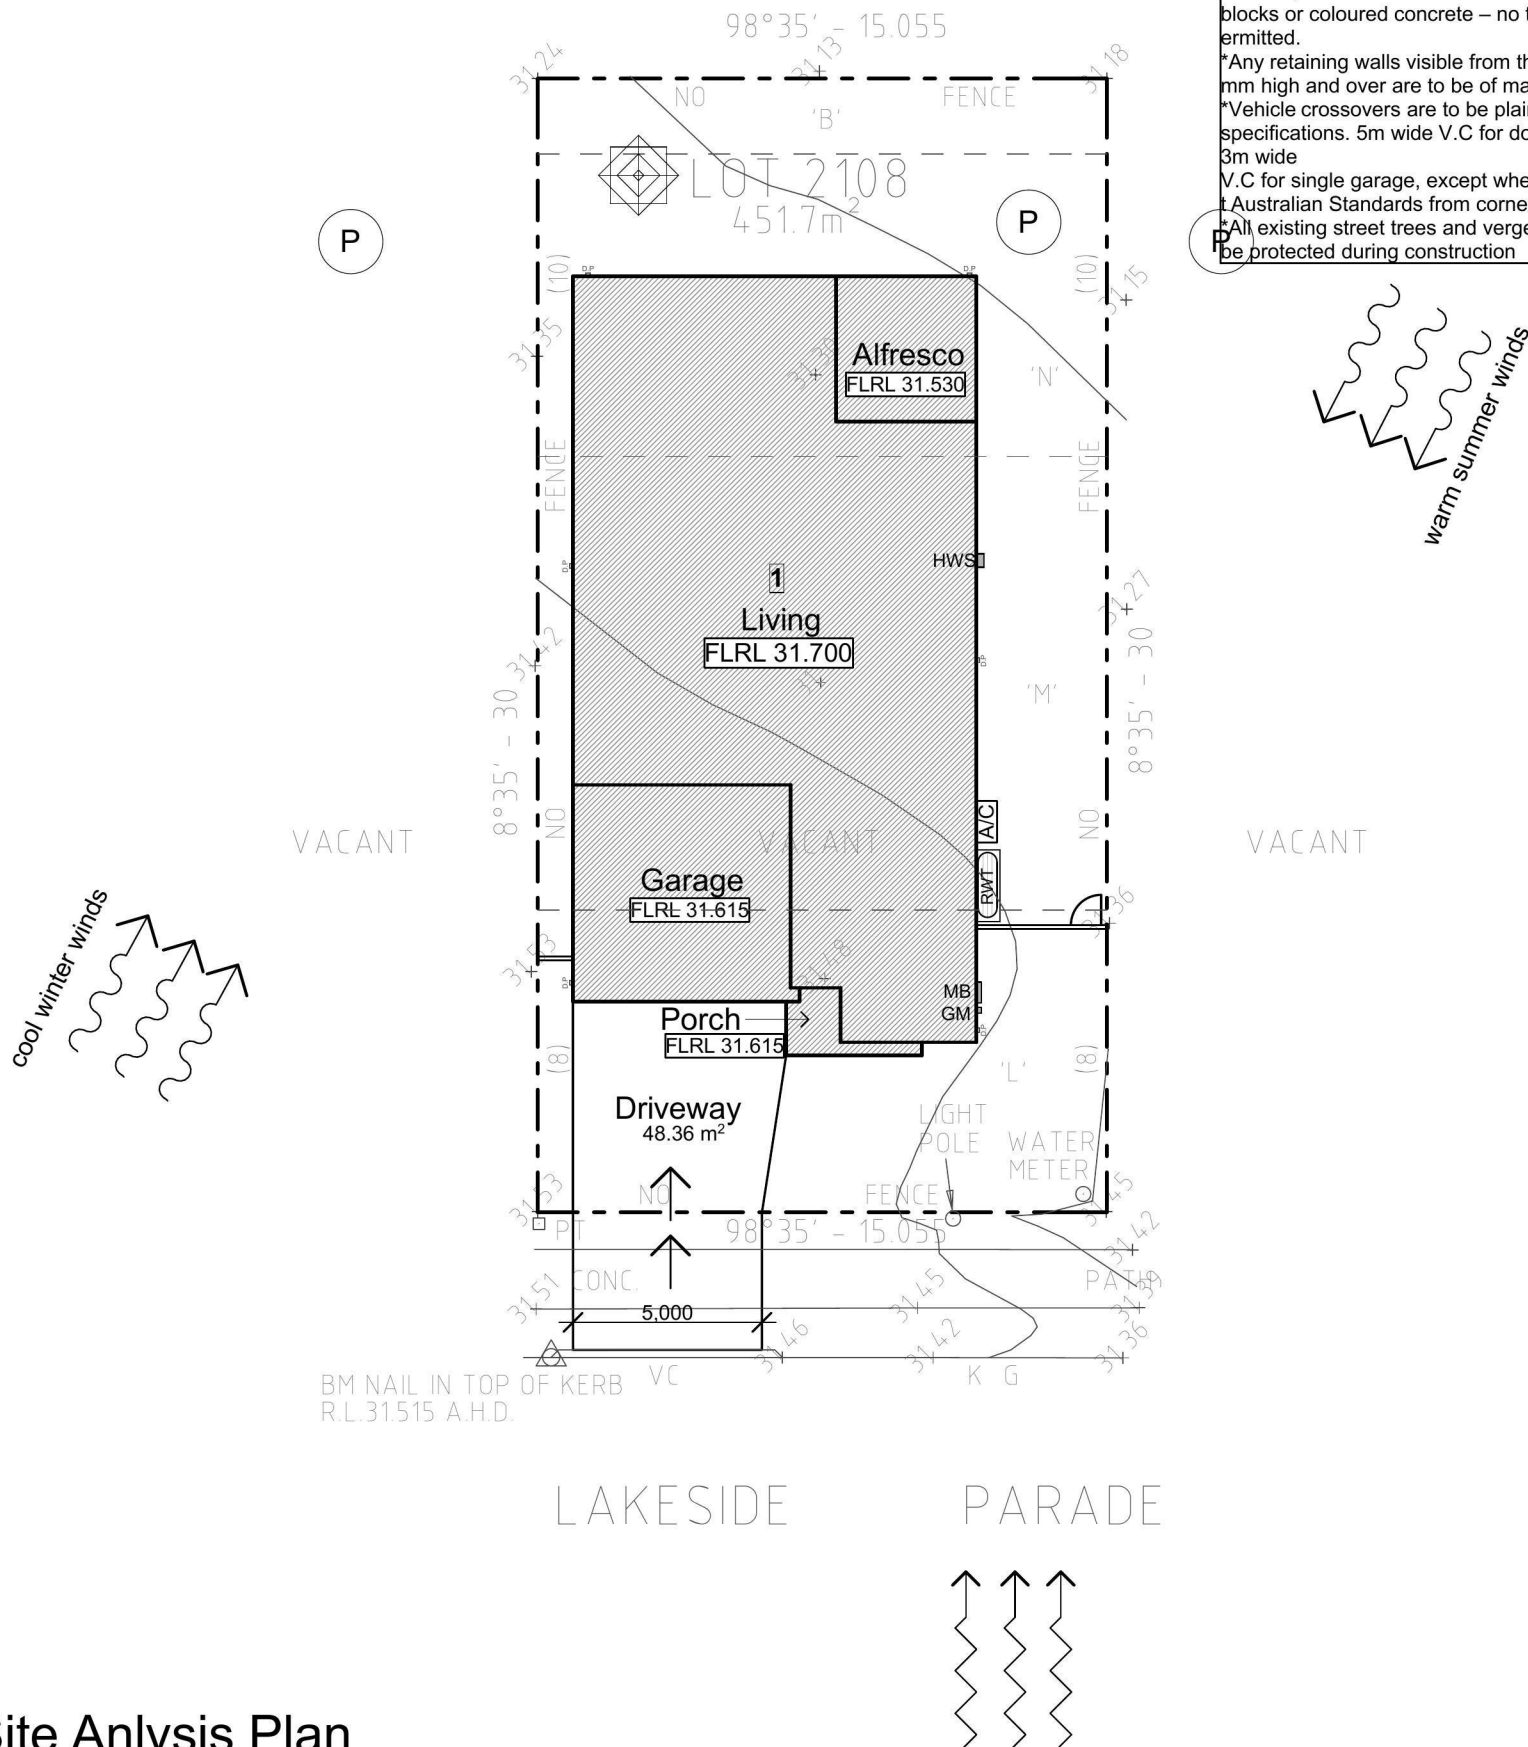
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New Single Storey Residence

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Client:
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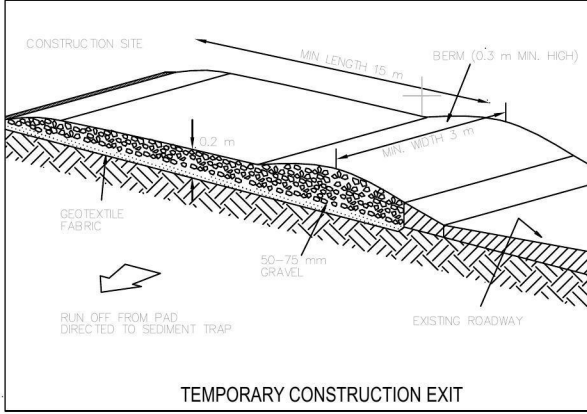
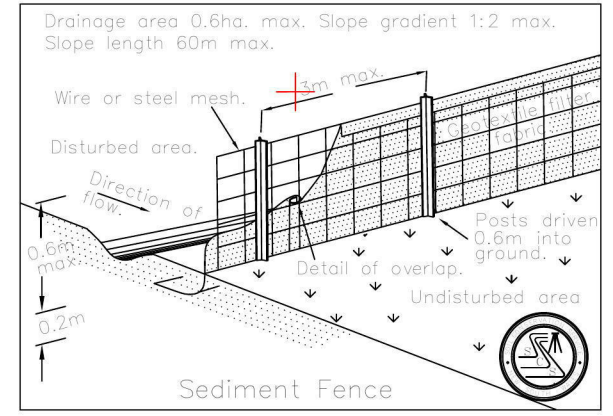
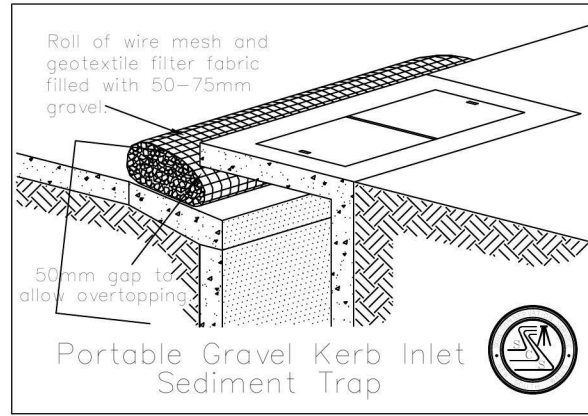
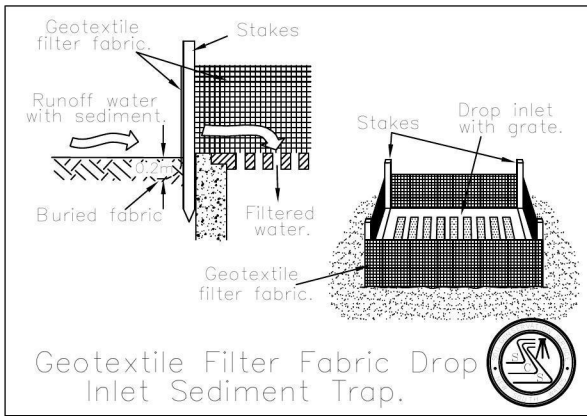
Drawing Title:
Site Analysis Plan

L.G.A

Drawn: JR Date: 15.10.2013
Scale: 1:200 Sheet: 7 of 8



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Job No:
LB1304




Erosion Control
 Temporary sediment and erosion control measures are to be installed prior to commencement of any works on the site. These measures must be maintained in working order during construction works up to completion. All sediment traps must be cleared on a regular basis and after major storm and/or as directed by the Principal Certifying Authority and Council officers.

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Sedimentation & Waste Management Plan

scale 1:200

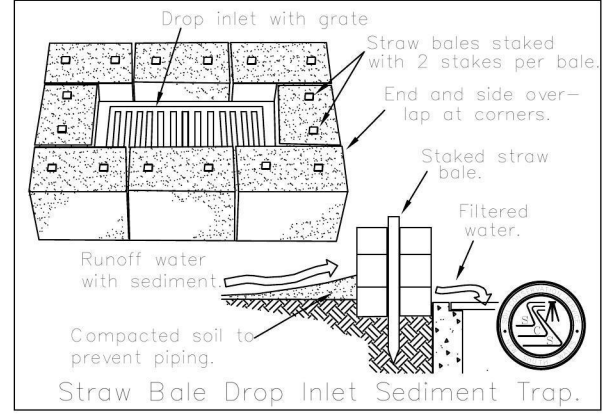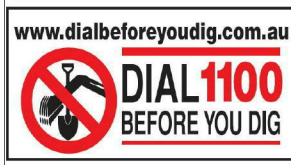Issue	Amendment	Date
A	Sketch Concept	03.07.13
B	Lodgement to Jordan Springs	20.08.13
C	Council Lodgement	15.10.13
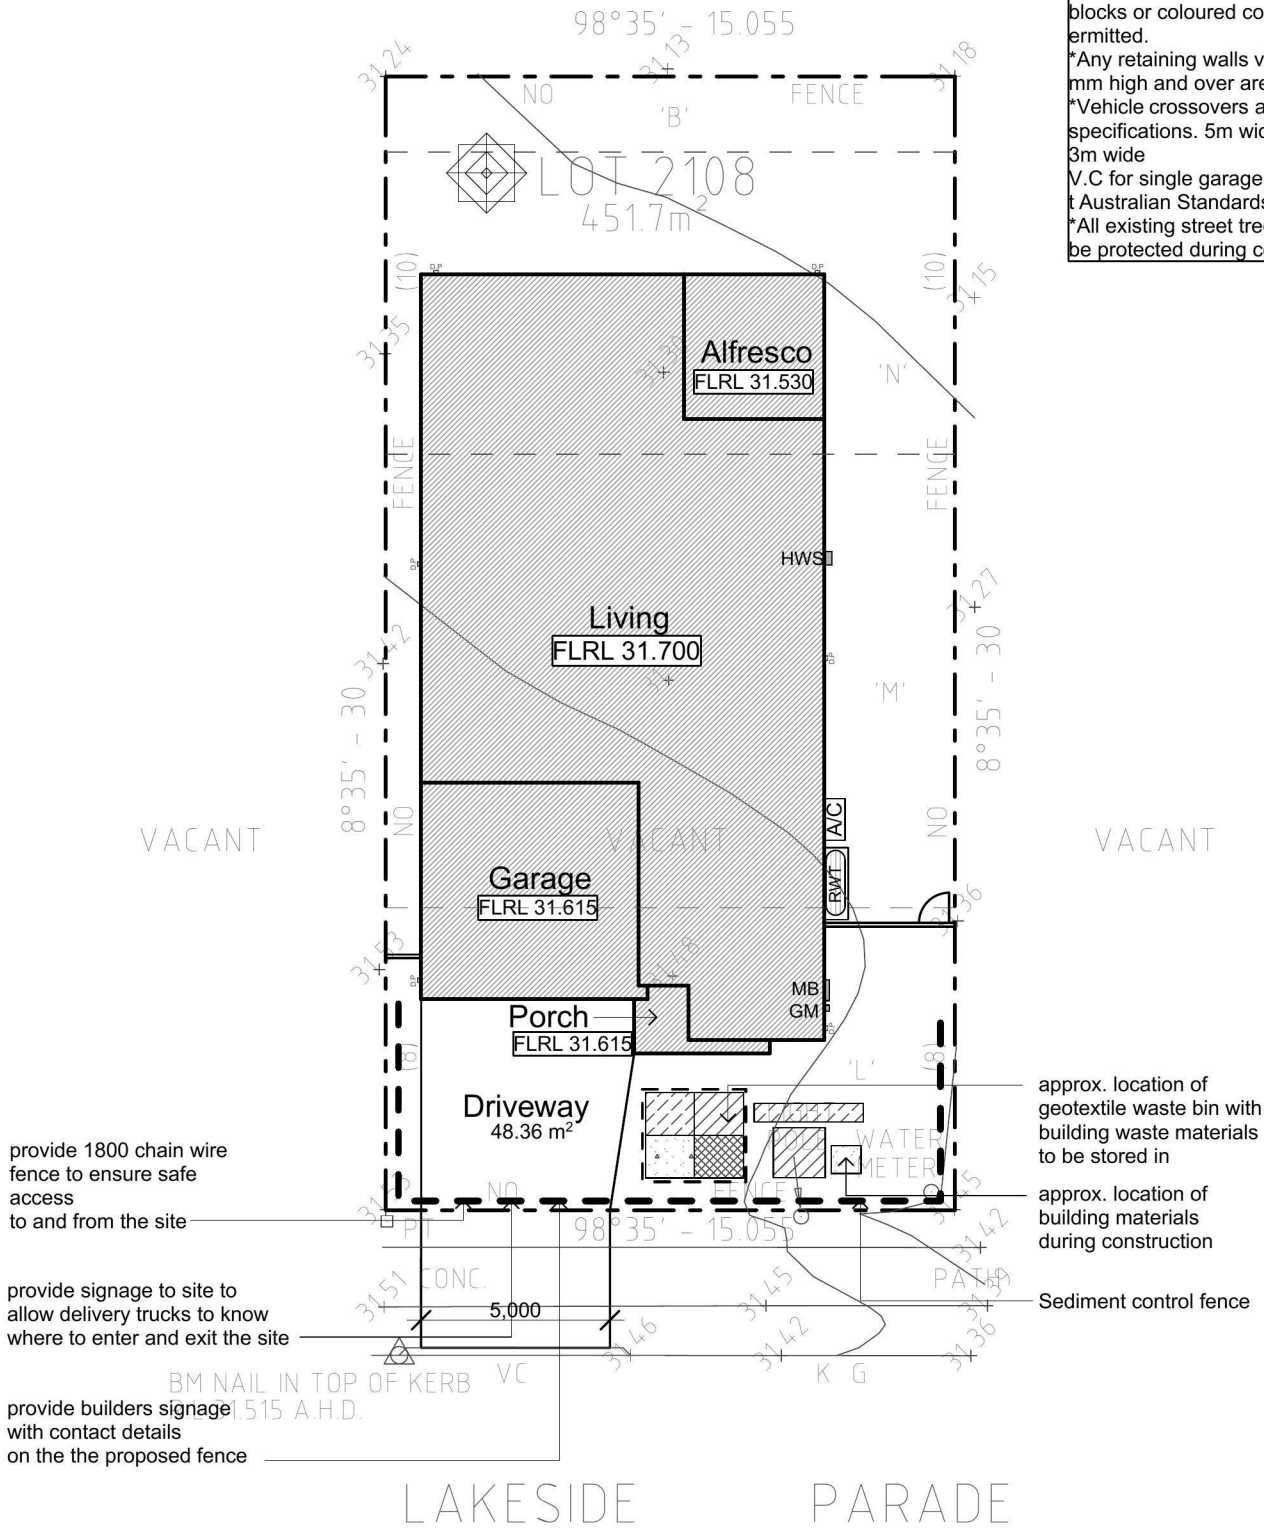
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Proposed: **New Single Storey Residence**

Location: Lot 2108 in DP 1168991 Lakeside Parade, Jordan Springs, NSW

Client: **LB Homes**

Drawing Title: **Soil Sedimentation & Waste Management**

L.G.A

Drawn: **JR** Date: **15.10.2013**

Scale: **1:200** Sheet: **8 of 8**

Revision: **C**

Job No: **LB1304**

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Living Area:	160.91m ²
Porch:	3.20m ²
Alfresco:	14.25m ²
Garage:	33.09m ²
TOTAL:	22.73SQ 211.45m ²
Courtyard:	
Required:	90.34m ²
Proposed:	138.17m ²
Provide 6 x 4 Dim:	Yes



General Notes:


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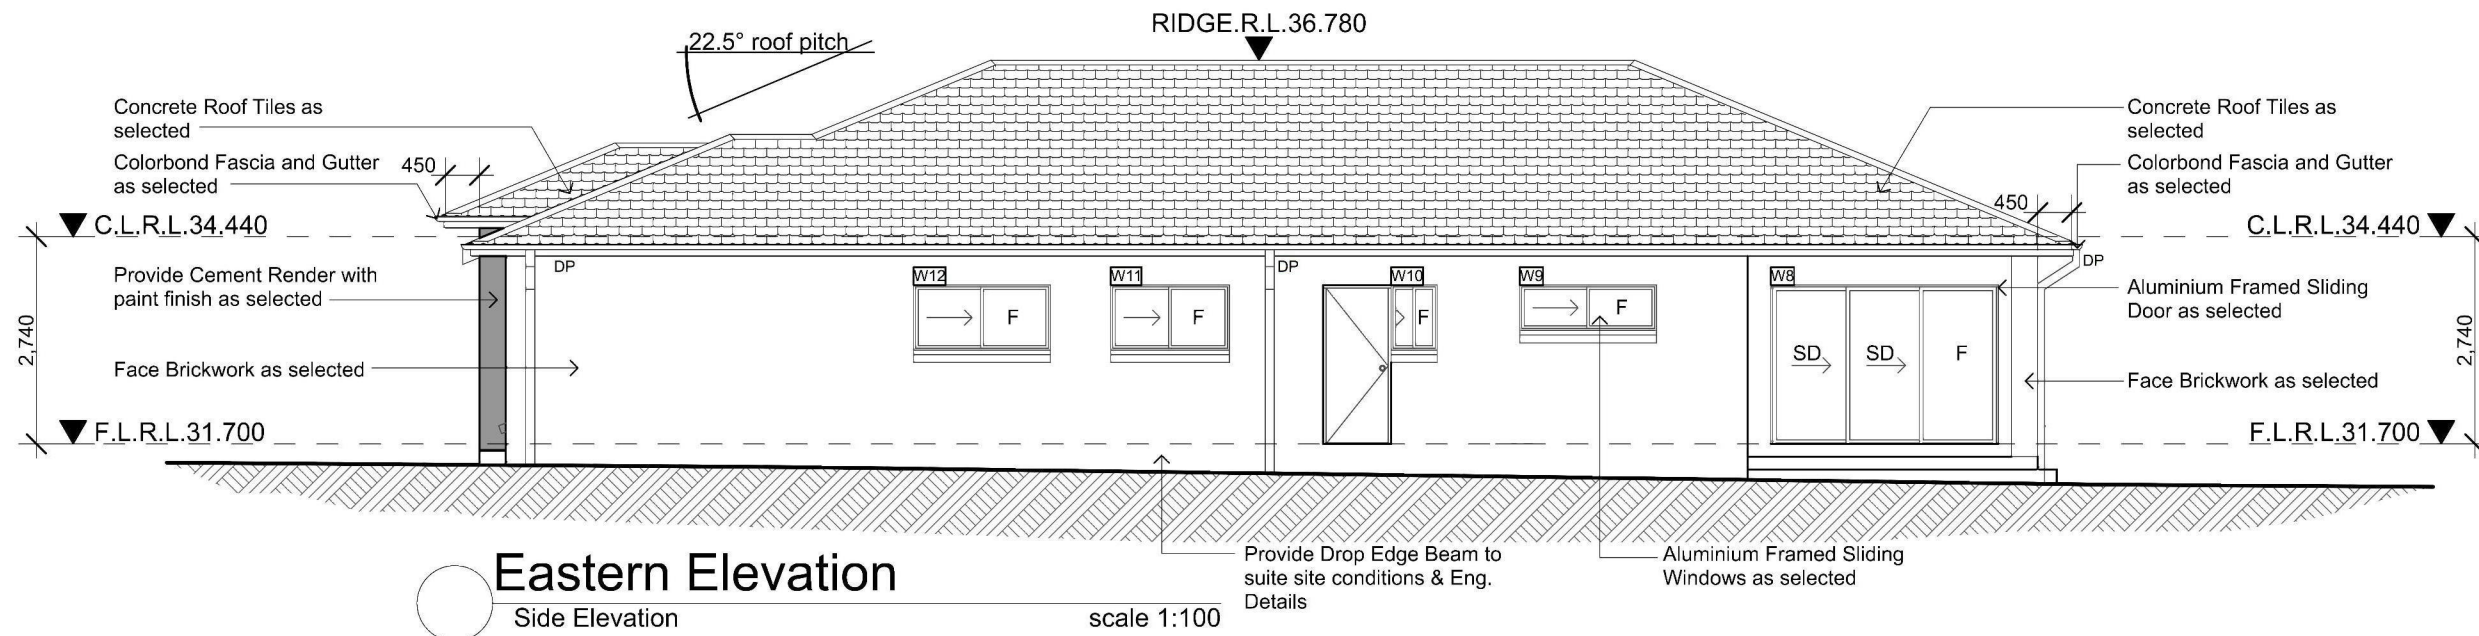
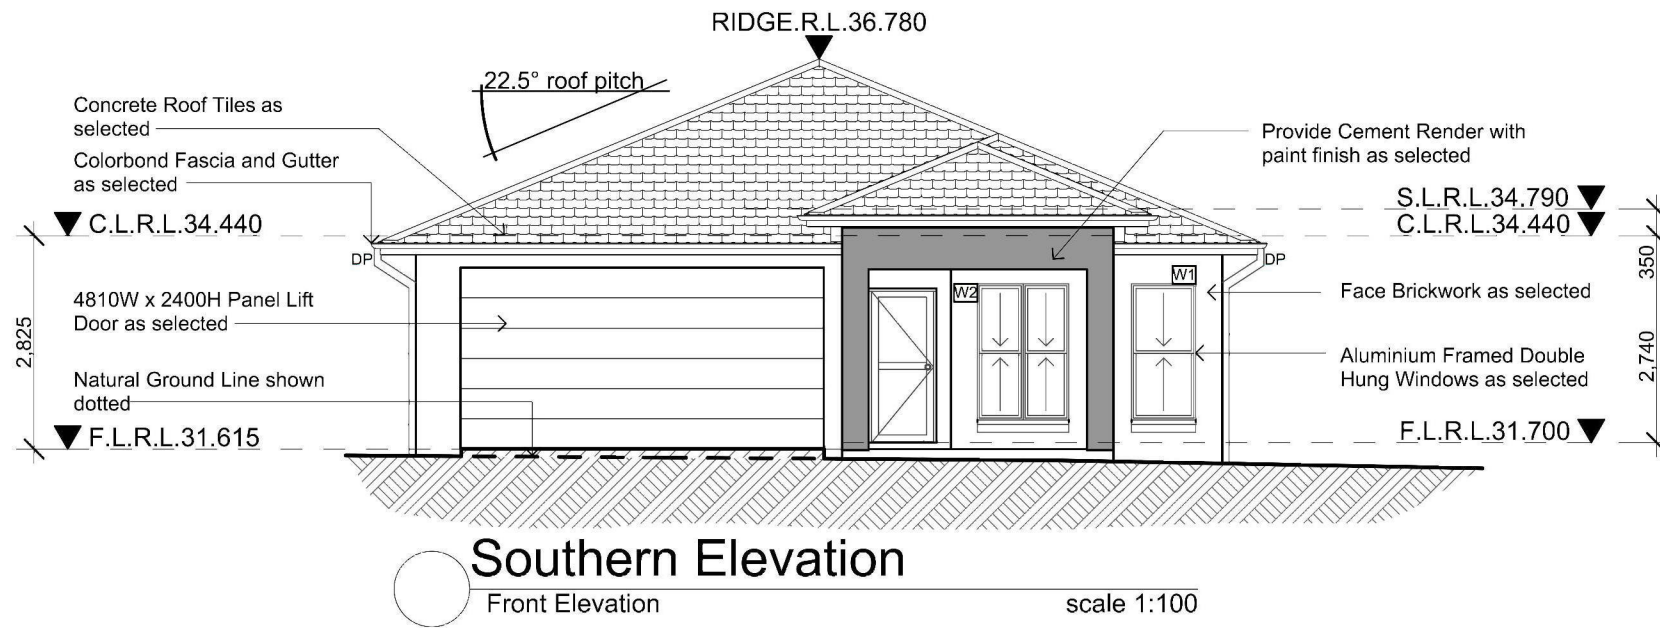
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Proposed Site Plan scale 1:200

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A	Sketch Concept	03.07.13			New Single Storey Residence	Proposed Site Plan / Concept Drainage Plan		C
B	Lodgement to Jordan Springs	20.08.13			Location:	L.G.A		Job No:
C	Council Lodgement	15.10.13	Address: 448 - 452 Victoria Street, Wetherill Park, NSW 2164	Client:	LB Homes	Drawn: JR	Date: 15.10.2013	
						Scale: 1:200	Sheet: 2 of 8	LB1304



Issue	Amendment	Date:
A	Designs	19.04.13
B	Lodgement to Jordan Springs	20.08.13
C	Council Submission	15.10.13

JR DESIGN & DRAFTING
RESIDENTIAL DESIGN & DRAFTING SERVICES

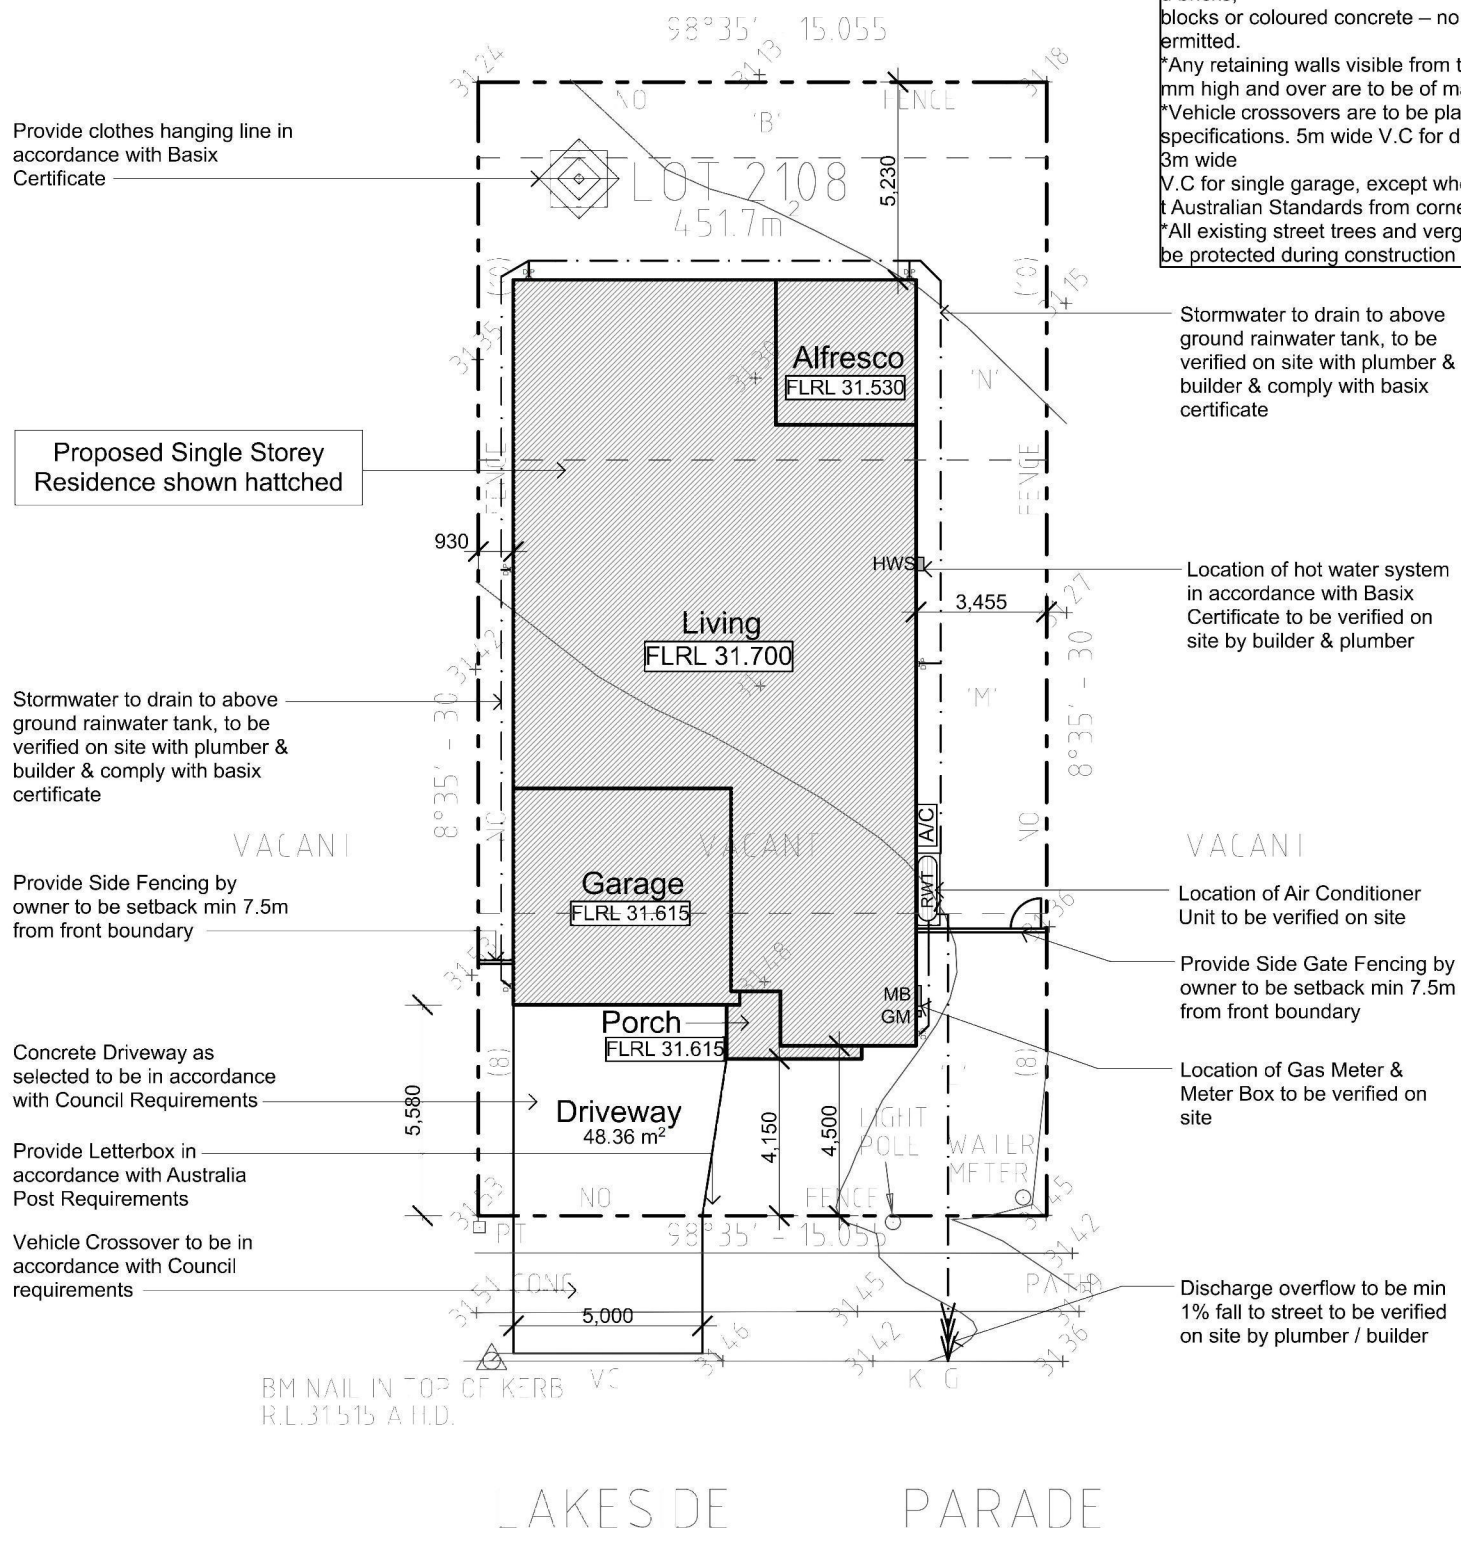Phone: (02) 9757 - 4002 Fax: (02) 9757 - 4003
Email: jr.design.drafting@gmail.com
Address: 448 - 452 Victoria Street, Wetherill Park, NSW 2164

Note:
Builder shall check and verify all dimensions prior to the commencement of any work

North:

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General Notes

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Proposed:
New Single Storey Residence

Location:
Lot 2108 in DP 1168991 Lakeside Parade, Jordan Springs, NSW

Client:
LB Homes

Drawing Title:
Southern Elevation Eastern Elevation



L.G.A

Drawn **JR** Date **15.10.2013**

Scale **1:100** Sheet **5 of 8**

Revision:
C

Job No:
LB1304

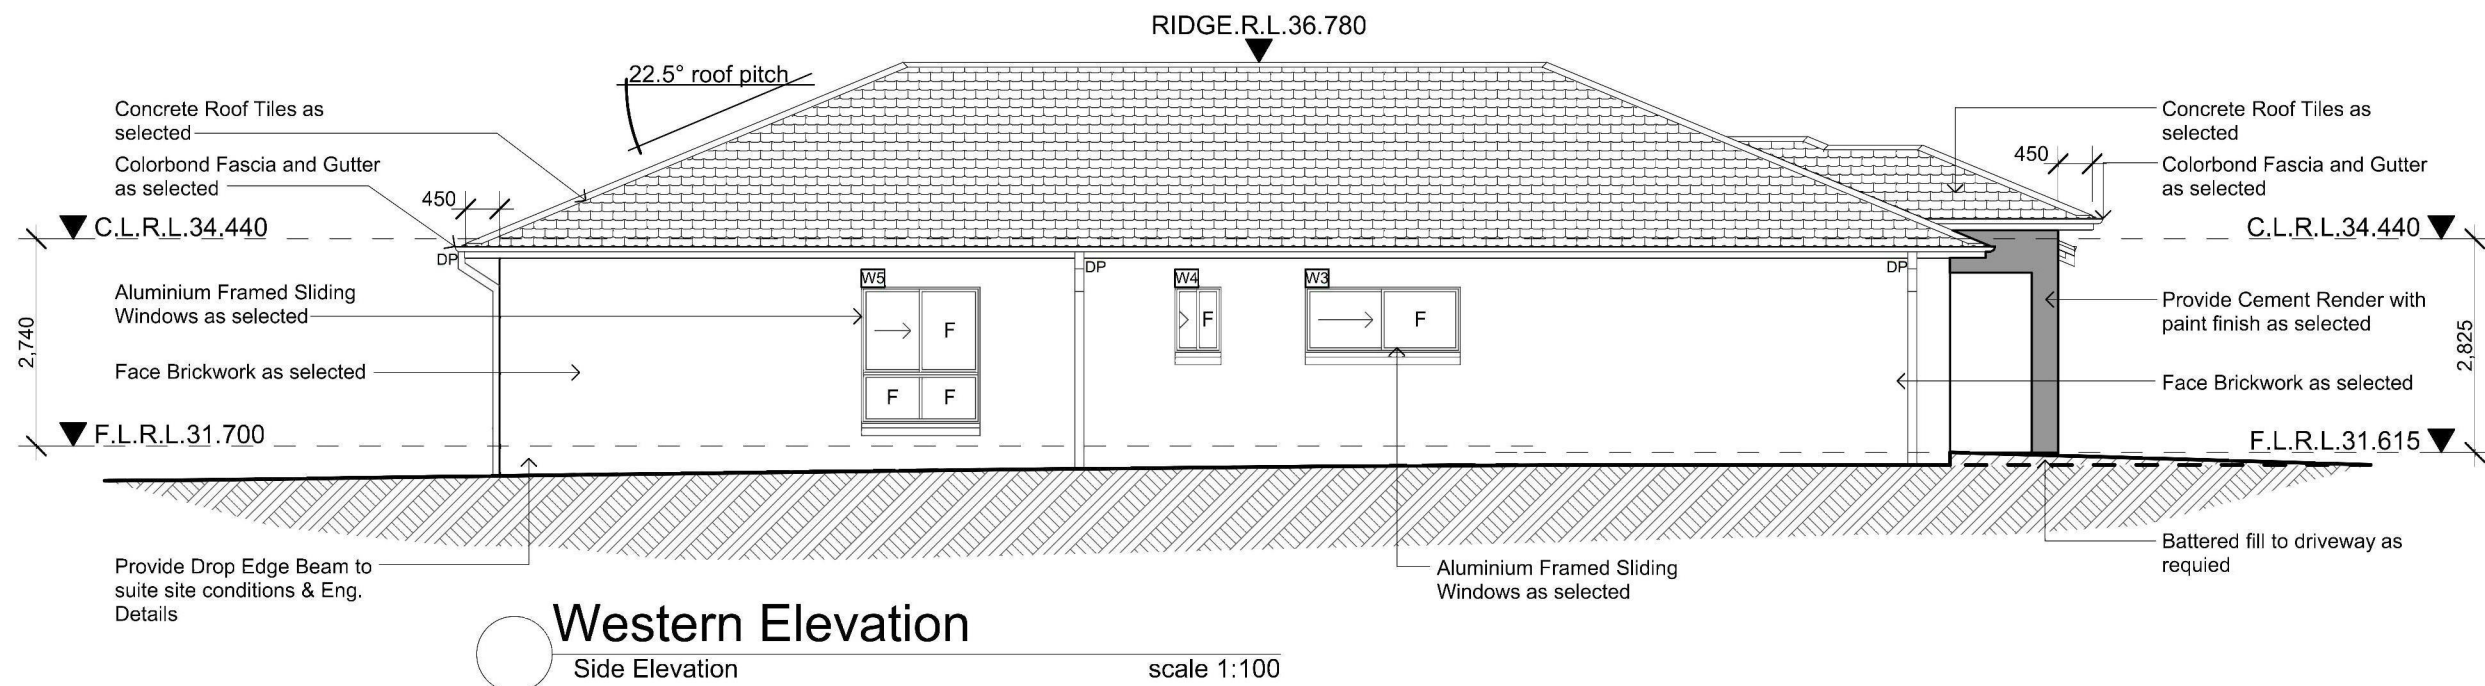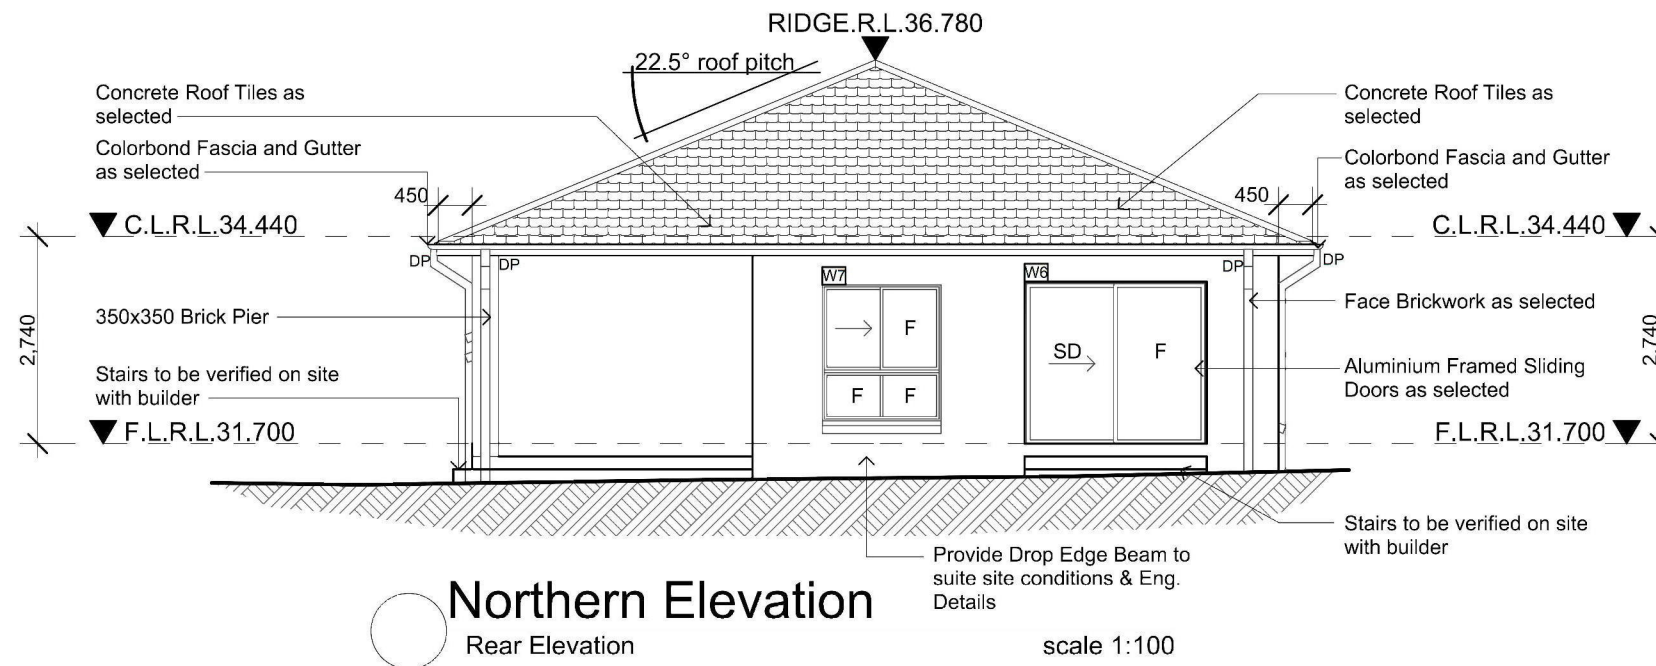

Issue	Amendment	Date:
A	Designs	19.04.13
B	Lodgement to Jordan Springs	20.08.13
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Proposed:
New Single Storey Residence

Location:
Lot 2108 in DP 1168991 Lakeside Parade, Jordan Springs, NSW

Client:
LB Homes


Drawing Title:
Southern Elevation
Eastern Elevation

L.G.A

Drawn: JR Date: 15.10.2013
Scale: 1:100 Sheet: 6 of 8

Revision:
C

Job No:
LB1304

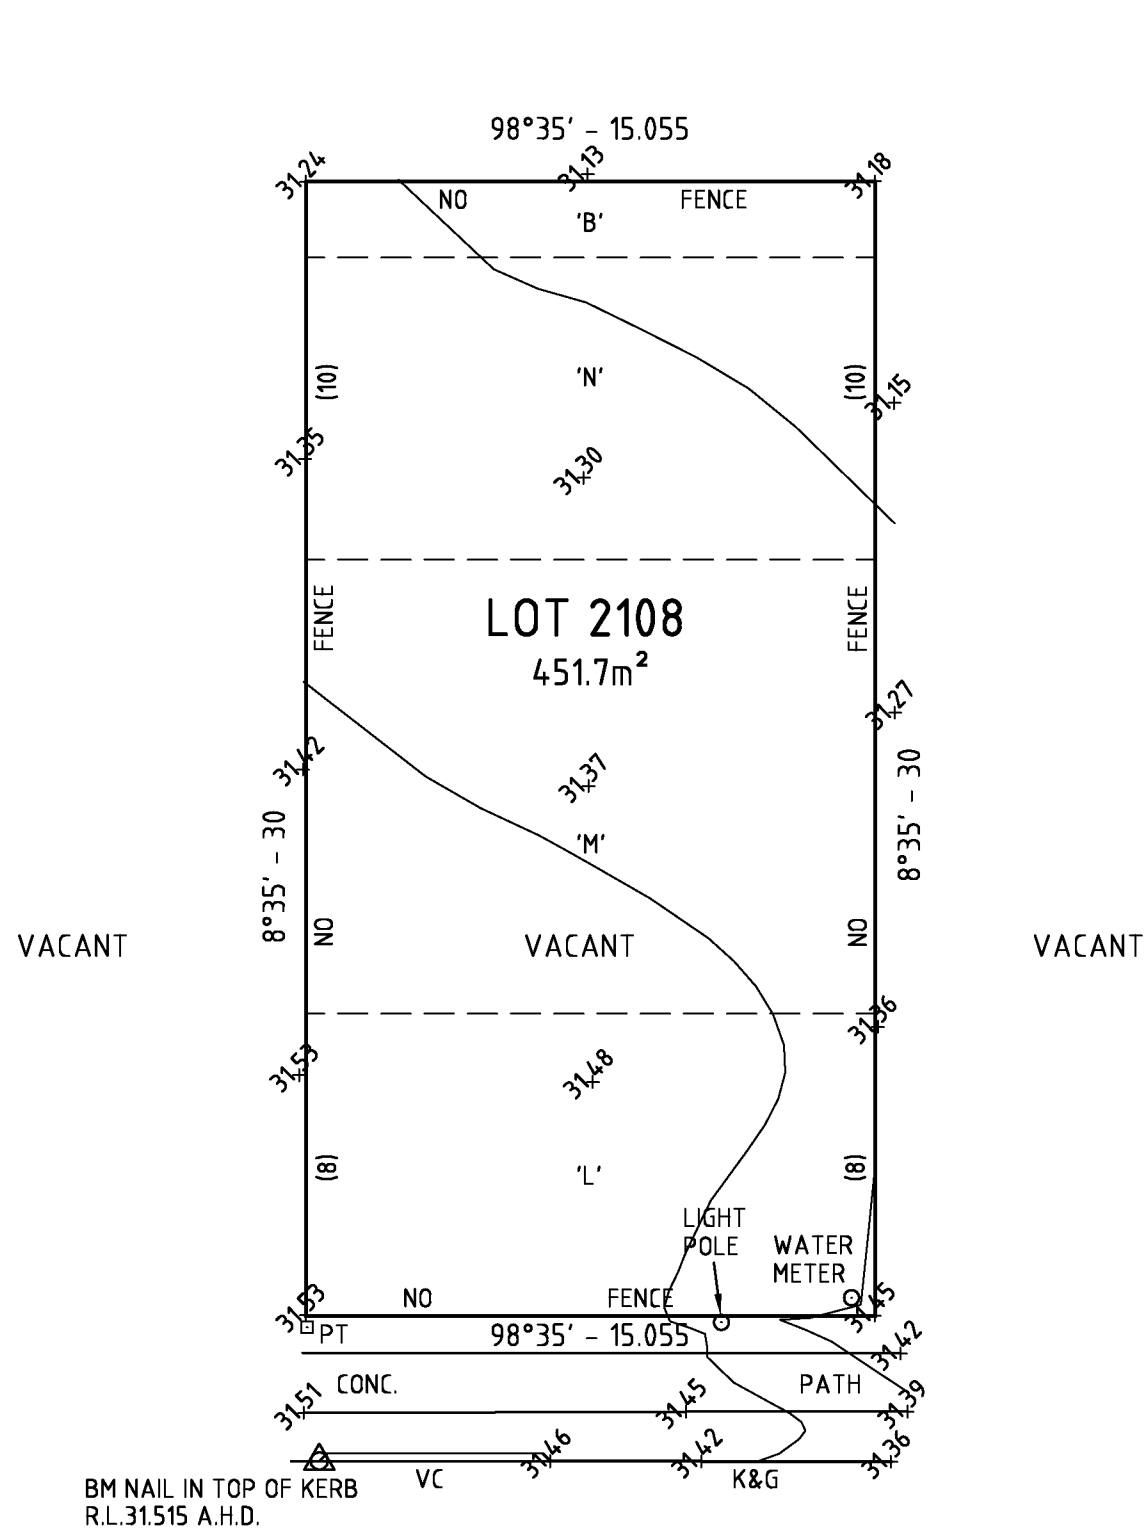

CAUTION

- THIS SURVEY DOES NOT GUARANTEE THE LOCATION OF BOUNDARY PEGS.
- NON-VISIBLE SERVICES HAVE NOT BEEN LOCATED.
- THE CERTIFICATE OF TITLE MUST BE CHECKED FOR EASEMENTS AND ENCUMBRANCES.

ORIGIN OF LEVELS BASED ON
SSM181214 R.L.27.105 A.H.D.
ORIGIN BY OTHERS

'B' EASEMENT TO DRAIN WATER 2 WIDE
'L' RESTRICTION ON THE USE OF LAND
'M' RESTRICTION ON THE USE OF LAND
'N' RESTRICTION ON THE USE OF LAND

WARNING:-

1. Plan compiled from information at Land Titles Office as regards dimensions and these are subject to final survey.
2. All details and features shown hereon have been plotted in relation to the occupations (fences and/or walls, etc.). These occupations have not yet been accurately located in relation to the boundaries.
3. The detail and features and contours are shown to scale plot accuracy only. Copying may distort the scale.
4. Service structures shown hereon are those that were visible at the time of survey and have been located by field survey. Further services may be present. Prior to any construction or excavation on site the relevant authorities should be contacted for possible location of further underground services and detailed locations of all services.

LAKESIDE PARADE

TITLE:
**LEVEL AND FEATURE SURVEY
AT LOT 2108 D.P.1168991
LAKESIDE PARADE
JORDAN SPRINGS**

**ASHER SILCOCK CONSULTING
PTY LTD**
A.C.N. 155 115 790
2/231 Maroubra Rd, Maroubra, NSW 2035
PHONE: 0408446567
EMAIL: steve@asherconsulting.com.au

CIVIL AND RESIDENTIAL SURVEYORS

REV.	AMENDMENT	DATE	CHEC.
REDUCTION RATIO: 1:200		DATE: 26/6/13	
DRAWING No. 13680ts		JOB No. 13680	
DATUM: A.H.D.	DRAWN BY: DB	CHECKED BY:	APPROVED BY:
SHEET: 1 OF 1	DATE: 26/6/13	DATE:	DATE:

LEGEND	
	Proposed tree plantings
	Proposed shrub plantings
	Proposed groundcover & native grass plantings
	Coloured concrete driveway / path pavement
	Non slip patio pavement
	Proposed garden bed
	Proposed turfed area
	Coloured concrete flush edge or brick garden edge

Notes:
 • Refer Architects drawings for pavement, walls, fence, steps, and levels
 • Refer Engineers drawings for hydraulic information

SPECIFICATION NOTES

PLANTING MATERIALS
Planting Mix:
 Imported planting mix to planting beds is to comprise an approved soil mix of:
 • 60% Soil mix (75% coarse sand and 25% blacksoil)
 • 10% Mushroom compost
 • 10% Composted sawdust
 • 10% Pine bark fines
 • 10% Composted manure

Mulch:
 Mulch shall mean Hort-Bark (15mm grade), free from material derived from Privet, Willow, Poplar, Coral trees, or other noxious weeds. Any mulch exceeding the 25mm grade shall be rejected / removed from the site. Graded pine bark mulch (ANL code MHB) to be supplied by Australian Native Landscapes Pty Ltd Phone (02) 9450 1444, or approved equivalent.

Plant Material:
 All plant material must be true to the species. No substitutes will be allowed. All plants shall be free of fungus and insect damage. All plants shall be healthy, well shaped, not soft or force grown and not root bound.

Turfed areas:
 All new turfed areas are to be selected weed free Soft Leaf Buffalo (eg. Sir Walter). Turf shall be laid neatly butted with staggered joints, flush with adjacent surfaces and have even running falls to all drainage points.

All new turfed area shall have a minimum 150mm depth of weed free top soil, placed and levelled prior to turfing.



PREPARATION AND HARDWORKS
Excavating for Spot Planting
 To planting areas, excavate a hole for each plant large enough to provide not less than twice the depth and twice the diameter than the root ball of species to be planted.

Staking
 Use durable hardwood, straight, free from knots or twists, pointed at one end. Drive stakes into the ground a minimum one third of their length, avoiding damage to the root system.
 • 45 Litre trees in 2 x 38x38x1800mm Hardwood Stake with double Nylon tie
 TIES: Provide a 50mm wide Nylon webbing tie per stake, fixed securely to the stakes, one tie at half the height of the main stem and the other as necessary to stabilise the plant.


Coloured concrete Edge
MATERIALS: Concrete to be dark grey colour.
INSTALLATION: Supply and install 100 x 150mm reinforced flush concrete kerb to locations as approved on site by the Superintendent. Provide flexible joints at maximum 3 metre intervals in colour to match concrete. Lightly expose aggregate through rinsing / sponging. Tool finish exposed edges with 10mm pencil round to prevent chipping.

MAINTENANCE / PLANT ESTABLISHMENT
 - Landscape Contractors to provide 13 weeks for maintenance / plant establishment period. Carry out recurrent works of a maintenance nature including, but not limited to, watering, mowing, weeding, rubbish removal, fertilising, pest and disease control, returfing, staking and tying, replanting, cultivating, pruning, hedge clipping, top dressing, and keeping the site neat and tidy.
NOTE:
 - All finished levels are to be verified by Contractor on site.
 - All landscape works be in strict accordance with Council's landscape code and guidelines
 - This plan to be used in conjunction with all other submitted architectural, hydraulics and engineering drawing where applicable.

JORDAN SPRINGS - ILLOURA VILLAGE NOTES:
 • Any garden or lawn edging visible from the street is to be constructed of masonry textured or coloured bricks, blocks or coloured concrete – no timber edging is permitted.
 • Any retaining walls visible from the street or 900mm high and over are to be of masonry construction.
 • Vehicle crossovers are to be plain concrete to PCC specifications. 5m wide V.C for double garage and 3m wide V.C for single garage.
 • All existing street trees and verge planting are to be protected during construction.

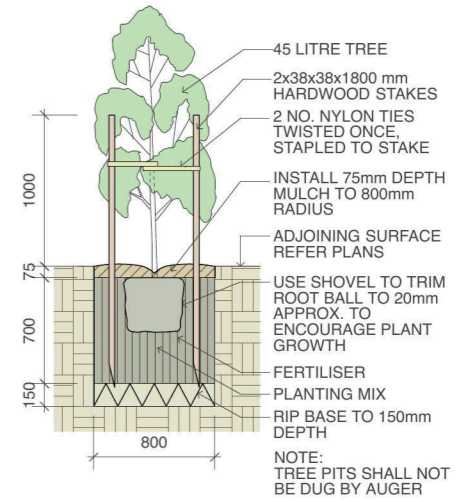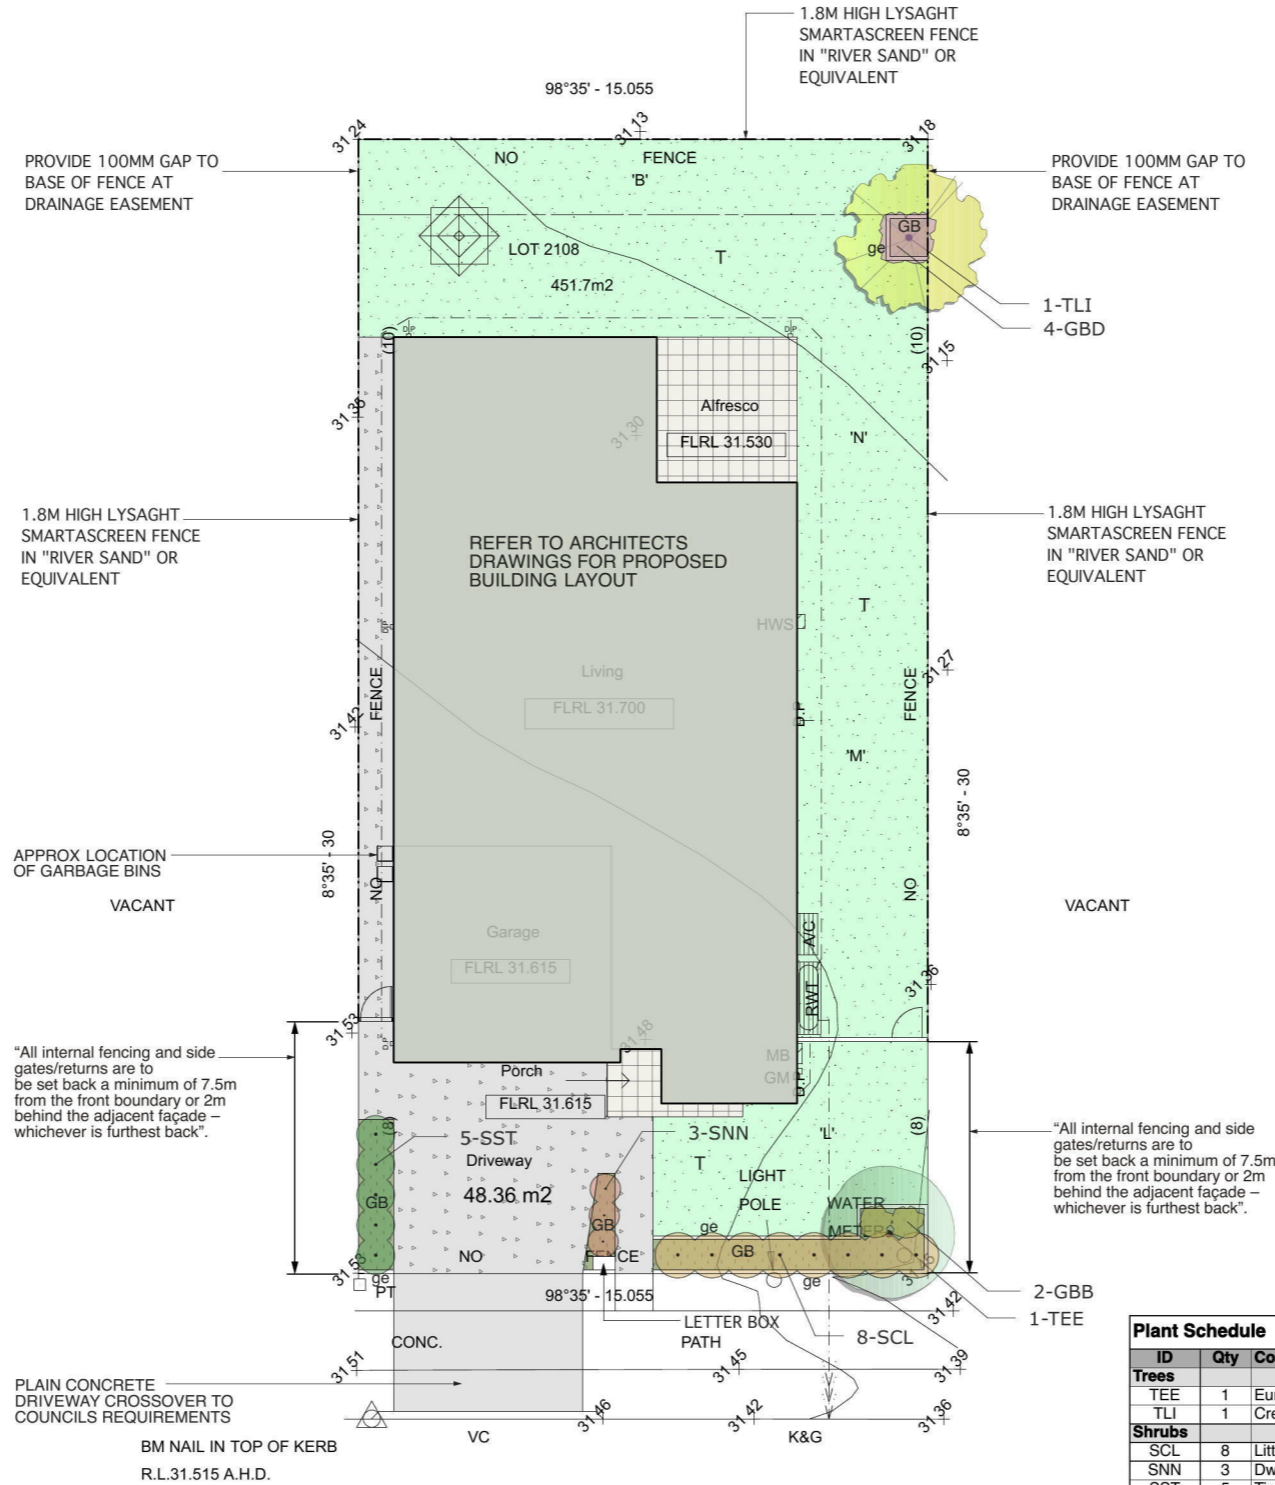

1 45 Litre Tree Planting scale 1:50

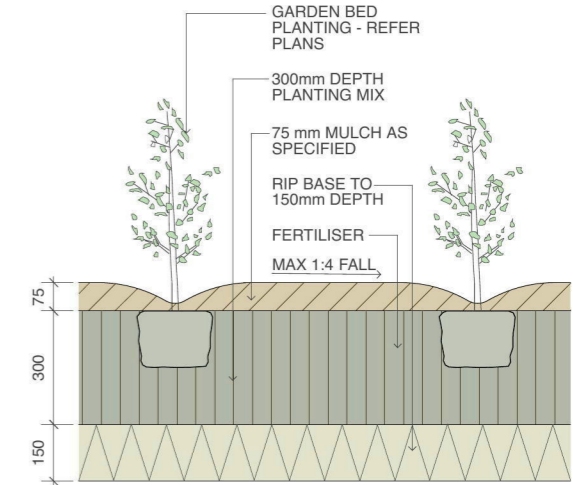

2 Planting Bed Detail scale 1:20

Plant Schedule							
ID	Qty	Common Name	Botanical Name	Size	Mature Height	Mature Spread	Native (N)
Trees							
TEE	1	Eumundi Quandong	Elaeocarpus eumundi	45Litre	6 - 8m	3.5 - 6m	N
TL1	1	Crepe Myrtle	Lagerstroemia indica 'Natchez'	45Litre	6-8m	3.5 - 6m	
Shrubs							
SCL	8	Little John	Callistemon 'Little John'	200mm	0.9 - 1.5m	0.9 - 1.2m	N
SNN	3	Dwarf Sacred Bamboo	Nandina domestica 'Nana'	150mm	0.6m	0.8m	
SST	5	Tiny Trev	Syzygium australe 'Tiny Trev'	200mm	0.8 - 1m	0.6 - 0.8m	N
Native Grasses & Ground Covers							
GBD	4	Break O Day	Brachyscome multifida	150mm	0.45 - 0.6m	0.9 - 1.2m	N
GBB	2	Birthday Candle	Banksia spinulosa 'Birthday Candle'	150mm	0.45 - 0.6m	0.9 - 1.2m	N

NOTE : 80% OF NATIVE PLANT SPECIES ARE PROPOSED

GENERAL NOTES: 1. Do not scale of drawings. Follow written dimensions. If in doubt obtain written advice from the Superintendent. 2. Verify all dimensions on site. 3. Refer to legend for all symbol and code keys. 4. Read in conjunction with the specifications 5. Read in conjunction with all associated drawings	DESIGNED: GD	PREPARED FOR: <i>LB HOMES</i>	LANDSCAPE ARCHITECTS: GREENLAND DESIGN Pty Ltd ABN 73 139 152 855 Landscape Architect. C. Ly I AILA Mob.: 0403 164 198	PROJECT: NEW RESIDENCE	DRAWING TITLE: Landscape Plan	DATE: AUGUST 2013
	DRAWN: CL			PROJECT ADDRESS: LOT 2108 LAKESIDE PDE, JORDAN SPRINGS		SCALE: 1:200 FULL SIZE: A3 ISSUE: A
A	FOR APPROVAL	CL	27.08.13			DRAWING NO: LB1304.L.01
ISSUE	AMENDMENT	DRAWN	DATE			



LEGEND


- Proposed tree plantings
- Proposed shrub plantings
- Proposed groundcover & native grass plantings
- Coloured concrete driveway / path pavement
- Non slip patio pavement
- Proposed garden bed
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- Coloured concrete flush edge or brick garden edge

Notes:


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2 Planting Bed Detail scale 1:20

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PREPARATION AND HARDWORKS


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 • This plan to be used in conjunction with all other submitted architectural, hydraulics and engineering drawing where applicable.

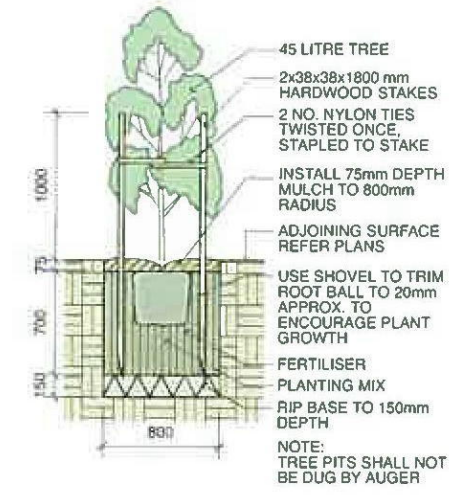

Reviewed by LEND LEASE COVENANT MANAGER
 - 4 OCT 2013
 Signed: [Signature]

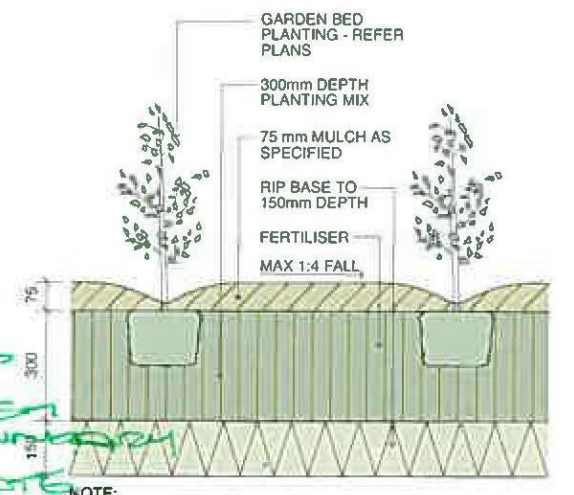REPORTS WATER TANK TO ALLOW SIDE GATES AND RETURN TO BS SET BACK TO 7.5M FROM FRONT BOUNDARY BETWEEN GATE FENCING ON THIS SIDE IS TO BE SET BACK TO 7.5M FROM THE FRONT BOUNDARY AND IS TO BE HORIZONTAL SLAT FENCING IN ACCORDANCE WITH THE GUIDELINES.

Plant Schedule

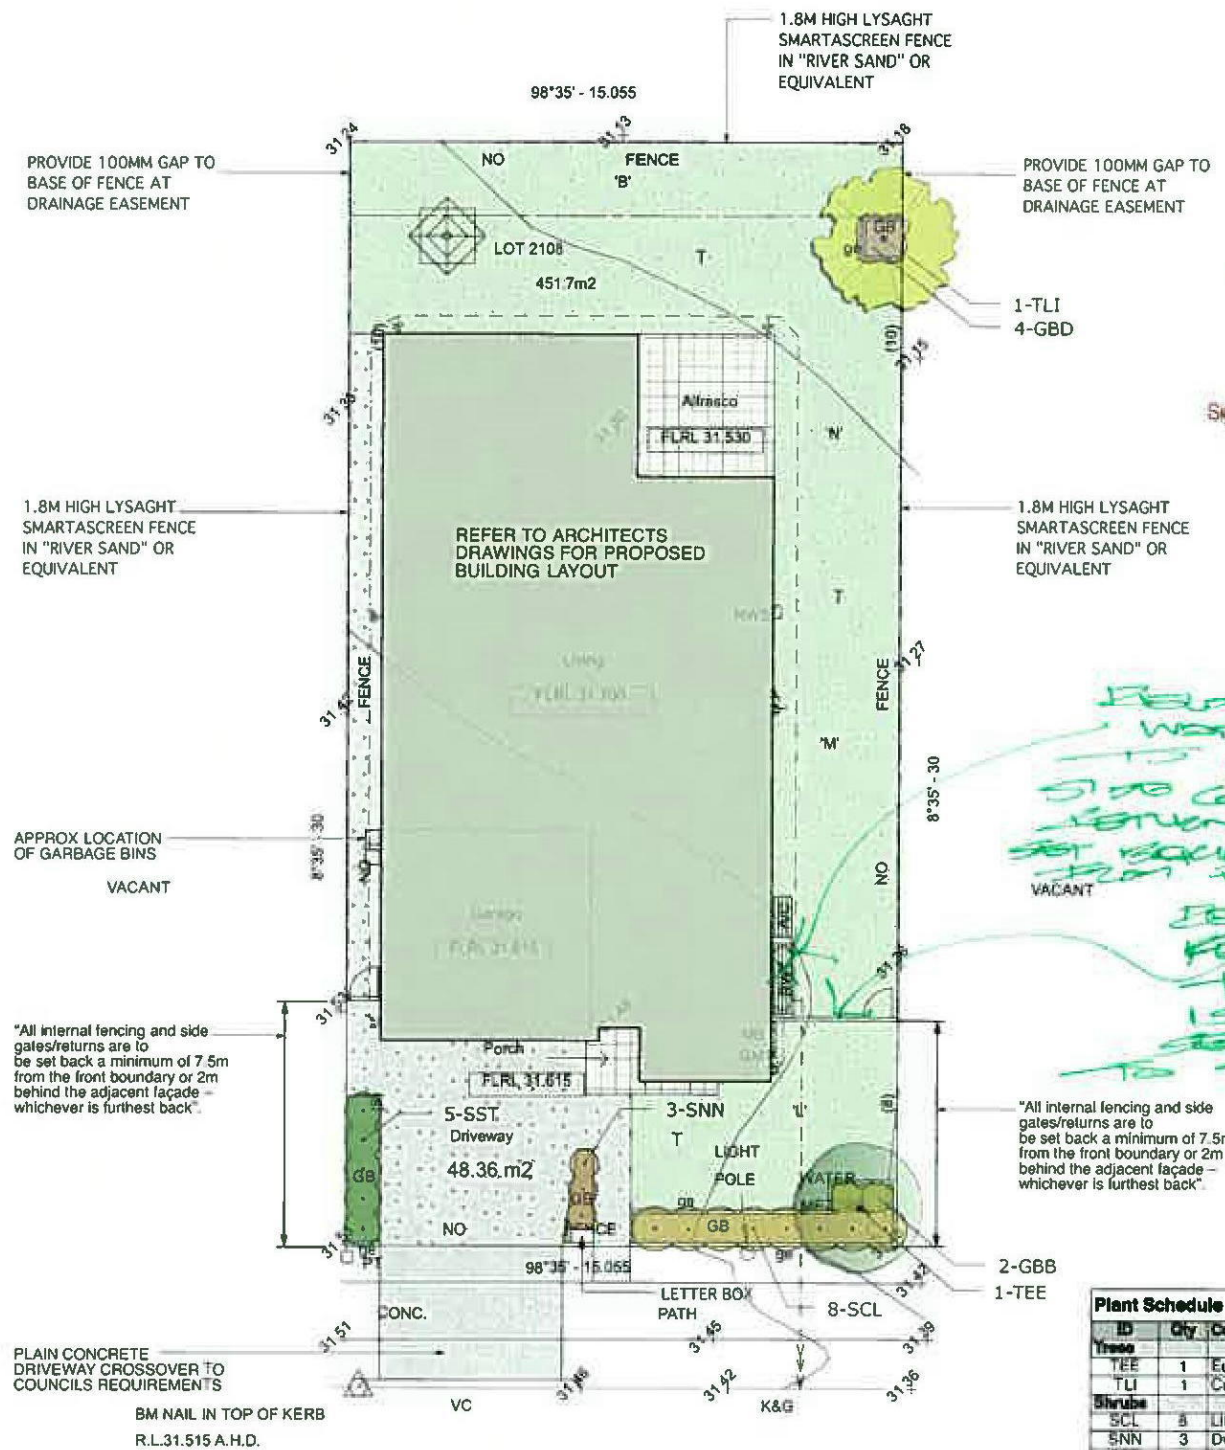ID	Qty	Common Name	Botanical Name	Size	Mature Height	Mature Spread	Native (N)
TEE	1	Eumundi Quandong	Elaeocarpus eumundi	45Litre	6 - 8m	3.5 - 6m	N
TLI	1	Crape Myrtle	Lagerstroemia indica 'Natchez'	45Litre	6-8m	3.5 - 6m	N
Shrubs							
SCL	3	Little John	Callistemon 'Little John'	200mm	0.9 - 1.5m	0.9 - 1.2m	N
SNN	3	Dwarf Sacred Bamboo	Nandina domestica 'Nana'	150mm	0.6m	0.8m	N
SST	5	Tiny Trev	Syzygium australe 'Tiny Trev'	200mm	0.8 - 1m	0.6 - 0.8m	N
Native Grasses & Ground Covers							
GBD	4	Break O Day	Brachycome multifida	150mm	0.45 - 0.6m	0.9 - 1.2m	N
GBB	2	Birthday Candle	Bankisia spinulosa 'Birthday Candle'	150mm	0.45 - 0.6m	0.9 - 1.2m	N

NOTE : 80% OF NATIVE PLANT SPECIES ARE PROPOSED

GENERAL NOTES:

- Do not scale of drawings. Follow written dimensions. If in doubt obtain written advice from the Superintendent.
- Verify all dimensions on site.
- Refer to legend for all symbol and code keys.
- Read in conjunction with the specifications.
- Read in conjunction with all associated drawings.

DESIGNED: GD
 PREPARED FOR: LB HOMES
 DRAWN: CL
 LANDSCAPE ARCHITECTS: GREENLAND DESIGN Pty Ltd
 PROJECT: NEW RESIDENCE
 DRAWING TITLE: Landscape Plan
 PROJECT ADDRESS: LOT 2108 LAKESIDE PDE JORDAN SPRINGS
 DATE: AUGUST 2013
 SCALE: 1:200
 FULL SIZE A3
 DRAWING NO: LB1304.L.01
 ISSUE: A

NOTES: USE FIGURED DIMENSIONS ONLY, DO NOT SCALE.
 * CHECK ALL DIMENSIONS PRIOR STARTING ANY WORK REPORT ANY DISCREPANCIES
 * FINISHED GROUND LEVELS SHOWN ON PLAN ARE SUBJECT TO SITE CONDITIONS
 * ALL CALCULATED DIMENSIONS ARE SUBJECT TO SITE MEASURE DURING CONSTRUCTION
 * NO ALLOWANCE HAS BEN MADE FOR SHRINKAGE OR MILLING
 * POSITION OF ELECTRICAL METER TO BE DETERMINED ON SITE


PROOF OF EXISTENCE OF ALL SERVICES IS THE CONTRACTOR'S RESPONSIBILITY. CURRENT "DIAL BEFORE YOU DIG" SERVICES PLANS MUST BE OBTAINED PRIOR TO COMMENCING ANY EXCAVATION

AREAS:	
Site Plan:	451.70m ²
Living Area:	160.91m ²
Porch:	3.20m ²
Alfresco:	14.25m ²
Garage:	33.09m ²
TOTAL:	22.73SQ 211.45m ²
Court yard:	
Required:	90.34m ²
Proposed:	143.09m ²
Provide 6 x 4 Dim:	Yes



- General Notes:**
- All work to be carried out in accordance with the requirements of the Building Code of Australia and the relevant local authority.
 - All timber framing to be carried out to the requirements of Australian Standards (as 1684) as a minimum.
 - All reinforced concrete, steel beams including supports, and nominated beams including supports to Engineer's details.
 - Structural Engineer to check, detail and certify brickwork to garage area with a height greater than 3000mm between horizontal supports.
 - All brickwork to be constructed in accordance with the requirements of the Building Code of Australia.
 - Control joints in brickwork to be provided in accordance with the requirements of the Building Code of Australia.
 - Doorway openings with inward opening doors to room containing toilets which are closer than 1200mm to the toilet are to be fitted with hinges to allow the door to be removed from the outside when the door is closed.
- Construction Notes:**
- R2.20 External Wall Insulation (Including Construction)
 - R3.0 Ceiling Insulation
 - Provide Foil & Sarking to Roof
 - Control Joints to be checked in accordance with engineers plans
 - Centre of Kitchen Sink, Vanity, WC, Range Hood, to be confirmed with owner & Manufacturer Details.
 - All windows, Insulation requirements, lighting to comply with Basix Certificate Approve by council.
 - Structural slab to engineer details.
 - Metre Box, Gas Metre to be confirmed with Builder on site.
 - Downpipes to be confirmed with plumber on site.

AMEND P.O.S.
 AREA WITH GATE
 AND FENCING SETBACK
 TO 7.5M FROM
 THE FRONT BOUNDARY.

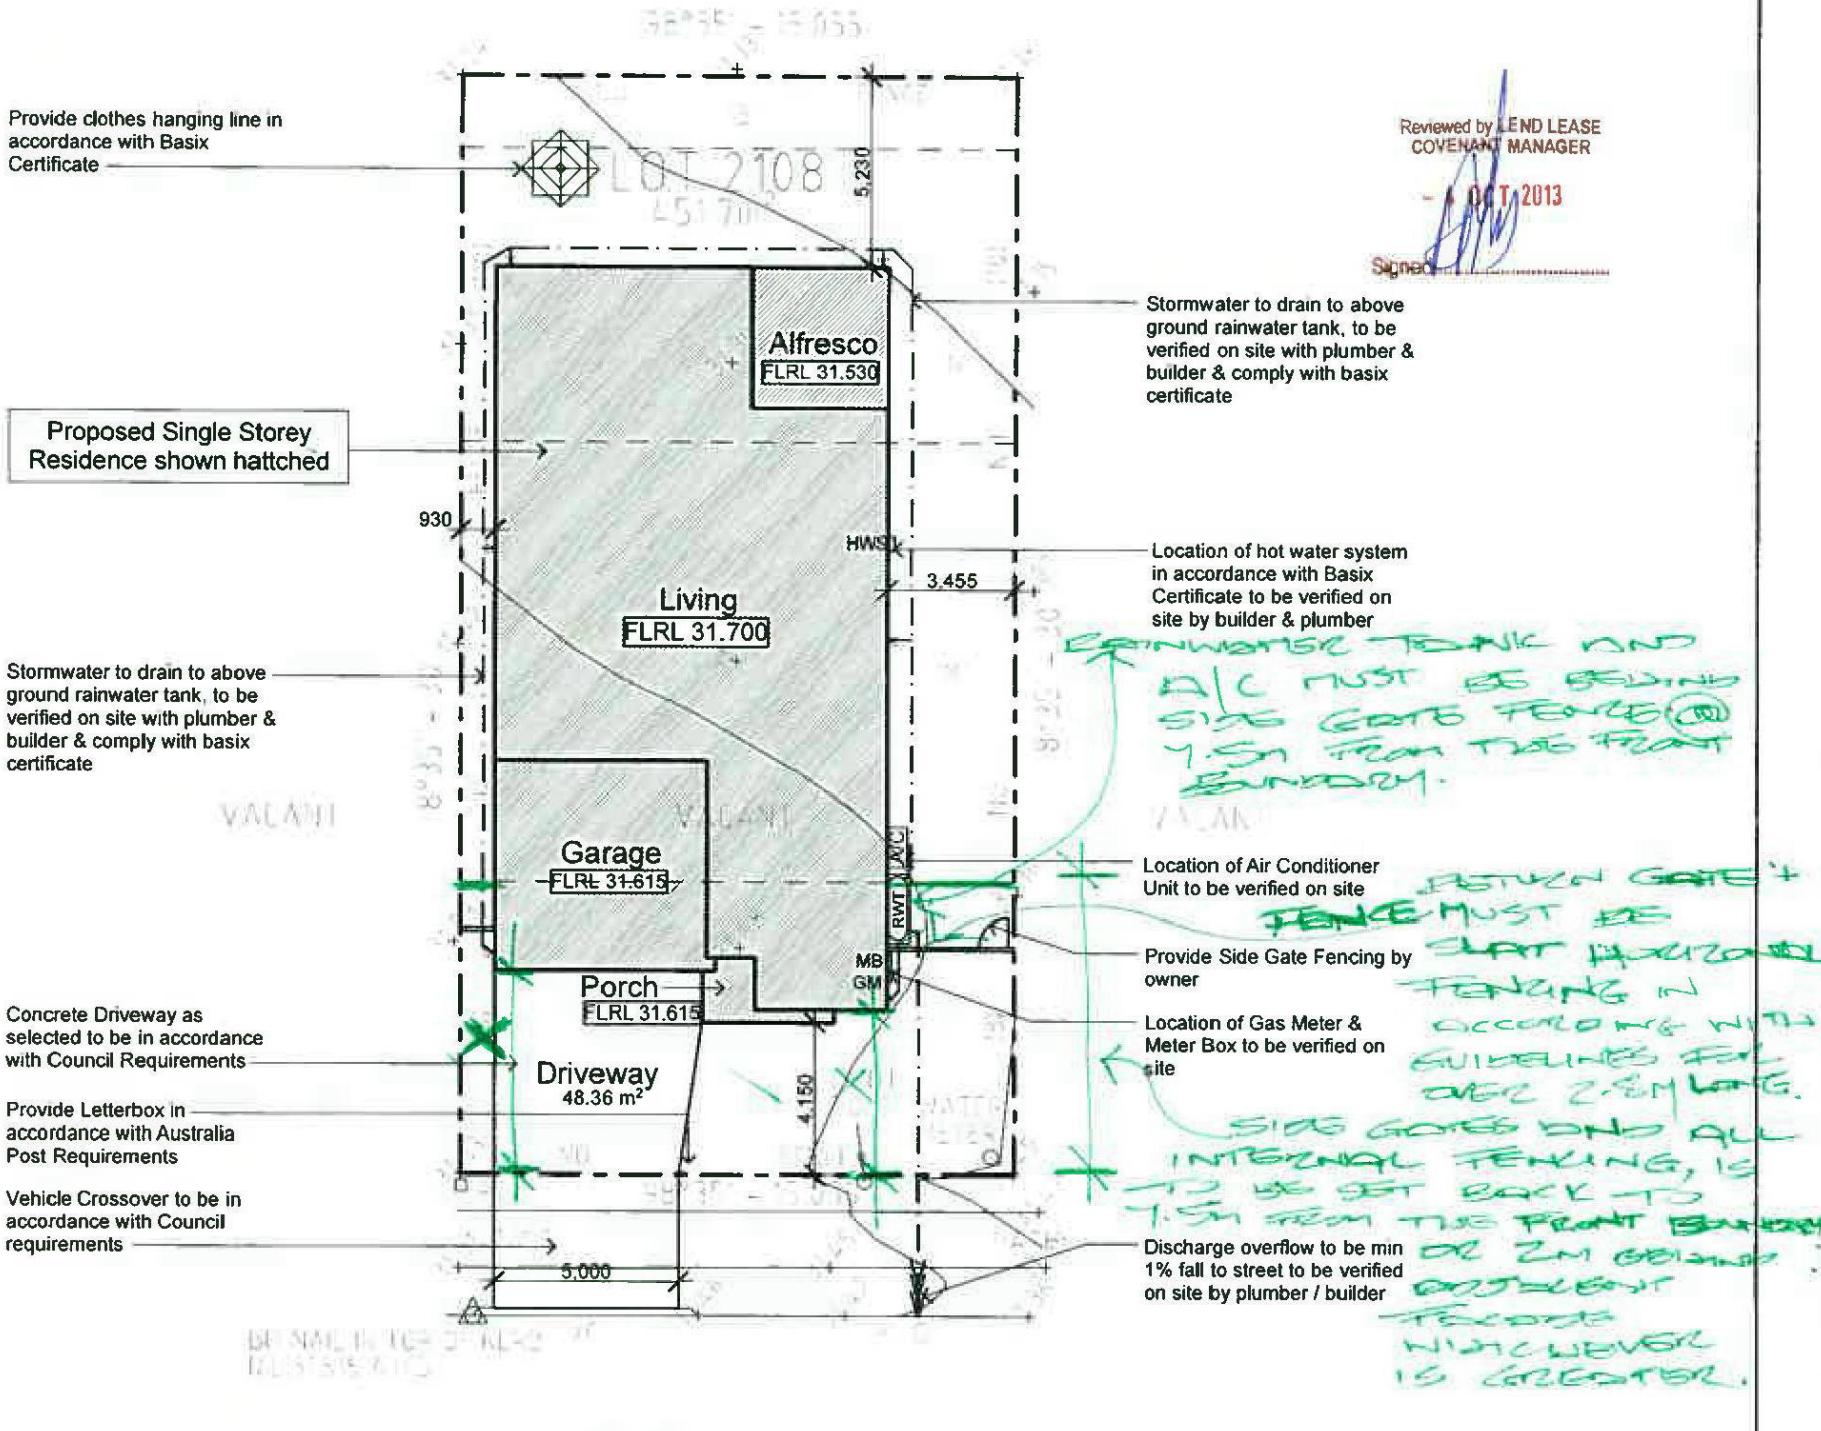

Reviewed by LEND LEASE COVENANT MANAGER
 OCT 2013
 Signed


Jordan Springs - Illoura Village Notes:

- (THESE NOTES MUST BE ADDED TO YOUR SITE AND LANDSCAPE PLANS)
- ANY GARDEN OR LAWN EDGING VISIBLE FROM THE STREET IS TO BE CONSTRUCTED OF MASONRY TEXTURED OR COLOURED BRICKS, BLOCKS OR COLOURED CONCRETE - NO TIMBER EDGING IS PERMITTED.
 - ANY RETAINING WALLS VISIBLE FROM THE STREET OR 900MM HIGH AND OVER ARE TO BE OF MASONRY CONSTRUCTION.
 - VEHICLE CROSSOVER IS TO BE PLAN CONCRETE TO COUNCIL SPECIFICATIONS. 5M WIDE V.C. FOR A DOUBLE GARAGE AND 3M WIDE V.C. FOR A SINGLE GARAGE.
 - ALL EXISTING STREET TREES AND VERGE PLANTING ARE TO BE PROTECTED DURING CONSTRUCTION.

Proposed Site Plan


scale 1:200

Issue	Amendment	Date	North:	Proposed:	Drawing Title:	Revision:
A	Sketch Concept	03.07.13		Various Designs	Proposed Site Plan / Concept Drainage Plan	B
B	Lodgement to Jordan Springs	20.08.13				
Phone: (02) 9757 - 4002 Fax: (02) 9757 - 4003 Email: jr.design.drafting@gmail.com Address: 448 - 452 Victoria Street, Wetherill Park, NSW 2164			Location:	Lot 2108 in DP 1168991 Lakeside Parade, Jordan Springs, NSW	L.G.A	Job No:
Note: Builder shall check and verify all dimensions prior to the commencement of any work.			Client:	LB Homes	Drawn: JR Scale: 1:200 Date: 20.08.2013 Sheet: 2 of 8	LB1304

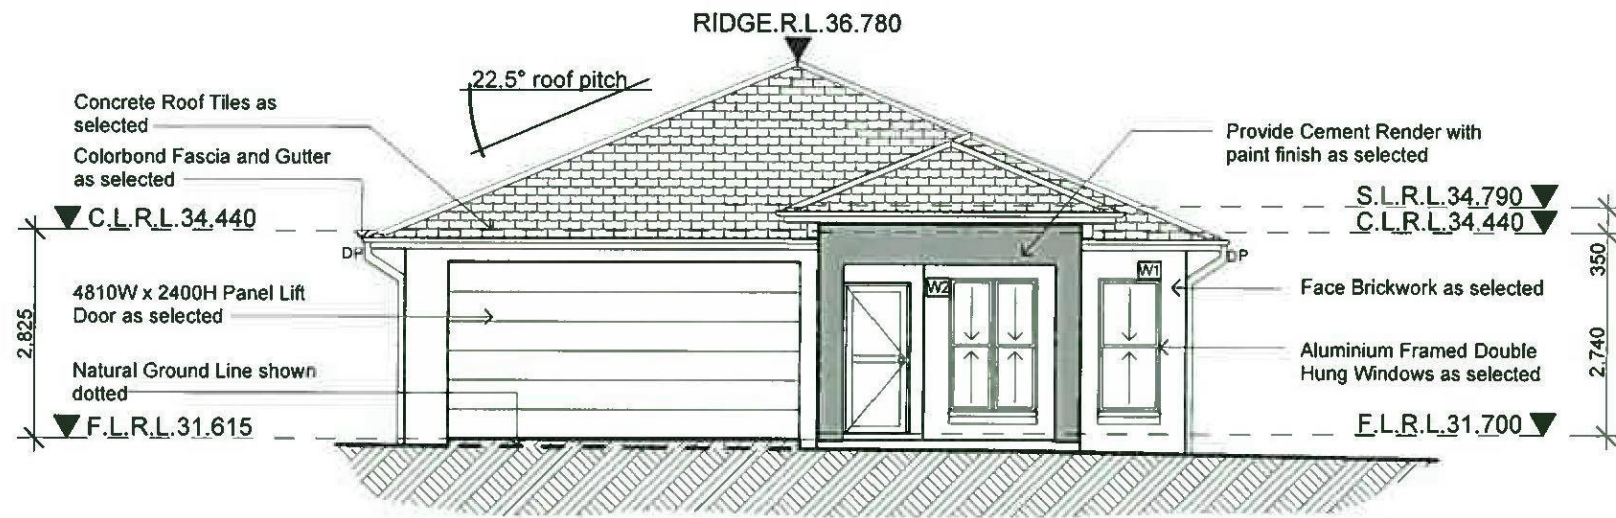

Southern Elevation
Front Elevation scale 1:100

Reviewed by LEASE COVENANT MANAGER
- 4 OCT 2013
Signed: _____

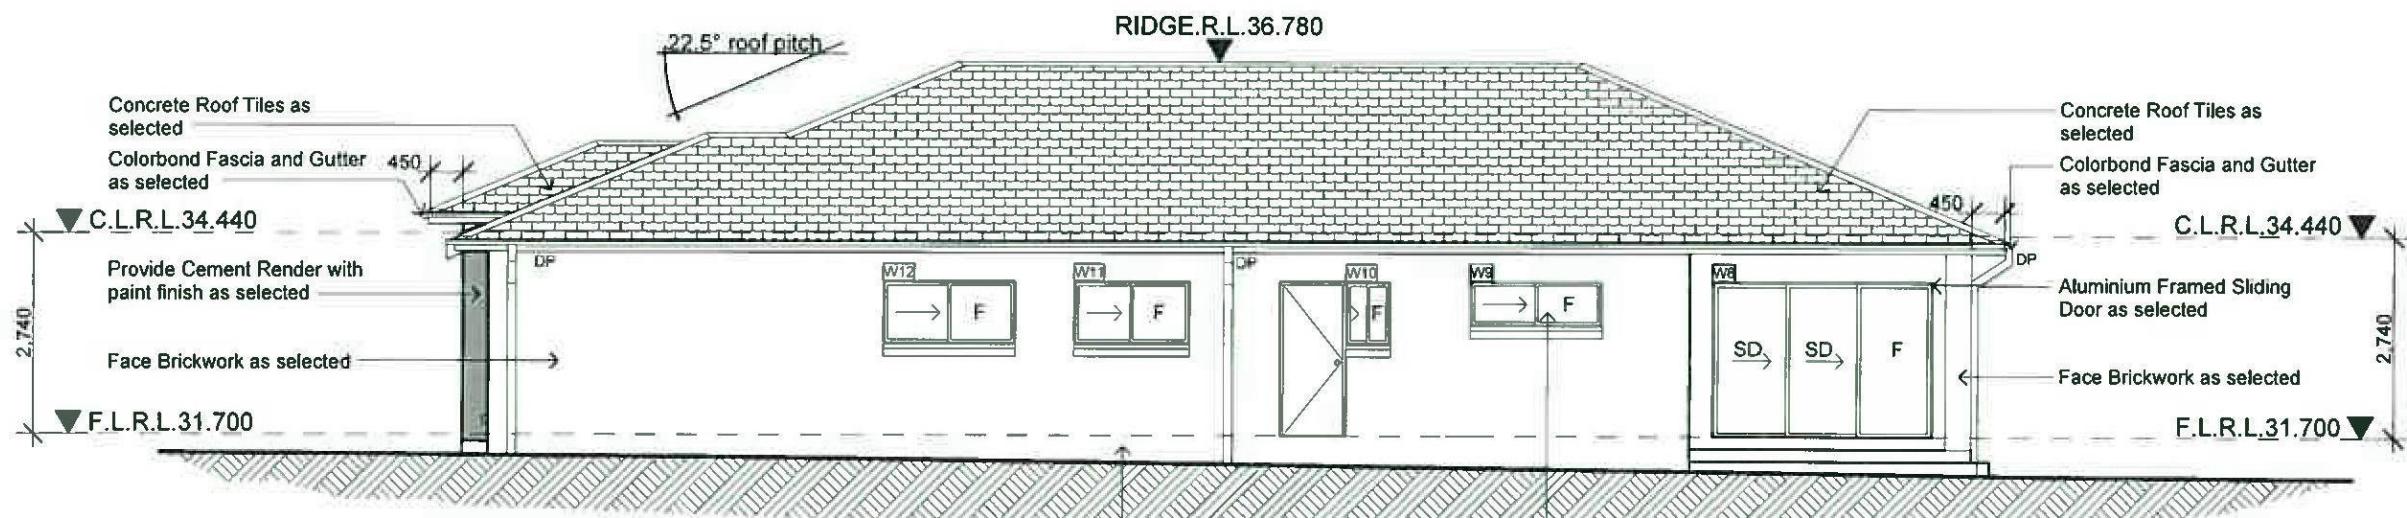

Eastern Elevation
Side Elevation scale 1:100

Issue	Amendment	Date:
A	Designs	19.04.13
B	Lodgement to Jordan Springs	20.08.13

JR DESIGN & DRAFTING
RESIDENTIAL DESIGN & DRAFTING SERVICES
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North: _____


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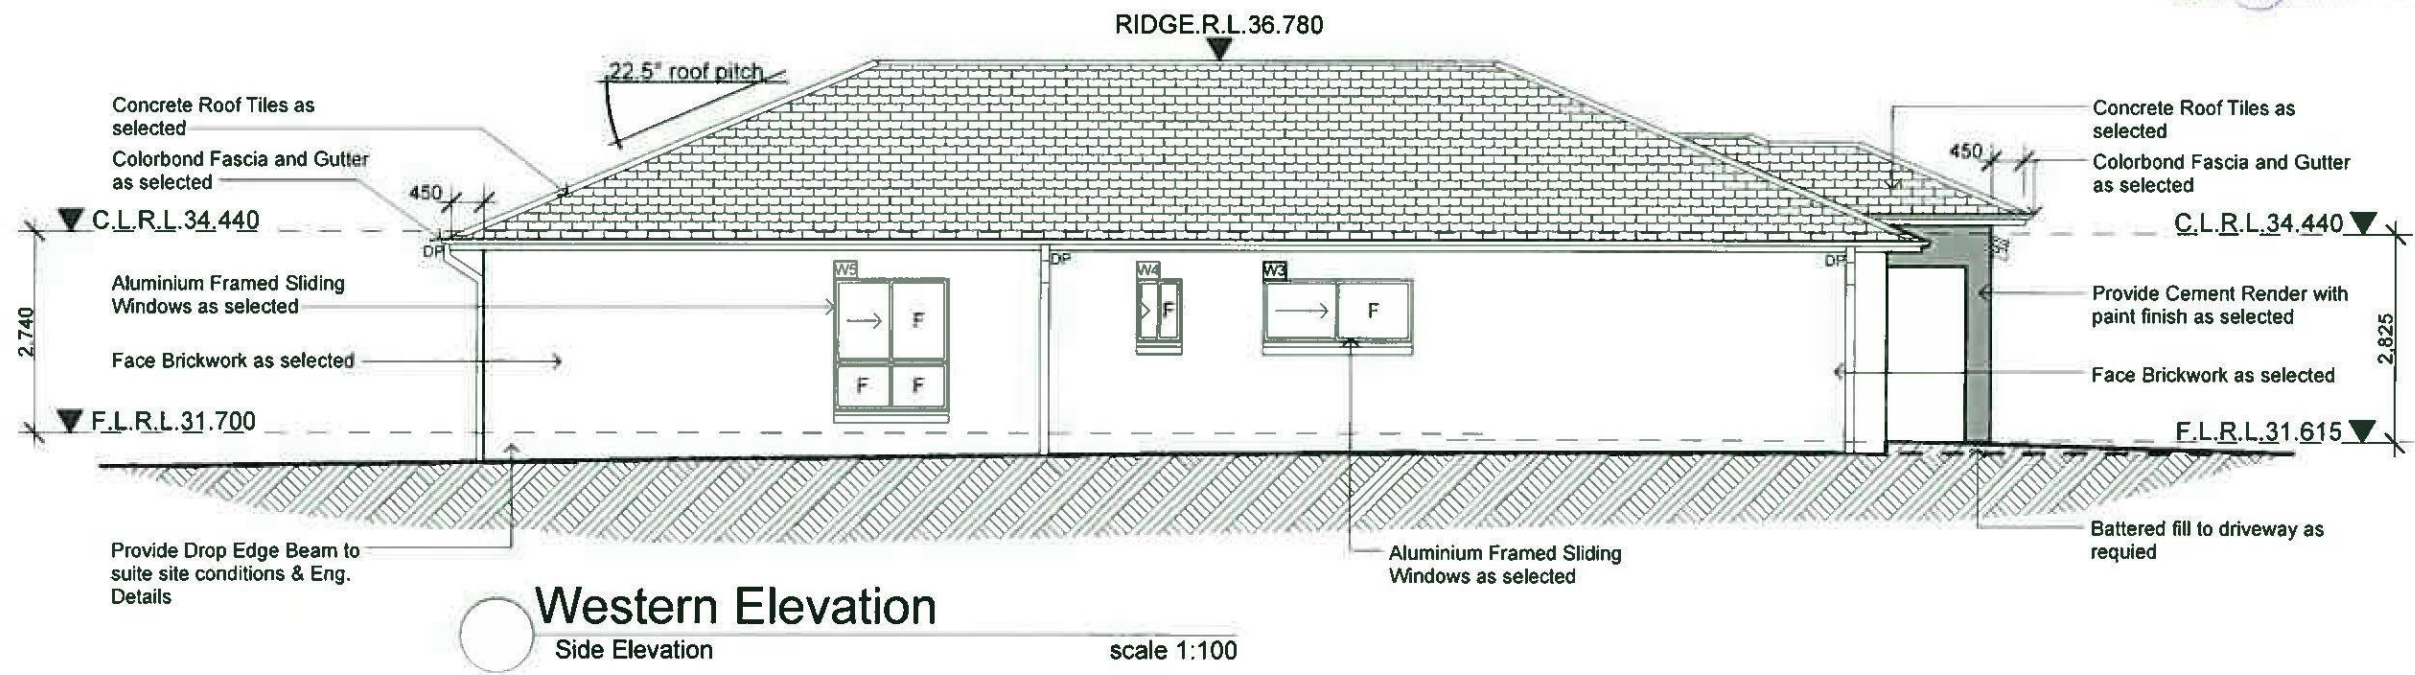
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Proposed:	Drawing Title	Revision:
Various Designs	Southern Elevation Eastern Elevation	B
Location: Lot 2108 in DP 1168991 Lakeside Parade, Jordan Springs, NSW	L.G.A.	Job No
Client: LB Homes	Drawn: JR Date: 20.08.2013 Scale: 1:100 Sheet: 5 of 8	LB1304



Northern Elevation
Rear Elevation scale 1:100

Reviewed by LEASE COVENANT MANAGER
- 4/08/2013
Signed

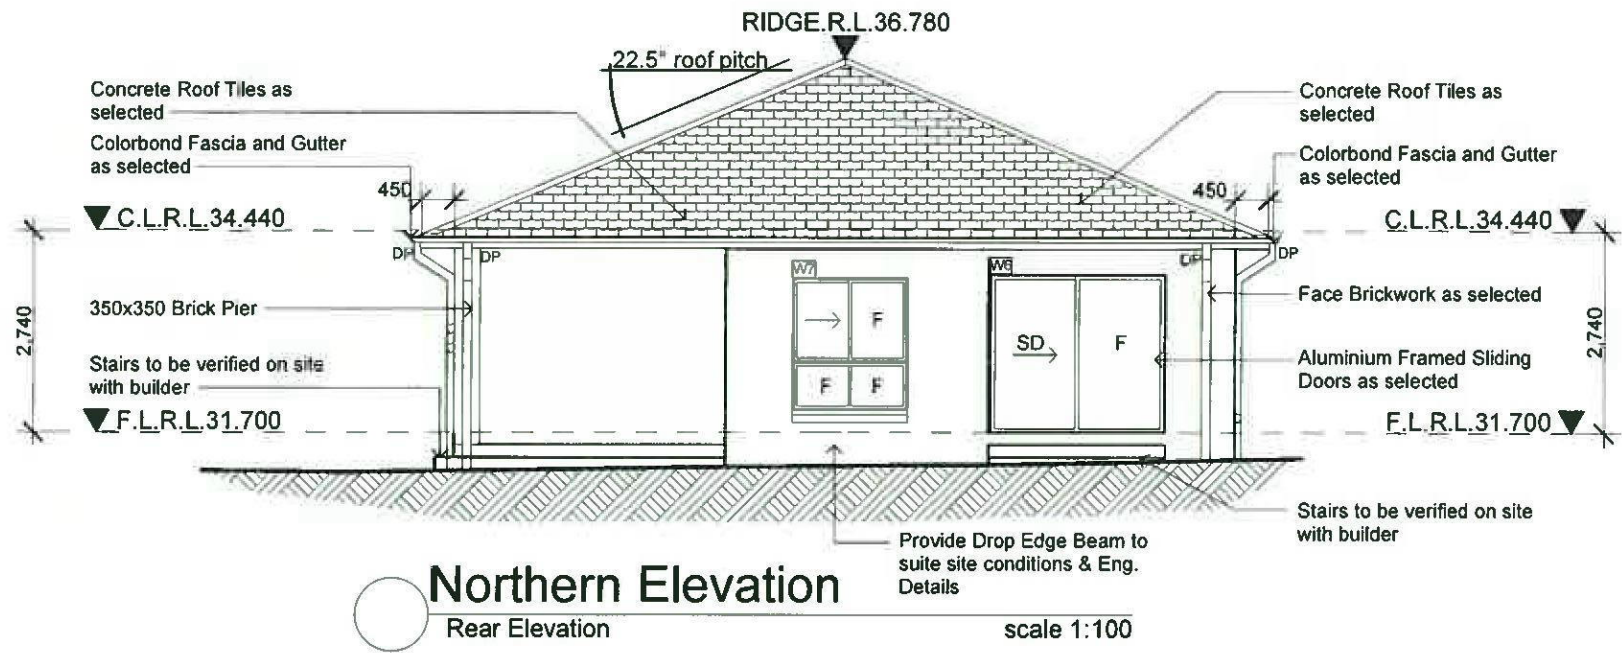

Western Elevation
Side Elevation scale 1:100

Issue	Amendment	Date
A	Designs	19.04.13
B	Lodgement to Jordan Springs	20.08.13

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North: [Symbol]

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General Notes

All work shall be carried out strictly in accordance with The Building Code Of Australia, relevant S.A.A. codes & to the satisfaction of the regulatory authority. All levels, dimensions & areas are to be verified by the Builder, prior to the preparation of contracts & the commencement of any building works. Any discrepancies are to be brought to the attention of JR Design & Drafting prior to the commencement of any building works.

Where Engineering Detail Plans are required, such must take preference to this drawing. Levels shown are approximate unless accompanied by reduced levels or Australian Height Datum Levels. Figured dimensions to be taken in preference to scaling. All Boundary clearances must be verified by Survey. Stormwater to be discharged to Councils requirements before any work commences. All services to be located & verified by the Builder with relevant Authorities before any work commences.

Proposed:	Various Designs		Drawing Title:	Southern Elevation Eastern Elevation		Revision:	B	
Location:	Lot 2108 in DP 1168991 Lakeside Parade, Jordan Springs, NSW		L.S.A			Job No:	LB1304	
Client:	LB Homes		Drawn	JR	Date	20.08.2013		
			Scale	1:100	Sheet	6 of 8		