
# 16 - 24 HOPE STREET, PENRITH PROPOSED MULTI-UNIT DEVELOPMENT

STORMWATER CONCEPT PLANS

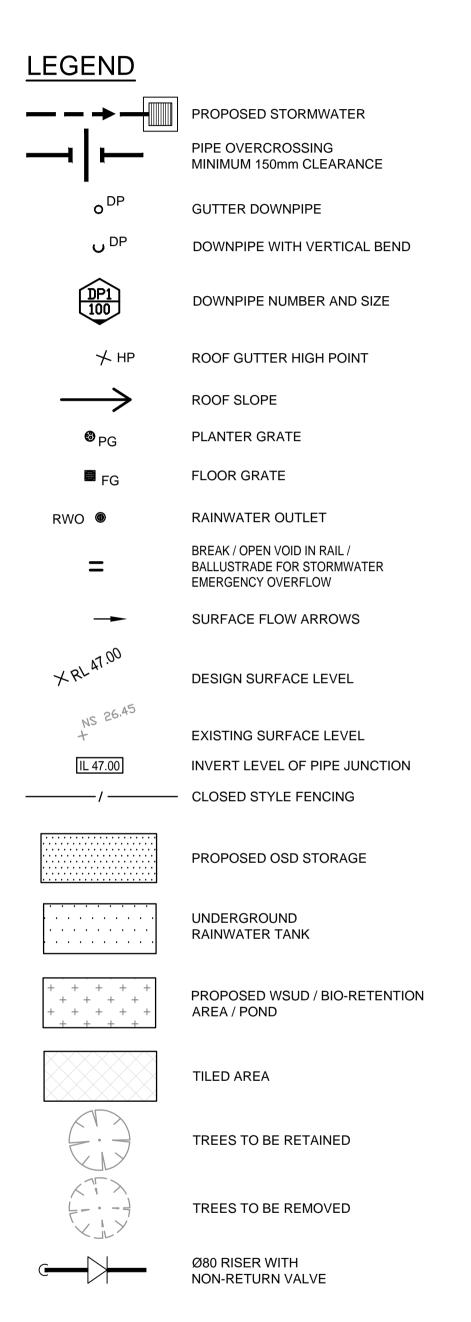



#### LOCALITY PLAN

## PIPES NOTE: Ø65 PVC @ MIN 1.0% Ø90 PVC @ MIN 1.0% Ø100 PVC @ MIN 1.0% Ø150 PVC @ MIN 1.0% Ø225 PVC @ MIN 0.5% Ø300 PVC @ MIN 0.4% UNLESS NOTED OTHERWISE

DRAWING INDEX						
Drawing No.	DESCRIPTION					
000	COVER SHEET PLAN					
101	STORMWATER CONCEPT PLAN BASEMENT LEVEL 2 SHEET 1 OF 2					
102	STORMWATER CONCEPT PLAN BASEMENT LEVEL 2 SHEET 2 OF 2					
103	STORMWATER CONCEPT PLAN BASEMENT LEVEL 1					
104	STORMWATER CONCEPT PLAN GROUND LEVEL					
105	ON-SITE DETENTION DETAILS AND CALCULATION SHEETS SHEET 1 OF 2					
105.1	ON-SITE DETENTION DETAILS AND CALCULATION SHEETS SHEET 2 OF 2					
106	MISCELLANEOUS DETAILS SHEET					

#### GENERAL NOTES

- ALL LINES ARE TO BE Ø90 uPVC 1.0% GRADE UNLESS NOTED OTHERWISE. CHARGED LINES TO BE SEWERGRADE & SEALED.
- 2. EXISTING SERVICES LOCATIONS SHOWN INDICATIVE ONLY. IT IS THE CONTRACTOR'S RESPONSIBILITY TO LOCATE & LEVEL ALL EXISTING SERVICES PRIOR TO THE COMMENCEMENT OF ANY EARTHWORKS.
- 3. ALL PIPES TO HAVE MIN 150mm COVER IF LOCATED WITHIN PROPERTY.
- 4. ALL PITS IN DRIVEWAYS TO BE 450x450 CONCRETE AND ALL PITS IN LANDSCAPED AREAS TO BE 450x450 PLASTIC.
- 5. PITS LESS THAN 600mm DEEP MAY BE BRICK, PRECAST OR CONCRETE.
- 6. ALL BALCONIES AND ROOFS TO BE DRAINED AND TO HAVE SAFETY OVERFLOWS IN ACCORDANCE WITH RELEVANT AUSTRALIAN STANDARDS.
- 7. ALL EXTERNAL SLABS TO BE WATERPROOFED.
- 8. ALL GRATES TO HAVE CHILD PROOF LOCKS.
- 9. ALL DRAINAGE WORKS TO AVOID TREE ROOTS.
- 10. ALL DPs TO HAVE LEAF GUARDS.

A.S.3500.3.

- 11. ALL EXISTING LEVELS TO BE CONFIRMED BY BUILDER PRIOR TO CONSTRUCTION.
- 12. ALL WORK WITHIN COUNCIL RESERVE TO BE INSPECTED BY COUNCIL PRIOR TO CONSTRUCTION.
- 13. COUNCIL'S ISSUED FOOTWAY DESIGN LEVELS TO BE INCORPORATED INTO THE FINISHED LEVELS ONCE ISSUED BY COUNCIL.
- 14. ALL WORK SHALL BE IN ACCORDANCE WITH B.C.A. AND
- 15. REFER TO LANDSCAPE ARCHITECT'S DRAWINGS FOR LANDSCAPING.
- 16. CARE TO BE TAKEN AROUND EXISTING SEWER. STRUCTURAL ADVIICE IS REQUIRED FOR SEWER PROTECTION AGAINST ADDITIONAL LOADING FROM NEW PITS, PIPES, RETAINING WALLS AND OSD BASIN WATER LEVELS.
- 17. ALL WALLS FORMING THE DETENTION BASINS SHALL BE CONSTRUCTED WHOLLY WITHIN THE PROPERTY BOUNDARIES OF THE SITE BEING DEVELOPED.
- 18. OSD WARNING SIGN AND SAFETY FENCING SHALL BE PROVIDED TO ABOVE GROUND OSD STORAGE AREA IN ACCORDANCE WITH COUNCIL REQUIREMENTS.
- 19. ENSURE THAT NON FLOATABLE MULCH IS USED IN DETENTION BASINS, ie. USE DECORATIVE ROCK MULCH OR EQUIVALENT.
- 20. ALL PIPES IN BALCONIES TO BE Ø65 uPVC
  CAST IN CONCRETE SLAB. CONTRACTOR TO PROVIDE
  A BREAK / OPEN VOID IN RAIL / BALLUSTRADE
  FOR STORMWATER EMERGENCY OVERFLOW.
  ALL ENCLOSED AREAS/PLANTER BOXES TO BE FITTED
  WITH FLOOR WASTES & DRAINED TO OSD
  DOWNPIPES TO BE CHECKED BY ARCHITECT & .
  PLUMBER PRIOR TO CONSTRUCTION
- 21. THE OSD BASIN / TANK IS TO BE BUILT TO THE CORRECT LEVELS & SIZE AS PER THIS DESIGN. ANY VARIATIONS ARE TO BE DONE UNDER CONSULTATION FROM OUR OFFICE ONLY. ANY AMENDMENTS WITHOUT OUR APPROVAL WOULD RESULT IN ADDITIONAL FEES FOR REDESIGN AT OC STAGE OR IF A SOLUTION CANNOT BE FOUND, RECONSTRUCTION IS REQUIRED UNDER THE CONTRACTOR'S EXPENSES.

NOT FOR CONSTRUCTION

C ISSUE FOR DEVELOPMENT APPLICATION

B ISSUE FOR DEVELOPMENT APPLICATION

A ISSUE FOR DEVELOPMENT APPLICATION

B ISSUE FOR DEVELOPMENT APPLICATION

Certification

Description

Description

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Certification By Dr. Anthony Hasham (NPER

Morson Group
P.O Box 170,
Potts Point, NSW 1335
EMAIL: info@ad-s.com.au
PHONE: 02 9380 4946

Prestige Developments Group (NSW) Pty Ltd

Penrith City Council

AUSTRALIAN
CONSULTING
ENGINEERS.


AUSTRALIAN
PTY LTD - A.C.N. 084 059 941
SHOP 2-141 CONCORD RD NORTH STRATHFIELD NSW 2137
PH: (02) 9763 1500 FX: (02) 9763 1515
EMAIL: info@aceeng.com.au


16 - 24 HOPE STREET, PENRITH
PROPOSED MULTI-UNIT DEVELOPMENT
STORMWATER CONCEPT PLANS
DEVELOPMENT APPLICATION


COVER SHEET PLAN

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 A1
 Project No.
 Dwg. No.
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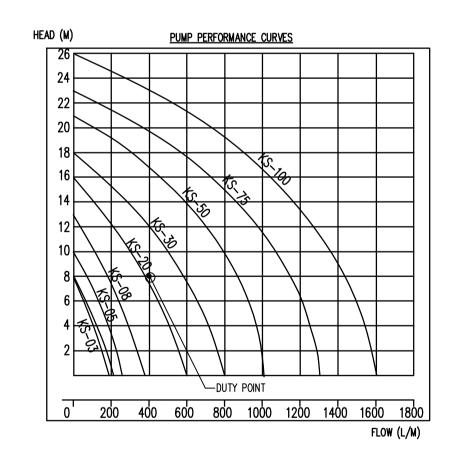


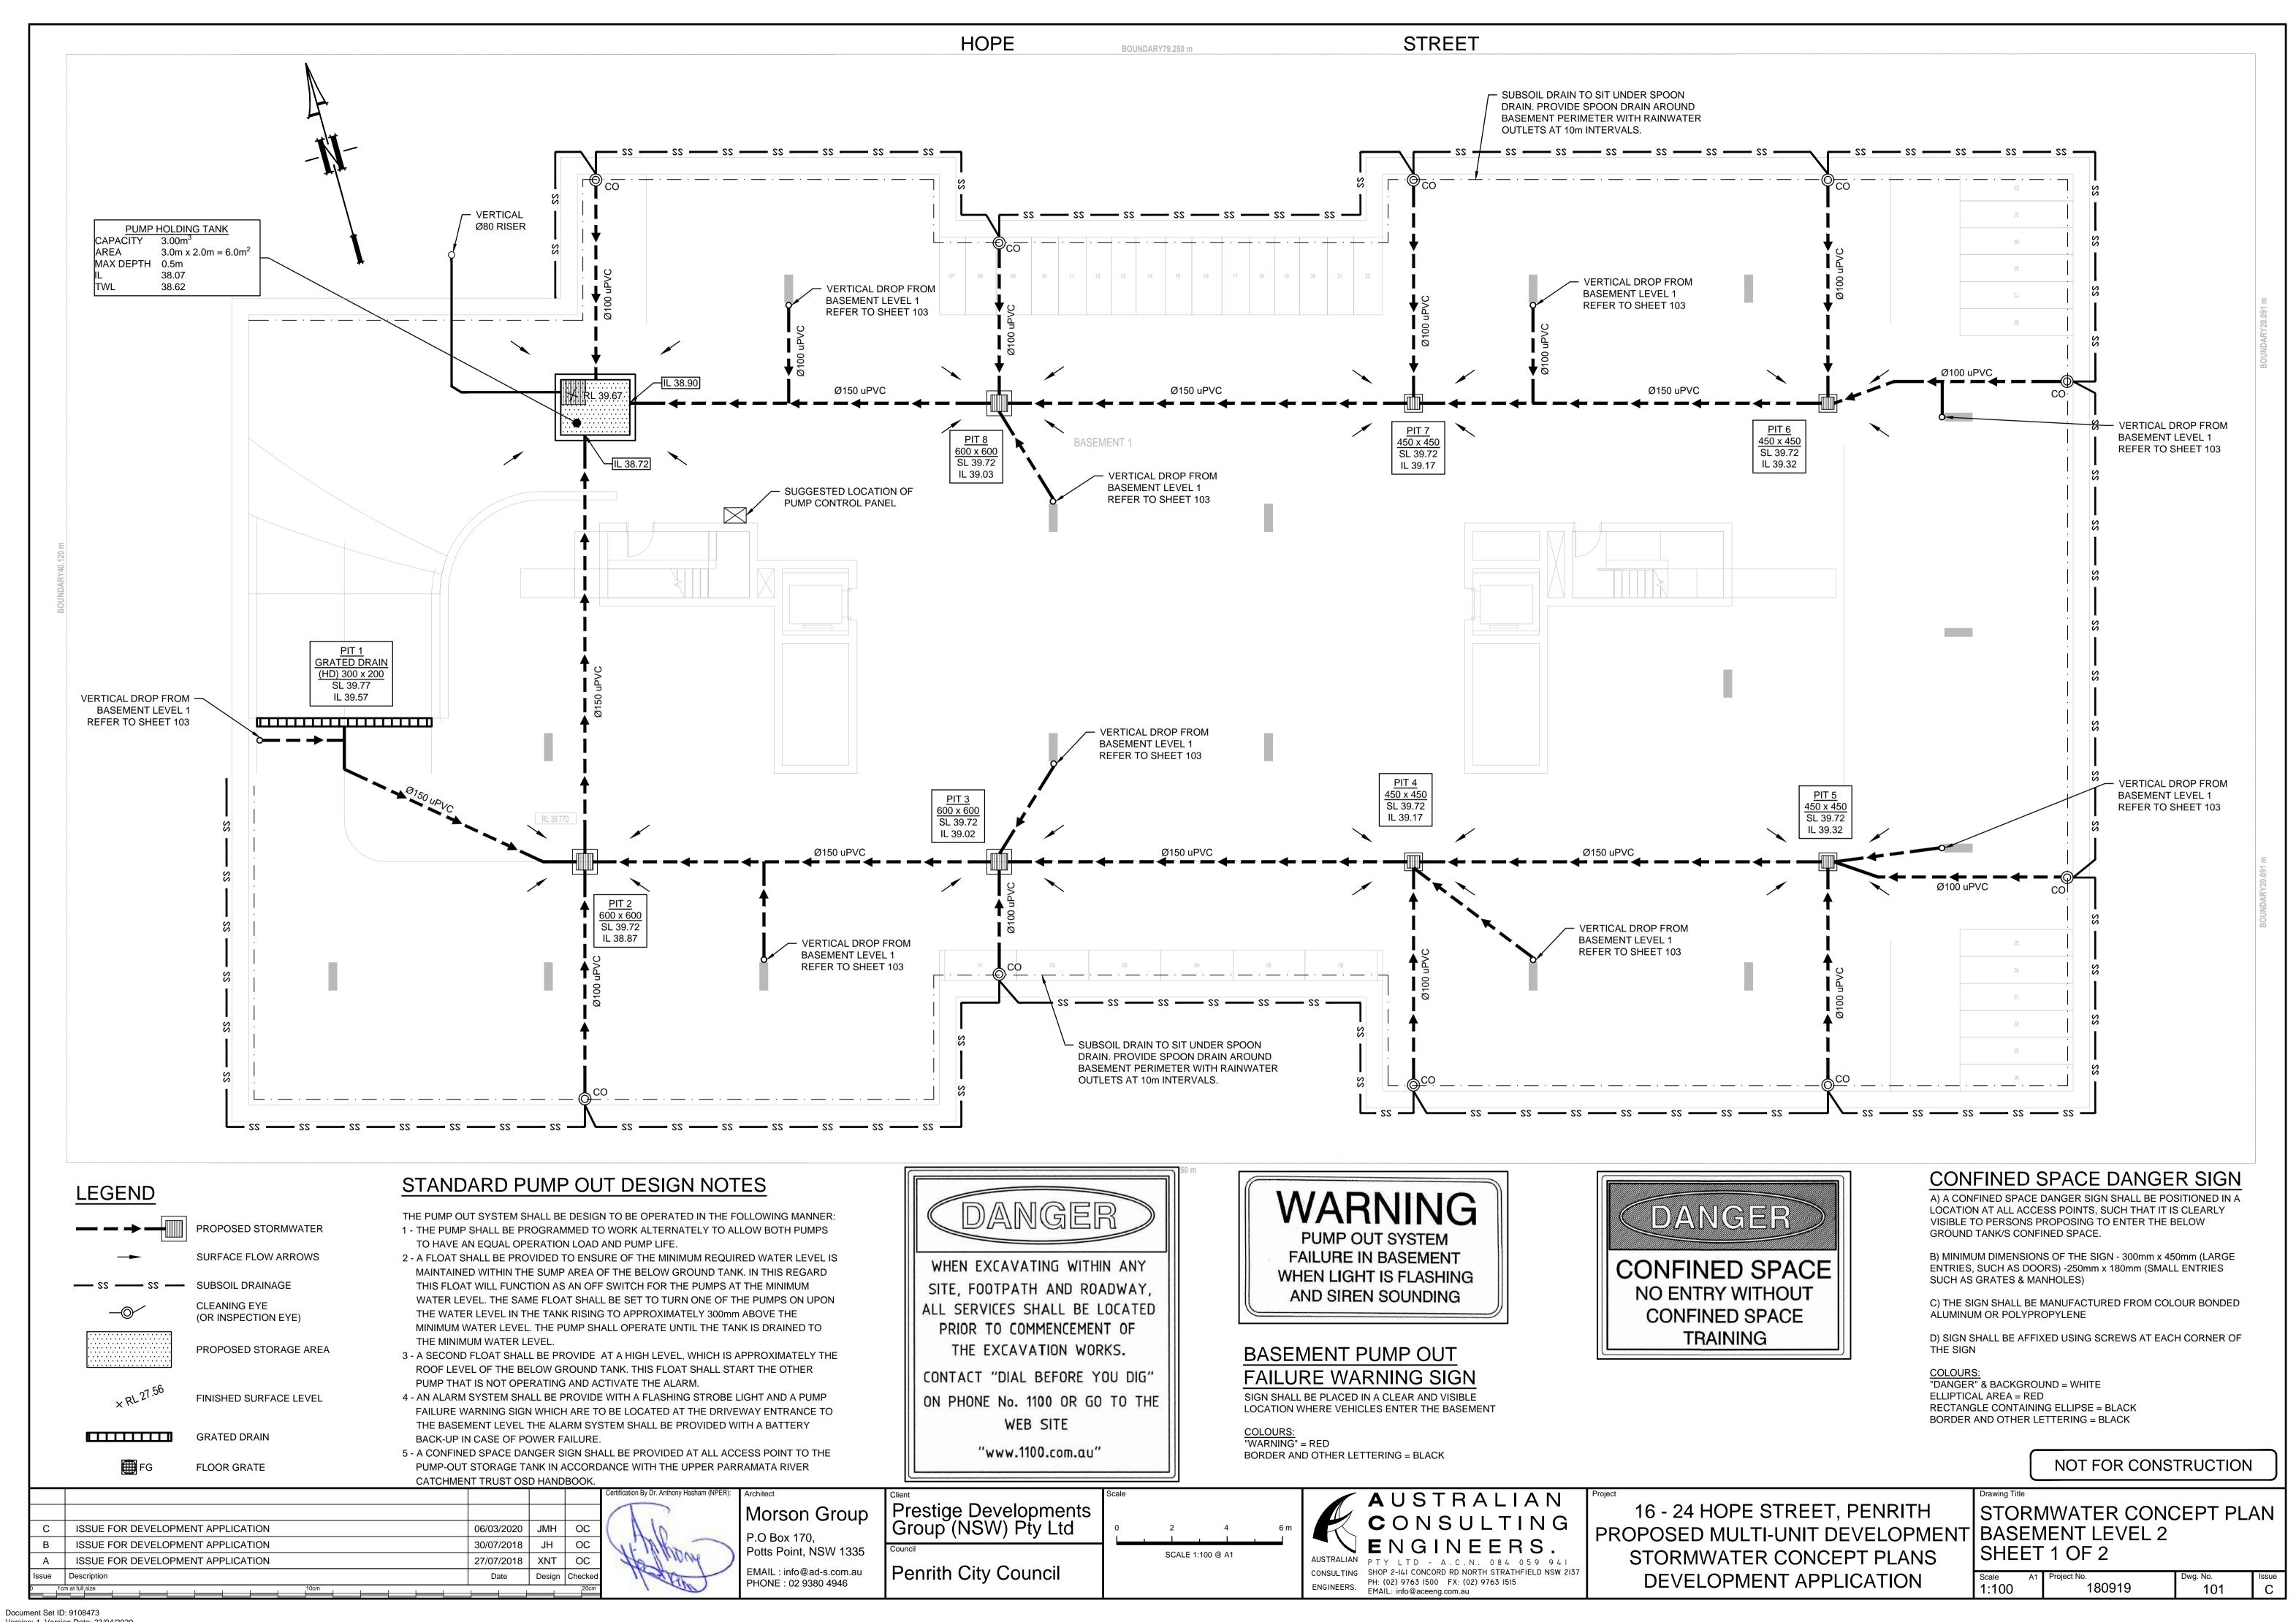

#### NOTE:

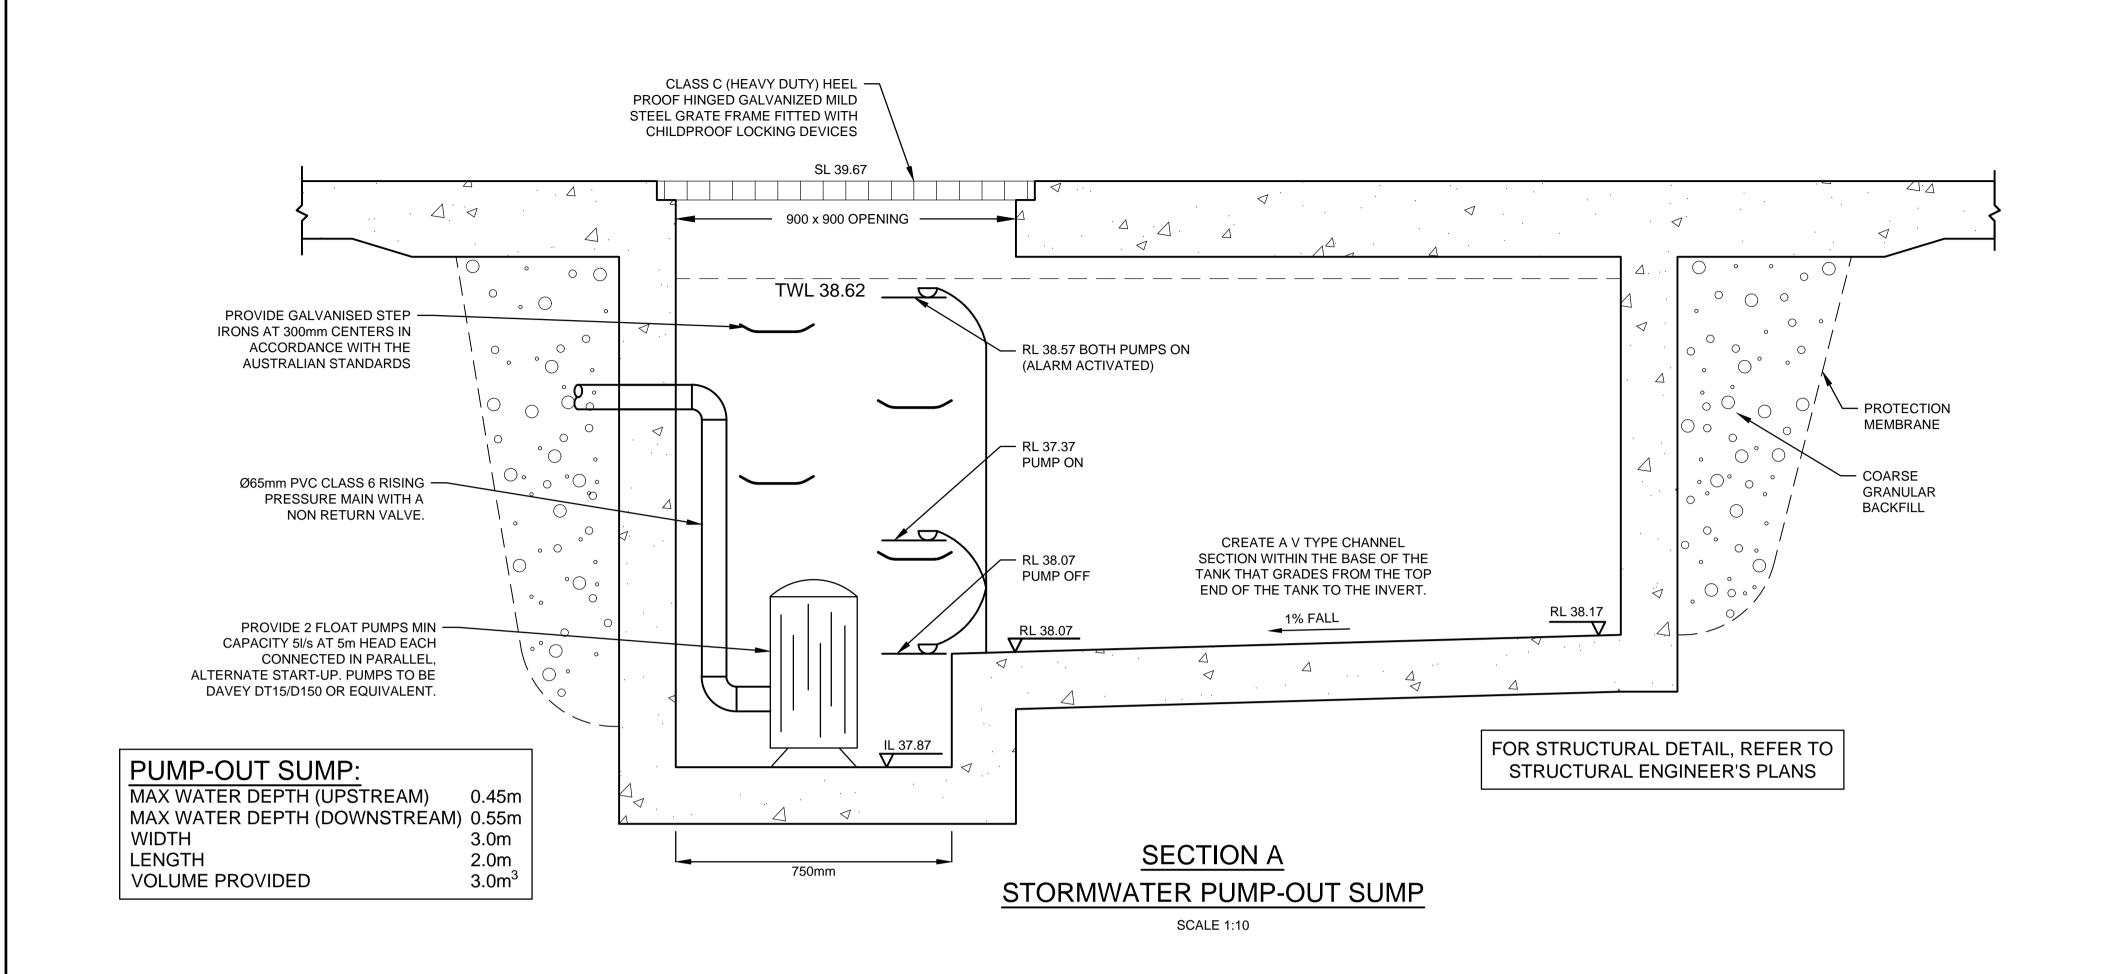FOR ALL THE STRUCTURAL DETAILS, REFER TO STRUCTURAL ENGINEER'S PLAN. ALL THE AG LINES BEHIND BASEMENT WALLS TO BE CONNECTED TO PUMP-OUT SUMP.

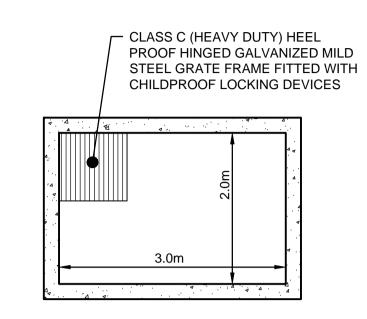PUMP-OUT SUMP DETAIL **PLAN VIEW** 



#### PUMP STORAGE VOLUME CALCULATION

AREA DRAINING TO SUMP= 17.9m<sup>2</sup>

SUMP SIZE BASED ON 100 YEAR 2 HR STORM, I= 44.4 mm/hr. Q=CIA/3600= 1X 44.4 X 17.9/3600 = 0.22L/sec VOLUME REQUIRED =  $0.22X(2x60x60) = 1584L = 1.584m^3$ STORAGE PROVIDED 3.0X2.0X0.5= 3.0m<sup>3</sup>

PUMP OUT RATE BASED ON 100YR 5MIN STORM, I=220 mm/hr (MIN RATE REQUIRED AS PER AS3500.3 IS 10 L/sec) Q=CIA/3600= 1X 220X 17.9/3600 = 1.09 L/sec

DUAL KS-30 PUMP OR EQUIVALENT TO BE INSTALLED IN SUMP AND CONNECTED TO CONTROL PANEL WHICH WILL ALLOW FOR THE PUMP TO OPERATE ALTERNATIVELY ON HIGH LEVEL WITH ALARM AT 10 L/sec AT 8m HEAD

ø50 WEEP HOLE	
150 BLUE METAL	
BASEMENT	
100mm AG. PIPE	

SRL 38.07 PUMP-OUT SUMP DETAIL SRL SCALE 1:50

		Output		Outlet		Rated		Maximum		Weigh	Dimension		
	Type	Out	.put	Ou	uet	Head C	apacity	Head	Capacity	weign		Difficusion	
		HP	kW	mm	Inch	М	LPM	М	LPM	Kg	L(mm)	W(mm)	H(mm)
	KS-03	1/3	0.25	40	1 1/2"	3	130	8	180	9	188	141	305
	KS-04	1/2	0.4	50	2"	5	150	8	220	11	208	140	359
	KS-05	1/2	0.4	50	2"	5	160	10	260	14	230	156	375
	KS-08	1	0.75	50	2"	6	240	13	380	21	290	180	425
	KS-20	2	1.5	80	3"	10	300	16	600	31	278	182	475
-	KS-30	3	2.2	80	3"	10	500	18	800	42	390	250	450
	KS-50	5	3.7	100	4"	10	800	21	1100	48	450	240	530
	KS-75	7 1/2	5.6	100	4"	15	800	23	1300	60	550	310	590
	KS-100	10	7.5	150	6"	18	900	25	1600	70	550	310	610

TYPICAL SPOON DRAIN DETAILS

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					1
С	ISSUE FOR DEVELOPMENT APPLICATION	06/03/2020	JMH	ОС	
В	ISSUE FOR DEVELOPMENT APPLICATION	30/07/2018	JH	ОС	1
Α	ISSUE FOR DEVELOPMENT APPLICATION	27/07/2018	XNT	ОС	
Issue	Description	Date	Design	Checked	

Morson Group P.O Box 170, Potts Point, NSW 1335 EMAIL: info@ad-s.com.au PHONE: 02 9380 4946


Prestige Developments Group (NSW) Pty Ltd Penrith City Council

SCALE 1:50 @ A1



16 - 24 HOPE STREET, PENRITH PROPOSED MULTI-UNIT DEVELOPMENT BASEMENT LEVEL 2 STORMWATER CONCEPT PLANS DEVELOPMENT APPLICATION

STORMWATER CONCEPT PLAN SHEET 2 OF 2 180919 As Shown 102

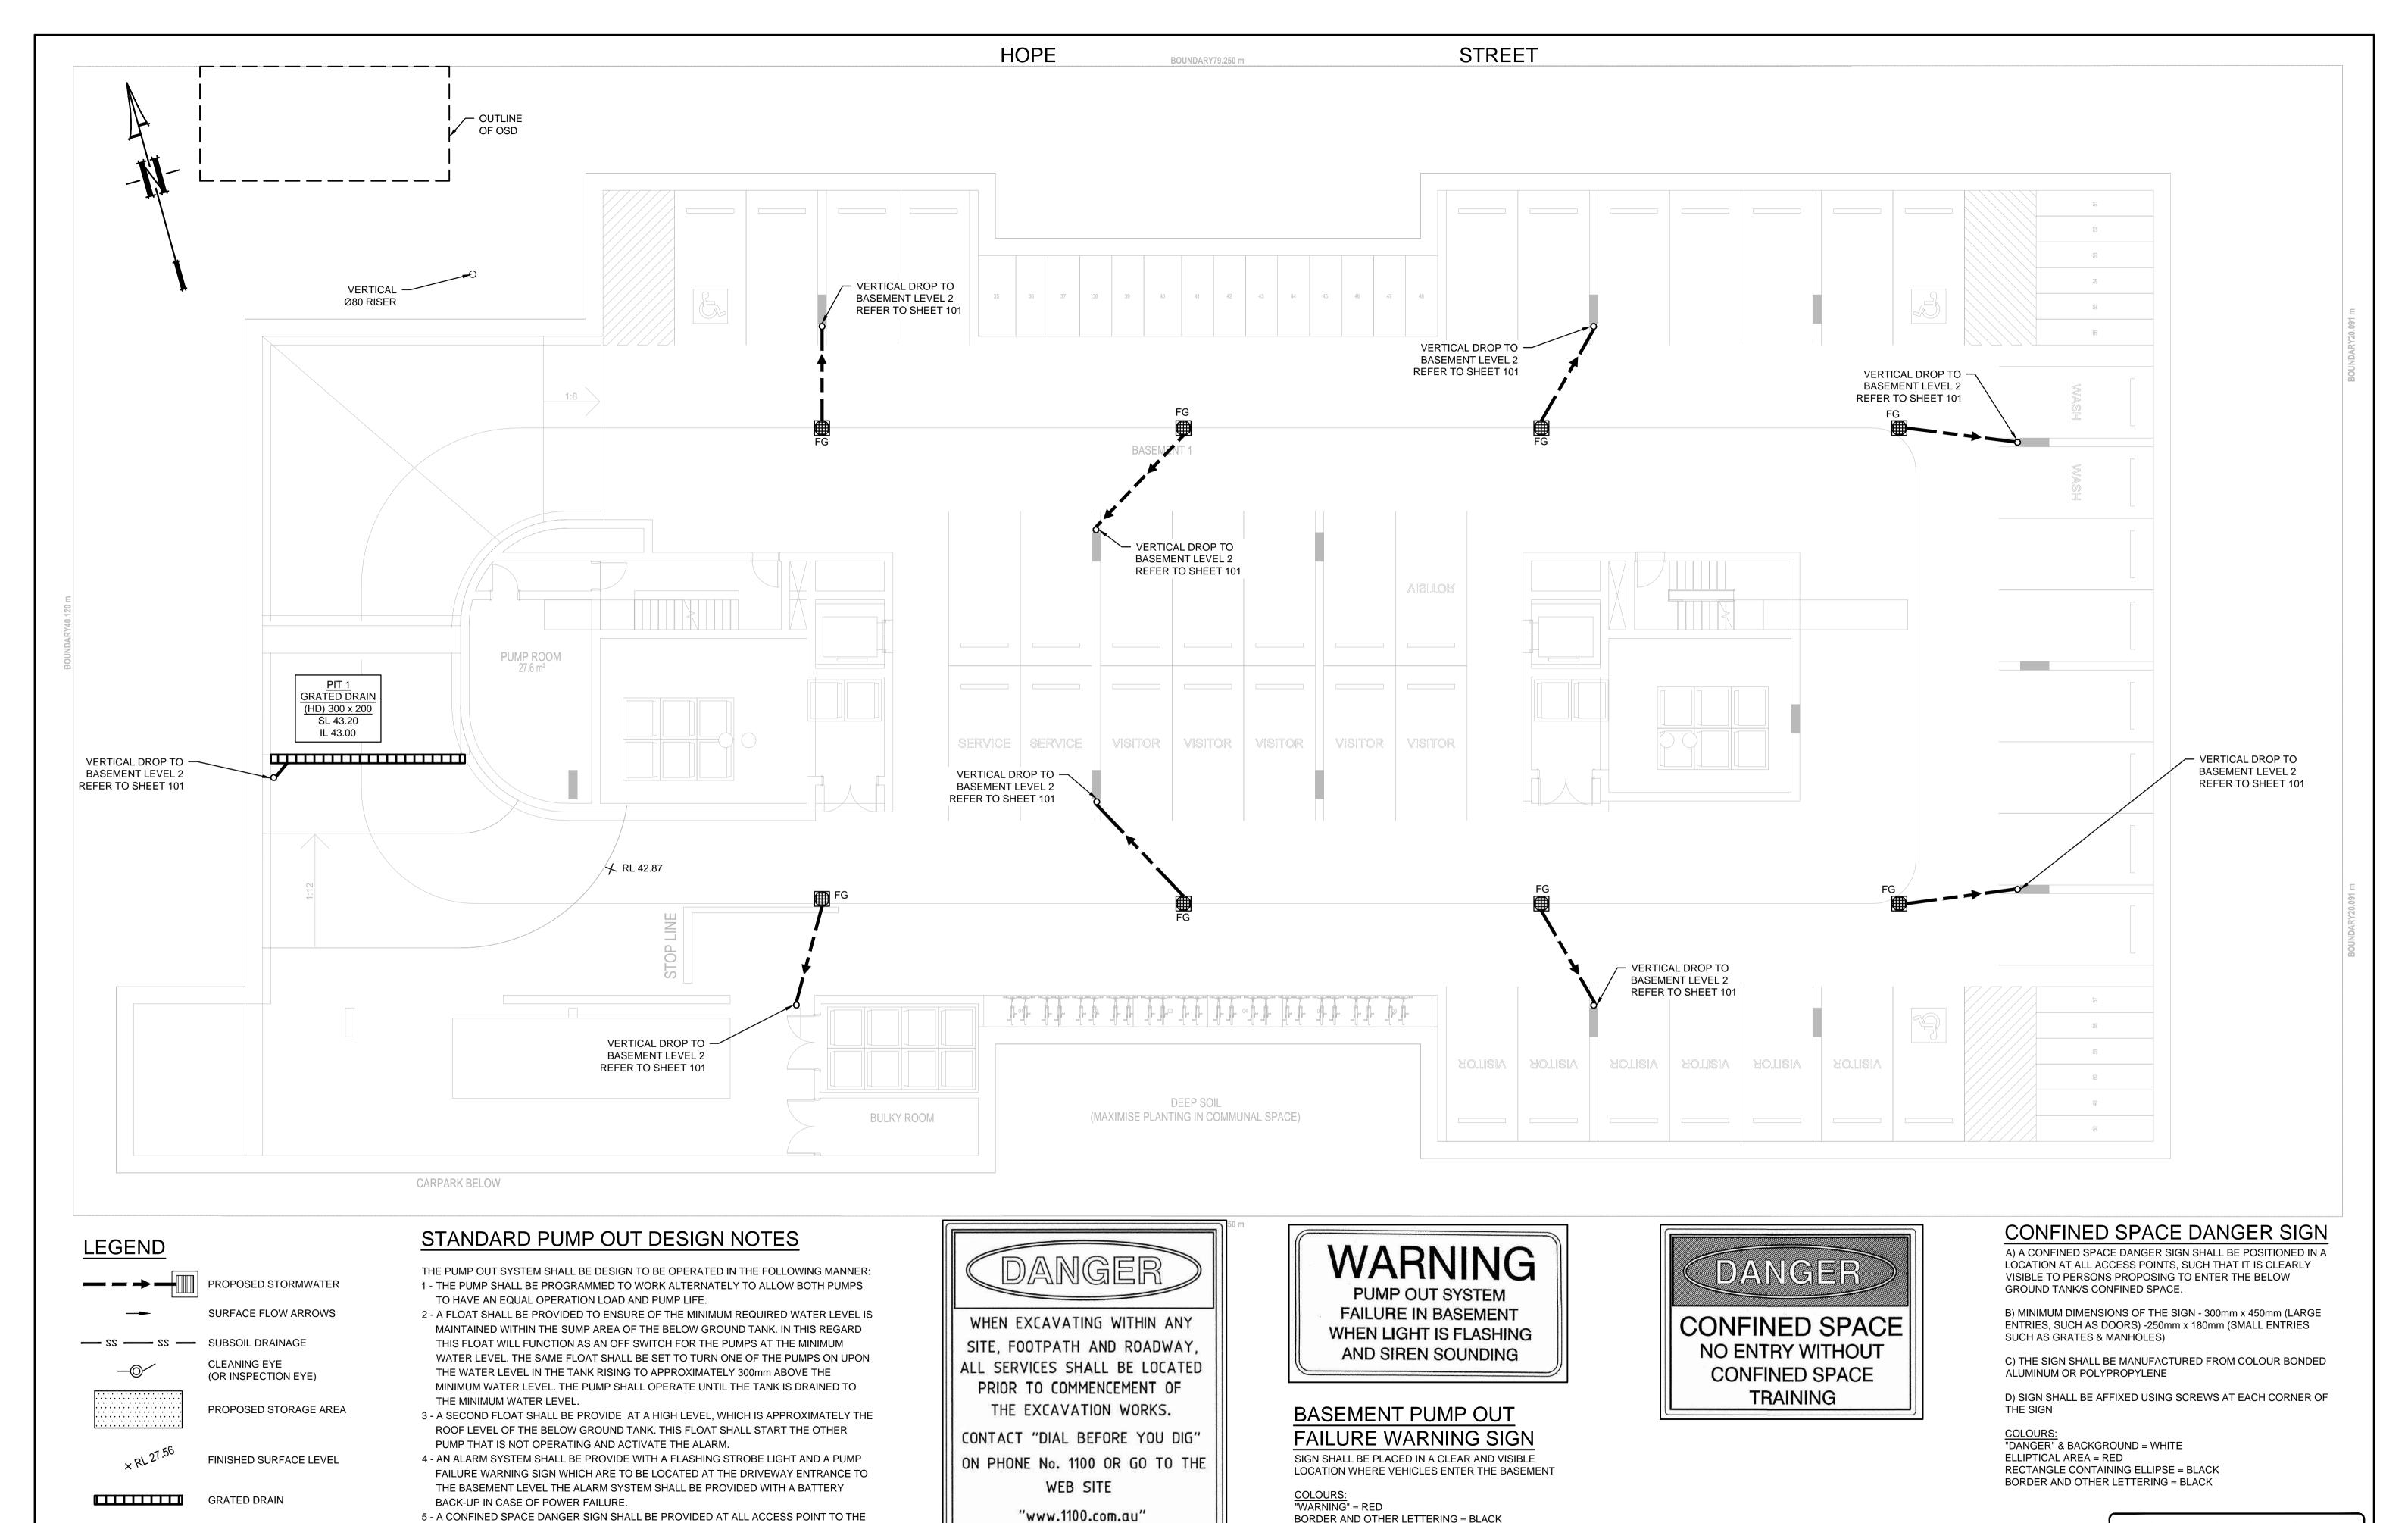

ISSUE FOR DEVELOPMENT APPLICATION 06/03/2020 | JMH | OC ISSUE FOR DEVELOPMENT APPLICATION 30/07/2018 JH OC ISSUE FOR DEVELOPMENT APPLICATION 27/07/2018 | XNT | OC ssue Description Date Design Checked

FLOOR GRATE

5 - A CONFINED SPACE DANGER SIGN SHALL BE PROVIDED AT ALL ACCESS POINT TO THE

PUMP-OUT STORAGE TANK IN ACCORDANCE WITH THE UPPER PARRAMATA RIVER

CATCHMENT TRUST OSD HANDBOOK

#### Morson Group P.O Box 170,

Potts Point, NSW 1335 EMAIL: info@ad-s.com.au

Prestige Developments Group (NSW) Pty Ltd

Penrith City Council

### SCALE 1:100 @ A1

## AUSTRALIAN

16 - 24 HOPE STREET, PENRITH PROPOSED MULTI-UNIT DEVELOPMENT BASEMENT LEVEL 1 STORMWATER CONCEPT PLANS CONSULTING SHOP 2-141 CONCORD RD NORTH STRATHFIELD NSW 2137


STORMWATER CONCEPT PLAN


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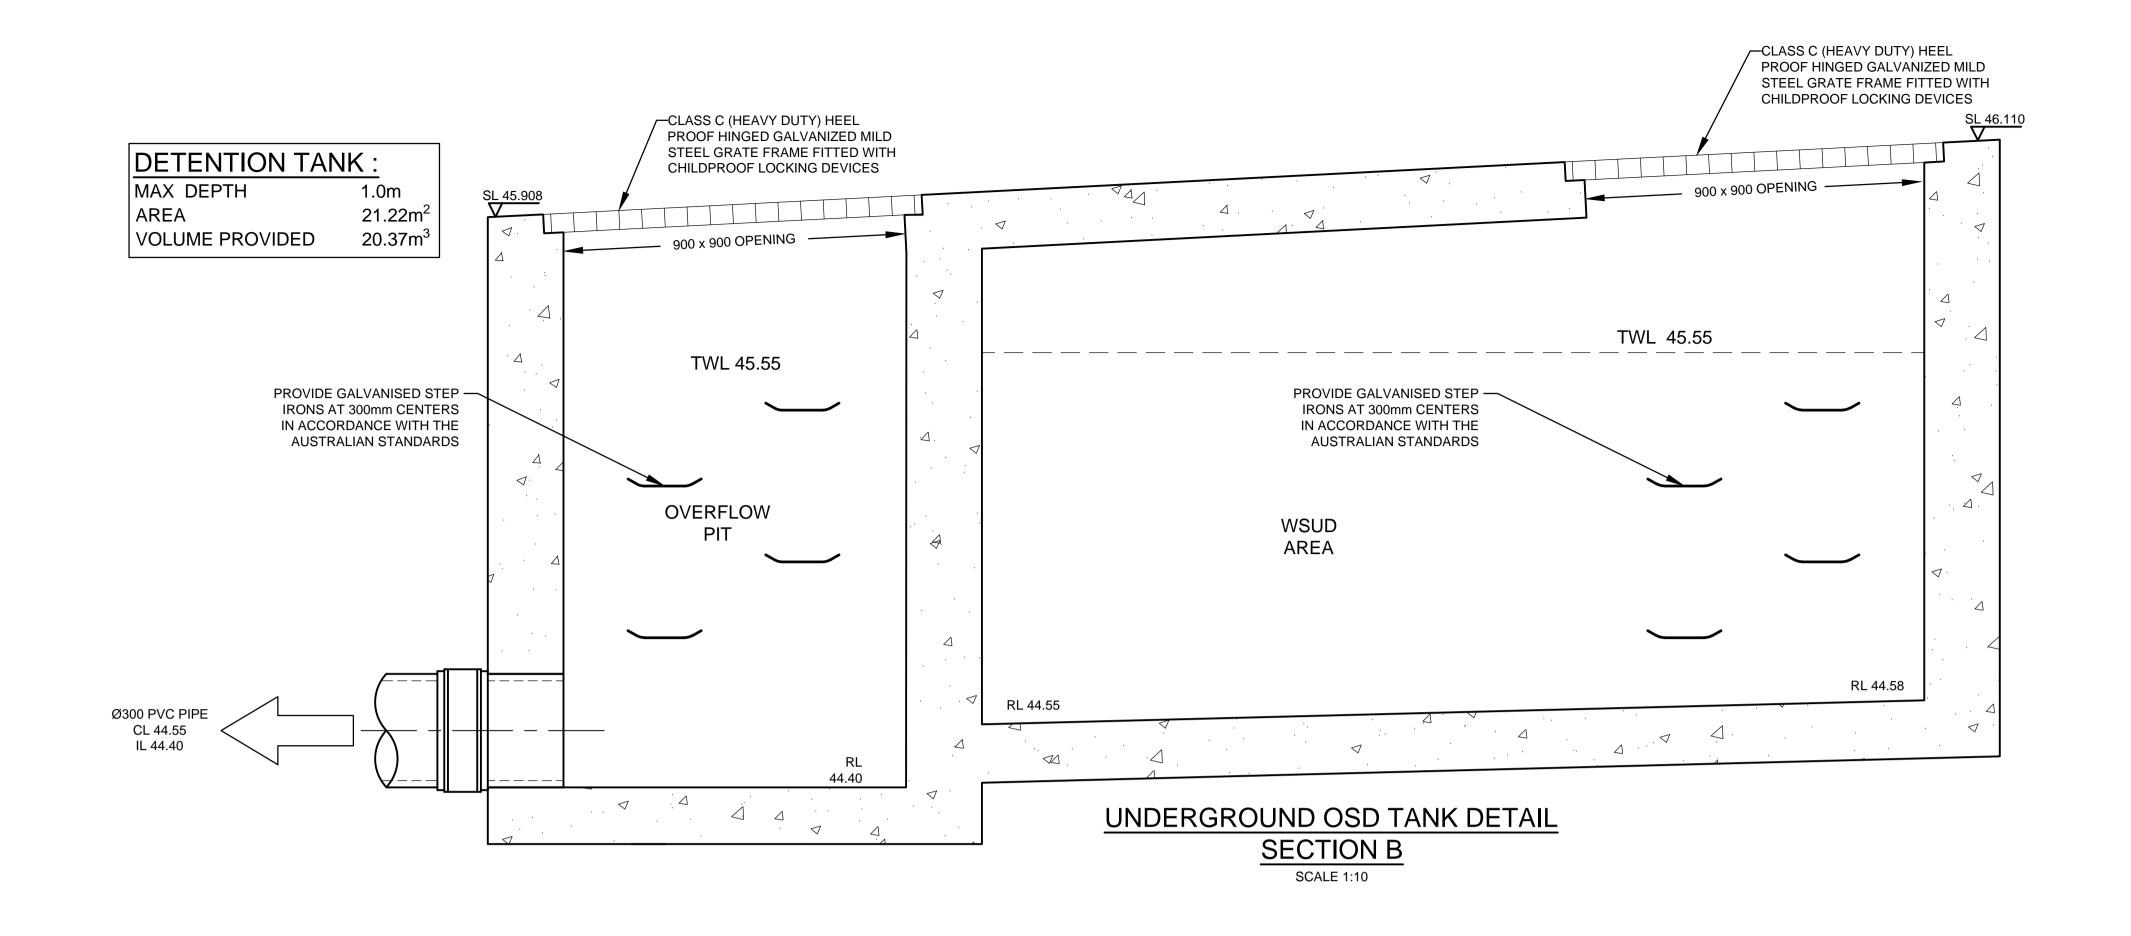
DEVELOPMENT APPLICATION


ENGINEERS. PH: (02) 9763 I500 FX: (02) 9763 I515 EMAIL: info@aceeng.com.au PHONE: 02 9380 4946 180919 103 1:100


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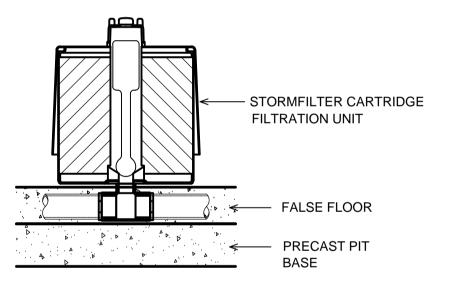




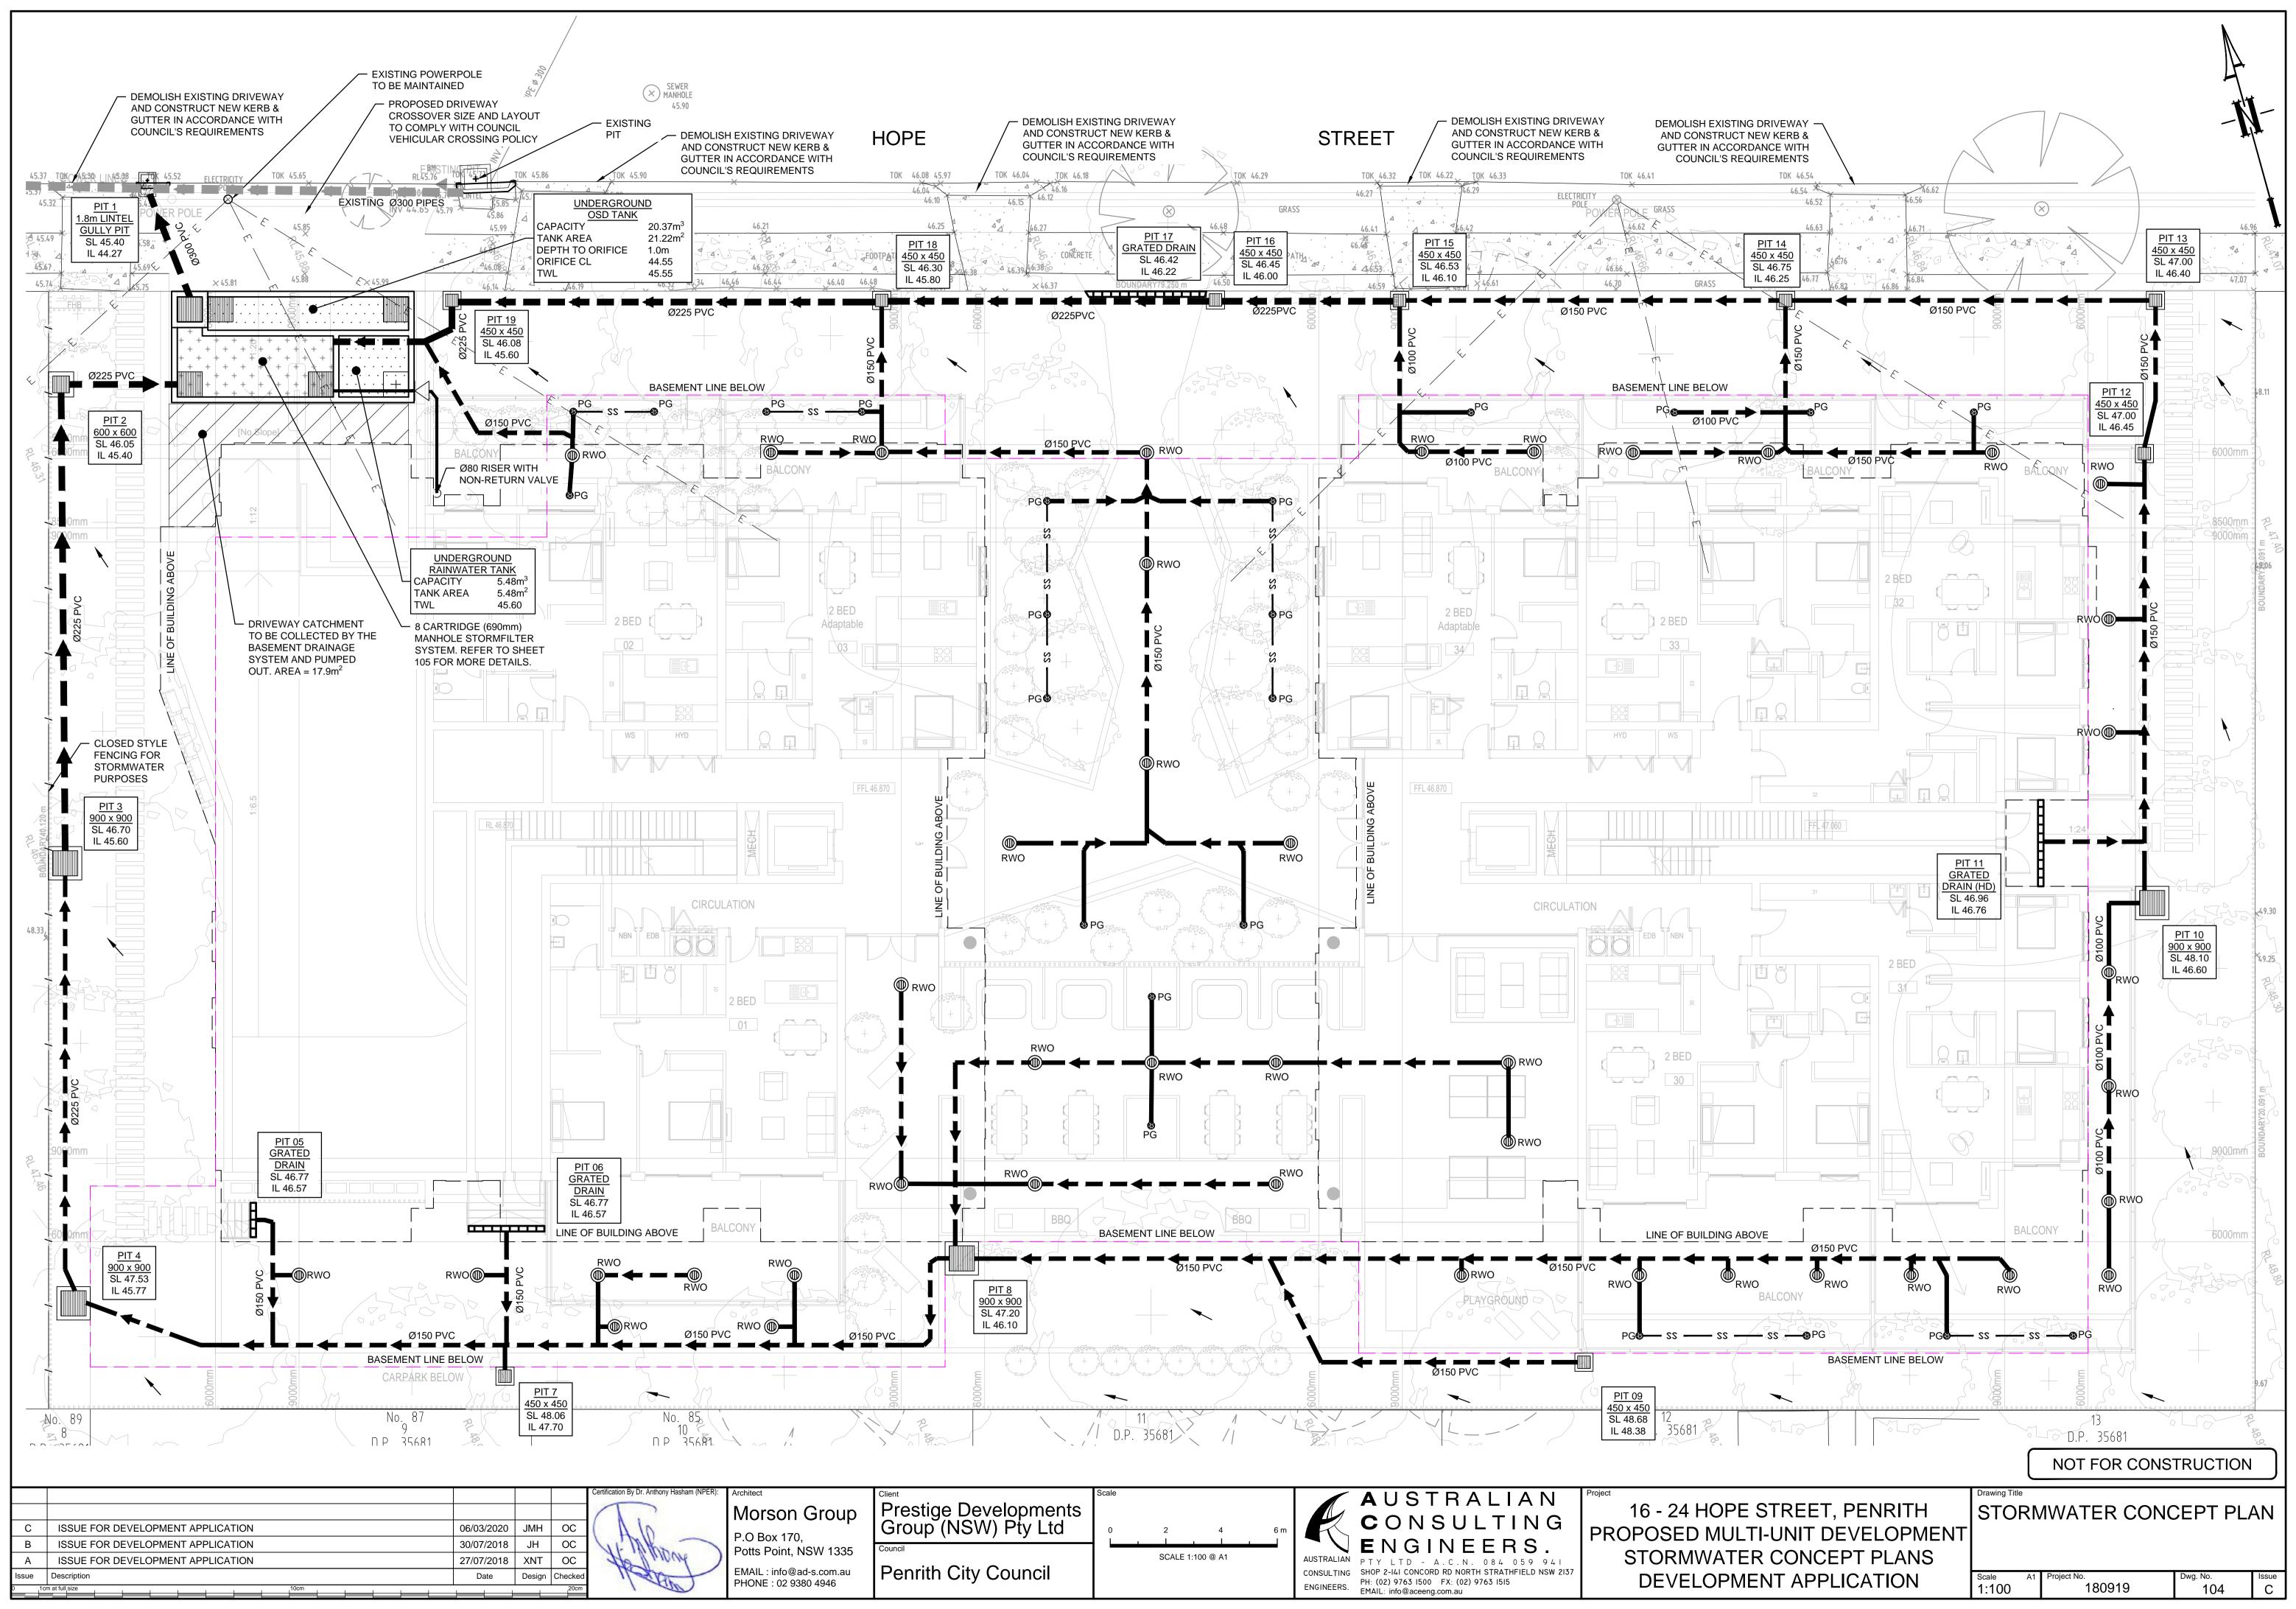

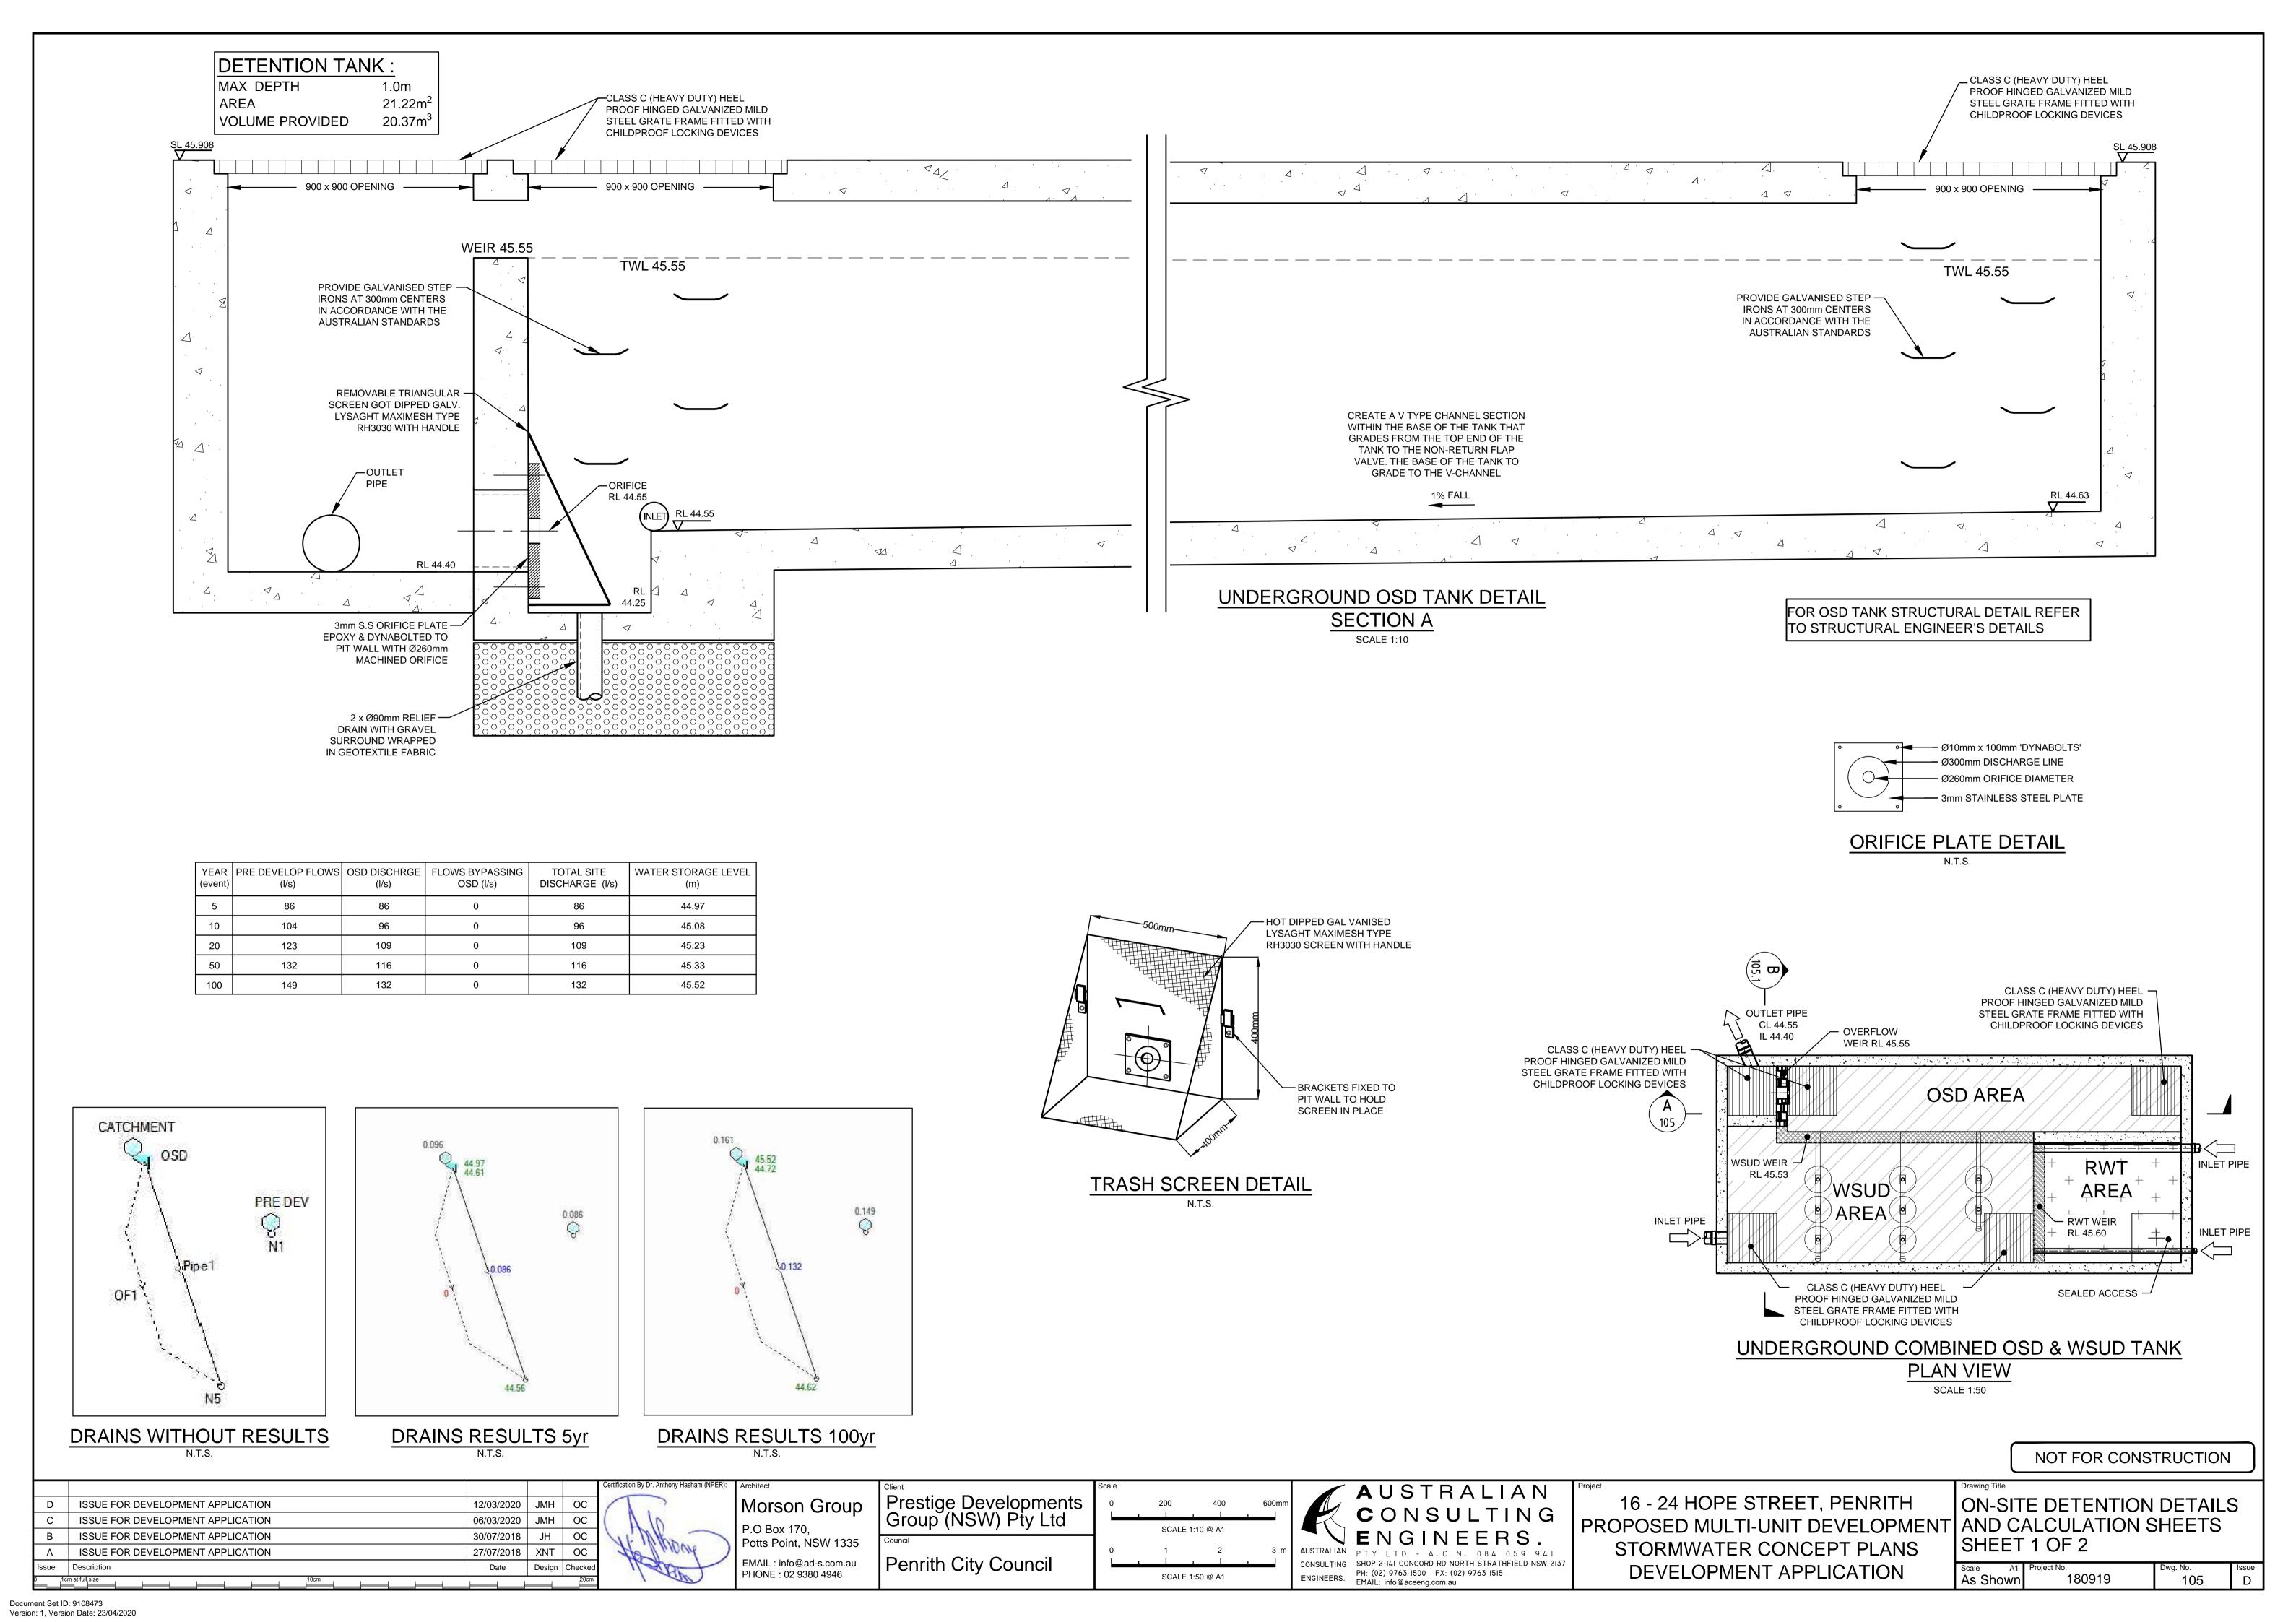

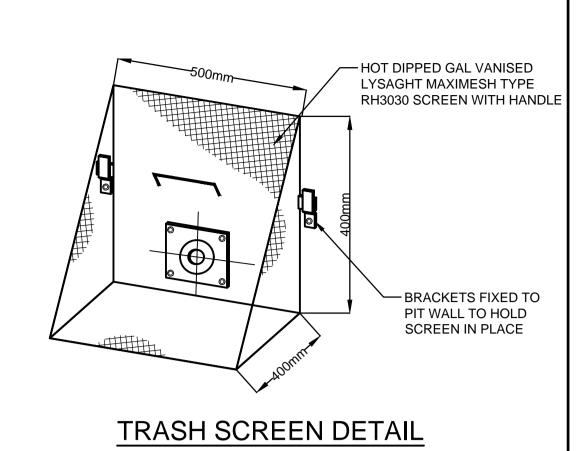ORIFICE PLATE DETAIL

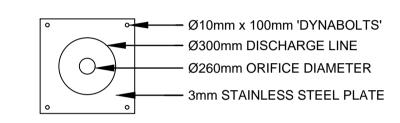

#### STORMFILTER DESIGN TABLE


- STORMFILTER TREATMENT CAPACITY VARIES BY NUMBER OF FILTER CARTRIDGES INSTALLED AND BY REGION SPECIFIC
- INTERNAL FLOW CONTROLS. CONVEYANCE CAPACITY IS RATED AT 80L/S. • THE STANDARD CONFIGURATION IS SHOWN. ACTUAL CONFIGURATION OF THE SPECIFIED STRUCTURE(S) PER CIVIL ENGINEER
- WILL BE SHOWN ON SUBMITTAL DRAWING(S). • ALL PARTS PROVIDED AND INTERNAL ASSEMBLY BY STORMWATER360 AUSTRALIA UNLESS OTHERWISE NOTED.

CARTRIDGE HEIGHT	690		460		310	
SYSTEM HYDRAULIC DROP (H - REQ'D. MIN.)	930		700		550	
TREATMENT BY MEDIA SURFACE AREA L/S/m2	1.4	0.7	1.4	0.7	1.4	0.7
CARTRIDGE FLOW RATE (L/s)	1.42	0.71	0.95	0.47	0.63	0.32

#### **GENERAL NOTES**

- 1. INLET AND OUTLET PIPING SHALL BE SPECIFIED BY SITE CIVIL ENGINEER (SEE PLANS) AND PROVIDED BY
- CONTRACTOR. STORMFILTER IS PROVIDED WITH OPENINGS AT INLET AND OUTLET LOCATIONS. 2. IF THE PEAK FLOW RATE, AS DETERMINED BY THE SITE CIVIL ENGINEER, EXCEEDS THE PEAK HYDRAULIC CAPACITY OF THE PRODUCT, AN UPSTREAM BYPASS STRUCTURE IS REQUIRED. PLEASE CONTACT
- STORMWATER360 FOR OPTIONS. 3. THE FILTER CARTRIDGE(S) ARE SIPHON-ACTUATED AND SELF-CLEANING. THE STANDARD DETAIL DRAWING SHOWS THE MAXIMUM NUMBER OF CARTRIDGES. THE ACTUAL NUMBER SHALL BE SPECIFIED BY THE SITE CIVIL ENGINEER ON SITE PLANS OR IN DATA TABLE BELOW. PRECAST STRUCTURE TO BE CONSTRUCTED IN ACCORDANCE WITH AS3600.
- 4. FOR SHALLOW, LOW DROP OR SPECIAL DESIGN CONSTRAINTS, CONTACT STORMWATER360 FOR DESIGN
- 5. ALL WATER QUALITY PRODUCTS REQUIRE PERIODIC MAINTENANCE AS OUTLINED IN THE O&M GUIDELINES. PROVIDE MINIMUM CLEARANCE FOR MAINTENANCE ACCESS.
- 6. STRUCTURE AND ACCESS COVERS DESIGNED TO MEET AUSTROADS T44 LOAD RATING WITH 0-2m FILL MAXIMUM.
- 7. THE STRUCTURE THICKNESSES SHOWN ARE FOR REPRESENTATIONAL PURPOSES AND VARY REGIONALLY.
- 8. ANY BACKFILL DEPTH, SUB-BASE, AND OR ANTI-FLOTATION PROVISIONS ARE SITE-SPECIFIC DESIGN
- CONSIDERATIONS AND SHALL BE SPECIFIED BY SITE CIVIL ENGINEER. 9.. STORMFILTER BY STORMWATER360:
- SYDNEY (AU) PHONE: (02) 9525 5833,

BRISBANE (AU) PHONE: (07) 3272 1872.

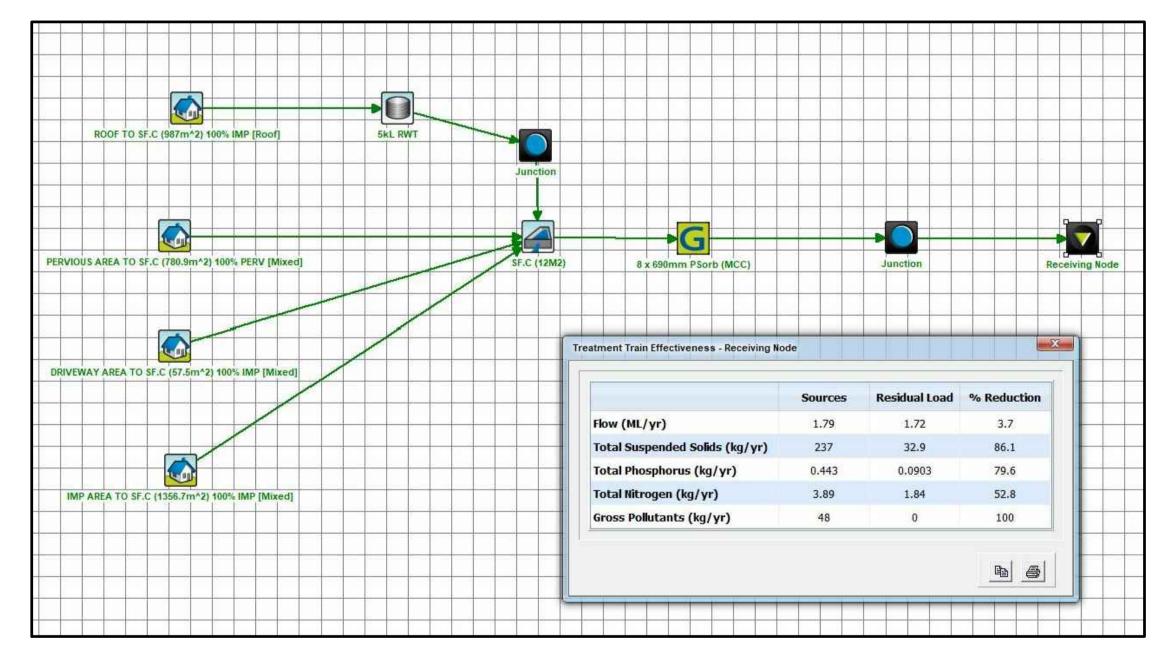

MUSIC MODEL RESULT

NOT FOR CONSTRUCTION

	Certification By Dr. Anthor	y Hasham (NPER): Architect	Client	Scale	AUSTRALIAN	Project A C A A LI O DE OTDEET DENDITIE	Drawing Title
		Morson Group	Prestige Developments	0 200 400 600mm	CONSILLTING		ON-SITE DETENTION DETAILS
	0/4	P.O Box 170,	Group (NSW) Pty Ltd	SCALE 1:10 @ A1	O O NOOLIING	PROPOSED MULTI-UNIT DEVELOPMENT	AND CALCULATION SHEETS
B ISSUE FOR DEVELOPMENT APPLICATION	12/03/2020 JMH OC	Potts Point NSW 1335	Council	SOALL 1.10 & AT	<b>ENGINEERS.</b>		
A ISSUE FOR DEVELOPMENT APPLICATION	06/03/2020 JMH OC	) Total olit, NSW 1935		0 1 2 3 m	AUSTRALIAN PTY LTD - A.C.N. 084 059 941	STORMWATER CONCEPT PLANS	SHEET 2 OF 2
Issue Description	Date Design Checked	EMAIL : info@ad-s.com.au	Penrith City Council		CONSULTING SHOP 2-141 CONCORD RD NORTH STRATHFIELD NSW 2137	DEVELOPMENT APPLICATION	Scale A1 Project No. Dwg. No. Issue
0 1cm at full size 10cm	20cm	FIIONE . 02 9300 4940	1	SCALE 1:50 @ A1	ENGINEERS. EMAIL: info@aceeng.com.au	DEVELOTIVILITATION TO THE	As Shown 180919 105.1 B

Version: 1, Version Date: 23/04/2020