Proposed New Single Storey Reisdence Located At: Lot 2053 in DP 1168989 Killuna Way, Jordan Springs. NSW

Schedule of BASIX commitments

The commitments set out below regulate how the proposed development is to be carried out. It is a condition of any development consent granted, or complying development certificate issued, for the proposed development, that BASIX commitments be complied with.

The applicant must install showerheads with a minimum rating of 3 star (> 4.5 but <= 6 L/min) in all showers in the development.

The applicant must install a toilet flushing system with a minimum rating of 1 star in each toilet in the development.

The applicant must install taps with a minimum rating of 3 star in the kitchen in the development.

The applicant must install basin taps with a minimum rating of 3 star in each bathroom in the development.

Alternative water

Rainwater tank

The applicant must install a rainwater tank of at least 2000 litres on the site. This rainwater tank must meet, and be installed in accordance with, the requirements of all applicable regulatory authorities.

The applicant must configure the rainwater tank to collect rain runoff from at least 319.37 square metres of the roof area of the development (excluding the area of the roof which drains to any stormwater tank or private dam).

The applicant must connect the rainwater tank to:

• all toilets in the development

· at least one outdoor tap in the development (Note: NSW Health does not recommend that rainwater be used for human consumption in areas with potable water supply.)

Floor, walls and ceiling/roof

The applicant must construct the floor(s), walls, and ceiling/roof of the dwelling in accordance with the specifications listed in the table

Construction Additional insulation required (R-Value) Other specifications

floor - concrete slab on ground nil

external wall - brick veneer 1.66 (or 2.20 including construction)

internal wall shared with garage - plasterboard nil

ceiling and roof - flat ceiling / pitched roof ceiling: 3 (up), roof: foil/sarking unventilated; medium (solar absorptance 0.475-0.70) Note Insulation specified in this Certificate must be installed in accordance with Part 3.12.1.1 of the Building Code of Australia.

The applicant must install the windows, glazed doors and shading devices described in the table below, in accordance with the specifications listed in the table. Relevant overshadowing specifications must be satisfied for each window and glazed door. The dwelling may have 1 skylight (<0.7 square metres) and up to 2 windows/glazed doors (<0.7 square metres) which are not listed in

The following requirements must also be satisfied in relation to each window and glazed door:

- Except where the glass is 'single clear' or 'single toned', each window and glazed door must have a U-value no greater than that listed and a Solar Heat Gain Coefficient (SHGC) +/-10% of that listed. Total system U-values and SHGC must be calculated in accordance with National Fenestration Rating Council (NFRC) conditions.
- The leading edge of each eave, pergola, verandah, balcony or awning must be no more than 500 millimetres above the head of the window or glazed door, except that a projection greater than 500 mm and up to 1500 mm above the head must be twice the value
- Pergolas with polycarbonate roof or similar translucent material must have a shading coefficient of less than 0.35.
- · Unless they have adjustable shading, pergolas must have fixed battens parallel to the window or glazed door above which they are situated, unless the pergola also shades a perpendicular window. The spacing between battens must not be more than 50 mm. Window/glazed door no. Orientation Maximum area

(square metres)

Type Shading Overshadowing
W1,W3,W4 N 5.85 standard aluminium, single clear (or

U-value: 7.63, SHGC: 0.75)

eave/verandah/pergola/balcony

451-600 mm

not overshadowed W2 N 1.53 standard aluminium, single clear (or

U-value:7.63, SHGC:0.75)

eave/verandah/pergola/balcony

1,500-2,000 mm

not overshadowed W5,W6,W7,W8 W 6.26 standard aluminium, single clear (or

U-value:7.63, SHGC:0.75)

eave/verandah/pergola/balcony

451-600 mm

not overshadowed

W9 S 6.3 standard aluminium, single clear (or

U-value:7.63, SHGC:0.75) eave/verandah/pergola/balcony

>2,000 mm

not overshadowed

W10,W11 S 4.98 standard aluminium, single clear (or U-value:7.63, SHGC:0.75)

eave/verandah/pergola/balcony

601-750 mm

not overshadowed

W12,W13,W14 E 4.41 standard aluminium, single clear (or

U-value: 7.63. SHGC: 0.75) eave/verandah/pergola/balcony

451-600 mm

not overshadowed

General Notes:

- 1. All work to be carried out in accoradnce with the requirements of the Building Code of Australia and the relevant local authority.
- 2. All timber framing to be carried out to the requirements of Australian Standards (as 1684) as a minimum.
- 3. All reinforced concrete, steel beams including supports, and
- nominated beams including supports to Engineer's details.
 4. Sturctural Engineer to check, detail and certify brickwork to garage area with a height greater than 3000mm between horizontal supports. 5. All brickwork to be constructed in accordance with the requirements
- of the Building Code of Australia. 6. Control joints in brickwork to be provided in accordance with the
- requirements of the Building Code of Australia. 7. Doorway openings with inward opening doors to room containing toilets which are closer than 1200mm to the toilet are to be ftted with hinges to allow the door to be removed from the outside when the

Construction Notes:

- * R2.20 External Wall Insulation (Including Construction)
- * R3.0 Ceiling Insulation
- * Provide Foil & Sarking to Roof
- * Control Joints to be checked in accordance with engineers plans
- Centre of kitchen Sink, Vanity, WC, Range Hood, to be confirmed with owner & Manufacturer Details.
- * All windows, Insulation requirements, lighting to
- comply with Basix Certificate Approvde by council.
- Structural slab to engineer details.
- * Metre Box, Gas Metre to be confirmed with Builder
- Downpipes to be confirmed with plumber on site.

Hot water

The applicant must install the following hot water system in the development, or a system with a higher energy rating: gas instantaneous with a performance of 4 stars.

Cooling system

The applicant must install the following cooling system, or a system with a higher energy rating, in at least 1 living area: 3-phase airconditioning; Energy rating: EER 3.5 - 4.0

The applicant must install the following cooling system, or a system with a higher energy rating, in at least 1 bedroom: 3-phase

airconditioning; Energy rating: EER 3.5 - 4.0 Heating system

The applicant must install the following heating system, or a system with a higher energy rating, in at least 1 living area: 3-phase airconditioning; Energy rating: EER 3.5 - 4.0

The applicant must install the following heating system, or a system with a higher energy rating, in at least 1 bedroom: 3-phase airconditioning; Energy rating: EER 3.5 - 4.0

The applicant must install the following exhaust systems in the development:

At least 1 Bathroom: no mechanical ventilation (ie. natural); Operation control: n/a

Kitchen: individual fan, ducted to façade or roof; Operation control: manual switch on/off Laundry: natural ventilation only, or no laundry; Operation control: n/a

Natural lighting

The applicant must install a window and/or skylight in the kitchen of the dwelling for natural lighting.

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The applicant must install a window and/or skylight in 2 bathroom(s)/toilet(s) in the development for natural lighting.

The applicant must install a gas cooktop & electric oven in the kitchen of the dwelling. The applicant must construct each refrigerator space in the development so that it is "well ventilated", as defined in the BASIX


The applicant must install a fixed outdoor clothes drying line as part of the development


			8	Sedimentaion & Waste Plan
			7	Site Analysis Plan
F	23.08.13	Designs Amended	6	Elevations
E	01.08.13	Designs Amended	5	Elevations
D	23.07.13	Designs Amended	4	Roof Plan & Section A-A
С	16.07.13	Designs Amended	3	Ground Floor Plan
В	09.07.13	Designs Amended	2	Site Plan
Α	03.07.13	Designs	1	Cover Sheet
Rev	Date	Amendments	Sheet	Description

Issue	Amendment	Date	#			North:
Α	Designs	03.07.13				
В	Design Amended	09.07.13		//	//	
С	Design Amended	16.07.13	DESTG	N &	<u>DRAFTİNG</u>	
D	Design Amended	23.07.13	RESIDENTIAL	DESIGN &	DRAFTING SERVICES	
E	Design Amended	01.08.13	Phone: (02) 9757 - 40	and the second	and the second	
F	Submission to Jordan Springs	23.08.13	Email: jr.design. Address: 448 - 452 Victoria	.drafting@	gmail.com therill Park. NSW 2164	
				Note:		
			Builder shall check and verify all		ior to the commencement	This plan is to


1:	Proposed:	Drawing Title:		Revision:
	New Single Storey Residence	Cover Page / B Requirements	asix	F
	Location:	L.G.A		•
	Lot 2053 Kiluna Way, Jordan Springs. NSW	Penrith	Council	Job No:
Copyright:	Client:	Drawn JR	Date 23.08.2013	LB1309


Sheet

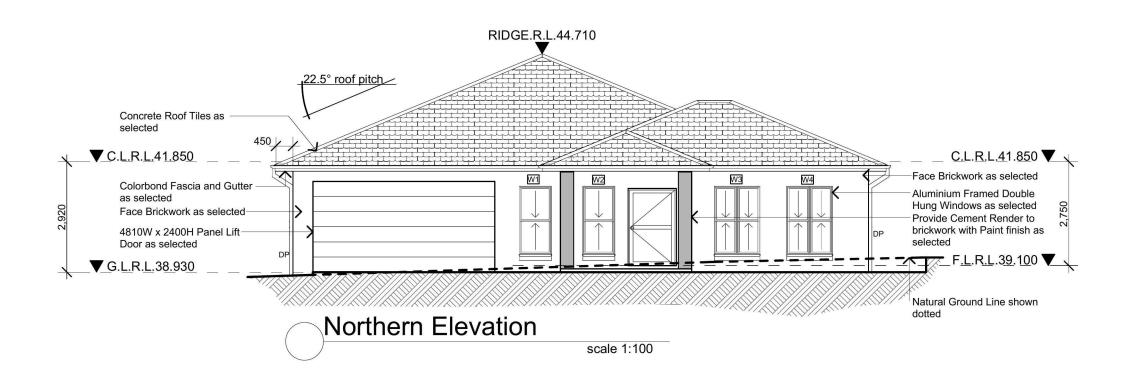

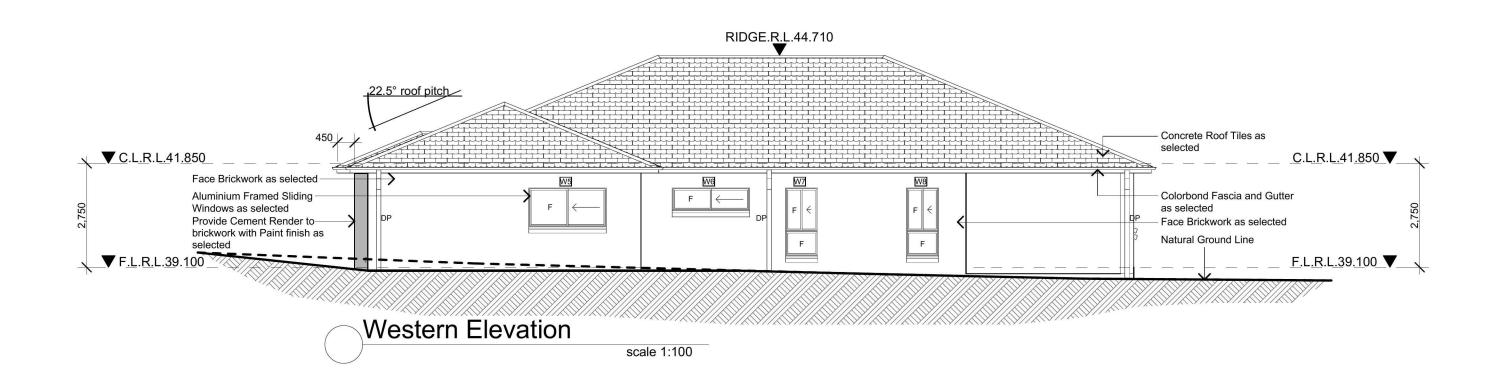

Issue Amendment	Date:	#	North:	General Notes		Proposed:	Drawing Title:	Revision:
A Designs B Design Amended	03.07.13 09.07.13			All work shall be carried out strictly in accordance with The Building Code Of Australia, relevant S.A.A. codes		New Single Storey Residence	Southern Elevation Eastern Elevation	F
C Design Amended D Design Amended E Design Amended	16.07.13 23.07.13 01.08.13	DESIGN & DRAFTING RESIDENTIAL DESIGN & DRAFTING SERVICES Phone: (02) 9757 - 4002 Fax: (02) 9757 - 4003		At the satisfaction of the regulatory authority. All levels, dimensions & areas are to be verified by the Builder, prior to the preparation of contracts	reduced levels or Australian Height Datum Levels. Figured dimensions to be taken in preference to scaling. All Boundary clearances must be verified by Survey.	Lot 2053 Kiluna Way,	Penrith Council	Job No:
	23.08.13	Email: jr.design.drafting@gmail.com ess: 448 - 452 Victoria Street, Wetherill Park. NSW 2164		& the commencement of any building works. Any discrepancies are to be brought to the attention	Stormwater to be disharged to Councils requirements before any work commences.	Jordan Springs. NSW Client:	Drawn JR Date 23.08.2013	B1309
		Note: Builder shall check and verify all dimensions prior to the commencement of any work		of JR Design & Drafting, prior to the commencement of any building works.	All services to be located & verified by the Builder with relevant Authorities before any work commences.	LB Homes	Scale 1:100 Sheet 5 of 8	

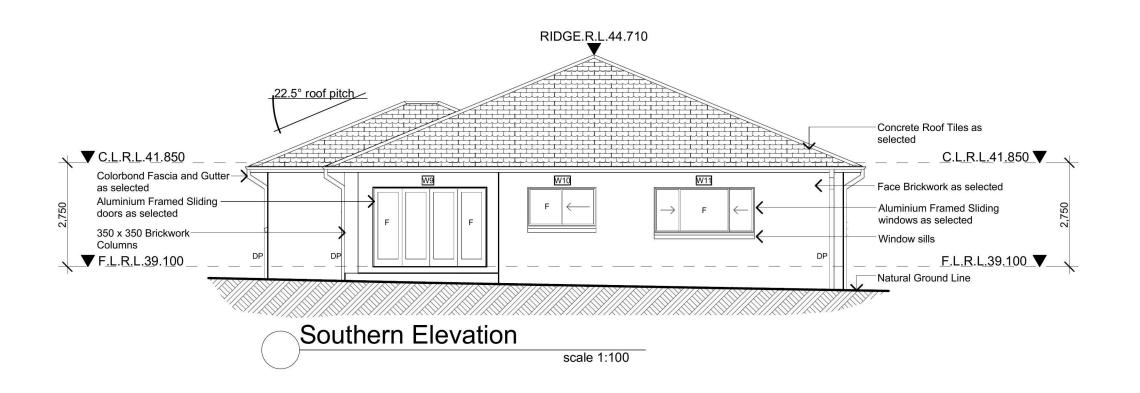

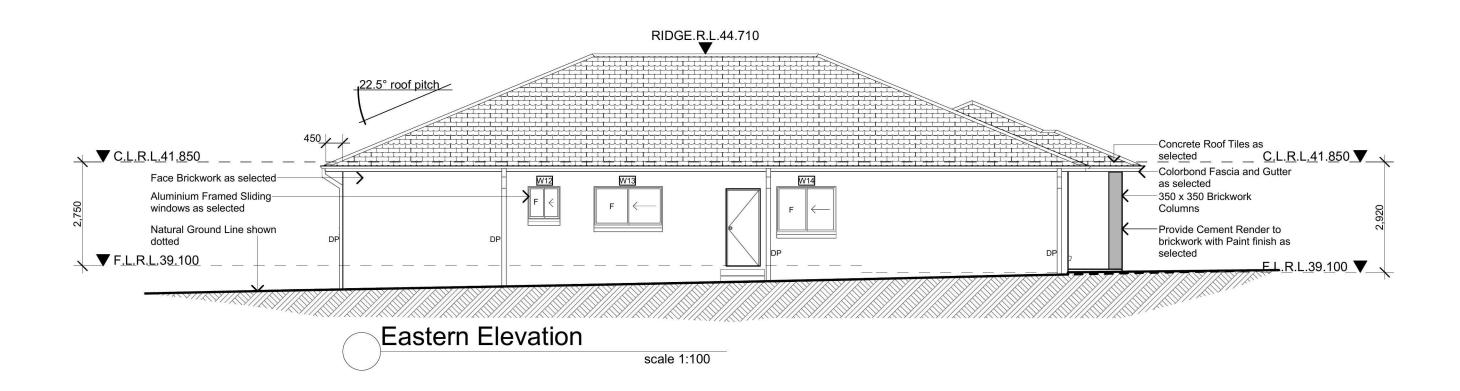

Issu	Amendment	Date:	#	North:	General Notes		Proposed:	Drawing Title:	Revision:
A B	Designs Design Amended	03.07.13 09.07.13			All work shall be carried out strictly in accordance with The Building Code Of Australia, relevant S.A.A. codes		New Single Storey Residence	Southern Elevation Eastern Elevation	F
C D	Design Amended Design Amended	16.07.13 23.07.13	Phone: (02) 9757 - 4002 Fax: (02) 9757 - 4003		& to the satisfaction of the regulatory authority. All levels, dimensions & areas are to be verified	reduced levels or Australian Height Datum Levels. Figured dimensions to be taken in preference to scaling.	Location: Lot 2053 Kiluna Way,	Penrith Council	lob No:
F	Design Amended Submission to Jordan Springs	01.08.13 23.08.13	Email: jr.design.drafting@gmail.com Address: 448 - 452 Victoria Street, Wetherill Park. NSW 2164		by the Builder, prior to the preparation of contracts & the commencement of any building works. Any discrepancies are to be brought to the attention	All Boundary clearances must be verified by Survey. Stormwater to be disharged to Councils requirements before any work commences.	Jordan Springs. NSW Client:		LB1309
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VACANT



- THIS SURVEY DOES NOT GUARANTEE THE LOCATION OF BOUNDARY PEGS.
- NON-VISIBLE SERVICES HAVE <u>NOT</u> BEEN LOCATED.
- THE CERTIFICATE OF TITLE MUST BE CHECKED FOR EASEMENTS AND ENCUMBRANCES.

ORIGIN OF LEVELS BASED ON SSM180147 R.L.38.738 A.H.D. ORIGIN BY OTHERS

'C' EASEMENT TO DRAIN WATER 2 WIDE

WARNING:-

- 1. Plan compiled from information at Land Titles Office as regards dimensions and these are subject to final survey.
- All details and features shown hereon have been plotted in relation to the occupations (fences and/or walls, etc.). These occupations have not yet been accurately located in relation to the boundaries.
- 3. The detail and features and contours are shown to scale plot accuracy only. Copying may distort the scale.
- 4. Service structures shown hereon are those that were visible at the time of survey and have been located by field survey. Further services may be present. Prior to any construction or excavation on site the relevant authorities should be contacted for possible location of further underground services and detailed locations of all services.

LEVEL AND FEATURE SURVEY
AT LOT 2053 D.P.1168989
KILLUNA WAY
JORDAN SPRINGS

ASHER SILCOCK CONSULTING PTY LTD
A.C.N. 155 115 790

A.C.N. 155 115 790 2/231 Maroubra Rd, Maroubra, NSW 2035 PHONE: 0408446567 EMAIL: steve@asherconsulting.com.au

CIVIL AND RESIDENTIAL SURVEYORS

REV. AMENDMENT DATE:

REDUCTION RATIO:

1:200

DRAWING No.

13681†s

DATUM:

A.H.D.

DRAWN BY:

DB

DATE:

