

# 110 - 112 MOUNT VERNON ROAD, MOUNT VERNON PROPOSED CHILDCARE CENTRE

## STORMWATER CONCEPT PLAN



LOCALITY PLAN  
N.T.S

### DRAWING INDEX

Drawing No.	DESCRIPTION
ACE171195.SW.DA - 000	COVER SHEET PLAN
ACE171195.SW.DA - 101	STORMWATER CONCEPT PLAN GROUND LEVEL
ACE171195.SW.DA - 102	WSUD TANK DETAILS SHEET 1 OF 3
ACE171195.SW.DA - 103	WSUD TANK DETAILS SHEET 2 OF 3
ACE171195.SW.DA - 104	WSUD TANK DETAILS SHEET 3 OF 3
ACE171195.SW.DA - 105	MISCELLANEOUS DETAILS SHEET

NOT FOR CONSTRUCTION

Issue	Description	Date	Drawn	Design	Checked
E	COUNCIL COMMENTS	30/03/2020	HUV	EHZ	JSF
D	COUNCIL COMMENTS	10/10/2019	HUV	EHZ	JSF
C	COUNCIL COMMENTS	26/03/2019	HUV	EHZ	JAB
B	COUNCIL COMMENTS	27/02/2018	HUV	JTF	MBR
A	ISSUE FOR DEVELOPMENT APPLICATION	30/11/2017	HUV	EHZ	MBR

Project Work  
Design Pty  
PO Box 5138, Chittaway  
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Client  
Vladimir Vanovac  
Council  
Penrith City Council

Scale

Certification By:  
Anthony Hasham

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Project  
110 - 112 MOUNT VERNON ROAD, MOUNT VERNON  
PROPOSED CHILDCARE CENTRE  
STORMWATER CONCEPT PLAN  
DEVELOPMENT APPLICATION

Drawing Title  
COVER SHEET PLAN  
Scale  
N.T.S.  
Project No.  
171195  
Dwg. No.  
000  
Issue  
E



**GENERAL NOTES**

- ALL LINES ARE TO BE Ø90 uPVC 1.0% GRADE UNLESS NOTED OTHERWISE. CHARGED LINES TO BE SEWERGRADE & SEALED.
- EXISTING SERVICES LOCATIONS SHOWN INDICATIVE ONLY. IT IS THE CONTRACTOR'S RESPONSIBILITY TO LOCATE & LEVEL ALL EXISTING SERVICES PRIOR TO THE COMMENCEMENT OF ANY EARTHWORKS.
- ALL PIPES TO HAVE MIN 150mm COVER IF LOCATED WITHIN PROPERTY.
- ALL PITS IN DRIVEWAYS TO BE 450x450 CONCRETE AND ALL PITS IN LANDSCAPED AREAS TO BE 450x450 PLASTIC.
- PITS LESS THAN 600mm DEEP MAY BE BRICK, PRECAST OR CONCRETE.
- ALL BALCONIES AND ROOFS TO BE DRAINED AND TO HAVE SAFETY OVERFLOWS IN ACCORDANCE WITH RELEVANT AUSTRALIAN STANDARDS.
- ALL EXTERNAL SLABS TO BE WATERPROOFED.
- ALL GRATES TO HAVE CHILD PROOF LOCKS.
- ALL DRAINAGE WORKS TO AVOID TREE ROOTS.
- ALL DPs TO HAVE LEAF GUARDS.
- ALL EXISTING LEVELS TO BE CONFIRMED BY BUILDER PRIOR TO CONSTRUCTION.
- ALL WORK WITHIN COUNCIL RESERVE TO BE INSPECTED BY COUNCIL PRIOR TO CONSTRUCTION.
- COUNCIL'S ISSUED FOOTWAY DESIGN LEVELS TO BE INCORPORATED INTO THE FINISHED LEVELS ONCE ISSUED BY COUNCIL.
- ALL WORK SHALL BE IN ACCORDANCE WITH B.C.A. AND A.S.3500.3.
- REFER TO LANDSCAPE ARCHITECT'S DRAWINGS FOR LANDSCAPING.
- CARE TO BE TAKEN AROUND EXISTING SEWER. STRUCTURAL ADVICE IS REQUIRED FOR SEWER PROTECTION AGAINST ADDITIONAL LOADING FROM NEW PITS, PIPES, RETAINING WALLS AND OSD BASIN WATER LEVELS.
- THE OSD BASIN / TANK IS TO BE BUILT TO THE CORRECT LEVELS & SIZE AS PER THIS DESIGN. ANY VARIATIONS ARE TO BE DONE UNDER CONSULTATION FROM OUR OFFICE ONLY. ANY AMENDMENTS WITHOUT OUR APPROVAL WOULD RESULT IN ADDITIONAL FEES FOR REDESIGN AT OC STAGE OR IF A SOLUTION CANNOT BE FOUND, RECONSTRUCTION IS REQUIRED UNDER THE CONTRACTOR'S EXPENSES.

**LEGEND**

- PROPOSED STORMWATER
- EXISTING OPTIC FIBER MAN (FROM RECORDS)
- EXISTING WATER (FROM RECORDS)
- EXISTING POWER (FROM RECORDS)
- EXISTING TELSTRA (FROM RECORDS)
- GUTTER DOWNPIPE
- ROOF SLOPE
- Ø300 CLEANING EYE
- SURFACE FLOW ARROWS
- DESIGN SURFACE LEVEL
- EXISTING SURFACE LEVEL
- PROPOSED OSD STORAGE
- PROPOSED WSUD / BIO-RETENTION AREA / POND
- PROPOSED PERVIOUS PAVING PARKING


**TREE NOTE:**  
ALL TREES TO BE TREATED AS PER THE ARBORIST REPORT (WHERE AVAILABLE).

**PIPES NOTE:**  
Ø65 PVC @ MIN 1.0%  
Ø90 PVC @ MIN 1.0%  
Ø100 PVC @ MIN 1.0%  
Ø150 PVC @ MIN 1.0%  
Ø225 PVC @ MIN 0.5%  
Ø300 PVC @ MIN 0.4%  
UNLESS NOTED OTHERWISE

**ABSORPTION PIT CALCULATION**

IMPERVIOUS AREA	VOLUME REQUIRED	VOLUME PROVIDED
100 m <sup>2</sup>	2.5 m <sup>3</sup>	0 m <sup>3</sup>
2607 m <sup>2</sup>	65.18 m <sup>3</sup>	65.61 m <sup>3</sup>

**GROUND FLOOR PLAN**  
SCALE 1:200

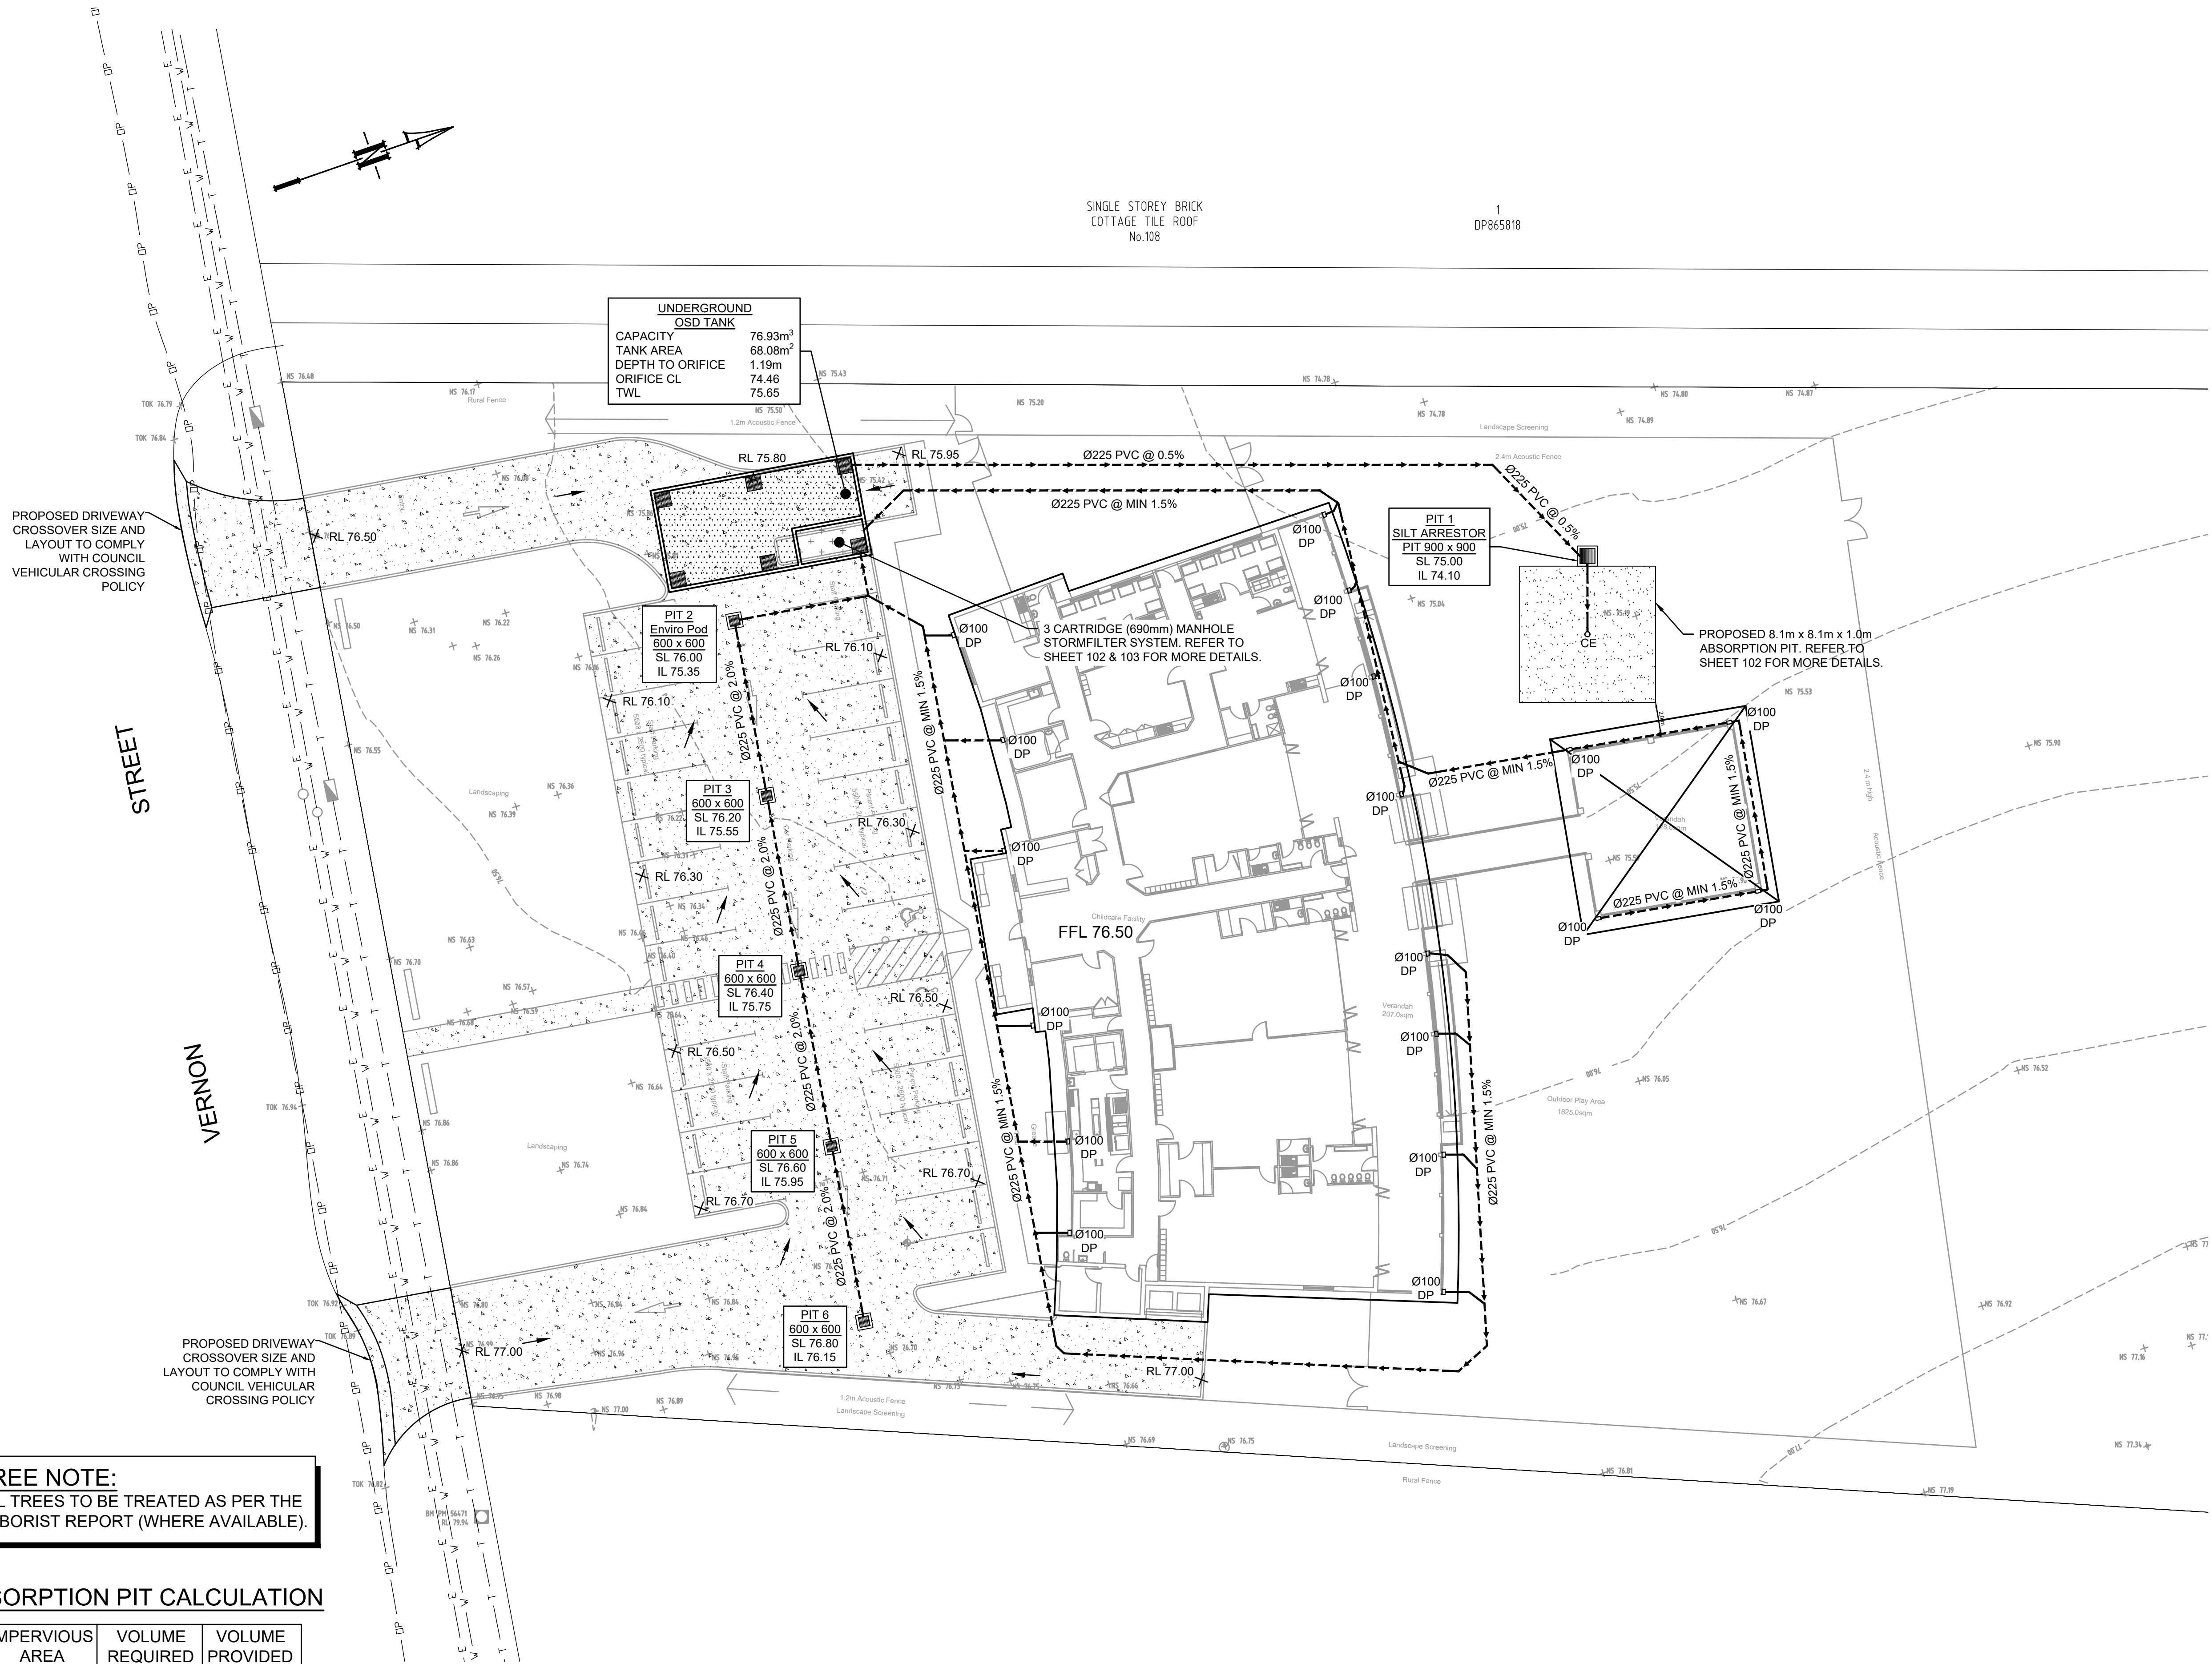


**NOT FOR CONSTRUCTION**


<table border="1"> <tr><td>E</td><td>COUNCIL COMMENTS</td><td>30/03/2020</td><td>HUV</td><td>EHZ</td><td>JSF</td><td>Architect</td></tr> <tr><td>D</td><td>COUNCIL COMMENTS</td><td>10/10/2019</td><td>HUV</td><td>EHZ</td><td>JSF</td><td></td></tr> <tr><td>C</td><td>COUNCIL COMMENTS</td><td>26/03/2019</td><td>HUV</td><td>EHZ</td><td>JAB</td><td></td></tr> <tr><td>B</td><td>COUNCIL COMMENTS</td><td>27/02/2018</td><td>HUV</td><td>JTF</td><td>MBR</td><td></td></tr> <tr><td>A</td><td>ISSUE FOR DEVELOPMENT APPLICATION</td><td>30/11/2017</td><td>HUV</td><td>EHZ</td><td>MBR</td><td></td></tr> <tr><td>Issue</td><td>Description</td><td>Date</td><td>Drawn</td><td>Design</td><td>Checked</td><td></td></tr> </table>	E	COUNCIL COMMENTS	30/03/2020	HUV	EHZ	JSF	Architect	D	COUNCIL COMMENTS	10/10/2019	HUV	EHZ	JSF		C	COUNCIL COMMENTS	26/03/2019	HUV	EHZ	JAB		B	COUNCIL COMMENTS	27/02/2018	HUV	JTF	MBR		A	ISSUE FOR DEVELOPMENT APPLICATION	30/11/2017	HUV	EHZ	MBR		Issue	Description	Date	Drawn	Design	Checked		<p><b>Project Work Design Pty</b> PO Box 5138, Chittaway Bay NSW 2261 M : 0412 637 875 W : pwdesign.com.au</p>	<p>Client <b>Vladimir Vanovac</b></p> <p>Council <b>Penrith City Council</b></p>	<p>Scale 0 3 6 9 m SCALE 1:200 @ A1</p>	<p>Certification By:  <b>Anthony Hasham</b></p>	<p><b>AUSTRALIAN CONSULTING ENGINEERS.</b> PTY LTD - A.C.N. 084 059 941 SHOP 2-4/1 CONCORD RD NORTH STRATHFIELD NSW 2137 PH: (02) 9763 1500 FX: (02) 9763 1515 EMAIL: info@aceeng.com.au</p>	<p>Project <b>110 - 112 MOUNT VERNON ROAD, MOUNT VERNON PROPOSED CHILDCARE CENTRE STORMWATER CONCEPT PLAN DEVELOPMENT APPLICATION</b></p>	<p>Drawing Title <b>STORMWATER CONCEPT PLAN</b></p>
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<p>Scale 1:200</p>		<p>Project No. 171195</p>	<p>Dwg. No. 101</p>	<p>Issue E</p>																																													



<b>DETENTION TANK:</b>	
MAX TANK DEPTH	1.44m
MIN TANK DEPTH	1.42m
AREA	68.08m <sup>2</sup>
VOLUME PROVIDED	76.93m <sup>3</sup>

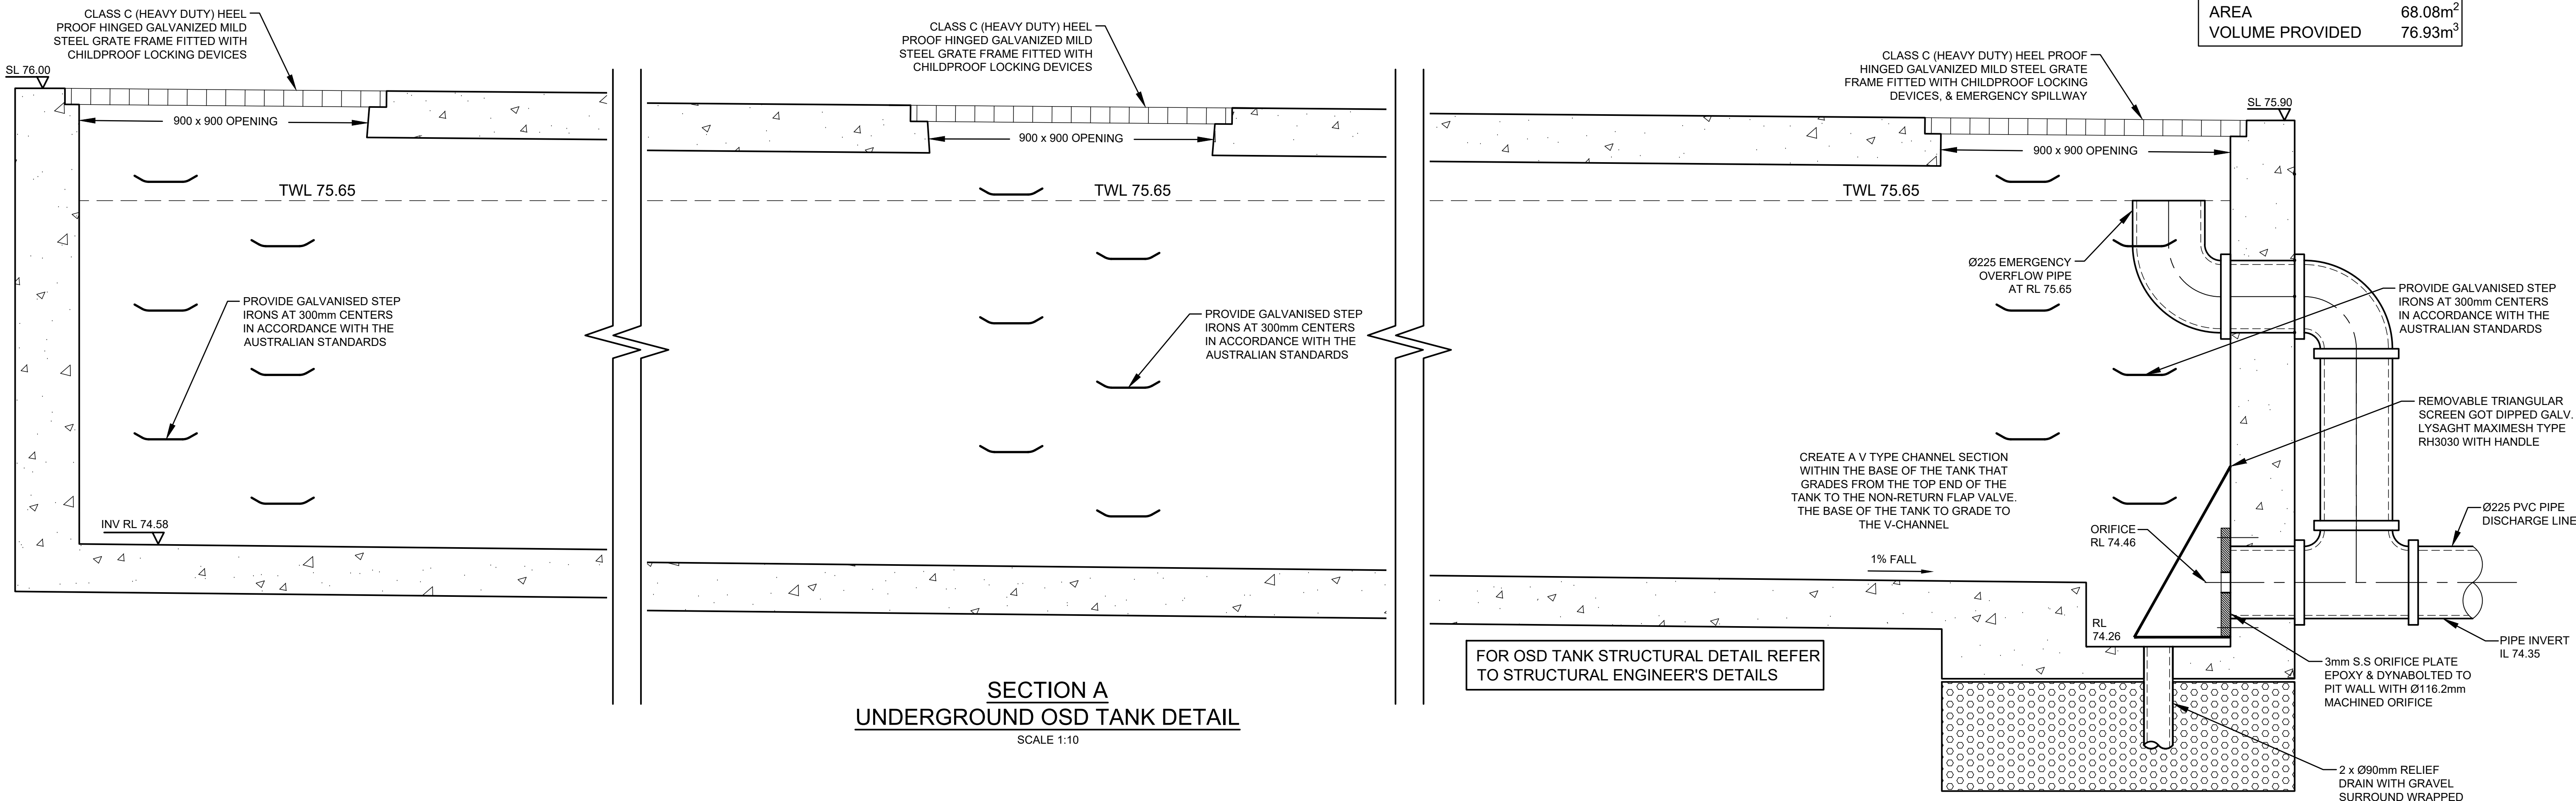

**SECTION A**  
**UNDERGROUND OSD TANK DETAIL**  
SCALE 1:10

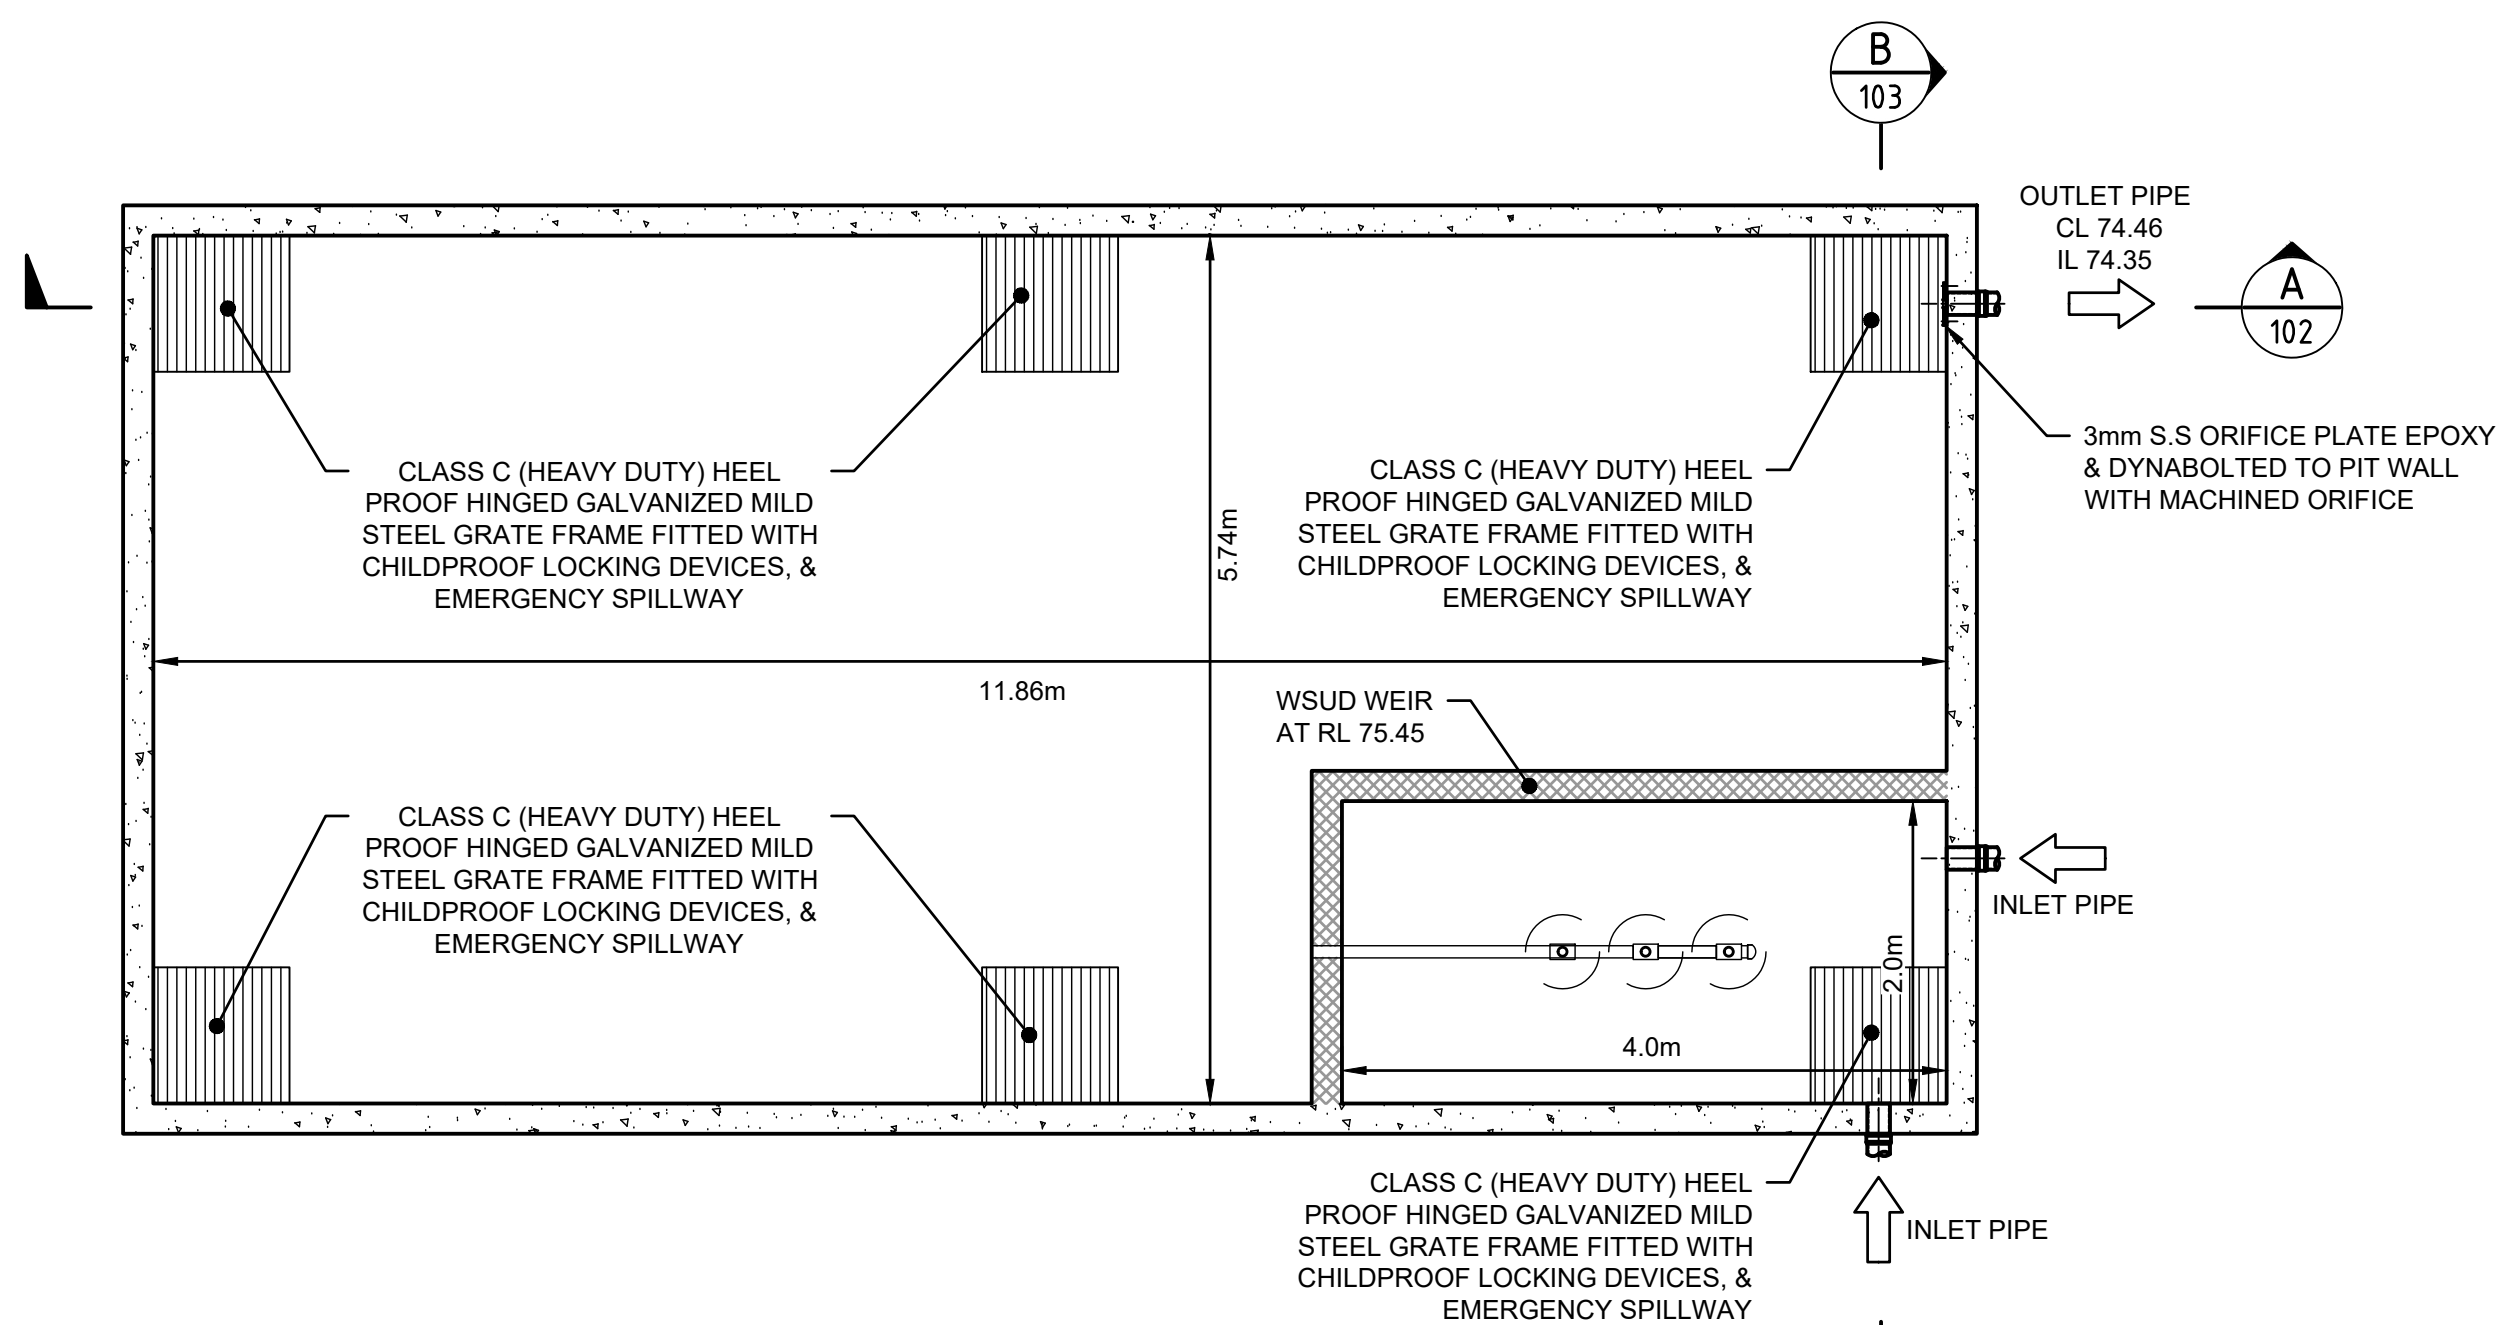


**UNDERGROUND COMBINED OSD & WSUD TANK**  
**PLAN VIEW**  
SCALE 1:50

**NOT FOR CONSTRUCTION**

E COUNCIL COMMENTS		30/03/2020	HUV	EZH	JSF	Architect	Client	Scale	Certification By:	<b>AUSTRALIAN CONSULTING ENGINEERS.</b> PTY LTD - A.C.N. 084 059 941 SHOP 2-141 CONCORD RD NORTH STRATHFIELD NSW 2137 PH: (02) 9763 1500 FX: (02) 9763 1515 EMAIL: info@aceeng.com.au	Project <b>110 - 112 MOUNT VERNON ROAD, MOUNT VERNON</b> <b>PROPOSED CHILDCARE CENTRE</b> <b>STORMWATER CONCEPT PLAN</b> <b>DEVELOPMENT APPLICATION</b>	Drawing Title	
D COUNCIL COMMENTS		10/10/2019	HUV	EZH	JSF	<b>Project Work Design Pty</b>	<b>Vladimir Vanovac</b>	0 200 400 600mm	 Anthony Hasham			<b>WSUD TANK DETAILS</b> <b>SHEET 1 OF 3</b>	
C COUNCIL COMMENTS		26/03/2019	HUV	EZH	JAB	PO Box 5138, Chittaway Bay NSW 2261	Council	SCALE 1:10 @ A1				Scale A1 Project No. 171195 Dwg. No. 102 Issue E	
B COUNCIL COMMENTS		27/02/2018	HUV	JTF	MBR	M: 0412 637 875 W: pwdesign.com.au	<b>Penrith City Council</b>	0 1 2 3 m					
A ISSUE FOR DEVELOPMENT APPLICATION		30/11/2017	HUV	EZH	MBR			SCALE 1:50 @ A1					
Issue	Description	Date	Drawn	Design	Checked								

<b>DETENTION TANK:</b>	
MAX TANK DEPTH	1.44m
MIN TANK DEPTH	1.42m
AREA	68.08m <sup>2</sup>
VOLUME PROVIDED	76.93m <sup>3</sup>

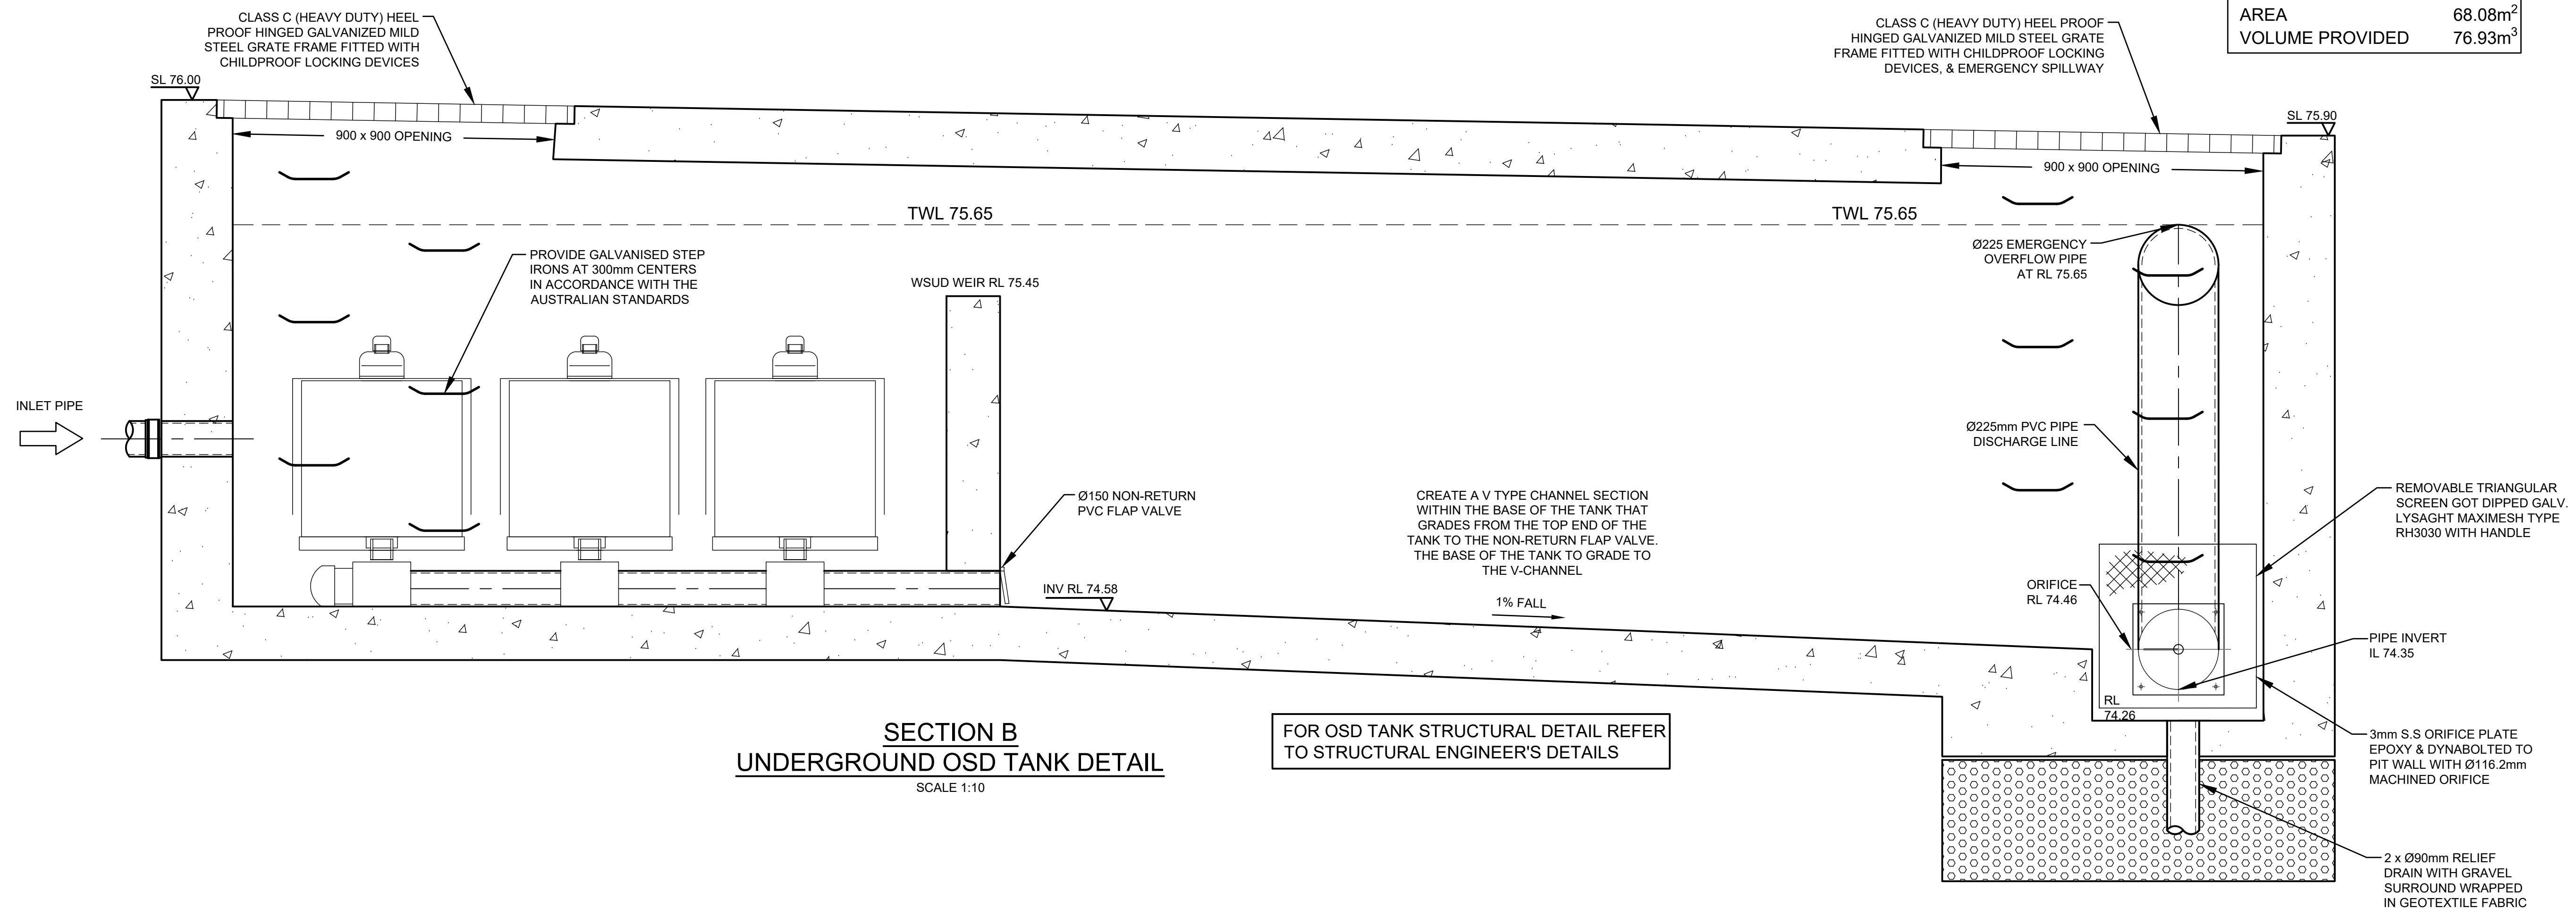

**UNDERGROUND OSD TANK STAGED STORAGE CALCULATIONS**

DEPTH (mm)	AREA (m <sup>2</sup> )	CUMULATIVE VOLUME (m <sup>3</sup> )
0	68.08	0
120	68.08	4.0848
200	68.08	9.5312
300	68.08	16.3392
400	68.08	23.1472
500	68.08	29.9552
600	68.08	36.7632
700	68.08	43.5712
800	68.08	50.3792
900	68.08	57.1872
1000	68.08	63.9952
1100	68.08	70.8032
1190	68.08	76.9304

**OSD CALCULATIONS:**

SITE AREA = 2607 m<sup>2</sup>  
= 0.2607 ha

PSD = 120 l/s/ha  
SSR = 280 m<sup>3</sup>/ha

THEREFORE:  
PSD = 120 x 0.2607  
= 31.28 l/s



SSR = 280 x 0.2607  
= 73.00 m<sup>3</sup>

**ORIFICE CALCULATIONS:**

$$Q = C \times A \times (2 \times g \times h)^{0.5}$$

$$\text{SO: } A = \frac{Q}{C \times \sqrt{2 \times g \times h}} = \frac{0.03128}{(0.61 \times \sqrt{2 \times 9.81 \times 1.19})} = 0.0106 \text{ m}^2$$


THEREFORE:  
d =  $\sqrt{4 \times A / \pi}$   
=  $\sqrt{4 \times 0.0106 / 3.14159}$   
= 116.2 mm

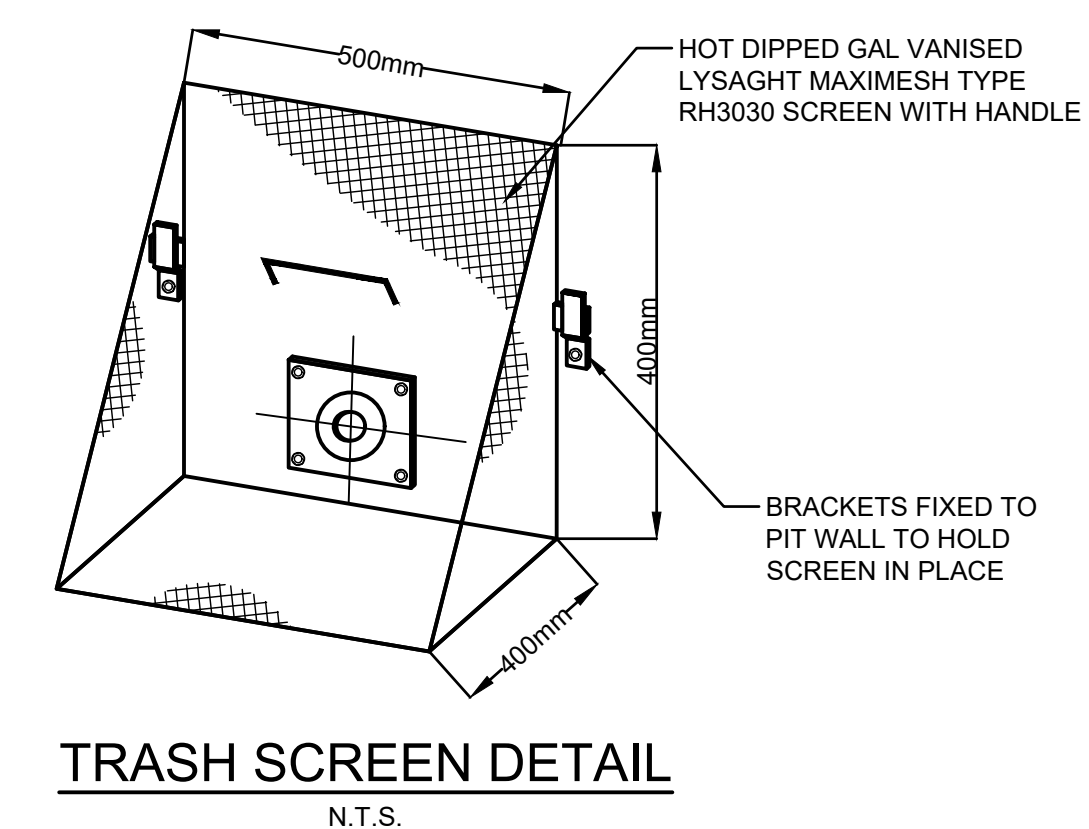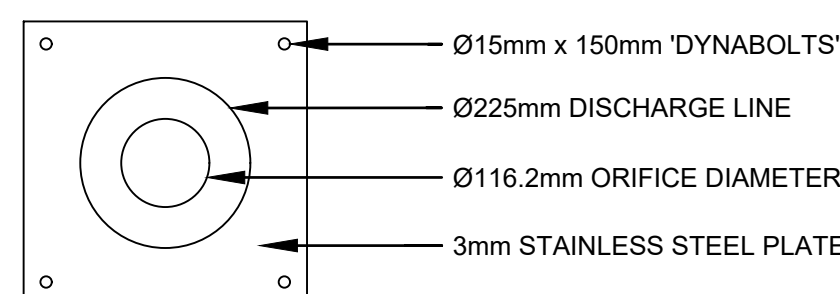

NOT FOR CONSTRUCTION

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C	COUNCIL COMMENTS	26/03/2019	HUV	EHZ	JAB							
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Issue	Description	Date	Drawn	Design	Checked							
Scale	A1	Project No.	Dwg. No.	Issue								
As Shown		171195	103	E								



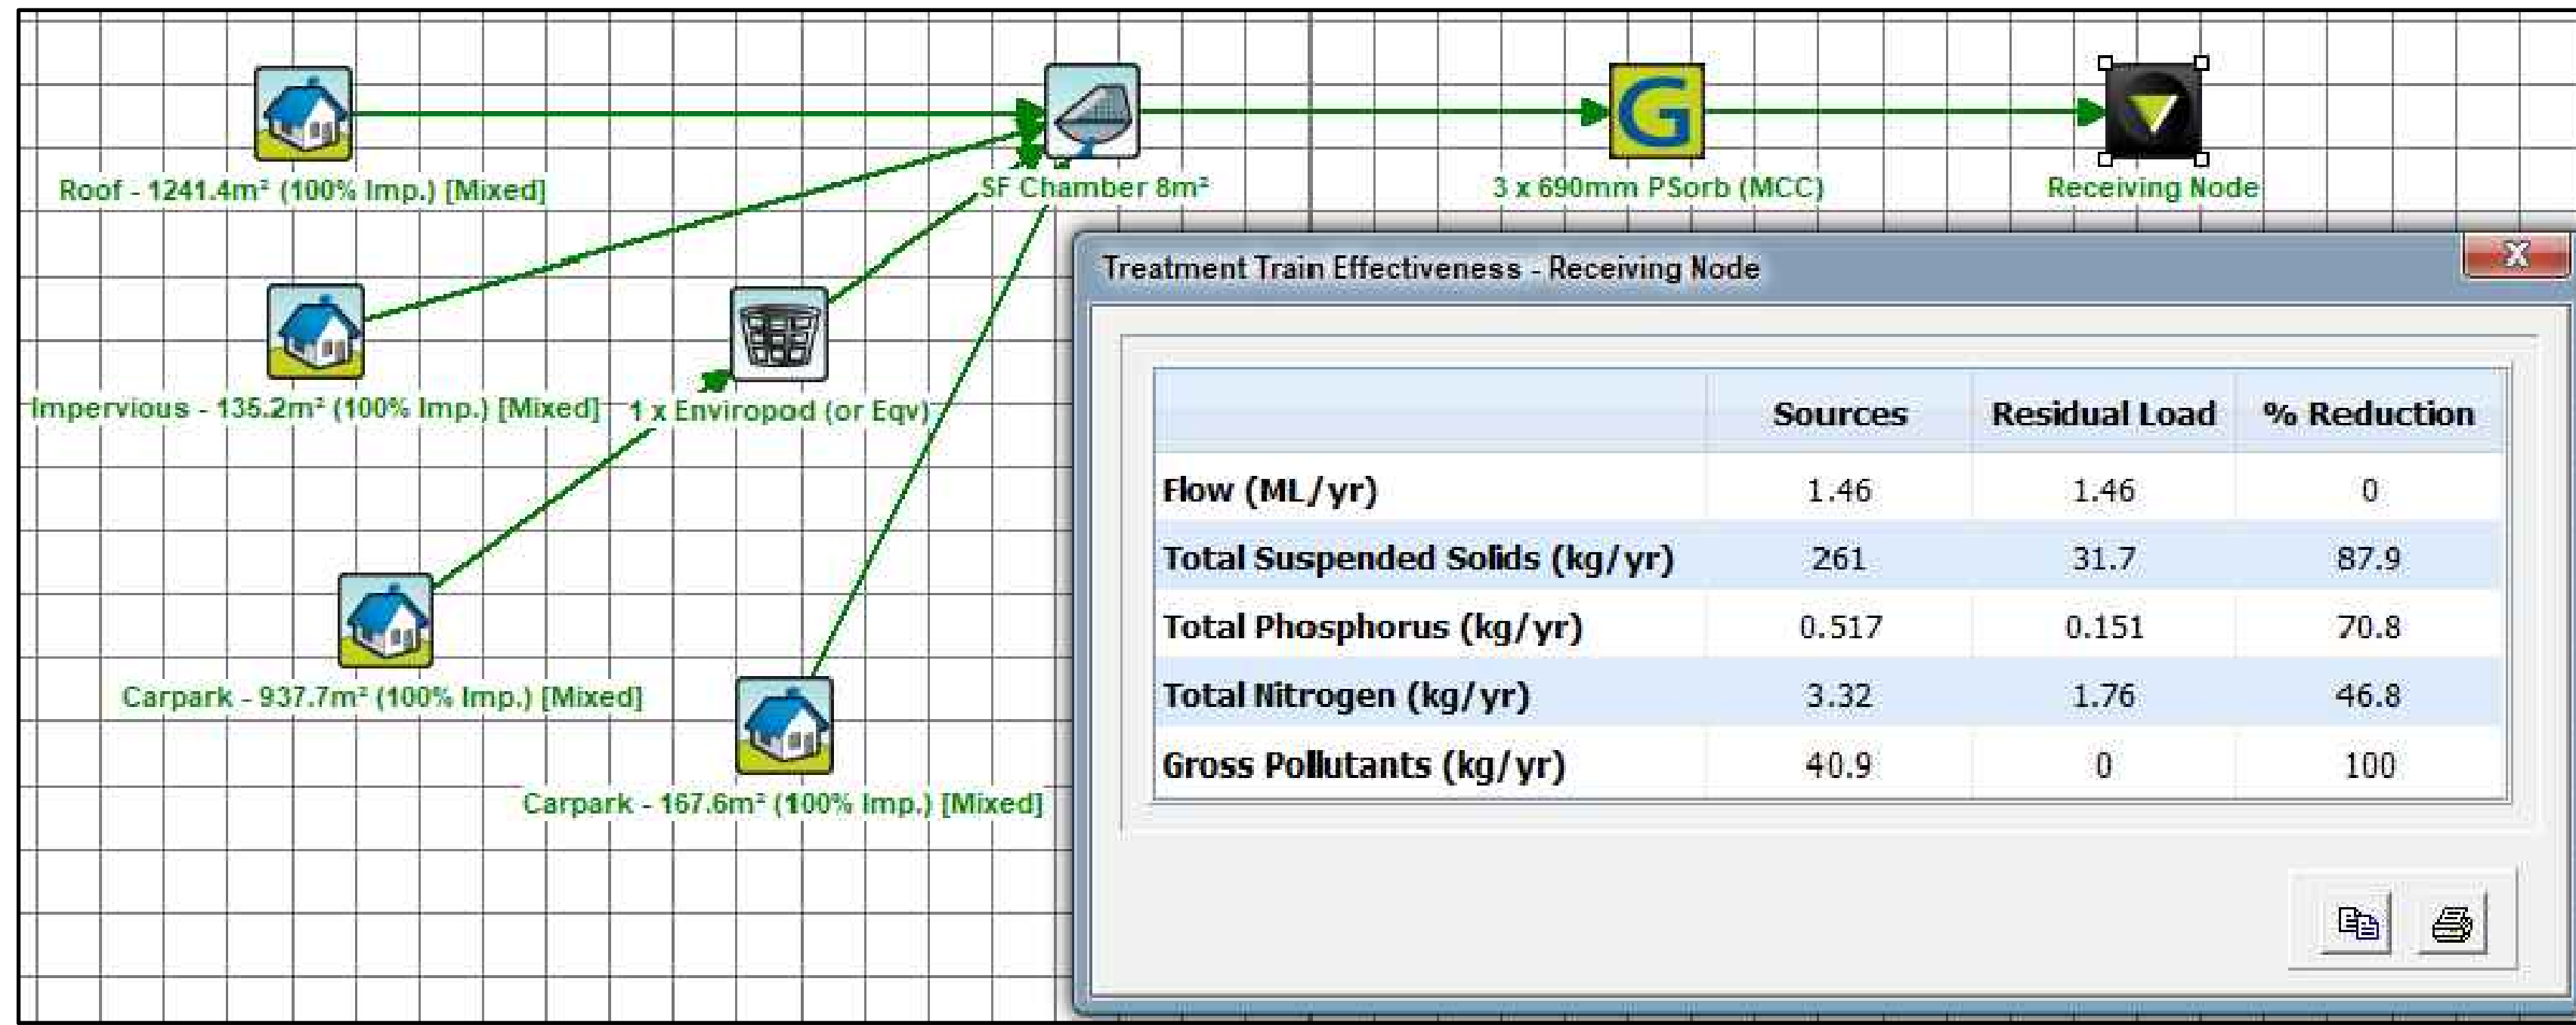

**WSUD MUSIC RESULTS**  
N.T.S.



**WSUD NOTE:**

THE WSUD TANK IS TO BE BUILT TO THE CORRECT LEVELS & SIZE AS PER THIS DESIGN. ANY VARIATIONS ARE TO BE DONE UNDER CONSULTATION FROM OUR OFFICE ONLY. ANY AMENDMENTS WITHOUT OUR APPROVAL WOULD RESULT IN ADDITIONAL FEES FOR REDESIGN AT OC STAGE OR IF A SOLUTION CANNOT BE FOUND, RECONSTRUCTION IS REQUIRED UNDER THE CONTRACTOR'S EXPENSES.

**STORMFILTER DESIGN TABLE**

- STORMFILTER TREATMENT CAPACITY VARIES BY NUMBER OF FILTER CARTRIDGES INSTALLED AND BY REGION SPECIFIC INTERNAL FLOW CONTROLS. CONVEYANCE CAPACITY IS RATED AT 80L/S.
- ALL PARTS PROVIDED AND INTERNAL ASSEMBLY BY STORMWATER360 AUSTRALIA UNLESS OTHERWISE NOTED.

CARTRIDGE HEIGHT	690		460		310	
SYSTEM HYDRAULIC DROP (H - REQ'D. MIN.)	930		700		550	
TREATMENT BY MEDIA SURFACE AREA L/S/m2	1.4	0.7	1.4	0.7	1.4	0.7
CARTRIDGE FLOW RATE (L/s)	1.42	0.71	0.95	0.47	0.63	0.32

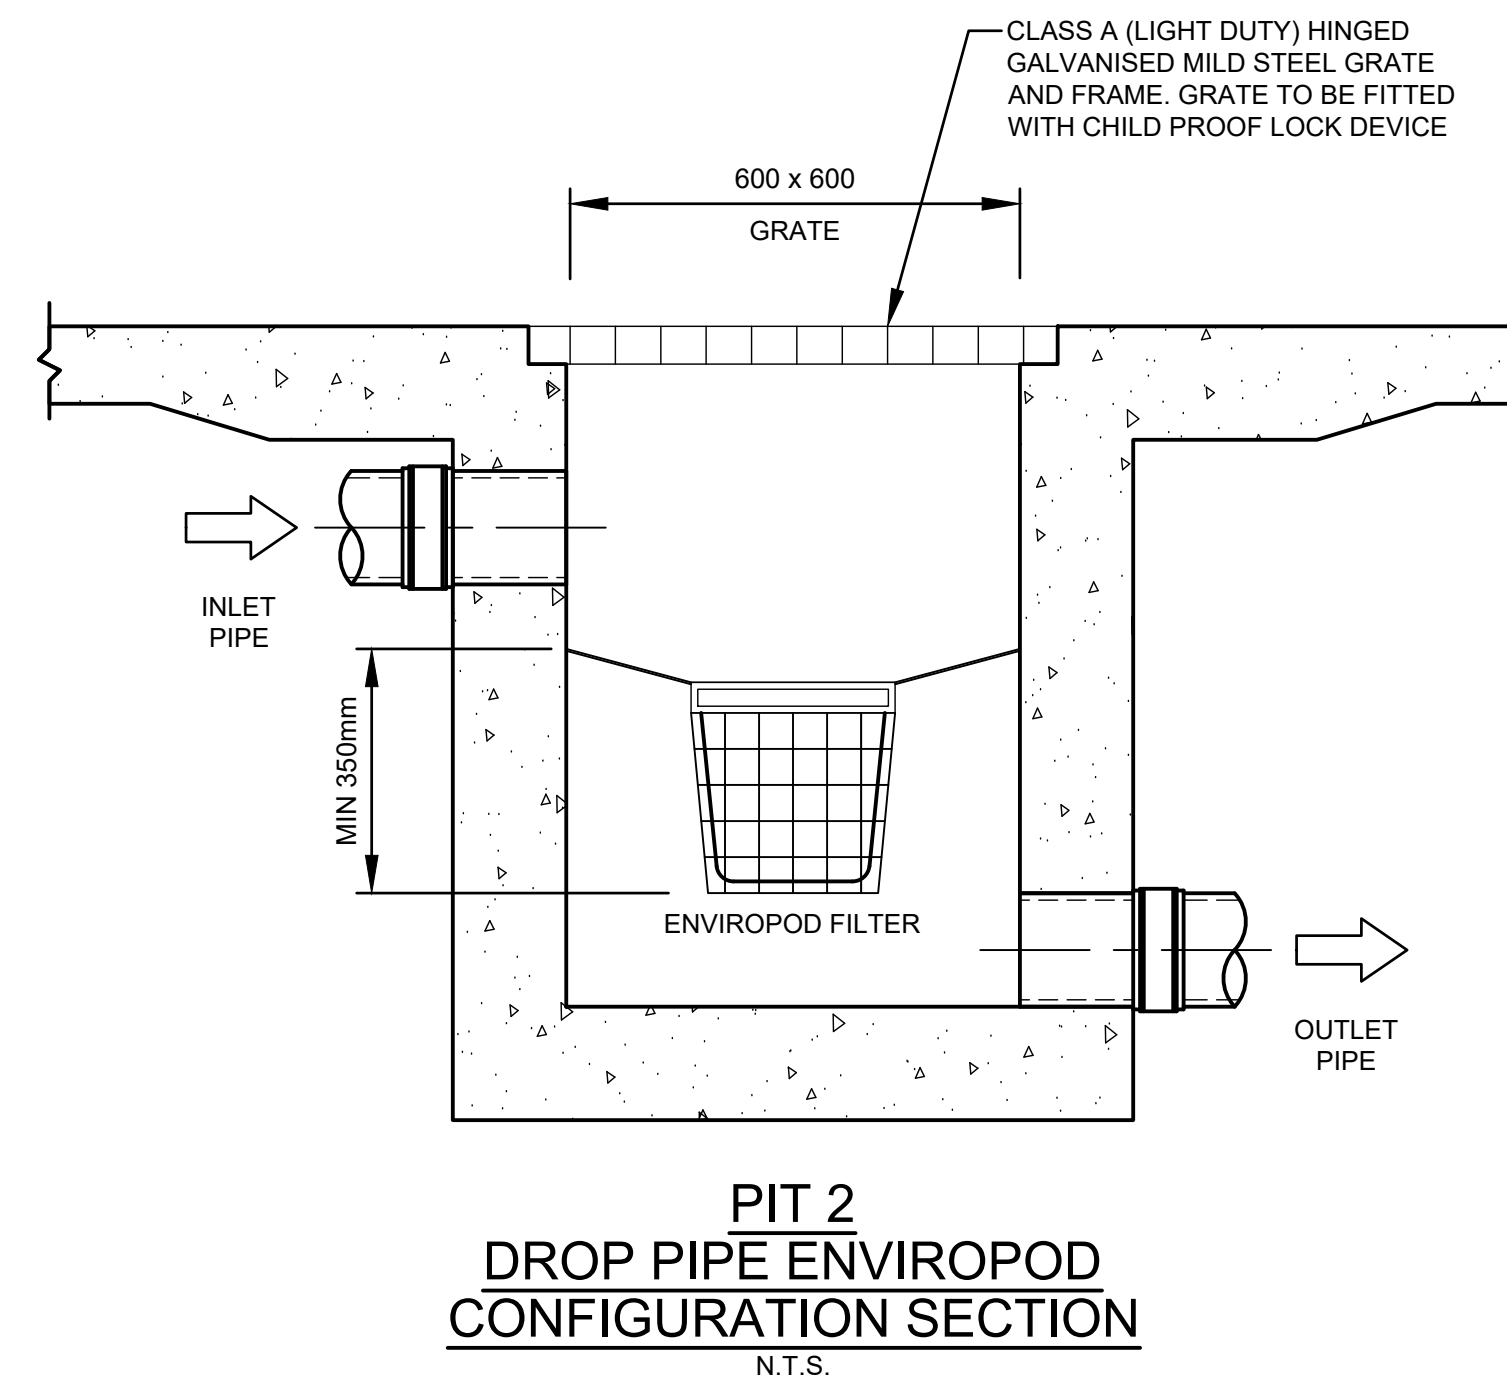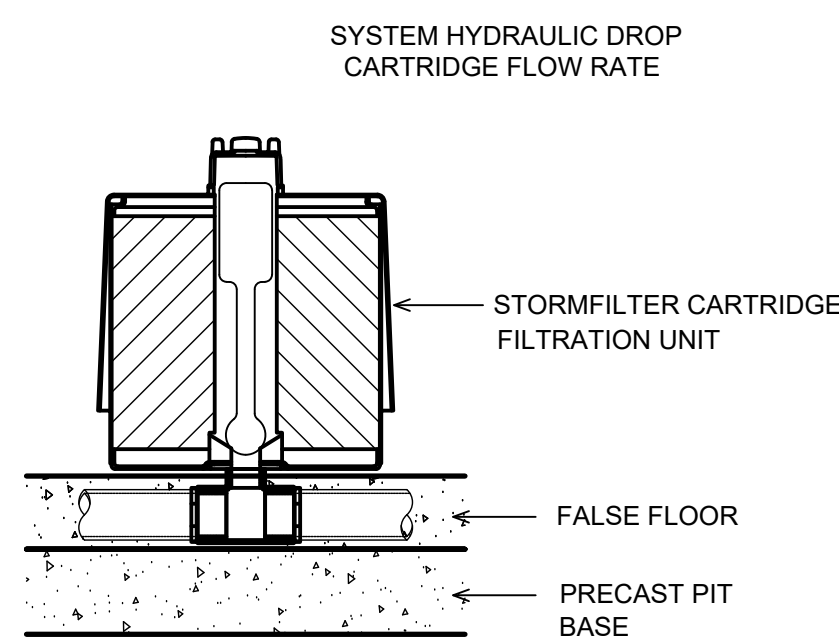

SITE SPECIFIC DATA REQUIREMENTS	
STRUCTURE ID	1
WATER QUALITY FLOW RATE (L/S)	-
PEAK FLOW RATE (L/S)	-
RETURN PERIOD OF PEAK FLOW (yrs)	-
# OF CARTRIDGES REQUIRED (8-22)	3
CARTRIDGE HEIGHT (310, 460 or 690mm)	690
MEDIA TYPE (PERLITE, PERLITE/ZEOLITE OR ZPG)	ZPG
PRECAST VAULT WEIGHT	-
PRECAST LID WEIGHT	-
PIPE DATA:	I.L. MATERIAL DIAMETER
INLET PIPE #1	74.58 PVC 225
INLET PIPE #2	74.58 PVC 225
OUTLET PIPE	74.35 PVC 225
PIPE ORIENTATION	90°
UPSTREAM FLOW	180°
DOWNSTREAM FLOW	0°
	270°
LADDER	YES/NO
ANTI-FLOTATION BALLAST	N/A N/A
	N/A N/A

**STORMFILTER TABLE**  
N.T.S.






**GENERAL NOTES**

1. INLET AND OUTLET PIPING SHALL BE SPECIFIED BY SITE CIVIL ENGINEER (SEE PLANS) AND PROVIDED BY CONTRACTOR. STORMFILTER IS PROVIDED WITH OPENINGS AT INLET AND OUTLET LOCATIONS.
2. IF THE PEAK FLOW RATE, AS DETERMINED BY THE SITE CIVIL ENGINEER, EXCEEDS THE PEAK HYDRAULIC CAPACITY OF THE PRODUCT, AN UPSTREAM BYPASS STRUCTURE IS REQUIRED. PLEASE CONTACT STORMWATER360 FOR OPTIONS.
3. THE FILTER CARTRIDGE(S) ARE SIPHON-ACTUATED AND SELF-CLEANING. THE STANDARD DETAIL DRAWING SHOWS THE MAXIMUM NUMBER OF CARTRIDGES. THE ACTUAL NUMBER SHALL BE SPECIFIED BY THE SITE CIVIL ENGINEER ON SITE PLANS OR IN DATA TABLE BELOW. PRECAST STRUCTURE TO BE CONSTRUCTED IN ACCORDANCE WITH ASS3600.
4. FOR SHALLOW, LOW DROP OR SPECIAL DESIGN CONSTRAINTS, CONTACT STORMWATER360 FOR DESIGN OPTIONS.
5. ALL WATER QUALITY PRODUCTS REQUIRE PERIODIC MAINTENANCE AS OUTLINED IN THE O&M GUIDELINES. PROVIDE MINIMUM CLEARANCE FOR MAINTENANCE ACCESS.
6. STRUCTURE AND ACCESS COVERS DESIGNED TO MEET AUSTRROADS T44 LOAD RATING WITH 0-2m FILL MAXIMUM.
7. THE STRUCTURE THICKNESSES SHOWN ARE FOR REPRESENTATIONAL PURPOSES AND VARY REGIONALLY.
8. ANY BACKFILL DEPTH, SUB-BASE, AND OR ANTI-FLOTATION PROVISIONS ARE SITE-SPECIFIC DESIGN CONSIDERATIONS AND SHALL BE SPECIFIED BY SITE CIVIL ENGINEER.
9. STORMFILTER BY STORMWATER360: SYDNEY (AU) PHONE: (02) 9525 5833, BRISBANE (AU) PHONE: (07) 3272 1872.



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**NOTE:**  
MINIMUM 2.0m  
SETBACK FROM SIDE /  
REAR BOUNDARIES



- SILT FENCE NOTES:**
1. FILTER CLOTH TO BE FASTENED SECURELY TO POSTS WITH GALVANISED WIRE TIES, STAPLES OR ATTACHMENT BELTS.
  2. POSTS SHOULD NOT BE SPACED MORE THAN 3.0m APART.
  3. WHEN TWO SECTIONS OF FILTER CLOTH ADJOIN EACH OTHER THEY SHALL BE OVERLAPPED BY 150mm AND FOLDED.
  4. FOR EXTRA STRENGTH TO SILT FENCE, WOVEN WIRE (14mm GAUGE, 150mm MESH SPACING) TO BE FASTENED SECURELY BETWEEN FILTER CLOTH AND POSTS BY WIRE TIES OR STAPLES.
  5. INSPECTIONS SHALL BE PROVIDED ON A REGULAR BASIS, ESPECIALLY AFTER RAINFALL AND EXCESSIVE SILT DEPOSITS REMOVED WHEN 'BULGES' DEVELOP IN SILT FENCE.
  6. SEDIMENT FENCES SHALL BE CONSTRUCTED WITH SEDIMENT TRAPS AND EMERGENCY SPILLWAYS AT SPACINGS NO GREATER THAN 40m ON FLAT TERRAIN DECREASING TO 20m SPACINGS ON STEEP TERRAIN.

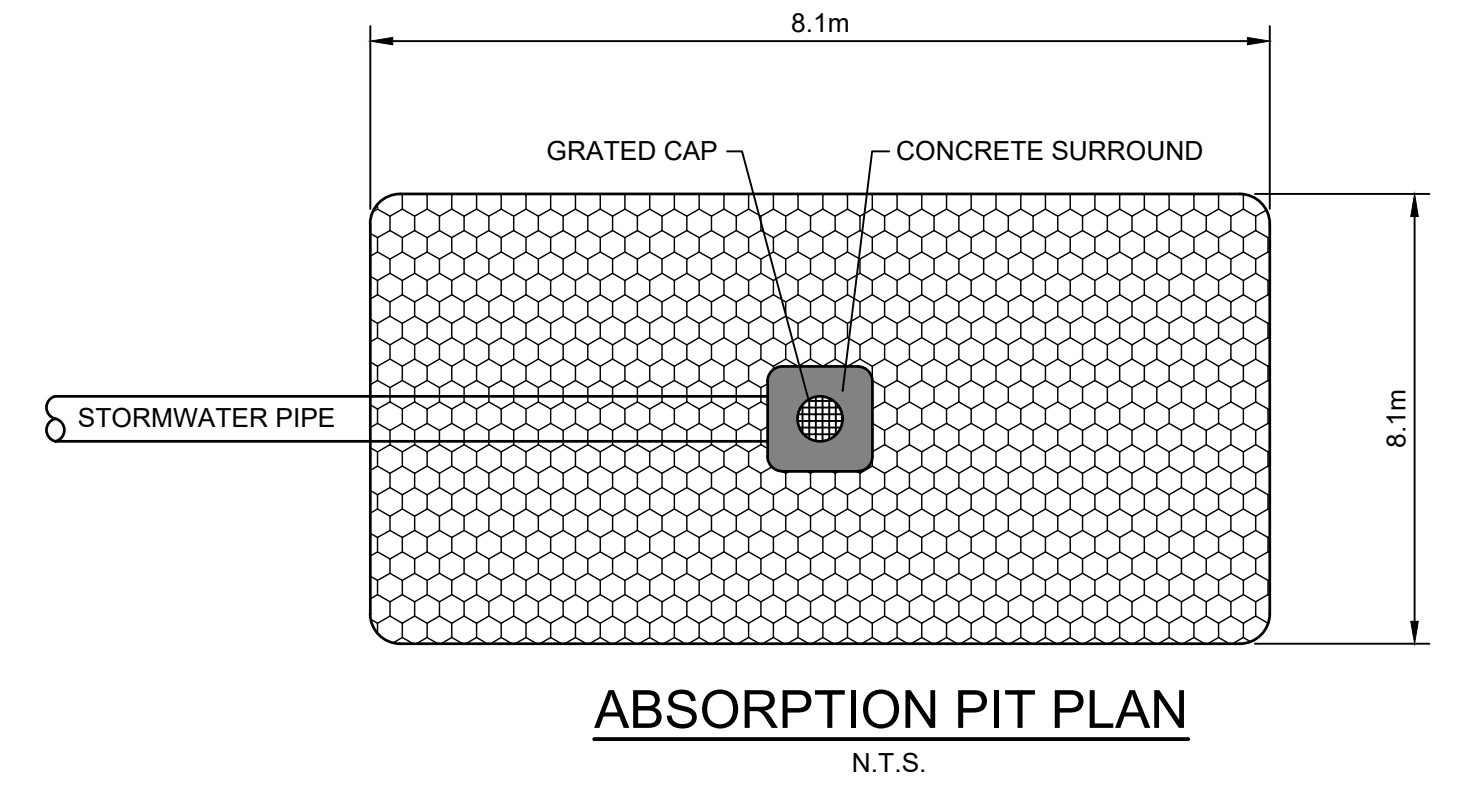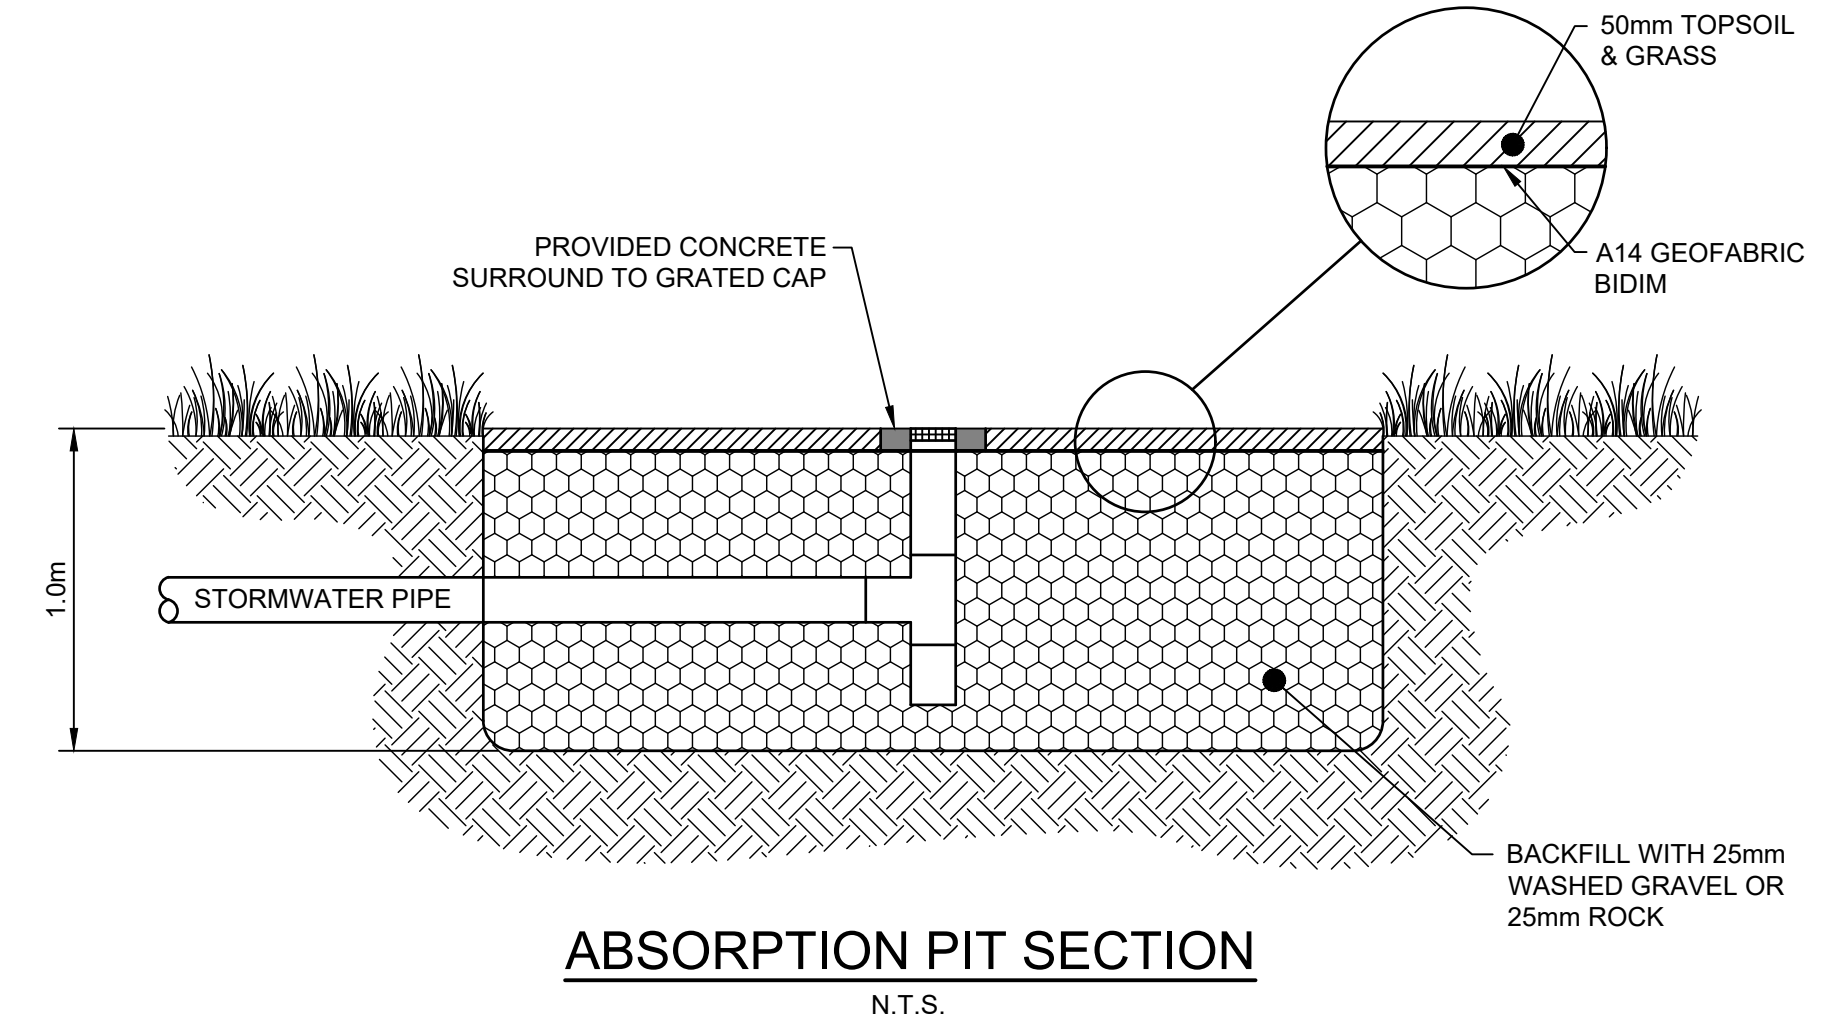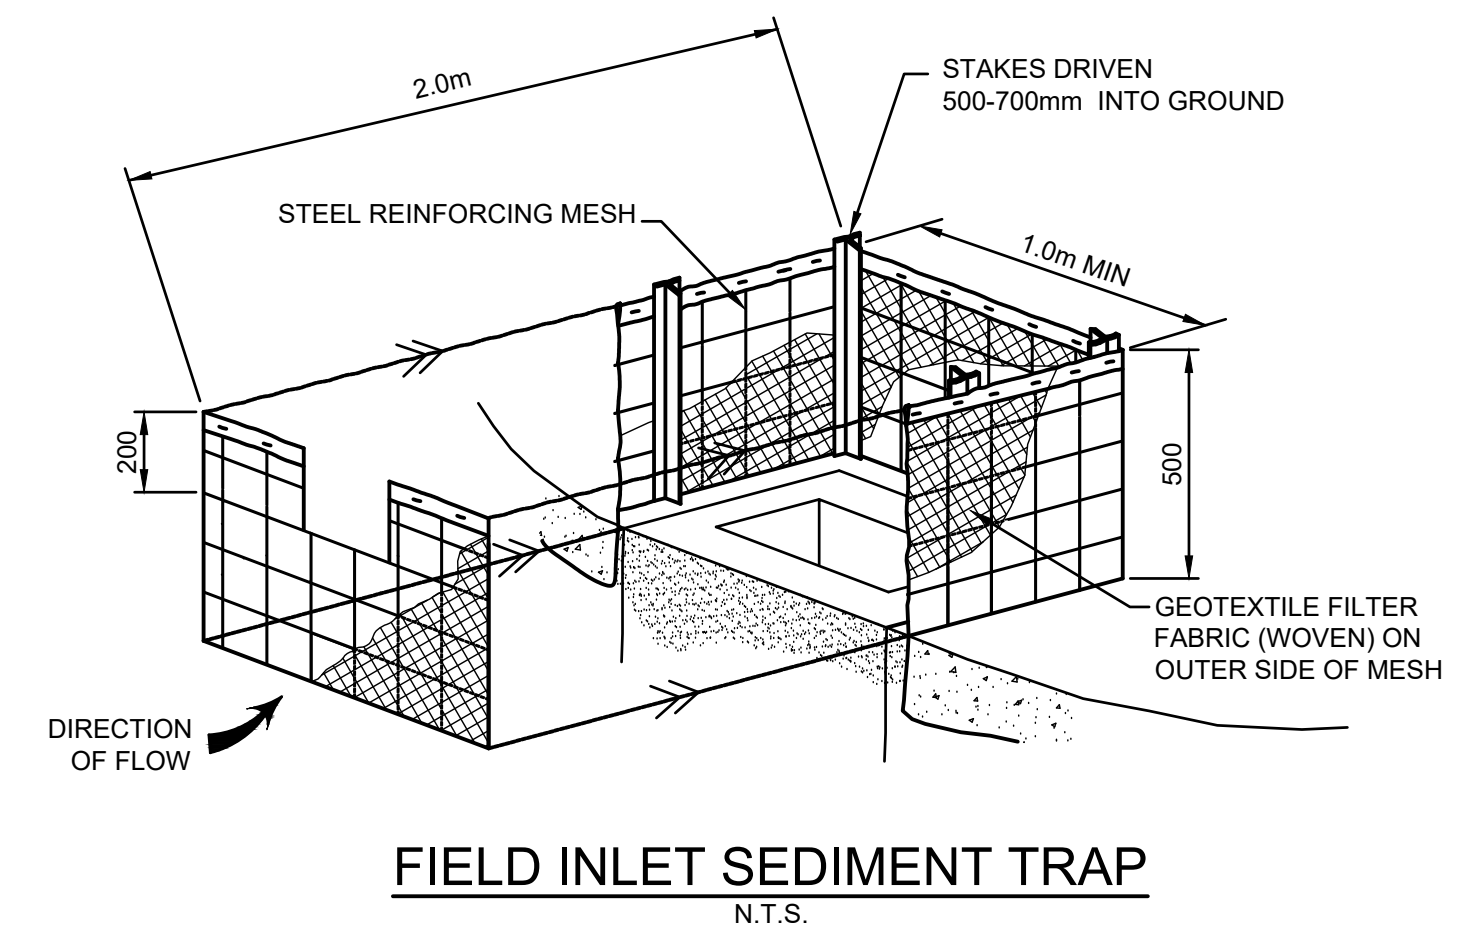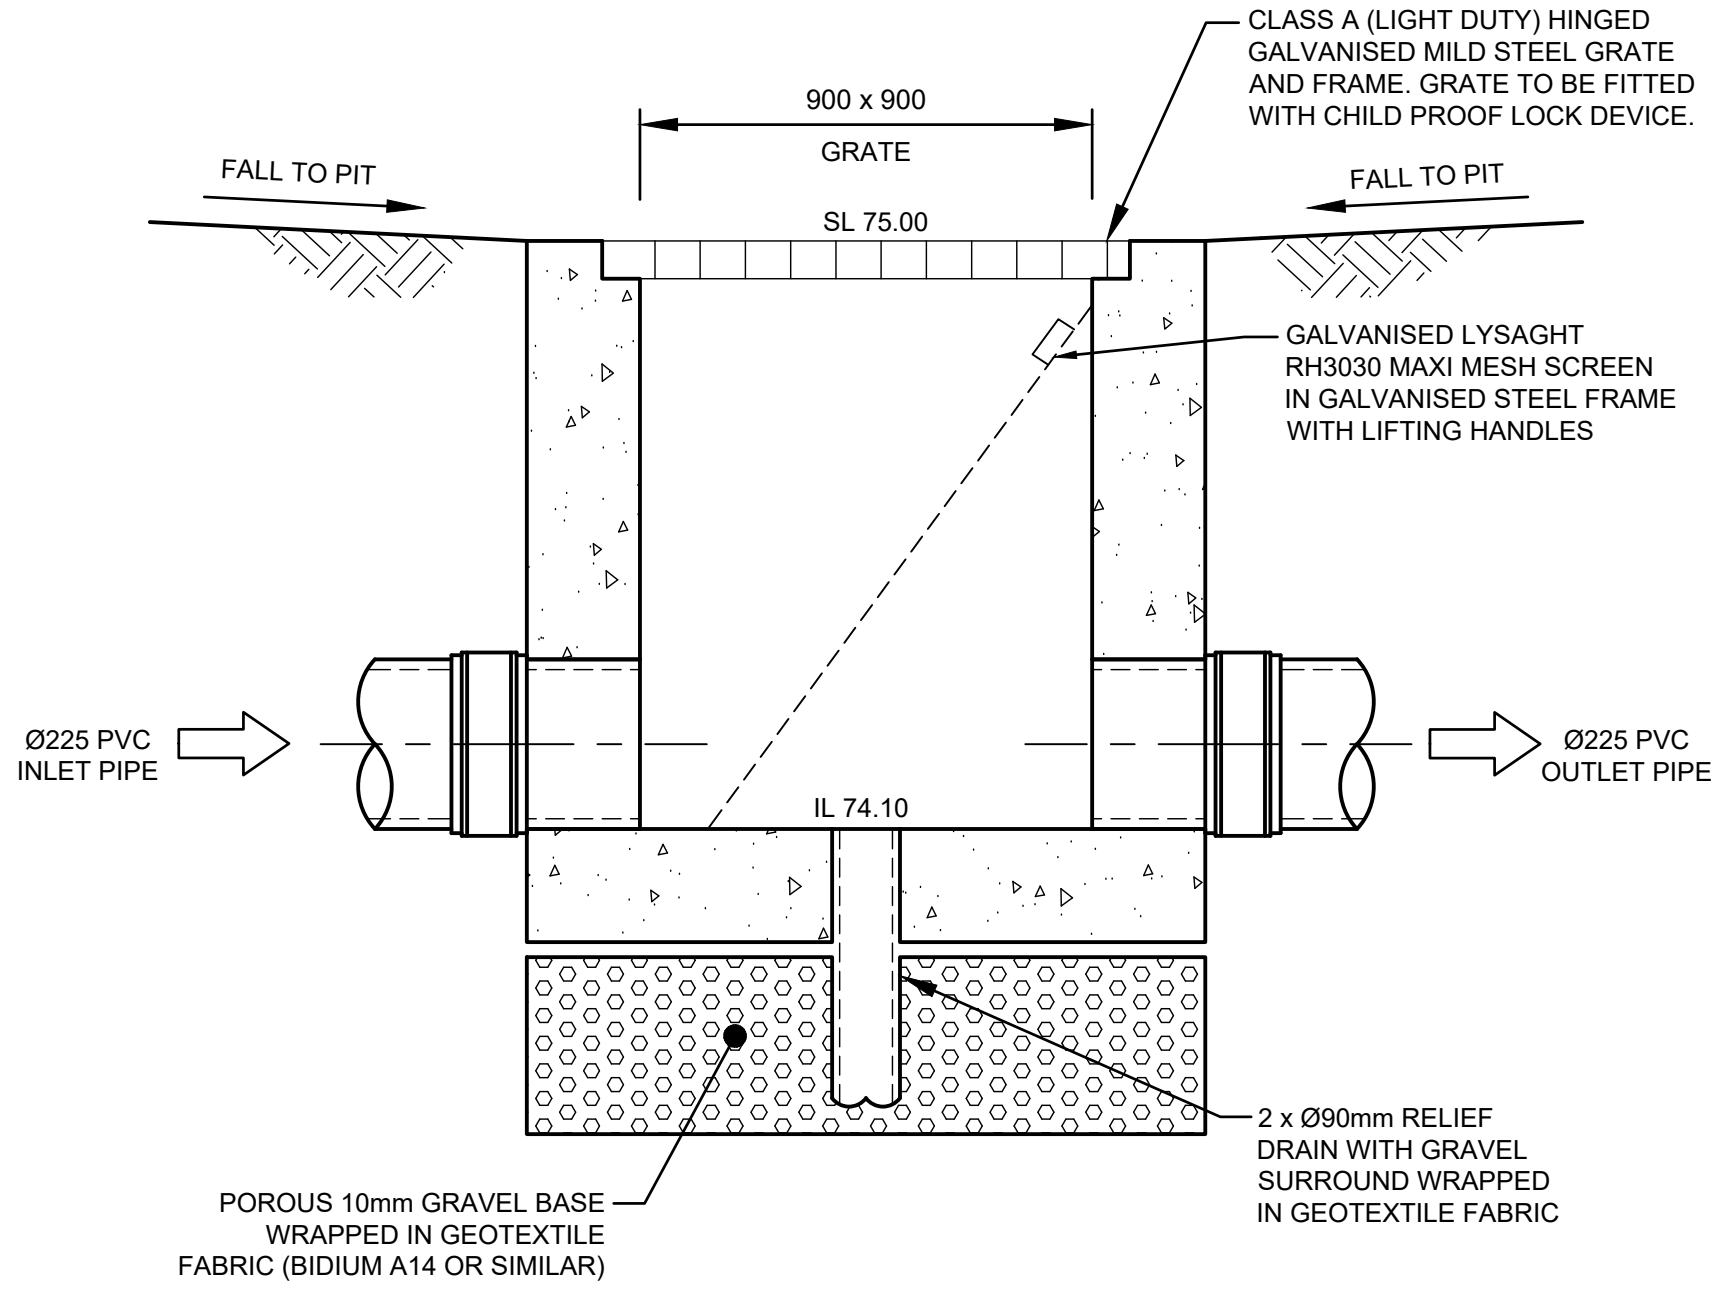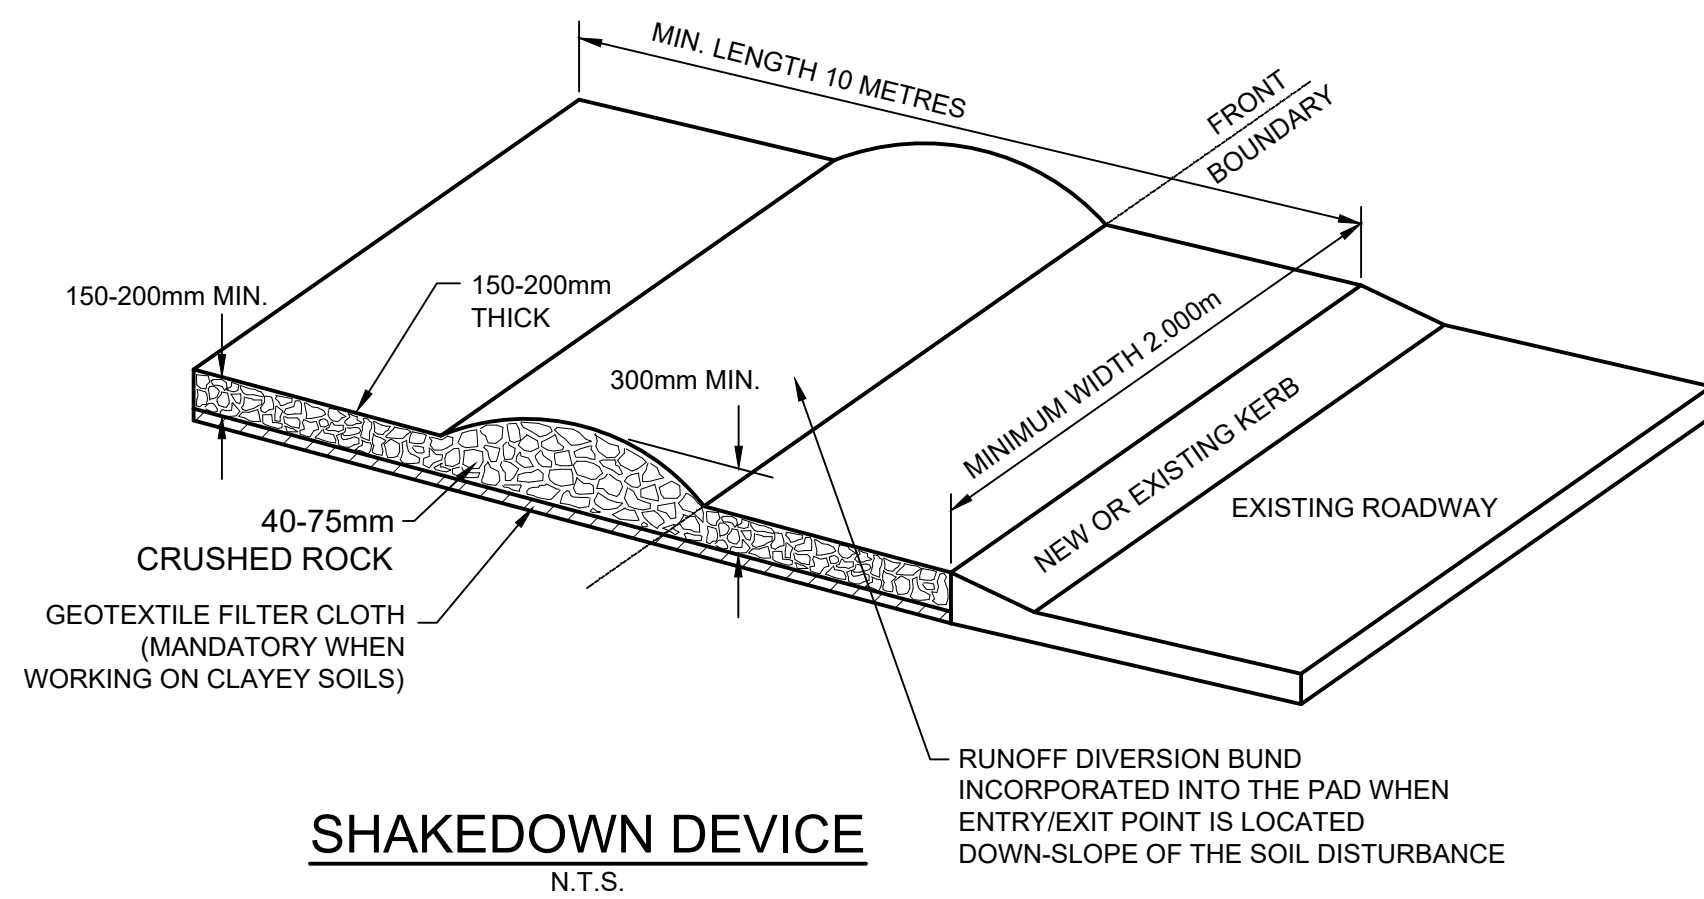- SEDIMENT & EROSION NOTES**
1. IMMEDIATELY FOLLOWING SETTING OUT OF THE WORKS, BUT PRIOR TO COMMENCEMENT OF ANY CLEARING OR EARTHWORKS, THE CONTRACTOR AND SUPERINTENDENT SHALL WALK THE SITE TO NOMINATE THE LOCATIONS AND TYPES OF SEDIMENT AND EROSION CONTROL MEASURES TO BE ADOPTED. THESE MEASURES SHALL BE IMPLEMENTED PRIOR TO ANY CLEARING OR EARTHWORKS AND MAINTAINED UNTIL THE WORKS ARE COMPLETED AND NO LONGER POSE AN EROSION HAZARD, UNLESS OTHERWISE APPROVED BY THE SUPERINTENDENT.
  2. IMMEDIATELY FOLLOWING SETTING OUT OF THE WORKS, BUT PRIOR TO COMMENCEMENT OF ANY CLEARING OR EARTHWORKS, THE CONTRACTOR AND SUPERINTENDENT SHALL WALK THE SITE TO IDENTIFY AND MARK TREES WHICH ARE TO BE PRESERVED. NOTWITHSTANDING THE ABOVE, THE CONTRACTOR SHALL TAKE ALL REASONABLE PRECAUTIONS TO MINIMISE DISTURBANCE TO EXISTING VEGETATION AND GROUND COVER OUTSIDE THE MINIMUM AREAS REQUIRED TO COMPLETE THE WORKS AND SHALL BE RESPONSIBLE FOR RECTIFICATION, AT ITS OWN COST, OF ANY DISTURBANCE BEYOND THOSE AREAS.
  3. PROVIDE GULLY GRATE INLET SEDIMENT TRAPS AT ALL GULLY PITS.
  4. PROVIDE SILT FENCING ALONG PROPERTY LINE AS DIRECTED BY SUPERINTENDENT.
  5. ADDITIONAL CONTROL DEVICES TO BE PLACED WHERE DIRECTED BY THE PRINCIPLE.
  6. ALTERNATIVE DESIGNS TO BE APPROVED BY SUPERINTENDENT PRIOR TO CONSTRUCTION.
  7. WASH DOWN/RUMBLE AREA TO BE CONSTRUCTED WITH PROVISIONS RESTRICTING ALL SILT AND TRAFFICKED DEBRIS FROM ENTERING THE STORMWATER SYSTEM.
  8. NO WORK OR STOCKPILING OF MATERIALS TO BE PLACED OUTSIDE OF SITE WORK BOUNDARY.
  9. APPROPRIATE EROSION AND SEDIMENT CONTROLS TO BE USED TO PROTECT STOCKPILES AND MAINTAINED THROUGH OUT CONSTRUCTION.
  10. IT IS THE CONTRACTORS RESPONSIBILITY TO TAKE DUE CARE OF NATURAL VEGETATION. NO CLEARING IS TO BE UNDERTAKEN WITHOUT PRIOR APPROVAL FROM THE SUPERINTENDENT.
  11. TO AVOID DISTURBANCE TO EXISTING TREES, EARTHWORKS WILL BE MODIFIED AS DIRECTED ON-SITE BY THE SUPERINTENDENT.
  12. THE LOCATION OF EROSION AND SEDIMENTATION CONTROLS WILL BE DETERMINED ON SITE BY THE SUPERINTENDENT.
  13. ACCESS TRACKS THROUGH THE SITE WILL BE LIMITED TO THOSE DETERMINED BY THE SUPERINTENDENT AND THE CONTRACTOR PRIOR TO ANY WORK COMMENCING.
  14. ALL SETTING OUT IS THE RESPONSIBILITY OF THE CONTRACTOR PRIOR TO WORKS COMMENCING ON SITE. THE SUPERINTENDENT'S SURVEYOR SHALL PEG ALL ALLOTMENT BOUNDARIES, PROVIDE COORDINATE INFORMATION TO THESE PEGS AND PLACE BENCH MARKS. THE CONTRACTOR SHALL SET OUT THE WORKS FROM AND MAINTAIN THESE PEGS.
  15. PLANS ARE MINIMUM REQUIREMENTS AND ARE TO BE USED AS A GUIDE ONLY. EXACT MEASURES USED SHALL BE DETERMINED ON SITE IN CONJUNCTION WITH PROGRAM OF CONTRACTORS WORKS etc.

NOT FOR CONSTRUCTION

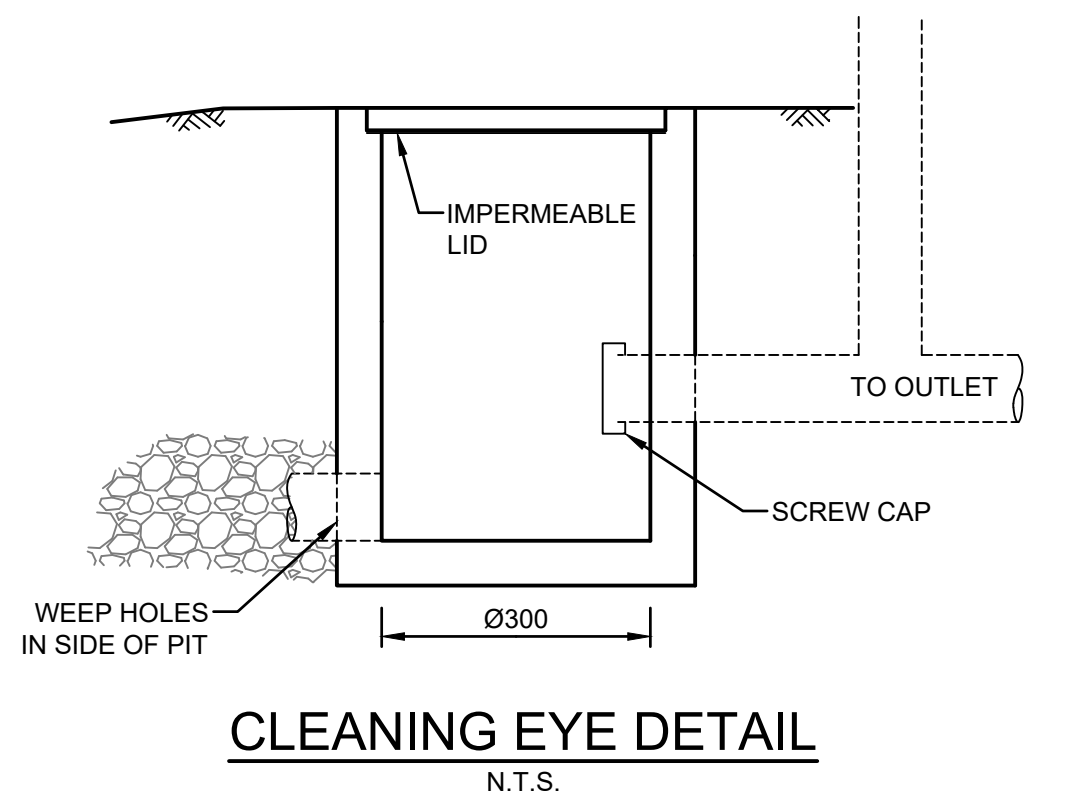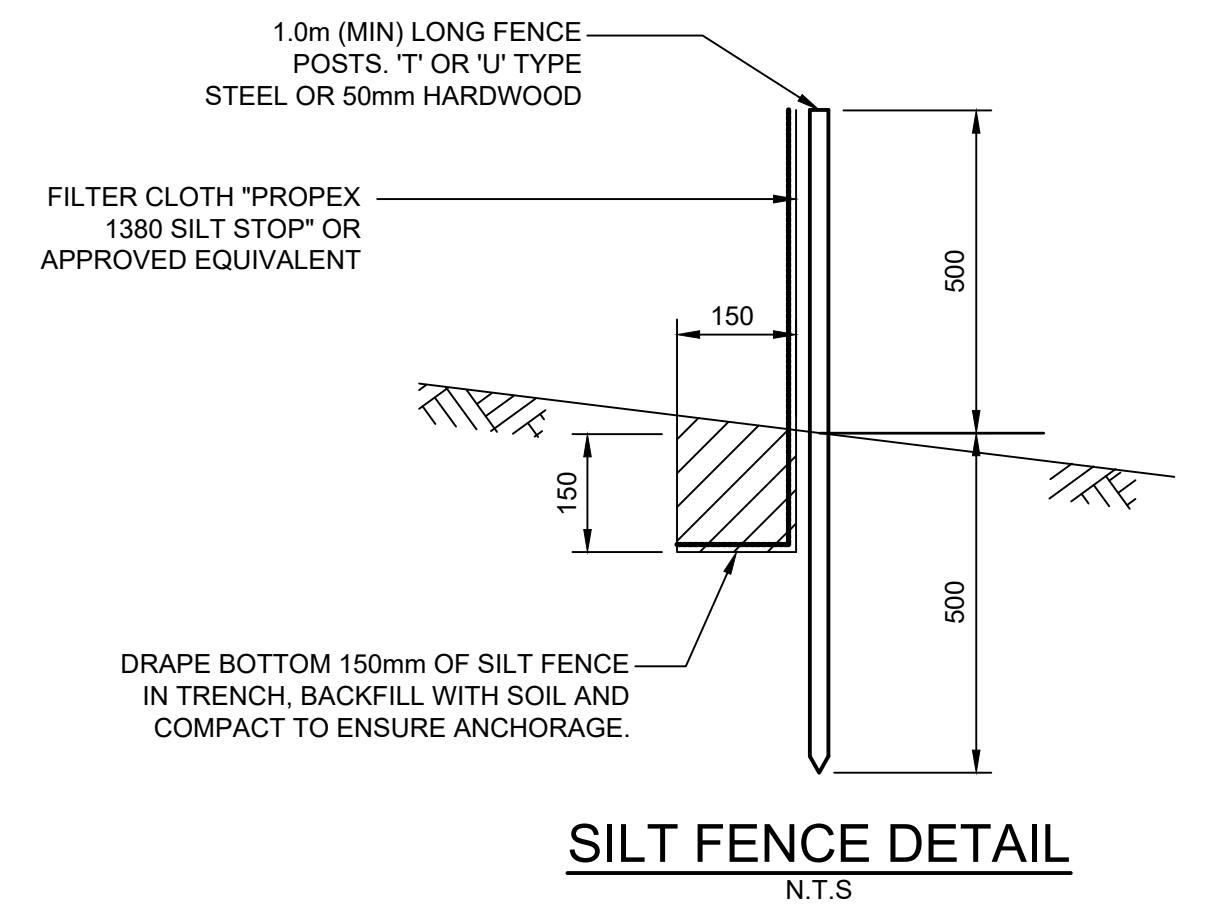E	COUNCIL COMMENTS	30/03/2020	HUV	EHZ	JSF	Architect												
D	COUNCIL COMMENTS	10/10/2019	HUV	EHZ	JSF	Project Work Design Pty	Vladimir Vanovac	Scale	0	200	400	600mm						
C	COUNCIL COMMENTS	26/03/2019	HUV	EHZ	JAB	PO Box 5138, Chittaway Bay NSW 2261	Penrith City Council	Certification By:										
B	COUNCIL COMMENTS	27/02/2018	HUV	JTF	MBR	M : 0412 637 875												
A	ISSUE FOR DEVELOPMENT APPLICATION	30/11/2017	HUV	EHZ	MBR	W : pwdesign.com.au												
Issue	Description	Date	Drawn	Design	Checked													
<p>Document Set ID: 9129795 Version: 1, Version Date: 08/05/2020</p>																		
<p><b>AUSTRALIAN CONSULTING ENGINEERS.</b> P T Y L T D A C N 0 8 4 0 5 9 9 4 1 SHOP 2/141 CONCORD RD NORTH STRATHFIELD NSW 2137 PH (02) 9763 1500 FX (02) 9763 1515 EMAIL: info@aceeng.com.au</p>												<p>Project <b>110 - 112 MOUNT VERNON ROAD, MOUNT VERNON PROPOSED CHILDCARE CENTRE STORMWATER CONCEPT PLAN DEVELOPMENT APPLICATION</b></p>				<p>Drawing Title <b>MISCELLANEOUS DETAILS SHEET</b></p>		
Scale As Shown		Project No. 171195		Dwg No. 105		Issue E												