
NOTE: REFER TO 'DATAPAGE (SHEET 2)' OF NOTE: CHARGED STORMWATER SYSTEM CANNOT BE WIND CLASSIFICATION mcdonald jones DRAWING SET FOR ALL RELEVANT BUILDING USED FOR DISPOSAL OF DRIVEWAY OR OTHER WITHIN 1 KM. OF NFORMATION WITH REGARDS TO **BREAKING SALT WATER** - BASIX/ABSA REQUIREMENTS - SITE CLASSIFICATION WITHIN 100 M. OF NOTED AS 'DPR' ON PLAN. McDONALD JONES HOMES - GENERAL HOUSE SPECIFICATIONS SALT WATER PROVIDES CAPACITY FOR DISPOSAL OF ROOF COLLECTED STORMWATER ONLY AND TAKES NO NOTE: STORMWATER LAYOUT IS DIAGRAMATIC ONLY RESPONSIBILTY FOR OVERFLOW OR DAMAGE TO AND SUBJECT TO CONTRACTORS RECOMMENDATIONS PROPERTY IF OWNER ADDS ADDITIONAL DISCHARGE AND/OR ANY CONSTRUCTION CONSTRAINTS. LOADS TO EXISTING STANDARD PROVISIONS ALL SURFACE WATER DRAINAGE BY OWNER DP 1168991 LOT 2137 www.mcdonaldjoneshomes.com.au © 2014 1.01 **VACANT** 101.3 03°39'35' (A) (C P.O.S **REQUIRED** 20% 102.00m2 1000 PROVIDED 37.3% 190.00m2 .OT 2184 THIS PLAN ACCEPTED BY: **RL 19.503** CUT 0.378 **RL 19.551** CUT 0.426 510 m<sup>2+</sup> SURFACE INLET PIT PRELIMINARY PLANS ( LOT 2183 PLEASE NOTE: NO VARIATIONS WILL BE ACCEPTED ON THIS PLAN AFTER SIGNING 19.6 **VACANT** SIGNATURE: cut (CT1) DATE: 10:30  $_{T}(A)(C)$ ş **Total Areas** 2013.06.C Room Name Area (m²) 19.2 **₽** ⊙ ALFRESCO 15.660 33.499 PROPOSED LIVING 151.525 ADDRESS: ADINA STREET CLIENT: H ZHOU JORDAN SPRINGS PATIO / VERANDAH 3.803 RESIDENCE 204.487 m<sup>2</sup> FFL 19.485 Flat Roof Area (A) (C) **FGL 19.125** 228.110 228.110 m<sup>2</sup> 2,815 1,350 18.81 **GARAGE** 18.8 260.282 FFL 19.415 260.281 m<sup>2</sup> RL 18.604 18.8 12.10 52.10 PENRITH APPROX. DRIVEWAY & PATH BY BUILDER AFTER HANDOVER 545 (APPROX. 30.5m² TO B'DRY) ₹¢Ο**Й**Μ SEDIMENT CONTROL FENCE -W/M □ EL 116937 2184 DP No: 1168992 CONCRET PATH Accredited Supplier to SYDNEY WARER BUILDING PLAN APPROVED ANDBM 02 FACADE: NEVADA BRISTOL ALL-WEATHER ACCESS SUBJECT TO REQUIREMENTS Ref NO: D13/4-12645 Date: 14/02/14 **ADINA STREET TOK RL18.40**( 4.0-5M WIDE **EXPENSE (IF REQUIRED)** 3,300 2,000 1,900 2,000 p 5,900 DRIVEWAY GRADIENT (A) EASEMENT FOR ACCESS AND MAINTENANCE 0.9 WIDE (B) EASEMENT TO DRAIN WATER 1.5 WIDE SCALES: 1:200, (C) EASEMENT TO DRAIN WATER 2 WIDE 1:100, <u>:</u> 50 x 25 x 1000-STAKE OR 3 / 11 CONSTRUCTION SITE MEMBRANE TO BE BIDIM U 24 OR APP EQUIVALENT STAR PICKET 0.2m EXISTING ROADWAY GAP BETWEEN SANBAGS ACT AS SPILLWAY DO NOT SCALE DRAWINGS, USE FIGURED DIMENSIONS ONLY, CHECK AND VERIFY DIMENSIONS AND LEVELS PRIOR TO THE COMMIENCEMENT OF ANY WORK, ALL DISCREPANCIES TO BE REPORTED TO THE DRAFTING OFFICE. BURY APPROXIMATELY
150mm OF MEMBRANE AND
TEMP. BACKFILL TO RESTORE
PRIOR NATURAL SURFACE 50-75mm GRAVEL 601159 NATURAL SURFACE DOWNHILL OF MEMBRANE NOT TO BE DISTURBED RUNOFF FROM PAD DIRECTED TO SEDIMENT TRAP

DPR - CHARGED DOWNPIPE DIRECTED TO TANK

### **EXCAVATION NOTES**

+/- 100mm TOLERANCE TO NOMINATED FINISHED FLOOR LEVELS. SUBJECT TO MAXIMUM DRIVEWAY PROFILE AND/OR ANY FLOOD RELATED LEVELS

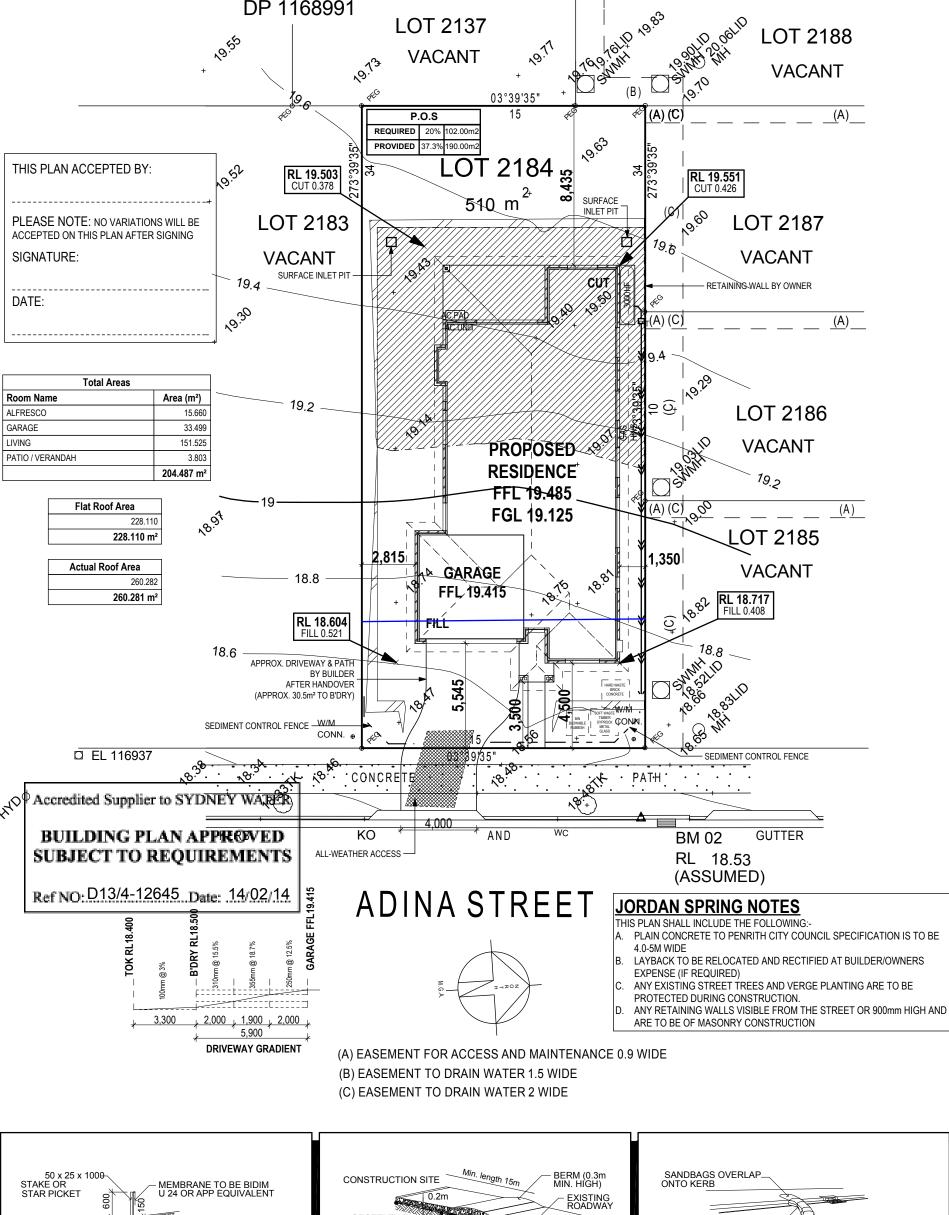

TEMPORARY CONSTRUCTION

**EXIT** 

SILT FENCING DETAIL

SANDBAG KERB INLET

SEDIMENTATION TRAP

THREE LAYERS OF

SANDGAGS WITH ENDS OVERLAPPED



### **Application Lodgement Summary**



**Reference Number** 8680351 **Date Requested:** Fri February 14 2014

**DOLFIN Number** D13/4-12645

**Agent** Greg Houston Plumbing, 1/9 Hargraves Pl Wetherill Park

**Applicant** McDonald Jones Homes, Suite 1, 62 Norwest Boulevarde Baulkham Hills 2153

Property/Asset 17 Adina St, Jordan Springs 2747 (J Zhou J Liu) PNum: 5486165

150 mm PVC Sewer Main - (10582378) (WasteWater)

**Product** Building Plan Approval Application

Charge Product Cost GST Total

Building Plan Approval Application \$17.01 \$0.00 \$17.01

### REFERRAL FOR BUILDING PLAN APPROVALS

### **Quick Check Agent**

The Quick Check Agent has lodged your application with Sydney Water and determined that your proposed building/structure may potentially impact on Sydney Water's infrastructure.

The Quick Check Agent has advised you to contact a Water Servicing Coordinator for approval of your proposed building/structure. The Water Servicing Coordinator acts as your contact in dealing with Sydney Water.

### **Water Servicing Coordinator**

Some of the activities required prior to approving your plan may include;

- Reviewing your proposed building/structure plans and discussing options.
- Advise if a Service Protection Report (also known as a Pegout) is required.
- Advise if structural engineering detail is required.
- Arrange supervision of concrete encasement and piering.
- Specify asset protection requirements and/or alternative options.

Water Servicing Coordinators are located across Sydney, Illawarra and the Blue Mountains. Sydney Water recommends that you contact several Water Servicing Coordinators to ensure you choose the one that is most appropriate for you.

To assist in your selection, Sydney Water recommends you ask each Water Servicing Coordinator the following type of questions:

- 1. How long will it take to obtain the Building Plan Approval?
- 2. How much do you charge for a Building Plan Approval?
- 3. If I require a Service Protection Report (pegout), how much will it cost?
- 4. Are there any other charges that I may have to pay?

For more information and a list of Water Servicing Coordinators, visit the Building, Developing and Plumbing section of Sydney Water's website at www.sydneywater.com.au. Alternatively you may obtain a list from the Sydney Water call centre on Tel: 13 20 92.

### **Property Special Conditions for Plumbers**

Boundary Trap Required No

Watercharged/Tidal area Unknown

Partial Drainage area No
Aggressive Soil area No
Cast Iron Pipe area No

Sewer Surcharge area Unknown
Minimum Gully Height area Unknown

Sewer Available Yes

Connection Type Low Infiltration Sewer

You must contact Sydney Water to clarify the property special conditions where the property special conditions are not shown (yes or no), are shown as "unset", "unknown" or "not available" or if the proposed development is being built over more than one existing property.

Please note that boundary traps must be fitted for all commercial and industrial properties and you must ensure that all plumbing/drainage and building works are carried out in accordance with the relevant codes and standards.

A water meter is required to be fitted to the property during construction. You will need to ensure that your licensed plumber carries out this work in accordance to the relevant codes and standards.



### **Application Lodgement Summary**



**Reference Number** 8680352 **Date Requested:** Fri February 14 2014

**Agent** Greg Houston Plumbing, 1/9 Hargraves Pl Wetherill Park

**Applicant** McDonald Jones Homes, Suite 1, 62 Norwest Boulevarde Baulkham

Hills 2153

**Property/Asset** 17 Adina St, Jordan Springs 2747 (J Zhou J Liu) PNum: 5486165

150 mm PVC Sewer Main - (10582378) (WasteWater)

**Product** Plumbing and Drainage Audit Inspection Application

Charge Product Cost GST Total

Plumbing and Drainage Audit Inspection Application \$190.00 \$0.00 \$190.00

### **Property Special Conditions for Plumbers**

Boundary Trap Required No

Watercharged/Tidal area Unknown

Partial Drainage area No
Aggressive Soil area No
Cast Iron Pipe area No

Sewer Surcharge area Unknown
Minimum Gully Height area Unknown

Sewer Available Yes

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Please note that boundary traps must be fitted for all commercial and industrial properties and you must ensure that all plumbing/drainage and building works are carried out in accordance with the relevant codes and standards.

You must contact NSW Fair Trading on 1300 889 099 at least 2 working days prior to the inspection time to arrange for inspection of the works.

Properties in recycled water areas are required to pay for additional inspections, as inspections are required to be carried out on both the potable and recycled water services. These fees will generally be charged upon payment of the Plumbing and Drainage Audit Inspection application, or as directed by NSW Fair Trading.

Recycled water areas require full inspections for all water and sewer drainage installations and a final inspection before occupation. If you have any further inquiries or need to organise the inspection please call NSW Fair Trading on 1300 889 099.

Re-use of greywater (eg washing machine) or blackwater (eg treated sewage) requires the installation/s to be fully inspected by NSW Fair Trading, and a testable backflow prevention device fitted to the water service at the meter installation. The application must be supported by

written approval from the local council and also include details of the changes to the house drainage/sanitary plumbing.

### Conditions

- All fees are NON REFUNDABLE and NON TRANSFERABLE
- Any Plumbing or Drainage work MUST BE carried out by or under the immediate Supervision of Authorised Licensees who MUST lodge a separate Application to commence the work.
- This Application will lapse if the relevant work shown hereon has not commenced within 12 months of the date shown on the receipt.
- Where the Sewer is not available Sydney Water cannot accept any responsibility for the locations, lines and levels of the Supervised work for connection to the Sewer when it becomes available
- Owner's please note: You should obtain a 'Certificate of Compliance' from your Plumber or Drainer. This is your warranty for work done.

## EXTRACT FROM THE WATER BOARD (CORPORATION) ACT 1994 - Clause 21 (5) Water (Finance) Regulation

- 1. An owner or occupier of land shall not refuse to give, wilfully omit to disclose, or wilfully misstate to an Officer of Sydney Water:
  - a. any information required for, or likely to affect, a valuation or determination to be made for the purpose of this clause;
  - b. in the case of an occupier, the name of the owner of the land or the person who receives, or is Authorised to receive, the rent for the land. MAXIMUM PENALTY:\$5,000 IN THE CASE OF A CORPORATION, OR IN OTHER CASES, \$2,000.



### **Application Lodgement Summary**



**Reference Number** 8680352 **Date Requested:** Fri February 14 2014

**Agent** Greg Houston Plumbing, 1/9 Hargraves Pl Wetherill Park

**Applicant** McDonald Jones Homes, Suite 1, 62 Norwest Boulevarde Baulkham

Hills 2153

**Property/Asset** 17 Adina St, Jordan Springs 2747 (J Zhou J Liu) PNum: 5486165

150 mm PVC Sewer Main - (10582378) (WasteWater)

**Product** Plumbing and Drainage Audit Inspection Application

ChargeProduct CostGSTTotalPlumbing and Drainage Audit Reinspection Application\$0.00\$0.00\$0.00Reinspection Charge\$100.00\$0.00\$100.00

### **Property Special Conditions for Plumbers**

Boundary Trap Required No

Watercharged/Tidal area Unknown

Partial Drainage area No
Aggressive Soil area No
Cast Iron Pipe area No

Sewer Surcharge area Unknown
Minimum Gully Height area Unknown

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  - a. any information required for, or likely to affect, a valuation or determination to be made for the purpose of this clause;
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Transaction Summary Page 1 of 1



### **Transaction Summary**



### **Date Requested** Fri February 14 2014

**A.B.N** 49 776 225 038

**Agent** Greg Houston Plumbing, 1/9 Hargraves Pl Wetherill Park

**Applicant** McDonald Jones Homes, Suite 1, 62 Norwest Boulevarde Baulkham Hills 2153

This document will be a tax invoice when you make payment.

Transaction Details	Charge	GST	Total
17 Adina St, Jordan Springs 2747			
8680351 Building Plan Approval Application	\$17.01	\$0.00	\$17.01
8680352 Plumbing and Drainage Audit Inspection Application	\$190.00	\$0.00	\$190.00
8680352 Plumbing and Drainage Audit Reinspection Application	\$0.00	\$0.00	\$0.00
8680352 Reinspection Charge	\$100.00	\$0.00	\$100.00
Transaction Total	\$307.01	\$0.00	\$307.01

# SYDNEY WATER BUILDING PLAN APPROVED SUBJECT TO REQUIREMENTS

Dolfin No: D13/4-12645 Quick Check Ref No: 8680351

e-Developer Case No: N/A

Pro	perty	Location
	<b>,</b>	

Street No: ...... Lot No: 2184

Street Name: ADINA STREET

Suburb: JORDAN SPRINGS

Building/Structure Description: NEW RESIDENCE

Building Plan No: 601159 Engineers Plan No: E78988

Proposed building/structure is APPROVED to construct ADJACENT TO a Sydney Water asset, subject to the following requirements: (NB. Delete non applicable requirements)

- 1. The foundations/piers are to be founded below 1:1 zone of influence, CLAY strata.
- 2. No part of the building/structure or its foundations to be less than a minimum 0.90 metre, horizontal distance from the centreline of the asset.
- 3. No part of the swimming pool or its foundations to be less than a minimum 1.0 metre, horizontal distance from the centreline of the asset to the outer edge of the pool coping.
- 4. No part of the building/structure or swimming pool coping to be less than 1m horizontal distance from outside edge of any Sydney Water structure.
- 5. No piering of building/structure to be less than 2m horizontal distance from centreline of maintenance hole to edge of piers.
- 6. Foundations/piers are constructed in accordance with Engineers detail plans (stated above) as submitted to Sydney Water.
- 7. All foundations/piers are to be founded to below the zone of influence or to solid rock.
- 8. Indemnity letter to be signed by owner/s of property and returned to Water Servicing Coordinator prior to issue of building plan approval.
- 9. Concrete encase approximately ...... metres of asset. Concrete encasement to be carried out by an Accredited Constructor of Minor Works (Sewer) / Constructor and a Minor Works Agreement signed prior to commencement of works.
- 10. Concrete encasement must extend a minimum of 600mm past the external walls of the building/structure.

- 13. Property connection point (junction) to be inserted under Minor Works Agreement.
- 14. All works are to be completed in accordance with Case No. .....

### **SPECIAL REQUIREMENTS**

(a) "A requirement of this approval is that this project requires a Pier Inspection to be carried out by Greg Houston Plumbing P/L. We are required by Sydney Water to attend site at the time of these particular stages of construction to ensure that the onsite works comply with the approval as granted herein.

Please ensure 48hrs (2 working days) notice is given to ensure our field team can attend your site at the time you require. (PLEASE NOTE: Failure to supply sufficient notice may result in project delays OR additional cost to facilitate a inspection time). Please contact 0415 671 467 to book your inspection."

b	)

(c)

### NOTE:

Above requirements must be inspected/supervised by an Accredited Supplier or Sydney Water to enable the issue of a satisfactory compliance letter.

Permits are required to fill all new swimming pools with a capacity greater than 10,000 litres. To arrange for a permit please contact Sydney Water on 13 20 92 during business hours. Fines will apply for filling swimming pools without a permit.


### **APPROVED BY**

WSC Company Name: Greg Houston Plumbing Pty Limited

Name of Key Personnel: Brett Garvey

Signature of Key Personnel: Date: 14/02/2014


Warning - Document current at time of printing or downloading.

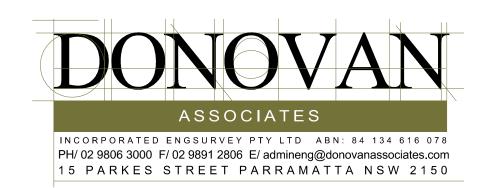

## STRUCTURAL ENGINEERING DETAILS

LOT 2184
ADINA STREET
JORDAN SPRINGS

SHEET No.	ISSUE No.	SHEET TITLE
SI	Α	STRUCTURAL NOTES
S2	В	GROUND FLOOR SLAB PLAN
S3	Α	SLAB FOOTING DETAILS
S <del>4</del>	Α	SLAB FOOTING DETAILS
S5	Α	SLAB FOOTING DETAILS
S6	Α	SLAB FOOTING DETAILS
S7	Α	RAINWATER TANK SLAB DETAILS
S8	Α	AIR CONDITIONING SLAB DETAILS
S <b>9</b>	Α	BAS SITE PLAN
S10	Α	TYPICAL BAS DETAILS

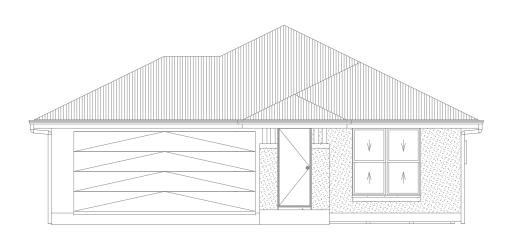



YOUR HOME YOUR DREAM

PH: (02) 8848 6000

FAX: (02) 9634 5511

601159	E78988
CLIENT REF.	DRAWING No.

### **GENERAL**

- G1. THESE DRAWINGS SHALL BE READ IN CONJUNCTION WITH ALL ARCHITECTURAL AND OTHER CONSULTANTS' DRAWINGS AND SPECIFICATIONS AND WITH SUCH OTHER WRITTEN INSTRUCTIONS AS MAY BE ISSUED DURING THE COURSE OF THE CONTRACT. ALL DISCREPANCIES SHALL BE REFERRED TO THE ARCHITECT AND BE RESOLVED BEFORE WORK PROCEEDS.
- G2. ALL MATERIALS AND WORKMANSHIP SHALL BE IN ACCORDANCE WITH THE REQUIREMENTS OF THE CURRENT S.A.I GLOBAL CODES, THE BCA/NCC, AND WITH THE BY-LAWS AND ORDINANCES OF THE RELEVANT BUILDING AUTHORITIES AS THEY RELATED SPECIFICALLY TO STRUCTURE FXCFPT WHFRE VARIED BY THE CONTRACT DOCUMENTS.
- G3. ALL WORK SHALL BE CARRIED OUT IN COMPLIANCE WITH THE REQUIREMENTS OF WORK COVER AND THE OH&S ACT.
- G4. ALL DIMENSIONS SHOWN AND/OR RELEVANT TO SETTING OUT AND OFF-SITE WORK SHALL BE VERIFIED BY THE BUILDER BEFORE CONSTRUCTION AND FABRICATION IS COMMENCED. ENGINEER'S DRAWINGS SHALL NOT BE SCALED FOR DIMENSIONS.
- G5. DURING CONSTRUCTION THE BUILDER SHALL MAINTAIN SAFE AND STABLE THE STRUCTURE AND NEIGHBOURING STRUCTURES. NO PART SHALL BE OVERSTRESSED. TEMPORARY BRACING SHALL BE PROVIDED BY THE BUILDER TO KEEP THE WORKS AND EXCAVATIONS STABLE AT ALL TIMES.
- G6. UNLESS NOTED OTHERWISE, ALL LEVELS ARE EXPRESSED IN METERS AND ALL DIMENSIONS ARE IN MII LIMETERS.
- G7. THE APPROVAL OF A SUBSTITUTION SHALL BE SOUGHT FROM THE ENGINEER. SUCH SUBSTITUTION SHALL NOT BE AN AUTHORIZATION FOR A VARIATION TO THE CONTRACT. ANY VARIATIONS INVOLVED MUST BE TAKEN UP WITH THE ARCHITECT BEFORE THE WORK COMMENCES.
- **G8.** ABBREVIATIONS USED:

**ALTERNATIVE** RTM **BOTTOM** CTS CENTRES

BRICK / BLOCK COURSE C/S DÍA DIAMETÉR FINISHED GROUND LINE

FGL HOT DIP GALVANISED GALV

MAX MAXIMUM MIN MINIMIIM

NOT SHOWN ON PLAN NSOF U.N.O UNLESS NOTED OTHERWISE

U/S UNDERSIDE

### **INSPECTIONS**

11. THE PURPOSE OF THE STRUCTURAL INSPECTIONS IS TO VERIFY THAT THE BUILDER HAS COMPLIED WITH THE STRUCTURAL REQUIREMENTS OF THE CONTRACT DOCUMENTATION, NOT TO BE THE FIRST CHECK OF A SUBCONTRACTOR'S INTERPRETATION OF THESE REQUIREMENTS. SHOULD THE WORK CLEARLY BE UNSATISFACTORY AT THE TIME THE INSPECTION IS ARRANGED, THE VISIT AND SUBSEQUENT 'ABORTIVE' INSPECTION VISITS (INCLUDING ASSOCIATED TRAVEL AND OFFICE TIME) WILL BE CHARGED TO THE BUILDER.

### SITE PREPARATION & EXCAVATOR NOTES

D1. STRIP TOPSOIL AND VEGETATION 100MM MINIMUM DEPTH AND STOCKPILE.

D2. THE SITE IS TO BE BENCHED BY CUT AND FILL TO DESIRED LEVELS. ALL EXCAVATION AND BACKFILL SHALL BE CARRIED OUT NEATLY TO THE LINES, LEVELS AND GRADES SPECIFIED BY THE ARCHITECT.

D3. FILL IS TO BE PLACED IN 150MM MAXIMUM LAYERS AND THOROUGHLY COMPACTED USING EXCAVATOR. UNLESS THIS FILL IS COMPACTED IN ACCORDANCE WITH CLAUSE 6.4.2 OF AS2870, IT IS NOT ADEQUATE TO PROVIDE LONG TERM STRUCTURAL SUPPORT TO THE SLAB/FOOTING SYSTEM AND THEREFORE, PIERS MUST BF INSTALLED. ALTERNATIVELY, THE FILL CAN BE PLACED, TESTED AND CERTIFIED BY A QUALIFIED GEOTECHNICAL ENGINEER AS "CONTROLLED FILL" AS DEFINED IN AS3798. THIS IS THEN DEEMED TO BE ADEQUATE TO SUPPORT THE SLAB/FOOTING SYSTEM.

D4. THE FILL IS TO EXTEND PAST THE EDGE OF THE HOUSE BY AT LEAST ONE METRE AND SHALL BE BATTERED OFF AT NOT STEEPER THAN TWO HORIZONTALLY TO ONE VERTICALLY OR RETAINED BY A SUITABLE STRUCTURE PROVIDED BY THE OWNER OR BUILDER AS SOON AS POSSIBLE.

D5. THE FINISHED LEVELS SHALL ALLOW FOR THE MAIN SLAB LEVEL TO BE AT LEAST 300MM ABOVE THE ADJACENT GROUND. SURFACE DRAINAGE SHALL BE PROVIDED AS REQUIRED TO AVOID THE POSSIBILITY OF WATER PONDING NEAR THE SLAB. A FALL OF 50MM OVER A DISTANCE OF ONE METRE AWAY FROM THE SLAB IS CONSIDERED ADEQUATE. SUBSOIL DRAINS (AGRICULTURAL DRAINS) ARE CONSIDERED DESIRABLE BUT SHOULD NOT BE LOCATED DIRECTLY ADJACENT TO THE FOOTINGS.

D6. IT IS THE RESPONSIBILITY OF THE OWNER TO ENSURE THE SITE IS PROPERLY MAINTAINED APPENDIX B OF AS2870 PROVIDES INFORMATION AND GUIDANCE ON THE MAINTENANCE OF FOUNDATION SITE CONDITIONS. SUBJECT TO ADOPTION OF THESE RECOMMENDATIONS THE BUILDING MAY EXPERIENCE MINOR DAMAGE BUT OF A SEVERITY NOT EXCEEDING THE LEVELS DEFINED IN APPENDIX C OF AS2870.

D7. TRENCH EXCAVATIONS FOR SERVICES OR AGRICULTURAL DRAINS PARALLEL TO THE EDGE OF THE SLAB SHALL BE IN WITH NOTE 'P5' OF THE BORED PIER NOTES.

D8. FOR ALL FILLED AREAS IN BUILDING PLATFORM, INTERNAL BEAMS ARE TO BE PIERED AT MAX. 2400 CTS. AT RIB INTERSECTIONS.

### FOOTING AND SLAB NOTES

F1. BORED PIERS / FOOTINGS / BEAMS ...ETC ARE TO BE FOUNDED ONTO NATURAL BEARING MATERIAL HAVING A MINIMUM SAFE BEARING CAPACITY OF 250 KPA U.N.O. BEFORE ANY CONCRETE IS PLACED, THE SAFE BEARING CAPACITY SHALL BE VERIFIED BY A QUALIFIED GEOTECHNICAL ENGINEER.

F2. THE FOOTING SYSTEM SPECIFIED ON THESE MEET THE PERFORMANCE DRAWINGS WILL REQUIREMENTS SET OUT IN CLAUSE 1.3 OF AS2870 (RESIDENTIAL SLABS AND FOOTINGS CODE). THE FOOTING SYSTEM INTENDED TO ACHIEVE ACCÉPTABLE PROBABILITIES OF SERVICEABILITY AND SAFETY OF THE BUILDING DURING ITS DESIGN LIFE.

F3. THE FOOTING DETAILS SHOWN ARE FOR THE SITE CLASSIFICATION STIPULATED ABOVE. WHILST EVERY CARE HAS BEEN TAKEN TO VERIFY THAT THE INFORMATION SHOWN IS CORRECT, DONOVAN TAKE NO RESPONSIBILITY ASSOCIATES VARIATIONS WHICH MAY OCCUR DUE TO VARIATIONS IN SITE CONDITIONS.

F4. A DAMP PROOFING MEMBRANE MUST BE PLACED BENEATH THE SLAB SO THAT THE BOTTOM OF THE SLAB IS ENTIRELY UNDERLAID. THE DAMP PROOFING MEMBRANE SHALL BE TURNED UP TO FINISHED GROUND LEVEL. THE DAMP PROOFING MEMBRANE MUST BE 0.2MM NOMINAL THICKNESS POLYTHENE FILM AND OF HIGH IMPACT RESISTANCE. LAPS SHALL BE 200MM MINIMUM AT JOINTS AND ALL PLUMBING PENETRATIONS SHALL BE TAPED. THE DAMP PROOFING MEMBRANE SHALL BE IN ACCORDANCE WITH THE BCA/NCC.

F5. SLAB REQUIREMENTS AT PIPE PENETRATIONS IN THE EDGE AND SPINE BEAMS ARE TO BE CARRIED OUT IN ACCORDANCE WITH THE DETAILS ON THESE DRAWINGS.

F6. SUBTERRANEAN TERMITE PROTECTION IS TO BE PROVIDED IN ACCORDANCE WITH THE REQUIREMENTS OF AS3660.1

### **BORED PIER NOTES**

P1. IF PIER LOCATIONS ARE NOT SHOWN ON THE PLAN, THEN ALL EDGE BEAMS, INTERNAL BEAMS AND OTHER LOAD BEARING AREAS THAT DO NOT BEAR ON FIRM NATURAL GROUND AS NOTED IN "FOOTING AND SLAB NOTES" NOTE F1 ARE TO BE PIERED IN ACCORDANCE WITH THE FOLLOWING PIERING SCHEDULE:

### Single Storey Piering Requirements Schedule

Bearing	Min. Design Bearing Capacity	Pier Diameter (mm)	Maximum Pier Spacing c/c (mm)	
Strata			Bored Pier	Bucket Pier (800x300)
Sand	100 kPa	600	1800	1800
Controlled Clay Fill	150 kPa	400	1600	1800
Stiff Natural Clay	250 kPa	400	2100	N/S
Shale/Rock	600 kPa	300 *	3000	N/S


Denotes: 400 dia pier if pier depth > 2.5 m N/S Denotes: Not Suitable

P2. IT SHOULD BE NOTED THAT IF ANY OF THE FOOTING BEAMS OR PIERS ENCOUNTER ROCK OR SHALE, THEN ALL FOOTING BEAMS AND LOAD BEARING SPINE BEAMS SHALL BE PIERED TO ROCK OR SHALE.

P3. PIERING TO STRATA OTHER THAN ROCK OR SHALE MAY BE DELETED FROM THE CUT AREA OF THE BUILDING PLATFORM IF AUTHORIZED BY THE ENGINEER.

P4. ALL PIERS ARE TO BE CLEAN AND DE-WATERED PRIOR TO PLACEMENT OF CONCRETE.

P5. WHERE A SERVICE TRENCH OR AGRICULTURAL DRAIN IS PARALLEL TO THE EDGE OF A SLAB WHETHER THE SLAB BE IN EXCAVATED OR FILLED AREA, THEN PIERING TO SUPPORT THE SLAB BESIDE THE SERVICE TRENCH IS ONLY REQUIRED IF THE SERVICE LINE IS BELOW A LINE OF INFLUENCE DRAWN AS INDICATED BELOW IN Z.O.I DIAGRAM:

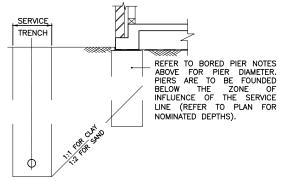

FOR CONSTRUCTION NEXT TO OR OVER EXISTING/PROPOSED SERVICES EASEMENT — FINAL EXTENT AND ZONE OF INFLUENCE TO BE DETERMINED BY ENGINEER PRIOR TO CONSTRUCTION OF FLOOR SLAB. DETAILS TO BE SUPPLIED FOLLOWING RECEIPT OF SEWER PEG OUT DETAILS.

### Z.O.I. DIAGRAM

P6. THESE NOTES ARE INTENDED AS A GUIDE. THERE IS ALWAYS A POSSIBILITY OF SITE CONDITIONS REQUIRING VARIATIONS TO THESE PROCEDURES. IN SUCH CASES. THE ENGINEER MUST BE CONSULTED

### PLASTIC SHRINKAGE CRACKING CONTROL AND **SLAB MAINTENANCE**

M1. CONCRETE PLACING, VIBRATING AND CURING MUST BE CARRIED OUT IN ACCORDANCE WITH

M2. WATER IS NOT TO BE ADDED TO THE CONCRETE ON SITE AS TO INCREASE THE SLUMP ABOVE THAT SPECIFIED.

M3. IT IS RECOMMENDED THAT AN APPROVED CURING COMPOUND BE APPLIED TO THE SLAB IN ACCORDANCE WITH MANUFACTURERS THE RECOMMENDATIONS.

CAUTION SHOULD BE EXERCISED WHEN APPLYING BRITTLE FINISHES, SUCH AS CERAMIC THES TO THE FLOOR SLAB AN ISOLATING MORTAR BED OR AN APPROVED FLEXIBLE ADHESIVE SYSTEM IS RECOMMENDED.

M5. THE OWNER'S ATTENTION SHALL BE DRAWN TO APPENDIX 'A' - "PERFORMANCE REQUIREMENTS AND FOUNDATION MAINTENANCE" OF AS2870 AND CSIRO PUBLICATION "GUIDE TO HOME OWNERS ON AND MAINTENANCE FOUNDATION FOOTING PERFORMANCE".

### CONCRETE NOTES

C1. ALL WORKMANSHIP AND MATERIALS SHALL BE IN ACCORDANCE WITH AS3600, EXCEPT WHERE VARIED BY THE CONTRACT DOCUMENTS.

C2. UNLESS NOTED OTHERWISE:

MAXIMUM AGGREGATE SIZE SHALL BE 20MM

SLUMP DURING PLACING SHALL BE 100MM NO ADMIXTURES SHALL BE USED IN CONCRETE

UNLESS APPROVED IN WRITING C3. CEMENT TYPE TO BE GP/GB AND 250KG MIN.

CEMENT CONTENT PER m3.


ALL CONCRETE CONSTRUCTION TO BE COMPACTED WITH A MECHANICAL VIBRATOR.

### REINFORCEMENT FIXING NOTES

R1. ALL REINFORCING BAR AND FABRIC SHALL BE DESIGNATED AS SHOWN IN THE FOLLOWING TABLE AND SHALL COMPLY WITH THE APPROPRIATE CODES AS NOTED BELOW:

Symbol	Туре		
R	Structural grade round bars to AS4671 (250MPa)		
S	Structural grade deformed bars to AS4671 (250MPa)		
N	N Tempcore deformed bars to AS4671 (500MPa)		
RL/SL	Fabric to AS4671 (500MPa)		
ТМ	Trench Mesh to AS4671 (500MPa)		
NOTE: The number following the symbol is the bar diameter in millimeters.			

R2. IF SLAB FABRIC IS USED IT IS TO BE LAPPED ONE FULL SQUARE PLUS 25MM AT SPLICES AS SHOWN IN THE DIAGRAM BELOW AND PLACED ON CHAIRS AT ONE METRE CENTRES BOTH WAYS TO GIVE 20MM CLEAR TOP COVER IN SHELTERED LOCATIONS AND 40MM CLEAR TOP COVER TO VERANDAHS.

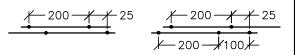

R3. FOOTING BEAMS AND RIB REINFORCEMENT TO HAVE 40MM CLEAR COVER ALL-ROUND.

R4. BAR REINFORCEMENT IS TO BE TIED BENEATH THE FABRIC IF USED OR OTHERWISE PLACED ON CHAIRS AND LAPPED AS FOLLOWS:

ISSUE

SHEET No.

S1

JD

JD


Bar Size	N12	N16	N20
Splice Length	500	700	900



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	DRAW
	J
JONES	
REAM : (02) 9634 5511	
NS THE PROPERTY	
TERED IN ANY WAY TTEN CONSENT.	MAS

NWA	DATE	DESCRIPTION	ISSUE	FOR
L	03/02/14	ISSUED FOR CONSTRUCTION	Α	H ZHOU
				SITE ADDRESS:
				LOT 2184
				ADINA STREET
ASTE	R CODE	BRISTOL - NEVADA		JORDAN SPRINGS



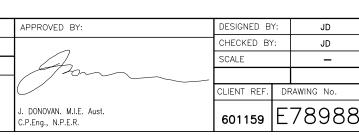

PIERING NOTE:

ALL PIERS TO BE FOUNDED MIN. 750 INTO EXISTING FOUNDATION. NOTE:

C/L DEPTH. -

DÉPTH TO INVERT

RWT & AC SLAB IS NOT SHOWN ON SLAB PLAN. REFER TO ARCHITECTURAL DRAWINGS FOR LOCATION AND SIZE. REFER TO STRUCTURAL DETAILS ON SHEET 7 & 8.


**SLAB SPECIFICATIONS:** SLAB THICKNESS (mm): 85 RESIDENCE POD DEPTH (mm): 225 150 GARAGE POD DEPTH (mm): 150 PATIO POD DEPTH (mm): 150 ALFRESCO POD DEPTH (mm): RESIDENCE MESH: **SL72** (TOP COVER: 20mm) GARAGE/PORCH & ALFRESCO MESH: **SL82** (TOP COVER: 30mm) 160 TYP. EDGE BEAM REBATE (mm): GARAGE EDGE BEAM REBATE (mm): 86 20 MPa RESIDENCE SLAB CONCRETE STRENGTH (F'c): 25 MPa GARAGE/PORCH & ALFRESCO SLAB CONCRETE: STRENGTH (F'c) SLAB CONCRETE SLUMP (mm): 100 mm 20 MPa PIERS CONCRETE STRENGTH (F'c): Р SITE CLASSIFICATION:

CONC. ENCASED SEWER APPROX.

	LEGEND			
MARK	NOTE			
	1090x1090mm STANDARD POD			
*	START POD LOCATION			
	2N12 or 2/1.5 RW 10.65 TRIMMERS UNDERSIDE OF MESH			
=====	110mm WIDE INTERNAL RIB			
O	400mm DIAMETER MASS CONCRETE PIER – REFER TO 'BORED PIER NOTES' ON SHEET 1			
	400mm DIA PIER FOUNDED BELOW SEWER Z.O.I. DEPTH OF PIERS ON PLAN ARE FROM NATURAL GROUND LEVEL, ADD FILL DEPTH TO PIER DEPTHS NOTED ON PLAN. REFER TO TYPICAL SEWER SECTION.			

### NOTES:

- 1. THIS DRAWING IS TO BE READ IN CONJUNCTION WITH THE STRUCTURAL NOTES SHEET AND THE SUBSEQUENT DETAIL SHEETS.
- 2. VERTICAL BRICKWORK ARTICULATION JOINTS MUST BE PROVIDED IN ACCORDANCE WITH AS4773 AND AS3700.
- 3. UNLESS NOTED OTHERWISE, SERVICES IN EASEMENT(S) ADJACENT TO THIS PROPERTY HAVE NOT BEEN ASSESSED. EVALUATION OF THE EFFECTS OF ANY SERVICES WILL BE MADE FOLLOWING RECEIPT OF FURTHER INFORMATION. THIS INFORMATION WILL BE DOCUMENTED AS AN AMENDMENT TO THESE DRAWINGS IF REQUIRED.
- 4. IT IS THE RESPONSIBILITY OF THE BUILDER , SUB-CONTRACTOR TO ENSURE CORRECT PIER SETOUT.

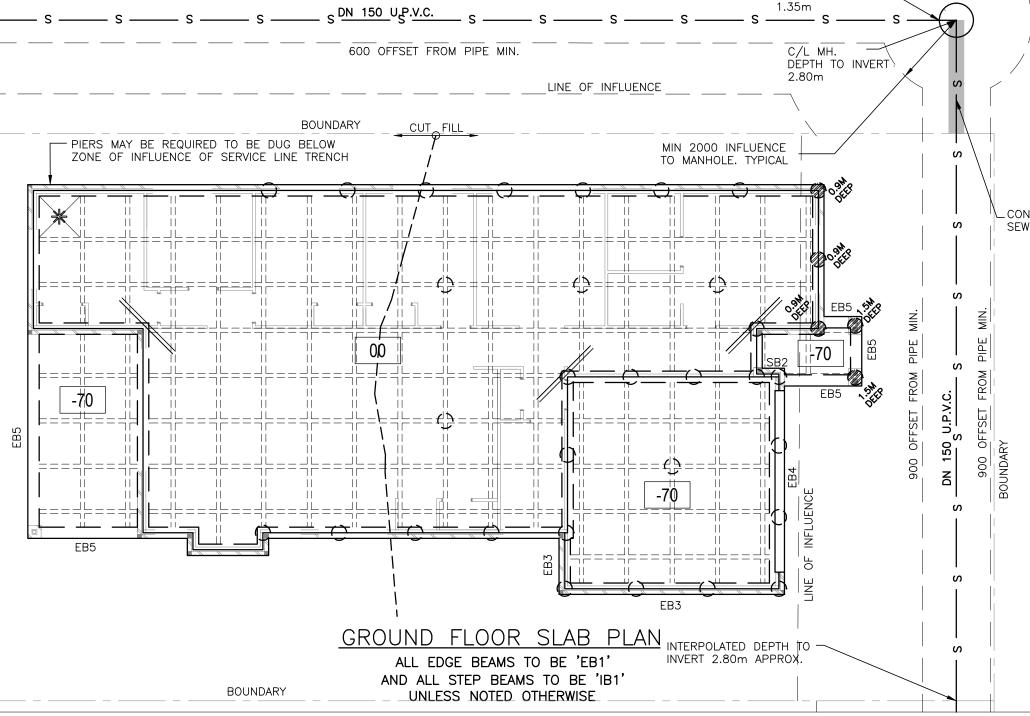

600 OFFSET FROM PIPE MIN.

### SITE CLASSIFICATION NOTE


THE SITE HAS BEEN CLASSIFIED "M" PURSUANT TO GEOTECHNICAL REPORT PREPARED BY SMEC TESTING SERVICES PTY LTD REPORT NUMBER 13/0932 DATED 13 JUNE 2013. THESE DOCUMENTS HAVE BEEN PREPARED IN ACCORDANCE WITH THE PROVISIONS OF AS2870: "RESIDENTIAL SLABS AND FOOTINGS — CONSTRUCTION" CODE ON THE BASIS OF A CLASSIFICATION "P". REFER TO SHEET 1 FOR ADDITIONAL NOTES.


DONG	VA	N	•
ASSOCI	ATES		
INCORPORATED ENGSURVEY PT PH/ 02 9806 3000 F/ 02 9891 2806 E/ ac	dmineng@donovanassocia		CON
15 PARKES STREET PA	RRAMATIA NSW	/ 2150	V

CLIENT	DR
McDONALD JONES	
YOUR HOME YOUR DREAM	
PH: (02) 8848 6000 FAX: (02) 9634 5511  COPYRIGHT — THIS DRAWING REMAINS THE PROPERTY	
OF DONOVAN AND MAY NOT BE ALTERED IN ANY WAY WITHOUT DONOVAN ASSOCIATES WRITTEN CONSENT.	N

	DRAWN	DATE	DESCRIPTION	ISSUE	FOR	APPROVED
	JL	03/02/14	ISSUED FOR CONSTRUCTION	Α	H ZHOU	
S	FL	12/02/14	SEWER DETAILS ADDED	Α	SITE ADDRESS:	
11					LOT 2184	
PERTY					ADINA STREET	J. DONOVAN.
NY WAY ENT.	MASTE	R CODE	BRISTOL - NEVADA		JORDAN SPRINGS	C.P.Eng., N.P

DESIGNED BY: ED BY: JD CHECKED BY: JD В SCALE 1:100 SHEET No. CLIENT REF. DRAWING No. S2 E78988 . M.I.E. Aust. 601159 N.P.E.R.

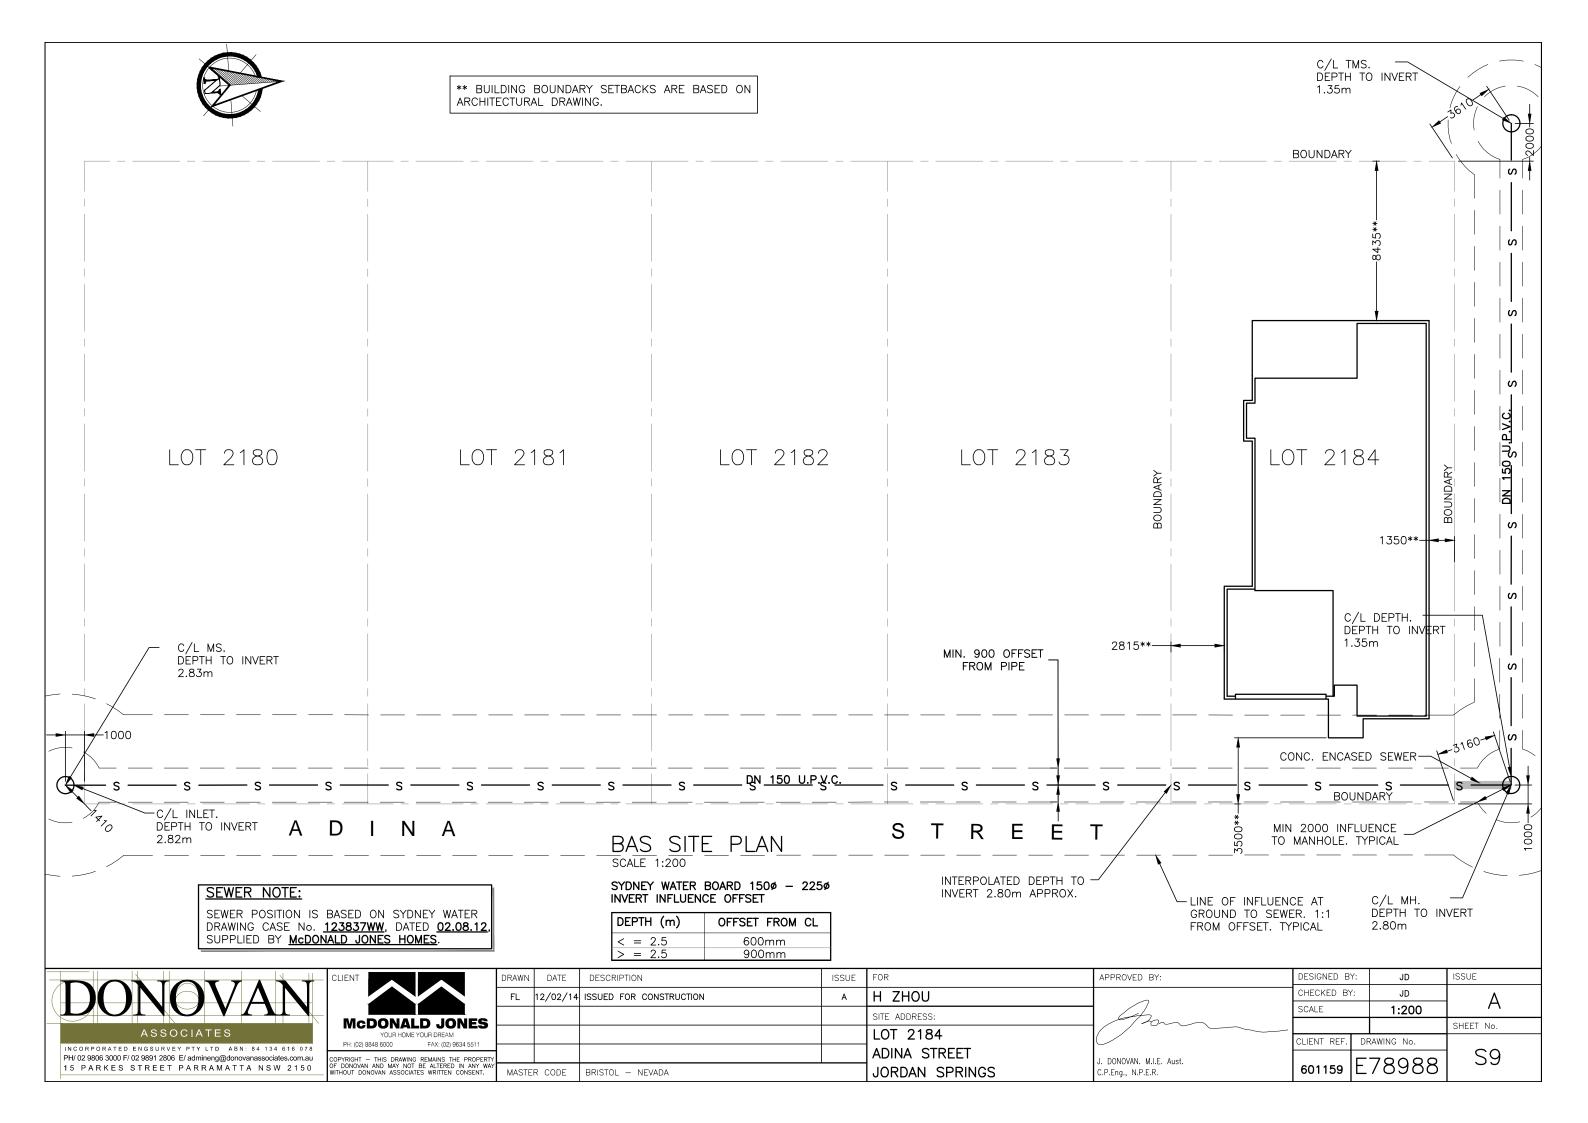

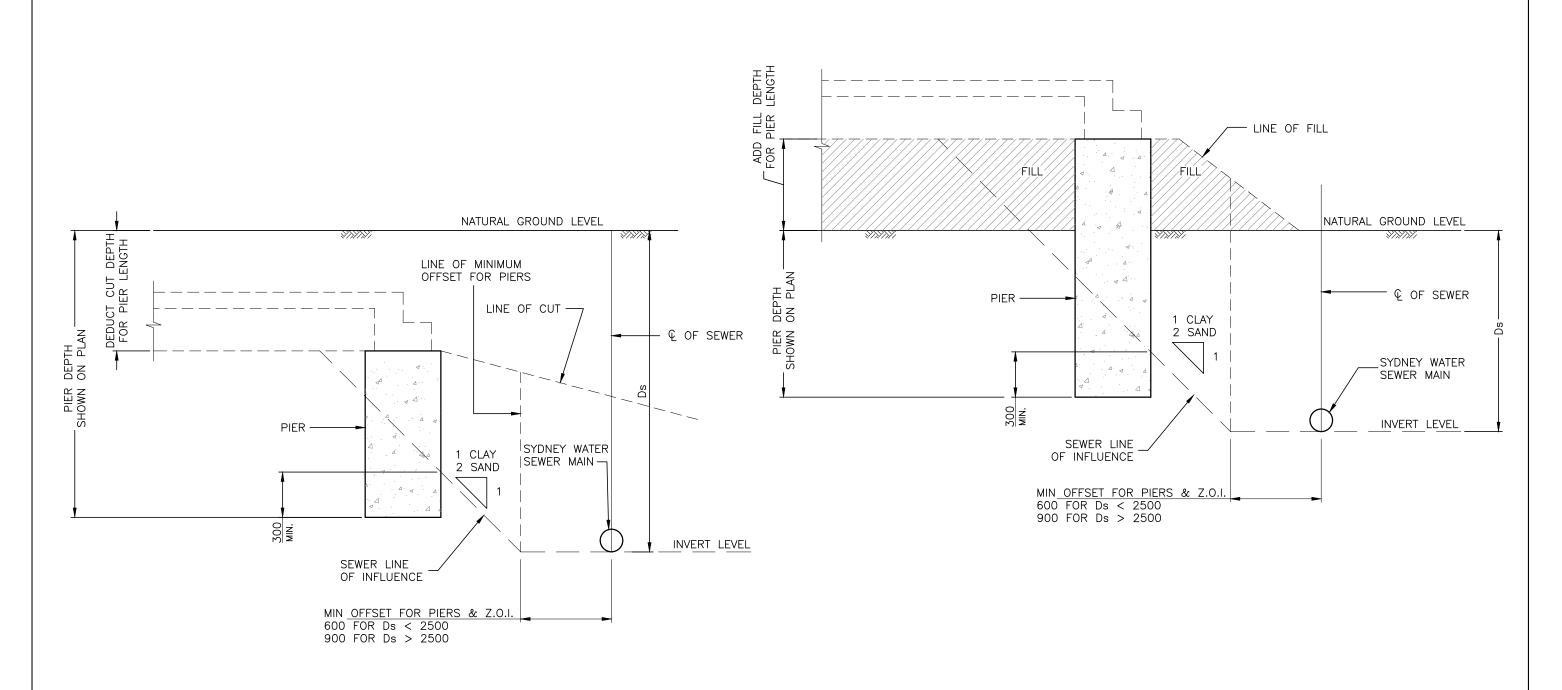

## SEWER ADJACENT TO SLAB TYPICAL SECTION IN CUT

Ds- DENOTES DEPTH OF SEWER SHOWN ON PLAN

## SEWER ADJACENT TO SLAB TYPICAL SECTION IN FILL

Ds- DENOTES DEPTH OF SEWER SHOWN ON PLAN

### **SEWER PIER REINFORCEMENT NOTE:**

THE FOLLOWING REINFORCEMENT IN PIERS IS REQUIRED FOR THE FULL HEIGHT OF THE PIER:

- 2.5m < PIER DEPTH ≤ 4.5m: 4N12 BARS WITH
- R6-300 SPIRAL OR CLOSED TIES. 4.5m < PIER DEPTH ≤ 6.0m: 4N16 BARS WITH R10-300 SPIRAL.

PH/ 02 9806 3000 F/ 02 9891 2806 E/ admineng@donovanassociates.com.au 15 PARKES STREET PARRAMATTA NSW 2150

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	DRAWN	DATE	DESCRIPTION	ISSUE	FOR	AF
	FL	12/02/14	ISSUED FOR CONSTRUCTION	Α	H ZHOU	
<u> </u>					SITE ADDRESS:	
					LOT 2184	
ERTY					ADINA STREET	J.
WAY 「.	MASTE	R CODE	BRISTOL - NEVADA		JORDAN SPRINGS	C.F

APPROVED BY:	DESIGNED B	Y:	JD	ISSUE
_	CHECKED BY	<b>′</b> :	JD	٨
4	SCALE		1:20	A
1/2000				SHEET No.
	CLIENT REF.	DF	RAWING No.	
J. DONOVAN. M.I.E. Aust. C.P.Eng., N.P.E.R.	601159	E	78988	S10

Qalchek Pty Ltd FOR CONSTRUCTION IN ACCORDANCE WITH

PLAN 123837WYSSUE D DATE 02 / 08 / 2012

1. DESIGNER AND WATER SERVICING COORDINATOR: QALCHEK PTY LTD (CERTIFIED No.289) 77 UNION RD. PENRITH NSW 2750 PH. No. (02) 4722 8181

MARYLAND DEVELOPMENTS PTY. LTD. C/- LEND LEASE ATT: IAN DOYLE PROJECT OFFICE, ROPES CROSSING BLVD, ROPES CROSSING NSW 2760 PH. No. 02 9673 8818 Mob. 0412 214 818

- 2. THE PROPOSED WORKS AND MATERIALS SHALL BE IN ACCORDANCE WITH THE SEWER RETICULATION CODE OF AUSTRALIA (WSA 02-2002-2.2 VERSION 3) INCLUDING THE SYDNEY WATER SUPPLEMENT AND APPENDICIES AND THE TECHNICAL SPECIFICATION FOR LOW INFILTRATION SEWER SYSTEMS. THE CONTRACTOR MUST HAVE A COPY OF THESE DOCUMENTS ON SITE AT ALL TIMES.
- 3. ALL STRUCTURES TO BE CONSTRUCTED TO PROPOSED FINISHED SURFACE LEVELS. ALL LEVELS REFER TO PROPOSED FINISHED SURFACE LEVEL. SEWER CONSTRUCTOR TO LIASE WITH RD. AND/OR CIVIL CONTRACTOR TO VERIFY ALL LEVELS IN PARTICULAR IN OR ADJACENT TO RD.S. PRÓJECT SUPERVISOR/DESIGNER TO BE INFORMED OF ANY DISCREPANCIES.
- 4. ALL FINISHED SURFACE LEVELS, STORMWATER INFORMATION, AND GENERAL CIVIL ENGINEERING DETAILS TAKEN FROM 'J. WYNDHAM PRINCE' ENGINEERING PLANS REVISION 'B' DATED 30.08.2011
- 5. THE MINIMUM NUMBER OF FIELD COMPACTION TESTS REQUIRED TO SATISFY THE SEWERAGE CODE OF AUSTRALIA ARE: IF SAND/CEMENT BACKFILL IS USED AT RD. CROSSINGS, THE NUMBER OF TRENCHFILL COMPACTION TESTS MAY BE REDUCED BY 22 IF THE CONSTRUCTOR PROVIDES DOCUMENTATION FROM HIMSELF AND THE TESTING COMPANY STATING EXTENTS AND COMPLIANCE.

PIPE EMBEDMENT ZONE: 20 TESTS REQUIRED

TRENCH FILL ZONE (TRAFFICABLE): 22 TESTS REQUIRED

TRENCH FILL ZONE (NON TRAFFICABLE): 37 TESTS REQUIRED

TRENCH FILL ZONE (MAINTENANCE HOLES): 19 TESTS REQUIRED

TRENCH FILL ZONE (MAINTENANCE SHAFTS): 65 TESTS REQUIRED

TRENCH FILL ZONE - TOTAL: 121 TESTS REQUIRED

- 6. ALL LEVELS ELECTRONICALLY GENERATED. NO LEVEL BOOK AVAILABLE.
- 7. THE REVIEW OF ENVIRONMENTAL FACTORS IS AN INTEGRAL PART OF THIS DESIGN AND MUST BE READ IN CONJUNCTION WITH THIS PLAN.
- 8. PRIOR TO ANY EXCAVATION THE CONSTRUCTOR MUST HAVE A CURRENT COPY OF THE UNDERGROUND SERVICES REPORT WHICH IS TO BE READ IN CONJUNCTION WITH THIS PLAN.
- 9. SERVICES SHOWN FROM 'DIAL BEFORE YOU DIG' SERVICES SEARCH ARE INDICATIVE ONLY. AUTHENTICITY AND ACCURACY SHOULD NOT BE PRESUMED AND SHOULD BE CONFIRMED BY THE CONSTRUCTOR PRIOR TO ANY EXCAVATION WORKS ON SITE.
- 10. ALL EXCAVATION, SHORING EXCAVATION AND STABILITY OF ADJACENT STRUCTURES/SERVICES/DWELLINGS IS THE RESPONSIBILITY OF THE CONSTRUCTOR.
- 11. PIPES TO BE CONCRETE ENCASED SHOWN ACCORDINGLY:- REFER TO SEW-1205-V


EACH SECTION OF PIPE SHALL BE CONCRETE ENCASED IN THE FOLLOWING MANNER EACH PIPE JOINT REQUIRES A 12mm THICK COMPRESSIBLE MEMBRANE TO BE INSERTED EACH PIPE JOINT IS REQUIRED TO HAVE 3 R16 DOWEL PINS TOP & BOTTOM, DOWEL PINS ARE TO BE CENTRALLY PLACED IN CONCRETE WITH A MINIMUM BAR LENGTH OF 600mm THE DOWEL PIN IS TO BE EITHER GALVANISE OR STAINLESS STEEL.

AT THE ENDS OF EACH SECTION OF ENCASEMENT A 600mm ROCKER PIPE IS TO BE INSTALLED.

- 12. MAINTENANCE STRUCTURE OPTIONS SHALL BE LIMITED TO CAST IN-SITU MAINTENANCE HOLES, PLASTIC MAINTENANCE SHAFTS AND PLASTIC TEMINAL MAINTENANCE SHAFTS.
- 13. CONSTRUCTOR RESPONSIBLE TO FOLLOW ANY TESTING PROCEDURES SET OUT IN SECTION LI10.1 & LI10.2 OF THE TECHNICAL SPECIFICATION FOR LOW INFILTRATION SEWERS.
- 14. ALL MH'S TO BE CONSTRUCTED IN ACCORDANCE WITH DTC-2000, DTC-2202, DTC-2220, DTC-2221, DTC-2222.
- 15. ALL MH'S AND MS'S TO HAVE TYPE 'B' LIDS.
- 16. PRECAUTIONS MAY BE NECESSARY IN THE VICINITY OF SUB-STATION EARTHING.
- 17. ALL BUILDING LAYOUTS, FINISHED SURFACE LEVELS, STORMWATER INFORMATION, AND GENERAL CIVIL ENGINEERING DETAILS TAKEN FROM 'J. WYNDHAM PRINCE' ENGINEERING PLANS REVISION 'B' DATED 30.08.2011
- 18. ALL LOTS WERE VACANT AT TIME OF SURVEY.
- 19. CONSTRUCTOR TO SUPPLY ALL JUNCTION DISTANCES AND END OF LINE DEPTHS TO INVERT, TIES TO NEAREST BOUNDARIES, CONCRETE ENCASEMENT CHAINAGES AND C/D AND DROP JUNCTION INLET LEVELS/DEPTHS. IF TIES ARE NOT ABLE TO BE PROVIDED THE CONSTRUCTOR IS TO LEAVE A MARKER OF SOME DESCRIPTION SO THAT SURVEYORS CAN LOCATE AT A LATER TIME AFTER CONSTRUCTION.
- 20. THE TOTAL LENGTH OF THE DN100 PCS'S EXCLUDING RISERS IS APPROXIMATELY 90m. PCS's TO HAVE MINIMUM STIFFNESS RATING OF SN10. JOINTING TO BE SOLVENT WELDED.

## IMPORTANT NOTES FOR PCS'S:

- 21. ALL JUNCTIONS FOR THE PCS'S TO BE LOCATED 1.0m MIN OFF DOWNSTREAM PROPERTY BOUNDARY (OR DOWNSTREAM INTERNAL BOUNDARY) OR DOWNSTREAM EASEMENT BOUNDARY OR 1.0m OFF THE EDGE OF THE DOWNSTREAM STRUCTURE OR DRIVEWAY.
- 22. DENOTES STANDARD PCS CONNECTION (REFER LIS FIG.5 STANDARD CONNECTION) ALTERNATIVE ARRANGEMENT NOT TO BE ADOPTED.
- 23. \ DENOTES SLOPED PCS CONNECTION (REFER LIS FIG.5 SLOPED CONNECTION) ALTERNATIVE ARRANGEMENT NOT TO BE ADOPTED.
- 24. \* DENOTES DEEP PCS CONNECTION (REFER LIS FIG.6) ALTERNATIVE ARRANGEMENT NOT TO BE ADOPTED.
- 25. DENOTES FUTURE BOUNDARY NEEDS TO BE MARKED SO THAT PCS CAN BE CONSTRUCTED AT CORRECT LOCATION (IN CONJUNCTION WITH SYMBOLS ABOVE)

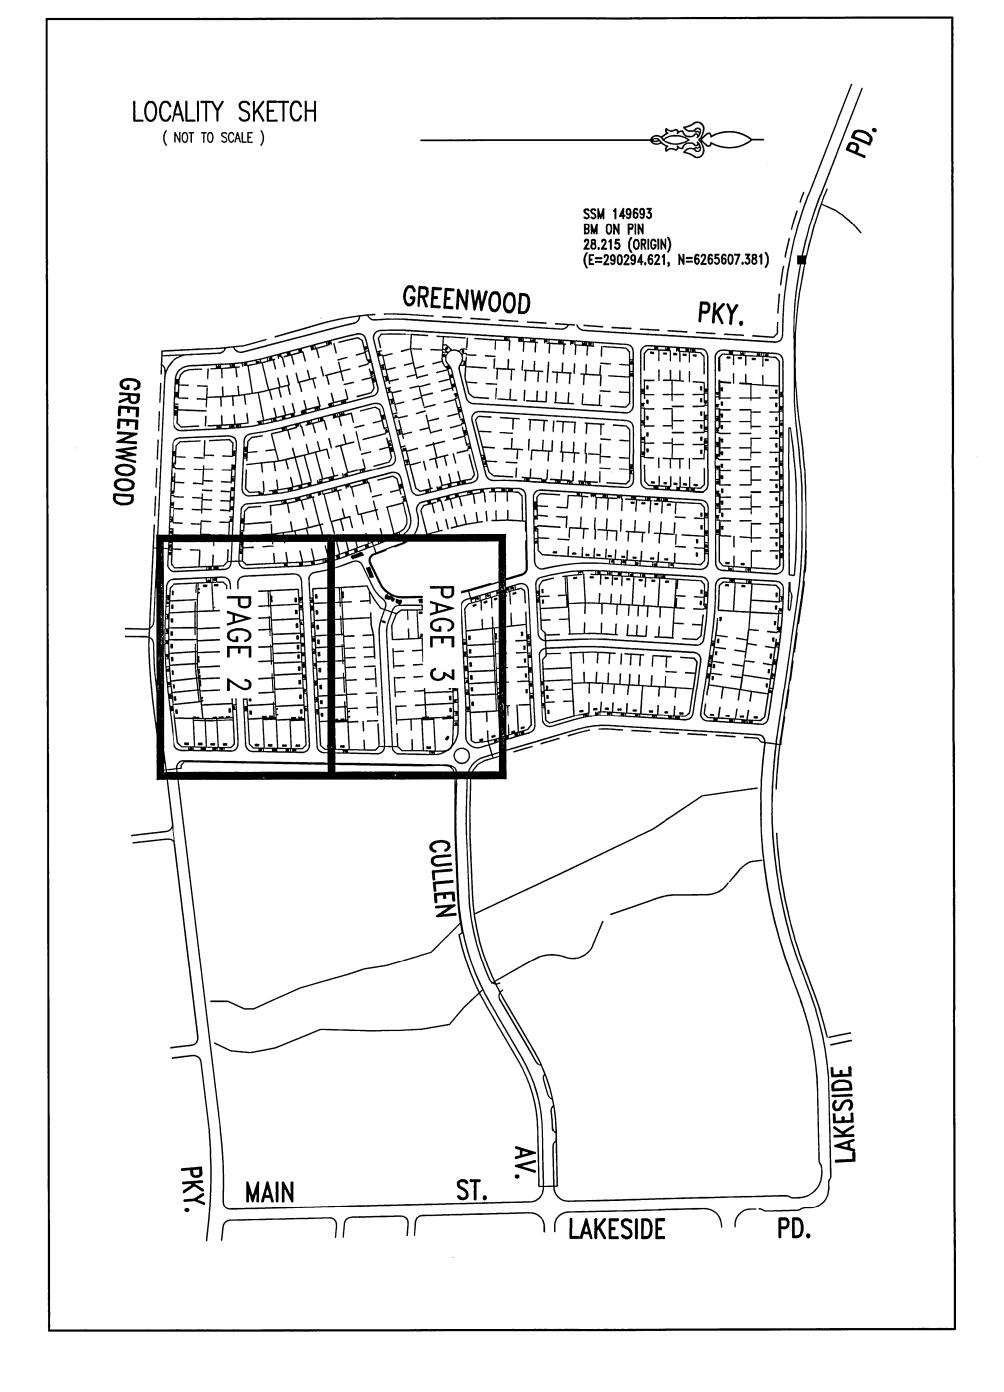


NUMBER	AMENDMENT	INITIAL	DATE	V.
Α	PRELIM. LAYOUT	G.M.	25.06.12	
В	REVIEW COPY	G.M.	03.07.12	
С	SYDNEY WATER ISSUE	G.M.	18.07.12	
D	TITLE BLOCK AMENDED	C.P.	24.07.12	


											D	TITLE BLOCK AMENDED	C.P. 24.07.12
PLAN TO BE READ IN CONJUNCTION		UTILITIE				WORK AS CONSTRUCTED CERTIFICATION		PIPE SCH	EDULE		NO AMENDMENTS ARE TO BE MADE TO THIS PLAN	Sydney SYD	DNEY WATER CORPORATION
WITH CURRENT SYDNEY WATER STANDARDS	TYPE DATE	REF.	TYPE DA	TE R	REF.	DEVELOPER	SIZE T	PE CLASS LENGTH	PIPE JOINING METHOD / NOTES	AUSTRALIAN HEIGHT DATUM	WITHOUT REFERENCE TO SYDNEY WATER. THIS PLAN	Sydney SYD WATER	
SYDNEY WATER CORPORATION	PROP STORMWATER: SWD ——— SWD 30.08.12	9111/				WATER SERVICE CO-ORDINATOR	150 U	VC SN8 1386.4			IS NOT NECESSARILY UP TO DATE OR CORRECT AND	<u> </u>	
PRIOR TO COMMENCEMENT OF EXCAVATION FOR		CC201				CONSTRUCTOR	100 UI	VC   SN10   90	SOLVENT WELDED	SCALES	SYDNEY WATER ACCEPTS NO RESPONSIBILITY.	Case No. 123	3837WW
	PROP WATER: DN100 Water ——— 25.06.12	CN123837								HOR. 1:500			
DIAL BEFORE YOU DIG Ph. 1100 Ph.	PROP ENDEAVOUR ENG: E — — E 07.03.12	350017				COMPLETED W.A.C. PREPARED				PLAN . 1:500 . SECTION VERT 1:125	U.B. DIRECTORY MAP 144/H15 14th Ed UBD 2013	ST MARYS SE	-WERAGE
GAS Ph.	PROF ENDLAYOON ENG. C C 07.03.12	333017	<del></del>			DESIGNER				- VEN		DRAINS	
TELĘCOMMUNICATIONS Ph.						DESIGNER		NO	BOUNDARY TRAPS	CROSS SECTIONS NATURAL		ST MARYS	
GIVING AT LEAST 48 HOURS NOTICE.						I CERTIFY THAT THE WORKS HAVE BEEN CONSTRUCTED IN ACCORDANCE WITH THE WORK AS CONSTRUCTED DRAWINGS.	DESIGNH		REQUIRED.	LENGTHS, DEPTHS & LEVELS ARE IN METRES.	SHEET. 1. OF. 7. File No. N/A		


FILE LOCATION: C:\Water\_b\dwg\9525S1\_D DESIGNED: G.M. DRAFTED: D.M.


APPROVED: D.M. VERIFIED: D.M REVIEWED: D.M.

ISSUED: 24.07.2012

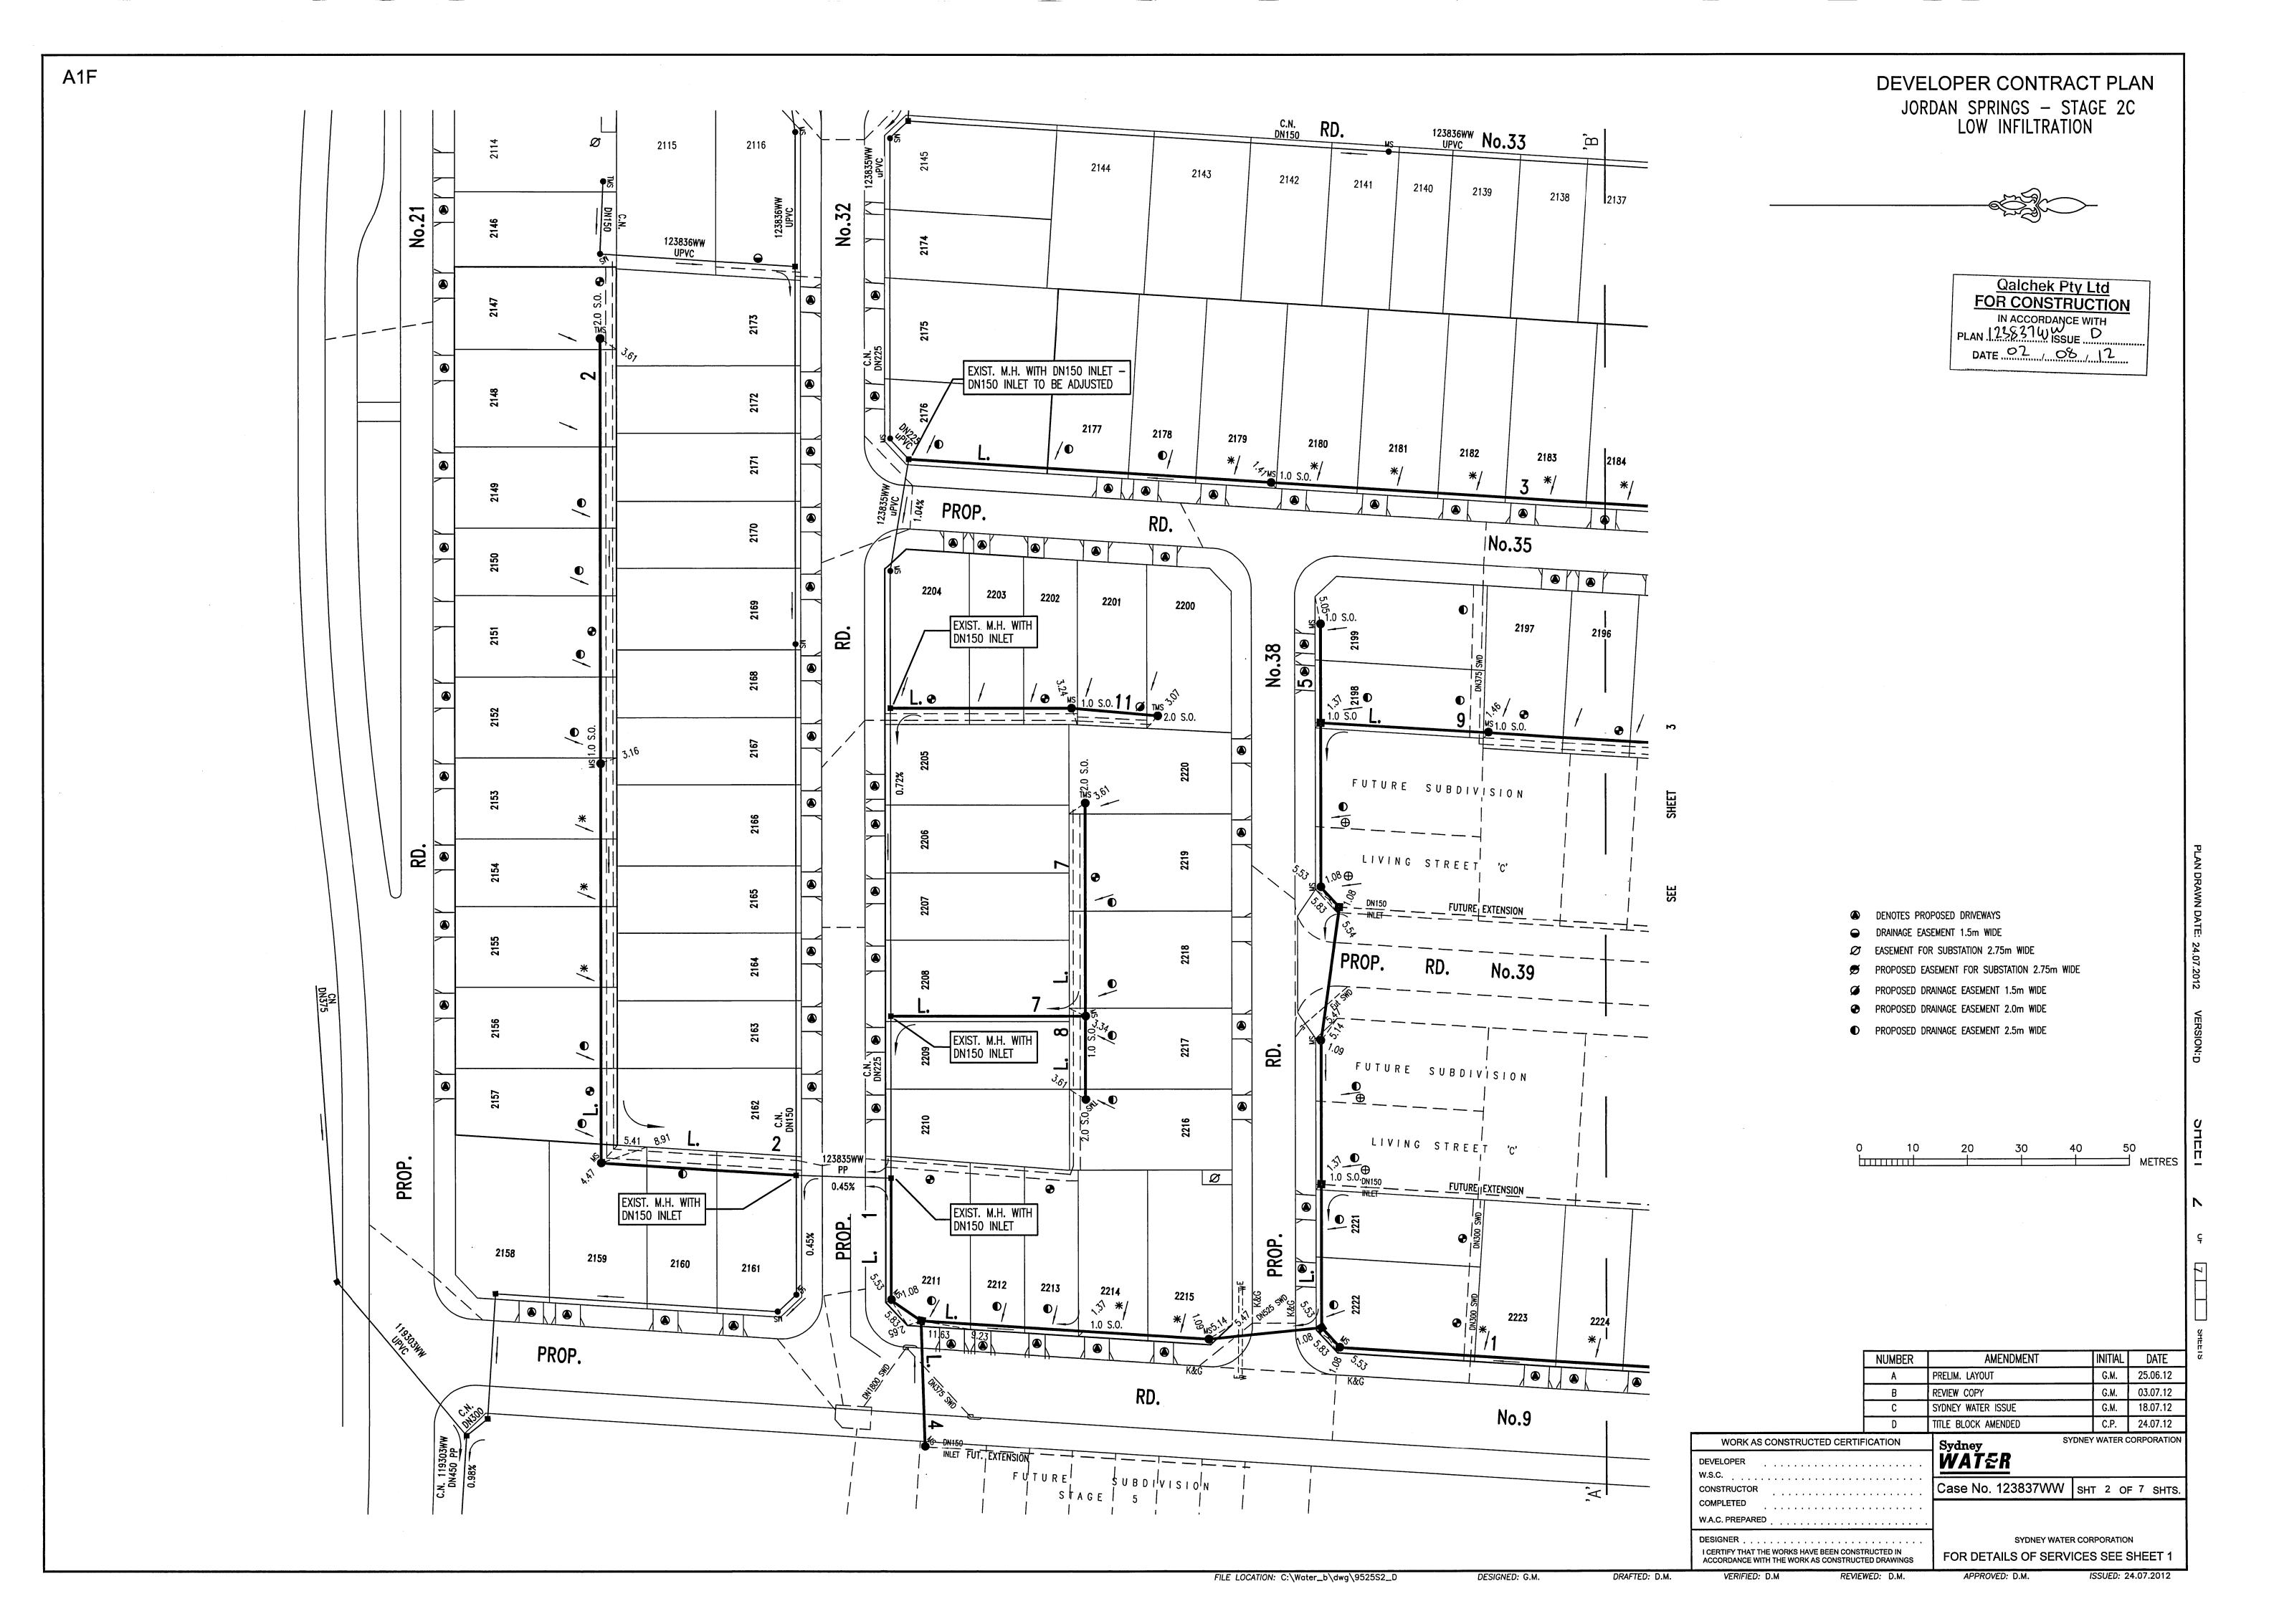

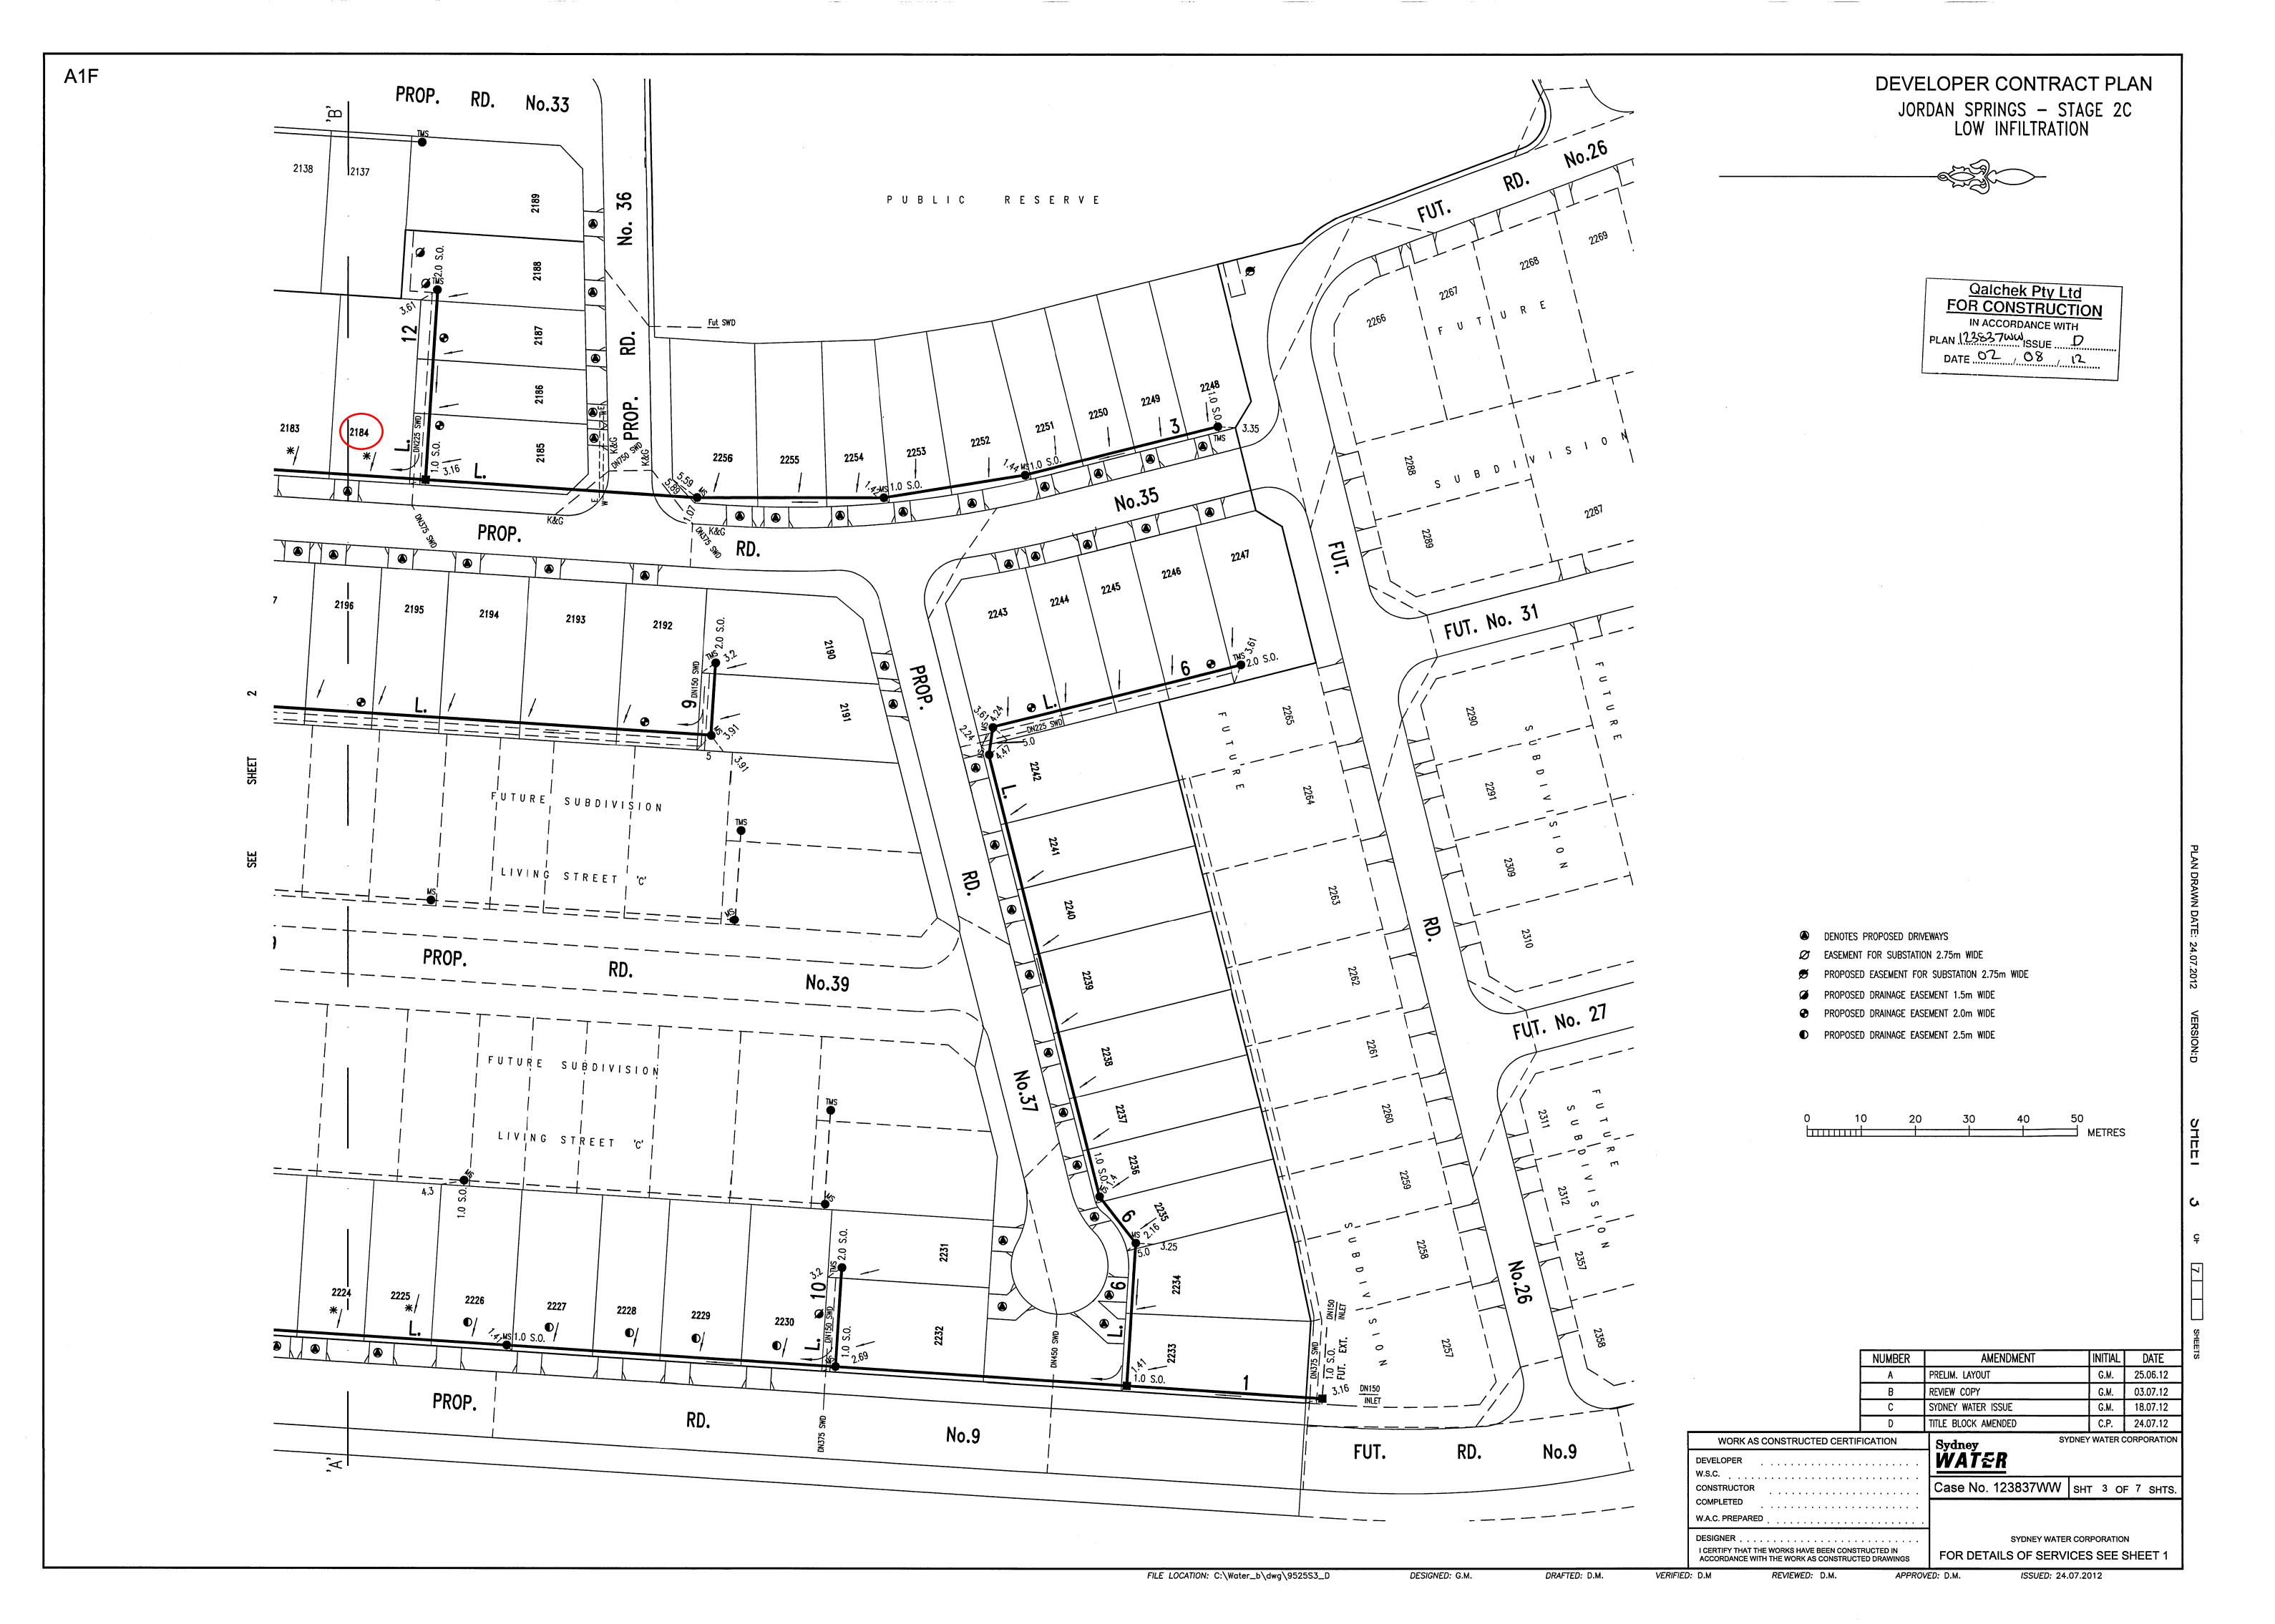

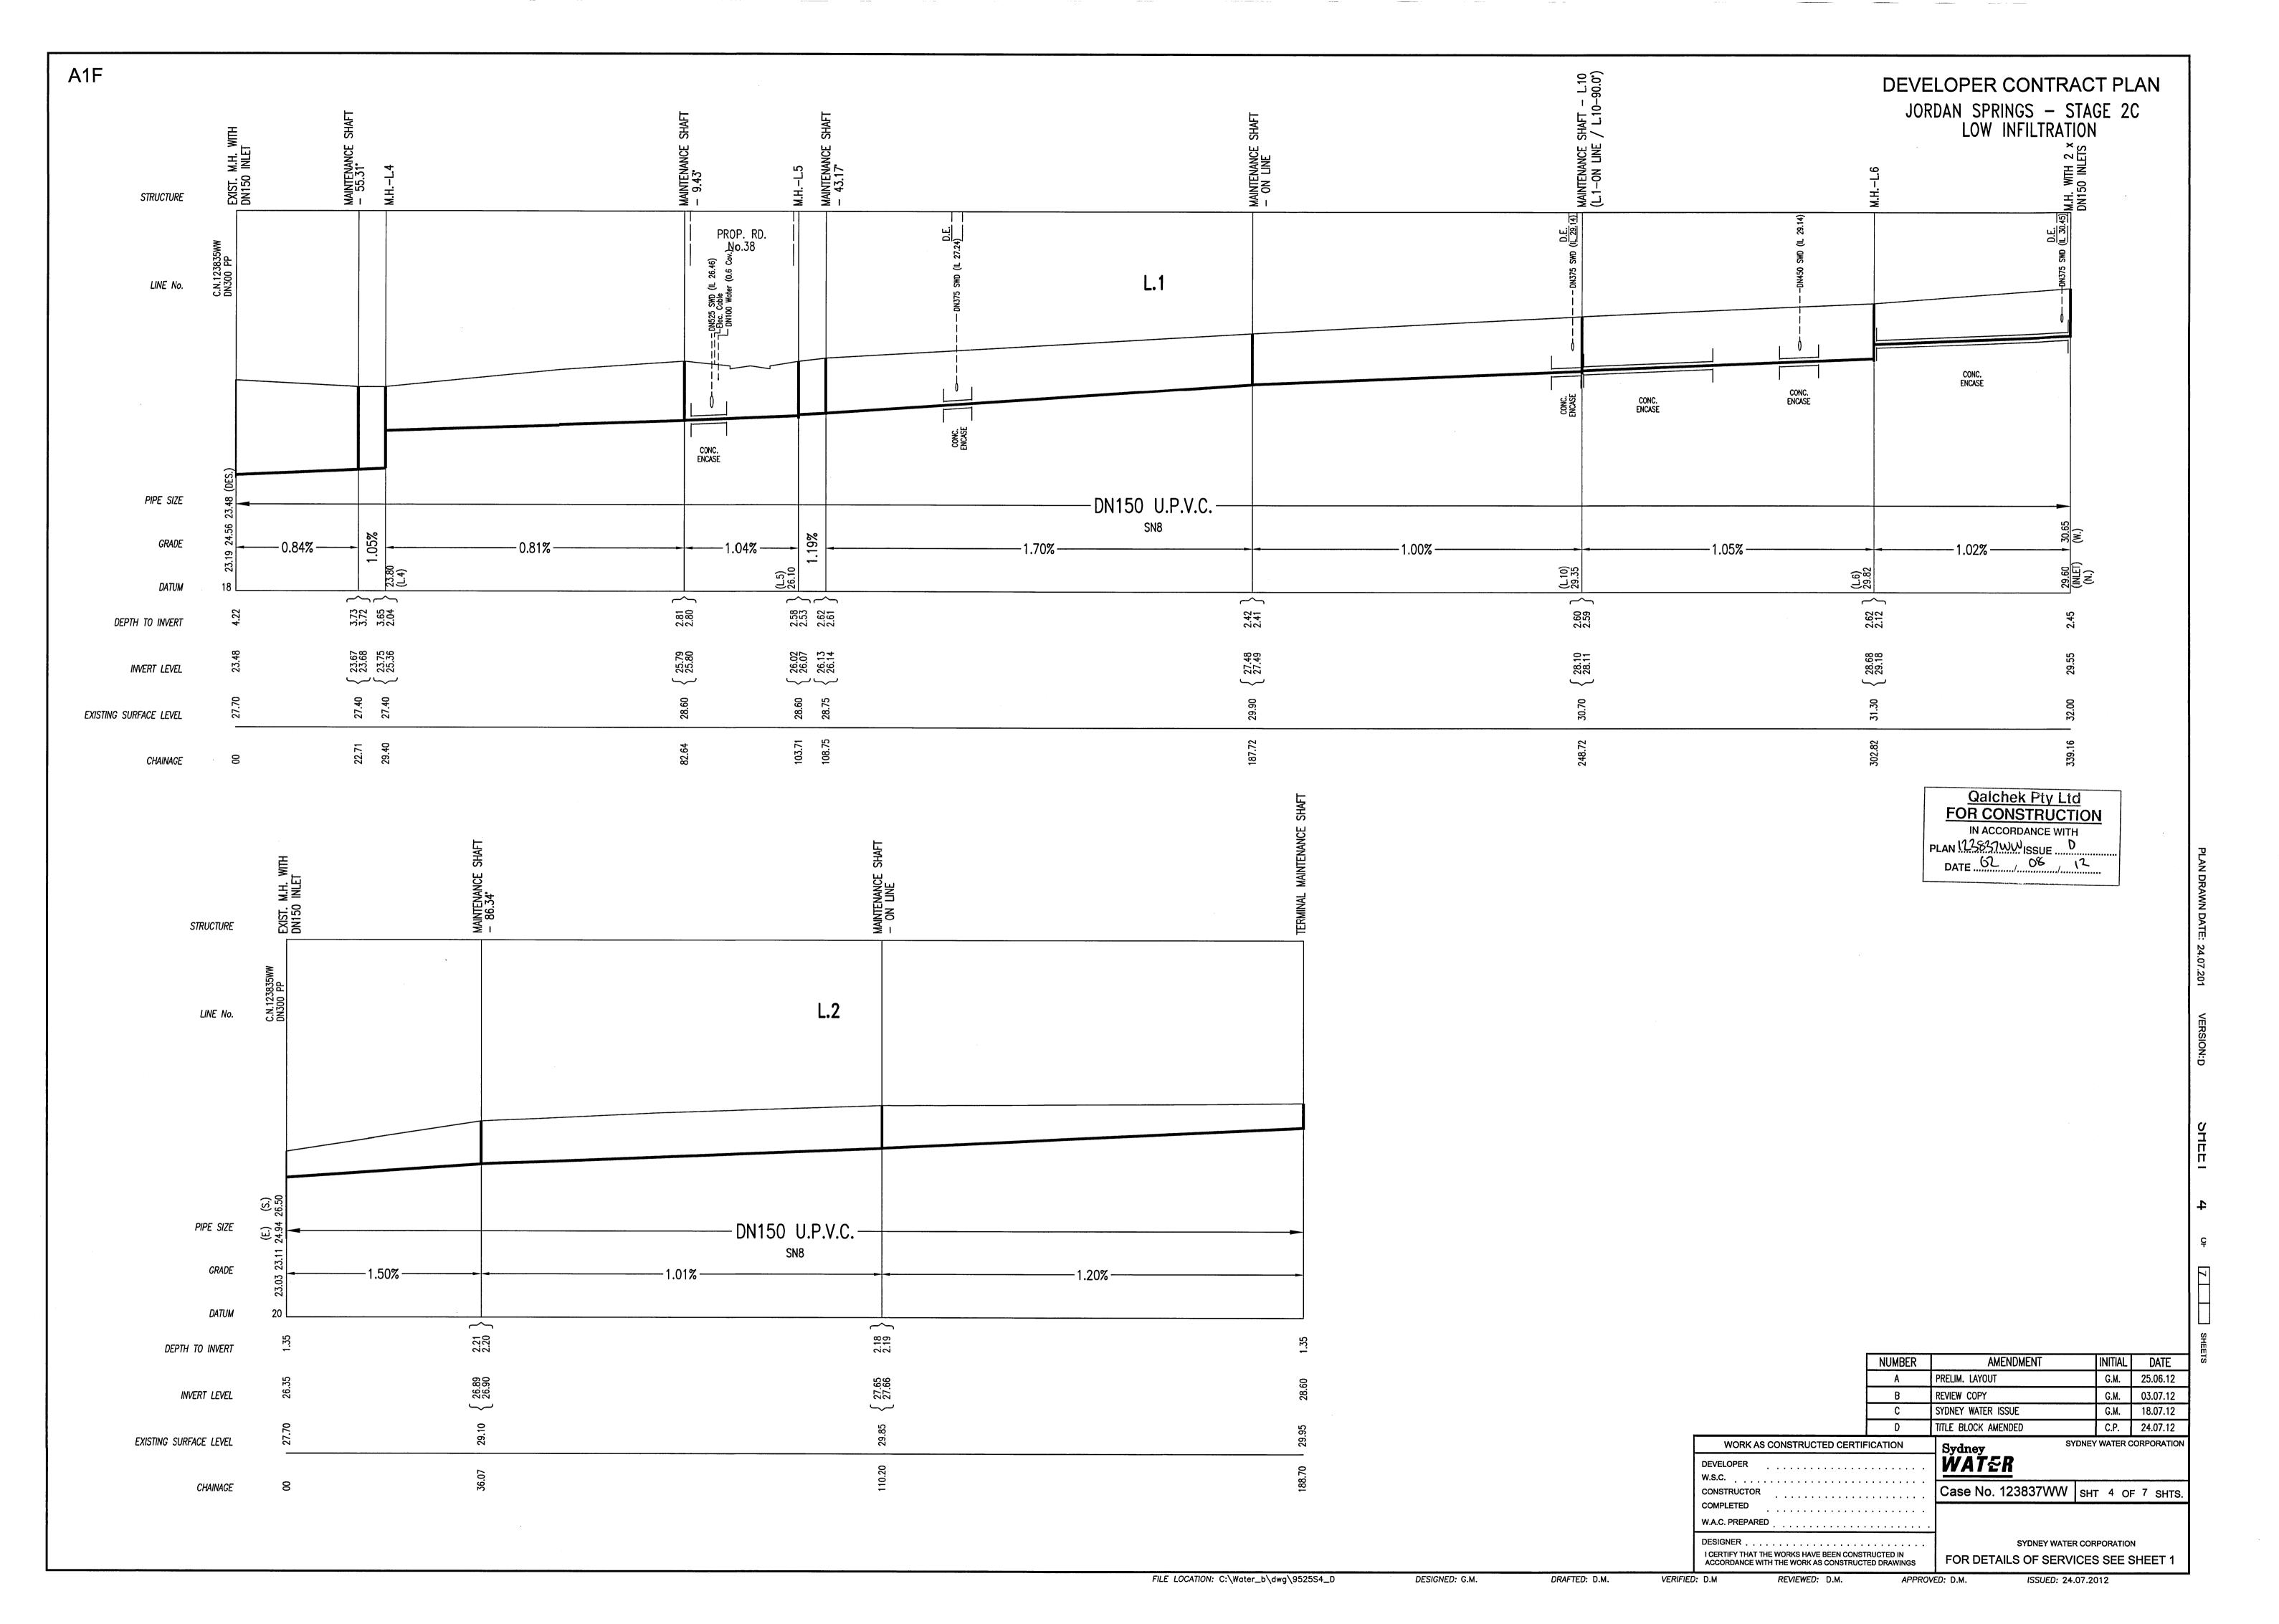

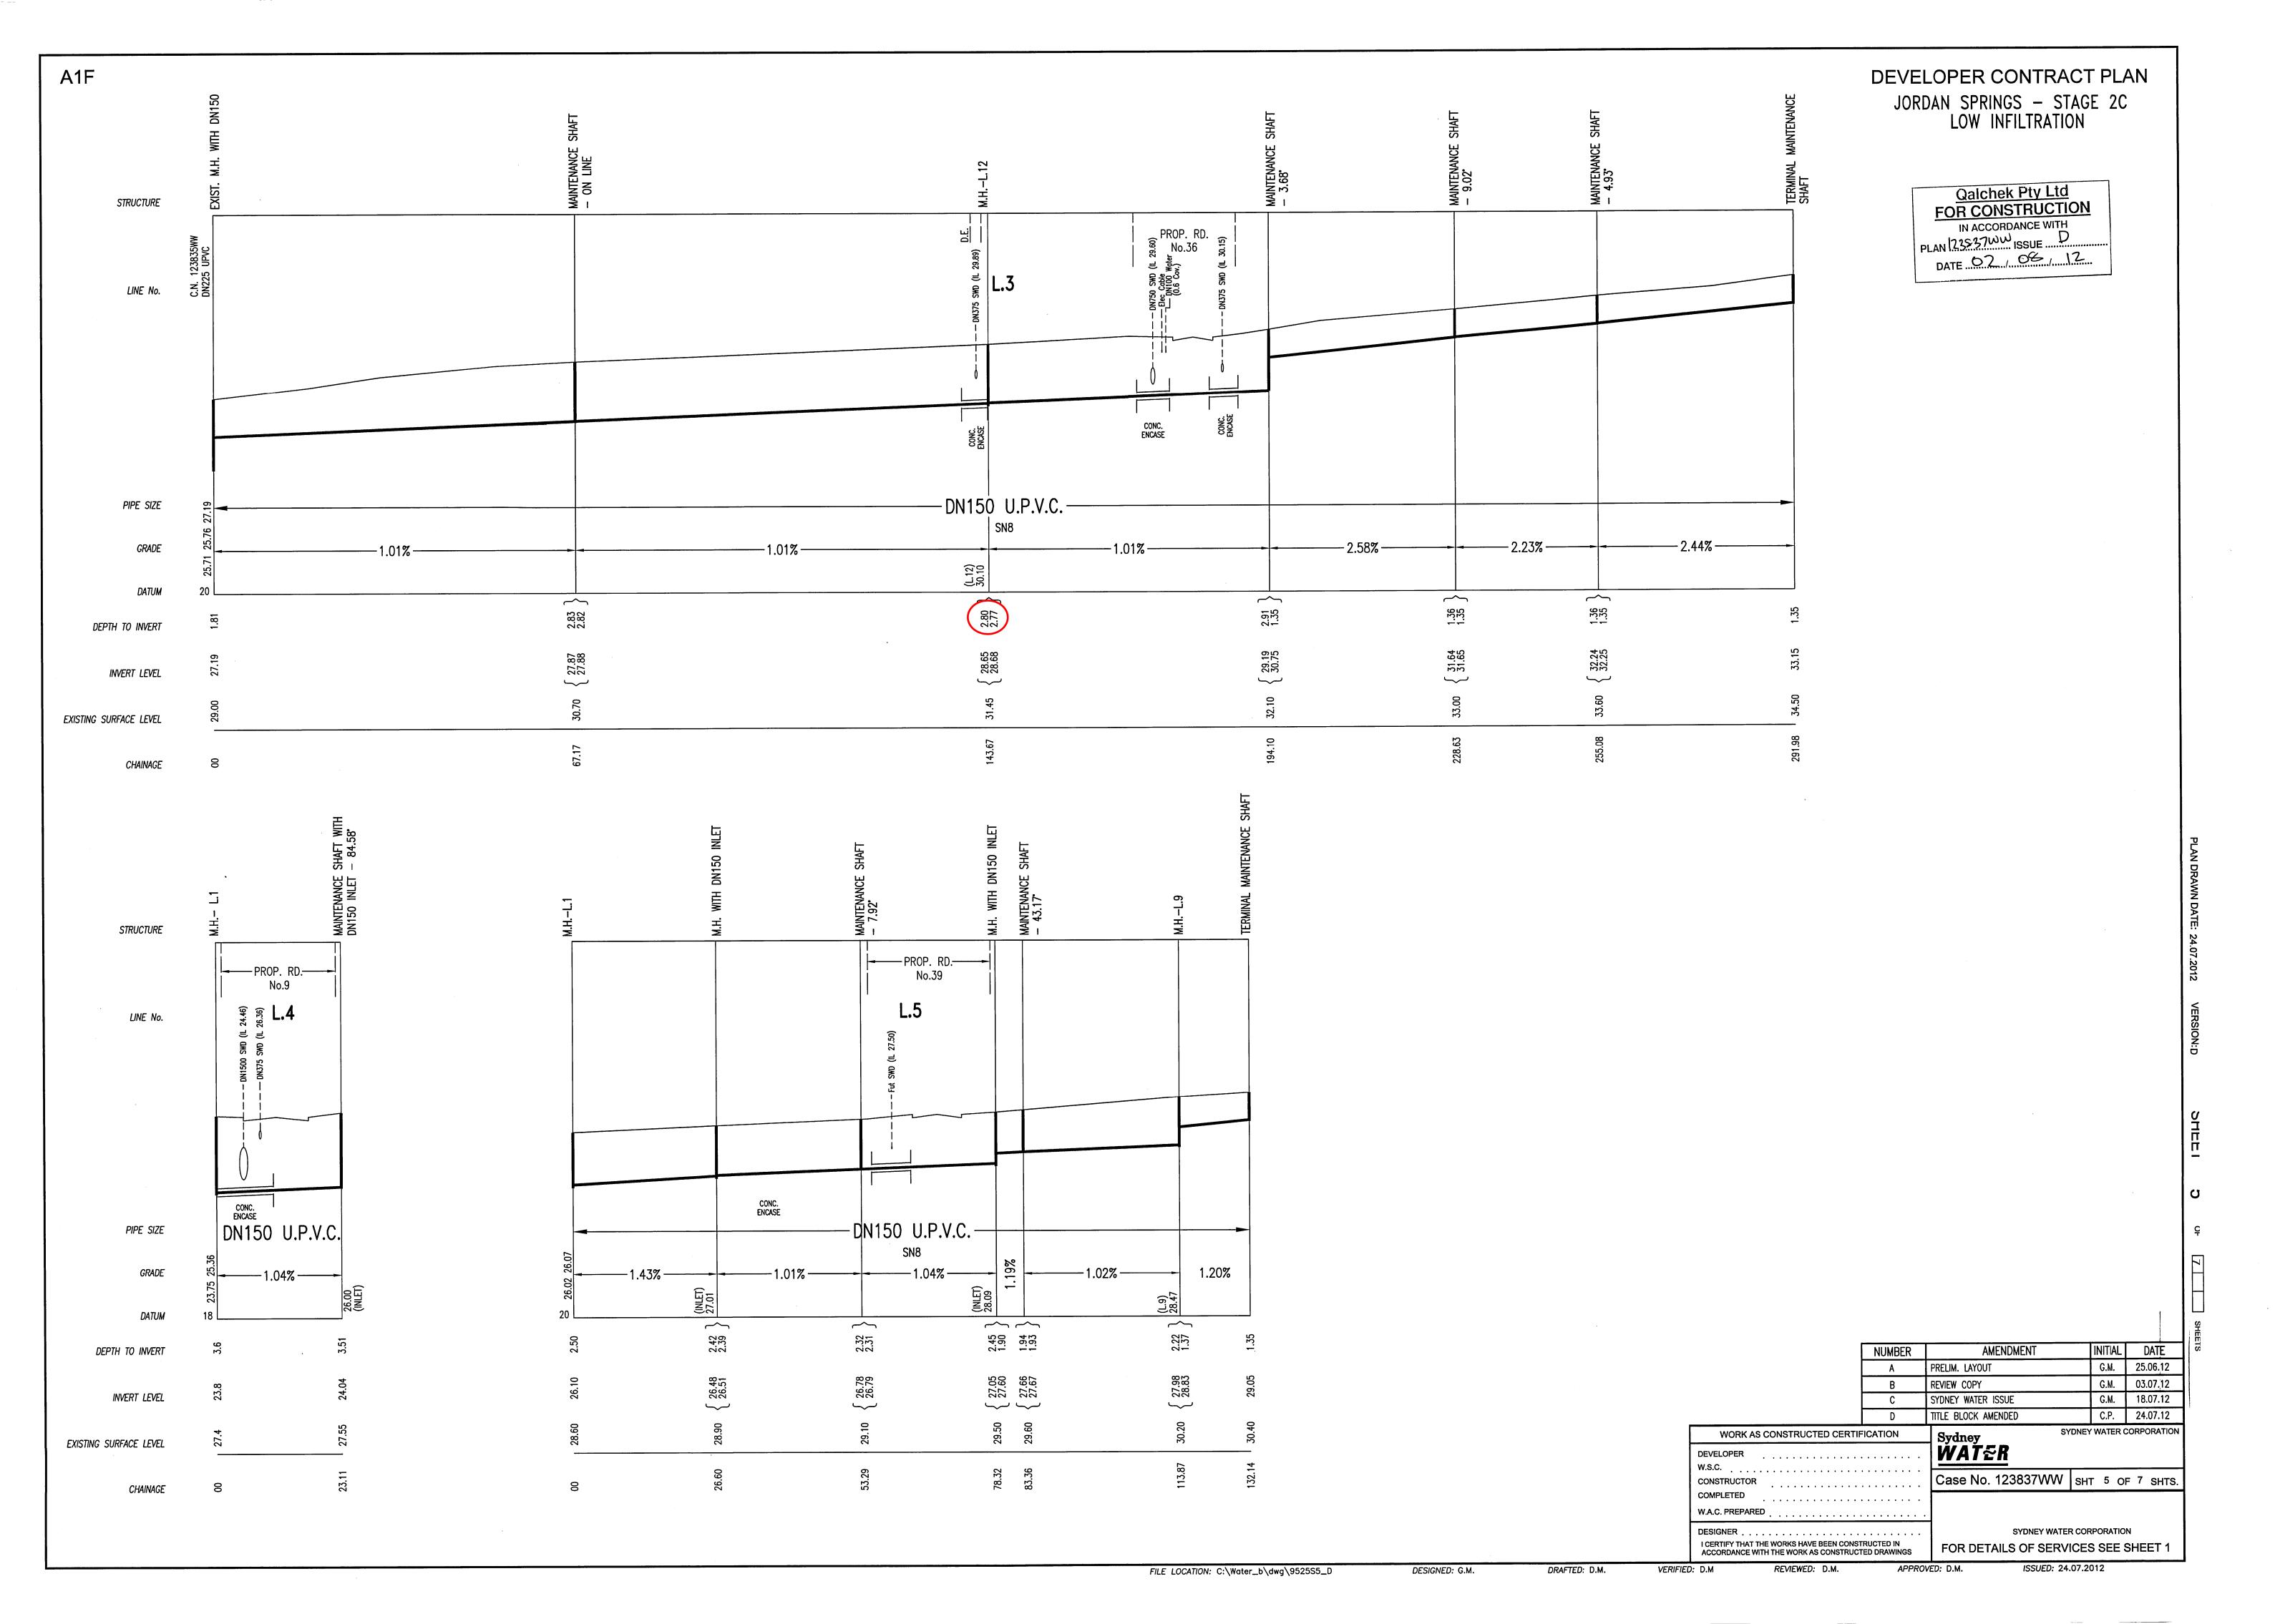

A1F STRUCTURE **L.6** LINE No. -DN150 U.P.V.C.-PIPE SIZE SN8 GRADE 1.28% - 2.95% -1.36 **∼ ∼** 1.36 1.35 1.35 1.36 DEPTH TO INVERT  $\left\{\begin{array}{c} 31.14\\ 31.15\\ 31.24\\ 31.25 \end{array}\right.$  $\left\{ \begin{array}{c} 30.09\\ 30.10 \end{array} \right.$  $\left\{\begin{array}{c} 30.24 \\ 30.25 \end{array}\right.$ INVERT LEVEL EXISTING SURFACE LEVEL 121.88 CHAINAGE STRUCTURE STRUCTURE LINE No. DN150 U.P.V.C. PIPE SIZE −DN150 U.P.V.C.-PIPE SIZE GRADE DEPTH TO INVERT INVERT LEVEL EXISTING SURFACE LEVEL EXISTING SURFACE LEVEL CHAINAGE

DEVELOPER CONTRACT PLAN

LOW INFILTRATION JORDAN SPRINGS - STAGE 2C

Qalchek Pty Ltd
FOR CONSTRUCTION
IN ACCORDANCE WITH
PLAN 123837 WW ISSUE
DATE 52 58 12

D	TITLE BLOCK AMENDED	C.P.	24.07.12
	STUNET WATER 1930E	G.M.	10.07.12
	SYDNEY WATER ISSUE	GM	18.07.12
В	REVIEW COPY	G.M.	03.07.12
Α	PRELIM. LAYOUT	G.M.	25.06.12
NUMBER	AMENDMENT	INITIAL	DATE
-	NUMBER A B	A PRELIM. LAYOUT B REVIEW COPY	A PRELIM. LAYOUT G.M. B REVIEW COPY G.M.

WORK AS CONSTRUCTED CERTIFICATION

DEVELOPER
W.S.C.
CONSTRUCTOR
COMPLETED
W.A.C. PREPARED

DESIGNER
I CERTIFY THAT THE WORKS HAVE BEEN CONSTRUCTED IN

<u>WATER</u>

Case No. 123837WW SHT 6 OF 7 SHTS.

SYDNEY WATER CORPORATION
FOR DETAILS OF SERVICES SEE SHEET 1

FILE LOCATION: C:\Water\_b\dwg\9525S6\_D

DRAFTED: D.M.

DESIGNED: G.M.

VERIFIED: D.M

REVIEWED: D.M.

ACCORDANCE WITH THE WORK AS CONSTRUCTED DRAWINGS

APPROVED: D.M.

ISSUED: 24.07.2012

