
# Westfield Penrith

# Riley Street Upgrade

# **Drawing Schedule**

Drawing Number	Drawing Title	Scale
000	Landscape Coversheet	N/A
101	Landscape Plan	1:100
102	Landscape Plan	1:100
501	Landscape Details	As Shown
502	Landscape Specification and Plant Schedule	

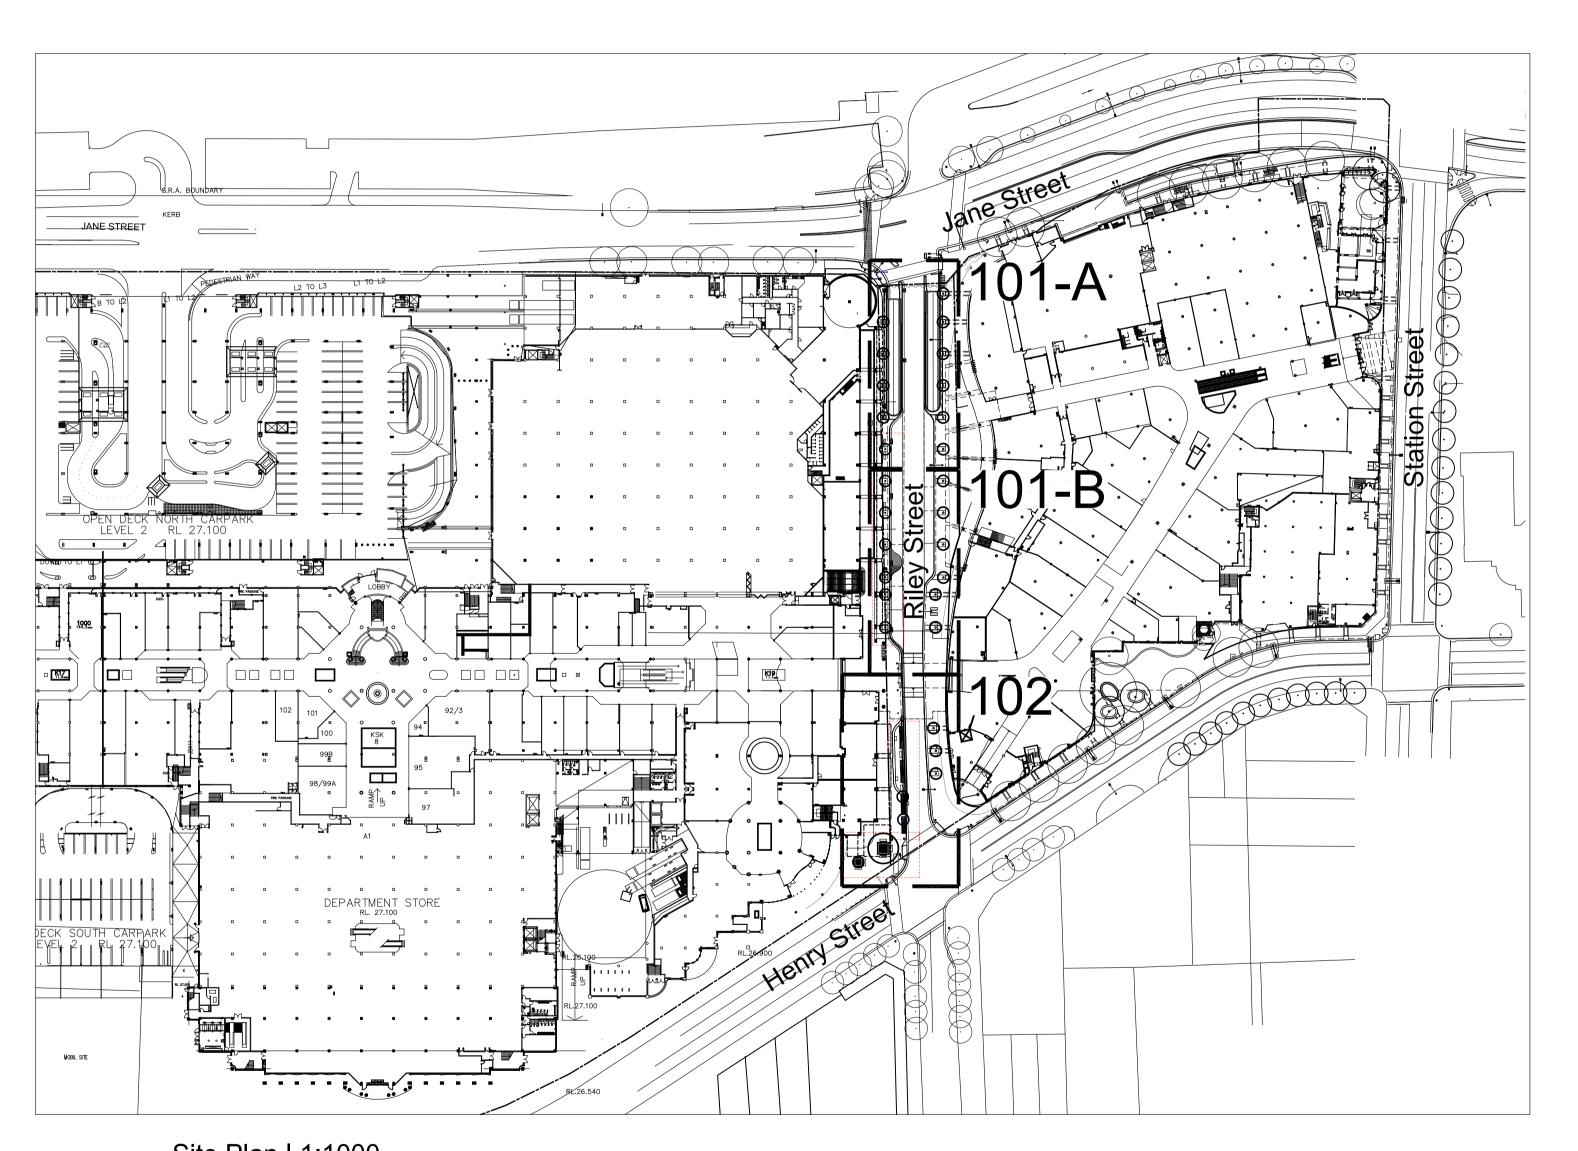

Site Plan | 1:1000


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I	Minor Amendments	LM	NM	27.04.2017
Н	Revised For Comments	JW	NM	19.04.2017
G	For Costing	JD	NM	27.06.2016
F	Revised for Comments	JW	NM	04.05.2016
E	New Architectural Base	JW	NM	29.04.2016
D	Tender	JD	NM	19.11.2015
С	Architectural coordination	JD	NM	17.11.2015
В	Revised Planting	JD	NM	02.11.2015
Α	Preliminary	JD	NM	09.10.2015
ssue	Revision Description	Drawn	Check	Date

## LEGEND

Key Plan:



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Westfield Penrith Riley Street Upgrade
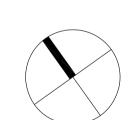
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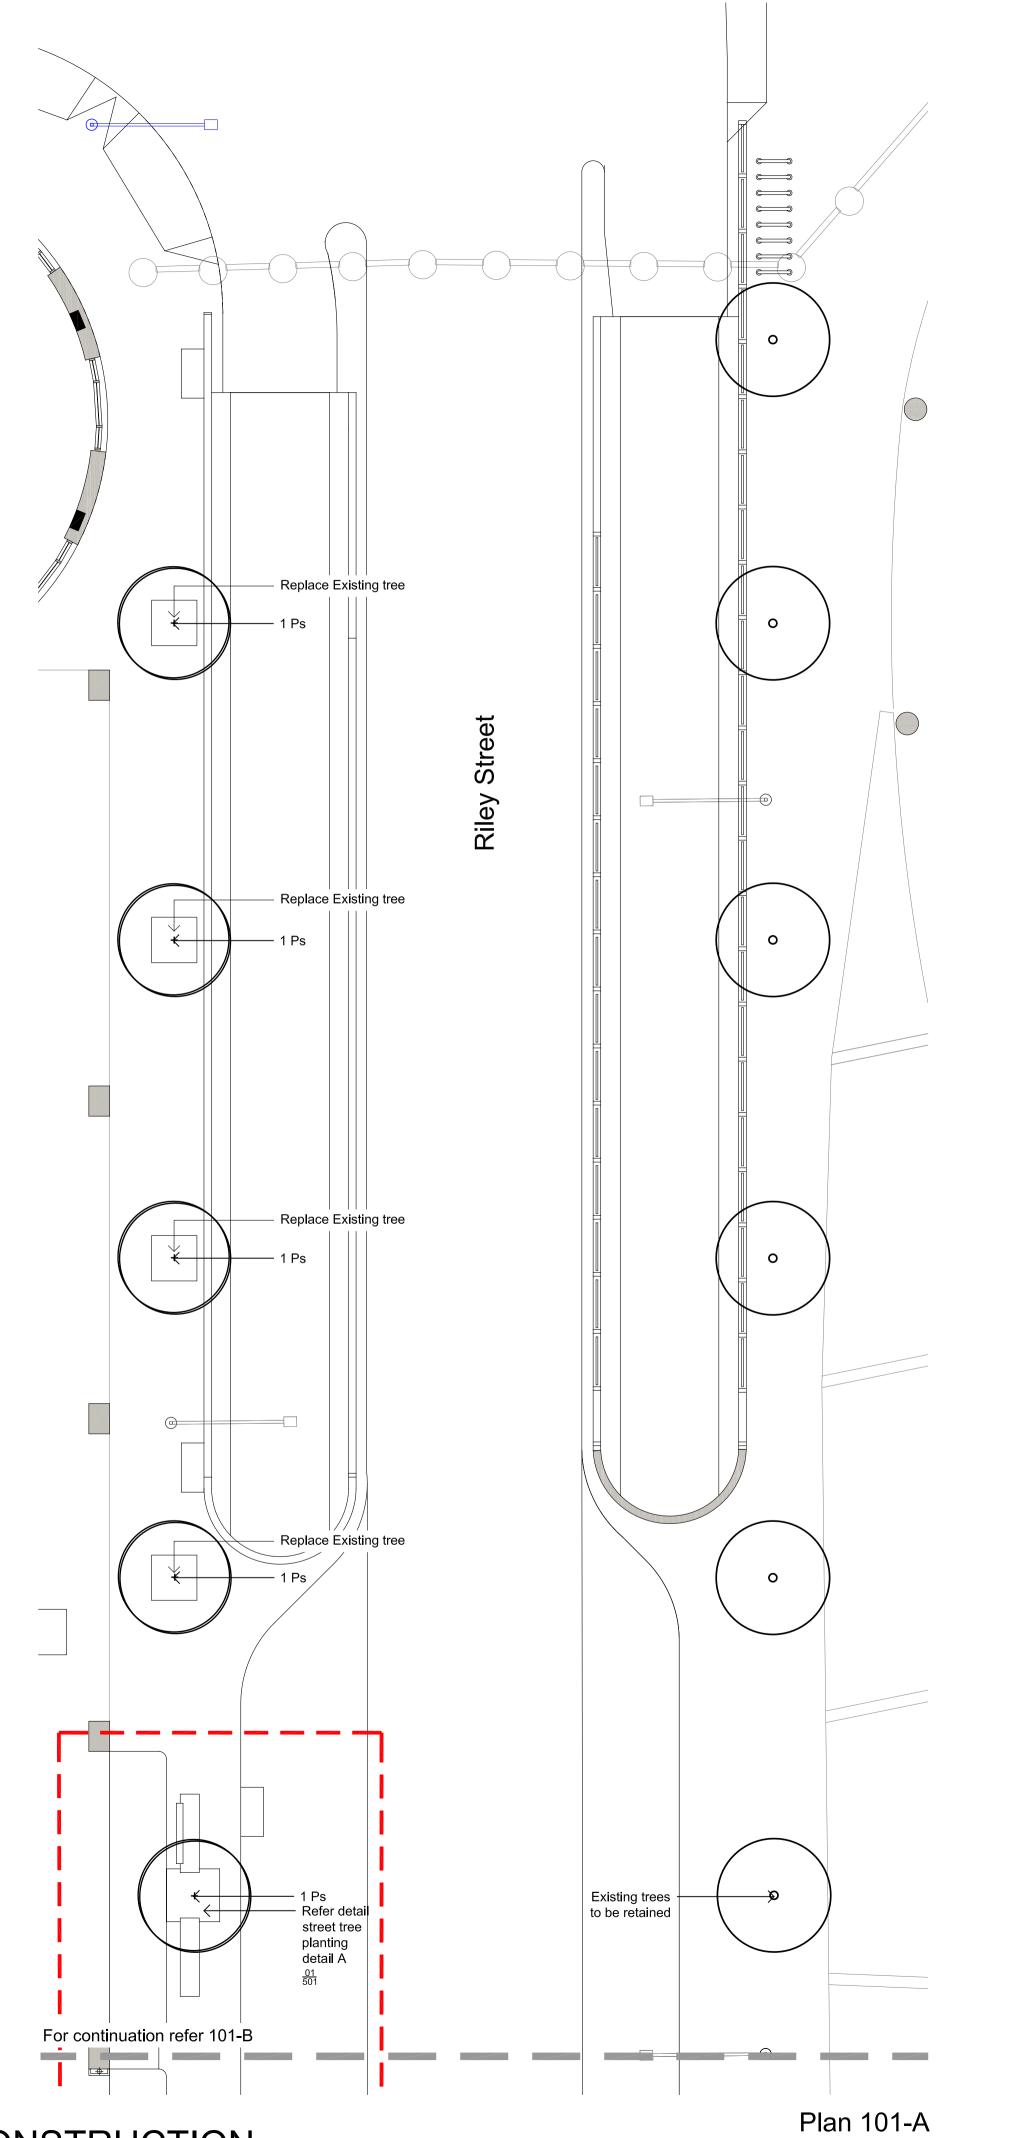
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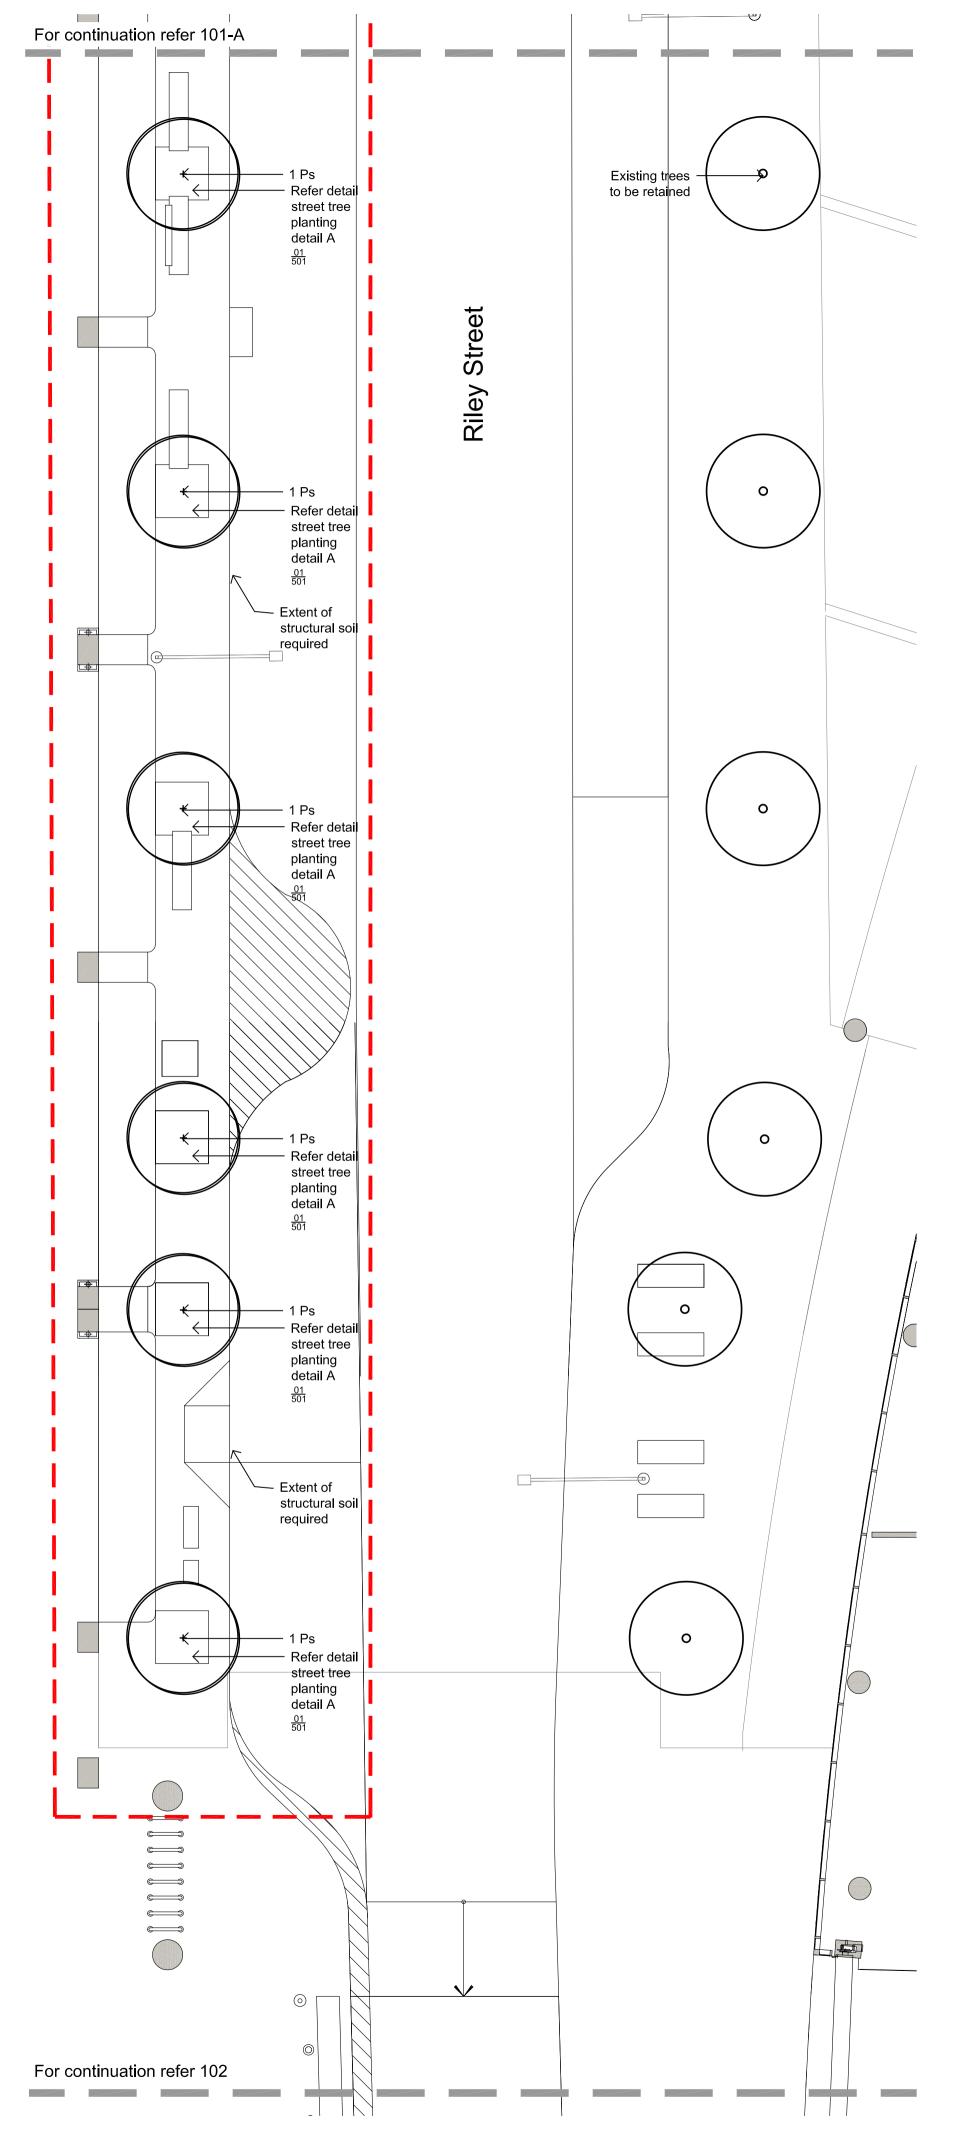
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Landscape Cover Sheet

SS15-3103

000 I





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LM NM 27.04.2017 I Minor Amendments H Revised For Comments JW NM 19.04.2017 JD NM 27.06.2016 G For Costing JW NM 04.05.2016 Revised for Comments New Architectural Base JW NM 29.04.2016 JD NM 19.11.2015 JD NM 17.11.2015 Architectural coordination Revised Planting JD NM 02.11.2015 A Preliminary JD NM 09.10.2015 Issue Revision Description Drawn Check Date

# LEGEND

Scope of Works Existing Tree to be retained
Refer to plant schedule

Proposed Tree
Refer to plant schedule

Proposed Shrub Refer to plant schedule

Proposed Massed Grasses and Groundcovers
Refer to plant schedule

Key Plan:



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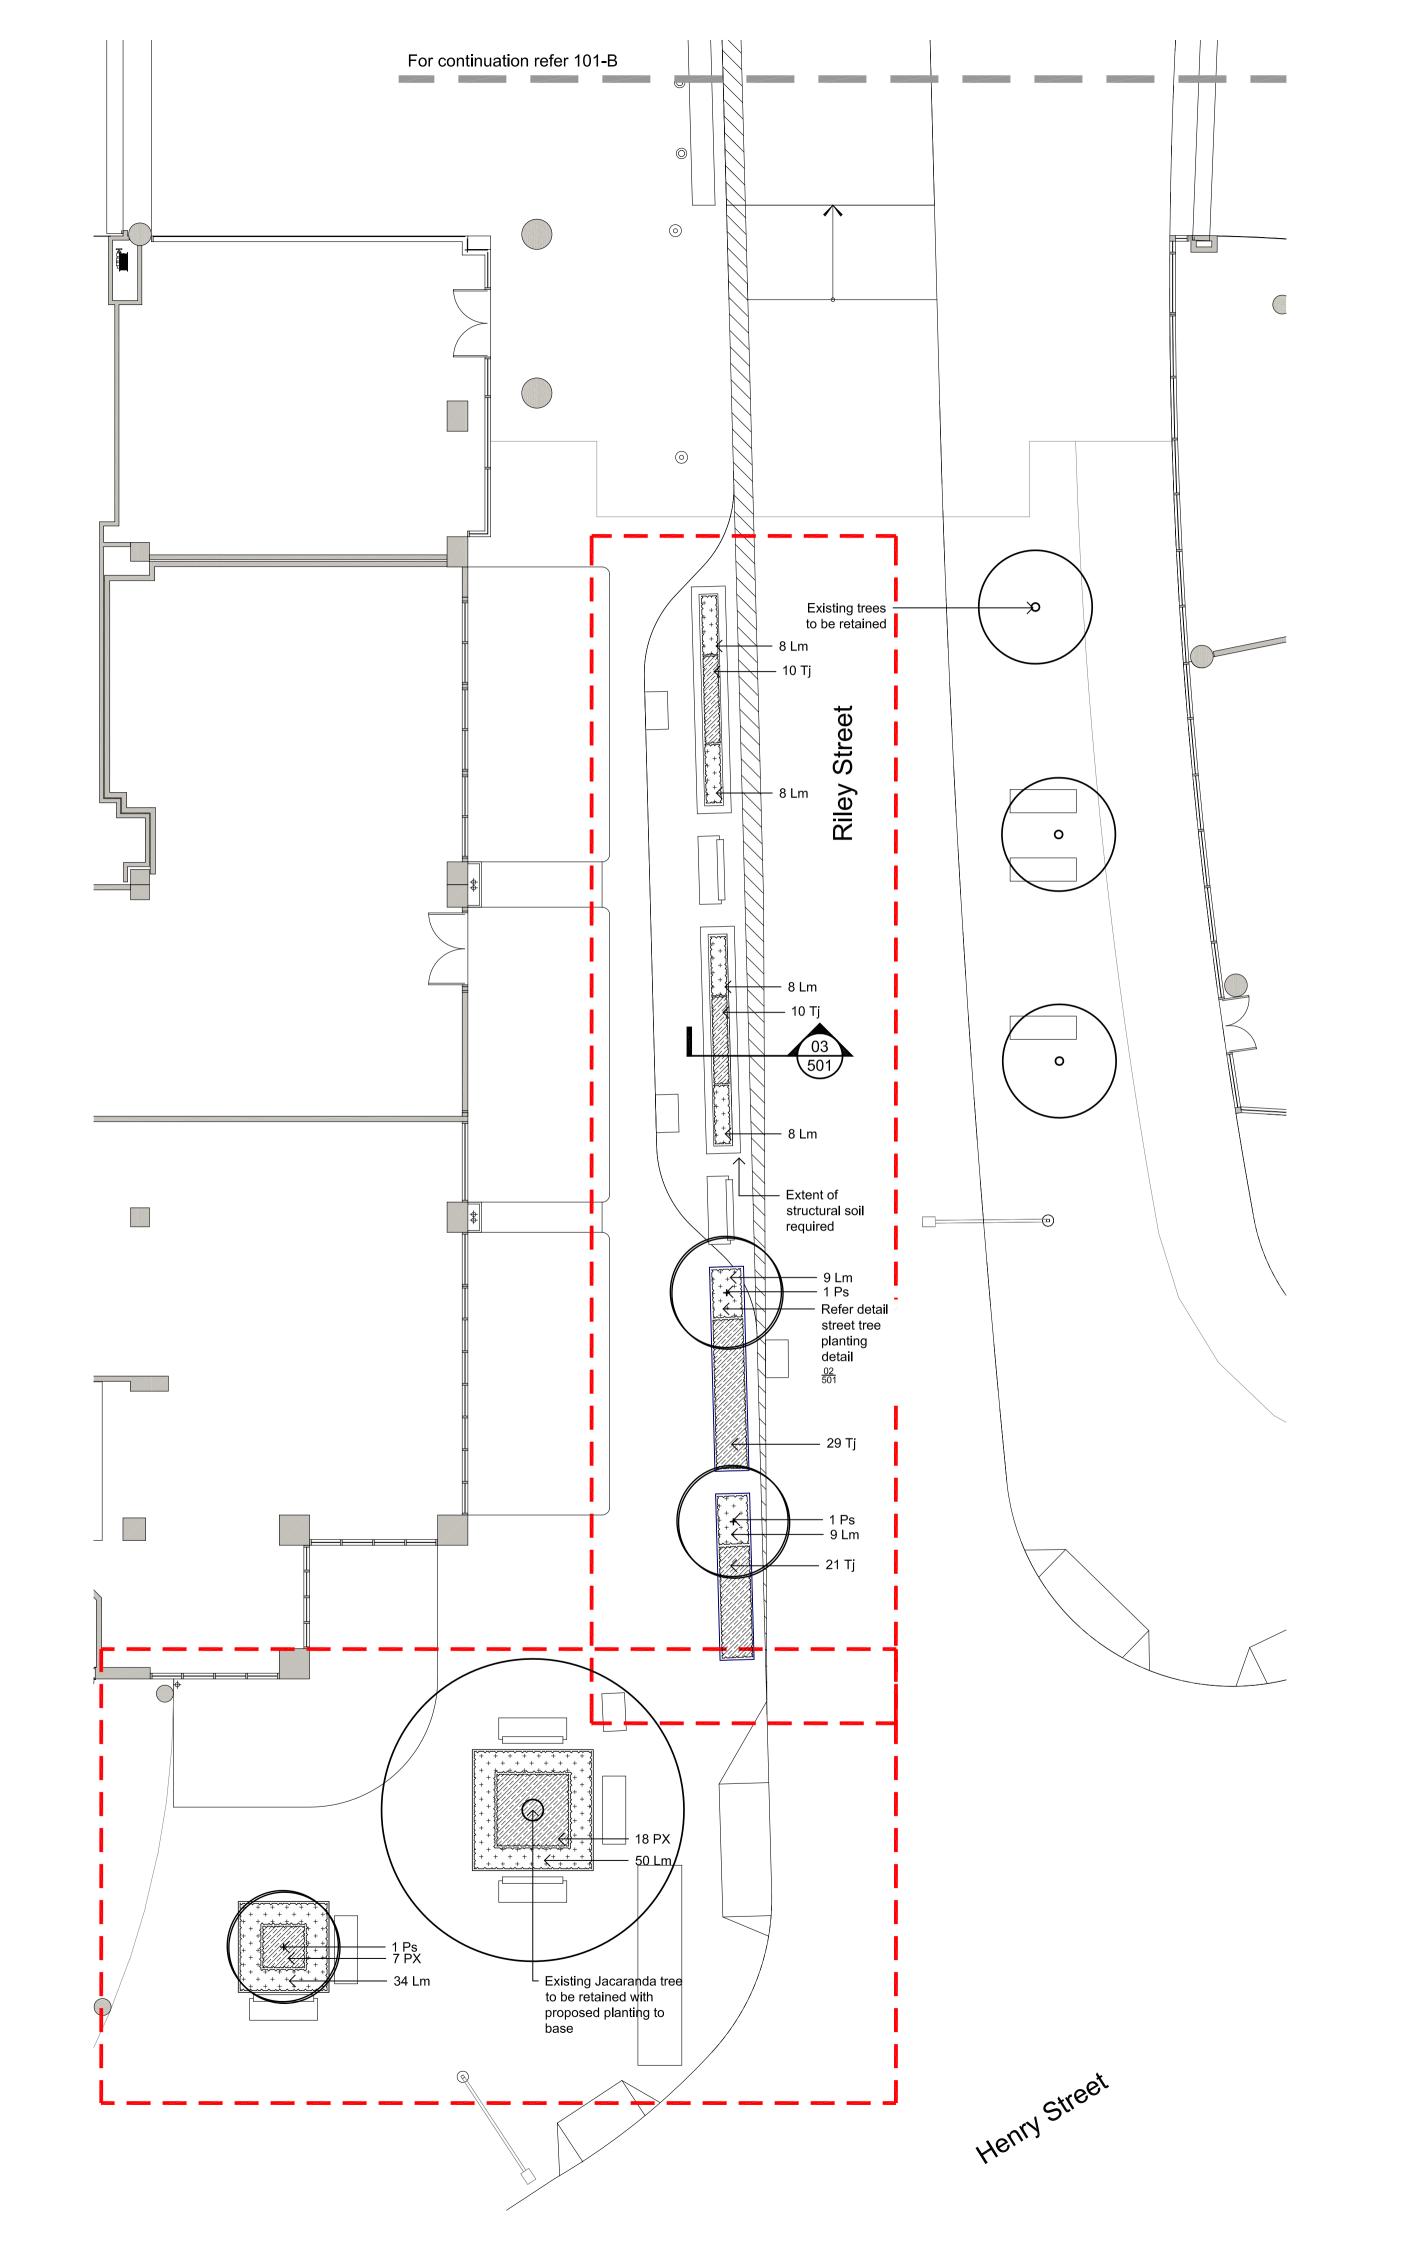
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Scale: 1:100 @ A1

101 I

Plan 101-B

SS15-3103



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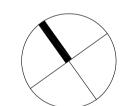
# LEGEND

Scope of Works Existing Tree to be retained
Refer to plant schedule Proposed Tree
Refer to plant schedule

Proposed Shrub
Refer to plant schedule

Proposed Massed Grasses and Groundcovers
Refer to plant schedule

Key Plan:



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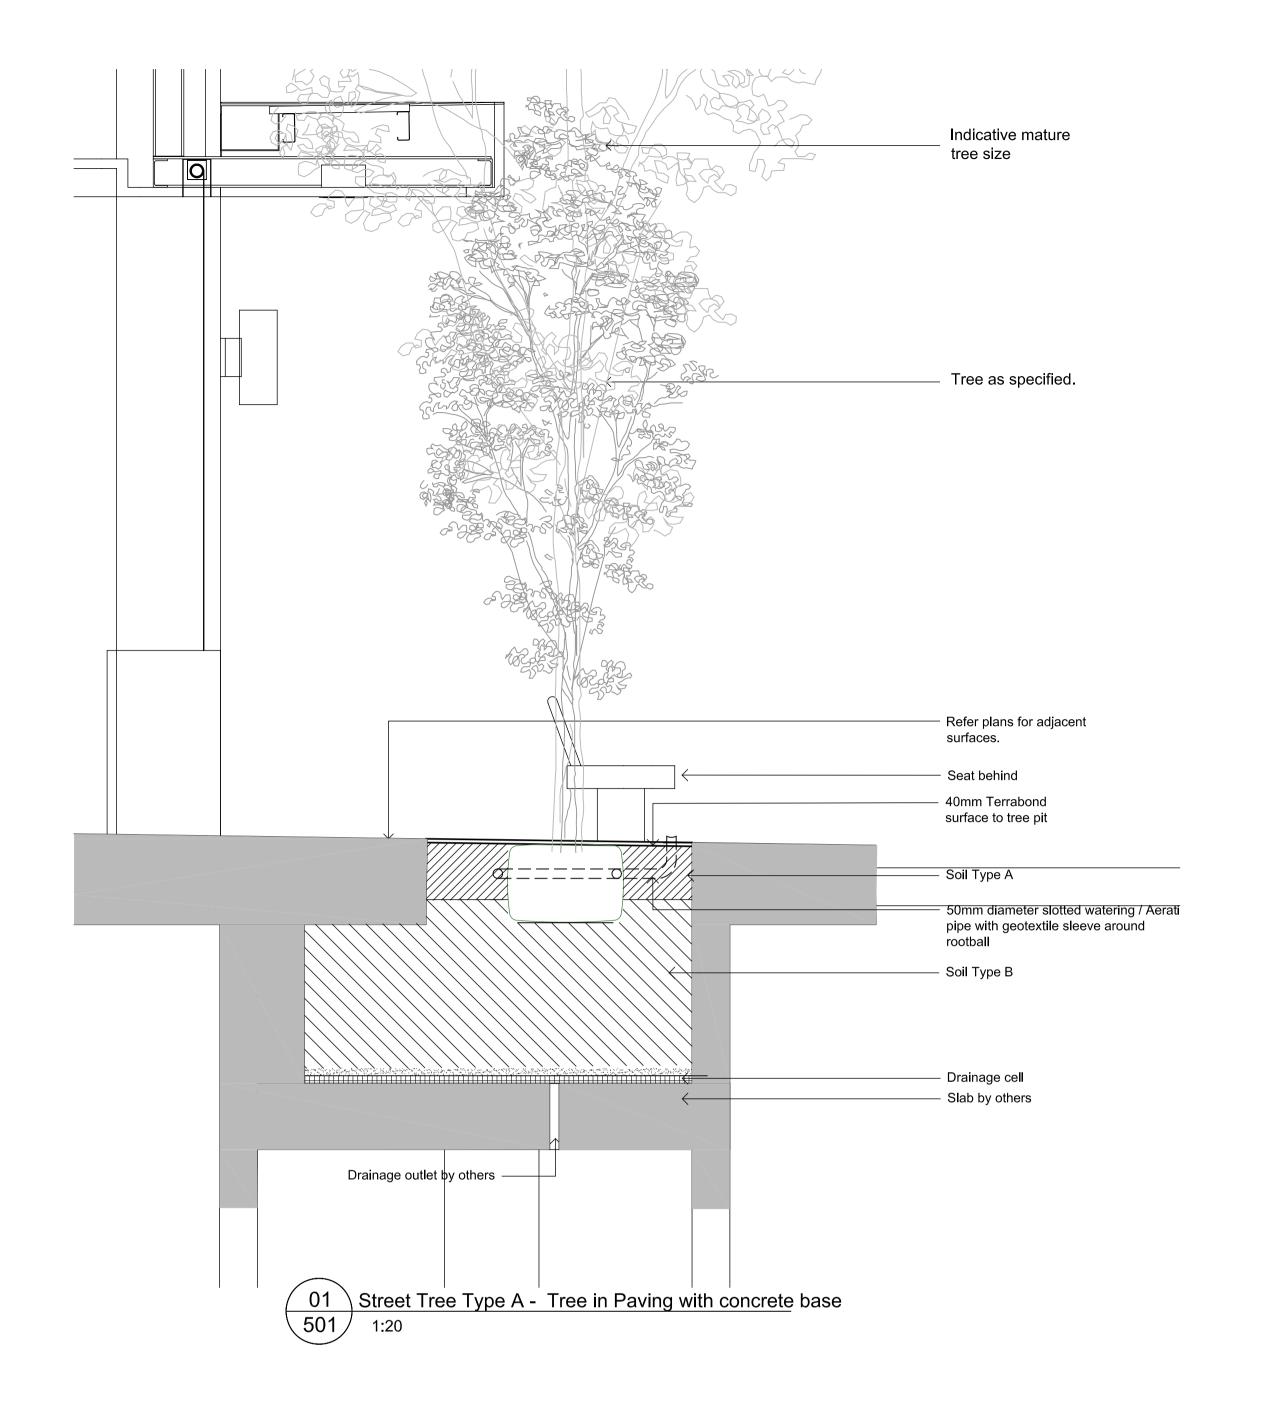
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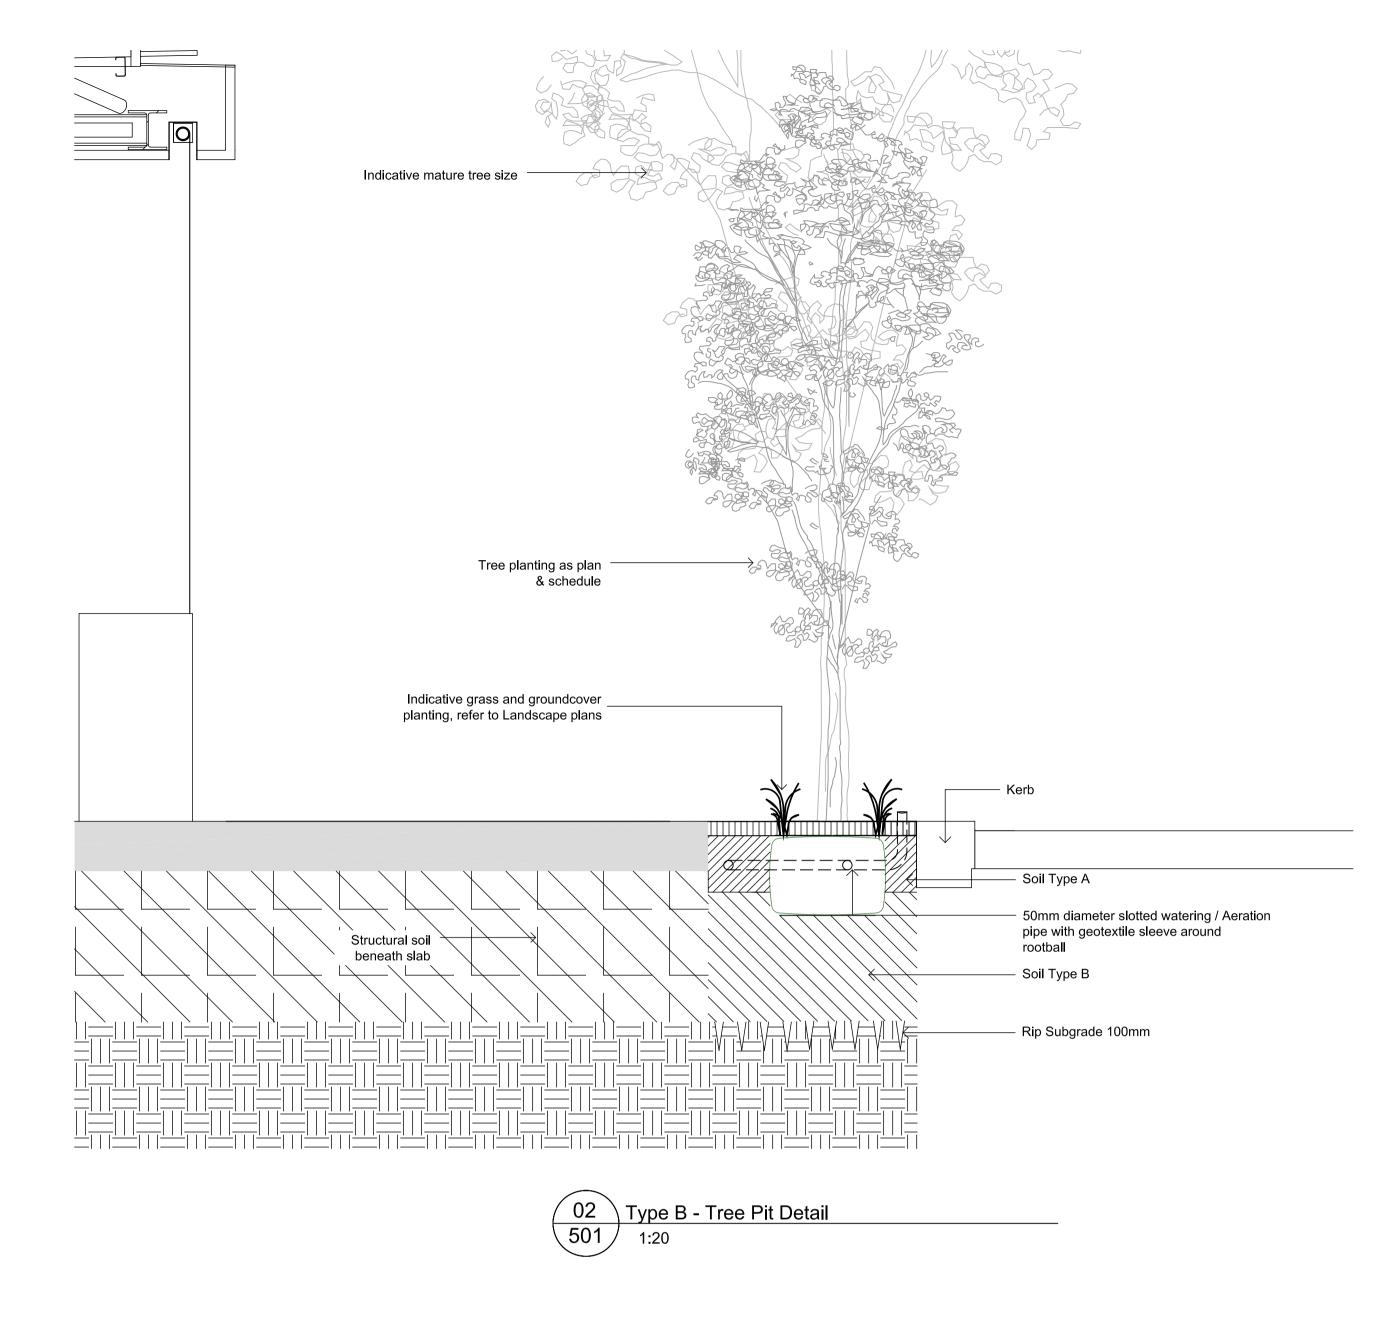
Landscape Plan


Scale: 1:100 @ A1

SS15-3103

102 J





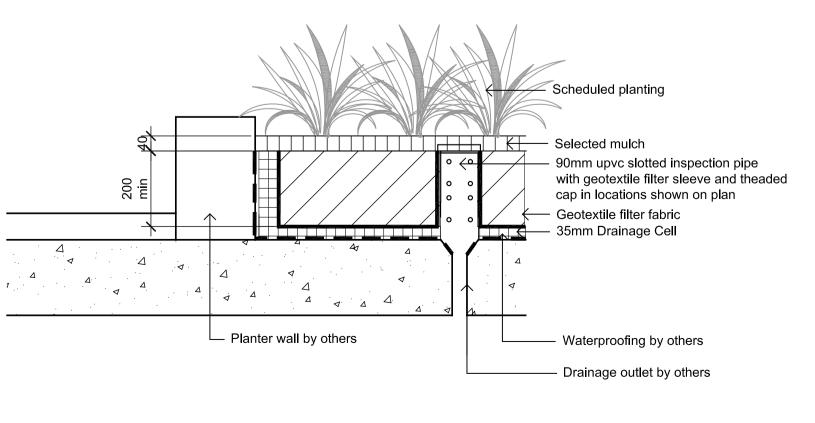

Typical Raised planter bed on slab 501 1:10

Shrub, accent & groundcover planting refer plan & schedule Mulch as specified Refer specification Soil mix type A Soil mix type B Rip subgrade to 100m

DETAIL - SHRUB, ACCENT & GROUNDCOVER PLANTING ON GRADE

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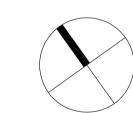
Minor Amendments LM NM 27.04.2017 Amended Details Revised For Comments JW NM 19.04.2017 JD NM 27.06.2016 For Costing Revised for Comments JW NM 04.05.2016 New Architectural Base JD NM 17.11.2015 Architectural coordination Revised Planting JD NM 02.11.2015 JD NM 09.10.2015 A Preliminary

Drawn Check Date

LEGEND

Issue Revision Description

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# **CONSTRUCTION CERTIFICATE**

Drawing Name: Landscape Details

Scale: As shown

SS15-3103

501 J

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#### **GENERAL NOTES**

All plans and details included in the project documents shall be read in conjunction with this specification. All structural and civil works components of the landscape design shall be referenced to engineers' details and specifications. Read this specification in conjunction with the plant and materials schedule on this drawing. If in doubt about any detail or if conflicts are found in the documents, seek advice.

### Workmanship and Materials

The whole of the landscape works shall be carried out by a competent, trained and qualified landscape contractor who is experienced in horticultural practices, landscape construction and planting techniques. The landscape contractor shall hold a current Building Contractors License and/or be a financial member of LNA Landscape Association NSW & ACT or equivalent organisations in other states.

#### **EXISTING TREES**

#### Trees to be Retained and Protected

Identify and mark trees and shrubs to be retained using a suitable non-injurious, easily visible and removable means of identification. Protect from damage the trees and shrubs to be retained, including those beyond the site area, both above and below the ground. If a tree becomes damaged during the works or it is proposed to perform work on a tree, give written notice immediately and obtain

#### Work near Trees

Keep the area of the drip-line free from construction material and debris. Do not place bulk materials and harmful materials under or near trees. Do not place spoil from excavations against tree trunks. Prevent wind-blown materials such as cement from harming trees and plants. Do not remove topsoil from, or add topsoil to, the area within the drip-line of trees.

#### **EARTHWORKS**

#### Excavation, Trimming and Filling

Except as otherwise note in the contract, bulk excavation is excluded from the landscape works. Trim and fill the excavated ground surfaces to achieve design levels to accommodate finish materials as detailed. Compact the finished surface as required for the finished ground treatment.

### Sub-soil Drainage

Keep the excavated works drained and free of standing water. Allow to supply and install sub-soil drainage pipes as required for the new works to ensure that all gardens are well drained. Connect the sub-soil drainage pipes to the nearest downstream stormwater pits. Include pipe filter socks.

#### **SOFTWORKS**

# Soil Testing

Undertake at least two (2) soil tests, in locations as advised by Project Manager, and provide results and recommendations for the improvement of plant growth and to adjust the soil to achieve appropriate planting medium (including pit levels) for successful plant growth.

Excavate all garden beds to bring the subsoil to at least 300mm below finished design levels. Shape the subsoil to fall to subsoil drains where applicable. Do not excavate within the drip line of trees to be retained. Excavate all turf areas to bring the subsoil to at least 100mm below finished design levels. Shape the subsoil to fall to subsoil drains where applicable. Do not excavate within the drip line of trees to be retained. Cultivate the subsoil to a further depth of 100mm. Remove stones exceeding 25mm, clods of earth exceeding 50mm, and weeds, rubbish or other deleterious material brought to the surface during cultivation. Do not disturb services or tree roots, if necessary cultivate these areas by hand. During cultivation, thoroughly mix in materials required to be incorporated into the subsoil, as recommended in the soil testing results and to manufacturer's recommendations. Trim the surface to design levels after cultivation.

- Import topsoil for the garden and turf areas, unless the topsoil can be provided from material recovered from the site, as recommended in the soil testing results. Spread the topsoil on the prepared subsoil and grade evenly, compact lightly and uniformly in 150mm layers. Avoid differential subsidence and excess compaction and produce a finished topsoil surface which has the following
- Finished to design levels, allowing for mulch or turf, which is to finish flush with adjoining hard surfaces such as paths and edge;
- Smooth and free from stones or lumps of soil;
- Graded to drain freely, without ponding, to catchment points; Graded evenly to adjoining surfaces; and Ready for planting.

Soil Type A: 7 parts sandy loam, 3 parts peat moss, PH range 5.5-7.0, salt content 1% max. This is equal to Benedict 70% screened topsoil no.2 / 30%

Soil Type B: 8 parts sandy loam, 2 parts course river sand, PH range 5.5-7.0,

# Structural Soil

Benedict Sand and Gravel Smart Mix 3 (84% nominal 40mm quarried basalt aggregate to 16% filler soil consisting of a screened blend of Virgin Menangle Sandy Loam & a unique Virgin Clay).

salt content 1% max. This is equal to Benedict 80:20 sand soil mix.

Provide, in accordance with AS 4454, well rotted vegetative material or animal manure, free from harmful chemicals, grass and weed growth.

# Fertiliser

Provide proprietary fertilisers, delivered to the site in sealed bags marked to show manufacturer or vendor, weight, fertiliser type, N:P:K ratio, recommended uses and application rates.

- Supply plants in accordance with the landscape drawings and schedules, which have the following characteristics:
- Large healthy root systems, with no evidence of root curl, restriction or
- Vigorous, well established, free from disease and pests, of good form consistent with the species or variety;
- Hardened off, not soft or forced, and suitable for planting in the natural climatic conditions prevailing at the site, and in particular shade conditions;
- Grown in final containers for not less than twelve weeks; • Trees, unless required to be multi-stemmed, shall have a single leading shoot;
- Containers shall be free from weeds and of appropriate size in relation to their

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## container. Plant Installation

## Following excavation of the planting hole place and spread 15gms of wetting agent pre-mixed with one (1) litre of water. Place the plant correctly orientated to north or for best presentation. Backfill the planting holes with specified topsoil mixture. Lightly tamp and water to eliminate air pockets. Ensure the topsoil is not

placed over the top of the rootball. Keep the plant stem at the same height above the ground as it was above the soil in the container. Apply fertiliser, as recommended in the soil testing results or in accordance with the manufacturer's recommendations around the plants in the soil at the time of planting.

## **Root Barrier**

Supply and install root control barriers to all new tree plantings adjacent to walls, paths and all trunk service trenches, where their proximity poses a threat to the stability of the infrastructure. Install in accordance with manufacturer's

Mulch shall be approved recycled wood fibre or pine bark mulch. Place mulch in all garden beds to a depth of 75mm, after all specified plants are installed. Keep mulch clear of all plant stems and rake to an even surface flush with the surrounding surfaces evenly graded between design surface levels. Over fill to allow mulch to settle to the specified depth.

## Stakes and Ties

Stakes shall be durable hardwood, straight, free of knots and twists, pointed at one end, in the following quantities and sizes for each of the various plant pot

- Plants (>25 lt): 1 off 38 x 38 x 1200mm; Semi-advanced plants (>75 lt): 2 off 50x50x 1800mm; • Advanced (≥100 lt): 3 off 50 x 50 x 2400mm.
- IRRIGATION

The irrigation system shall be an automatic fixed drip system, with an irrigation controller self operated via a soil moisture sensor. The system shall be compatible to the type of plant material and rates of water required. Where appropriate adjustable and fully serviceable. The layout of the entire irrigation is to ensure that each individual plant receives the required amount of water to maintain healthy and vigorous growth. The irrigation system shall be such that, component theft, vandalism, over-spray and wetting of paths shall be reduced to a minimum or completely eliminated by the use of drip, pop-up sprinklers and judiciously placed fixed spray emitters. Do not use fine mist type emitters that provide a drifting mist that may wet paths and the buildings.

#### LANDSCAPE MAINTENANCE

- The Landscape Contractor shall rectify defects during installation and that become apparent in the works under normal use for the duration of the contract Defects Liability Period. The Landscape Contractor shall maintain the contract areas by the implementation of industry accepted horticultural practices for 52 weeks. The landscape maintenance works shall include, but not be limited to, the following:
- Replacing failed plants;
- Pruning;
- Insect and pest control; Fertilising;
- Stakes and ties;
- Maintaining mulch;
- Mowing and top dressing; Irrigation and watering;
- Erosion control; and Weeding and rubbish removal.

# Implement and keep a maintenance log book recording when and what

maintenance work has been undertaken and what materials, actions and decisions have been used, implemented and concluded to keep the landscape always looking its best.

## **Maintenance Activities**

Schedule the following activities to occur on a timely basis.

- Plant replacement Replace plants that have failed to mature, die or are damaged. Replacement plants shall be in a similar size and quality and identical species or variety to the plant that has falled. Replacement of plants shall be at the cost of the landscape contractor unless advised otherwise. If the cause of the failure is due to a controllable situation then correct the situation prior to replacing
- Pruning Prune dead wood, broken limbs, dead or infected foliage and as needed to develop strong, healthy plants to achieve the
- shape and form expected of the plant type.
- Insect and pest control Avoid spraying: if ever possible;
- in wet weather or if wet weather is imminent; if target plants are still wet after rain;
- in windy weather; and
- if non-target species are too close. Immediately report to the Project Manager any evidence of intensive weed infestation, insect attack or disease amongst plant material. Submit all proposals to apply chemicals and obtain approval before starting this work. When approved, spray with herbicide, insecticide, fungicide as appropriate in
- accordance with the manufacturers' recommendations. Record in the logbook all relevant details of spraying activities including:
- Product brand / manufacturer's name, Chemical / product name.
- Chemical contents, Application quantity and rate,
- Date of application and location, Results of application, and
- Use approval authority.
- Fertilising Fertilise gardens with a proprietary slow release fertiliser applied in accordance with the manufacturer's directions and recommendations. Record in the logbook all relevant details of
- fertilising including: Product brand / manufacturer's name,
- Fertiliser / product name, Application quantity and rate, and
- Date of application and location.
- Stakes and ties Adjust and replace as required to ensure plants remain correctly staked. Remove those not required at the end of the planting establishment period (Defects Liability Period). Maintaining mulch - Maintain the surface in a clean, tidy and
- weed free condition and reinstate the mulch as necessary to ensure correct depth as specified. Mowing and top dressing - Mow the turf to maintain a grass height of between 30-50mm. Do not remove more than one third of
- the grass height at any one time. Remove grass clippings from the site after each mowing. Top dress to a maximum of 10mm to fill depressions and hollows in the surface.
- Irrigation and watering Maintain the irrigation system to sure that each individual plant receives the required amount of water to maintain healthy and vigorous growth, adjust and rectify as required. Provide additional watering, if necessary.
- **Erosion control** Where necessary, maintain the erosion control devices in a tidy and weed free condition and reinstate as necessary to ensure control measures are effective where deemed
- Weeding and rubbish removal During the plant establishment period remove by hand, rubbish and weed growth that may occur or re-occur throughout all planted, mulched and paved areas. The contractor shall target weeds that are capable of producing a major infestation of unwanted plants by seed distribution. Whenever possible, time weed removal to precede flowering and seed set.

## PLANT SCHEDULE

Symbol	Botanic Name	Common Name	Spacing	Pot Size	HxW (m)	Height at Delivery	Qty	Notes
TREES								
PS	Populus simonii	Chinese Poplar	As Shown	300L	8 x 3	4-4.5m	10	Narrow columar habit, deciduous
GROUNI	DCOVERS AND GRASSES							
Tj	Trachelospermum jasminoides	Star Jasmine	9/m2	150mm	0.2 x 0.5	200mm	70	
LM	Liriope muscari	Evergreen Giant	9/m2	150mm	0.8 x 0.8	300mm	134	
Px	Philadendron 'Xanadu'	Xanadu	5/m2	300mm	0.5 x 0.5	300mm	25	


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LEGEND

Key Plan:



SCENTRE GROUP

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Job Number:
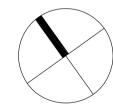
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Drawing Number:

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