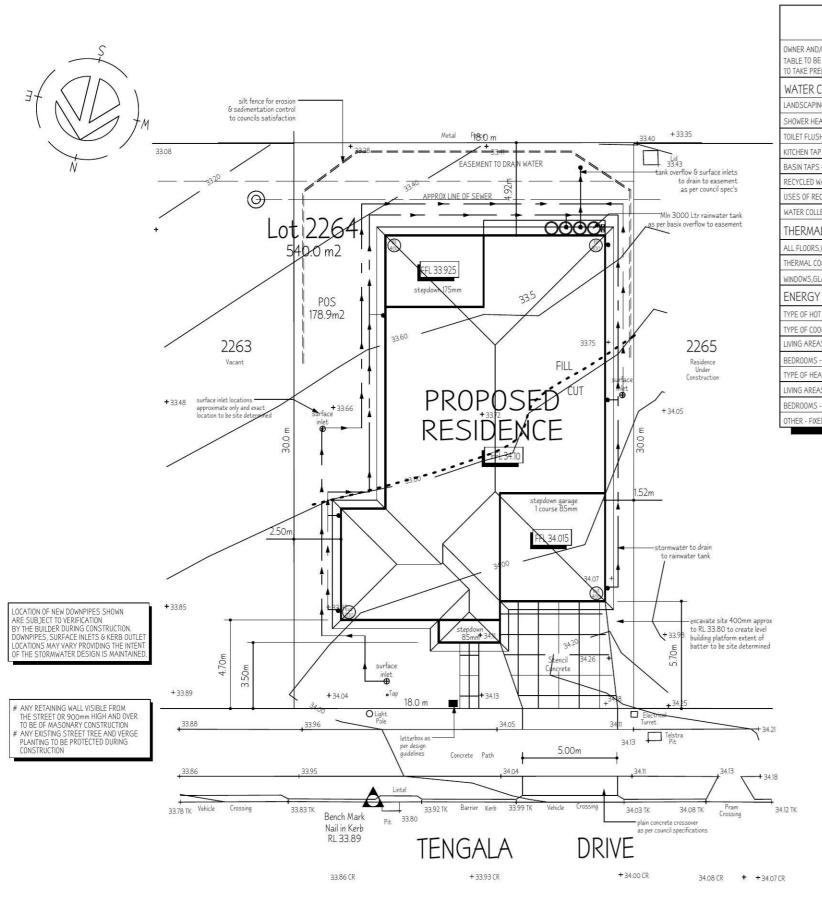


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BASIX COMMITMENTS

DWNER AND/OR BUILDER TO CHECK ALL COMMITMENTS ON THE BASIX CERTIFICATE 'SCHEDULE OF COMMITMENTS'. TABLE TO BE READ IN CONJUSTION WITH SCHEDULE OF COMMITMENTS & SPECIFICATION, SCHEDULE OF COMMITMENTS O TAKE PRECODENCE OVER PLANS AND SPECIFICATION

WATER COMMITMENTS

ANDSCAPING - PLANT INDIGENOUS OR LOW WATER USE SPECIES OF VEGETATION THROUGHOUT 10m2 OF THE SITE

SHOWER HEAD RATING - 3 STAR

TOILET FLUSHING SYSTEM RATING - 4 STAR

KITCHEN TAP RATING - 5 STAR

BASIN TAPS - 3 STAR

RECYCLED WATER - 3000 LITRE RAINWATER TANK

USES OF RECYCLED WATER- ALL TOILETS AND AT LEAST ONE GARDEN TAP

WATER COLLECTION AREA - 285 m2

THERMAL COMMITMENTS

ALL FLOORS, WALLS AND CEILINGS/ROOF OF THE DWELLING MUST BE IN ACCORDANCE WITH THE SPECIFICATIONS LISTED IN THE

THERMAL COMFORT COMMITMENTS TABLE IN THE DWELLINGS BASIX CERTIFICATE.

WINDOWS, GLAZED DOORS AND SHADING DEVICES INSTALLED AS DESCRIBED IN THE WINDOW SCHEDULE AND THE DWELLINGS BASIX CERTIFICATE

ENERGY COMMITMENTS

TYPE OF HOT WATER SYSTEM -GAS INSTATATENOUS 5.5 STAR

TYPE OF COOLING SYSTEM

LIVING AREAS -Single Phase - Min Energy rating: EER < 2.5Single Phase - Min Energy rating: EER < 2.5

TYPE OF HEATING SYSTEMS

Single Phase - Min Energy rating: EER < 2.5 LIVING AREAS

Single Phase - Min Energy rating: EER < 2.5 BEDROOMS -

THER - FIXED OUTDOOR CLOTHESLINE, WELL VENTILATED FRIDGE SPACE, GAS COOKTOP

SITE NOTES

Do not scale of the drawings unless otherwise stated as written dimensions will take preference over scaling


All dimensions and levels are to be checked and verified by the CONTRACTOR on site before the commencement of any works, all dimensions and levels are subject to final survey and set-out. screpancies to be reported to the designer prior to commencement

of any works

- Where Engineers drawings are required such must take
preference over this set of drawings

- Contours have been interpolated from the spot heights taken and are Contours have been interpolated from the spot heights taken and are approximate only.
Finished site levels, banks excavations & filling may vary due to site conditions. Adjustments while complying with council requirements rema at the discretion on the builder.
All boundary clearances are to be verified by survey before any work.
All services to be located and verified by the Builder with the relevant authorities prior to any work commencing.
All work to be carried out in accordance with the Building todge of Australia, all Local and State Government Ordinances, relevant Australian Standards, Electricity and Water Authorities Regulations and all other relevant Authorities.

Drainage area 0.6ha. max. Slope gradient 1:2 max. Slope length 60m max.

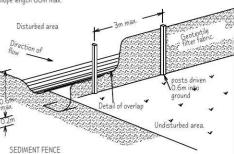

SEDIMENTATION / SITE CONTROL NOTES

SEDIMENTATION / SHE LONGROUND NOTES

All Erosion & Sedimentation control measures, including revegetation
and storage of soil and topsoil shall be implemented to the standards of
the Soil Conservation Of NSW

All Erosion & Sedimentation controls measures to be inspected and

maintained daily. - Roads and Footpaths to be swept and kept clean daily.


Roads and Footpaths to be swept and kept clean daily.
 All disturbed areas to be minimized.
 All stockpiles to be clear of Drains, Gutters & Footpaths.
 Drainage to be connected to Stormwater as soon as possible.
 Filter shall be constructed by stretching a filter fabric (Propex or Approved Equivalent) between post at 3.0m centres.
 Fabric shall be buried 150mm along it's lower edge.
 2.0m high chain mesh fence around tree preservation zones to remain intact until all construction on site is completed



		200					
DEVELOPMENT CALCULATIONS			date 14-02-14	revision PRELIMINARY PLANS			
site area: 540.0m2		B C	15-04-14	DESIGN REVIEW		W	
Itemised Floor Areas:	Totals:	D	D 17-06-14 CONTOUR ADDED				
ground floor :	194.4	PR	PROPOSED NEW RESIDENCE				
first floor :	n/a	client A, M & J FEELEY				ĸ	
sub floor :	n/a						
garage :	32.0	project LOT 2264					
porch:	3.90	TENGALA DRIVE JORDAN SPRINGS					
verandah :	n/a						
alfresco :	19.8	scale drawing title					
rear slab :	5.1	Scale	1:200			SITE PLAN	
total floor area:	255.2 m2	drawn	J.S		design	NEWTOWN 25	
floor space ratio	n/a	Lac	3.5			I	
private open space	178 m2	date		drawing	no.	issue	
landscape area	258 m2	17/0	06/14	1	/6	D.	
site coverage	47%						

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SITE PLAN scale 1:200

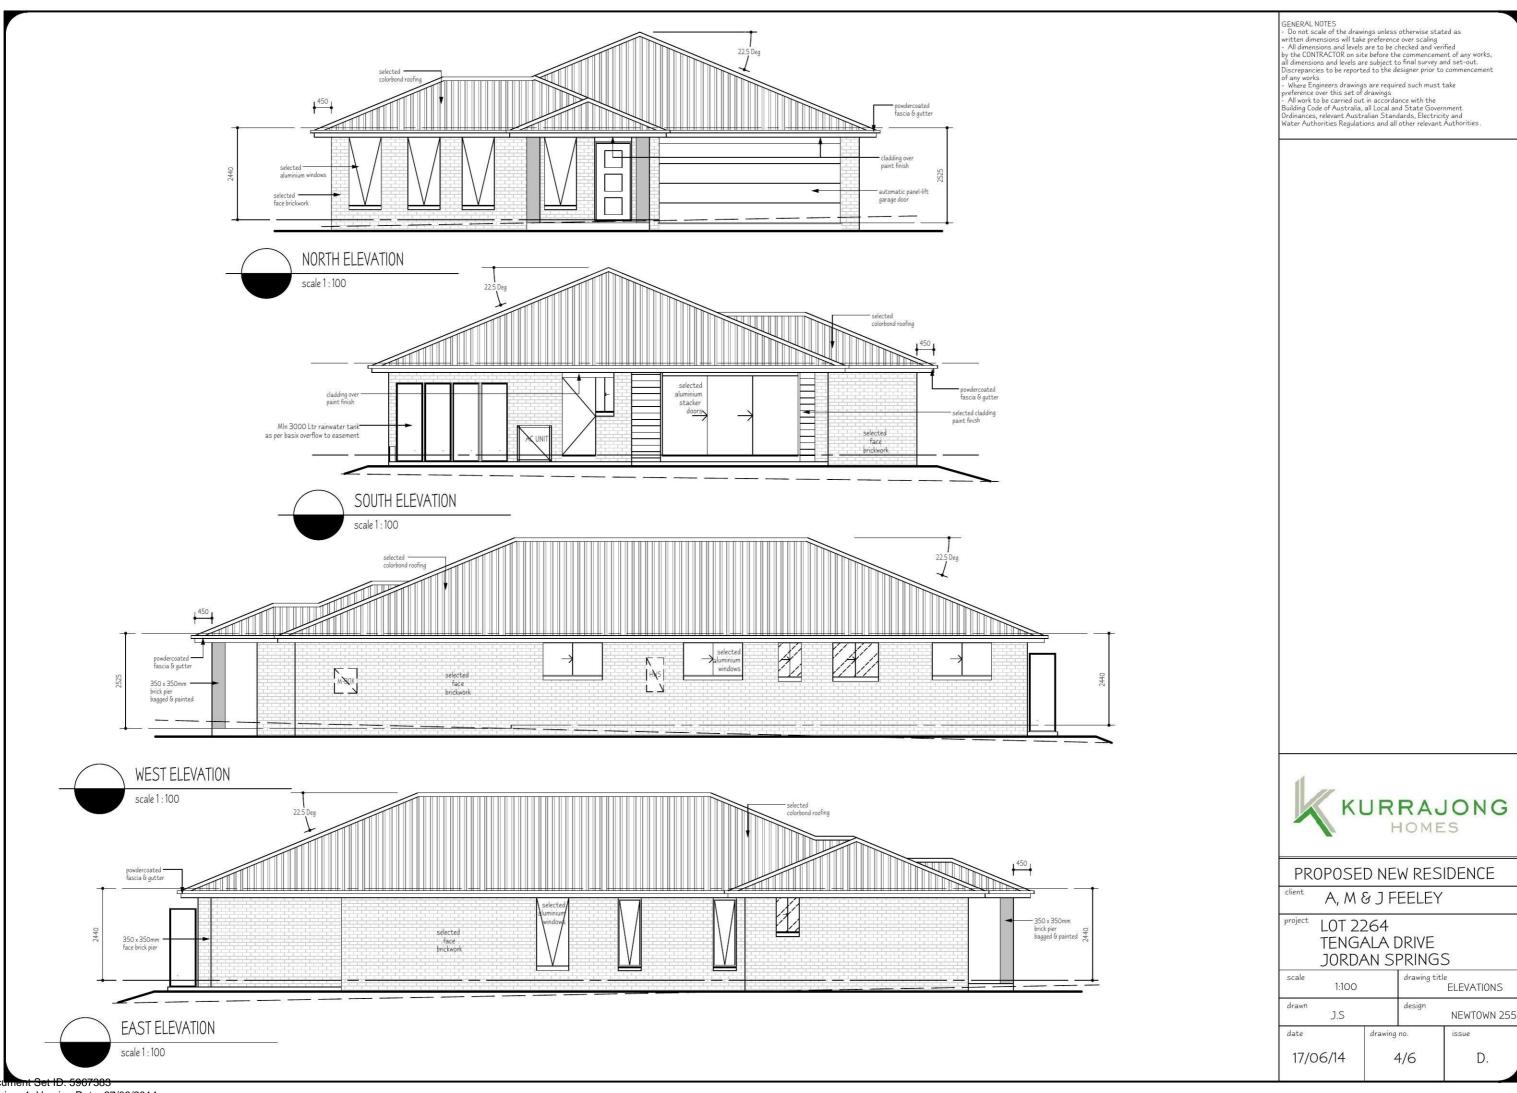

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LEGEND

Excavate / grade all areas to be turfed to 120mm below required finished levels. Do not excavate within 1500mm of the trunk of any existing tree to be retained. Ensure that all surface water runoff is directed towards the inlet pits, kerbs etc.. and away from buildings. Rip the subgrade to 150mm. Install 100mm depth of imported topsoil. Lay turf rolls closely butted. Fill any small gaps with topsoil. Water thoroughly.



Ensure that the mass planting areas have been excavated to 300 below finished levels. Rip to a further depth of 150mm. Supply and install 300mm soil mix.



Garden edging



selected retaining walls






Bins location






1800mm boundary fence as per design guidelines

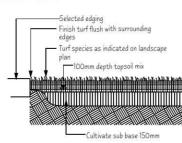

Ground preparation


Grassed area: turf using imported topsoil

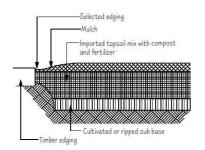


Ground preparation Planting area using imported topsoil


SYMBOL	BOTANICAL NAME	COMMON NAME	QTY	MATURE HEIGHT	MATURE WIDTH	NATIVE
) d	TREES				,,,,,,,,,,,,,,,,,,,,,,,,,,,,,,,,,,,,,,,	
FT	ACER NEGUNDO	FLAMINGO TREE	1	5	4	NO
LST	LEPTOSPERMUM PETERSONII	LEMON SCENTED TEA TREE	1	5	1-2	YES
	SHRUBS					
PH	PHORMIUM TENAX PURPUREA	PURPLE HAZE	6	1.2	0.6	YES
LC	LOMANDRA CONFERTIFOLIA	LITTEL CON	22	0.3	0.3	YES
BG	FESTUCA GLAUCA	BLUE GRASS	4	1.0	0.5	NO
ВМ	OPHIOPOGON PLANISCAPUS	BLACK MONDO	4	1.0	0.5	YES

- ISED
- & CONTRACT FOR CONFIRMATION

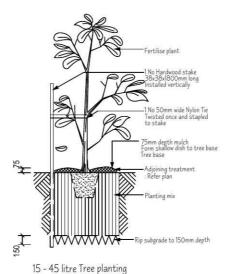

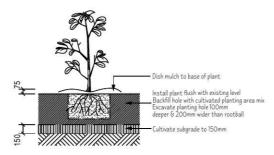

Planting in garden beds

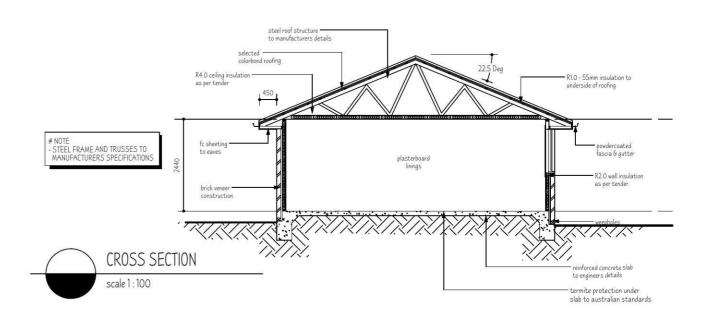

- CONSTRUCTION NOTES

 All work to be carried out in accordance with the Building Code of Australia , all Local and State Government Ordinances, relevant Australian Standards, Electricity and Water Authorities Regulations and all other relevant Authorities concerned .

 All structural work and site drainage to be subject to the Engineers details or certification where required by Council. This shall include r.c. slab and footings, r.c. and steel beams and columns, wind bracing to AS 1170 and AS 4055, anchor rods or bolts, tie downs, fixings etc.. driveway slab and drainage to Council's satisfaction Smoke alarms are to be mains electrical & battery back up as per AS 3786 & AS/NZS 3000:2000

- AS/NZS 3000:2000

 Masonry walls shall be in accordance with AS 3700 Masonry code

 All timber frames in accordance with AS 1684 National Timber Framing Code

 Glazing selected and installed in accordance with AS 1288

 Stair and handrails to comply with AS 1288 & with BCA 3.9.1, 3.9.2.3, 3.9.1.3 & 3.9.1.4.

 Site preparation for Footings, Services, Drainage & Installation of Termite Barriers in accordance with: AS/NZS 3500.3.2 (Storm Water Drainage) & AS 3660.1 (Termite Protection
- of Buildings from Subterranean Termites)

 Waterproofing of wet areas in accordance with AS 3740

- IF SPECIES UNAVAILABLE AT TIME OF PLANTING A
SUITABLE NATIVE OR LOW WATER USE PLANT IS TO BE US
- ITEMS SHOWN ON LANDSCAPE PLAN MAY BE REQUIRE
TO BE SUPPLIED & INSTALLED BY CLIENT REFER TO TEND




PROPOSED NEW RESIDENCE	scale 1:100		drawing title SECTION	e N & LANDSCAPI
client A, M & J FEELEY	drawn J.S		design N	EWTOWN 255
Project LOT 2264 TENGALA DRIVE JORDAN SPRINGS	17/06/14	drawing	no. 5/6	issue D.

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- of any works


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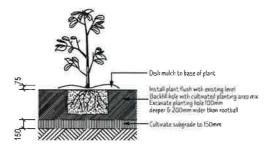
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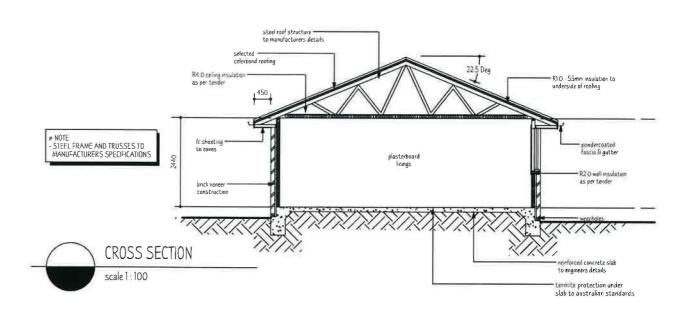
	PLANT SCHEDULE					
SYMBOL	BOTANICAL NAME	COMMON NAME	QTY	MATURE HEIGHT	MATURE WIDTH	NATIVE
	TREES					
FT	ACER NEGUNDO	FLAMINGO TREE	1	5	4	NO
LST	LEPTOSPERMUM PETERSONII	LEMON SCENTED TEATREE	1	5	1-2	YES
25						
	SHRUBS					
PH	PHORMIUM TENAX PURPUREA	PURPLE HAZE	5	1.2	0.6	YES
LC	LOMANDRA CONFERTIFOLIA	LITTEL CON	20	0.3	0.3	YES
BG	FESTUCA GLAUCA	BLUE GRASS	4	1.0	0.5	NO
ВМ	OPHIOPOGON PLANISCAPUS	BLACK MONDO	. 4	1.0	0.5	YES

- IF SPECIES UNAVAILABLE AT TIME OF PLANTING A SUITABLE NATIVE OR LOW WATER USE PLANT IS TO BE USED - ITEMS SHOWN ON LANDSCAPE PLAN MAY BE REQUIRED TO BE SUPPLIED & INSTALLED BY CLIENT REFER TO TENDER & CONTRACT FOR CONFIRMATION



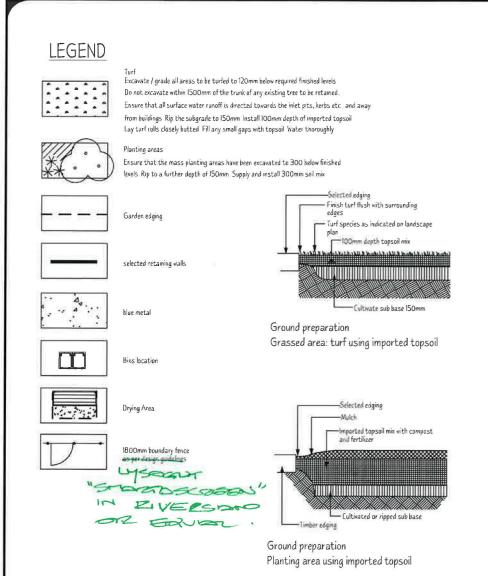

Planting in garden beds

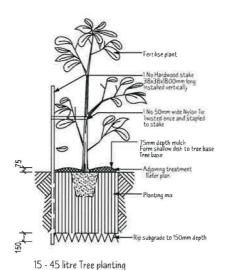

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AS/NZS 3000-2000

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- Waterproofing of wet areas in accordance with AS 3740



PROPOSED NEW RESIDENCE	NEW RESIDENCE scale 1:100		drawing title SECTION & LANDSCAP		
client A, M & J FEELEY	drawn J.S		design N	EWTOWN 255	
Project LOT 2264 TENGALA DRIVE JORDAN SPRINGS	03/06/14	drawing	5/6	issue C.	

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