



12th September 2013

Attention: James Remaili JR Design & Drafting for LB Homes 448-452 Victoria St WETHERILL PARK, NSW 2164

Dear James,

The design plans for the new home you are building for Ms Zhang at Lot 2053 Killuna Way, Jordan Springs are now stamped and ready for submission to Penrith City Council or your Certifier on the following conditions:

- The render colour is to be added to the External Finishes Schedule. The new External Finishes Schedule is to be forwarded to Lend Lease for our records.
- The internal fencing and side gates are to be set back to a minimum of 7.5m from the front boundary or 2m behind the adjacent façade whichever is furthest back. Amend gate locations on the site plan accordingly.
- The air-conditioning unit is to be relocated to ensure that it sits behind the internal fencing and gates in accordance with the guidelines.
- The following notes are to be added to the site plan where not shown:
 - Any garden or lawn edging visible from the street is to be constructed of masonry textured or coloured bricks, blocks or coloured concrete – no timber edging is permitted.
 - o Any retaining walls visible from the street or 900mm high and over are to be of masonry construction.
 - Vehicle crossovers are to be plain concrete to PCC specifications. 5m wide V.C for double garage and 3m wide V.C for single garage.
 - All existing street trees and verge planting are to be protected during construction.

PLEASE ENSURE THAT THE AMENDED PLANS AND FINISHES SCHEDULES ARE FORWARDED TO THE LEND LEASE FOR THEIR RECORDS PRIOR TO SUBMISSION TO COUNCIL OR YOUR CERTIFIER.

It is also worth noting that Sydney Water is currently implementing 'low infiltration' systems and we recommend that you consult with Sydney Water to confirm whether this system will impact your design in any way. Should this system alter the design in any way please ensure these plans are submitted to Lend Lease for re-approval.

Please note: Jordan Springs is a Fibre Connected Community and arrangements for connections and related costs will be required. Please visit http://www.opticomm.net.au for further information.

We look forward to the opportunity of welcoming Ms Zhang or her residents to the Jordan Springs community and to working with you when you choose to build again at Jordan Springs.

However, in the meantime, remember we are here to help with any questions or concerns you may have, so please don't hesitate to contact us.

Yours sincerely,

Rebecca Minney

Design Coordinator, Jordan Springs

CC: Ms Zhang 4 Mimosa Street OATLEY, NSW 2223

Option 3







Contour

Colour: Dark Chocolate

Gutter



Powdercoat/Painted Gutters

Colour: Warm Grey 2

Fascia



Painted Fascia

Colour: Warm Grey 1

Windows



Dowell Windows & Doors

Colour: Woodland Grey

Bricks



Horizon Riverside Colour: Red Cove


Mortar Colour: Default

Concrete



Exposed Aggregate - $\mathsf{Expose}^{\mathsf{TM}}$

Colour: Rustic Red

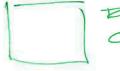

BASIX Report

Building Sustainability Index www.basix.nsw.gov.au



Project summary	TO TO TOWN			
Project name	Lot 2053 Killuna Way, Jordan Springs. NS\			
Street address	Killuna Way Jordan	Springs 2747		
Local Government Area	Penrith City Counci			
Plan type and plan number	deposited 1168989			
Lot no.	2053			
Section no.	-			
Project type	separate dwelling house			
No. of bedrooms	4			
Project score				
Water	40	Target 40		
Thermal Comfort	Pass	Target Pass		
Energy	40	Target 40		

This is not a valid certificate. page 1/8

Description of project

Project name	Lot 2053 Killuna Way, Jordan Springs
r roject name	NSW
Street address	n/a Killuna Way Jordan Springs 2747
Local Government Area	Penrith City Council
Plan type and plan number	Deposited Plan 1168989
Lot no.	2053
Section no.	
Project type	
Project type	separate dwelling house
No. of bedrooms	4
Site details	
Site area (m²)	540
Roof area (m²)	319
Conditioned floor area (m2)	207
Unconditioned floor area (m2)	13
Total area of garden and lawn (m2)	100

Assessor details and thermal I	oads	
Assessor number	n/a	
Certificate number	n/a	
Climate zone	n/a	
Area adjusted cooling load (MJ/m².year)	n/a	
Area adjusted heating load (MJ/m².year)	n/a	
Other		
none	n/a	
Project score		
Water	40	Target 40
Thermal Comfort	Pass	Target Pass
Energy	40	Target 40

This is not a valid certificate.

Schedule of BASIX commitments

The commitments set out below regulate how the proposed development is to be carried out. It is a condition of any development consent granted, or complying development certificate issued, for the proposed development, that BASIX commitments be complied with.

Water Commitments	Show on DA plans	Show on CC/CDC plans & specs	Certifier check
Fixtures			
The applicant must install showerheads with a minimum rating of 3 star (> 4.5 but <= 6 L/min) in all showers in the development.		1	1
The applicant must install a toilet flushing system with a minimum rating of 1 star in each toilet in the development.		1	1
The applicant must install taps with a minimum rating of 3 star in the kitchen in the development.		1	
The applicant must install basin taps with a minimum rating of 3 star in each bathroom in the development.		1	
Alternative water		A PART BAS	
Rainwater tank			
The applicant must install a rainwater tank of at least 2000 litres on the site. This rainwater tank must meet, and be installed in accordance with, the requirements of all applicable regulatory authorities.	1	1	1
The applicant must configure the rainwater tank to collect rain runoff from at least 319.37 square metres of the roof area of the development (excluding the area of the roof which drains to any stormwater tank or private dam).		1	1
The applicant must connect the rainwater tank to:			
all toilets in the development		1	1
 at least one outdoor tap in the development (Note: NSW Health does not recommend that rainwater be used for human consumption in areas with potable water supply.) 		1	1

This is not a valid certificate.

Thermal Comfort Commitments	Show on DA plans	Show on CC/CDC plans & specs	Certifier check
Floor, walls and ceiling/roof	San B		
The applicant must construct the floor(s), walls, and ceiling/roof of the dwelling in accordance with the specifications listed in the table below.	1	1	1

Construction	Additional insulation required (R-Value)	Other specifications
floor - concrete slab on ground	nil	
external wall - brick veneer	1.66 (or 2.20 including construction)	
internal wall shared with garage - plasterboard	nil	
ceiling and roof - flat ceiling / pitched roof	ceiling: 3 (up), roof: foil/sarking	unventilated; medium (solar absorptance 0.475-0.70)

Note Insulation specified in this Certificate must be installed in accordance with Part 3.12.1.1 of the Building Code of Australia.

Thermal Comfort Commitments	Show on DA plans	Show on CC/CDC plans & specs	Certifie check
Windows, glazed doors and skylights		An in the second	-
The applicant must install the windows, glazed doors and shading devices described in the table below, in accordance with the specifications listed in the table. Relevant overshadowing specifications must be satisfied for each window and glazed door.	1	1	1
The dwelling may have 1 skylight (<0.7 square metres) and up to 2 windows/glazed doors (<0.7 square metres) which are not listed in the table.	1	1	1
The following requirements must also be satisfied in relation to each window and glazed door:	1	1	1
 Except where the glass is 'single clear' or 'single toned', each window and glazed door must have a U-value no greater than that listed and a Solar Heat Gain Coefficient (SHGC) +/-10% of that listed. Total system U-values and SHGC must be calculated in accordance with National Fenestration Rating Council (NFRC) conditions. 			1
 The leading edge of each eave, pergola, verandah, balcony or awning must be no more than 500 millimetres above the head of the window or glazed door, except that a projection greater than 500 mm and up to 1500 mm above the head must be twice the value in the table. 	1	1	1
• Pergolas with polycarbonate roof or similar translucent material must have a shading coefficient of less than 0.35.		1	1
 Unless they have adjustable shading, pergolas must have fixed battens parallel to the window or glazed door above which they are situated, unless the pergola also shades a perpendicular window. The spacing between battens must not be more than 50 mm. 		1	1

Window/glazed door no.	indow/glazed door no.		Туре	Shading	Overshadowing		
W1,W3,W4	N	5.85	standard aluminium, single clear (or U-value:7.63, SHGC:0.75)	eave/verandah/pergola/balcony 451-600 mm	not overshadowed		
W2	N	1.53 standard aluminium, single of U-value:7.63, SHGC:0.75) 6.26 standard aluminium, single of		eave/verandah/pergola/balcony 1,500-2,000 mm	not overshadowed		
W5,W6,W7,W8	W	6.26	standard aluminium, single clear (or U-value:7.63, SHGC:0.75)	eave/verandah/pergola/balcony 451-600 mm	not overshadowed		
W9	s	6.3	standard aluminium, single clear (or U-value:7.63, SHGC:0.75)	eave/verandah/pergola/balcony >2,000 mm	not overshadowed		
W10,W11	S	4.98	standard aluminium, single clear (or U-value:7.63, SHGC:0.75)	eave/verandah/pergola/balcony 601-750 mm	not overshadowed		
W12,W13,W14	E	4.41	standard aluminium, single clear (or U-value:7.63, SHGC:0.75)	eave/verandah/pergola/balcony 451-600 mm	not overshadowed		

Energy Commitments	Show on DA plans	Show on CC/CDC plans & specs	Certifier check
Hot water			
The applicant must install the following hot water system in the development, or a system with a higher energy rating: gas instantaneous with a performance of 4 stars.	1	1	1
Cooling system			
The applicant must install the following cooling system, or a system with a higher energy rating, in at least 1 living area: 3-phase airconditioning; Energy rating: EER 3.5 - 4.0		1	1
The applicant must install the following cooling system, or a system with a higher energy rating, in at least 1 bedroom: 3-phase airconditioning; Energy rating: EER 3.5 - 4.0		1	1
Heating system			
The applicant must install the following heating system, or a system with a higher energy rating, in at least 1 living area: 3-phase airconditioning; Energy rating: EER 3.5 - 4.0		1	1
The applicant must install the following heating system, or a system with a higher energy rating, in at least 1 bedroom: 3-phase airconditioning; Energy rating: EER 3.5 - 4.0		1	1
Ventilation	The same of		
The applicant must install the following exhaust systems in the development:			
At least 1 Bathroom: no mechanical ventilation (ie. natural); Operation control: n/a		1	1
Kitchen: individual fan, ducted to façade or roof; Operation control: manual switch on/off			•
		1	1
Laundry: natural ventilation only, or no laundry; Operation control: n/a		1	1
Natural lighting	Non-All-		
The applicant must install a window and/or skylight in the kitchen of the dwelling for natural lighting.	1	1	1
The applicant must install a window and/or skylight in 2 bathroom(s)/toilet(s) in the development for natural lighting.	1	1	1
Other Control of the		The State of the S	
The applicant must install a gas cooktop & electric oven in the kitchen of the dwelling.		1	
The applicant must construct each refrigerator space in the development so that it is "well ventilated", as defined in the BASIX definitions.		1	

Energy Commitments	Show on DA plans	Show on CC/CDC plans & specs	Certifier check
The applicant must install a fixed outdoor clothes drying line as part of the development.		1	

Legend


In these commitments, "applicant" means the person carrying out the development.


Commitments identified with a in the "Show on DA plans" column must be shown on the plans accompanying the development application for the proposed development (if a development application is to be lodged for the proposed development).

Commitments identified with a in the "Show on CC/CDC plans and specs" column must be shown in the plans and specifications accompanying the application for a construction certificate / complying development certificate for the proposed development.


Commitments identified with a in the "Certifier check" column must be certified by a certifying authority as having been fulfilled, before a final occupation certificate(either interim or final) for the development may be issued.


This is not a valid certificate.

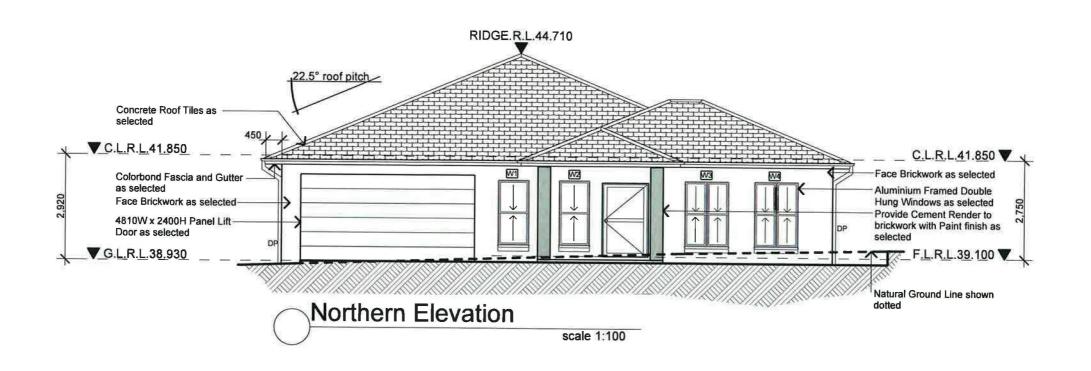

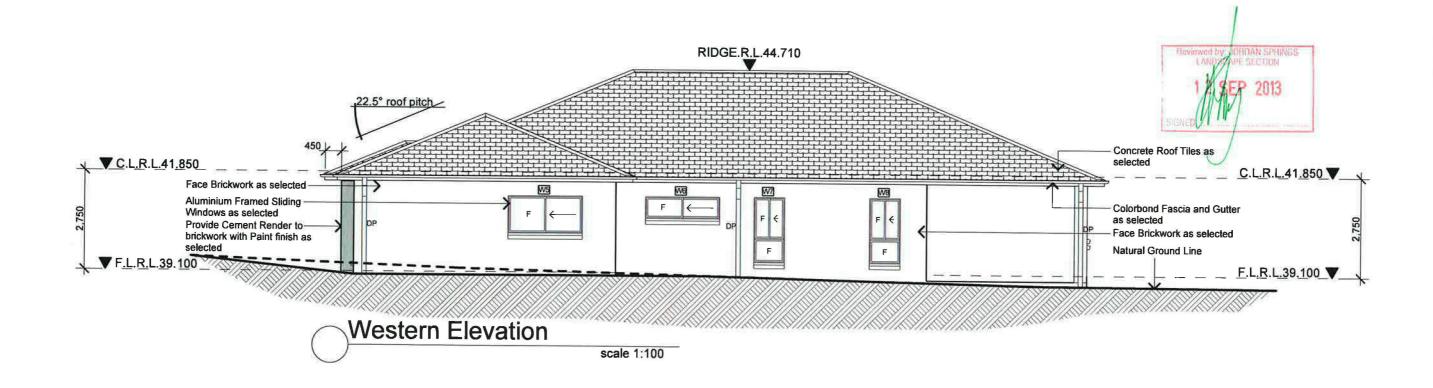

Amendment Designs	03.07.13	i	North:	General Notes	Where Engineering Detail Plans are required, such must take	Proposed:	Drawing Title:	Revision:
Design Amended Design Amended	09.07.13	ROSSISSISSISSISSISSISSISSISSISSISSISSISSI		All work shall be carried out strictly in accordance with	preference to this drawing.	New Single Storey Residence	Southern Elevation Eastern Elevation	
Design Amended	16.07.13 23.07.13	DESIGN & DRAFTING	1	& to the satisfaction of the regulatory authority.	Levels shown are approximate unless accompanied by reduced levels or Australian Height Dalum Levels.	Location:	LGA	→ F
Design Amended	01.08.13	Phone: (02) 9757 - 4002 Fax: (02) 9757 - 4003		All levels, dimensions & areas are to be verified	Figured dimensions to be taken in preference to scaling.	Lot 2053 Kiluna Way,	Penrith Council	
Submission to Jordan Springs	23.08.13	Email: jr.design.drafting@gmail.com Address: 448 - 452 Victoria Street, Wetherill Park, NSW 2164		by the Builder, prior to the preparation of contracts & the commencement of any building works.	All Boundary clearances must be verified by Survey. Stormwater to be disharged to Councils requirements	Jordan Springs, NSW	Pennui Councii	Job No:
		Note:	Conviols	Any discrepancies are to be brought to the attention	before any work commences,	Client:	Drawn ID Date 22.08.204	12 D42
		Builder shall check and verify all dimensions prior to the commencement of any work	This plan is the exclusive property at JR Design & Drafting, and must not be used, reproduced or copie wholly or partly in any way without permission.	of JR Design & Drafting, prior to the commencement of any building works.	All services to be located & verified by the Builder with relevant Authorities before any work commences.	LB Homes	Scale 4:400 Sheet 5-49	13 LB13

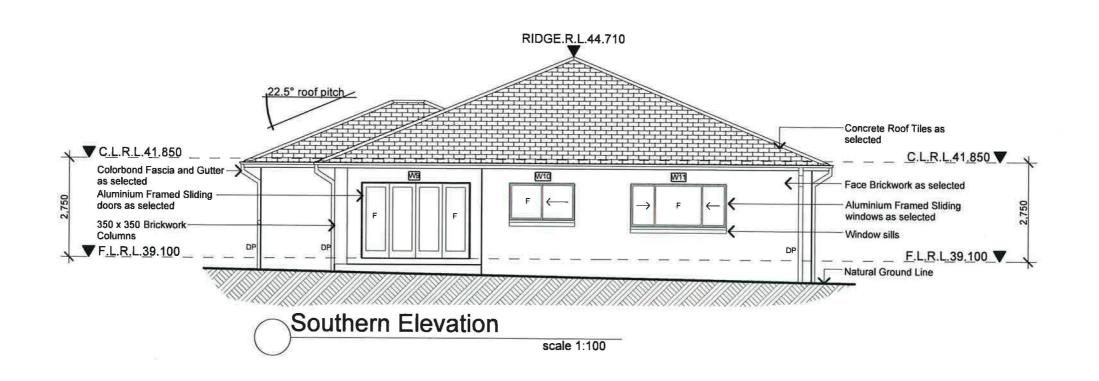

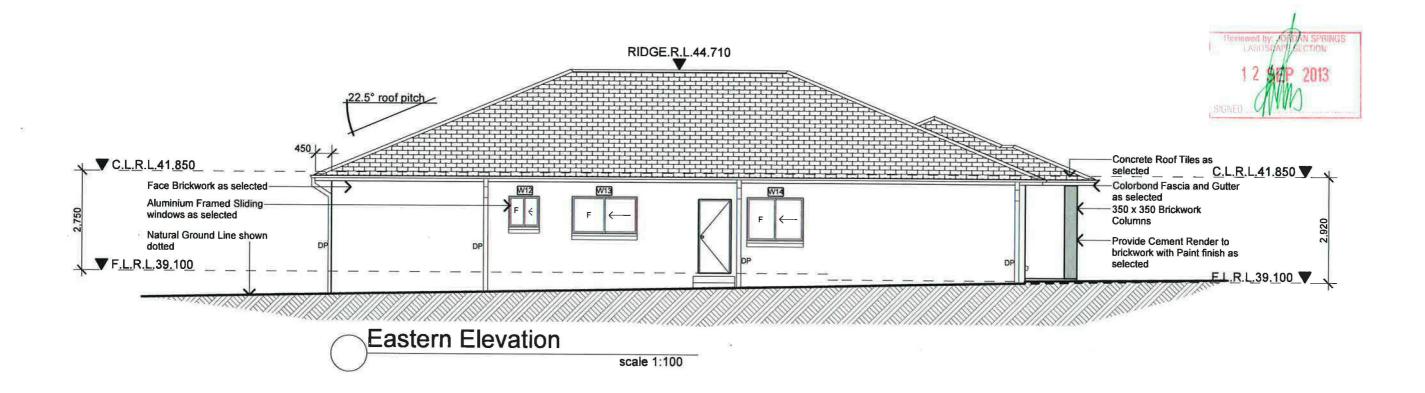

ssue Amendment	Date:	T.	North:	General Notes		Proposed:	Drawing Title:	Revision
Designs Design Amended	03.07.13 09.07,13			All work shall be carried out strictly in accordance with The Building Code Of Australia, relevant S.A.A. codes	Francisco de timo di anni gi	New Single Storey Residence	Southern Elevation Eastern Elevation	- C
Design Amended Design Amended	16.07.13	DESIGN & DRAFTING		& to the satisfaction of the regulatory authority.	Levels shown are approximate unless accompanied by reduced levels or Australian Height Datum Levels.	Location:	L.G.A	_
Design Amended	23.07.13 01.08.13	Phone: (02) 9757 - 4002 Fax: (02) 9757 - 4003	1	All levels, dimensions & areas are to be verified by the Builder, prior to the preparation of contracts	Figured dimensions to be taken in preference to scaling. All Boundary clearances must be verified by Survey.	Lot 2053 Kiluna Way,	Penrith Council	Job No:
Submission to Jordan Springs	23.08.13	Email: jr.design.drafting@gmail.com Address: 448 - 452 Victoria Street, Wetherill Park. NSW 2164		& the commencement of any building works.	Stormwater to be disharged to Councils requirements	Jordan Springs. NSW		JOD 140.
		Note:	Copyright: This plan is the exclusive property of IR Classes 5.	 Any discrepancies are to be brought to the attention of JR Design & Drafting, prior to the 	before any work commences. All services to be located & verified by the Builder	Client.	Drawn JR Date 23.08.2013	3 LB1309
		of any work	Drafting, and must not be used, reproduced or copie wholly or partly in any way without permission		with relevant Authorities before any work commences.	LB Homes	Scale 1:100 Sheet 6 of 8	

