

PRIME ENGINEERING CONSULTANTS

PROPOSED SECONDARY DWELLING AT 3 VALLEYVIEW CRESCENT. WERRINGTON DOWNS



	-
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DRAWN	DATE	DESCRIPTION	ISSUE	CLIENT	DESIGNED B	Y: D.S.	ISSUE:	
D.S.	20.10.2021	ISSUED FOR DA	Α		CHECKED BY	/: D.S.	٨	
				SITE ADDRESS	SCALE:	1:100	А	COVER PAGE
				3 VALLEYVIEW CRESCENT, WERRINGTON DOWNS	CLIENT REF:	ARCH DRAWING NO:	SHEET NO:	
					PSW21283	TD3V14821	SW01	
					1 31121200	150111021	3 7 7 0 1	

DP ●	DOWNPIPE
	STORMWATER LINE
——————————————————————————————————————	SUBSOIL DRAINAGE LINE
—— OF ——	OVERFLOW LINE
SWRM	STORMWATER RISING MAIN
е	EXISTING STORMWATER LINE
swsw	AUTHORITY STORMWATER LINE
—— нь—— нь——	HIGH LEVEL STORMWATER LINE
s	AUTHORITY SEWER LINE
w	AUTHORITY WATER LINE
G G	AUTHORITY GAS LINE
	AUTHORITY ELECTRICITY LINE
— FO— FO— FO—	AUTHORITY FIBRE OPTIC LINE
TEL	AUTHORITY COMMS LINE
	FENCE LINE
	GRATED SURFACE INLET PIT
	GRATED SURFACE INLET PIT WITH ENVIROPOD INSERT
	JUNCTION PIT
	KERB INLET PIT
	EXISTING GRATED SURFACE INLET PIT
	EXISTING GRATED TRENCH DRAIN
	EXISTING JUNCTION PIT
	EXISTING KERB INLET PIT
eTEL	EXISTING TELSTRA PIT
⊞ eHYD	EXISTING HYDRANT
⋈ eSV	EXISTING STOP VALVE
□ eGAS	EXISTING GAS VALVE
O ePP	EXISTING POWER POLE
¤ eBT	EXISTING BOUNDARY TRAP

<u>LEGEND</u>	
FF ❷	FIRST FLUSH
eSMH	EXISTING SEWER MANHOLE
OFP	OVERLAND FLOW PATH
RWO ⊘	RAINWATER OUTLET
CO 👁	CLEAR OUT POINT
DDO 🛮	DISH DRAIN OUTLET
PD •	PLANTER DRAIN
٦	CAPPING
(1.01)	PIT TAG/NUMBER
RH 🖸	RAINHEAD
•	DOWNPIPE DROP
M	NON RETURN VALVE
×	WALL PENETRATION
DP •	DOWNPIPE SPREADER
	WARNING LIGHT
0.00 ♦	SPOT LEVELS
Δ	BENCHMARK



DIAL BEFORE YOU DIG SHOULD BE CONTACTED PRIOR TO ANY EXCAVATION ON SITE

TM: TRADE MARK OF THE ASSOCIATION OF DIAL BEFORE YOU DIG SERVICES LTD. USED UNDER LICENSE.

SERVICES SHOWN ON PLAN ARE INDICATIVE, EXACT DEPTH AND LOCATION TO BE CONFIRMED ONSITE. CONTRACTOR TO CARRY OUT DIAL BEFORE YOU DIG APPLICATION AND ENGAGE A REGISTERED SURVEYOR TO PEG OUT ALL EXISTING SERVICES PRIOR TO ANY WORK COMMENCING ONSITE.

ABBREVIATIONS:

<u> </u>	CE VIA HONS.
OR OR OR OCCCODDDDDD e FGGHJKLPRO&RSGPD P EFGGHJKLPRO&RSGPD P ORR ORR ORR ORR ORR ORR ORR O	DIAMETER CALIFORNIA BEARING RATIO CHAINAGE CENTER LINE CLEAR OUT DISH DRAIN DISH DRAIN OUTLET DOWELLED EXPANSION JOINT DENSE GRADED BASECOURSE DENSE GRADED SUB—BASE DOWNPIPE EXISTING FINISHED FLOOR LEVEL GRATED TRENCH DRAIN GRATED SURFACE INLET PIT HYDRANT ISOLATING JOINT INTEGRAL KERB INVERT LEVEL INTERSECTION POINT KERB INLET PIT KERB ONLY KERB & GUTTER KERB RETURN LONGITUDINAL SECTION NATURAL GROUND LEVEL OVERLAND FLOW PATH ON—SITE DETENTION RADIUS REINFORCED CONCRETE PIPE ROLL KERB & GUTTER REDUCED LEVEL RETAINING WALL RAINWATER TANK SAWN CONTROL JOINT SEWER MAN HOLE STORMWATER RISING MAIN
SWP	STORMWATER PIT
SWRM SWS SV	STORMWATER RISING MAIN STORMWATER SUMP STOP VALVE
TOK TOW	TOP OF KERB TOP OF WALL
TWL	TOP WATER LEVEL

TANGENT POINT

CHLORIDE

TYPICAL

BENCH MARK

UNPLASTICISED POLYVINYL

UNLESS NOTED OTHERWISE

WEAKENED PLANE JOINT FIRST FLUSH DEVICE

UPVC

UNO

DRAINAGE NOTES:

ALL PIPES TO BE LAID ON 75mm SAND BED WITH THE BARRELS FULLY SUPPORTED

100mm AND 150mm DIAMETER PIPES TO BE LAID ON MINIMUM 1% GRADE

MINIMUM DEPTH OF COVER FOR PIPES NOT SUBJECT TO VEHICULAR LOADING TO BE 300mm

ALL DRAINAGE PIPES LAID UNDER PAVEMENT SHALL BE REINFORCED CONCRETE WITH RUBBER RING JOINTS

BACKFILL TRENCHES WITH COMPACTED SAND OR APPROVED AGGREGATE MATERIAL

ALL PITS TO HAVE 600x600mm INTERNAL DIMENSIONS (U.N.O.)

SILT ARRESTORS TO HAVE 900x900mm INTERNAL DIMENSIONS

HEAVY DUTY GRATES AND COVERS ARE TO BE PROVIDED IN

PIT GRATE TO BE TYPE WELDLOK OR APPROVED EQUIVALENT

ALL PITS SHALL BE PROVIDED WITH A LOCKING CLIP

ALL PITS SHALL BE MAINTAINED REGULARLY

TOP OF BENCHING SHALL BE TO THE HALF OF THE OUTLET PIPE DIAMETER

MAXIMUM FRONT ENTRY PIPE: — STRAIGHT ENTRY — Ø750 SKEW ENTRY 45* — Ø525

MINIMUM OF 20MPa AT 28 DAYS

TRAFFICABLE AREAS

ø100 SUBSOIL DRAINAGE PIPE 3000mm LONG WRAPPED IN FABRIC

COMPRESSIVE STRENGTH f'e FOR CAST IN SITU CONCRETE TO BE A

SOCK TO BE PROVIDED ADJACENT TO INLET PIPES

PROVIDE CLEANING EYES TO ALL DOWNPIPES NOT DIRECTLY CONNECTED

ISOLATED JOINTS TO BE PROVIDED TO ISOLATE CONCRETE PAVEMENTS FROM PITS

ALL TRENCH GRATES PROVIDED SHALL HAVE A MINIMUM CLEAR WIDTH

OF 200mm

STORMWATER DRAINAGE CONNECTIONS TO THE MAIN SYSTEM SHALL BE TO THE REQUIREMENTS AND THE SATISFACTION OF LOCAL COUNCIL

STORMWATER PIPE BEDDING/PAVING

WHERE TRENCH BASE IS ROCK A MINIMUM OF 75mm BEDDING TO BE PROVIDED UNDER PIPE COLLARS.

STORMWATER PIPE BEDDING DETAIL TO BE IN ACCORDANCE WITH LOCAL COUNCIL REQUIREMENTS. BEDDING DETAILS TO BE CONFIRMED UPON EXCAVATION & PRIOR TO INSTALLATION OF PIPEWORK.

FOOTPATH REINSTATEMENT NOTES:

REMOVE ALL SAND FILL WITHIN THE FOOTPATH AREA TO THE EXISTING SUBGRADE.

SUPPORT ALL AUTHORITY SERVICES TO STRUCTURAL ENGINEERS DETAILS DURING EXCAVATION.

REINSTATE FOOTPATH SUBGRADE.

THE CONTRACTOR SHALL PROVIDE CERTIFICATION OF COMPACTION FROM A NATA REGISTERED TESTING AUTHORITY. MINIMUM THREE TESTS PER

LAYER AS FOLLOWS: SELECT FILL

95% MODIFIED 98% MODIFIED

SELECT FILL (LESS THAN 300mm BELOW BASE COURSE) BASE COURSE

100% MODIFIED

EROSION & SEDIMENT CONTROL NOTES:

PROVIDE SILT FENCE/HAY BAIL BARRIERS TO THE LOW SIDE OF ALL EXPOSED EARTH EXCAVATIONS (TYPICAL).

ISOLATE EXISTING STORMWATER PITS WITH HAY BALES TO FILTER ALL INCOMING FLOWS.

DO NOT STOCK PILE EXCAVATED MATERIAL ON THE ROAD WAY.

SURVEY

THE EXISTING SITE CONDITIONS SHOWN ON THE FOLLOWING DRAWINGS HAVE BEEN INVESTIGATED BY COMPLETE PRECISION SURVEYS, BEING REGISTERED SURVEYORS. THE INFORMATION IS SHOWN TO PROVIDE A BASIS FOR DESIGN. PRIME ENGINEERING CONSULTANTS DOES NOT GUARANTEE THE ACCURACY OR COMPLETENESS OF THE SURVEY BASE OR ITS SUITABILITY AS A BASIS FOR CONSTRUCTION DRAW.

SHOULD DISCREPANCIES BE ENCOUNTERED DURING CONSTRUCTION BETWEEN THE SURVEY DATA AND ACTUAL FIELD DATA, CONTACT PRIME ENGINEERING CONSULTANTS.


ADOPT DATUM RL 41.50. (A.H.D) AS PER COMPLETE PRECISION

	DRAWING REGISTER							
NUMBER	REVISION							
SWO	COVER SHEET	А						
SW1	SPECIFICATIONS SHEET	А						
SW2	STORMWATER DRAINAGE PLAN & DETAILS	А						





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			•	SITE ADDRESS	SCALE:	1:100	А	SPECIFICATIONS SHEET
				3 VALLEYVIEW CRESCENT, WERRINGTON DOWNS	CLIENT REF: A	RCH DRAWING NO:	SHEET NO:	
					PSW21283	TD3V14821	SW02	
					1 3 2 1 2 3 3	150711021	J VV U Z	

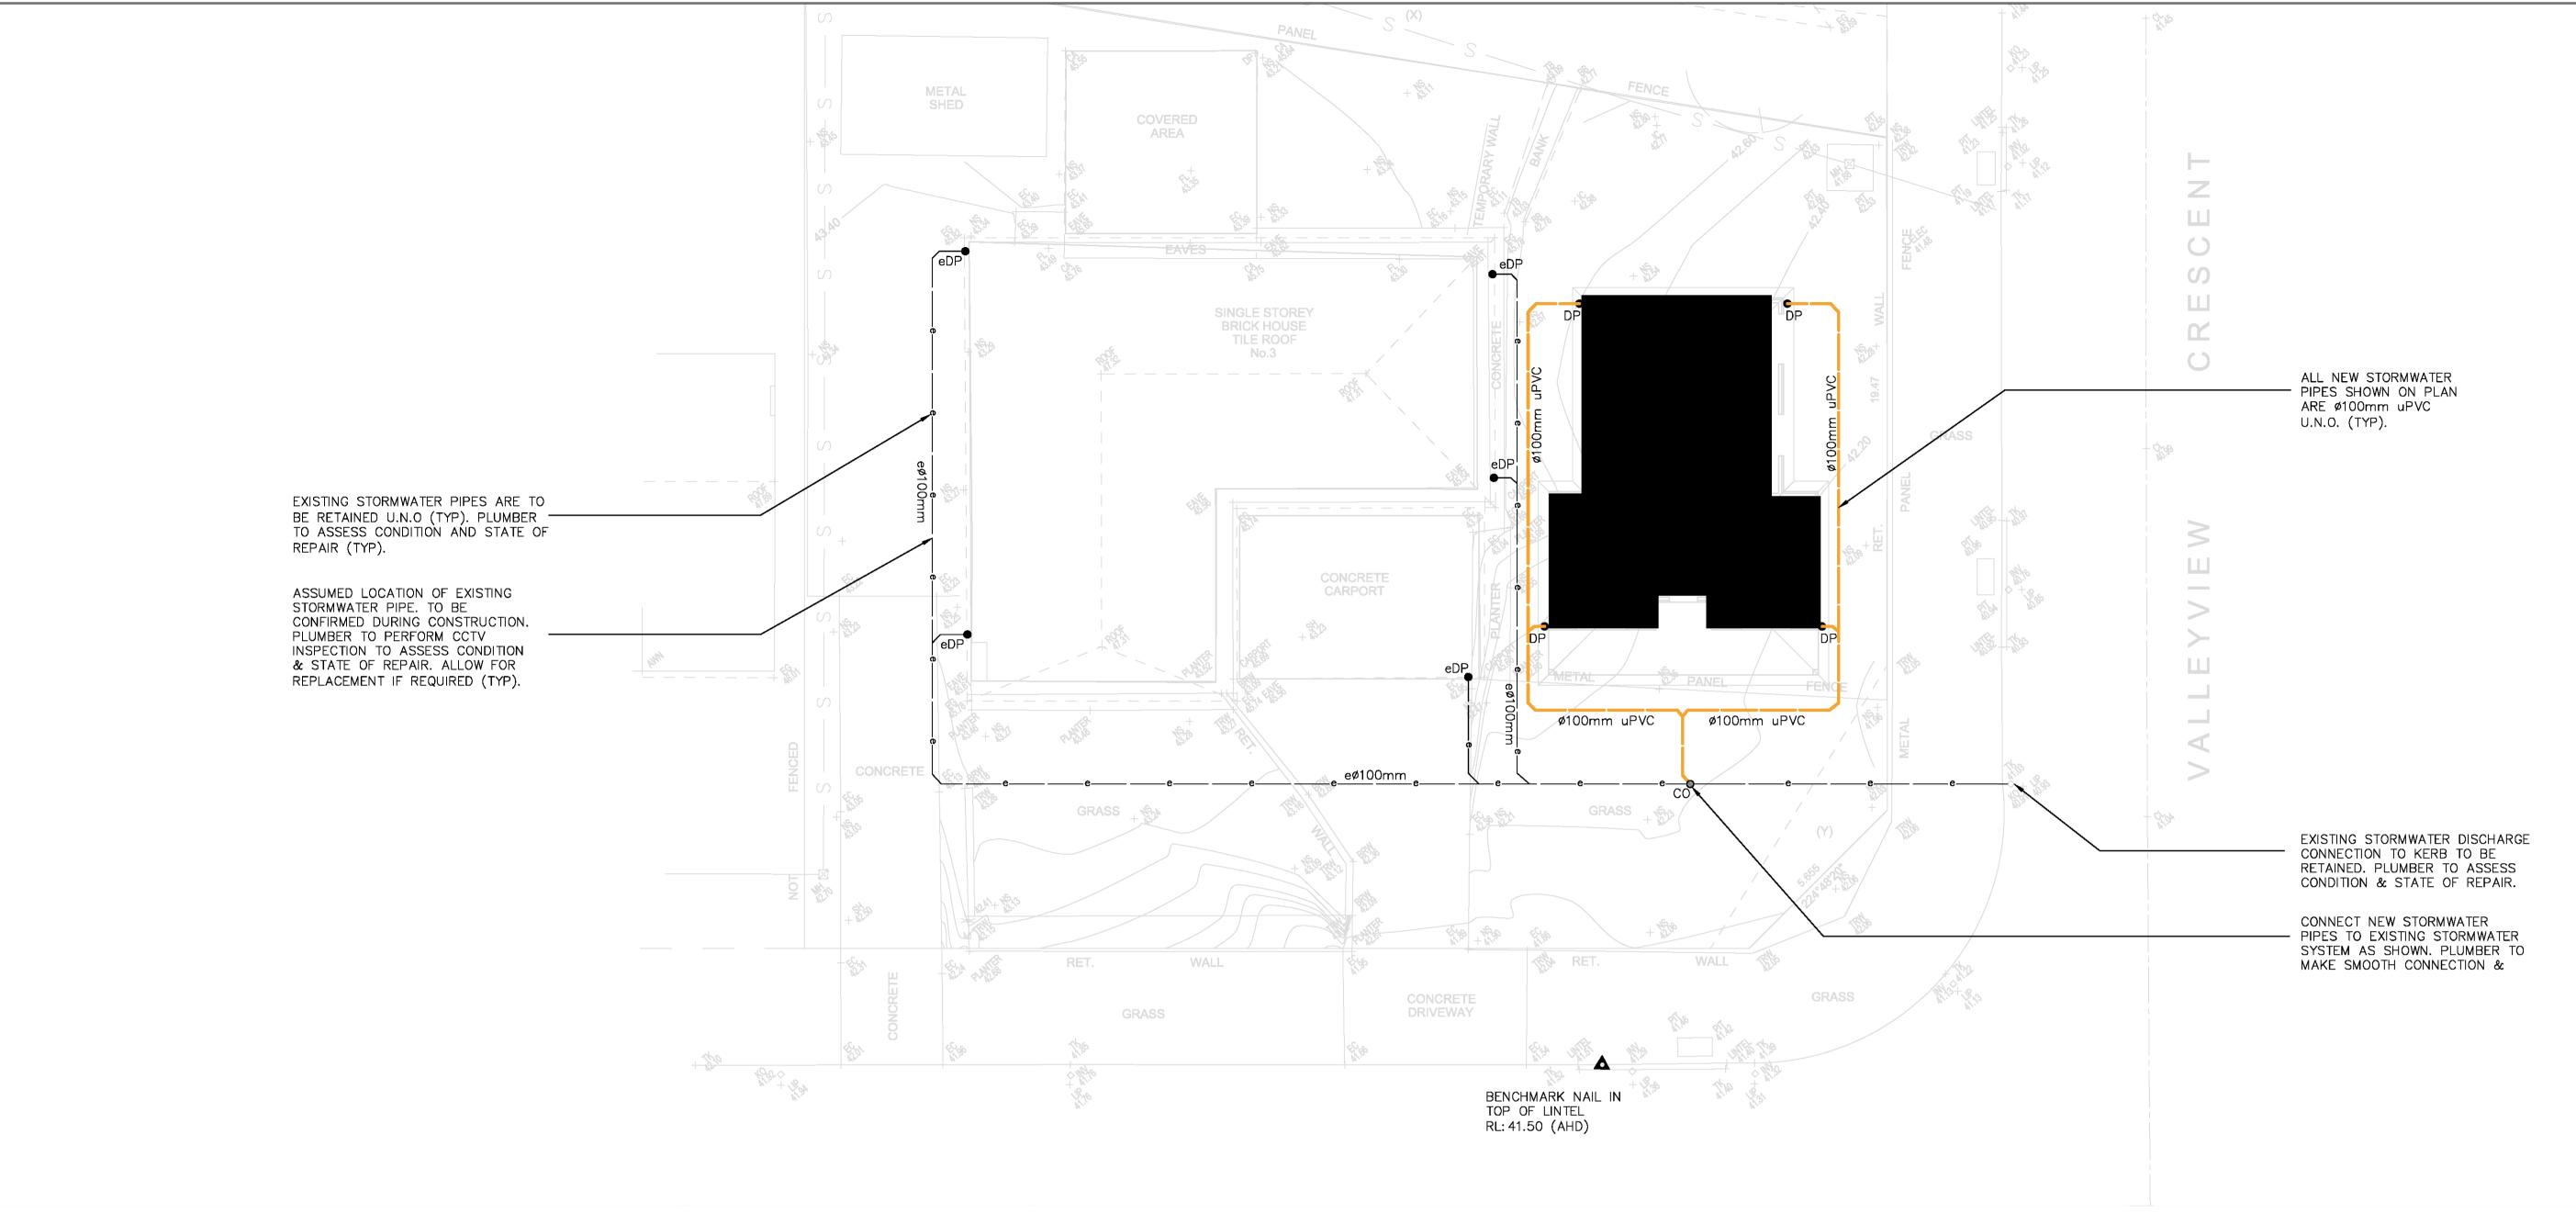

GROUND FLOOR PLAN SCALE 1:100

DESIGN NOTES:

THE SITE IS LOCATED IN PENRITH CITY COUNCIL.

SITE AREA = $806.0m^2$

THE DEVELOPMENT CONSISTS OF THE CONSTRUCTION OF A DETACHED SECONDARY DWELLING.

OSD IS NOT REQUIRED AS PER SECITON 4.1 OF PENRITH CITY COUNCIL STORMWATER DRAINAGE SPECIFICATION FOR BUILDING DEVELOPMENTS 2016.

ALL NEW STORMWATER PIPES TO HAVE A MINIMUM OF 100mm CONCRETE OR 300mm TOPSOIL COVER U.N.O.

INSTALL CLEAR OUT FOR INSPECTION AND MAINTENANCE PURPOSES WHERE REQUIRED.

RAINWATER TANK TO BE EQUIPPED WITH FIRST FLUSH AND MOSQUITO PROTECTION DEVICES (REFER DETAIL).

LOCATION RAINWATER TANK SHOWN ON PLAN IS INDICATIVE. TO BE CONFIRMED DURING CONSTRUCTION.

KEY NOTES:

. ALL EXISTING STORMWATER PIPES AND DOWNPIPES ARE TO BE RETAINED U.N.O (TYP). PLUMBER TO ASSESS CONDITION AND STATE OF REPAIR. ALLOW FOR REPLACEMENT IF REQUIRED.

2. CONTRACTOR TO ENSURE LOCATION OF NEW DWELLING DOES NOT ADVERSELY IMPACT EXISTING STORMWATER SYSTEM. IF SO, CONTRACTOR TO CONTACT STORMWATER ENGINEER PRIOR TO COMMENCING ANY

3. CONTRACTOR PERMITTED TO CONNECT TO EXISTING STORMWATER SYSTEM IF FOUND TO BE IN GOOD CONDITION DURING CONSTRUCTION. STORMWATER ENGINEER TO BE CONTACTED PRIOR TO COMMENCING ANY WORKS WHICH VARY FROM THE APPROVED STORMWATER PLANS.

4. IF EXISTING STORMWATER SYSTEM IS CONNECTED TO SEWER, CONTRACTOR IS TO RECTIFY STORMWATER DESIGN AND CREATE A NEW CONNECTION AS PER COUNCIL SPECIFICATIONS AND AUSTRALIAN STANDARDS. CONTRACTOR TO CONTACT STORMWATER ENGINEER PRIOR TO COMMENCING ANY WORKS.

EROSION & SEDIMENT CONTROL NOTES:


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ISOLATE EXISTING STORMWATER PITS WITH HAY BALES TO FILTER ALL INCOMING FLOWS.

DO NOT STOCK PILE EXCAVATED MATERIAL ON THE ROAD WAY.

SURVEY

THE EXISTING SITE CONDITIONS SHOWN ON THE FOLLOWING DRAWINGS HAVE BEEN PROVIDED BY A1 GRANNY FLAT'S SITE PLAN REFERENCED TD3V14821 DATED 18/10/2021. THE INFORMATION IS SHOWN TO PROVIDE A BASIS FOR DESIGN.

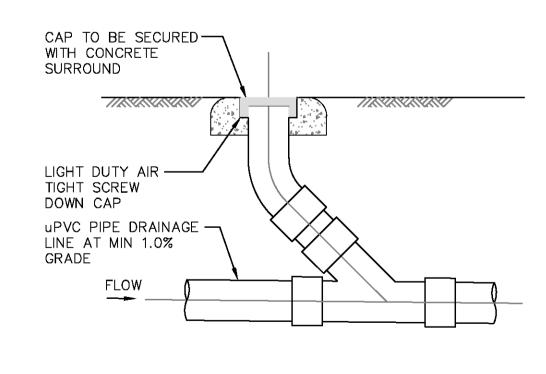

DETAIL CLEANING EYE SCALE 1:20



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				3 VALLEYVIEW CRESCENT, WERRINGTON DOWNS	CLIENT REF:	ARCH DRAWING NO:	SHEET NO:	
					PSW21283	TD3V14821	SW03	
					1 31121200	100 \$1 1021	2000	

NSW 2170