EYE OF THE SUN - COVER SHEET

Project No. 19043

Project PROPOSED RESIDENTIAL FLAT BUILDING

Address 44-48 Rodley Avenue, Penrith, NSW, 2750

Project Status DA SUBMISSION



ACN 159 480 056, ABN 41 159 480 056 E: info@morsongroup.com.au P: (02) 9380 4946 P: PO Box 170, Potts Point, NSW, 1335

lient Inglow Investments Two



	EOS - SHEET LIST		
Number	Name	Current Revision Date	Revision
EOS00	EYE OF THE SUN - COVER SHEET	2021-03-04	Α
EOS01	EYE OF THE SUN - WEST (SHEET 1-7)	2021-03-04	Α
EOS02	EYE OF THE SUN - WEST (SHEET 2-7)	2021-03-04	Α
EOS03	EYE OF THE SUN - WEST (SHEET 3-7)	2021-03-04	Α
EOS04	EYE OF THE SUN - WEST (SHEET 4-7)	2021-03-04	А
EOS05	EYE OF THE SUN - WEST (SHEET 5-7)	2021-03-04	Α
EOS06	EYE OF THE SUN - WEST (SHEET 6-7)	2021-03-04	А
EOS07	EYE OF THE SUN - WEST (SHEET 7-7)	2021-03-04	Α
EOS08	EYE OF THE SUN - EAST (SHEET 1-7)	2021-03-04	А
EOS09	EYE OF THE SUN - EAST (SHEET 2-7)	2021-03-04	Α
EOS10	EYE OF THE SUN - EAST (SHEET 3-7)	2021-03-04	А
EOS11	EYE OF THE SUN - EAST (SHEET 4-7)	2021-03-04	A
EOS12	EYE OF THE SUN - EAST (SHEET 5-7)	2021-03-04	Α
EOS13	EYE OF THE SUN - EAST (SHEET 6-7)	2021-03-04	Α
EOS14	EYE OF THE SUN - EAST (SHEET 7-7)	2021-03-04	Α
EOS15	EYE OF THE SUN - SUN LIGHT ACCESS SCHEDULE	2021-03-04	Α

DRAWING NUMBER

EOS00

ISSUE NO.



EYE OF THE SUN - WEST (SHEET 1-7)

Project No. 19043

Project PROPOSED RESIDENTIAL FLAT BUILDING


Address 44-48 Rodley Avenue, Penrith, NSW, 2750

Project Status DA SUBMISSION




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EAST VIEW - 9.00AM JUN

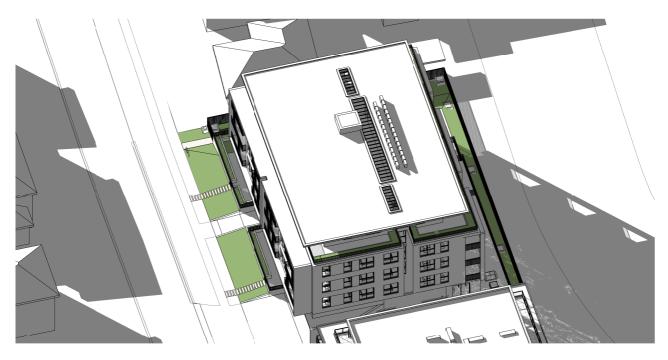

EAST VIEW - 9.30AM JUN

DRAWING NUMBER

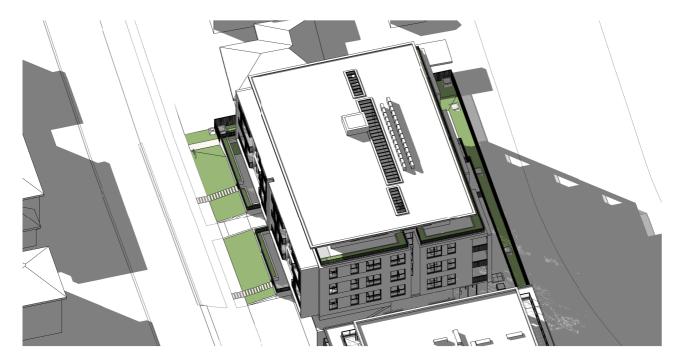EOS01

ISSUE NO.

EYE OF THE SUN - WEST (SHEET 2-7)

Project No. 19043

Project PROPOSED RESIDENTIAL FLAT BUILDING


Address 44-48 Rodley Avenue, Penrith, NSW, 2750

Project Status DA SUBMISSION




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EAST VIEW - 10.00AM JUN

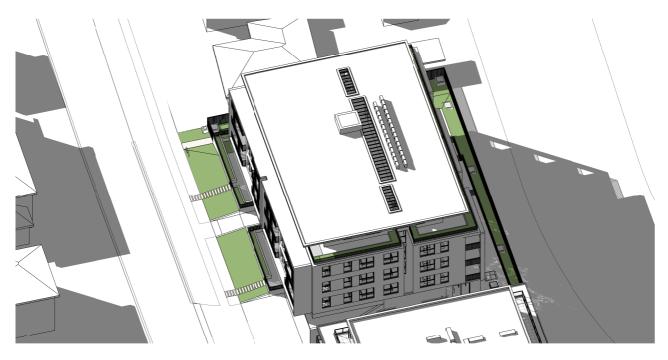

EAST VIEW - 10.30AM JUN

DRAWING NUMBER

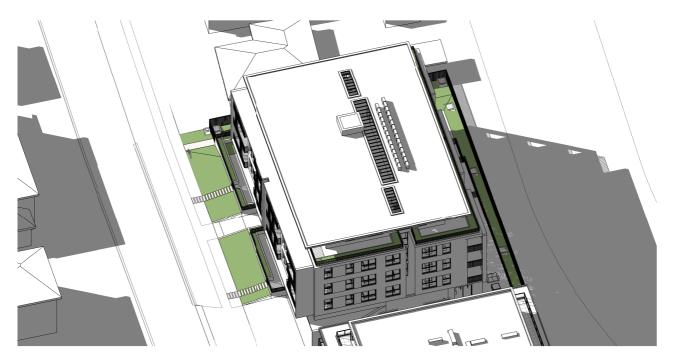EOS02

ISSUE NO.

EYE OF THE SUN - WEST (SHEET 3-7)

Project No. 19043

Project PROPOSED RESIDENTIAL FLAT BUILDING


Address 44-48 Rodley Avenue, Penrith, NSW, 2750

Project Status DA SUBMISSION




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EAST VIEW - 11.00AM JUN

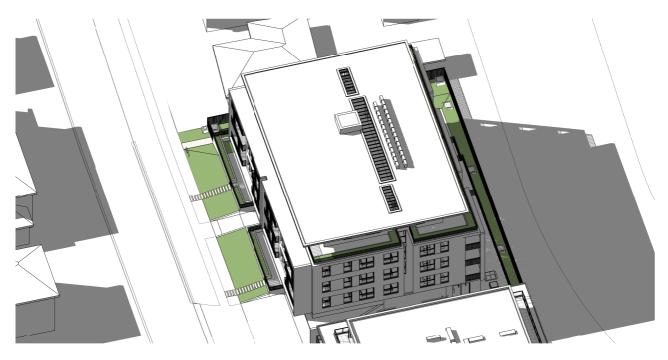

EAST VIEW - 11.30AM JUN

DRAWING NUMBER

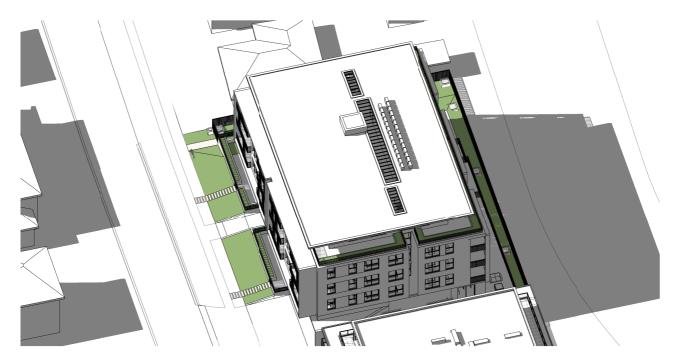EOS03

ISSUE NO.

A

Docurn@182020:9507891 Version: 1, Version Date: 19/03/2021

EYE OF THE SUN - WEST (SHEET 4-7)

Project No. 19043

Project PROPOSED RESIDENTIAL FLAT BUILDING


Address 44-48 Rodley Avenue, Penrith, NSW, 2750

Project Status DA SUBMISSION



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EAST VIEW - 12.00PM JUN

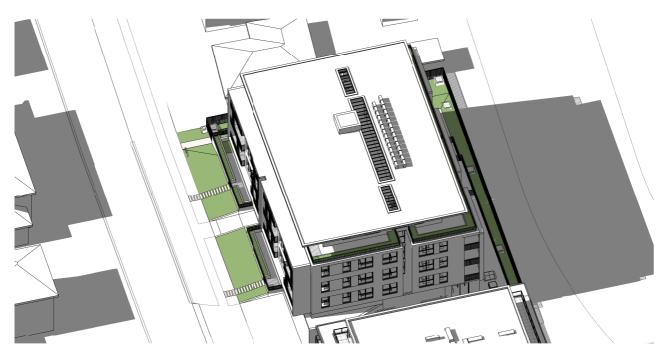

EAST VIEW - 12.30PM JUN

DRAWING NUMBER

EOS04

ISSUE NO.

EYE OF THE SUN - WEST (SHEET 5-7)

Project No. 19043

Project PROPOSED RESIDENTIAL FLAT BUILDING


Address 44-48 Rodley Avenue, Penrith, NSW, 2750

Project Status DA SUBMISSION




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EAST VIEW - 1.00PM JUN

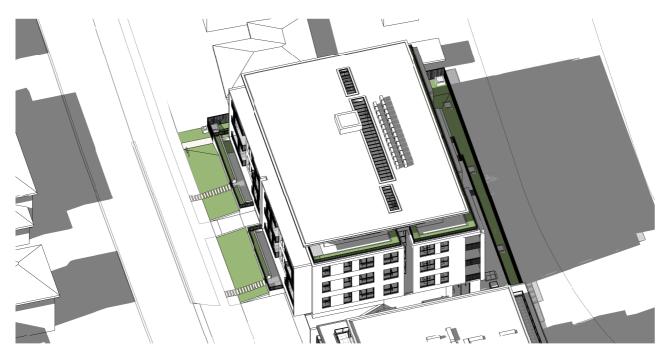

EAST VIEW - 1.30PM JUN

DRAWING NUMBER

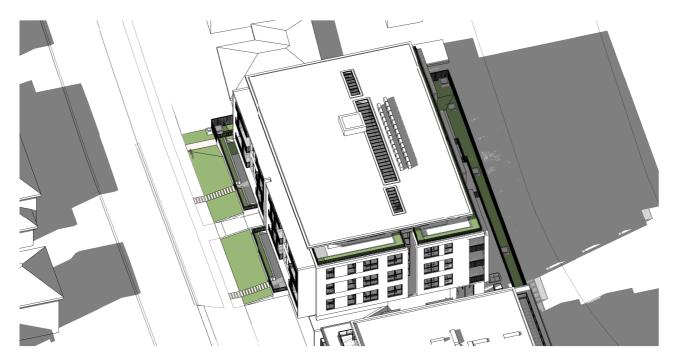EOS05

ISSUE NO.

EYE OF THE SUN - WEST (SHEET 6-7)

Project No. 19043

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Address 44-48 Rodley Avenue, Penrith, NSW, 2750

Project Status DA SUBMISSION




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EAST VIEW - 2.00PM JUN



EAST VIEW - 2.30PM JUN

DRAWING NUMBER

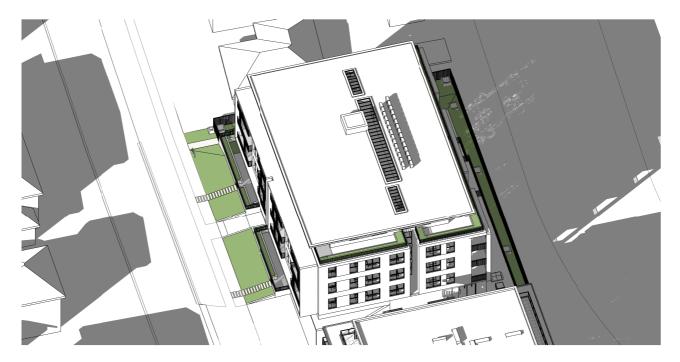EOS06

ISSUE NO.

EYE OF THE SUN - WEST (SHEET 7-7)

Project No. 19043

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Address 44-48 Rodley Avenue, Penrith, NSW, 2750

Project Status DA SUBMISSION



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EAST VIEW - 3.00PM JUN

DRAWING NUMBER

EOS07

ISSUE NO.

A

EYE OF THE SUN - EAST (SHEET 1-7)

Project No. 19043

Project PROPOSED RESIDENTIAL FLAT BUILDING

Address 44-48 Rodley Avenue, Penrith, NSW, 2750

Project Status DA SUBMISSION



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WEST VIEW - 9.00AM JUN



WEST VIEW - 9.30AM JUN

DRAWING NUMBER

EOS08

ISSUE NO.

EYE OF THE SUN - EAST (SHEET 2-7)

Project No. 19043

Project PROPOSED RESIDENTIAL FLAT BUILDING

Address 44-48 Rodley Avenue, Penrith, NSW, 2750

Project Status DA SUBMISSION



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WEST VIEW - 10.00AM JUN



WEST VIEW - 10.30AM JUN

DRAWING NUMBER

EOS09

ISSUE NO.

A

Docum**?**/1332970:9537691 Version: 1, Version Date: 19/03/2021

EYE OF THE SUN - EAST (SHEET 3-7)

Project No. 19043

Project PROPOSED RESIDENTIAL FLAT BUILDING

Address 44-48 Rodley Avenue, Penrith, NSW, 2750

Project Status DA SUBMISSION



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WEST VIEW - 11.00AM JUN



WEST VIEW - 11.30AM JUN

DRAWING NUMBER

EOS10

ISSUE NO.

A

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EYE OF THE SUN - EAST (SHEET 4-7)

Project No. 19043

Project PROPOSED RESIDENTIAL FLAT BUILDING

Address 44-48 Rodley Avenue, Penrith, NSW, 2750

Project Status DA SUBMISSION



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WEST VIEW - 12.00PM JUN



WEST VIEW - 12.30PM JUN

DRAWING NUMBER

EOS11

ISSUE NO.

A

Document Reference No.:EOS11
Version: 1, Version Date: 19/03/2021

EYE OF THE SUN - EAST (SHEET 5-7)

Project No. 19043

Project PROPOSED RESIDENTIAL FLAT BUILDING

Address 44-48 Rodley Avenue, Penrith, NSW, 2750

Project Status DA SUBMISSION



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WEST VIEW - 1.00PM JUN



WEST VIEW - 1.30PM JUN

DRAWING NUMBER

EOS12

ISSUE NO.

A

Docum**?**/1332970:9557691 Version: 1, Version Date: 19/03/2021

EYE OF THE SUN - EAST (SHEET 6-7)

Project No. 19043

Project PROPOSED RESIDENTIAL FLAT BUILDING

Address 44-48 Rodley Avenue, Penrith, NSW, 2750

Project Status DA SUBMISSION



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WEST VIEW - 2.00PM JUN



WEST VIEW - 2.30PM JUN

DRAWING NUMBER

EOS13

ISSUE NO.

A

EYE OF THE SUN - EAST (SHEET 7-7)

Project No. 19043

Project PROPOSED RESIDENTIAL FLAT BUILDING

Address 44-48 Rodley Avenue, Penrith, NSW, 2750

Project Status DA SUBMISSION



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WEST VIEW - 3.00PM JUN

DRAWING NUMBER

EOS14

ISSUE NO.

EYE OF THE SUN - SUN LIGHT ACCESS SCHEDULE

Project No. 19043

Project PROPOSED RESIDENTIAL FLAT BUILDING

Address 44-48 Rodley Avenue, Penrith, NSW, 2750

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No.	Туре	Solar & Daylight Access	Time	Hours
GROUN	ND LEVEL			
01	2 BED Adaptable	Yes	From 9:00am to 3:00pm	6:00 hours
02	3 BED Adaptable	Yes	From 9:00am to 3:00pm	6:00 hours
03	2 BED	No	From 12:00pm to 1:30pm	1:30 hours
04	2 BED	No	-	0:00 hours
LEVEL	1	<u>'</u>		
11	2 BED	Yes	From 9:00am to 3:00pm	6:00 hours
12	2 BED Adaptable	Yes	From 9:00am to 3:00pm	6:00 hours
13	2 BED	Yes	From 9:00am to 3:00pm	6:00 hours
14	2 BED	Yes	From 9:00am to 3:00pm	6:00 hours
15	2 BED	No	From 2:00pm to 3:00pm	1:00 hours
16	2 BED	No	-	0:00 hours
17	2 BED	Yes	From 9:00am to 11:00am	2:00 hours
LEVEL	2			,
21	2 BED	Yes	From 9:00am to 3:00pm	6:00 hours
22	2 BED	Yes	From 9:00am to 3:00pm	6:00 hours
23	2 BED	Yes	From 9:00am to 3:00pm	6:00 hours
24	2 BED	Yes	From 9:00am to 3:00pm	6:00 hours
25	2 BED	No	From 2:00pm to 3:00pm	1:00 hours
26	2 BED	No	-	0:00 hours
27	2 BED	Yes	From 9:00am to 11:00am	2:00 hours
LEVEL:	3			,
31	2 BED	Yes	From 9:00am to 3:00pm	6:00 hours
32	2 BED	Yes	From 9:00am to 3:00pm	6:00 hours
33	2 BED	Yes	From 9:00am to 3:00pm	6:00 hours
34	2 BED	Yes	From 9:00am to 3:00pm	6:00 hours
35	2 BED	No	From 2:00pm to 3:00pm	1:00 hours
36	2 BED	No	-	0:00 hours
37	2 BED	Yes	From 9:00am to 11:00am	2:00 hours
LEVEL	4		•	'
41	3 BED	Yes	From 9:00am to 3:00pm	6:00 hours
42	3 BED	Yes	From 9:00am to 3:00pm	6:00 hours
43	2 BED	Yes	From 10:00am to 3:00pm	5:00 hours
44	2 BED	Yes	From 9:00am to 3:00pm	6:00 hours

12.4%

DRAWING NUMBER

EOS15

ISSUE NO.




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PROPOSED RESIDENTIAL FLAT BUILDING

44-48 Rodley Avenue, Penrith, NSW, 2750





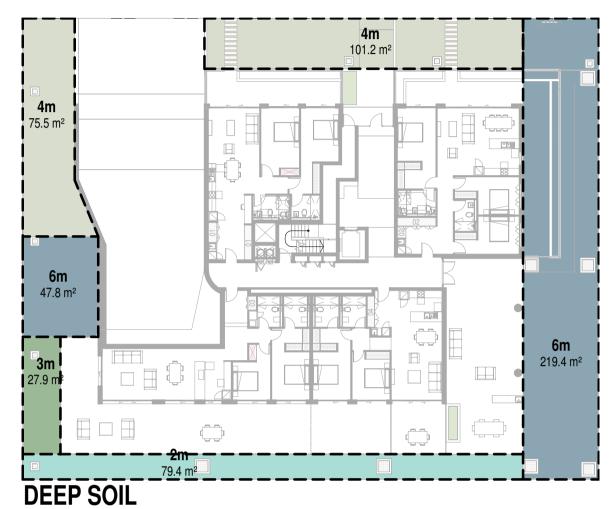

LANDSCAPE AREA

1:300



COS AREA

1:300

DEVELOPI	MENT DETAILS	
Site Area		1672m²
Gross Floor Area (GFA)		2958m²
Zoning	R4 High Density Residential	
	Allowable	Proposed
Floor Space Ratio (FSR)*	n/a	1.77:1
Total Storeys	5	5

Communal Open Space	25%	446.8m²	26%
Deep Soil Zones	7%	271.5m ²	16%

UNITS TYPES		
Туре	Count	
2 BED	25	
2 BED Adaptable	1	
3 BED	2	
3 BED Adaptable	1	
TOTAL APARTMENTS: 29		

GROSS FLOOR AREA		
Level	Area	
GROUND LEVEL	482.1 m ²	
LEVEL 1	678.5 m ²	
LEVEL 2	678.5 m ²	
LEVEL 3	678.5 m ²	
LEVEL 4	440.9 m ²	
	2958.4 m ²	

COMMON OPEN SPACE				
Name	Area	% of Site		
COS	257.4 m²	15.40		
	257.4 m ²	15.40		

DEEP SOIL AREA		
Name	Area	% the Site
6m	267.2 m ²	15.98
4m	176.7 m ²	10.57
3m	27.9 m ²	1.67
2m	79.4 m ²	4.75
	551.3 m ²	32.97

LANDSCAPE SCHEDULE		
Area	% the Site	
495.3 m²	29.62	
495.3 m ²	29.62	

CAR SPACES REQUIRED		
2 Bed units: 26	26	
3 Bed units: 3	6	
Visitors (1/5)	5	
Visitors		
Service vehicles (1/40)	1	
Washing bay (1/50)	00	
Grand total	38	

Type	Number
Class 1a - 2500w x 5400d (Resident)	29
Class 1a - 2500w x 5400d (Visitor)	6
Class 4 - 2400w x 5400d (Disabled)	3
	38

CAR SPACES - TYPES

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ISSUE	DATE	AMENDMENT	LEGENDS / NOTES:
Α	2021-03-04	DA SUBMISSION	BR BEDROOM COM COMMS CUPBOARD
			DP DOWNPIPE
			E ELECTRICAL CUPBOAR
			FHR FIRE HOSE REEL

GAS GAS CUPBOARD

GEX GARBAGE EXHAUST TOH TOP OF HOB

N	NOMINATED ARCHITECT - P F
N	MORSON REGISTRATION NUMBER 8100
	ACN 159 480 056, ABN 41 159 480 056
	www.morsongroup.com.au
	(02) 9380 4946
	PO Box 170. Potts Point, NSW 1335

SHEET SIZE: A1 SHEET NAME: VIEW AND SCHEDULES SCALE: As indicated

ISSUE No.

Document Set ID: 9517691 Version: 1, Version Date: 19/03/2021



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ABN 41 159 480 056 NOMINATED ARCHITECT: P Morson(8100)

ISSUE DATE AMENDMENT

A 2021-03-04 DA SUBMISSION

LEGENDS / NOTES:

BR BEDROOM GAS GAS CUPBOARD RWORAINWATER OUTLET
COM COMMS CUPBOARD GD GRATED DRAIN SWP STORM WATER PIT
DP DOWNPIPE GEX GARBAGE EXHAUST TOH TOP OF HOB
E ELECTRICAL CUPBOARD MBX MAILBOX TOW TOP OF WALL
FHR FIRE HOSE REEL RL RELATIVE LEVEL TTI TACTILE INDICATORS

PROJECT
PROPOSED RESIDENTIAL FLAT BUILDING
ADDRESS
44-48 Rodley Avenue, Penrith, NSW, 2750

PROJECT No. 1904

CLIENT
Inglow Investments Two

NOMINATED ARCHITECT - P F MORSON REGISTRATION NUMBER 81 ACN 159 480 056, ABN 41 159 480 05 www.morsongroup.com.au (02) 9380 4946 PO Box 170, Potts Point, NSW 1335

SHEET SHEET SHEET SHEET SHEET SAME: 3D VIEWS

SCALE:

ISSUE No.









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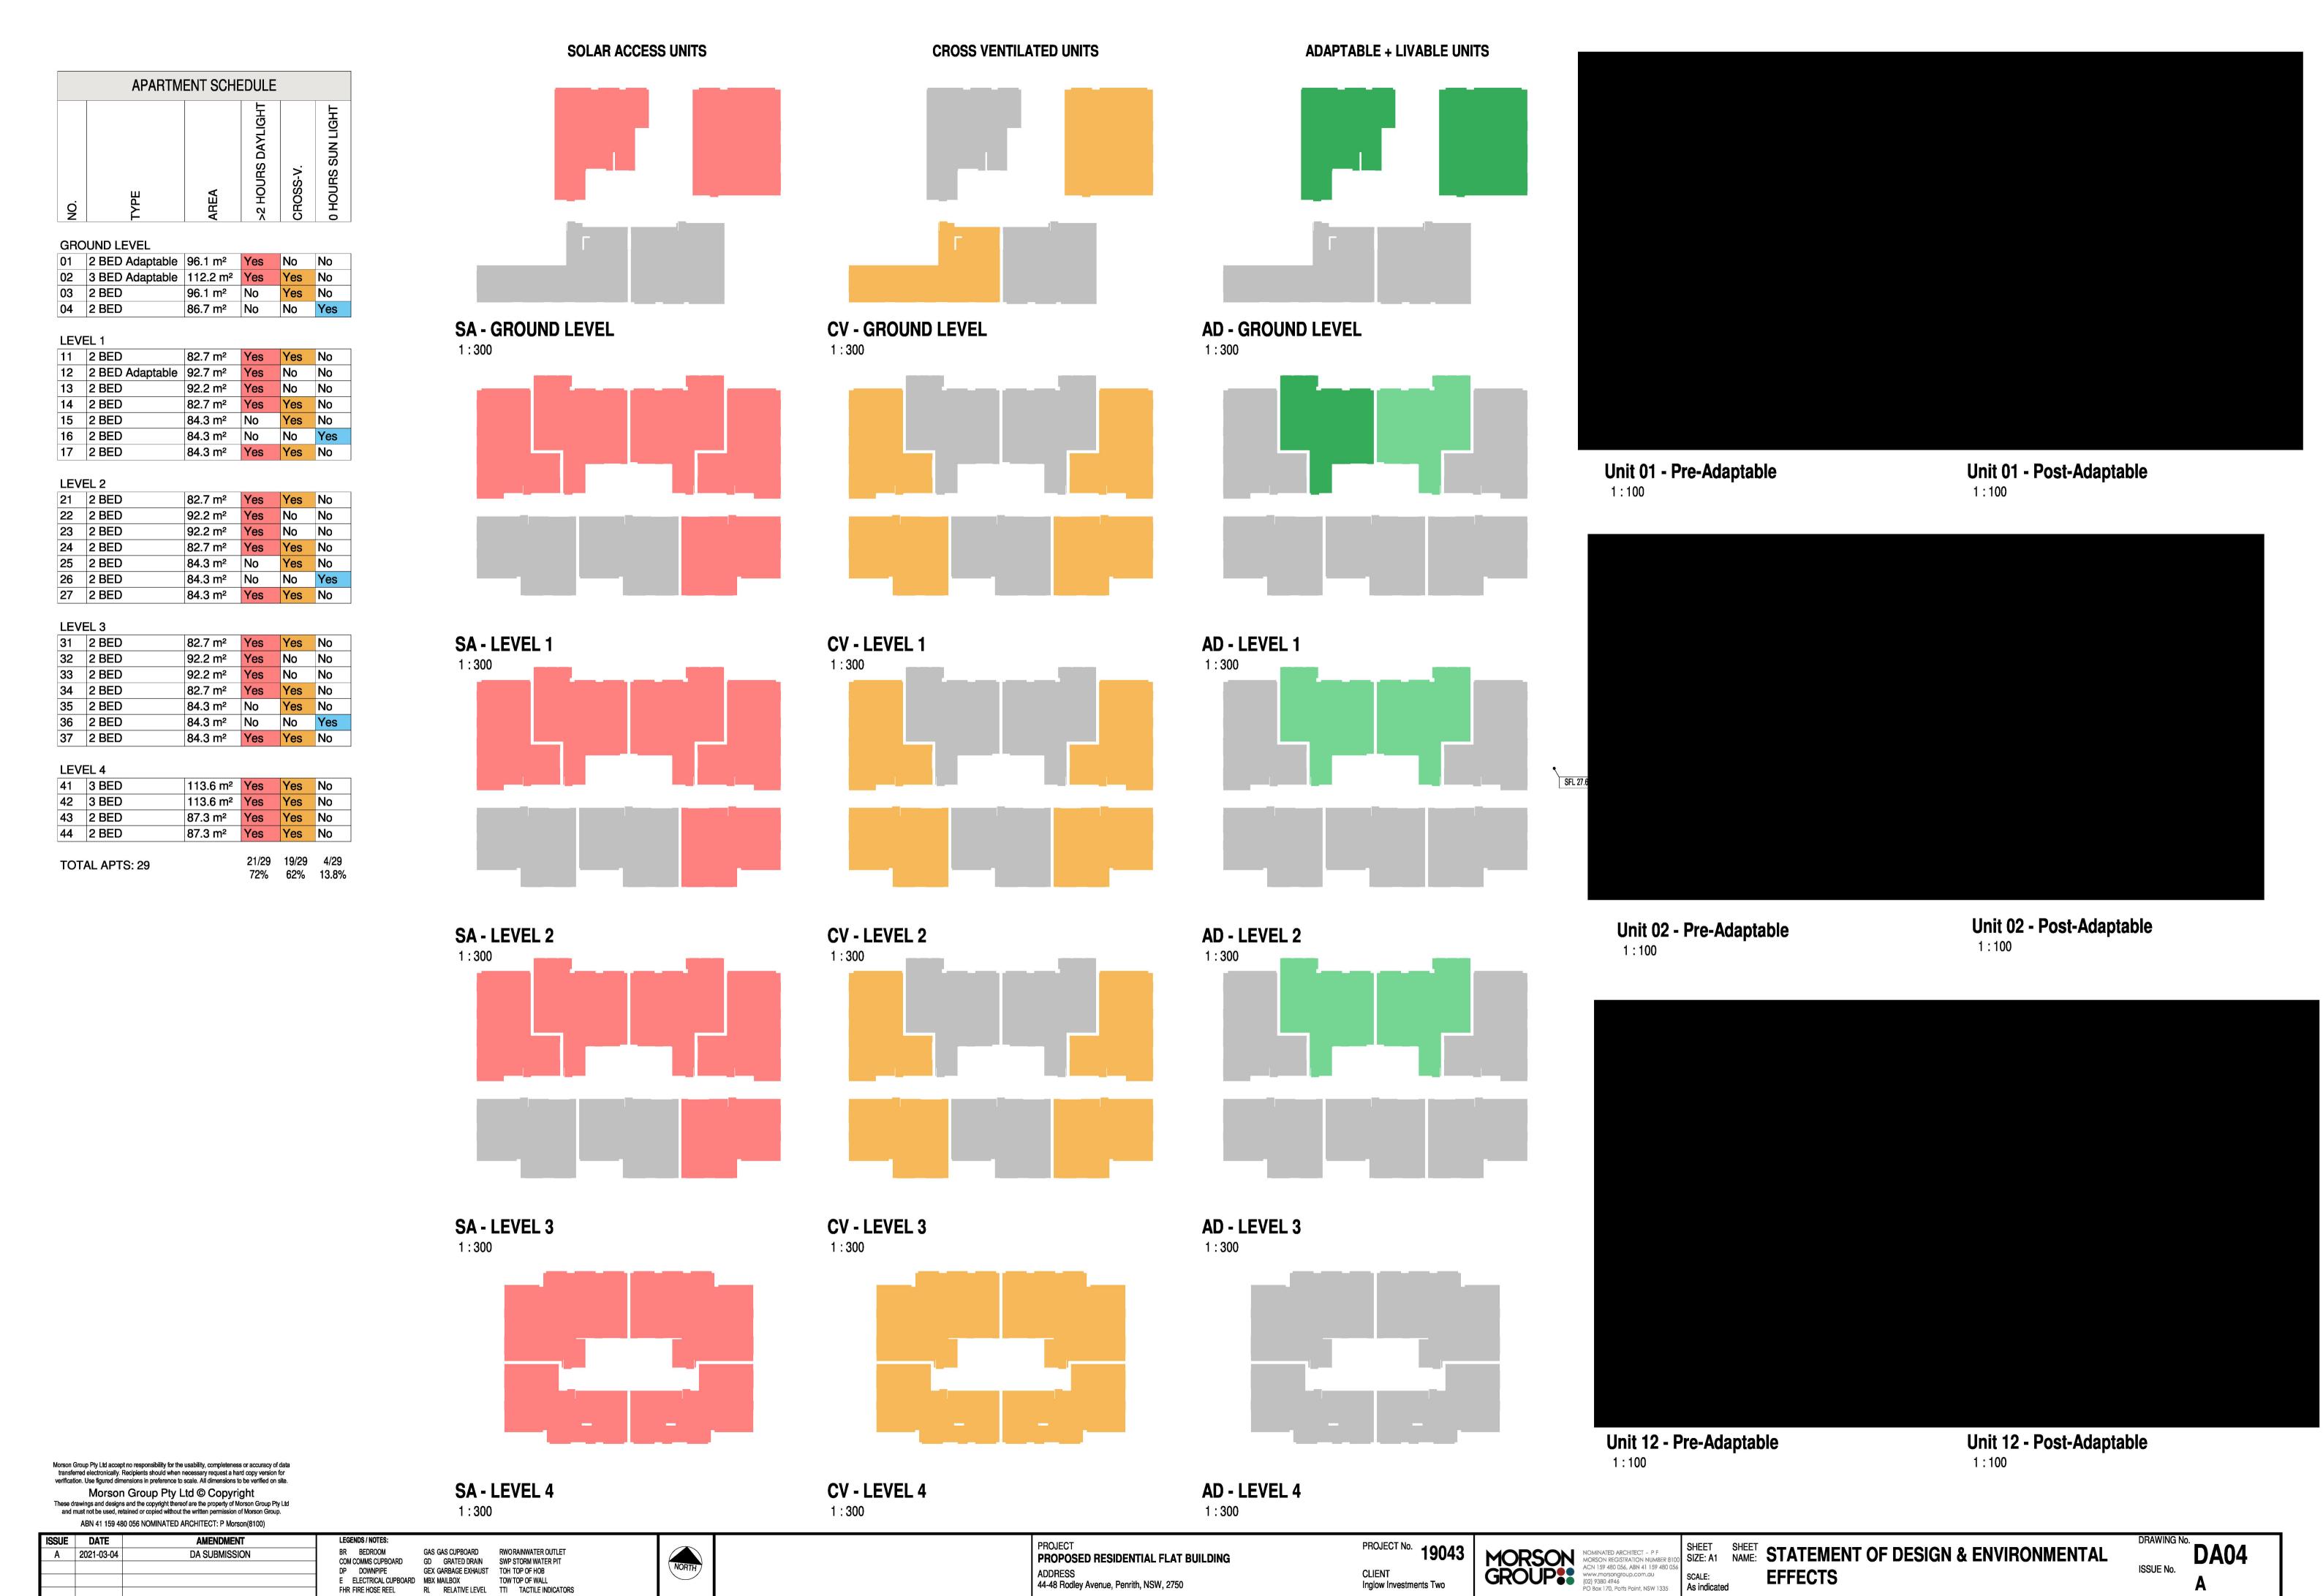
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ABN 41 159 480 056 NOMINATED ARCHITECT: P Morson(8100) ISSUE DATE AMENDMENT A 2021-03-04 DA SUBMISSION

SHEET SHEET 3D VIEWS SCALE:

ISSUE No.



44-48 Rodley Avenue, Penrith, NSW, 2750

CLIENT

Inglow Investments Two

03/03/2021 10:32:14 Document Set ID: 9517691

Version: 1, Version Date: 19/03/2021

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GEX GARBAGE EXHAUST TOH TOP OF HOB

E ELECTRICAL CUPBOARD MBX MAILBOX TOW TOP OF WALL
FHR FIRE HOSE REEL RL RELATIVE LEVEL TTI TACTILE INDICATORS

FHR FIRE HOSE REEL

EFFECTS

SCALE:

As indicated

Design Criter	ria	Compliance	Design Proposal		Design Criteria	Compliance	Design Proposal
2. Developme principal usab	al open space has a minimum area equal to 25% of the site ents achieve a minimum of 50% direct sunlight to the ble part of the communal open space for a minimum of 2 hours m and 3 pm on 21 June (mid winter)	NO	There is a total combined Communal Open Space Area of 257.4m². As a percentage of the site, this equates to 15%. The ADG has numerical requirements for COS provision however the intention is for a suitably located and designed space that accommodates and encouraged congregation and social interaction. The location of the space, design of the space, and visual access into the space provides for design quality in order to supports a variation to the numerical requirements.	4D-1	Apartments are required to have the following minimum internal areas: Apartment type	YES	All minimum apartment sizes are achieved
	zones are to meet the following minimum requirements: Min. Dimension Deep Soil Zone (% of site Area)	YES	There is a total combined Deep Soil Area of 551.3m². As a percentage of the site, this equates to 33%; exceeding the minimum requirement. The Deep Soil with a minimum dimension of 6m equals to 267m², 17% of the site		minimum glass area of not less than 10% of the floor area of the room. Daylight and air may not be borrowed from other rooms.		
650m²-1,500m² >1,500m²	2 3m 7% 6m			4D-2	Habitable room depths are limited to a maximum of 2.5 x the ceiling height In open plan layouts (where the living, dining and kitchen are combined) the maximum habitable room depth is 8m from a window		All habitable room depths comply with the calculation (2.5 x ceiling height) All habitable room depths, with open plan layouts, are less than 8m from a window
visual privacy buildings to the Building Height up to 12m (4 store up to 25m (5-8 store over 25m (9+ store	reys) 6m 3m storey) 9m 4.5m	YES	Refer to Statement of Environmental Effects (SEE) for a detailed building separation summary	4D-3	1. Master bedrooms have a minimum area of 10m² and other bedrooms to have 9m² (excluding wardrobe space) 2. Bedrooms have a minimum dimension of 3m (excl. wardrobe space) 3. Living rooms or combined living/dining rooms have a minimum width of: • 3.6m for studio and 1 bed apartments • 4m for 2 and 3 bedroom apartments		All Master Bedrooms have a minimum area of 10m². In a majority of the apartments, the second bedroom is also 10m².
	stances between neighbouring properties.			4E-1	Dwelling type Minimum area Minimum depth	YES	All minimum primary balcony sizes are met.
building receiv pm at mid wint Wollongong lo	ms and private open spaces of at least 70% of apartments in a live a minimum of 2 hours direct sunlight between 9 am and 3 nter in the Sydney Metropolitan Area and in the Newcastle and local government areas. In of 15% of apartments in a building receive no direct ween 9 am and 3 pm at mid winter	YES	A total of 21/29 apartments receive a minimum of 2 hours direct sunlight between 9am and 3pm at mid winter. This equates to 72%		Studio apartments 4m² - 1 bedroom apartments 8m² 2m 2 bedroom apartments 10m² 2m 3+ bedroom apartments 12m² 2.4m The minimum balcony depth to be counted as contributing to the balcony area is 1m. 2. For apartments at ground level or on a podium or similar structure, a private open space is provided instead of a balcony. It must have a minimum area of 15m² and a minimum depth of 3m		
storeys of the be cross venti allows adequa 3. Overall dep	% of apartments are naturally cross ventilated in the first nine building. Apartments at ten storeys or greater are deemed to tilated only if any enclosure of the balconies at these levels at natural ventilation and cannot be fully enclosed pth of a cross-over or cross-through apartment does not measured glass line to glass line	YES N/A	A total of 18/29 apartments are naturally cross ventilated. This equates to 62% and exceeds to minimum of 60%. Due to the nature of the design and creation of corner apartments, this will provide great amenity. There are no cross-over apartments in the proposed design.	4F-1	The maximum number of apartments off a circulation core on a single level is eight For buildings of 10 storeys and over, the maximum number of apartments sharing a single lift is 40	YES	The maximum number of apartments off a circulation core is 7.
1 Measured from	om finished floor level to finished ceiling um ceiling heights are: g height for apartment and mixed use buildings	YES	As we have allowed 3100mm between each level, all minimum ceiling heights can realistically be achieved.	4G-1	1. In addition to storage in kitchens, bathrooms and bedrooms, the following storage is provided: Apartment type	YES	Refer to DA04

Design Statement (SEPP65-2015 SCHEDU	JLE I - De	sign Quanty Finiciples					
Principle 1: Context and Neighbourhood Character		Principle 2: Built Form and Scale		Principle 3: Density		Principle 4: Sustainability	
The proposed development significantly contributes to the local context & cha area. By providing a diverse range of apartment options which are affordable demographic of people, it not only assists with the densification issue currently but also provides social & economic benefits for the community. These includ businesses, improvement to environmental conditions ie. parks, roads (throug and social interaction & participation in community events just to name a few. The Landscaping strategy has been critically analysed to ensure that is not or existing character of the neighbourhood, but also the future character. If each can do the same, it will create a continous green network of planting. By doing only achknowledge the key built & natural features of the area, but also impro	for a wider y within Sydney, e new gh contributions) nly enhances the development g so, it will not	If you were to walk down Rodley Ave. today, the local new summarised by single storey, detached residences with however is not an accurate depiction of the future characteriver or six storey residential flat buildings have been develowed and others are under review. With this in mind we made appropriately consider the future neighbourhood context. The built form & public domain are clearly defined with a trees lining the site. To minimise visual & acoustic privaction balcony areas to the North & South. This will provide a mactivation specifically to Rodley Ave. All side & rear settle reduce overshadowing on the surrounding properties. Set information.	I-2 buildings under construction. This ster of Rodley Ave. Currently, a few reloped, some have an approved DA some critical design decisions to central entry way & a row of canopy y issues, we located all of the private lore desirable outlook and increase ack are generally compliant in order to	Increased supply of various housing of the increased levels of densification. The proposal aims to cater for a diver into the housing market. Located with good potential renting posibilities for of facilities within Penrith (and the great- work being done on the local environ-	options at an affordable price is key in dealing with rese number of individuals & families looking to get an affordable price is key in dealing with rese number of individuals & families looking to get an walking distance to Penrith CBD, it provides owners. Similarly, the number of jobs & community er region) continues to increase, not to mention the ment; specifically at the Nepean River. Both Penrith exproximity to the development, as well as locally the Northern Rd (150m walk)	provide amenity the creating numerous heating or cooling Additional to this, and daylight all year roon each level, we This is amass with	arge temperature variation between Winter & Summer Solstice, the need to arough passive design was one of the key drivers for the proposal. By a corner apartments, it allows natural ventilation rather than mechanical we have ensured that over 72% of the apartments will have great access to und. This will reduce the reliance on artificial lighting and in turn, energy. have provided a Bin Chute system with both Residual & Recycling options. in the waste rooms (Basement 1) and be collected multiple times throughout e it is being dealt with responsively.
Good design responds and contributes to its context. Context is the key natural and built features of a and the character they create when combined. It also includes social, economic, health and environment Responding to context involves identifying the desirable elements of an area's existing or future characters.	ental conditions. cter. Well designed	Good design achieves a scale, bulk and height appropriate to the existing surrounding buildings.	or desired future character of the street and			Good design combines	s positive environmental, social and economic outcomes.
buildings respond to and enhance the qualities and identity of the area including the adjacent sites, st. neighbourhood.	reetscape and	Good design also achieves an appropriate built form for a site and the built proportions, building type, articulation and the manipulation of building ele		Good design achieves a high level of amenity fo and its context.	r residents and each apartment, resulting in a density appropriate to the site	Good sustainable desi	rendering includes use of natural cross ventilation and sunlight for the amenity and liveability of residents and
Consideration of local context is important for all sites, including sites in established areas, those under identified for change.	ergoing change or	Appropriate built form defines the public domain, contributes to the character and vistas, and provides internal amenity and outlook.	ter of streetscapes and parks, including their views		ea's existing or projected population. Appropriate densities can be sustained insport, access to jobs, community facilities and the environment.		n for ventilation, heating and cooling reducing reliance on technology and operation costs. Other sling and reuse of materials and waste, use of sustainable materials and deep soil zones for and vegetation.
Principle 5: Landscape	Principle 6: Amenity		Principle 7: Safety		Principle 8: Housing Diversity & Social Interaction		Principle 9: Aesthetics
opportunity for Social Interaction in the Common Open Space. We want the Landscaping & Building to work together & compliment one another. To	proposal is critica of the apartments ventilation. Over sunlight all year or To mitigate visual propose a variety position, complete As we have caref generally screenes shielding the hot	than adequate amenity for the future inhabitants of the illy important to us. The shape and general arrangement is are efficient, spacious & a large majority allow for natural 72% of the apartments will receive great access to ound; reducing the requirements for artificial lighting. I privacy concerns associated to building separation, we of extruded elements which, when placed in the correct ely eliminate any privacy issues. Fully considerd the landscaping strategy, residents are ed by large canopy trees, which also contribute towards summer sun whilst providing another level of creatment to the surrounding context.	Residents enter through a central wal defined access point & into the entry f adequately lit at night, the windows pr overlooks the surrounded area; encountimes. Many developments have a number of are located at the rear of the building, residents feel most unsafe & uncomfor eliminated this from our design & simple the private terraces.	foyer. Not only will the main entry be ovided at the end of the corridors uraging passive surveillance at all of walkways & common spaces which From our experience, this is where oratble. With this in mind, we oly improved the size & amenity of	Residential areas of Penrith have traditionally included a detached housing (3br+) with a scattering of villa develop to the Penrith CBD (2br+). With the recent rezoning to R4 Residential, the proposed development aligns itself to the demographic while providing increase density to respond demands of the growing outer suburban ring of Western 1. The development features a mix of 2br & 3br apartments responds to current market demands in the area. Located Sydney, apartments prices are considerably lower than in equivalents which facilitates affordability by default.	ments closer I High-Density existing to the Sydney. which also d in Western	Typically, the streetscape character of the area is predominantly individual, free standing houses. Now re-zoned & unrealistic for increased densification, we believe it is important to bring that character through in our facade treatment & overall building envelope. The design similarly considers the internal layout & structure of the building as a priority to ensure amenity & functionaly is not sacrificed. The East & West elevations have bee carefully considered. Using a variety of colours, horizontal & vertical elements, we have broken down the scale of the building and provided a suitable transition between the North & South facade differences.
Good design recognises that together landscape and buildings operate as an integrated and sustainable system, resulting in attractive developments with good amenity. A positive image and contextual fit of well designed developments is achieved by contributing to the landscape character of the streetscape and neighbourhood. Good landscape design enhances the development's environmental performance by retaining positive natural features which contribute to the local context, co-ordinating water and soil management, solar access, micro-climate, tree canopy, habitat values and preserving green networks. Good landscape design optimises useability, privacy and opportunities for social interaction,	Good design positivel Achieving good amen	ly influences internal and external amenity for residents and neighbours. ity contributes to positive living environments and resident well being. nes appropriate room dimensions and shapes, access to sunlight, natural	All of the public & private spaces are of the local neighbourhood. Good design optimises safety and security within provides for quality public and private spaces the purpose. Opportunities to maximise passive surv safety. A positive relationship between public and private	n the development and the public domain. It at are clearly defined and fit for the intended veillance of public and communal areas promote	Social interaction between residents of the development is the design of the lift lobby. It is a pleasant space to interact at 2 sides with views to the outside world and direct connectifit access point. Good design achieves a mix of apartment sizes, providing housing choice for demographics, living needs and household budgets. Well designed apartment developments respond to social context by providing to suit the existing and future social mix.	ct as itis open ection to the	Good design achieves a built form that has good proportions and a balanced composition of elements, reflecting the internal layout and structure. Good design uses a variety of materials, colours and textures.

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ABN 41 159 480 056 NOMINATED ARCHITECT: P Morson(8100) ISSUE DATE A 2021-03-04 DA SUBMISSION

PROJECT PROPOSED RESIDENTIAL FLAT BUILDING 44-48 Rodley Avenue, Penrith, NSW, 2750

CLIENT

Inglow Investments Two

MORSON GROUP:

SCALE:

STORAGE

| Unit / Location | Height | Width | Depth | Volume

Basement 2650 846 2801 6.28 m³

Unit 2650 600 1500 2.39 m³

 Basement
 2650
 846
 2801
 6.28 m³

 Unit
 2650
 600
 3000
 4.77 m³

Basement 2650 923 2801 6.85 m³

Unit 2650 600 1035 1.65 m³

Basement 2650 1190 2200 6.94 m³ 2650 500 2410 3.19 m³

 Basement
 2650
 2137
 903
 5.12 m³

 Unit
 2650
 1650
 800
 3.50 m³

Basement 2650 800 2815 5.97 m³

Basement 2650 2137 903 5.12 m³

Basement 2650 2137 903 5.12 m³ Unit 2650 1650 800 3.50 m³

Basement 2650 2137 903 5.12 m³

 Basement
 2650
 2137
 903
 5.12 m³

 Unit
 2650
 1600
 500
 2.12 m³

 Unit
 2650
 500
 1500
 1.99 m³

GROUND LEVEL

LEVEL 1

2 BED Adaptable

2 BED

2 BED 2 BED

2 BED

2 BED

2 BED

2 BED

2 BED

2 BED

3 BED

3 BED

2 BED

2 BED

LEVEL 3

LEVEL 4

UNITS: 29

3 BED Adaptable

2 BED Adaptable

2650 1650 800 3.50 m³

2650 1395 1025 3.79 m³

2650 1395 1025 3.79 m³

2650 1600 500 2.12 m³

2650 500 1500 1.99 m³

9.22 m³

2650 500 2700 3.58 m³

2650 600 845 1.34 m³

12.39 m³

8.50 m³

Unit / Location | Height | Width | Depth | Volume

Basement 2650 2137 903 5.12 m³

 Unit
 2650
 1600
 500
 2.12 m³

 Unit
 2650
 500
 1500
 1.99 m³

 Basement
 2650
 2137
 903
 5.12 m³

 Unit
 2650
 1650
 800
 3.50 m³

Basement 2650 2137 903 5.12 m³

Basement 2650 2137 903 5.12 m³

Unit 2650 1395 1025 3.79 m³

Basement 2650 2137 903 5.12 m³

Unit 2650 1650 800 3.50 m³

Basement 2650 2137 903 5.12 m³

Basement 2650 2137 903 5.12 m³

Basement 2650 2137 903 5.12 m³

 Basement
 2650
 2137
 903
 5.12 m³

 Unit
 2650
 1650
 800
 3.50 m³

 Basement
 2650
 2137
 903
 5.12 m³

 Unit
 2650
 1395
 1025
 3.79 m³

SOLAR ACCESS - COMPLIANCE TABLE

From 9:00am to 3:00pm

From 2:00pm to 3:00pm

From 9:00am to 11:00am

From 9:00am to 3:00pm

From 9:00am to 3:00pm

From 9:00am to 3:00pm

From 9:00am to 3:00pm

From 2:00pm to 3:00pm

From 9:00am to 11:00am

From 9:00am to 3:00pm

From 9:00am to 3:00pm

From 9:00am to 3:00pm

From 9:00am to 3:00pm

From 2:00pm to 3:00pm

From 9:00am to 11:00am

From 9:00am to 3:00pm

From 9:00am to 3:00pm

From 10:00am to 3:00pm

From 9:00am to 3:00pm

From 12:00pm to 1:30pm

Solar & Daylight Access

2650 500 1500 1.99 m³

2650 1600 500 2.12 m³

2650 500 1500 1.99 m³

2650 1600 500 2.12 m³

2650 500 1500 1.99 m³ 2650 1600 500 2.12 m³

2650 1395 1025 3.79 m³

9.22 m³

SHEET SIZE: A1 SHEET NAME: Compliance SEPP65 - Design Criteria & Objectives ISSUE No.

STORAGE

Unit / Location | Height | Width | Depth | Volume

Basement 2650 2137 903 5.12 m³

Unit 2650 1395 1025 3.79 m³

Basement 2650 2137 903 5.12 m³

Basement 2650 2400 900 5.72 m³

Basement 2650 2900 900 6.92 m³

Basement 2650 2137 903 5.12 m³

Hours

6:00 hours

6:00 hours

1:30 hours

6:00 hours

6:00 hours

6:00 hours

6:00 hours

1:00 hours

0:00 hours

2:00 hours

6:00 hours

6:00 hours

6:00 hours

6:00 hours 1:00 hours

0:00 hours

2:00 hours

6:00 hours

6:00 hours

6:00 hours

6:00 hours

1:00 hours

0:00 hours

2:00 hours

6:00 hours 6:00 hours

5:00 hours

6:00 hours

2650 1650 800 3.50 m³

2650 500 1500 1.99 m³

2650 1600 500 2.12 m³

2650 500 1500 1.99 m³

2650 1600 500 2.12 m³

2650 500 1500 1.99 m³ 2650 1600 500 2.12 m³

2650 500 3041 4.03 m³ 2650 500 1817 2.41 m³

2650 500 3041 4.03 m³ 2650 500 1817 2.41 m³

2650 500 2906 3.85 m³

2650 500 2906 3.85 m³

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GAS GAS CUPBOARD RWORAINWATER OUTLET

TOW TOP OF WALL

GD GRATED DRAIN SWP STORM WATER PIT

RL RELATIVE LEVEL TTI TACTILE INDICATORS

GEX GARBAGE EXHAUST TOH TOP OF HOB

and service areas and ease of access for all age groups and degrees of mobility.

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LEGENDS / NOTES:

BR BEDROOM


DP DOWNPIPE

COM COMMS CUPBOARD

FHR FIRE HOSE REEL

E ELECTRICAL CUPBOARD MBX MAILBOX



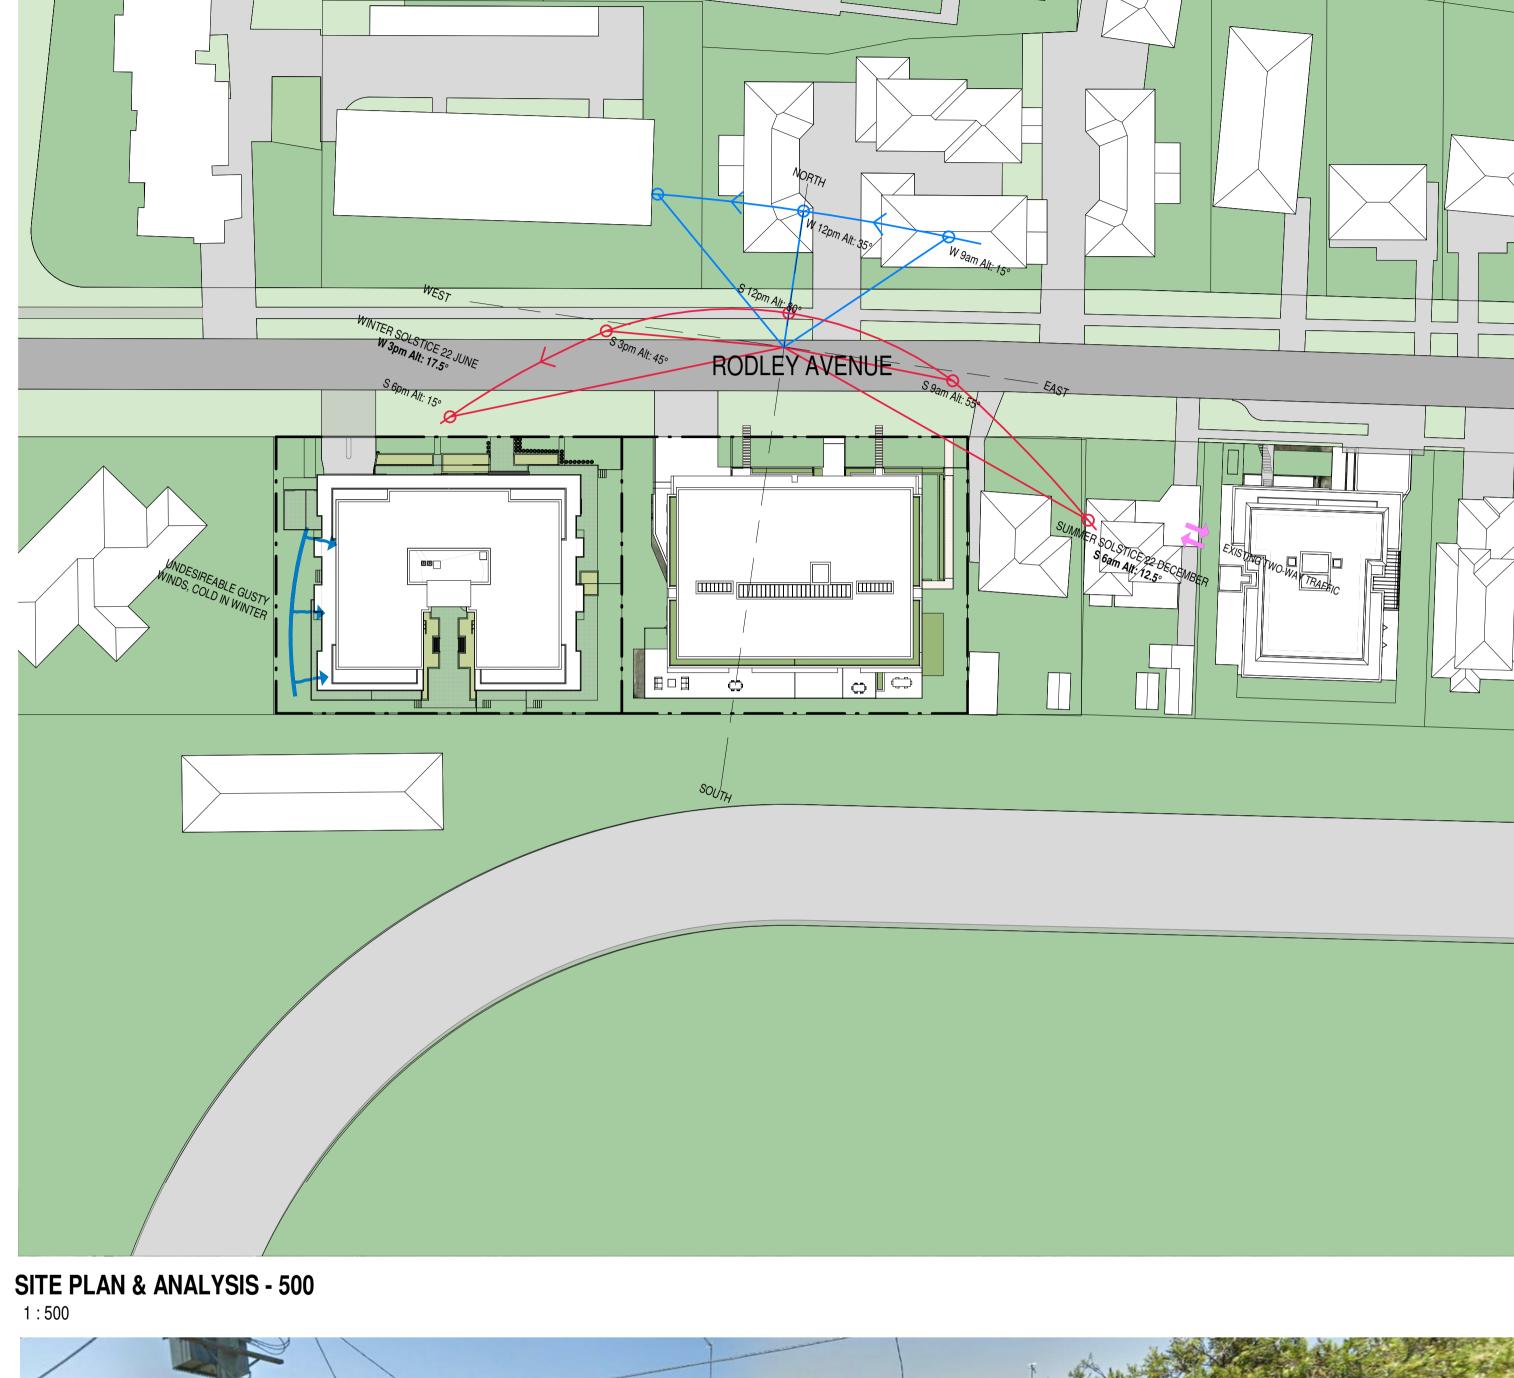

SITE PLAN - 1500

1:1500







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_	ABN 41 159 480 056 NOMINATED ARCHITECT: P Morson(8100)				
	ISSUE DATE AMENDMENT A 2021-03-04 DA SUBMISSION	LEGENDS / NOTES: BR BEDROOM GAS GAS CUPBOARD RWORAINWATER OUTLET COM COMMS CUPBOARD GD GRATED DRAIN SWP STORM WATER PIT DP DOWNPIPE GEX GARBAGE EXHAUST TOH TOP OF HOB E ELECTRICAL CUPBOARD MBX MAILBOX TOW TOP OF WALL FHR FIRE HOSE REEL RL RELATIVE LEVEL TTI TACTILE INDICATORS	NORTH	PROJECT PROPOSED RESIDENTIAL FLAT BUILDING ADDRESS 44-48 Rodley Avenue, Penrith, NSW, 2750 PROJECT No. 1904 CLIENT Inglow Investments Two	






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E ELECTRICAL CUPBOARD MBX MAILBOX TOW TOP OF WALL FIRE HOSE REEL RL RELATIVE LEVEL TTI TACTILE INDICATORS TOW TOP OF WALL (1:500@A3) SCALE: 44-48 Rodley Avenue, Penrith, NSW, 2750 SCALE: 1:250 SC	A 2021-03	3-04 DA SUBMISSION	E ELECTRICITE OUI DOMIND WIDE WINDER WITH TO THE TIME	0 5	PRC PR PR ADI 44-	ROJECT ROPOSED RESIDENTIAL FLAT BUILDING DDRESS 4-48 Rodley Avenue, Penrith, NSW, 2750 PROJECT No. 19043 CLIENT Inglow Investments Two	MORSON NOMINATED ARCHITECT - P F MORSON REGISTRATION NUMBER 8100 ACN 159 480 056, ABN 41 159 480 056 www.morsongroup.com.au (02) 9380 4946 PO Box 170 Patts Point NSW 1335	SHEET SIZE: A1 SHEET NAME: SITE ANALYSIS - STREETSCAPE / FORM STUDY SCALE: 1 · 250
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RODLEY AVENUE

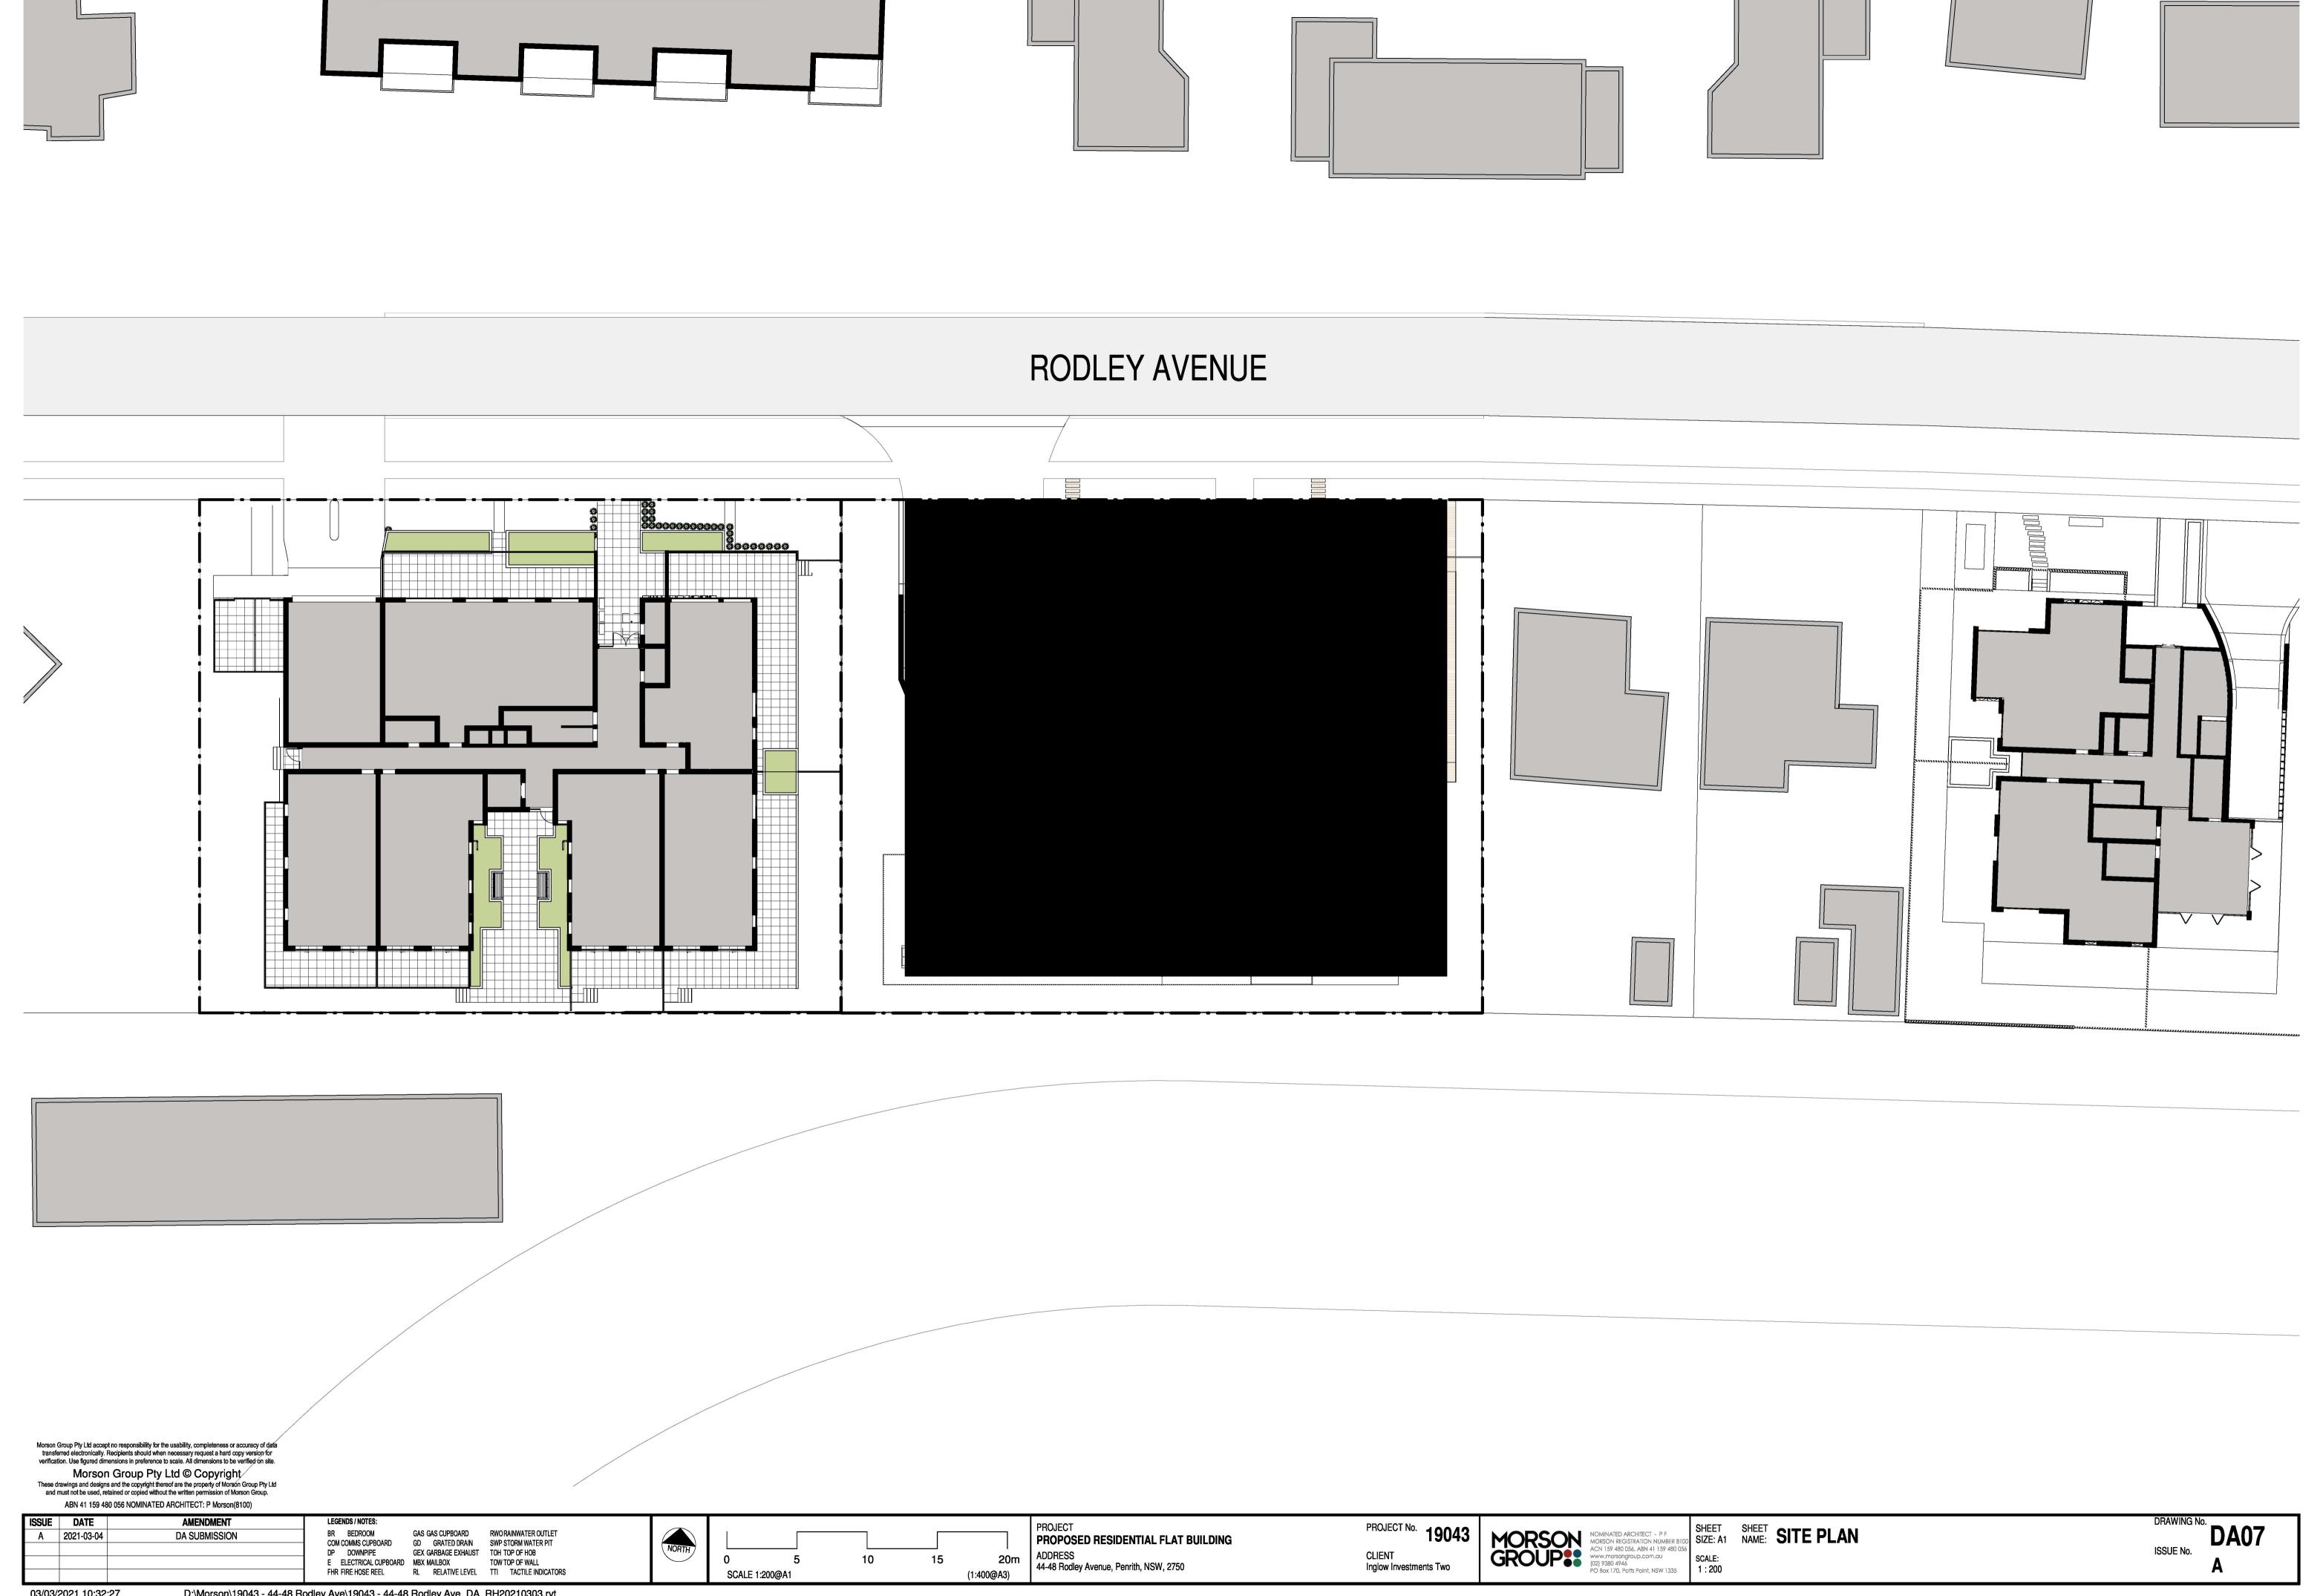
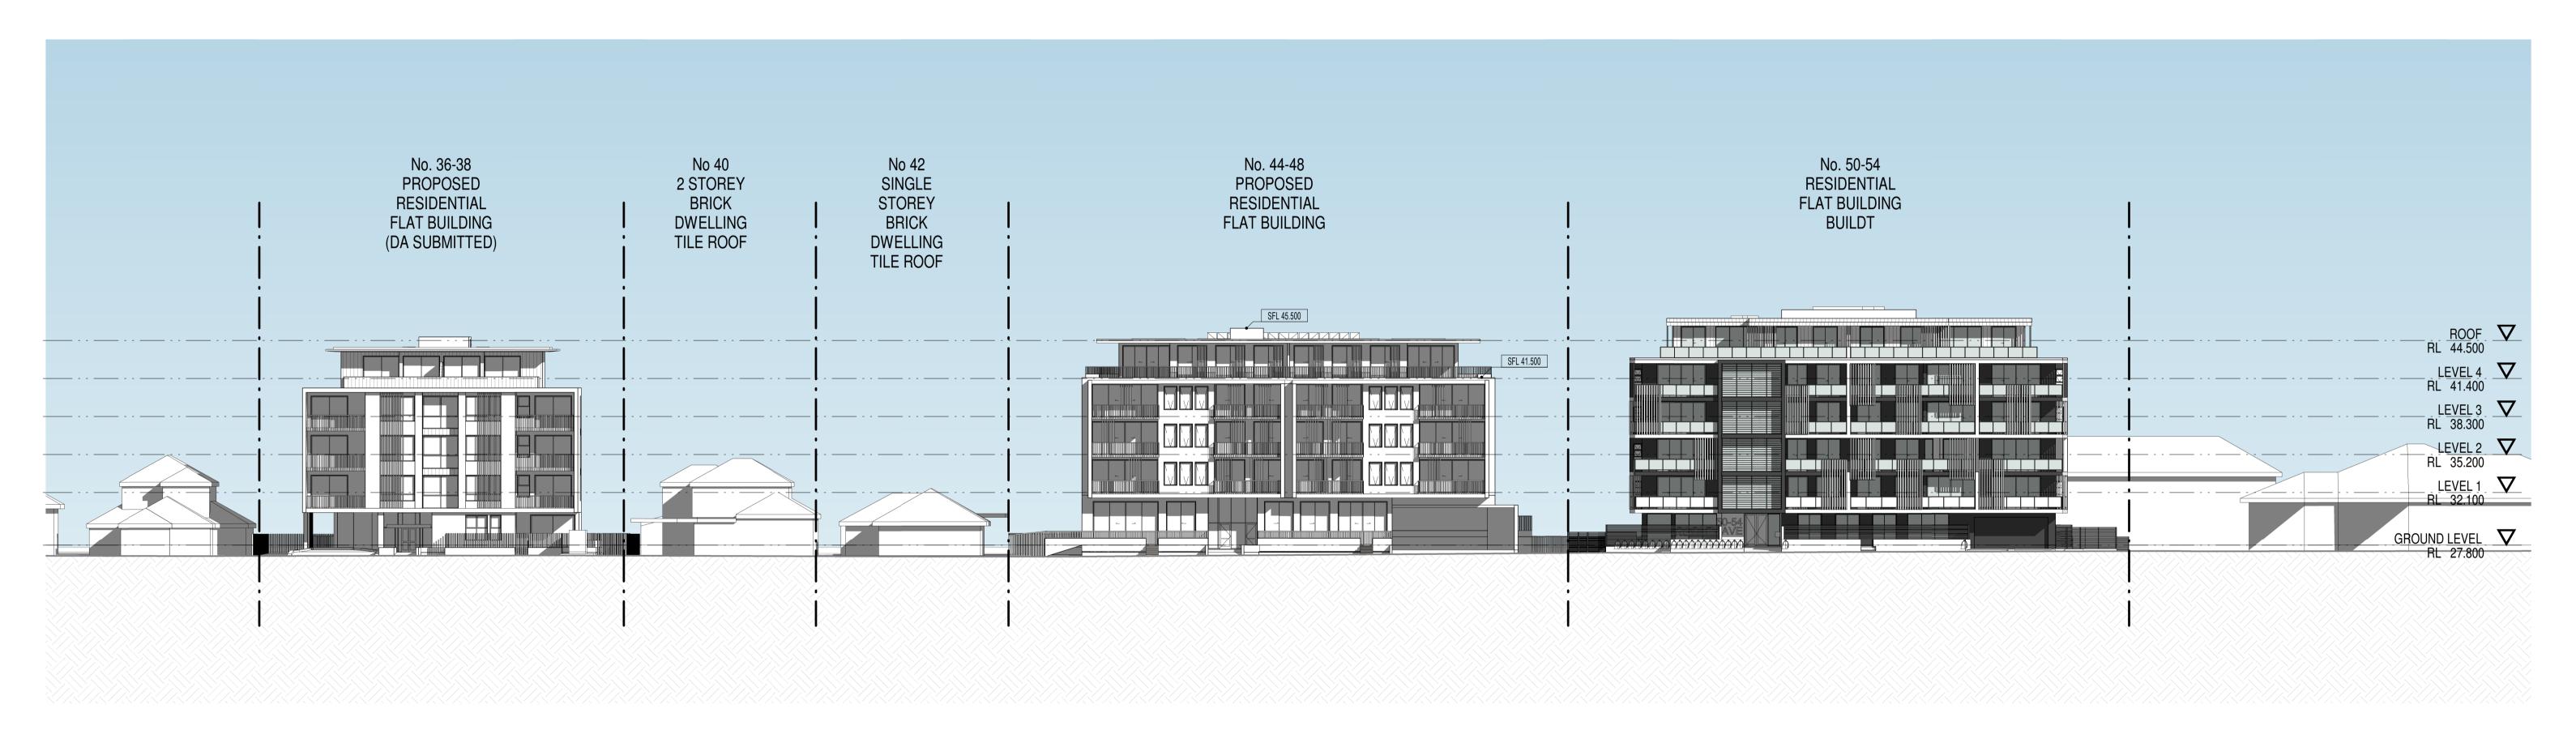
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ISSUE DATE AMENDMENT

A 2021-03-04 DA SUBMISSION

BR BEDROOM GAS GAS CUPBOARD RWORAINWATER OUTLET COM COMMS CUPBOARD GD GRATED DRAIN SWP STORM WATER PIT DP DOWNPIPE GEX GARBAGE EXHAUST TOH TOP OF HOB E ELECTRICAL CUPBOARD MBX MAILBOX TOW TOP OF WALL FHR FIRE HOSE REEL RL RELATIVE LEVEL TTI TACTILE INDICATORS

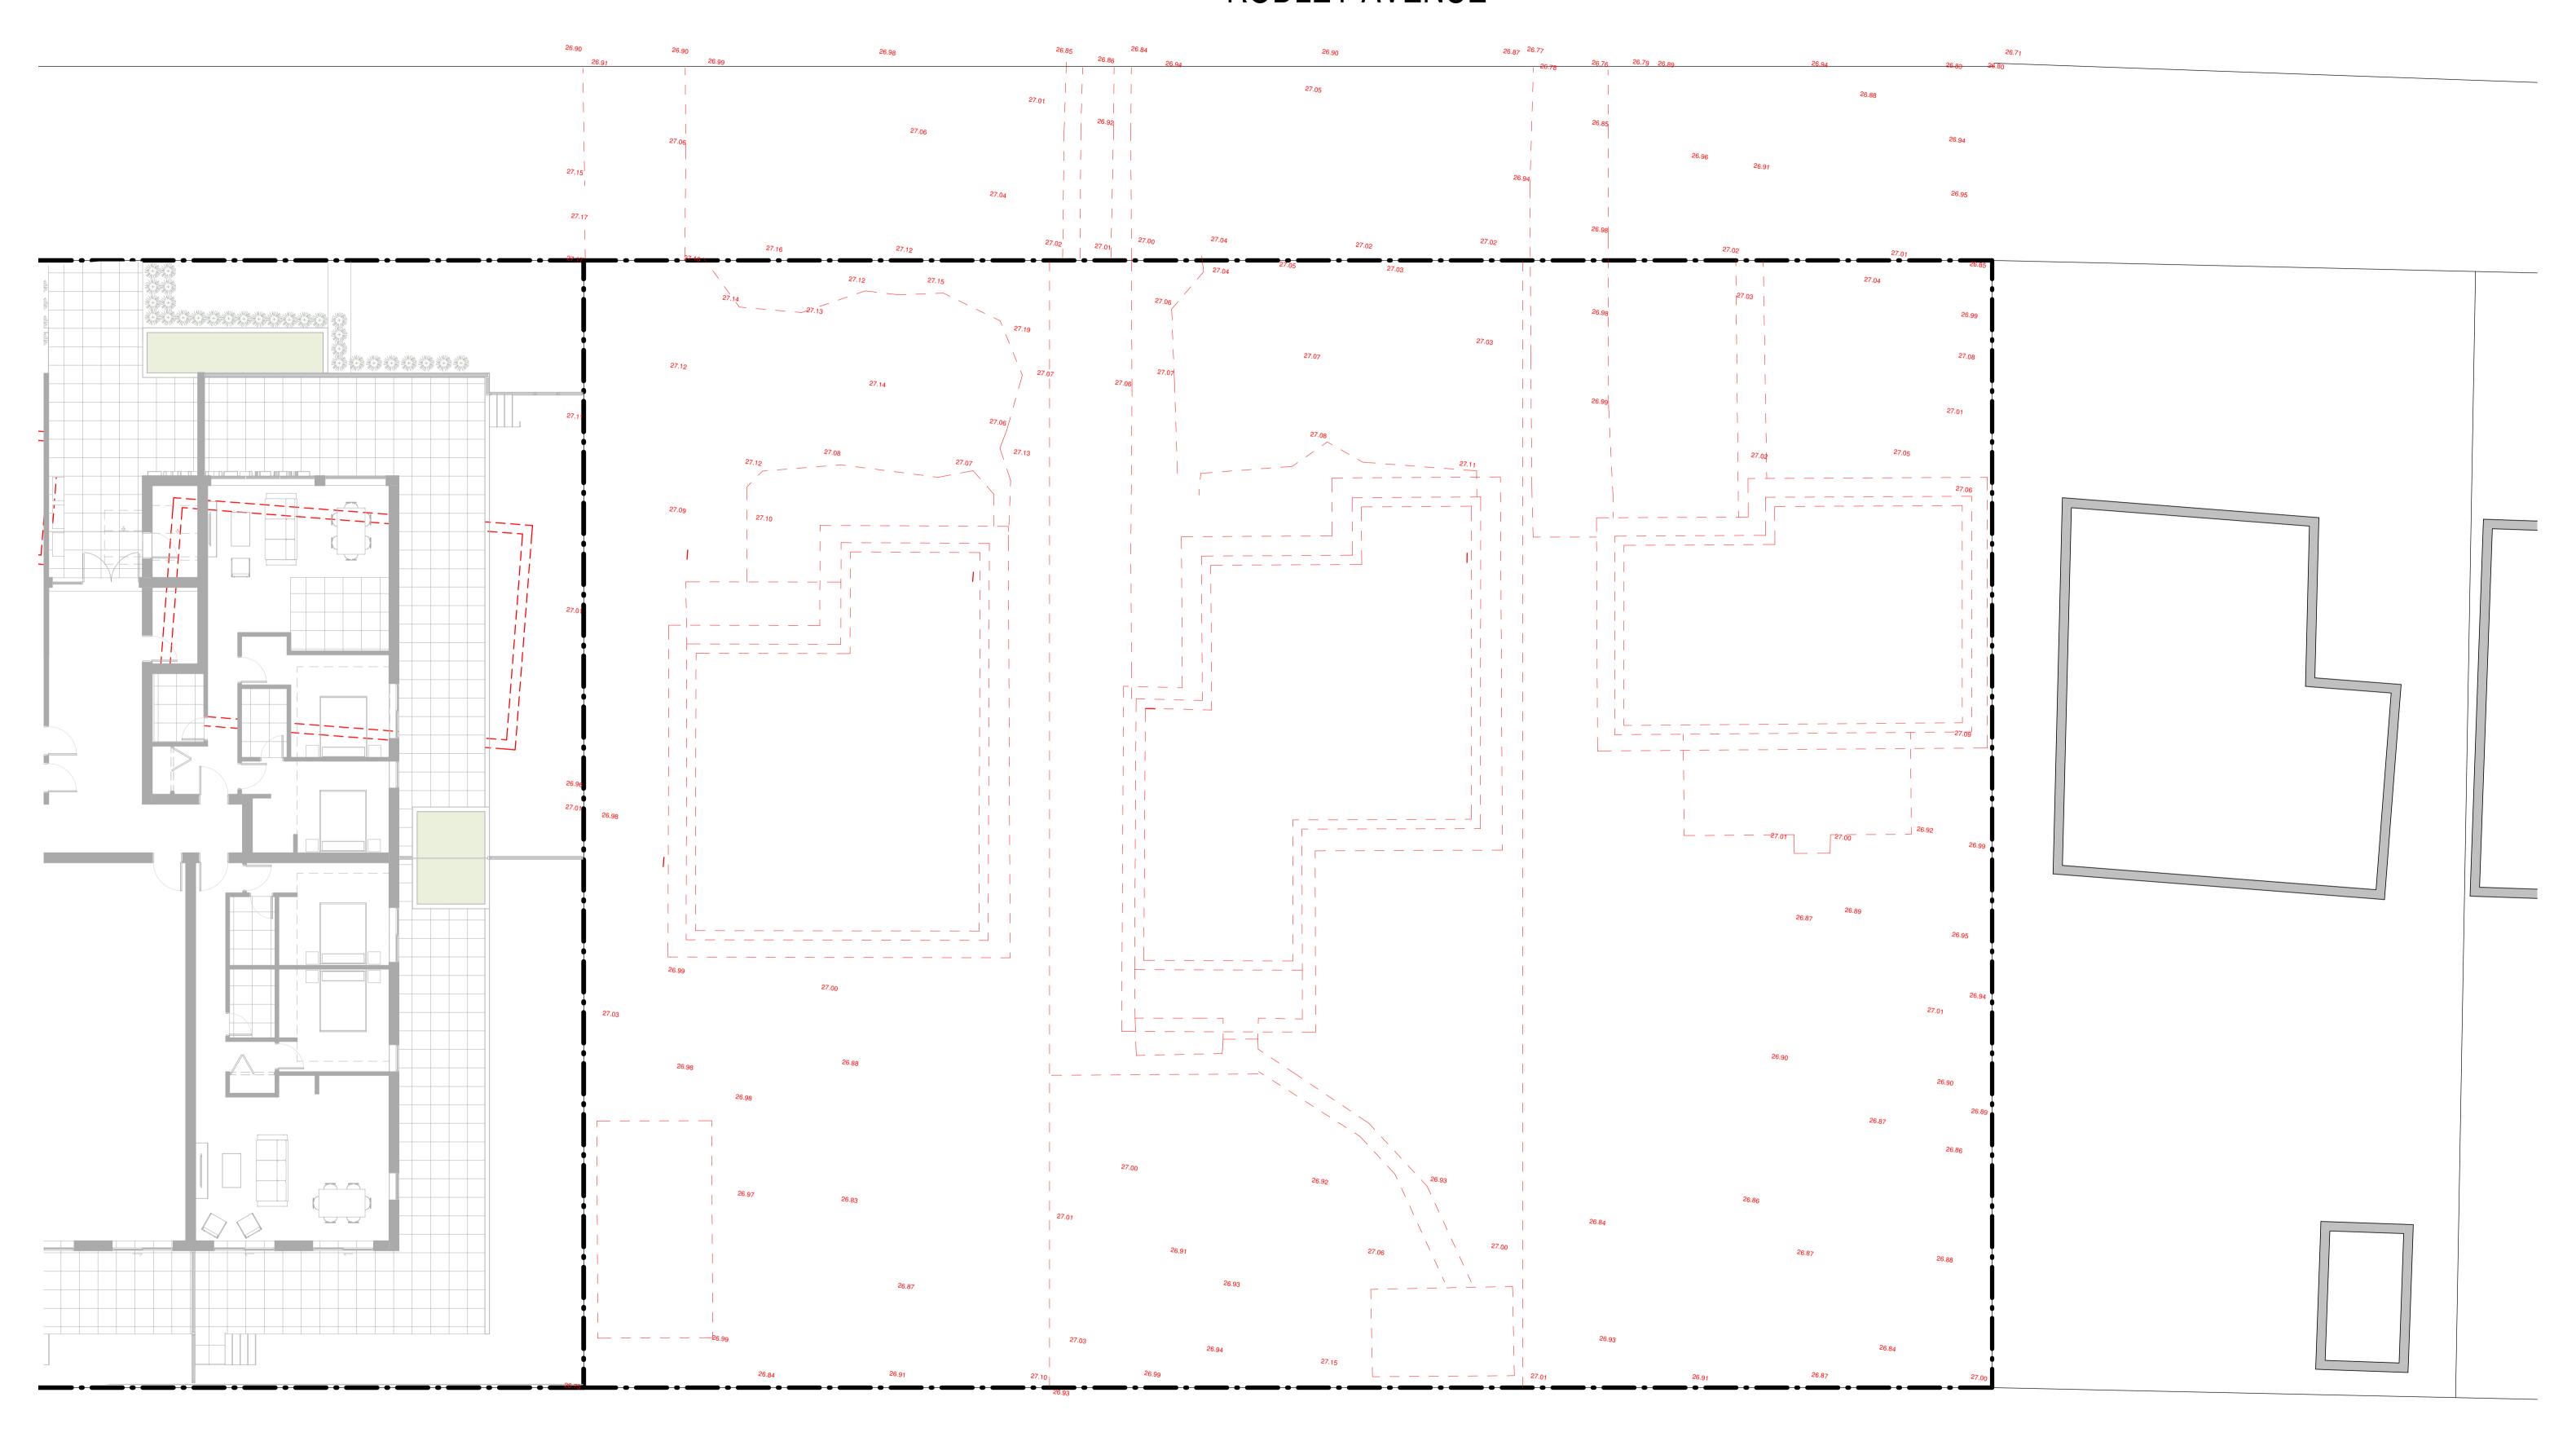NORTH 0 SCA

PRC PRC PRC SCALE 1:100@A1 (1:200@A3)

PROJECT
PROPOSED RESIDENTIAL FLAT BUILDING
ADDRESS
44-48 Rodley Avenue, Penrith, NSW, 2750

PROJECT No. 19043


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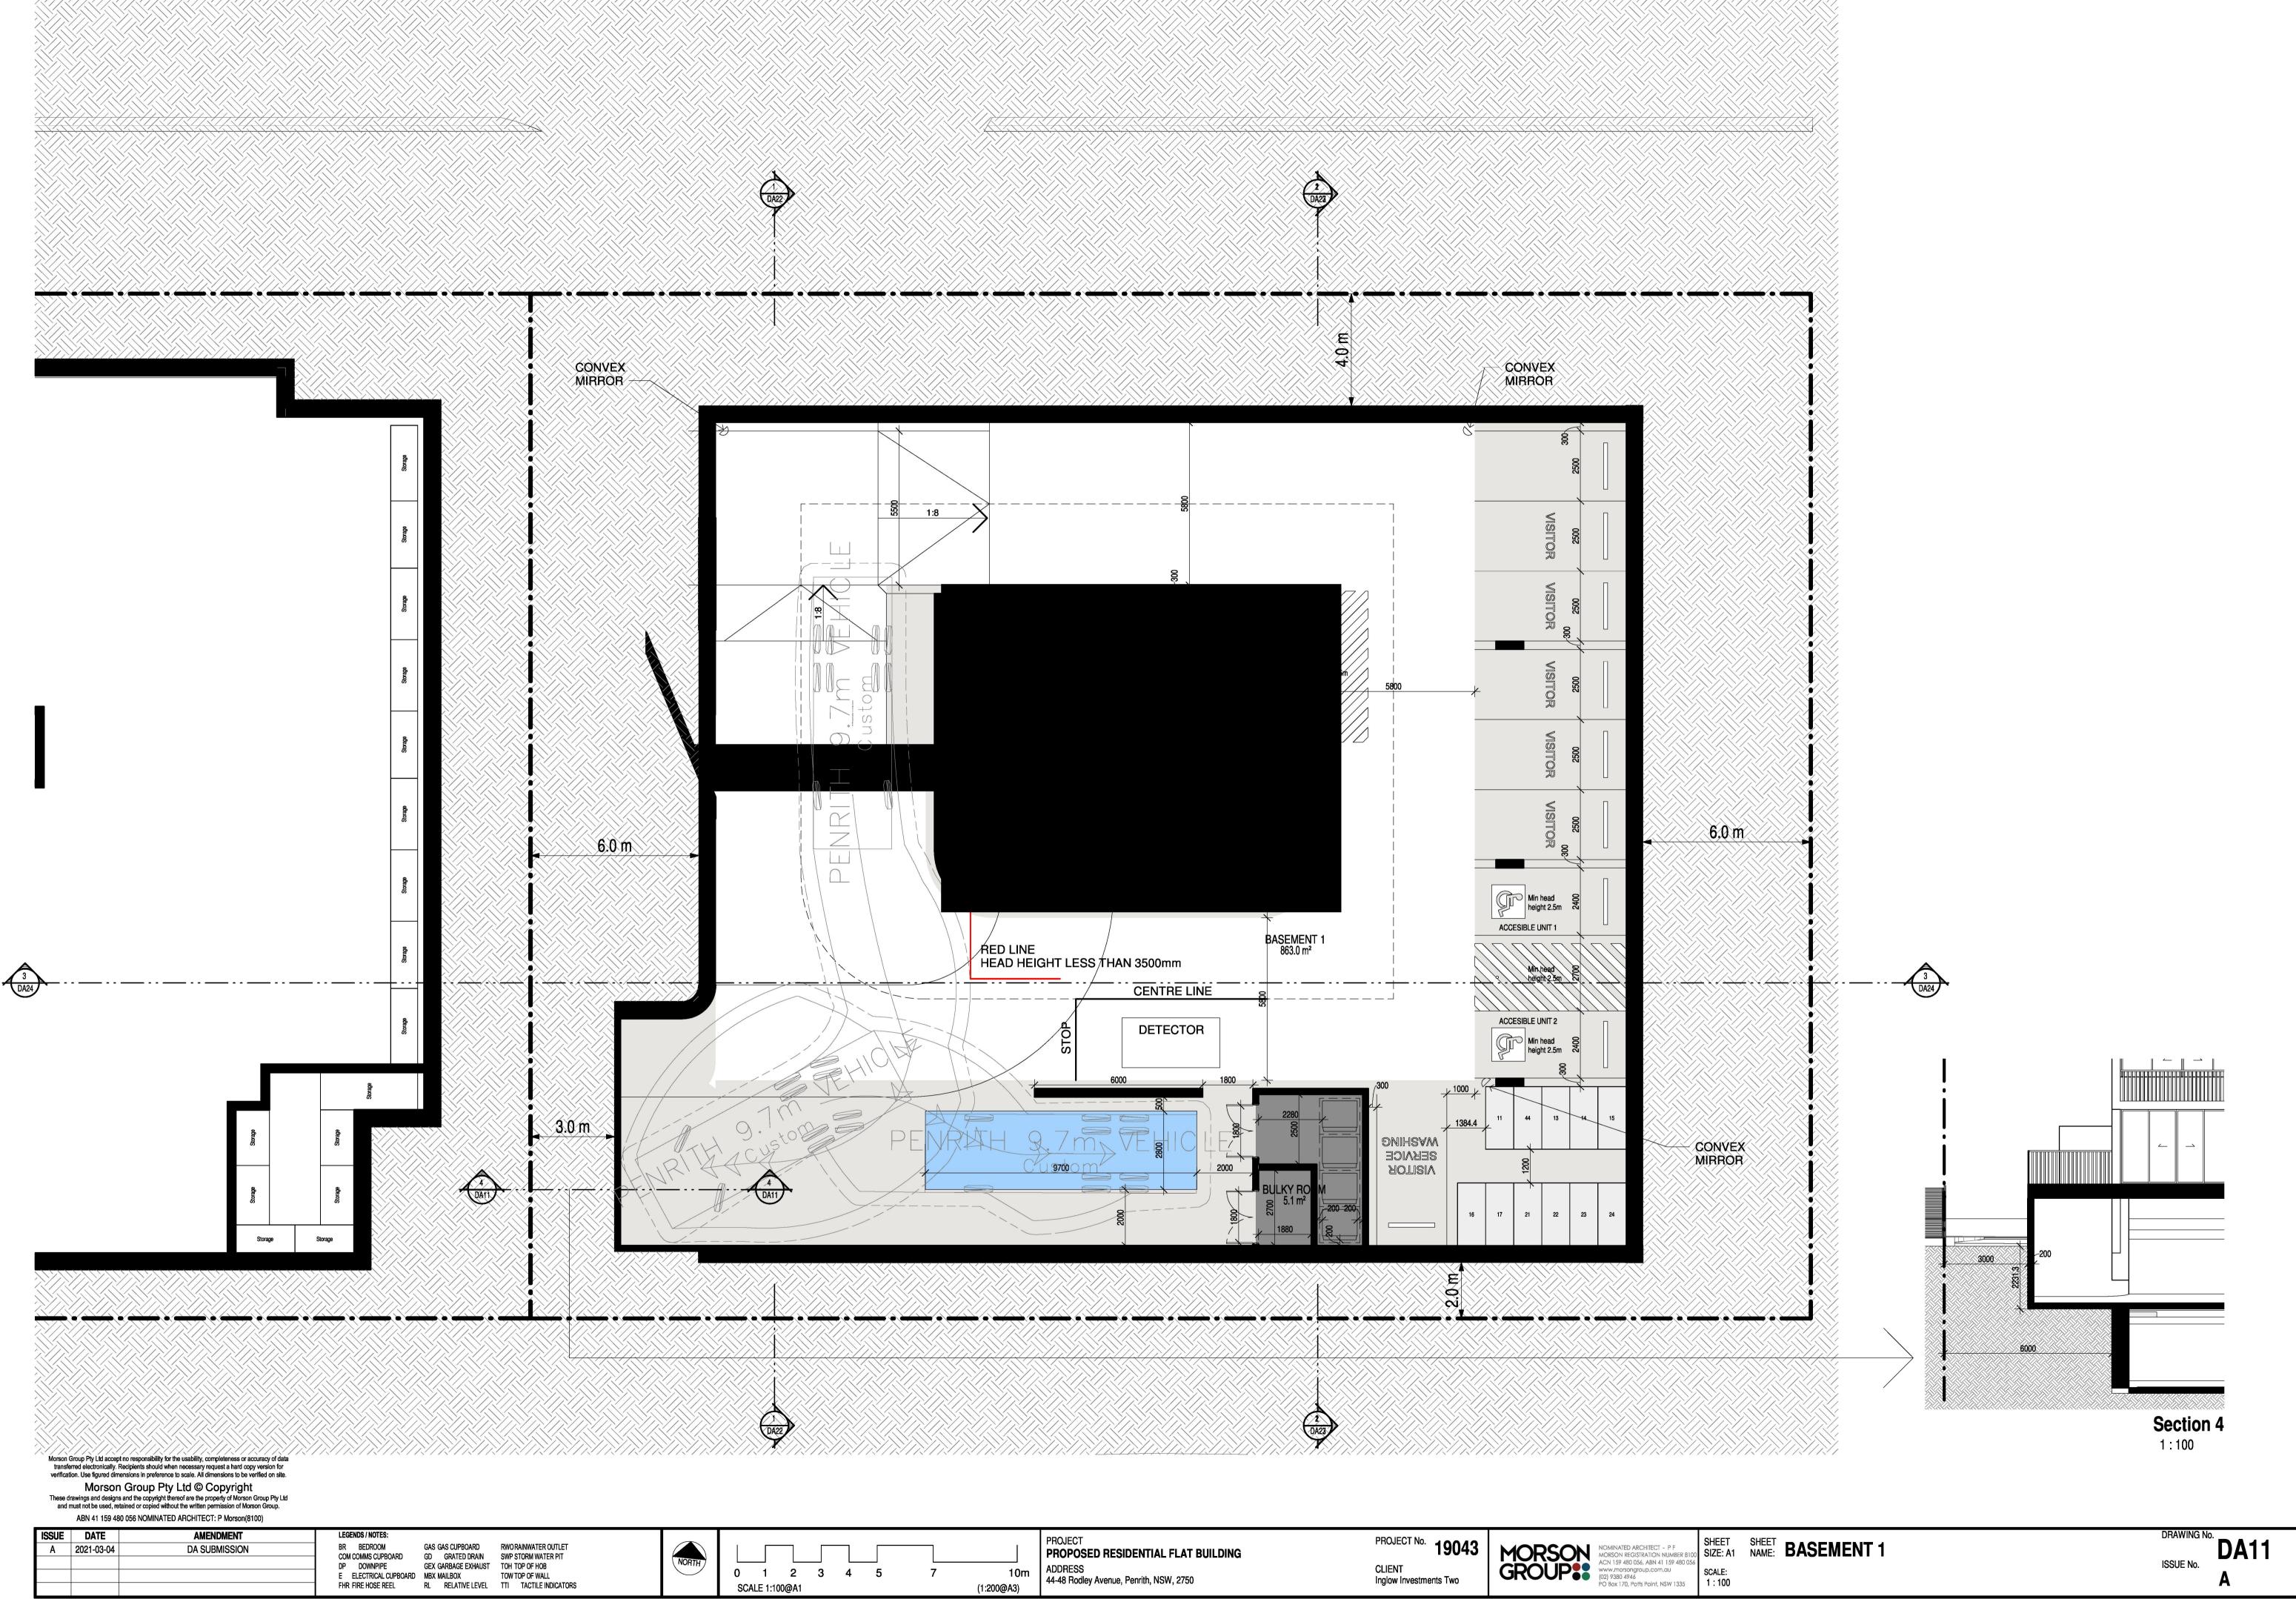
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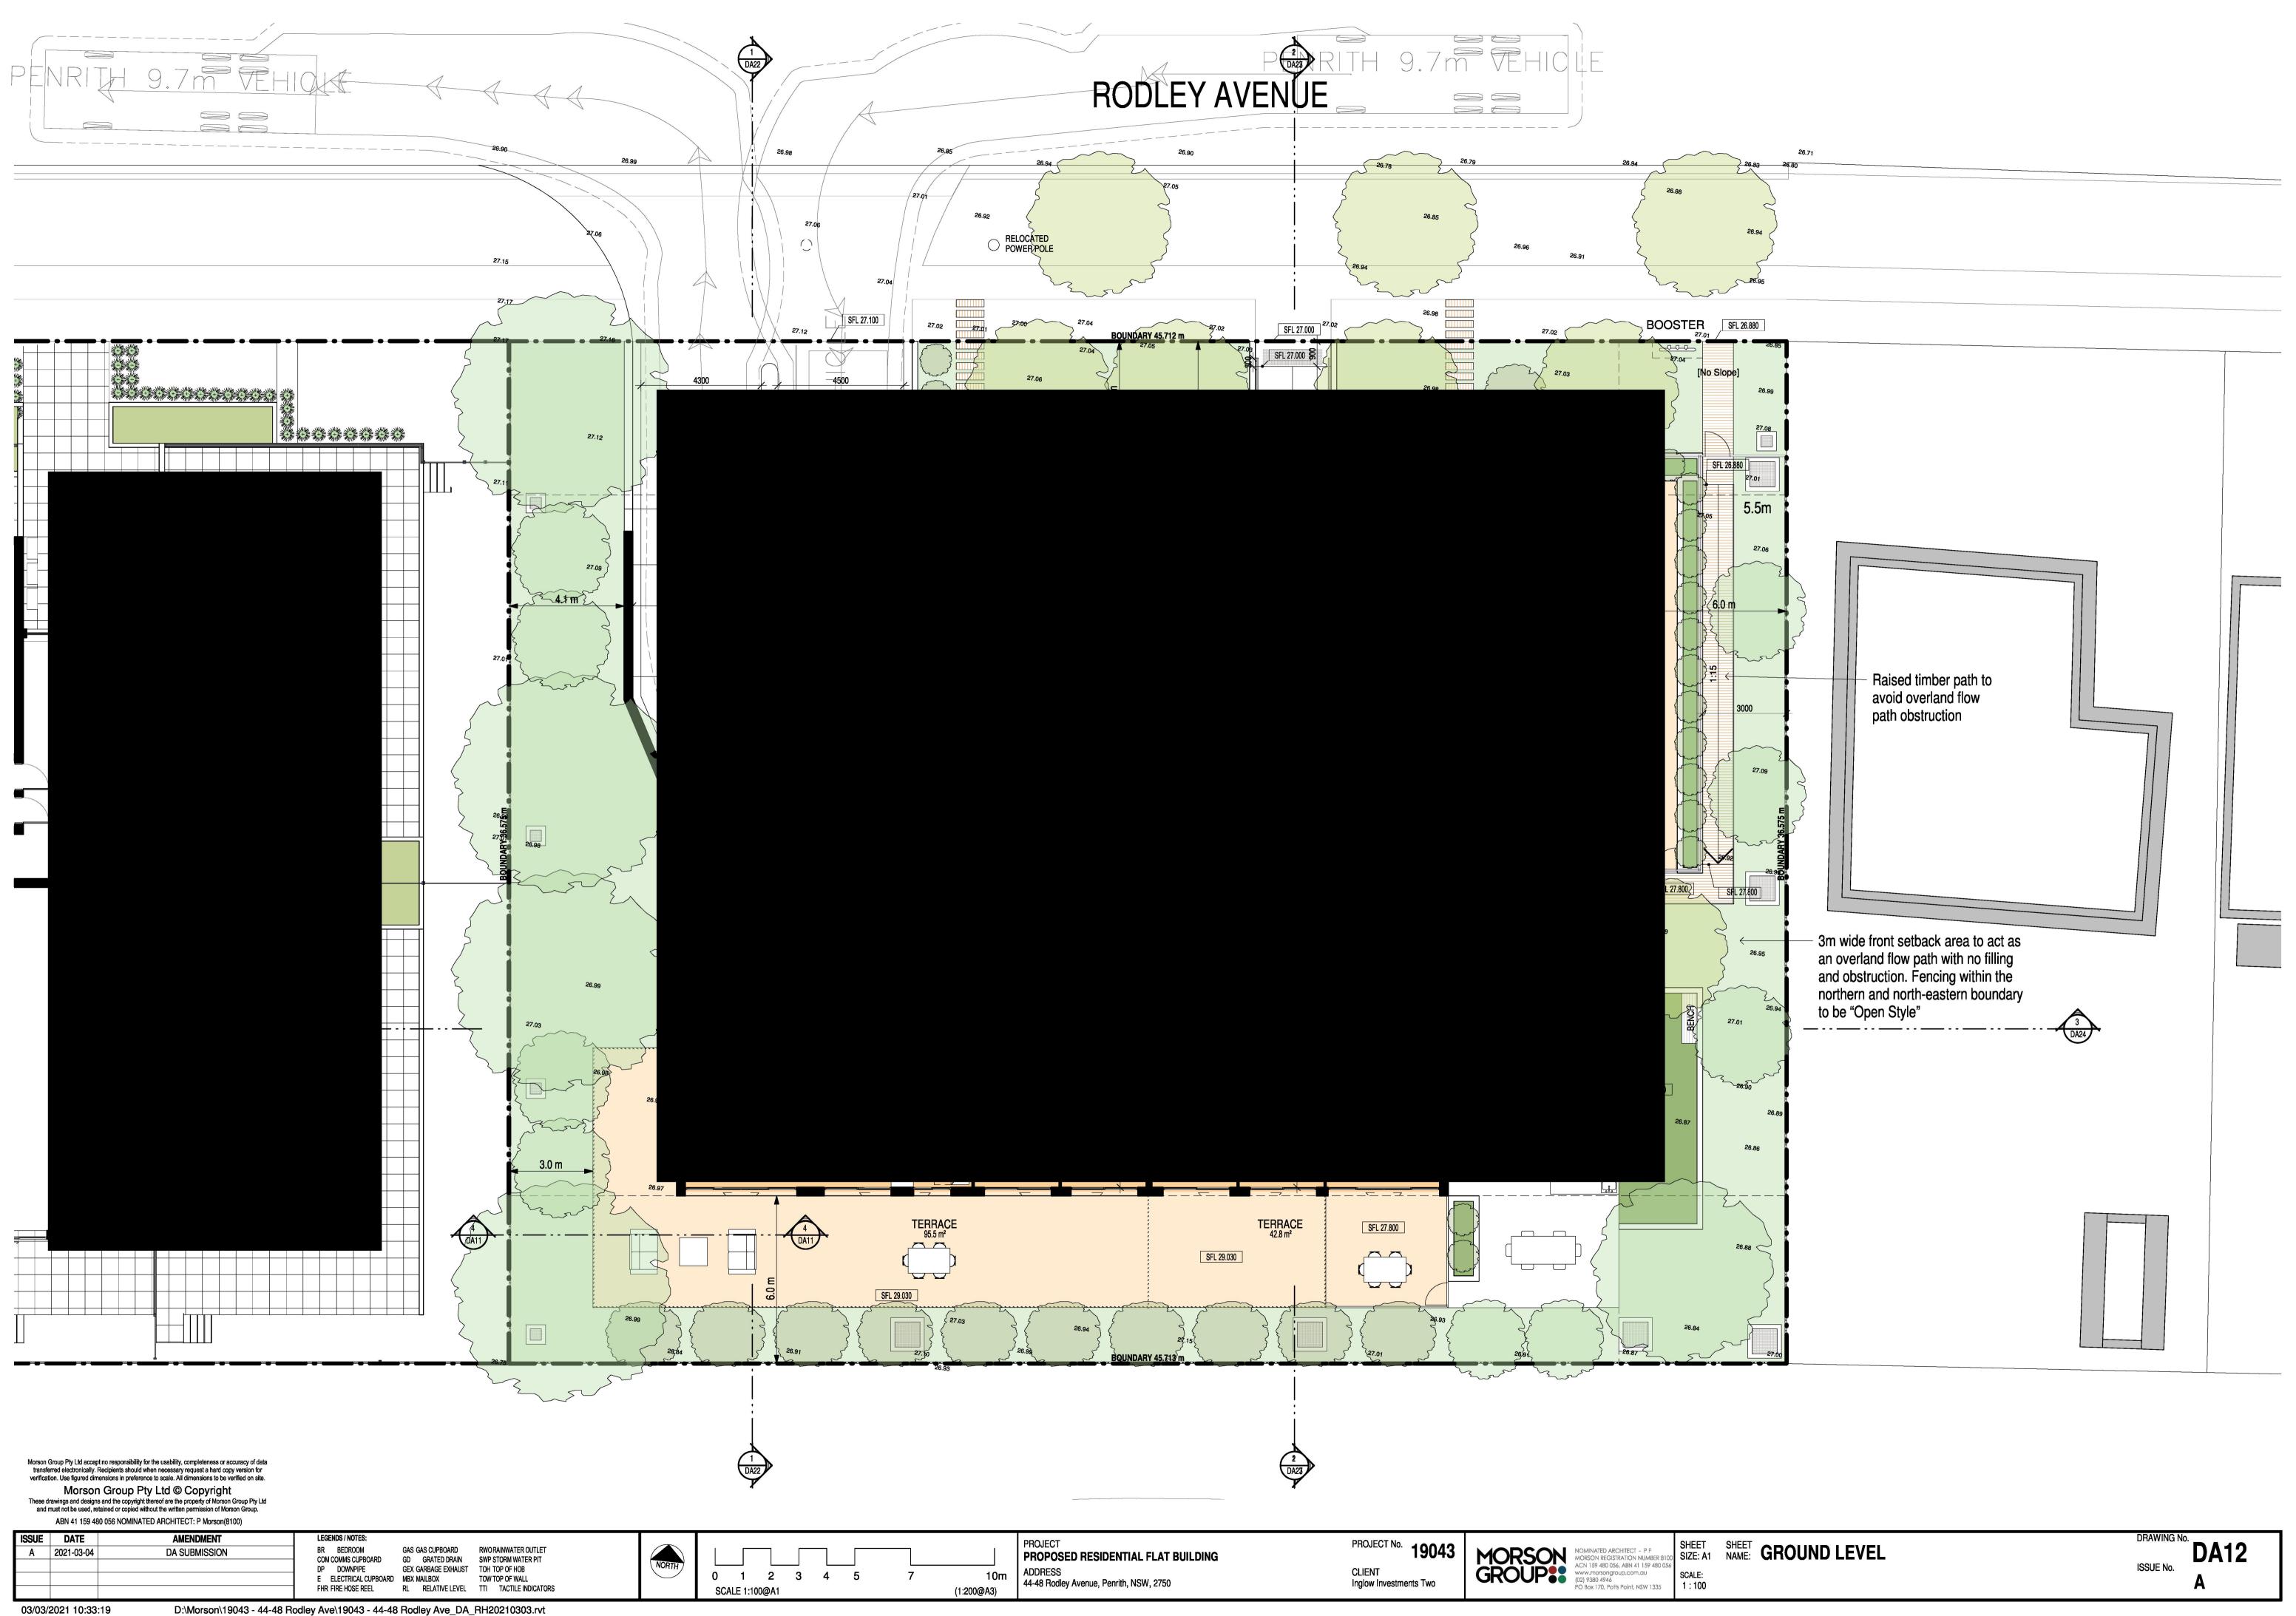
SCALE:
1:100


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PROPOSED RESIDENTIAL FLAT BUILDING

ADDRESS 44-48 Rodley Avenue, Penrith, NSW, 2750

10m

(1:200@A3)

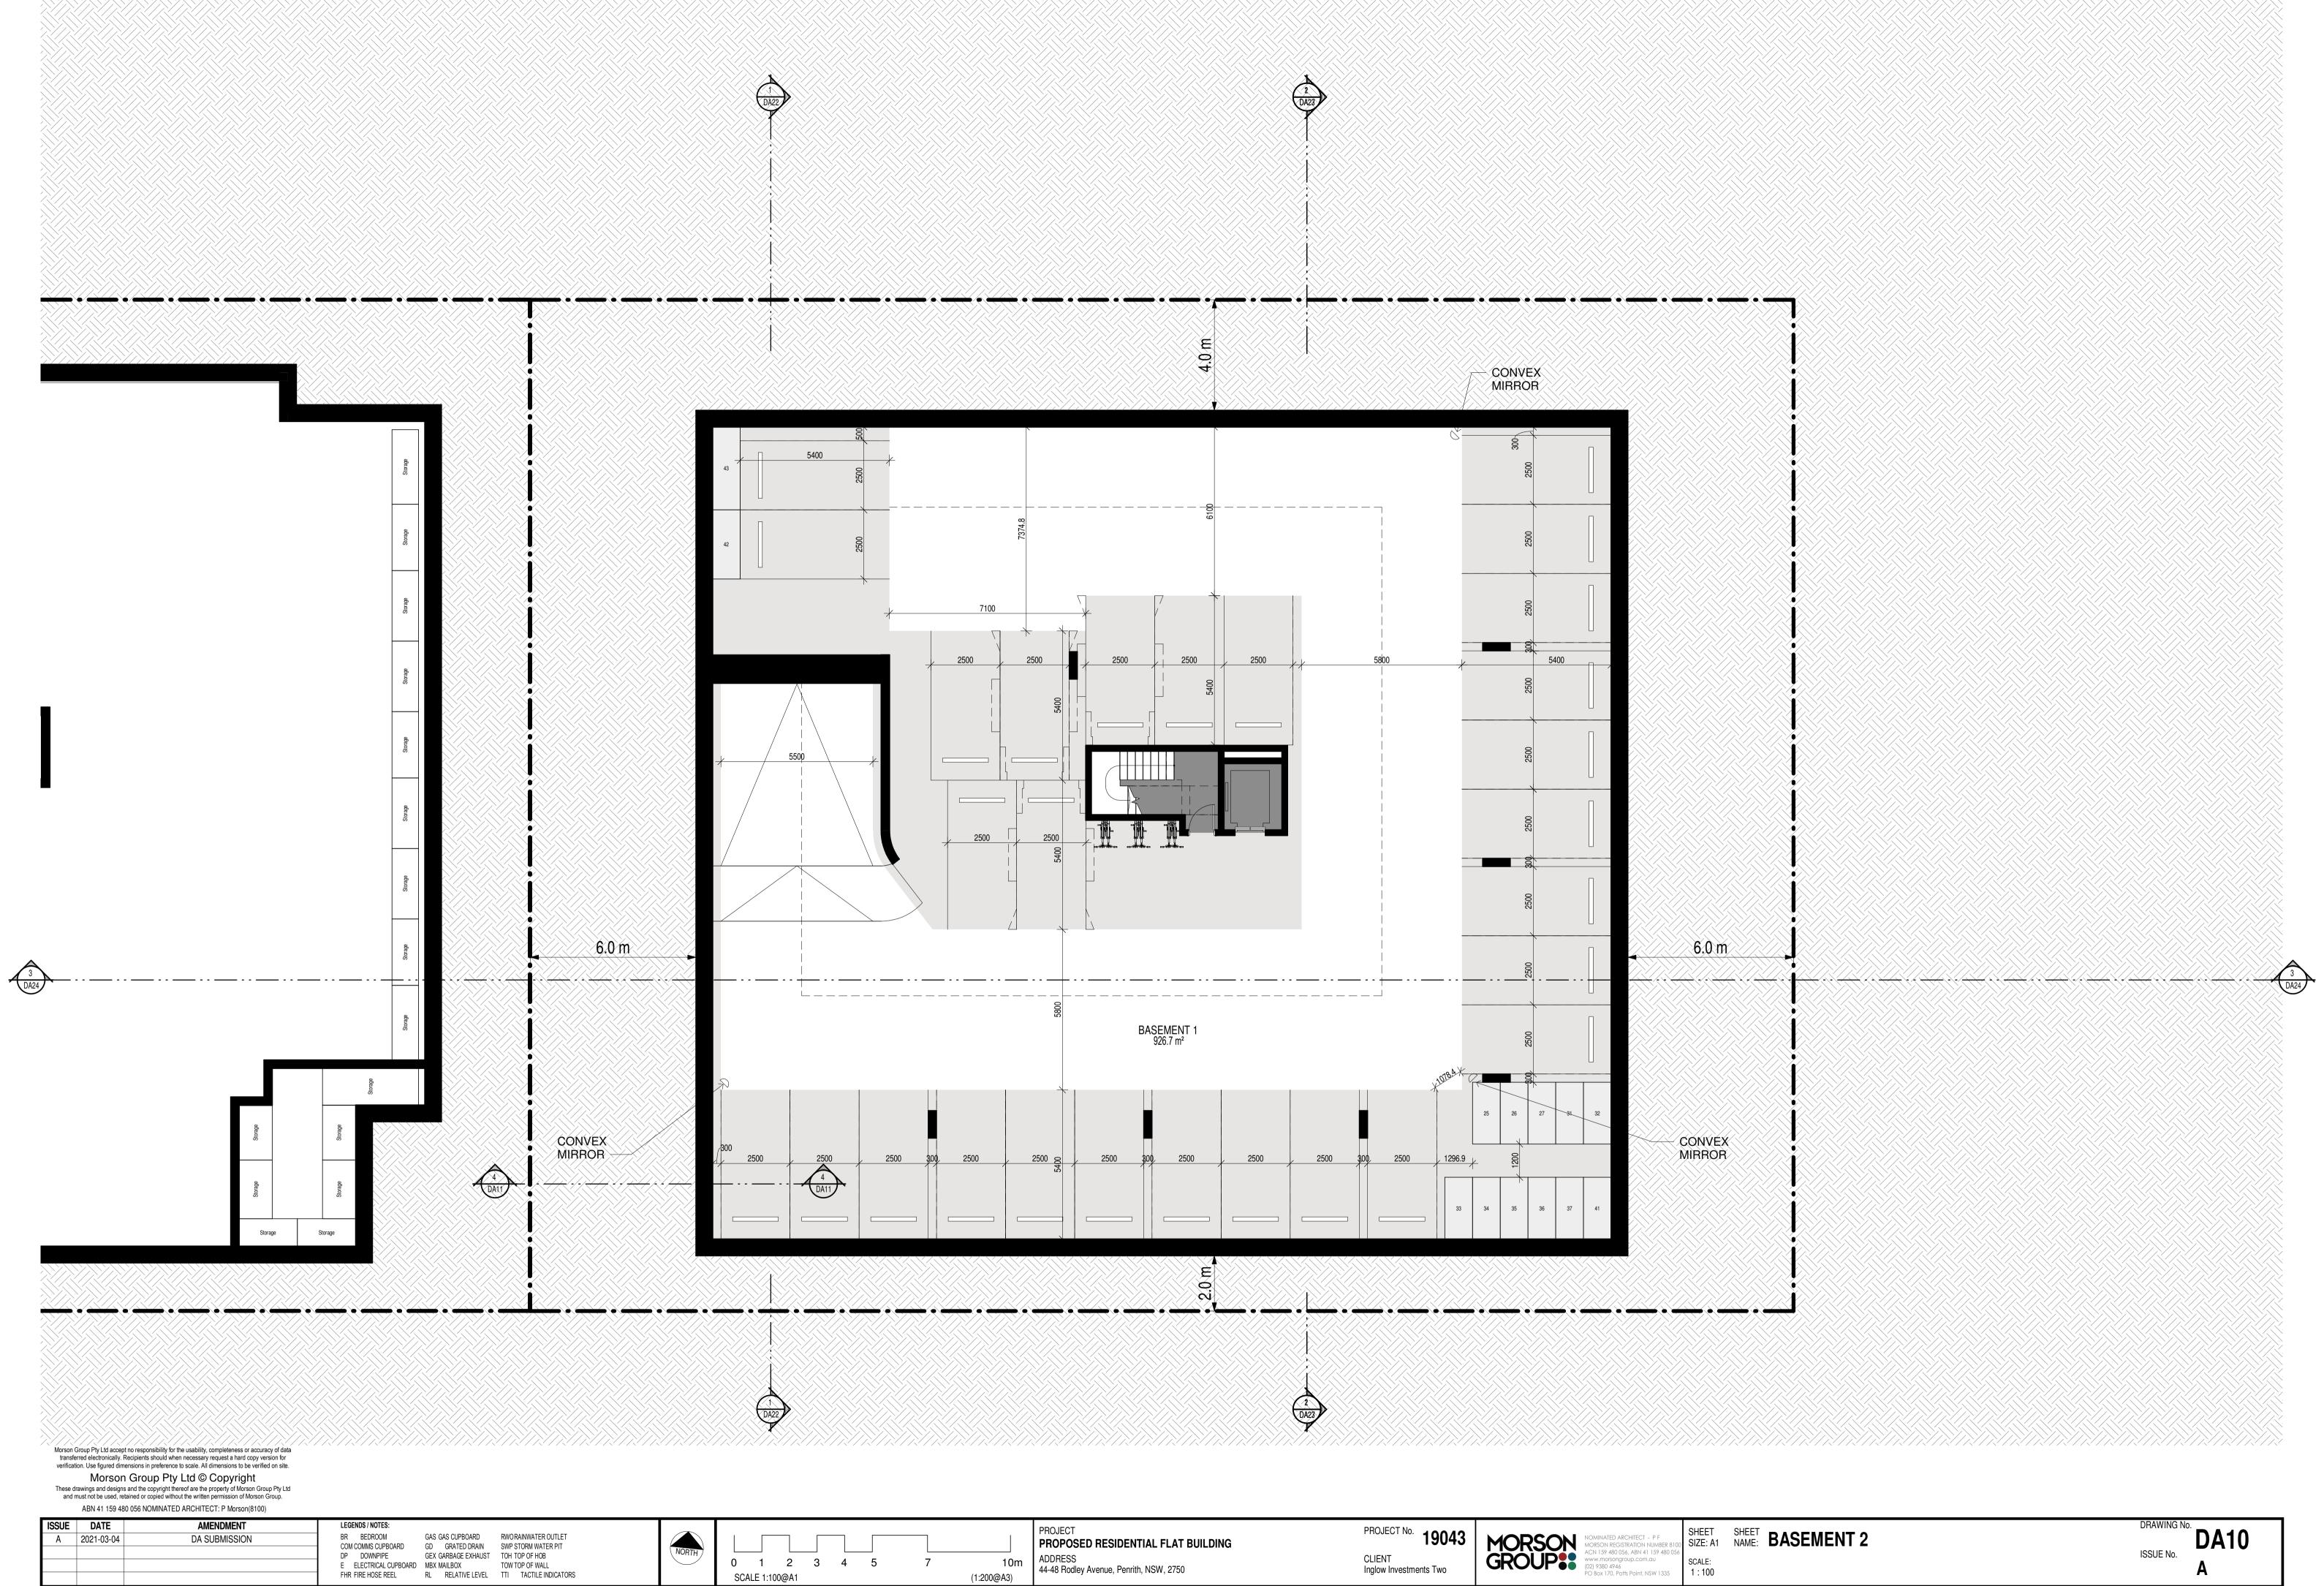0 1 2 3 4 5

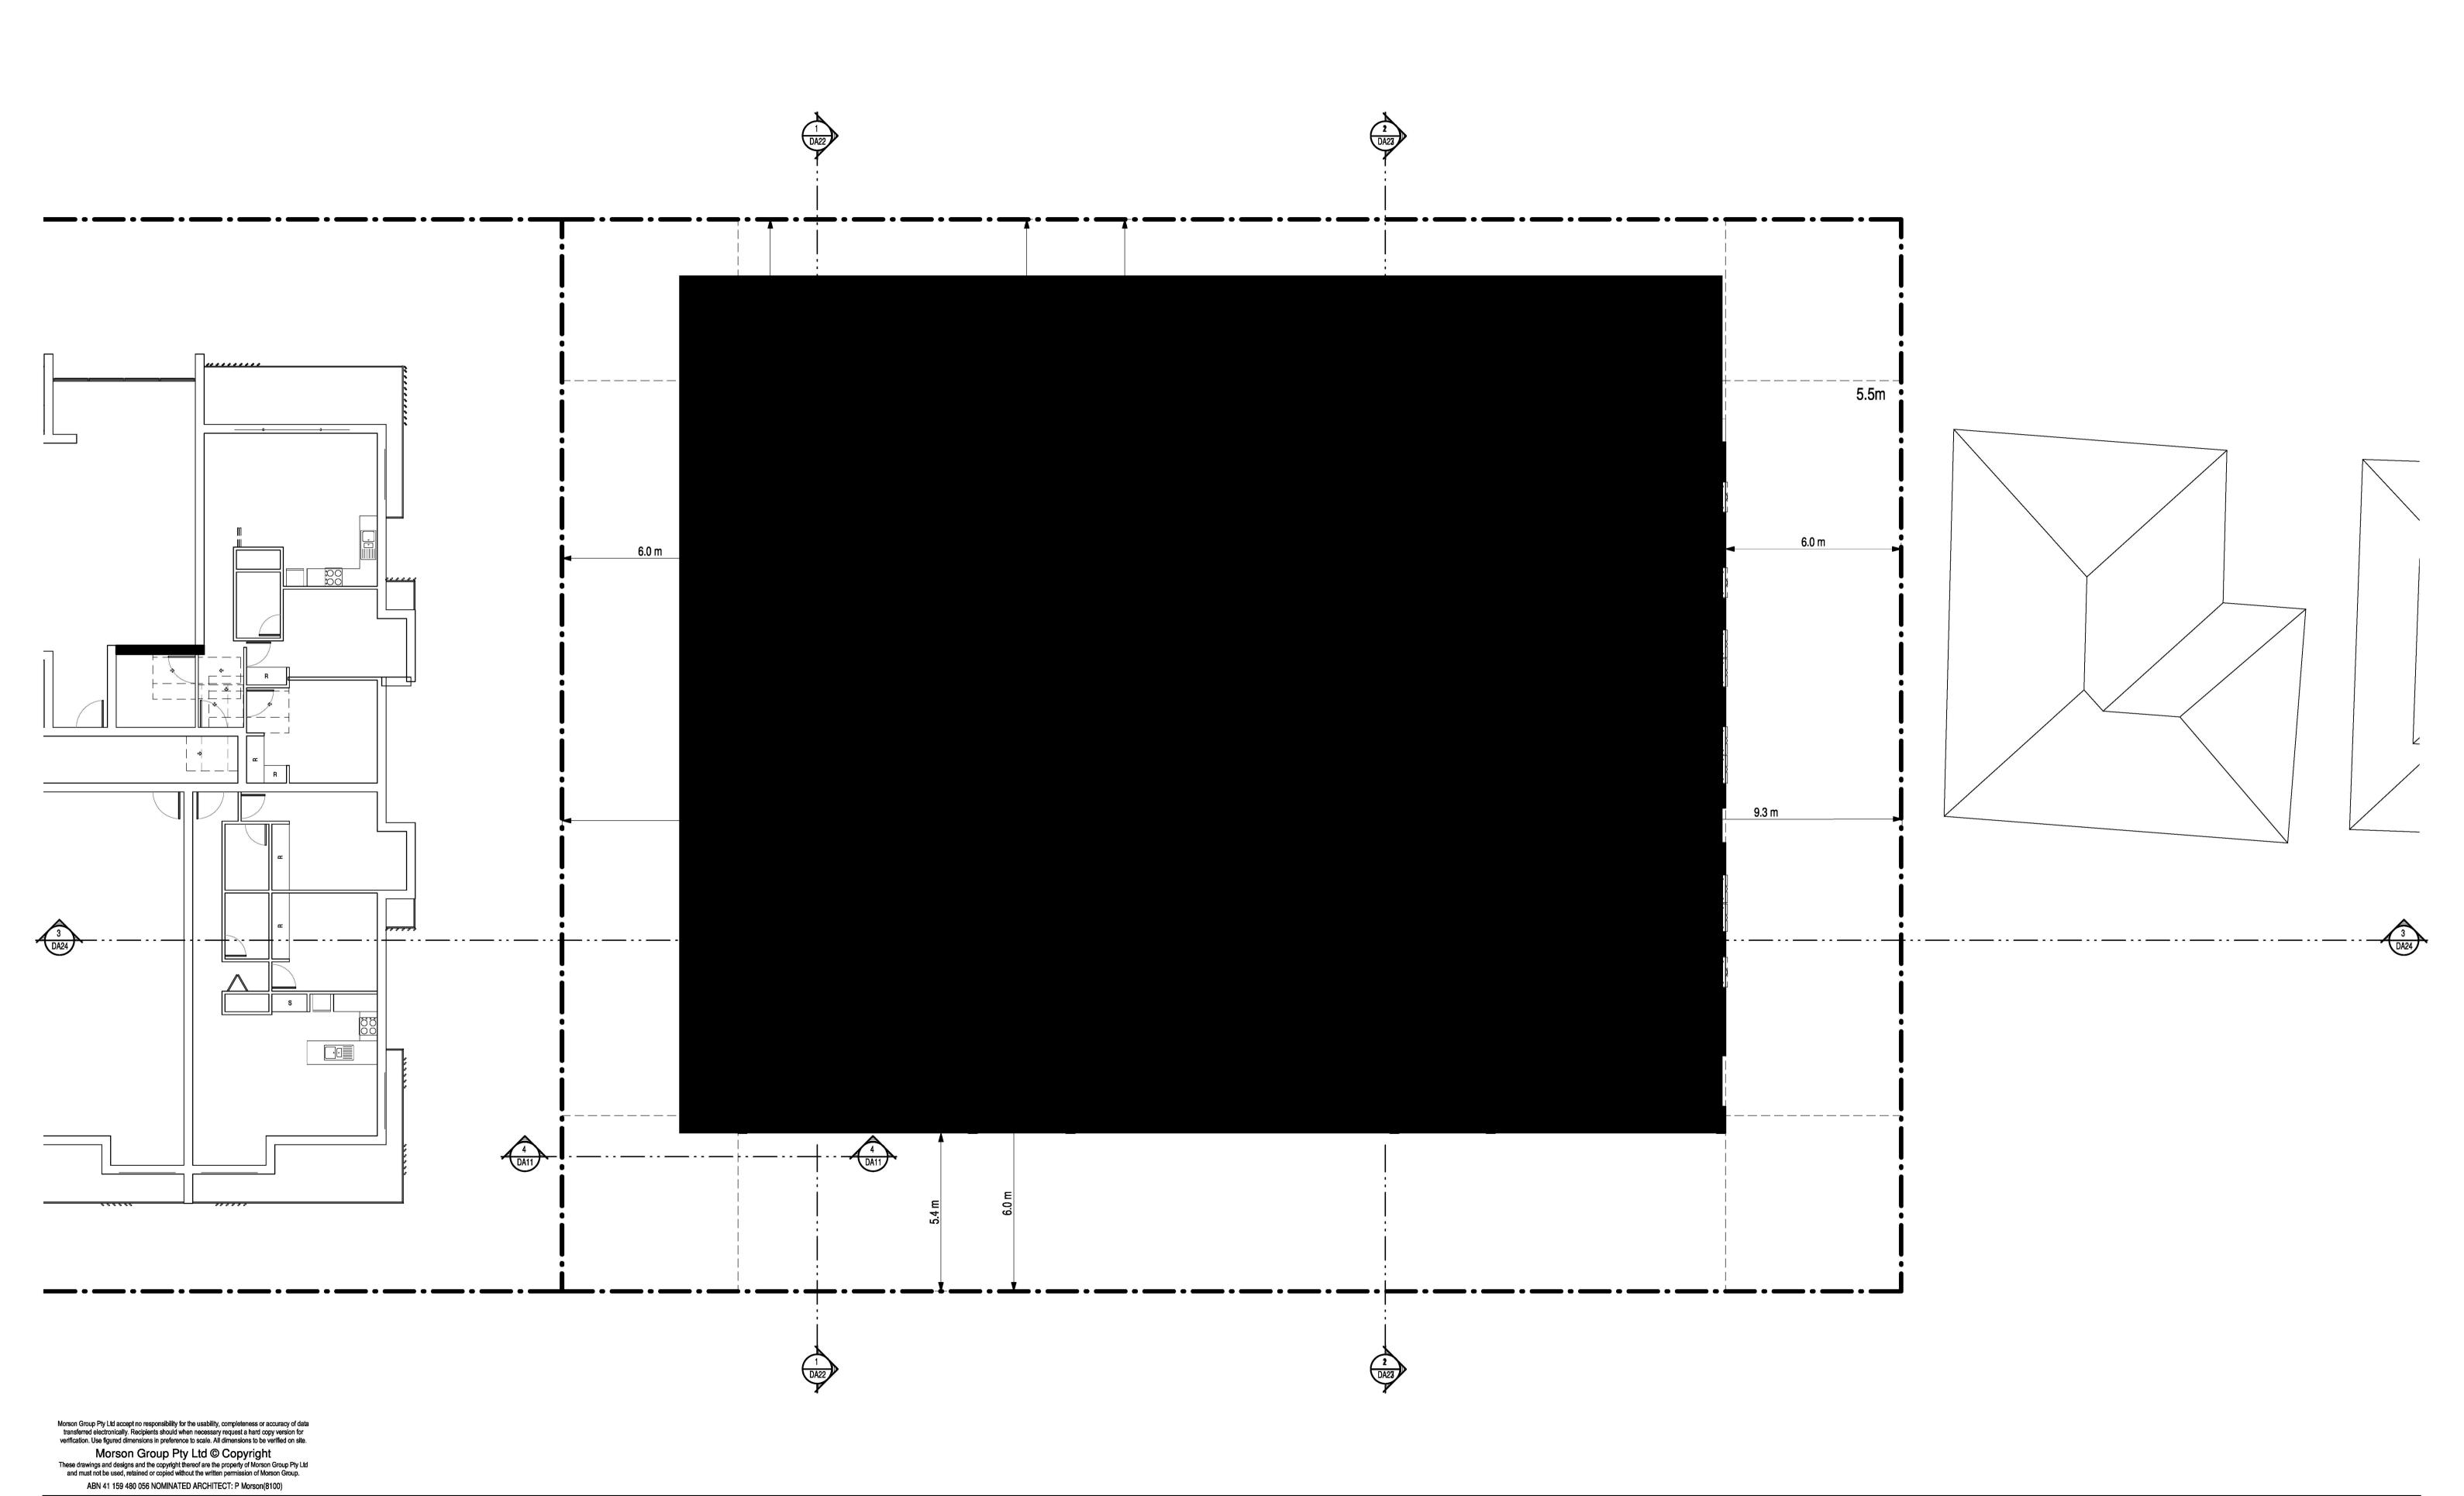SCALE 1:100@A1

SHEET SHEET LEVEL 1

SCALE: 1:100

ISSUE No.

MORSON REGISTRATION NUMBER 8100
ACN 159 480 056, ABN 41 159 480 056
www.morsongroup.com.au
(02) 9380 4946
PO Box 170, Potts Point, NSW 1335

CLIENT Inglow Investments Two

DP DOWNPIPE GEX GARBAGE EXHAUST TOH TOP OF HOB
E ELECTRICAL CUPBOARD MBX MAILBOX TOW TOP OF WALL
FHR FIRE HOSE REEL RL RELATIVE LEVEL TTI TACTILE INDICATORS D:\Morson\19043 - 44-48 Rodley Ave\19043 - 44-48 Rodley Ave_DA_RH20210303.rvt 03/03/2021 10:33:28 Document Set ID: 9517691

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ISSUE DATE


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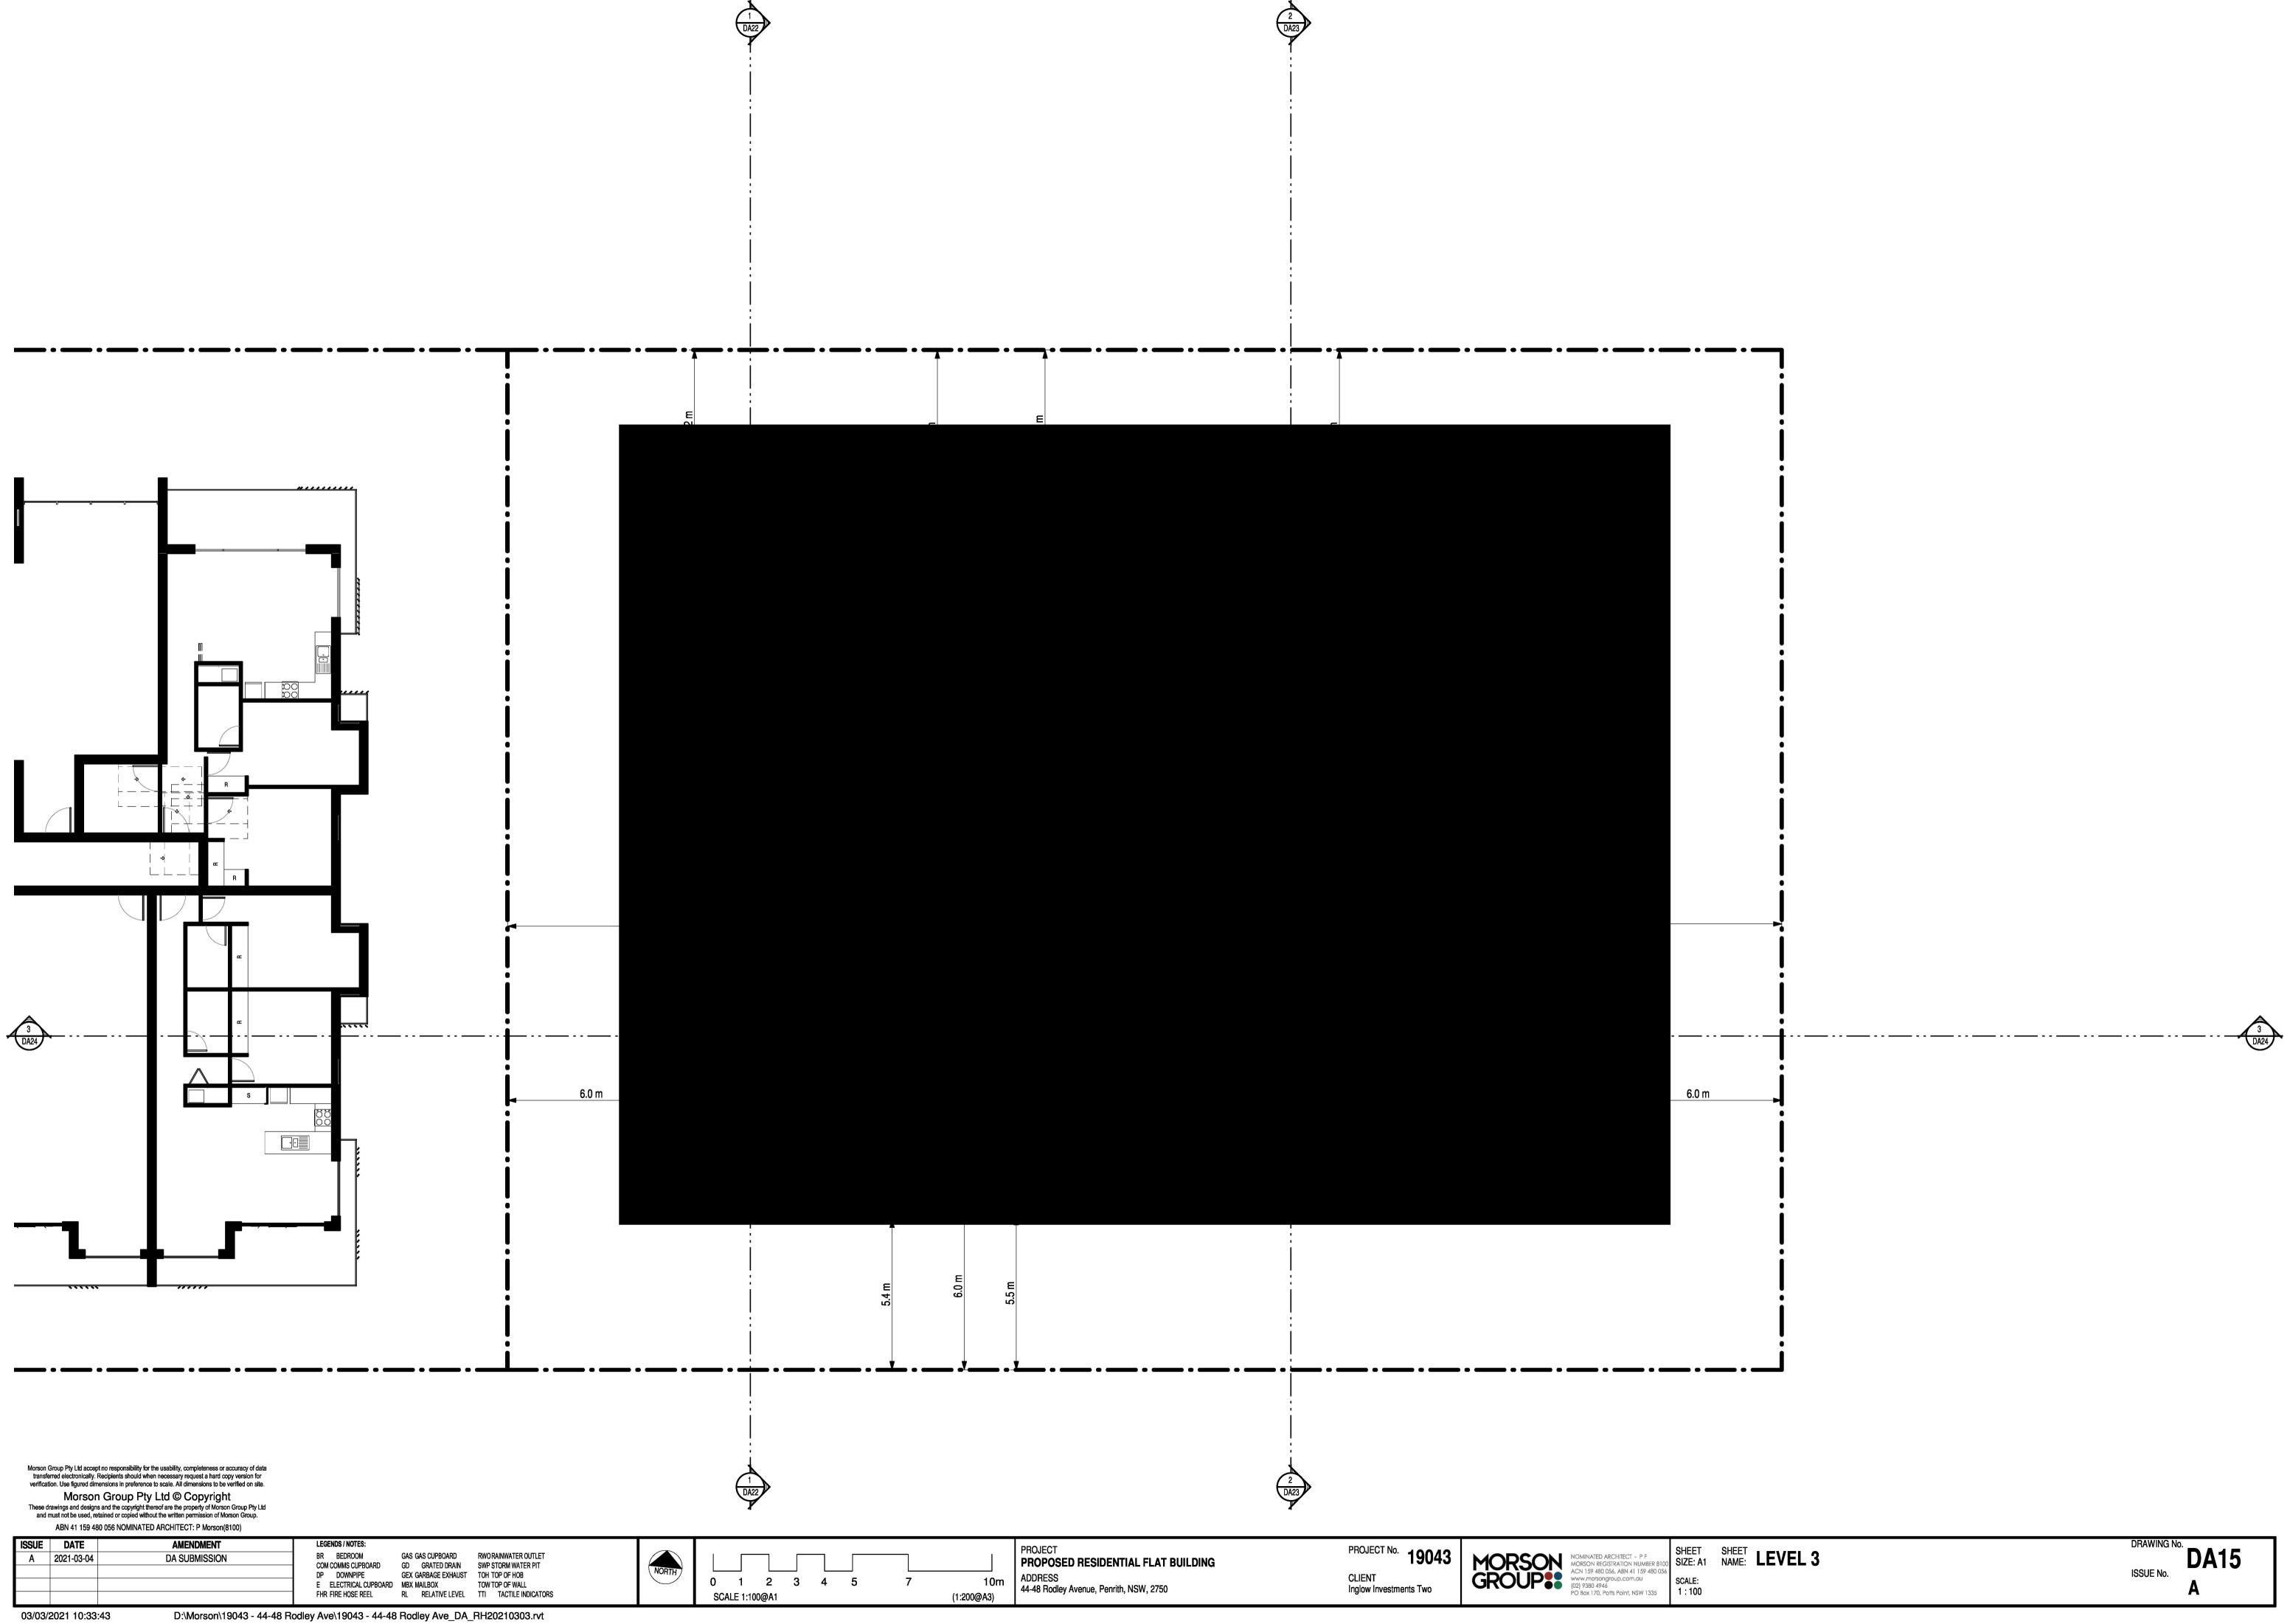
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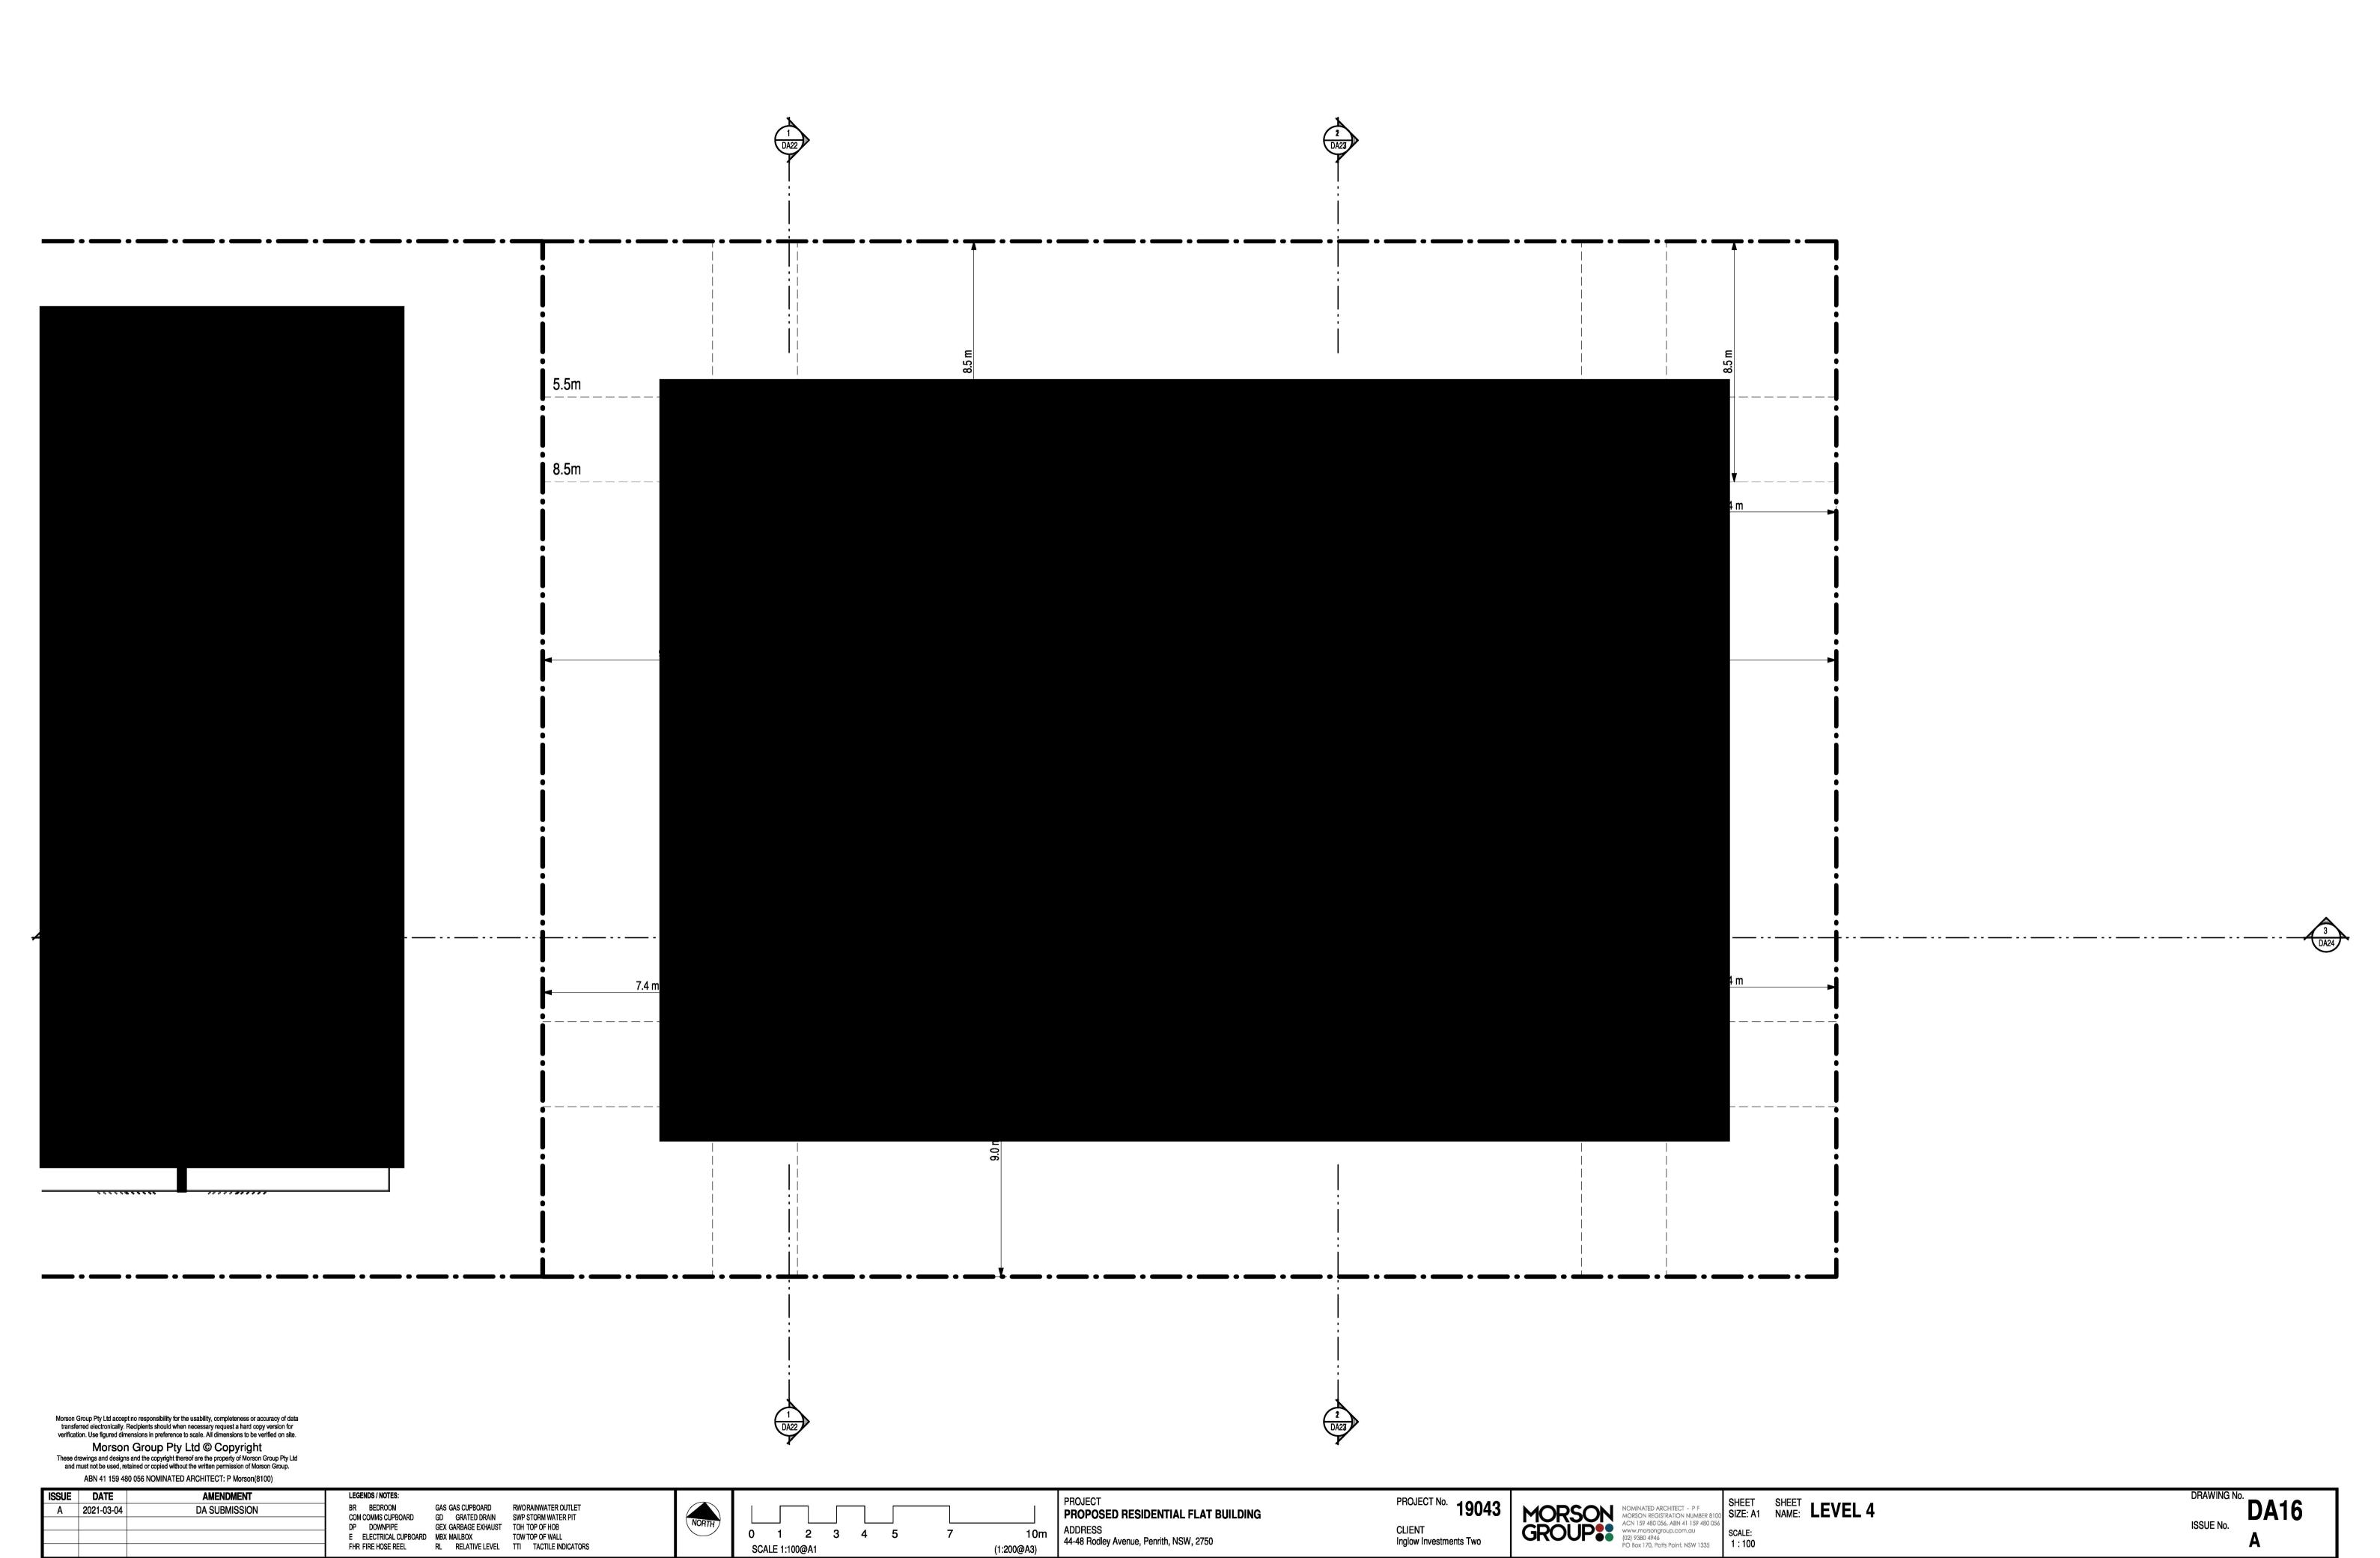
GAS GAS CUPBOARD RWO RAINWATER OUTLET

COM COMMS CUPBOARD GD GRATED DRAIN SWP STORM WATER PIT DP DOWNPIPE GEX GARBAGE EXHAUST TOH TOP OF HOB


BR BEDROOM





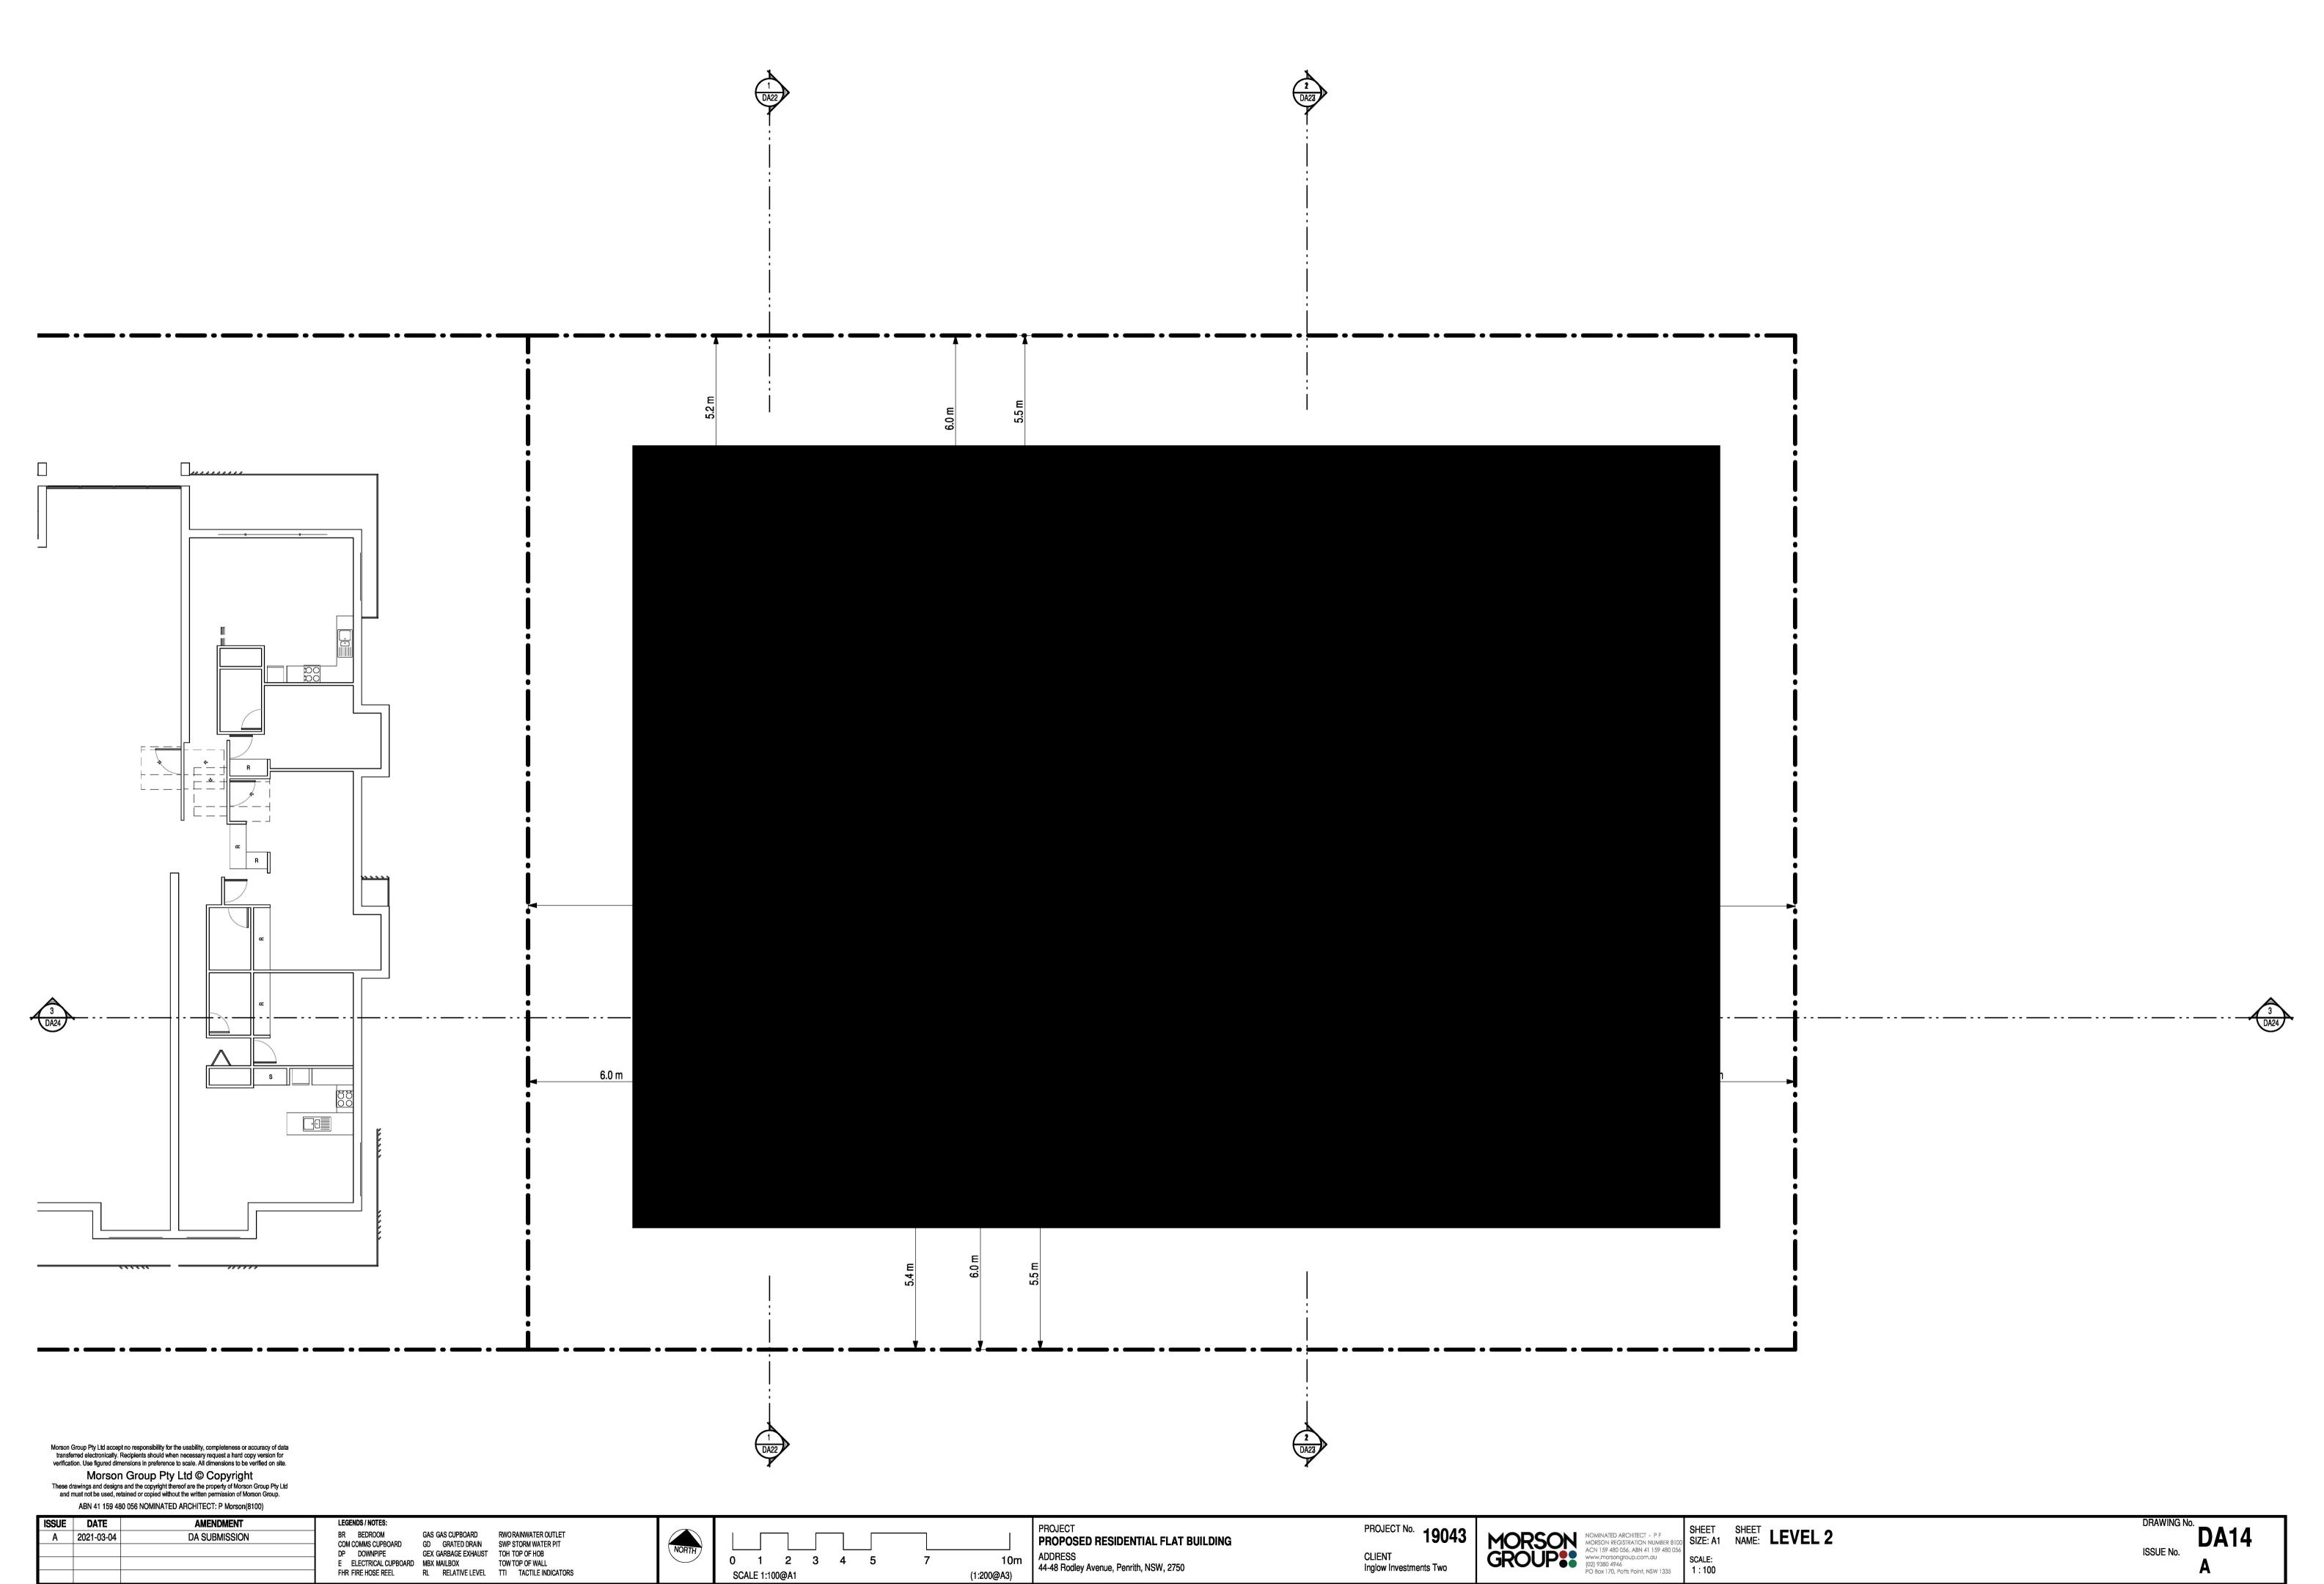

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FBK2
AB-Bricks
Bowral Brahman Granite
230x76-110-240-NAT
Level 1-4

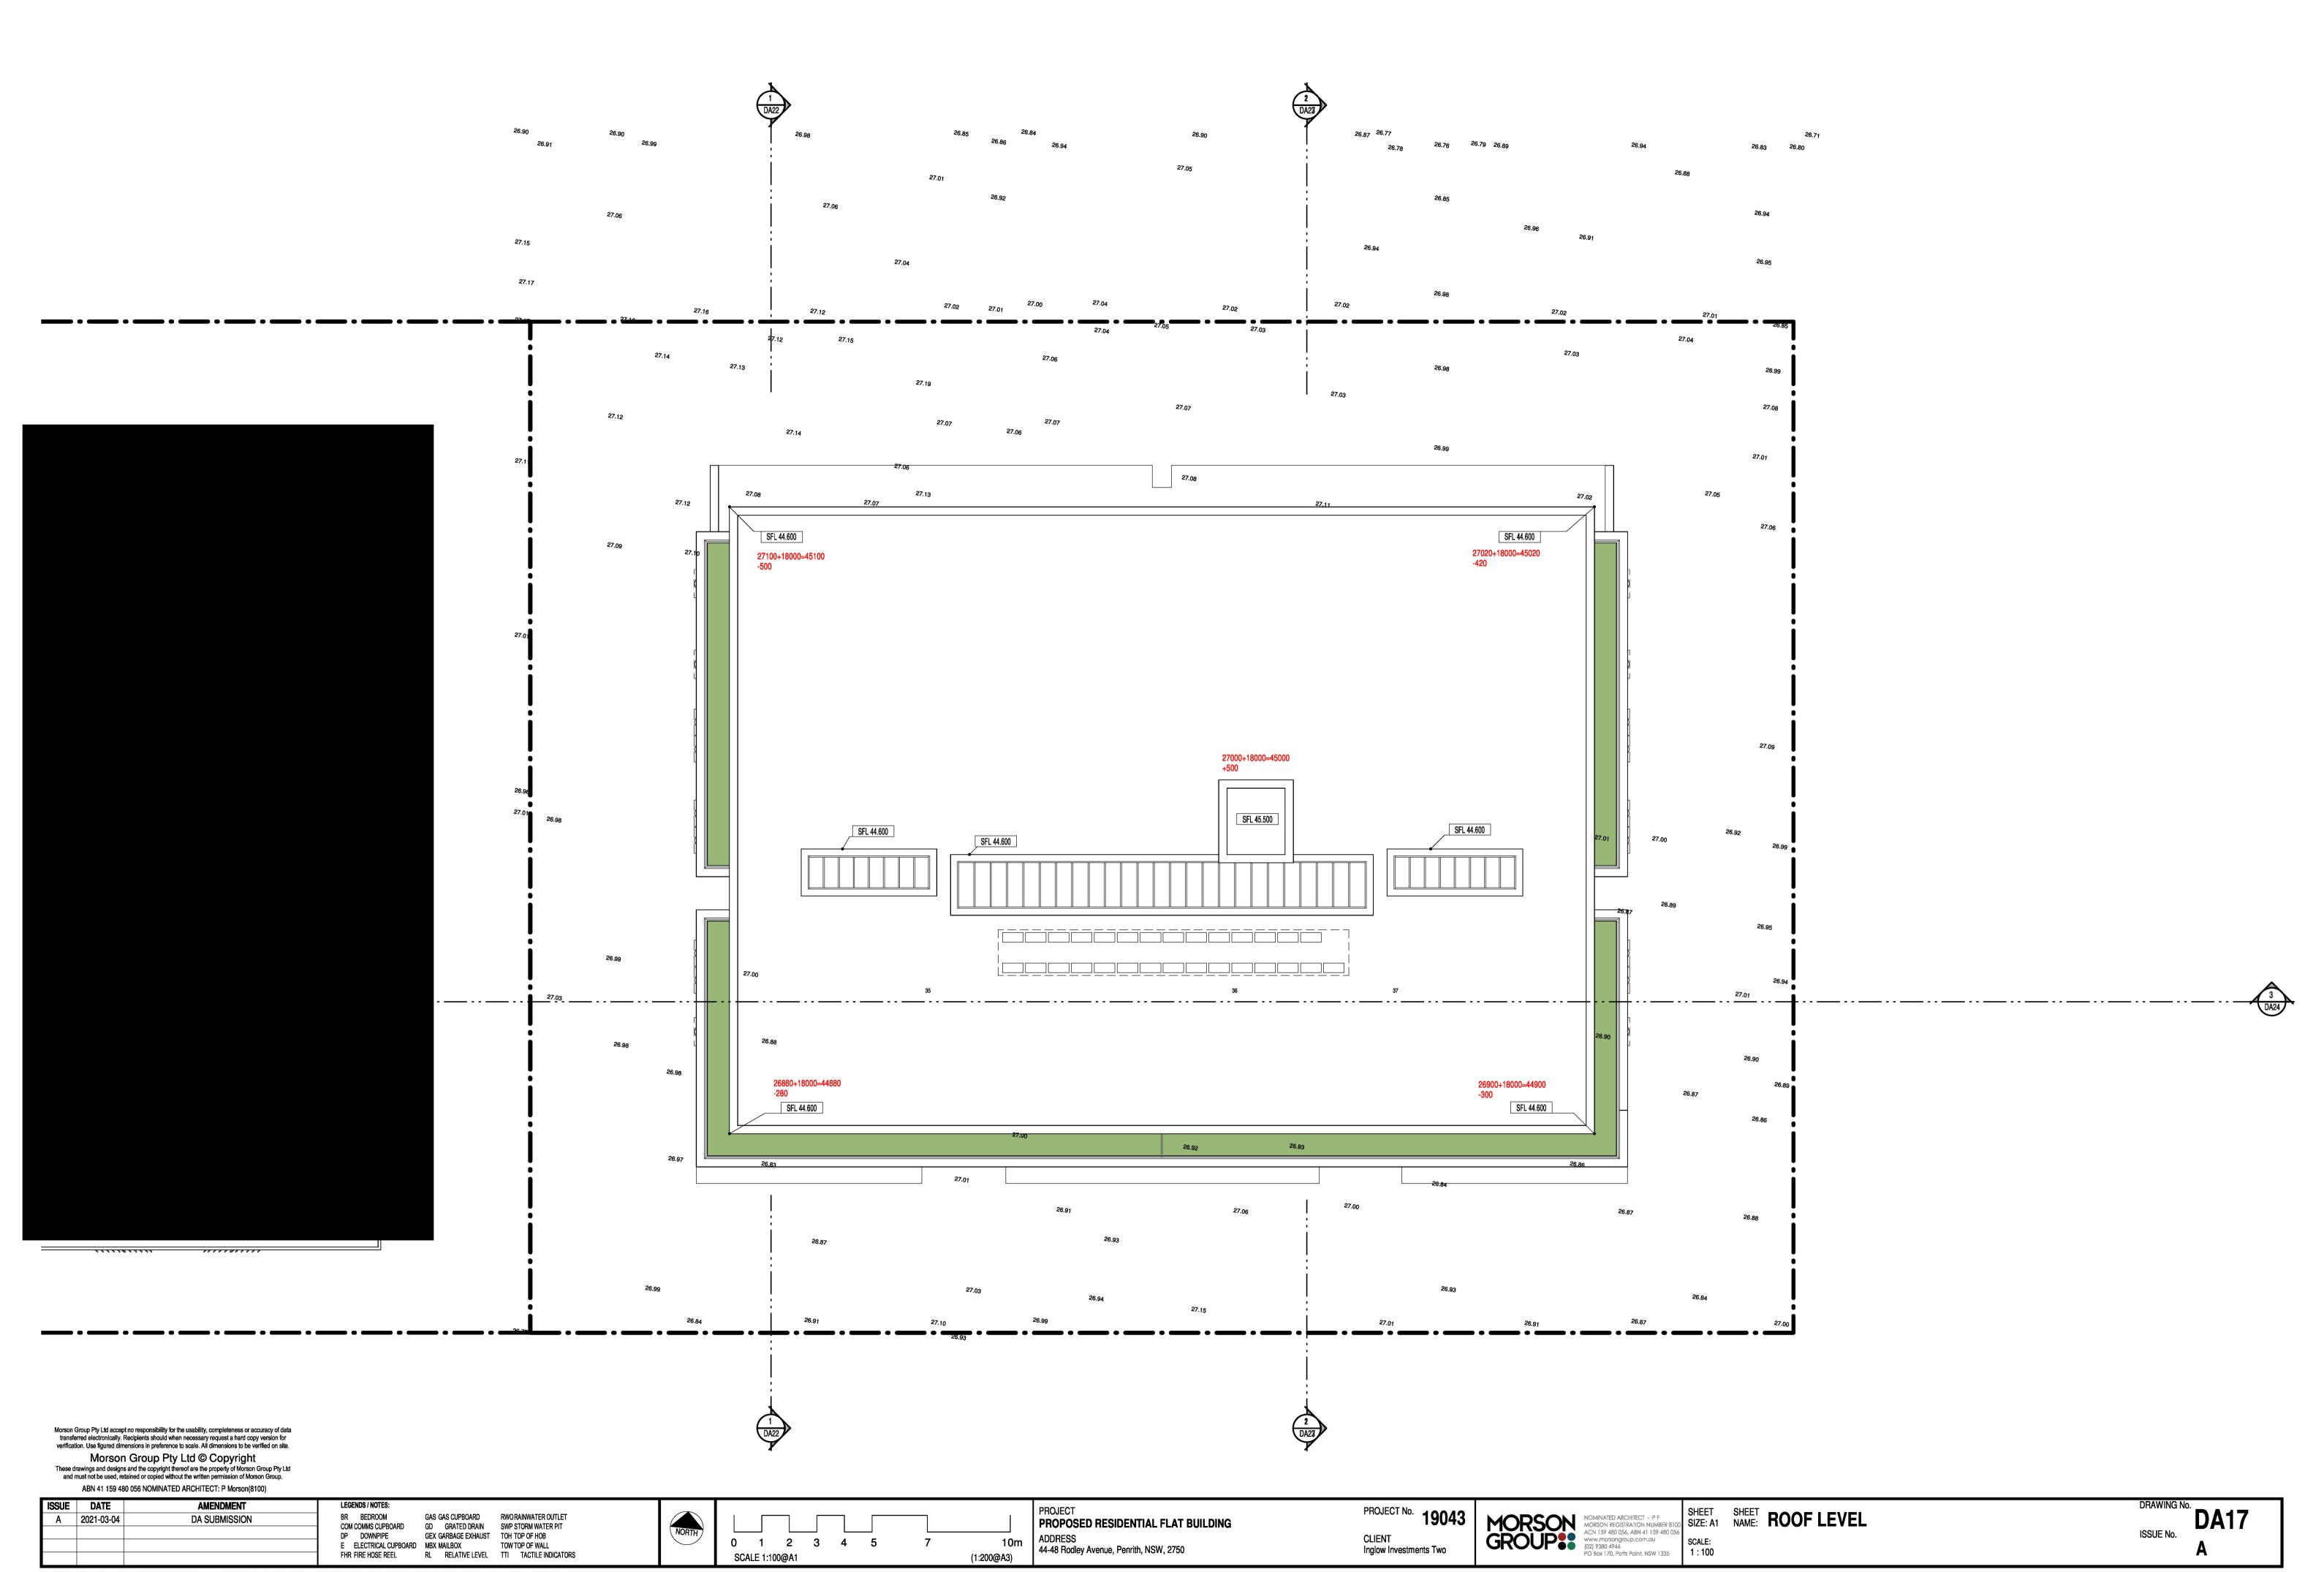FBK3
AB-Bricks
Whitsunday Brampton
230x76-110-240-NAT
Level 4

MFW1
Dulux Eternity Titanium Pearl
Satin 90087728
Louvres and Window Frames

CR1 Render Painted Finish Dulux Handmade Linen Quarter A213 Awnings

CR2
Render Painted Finish
Dulux Charcoal Essence 88590
Ground Level

GL01 Clear Glass Window MSC1
Dulux Eternity Titanium
Pearl Satin 90087728
Fence

TFW1
Render Painted Finish
Dulux Handmade Linen Quarter A213
Timber Louvres with Fly Wire

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ABN 41 159 480 056 NOMINATED ARCHITECT: P Morson(8100)

ISSUE DATE AMENDMENT SHEET SIZE: A1 SHEET NAME: NORTH FACADE GAS GAS CUPBOARD RWORAINWATER OUTLET GD GRATED DRAIN SWP STORM WATER PIT MORSON A GROUP ** BR BEDROOM A 2021-03-04 DA SUBMISSION PROPOSED RESIDENTIAL FLAT BUILDING COM COMMS CUPBOARD ISSUE No. GEX GARBAGE EXHAUST TOH TOP OF HOB ADDRESS 44-48 Rodley Avenue, Penrith, NSW, 2750 CLIENT Inglow Investments Two SCALE: As indicated 0 1 2 3 4 5 10m E ELECTRICAL CUPBOARD MBX MAILBOX TOWTOP OF WALL
FHR FIRE HOSE REEL RL RELATIVE LEVEL TTI TACTILE INDICATORS SCALE 1:100@A1 (1:200@A3)





FBK2
AB-Bricks
Bowral Brahman Granite
230x76-110-240-NAT
Level 1-4

FBK3
AB-Bricks
Whitsunday Brampton
230x76-110-240-NAT
Level 4

MFW1
Dulux Eternity Titanium Pearl
Satin 90087728
Louvres and Window Frames

CR1
Render Painted Finish
Dulux Handmade Linen Quarter
A213
Awnings

CR2
Render Painted Finish
Dulux Charcoal Essence 88590
Ground Level

GL01 Clear Glass Window MSC1
Dulux Eternity Titanium
Pearl Satin 90087728
Fence

TFW1 Render Painted Finish Dulux Handmade Linen Quarter A213

Timber Louvres with Fly Wire

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ABN 41 159 480 056 NOMINATED ARCHITECT: P Morson(8100) ISSUE DATE AMENDMENT LEGENDS / NOTES: SHEET SIZE: A1 SHEET NAME: SOUTH FACADE PROJECT MORSON REGISTRATION N ACN 159 480 056, ABN 41 www.morsongroup.com.6 (02) 9380 4946 PO Rey 170 Potts Point N BR BEDROOM GAS GAS CUPBOARD RWORAINWATER OUTLET A 2021-03-04 DA SUBMISSION PROPOSED RESIDENTIAL FLAT BUILDING COM COMMS CUPBOARD GD GRATED DRAIN SWP STORM WATER PIT ISSUE No. GEX GARBAGE EXHAUST TOH TOP OF HOB ADDRESS 44-48 Rodley Avenue, Penrith, NSW, 2750 CLIENT Inglow Investments Two SCALE: As indicated 0 1 2 3 4 5 10m E ELECTRICAL CUPBOARD MBX MAILBOX TOWTOP OF WALL
FHR FIRE HOSE REEL RL RELATIVE LEVEL TTI TACTILE INDICATORS SCALE 1:100@A1 (1:200@A3)







FBK3
AB-Bricks
Whitsunday Brampton
230x76-110-240-NAT
Level 4

MFW1
Dulux Eternity Titanium Pearl
Satin 90087728
NAT
Louvres and Window Frames

CR1
Render Painted Finish
Dulux Handmade Linen Quarter
A213
Awnings

CR2
Render Painted Finish
Dulux Charcoal Essence 88590
Ground Level

GL01 Clear Glass Window

MSC1
Dulux Eternity Titanium
Pearl Satin 90087728
Fence

TFW1
Render Painted Finish
Dulux Handmade Linen Quarter A213

Timber Louvres with Fly Wire

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ABN 41 159 480 056 NOMINATED ARCHITECT: P Morson(8100)

A 2021	ATE AMENDMENT -03-04 DA SUBMISSION	LEGENDS / NOTES: BR BEDROOM GAS GAS CUPBOARD RWORAINWATER OUTLET COM COMMS CUPBOARD GD GRATED DRAIN SWP STORM WATER PIT DP DOWNPIPE GEX GARBAGE EXHAUST TOH TOP OF HOB E ELECTRICAL CUPBOARD MBX MAILBOX TOW TOP OF WALL FHR FIRE HOSE REEL RL RELATIVE LEVEL TTI TACTILE INDICATORS		0 1 2 3 4 5 7 10m SCALE 1:100@A1 (1:200@A3)	PROJECT PROPOSED RESIDENTIAL FLAT BUILDING ADDRESS 44-48 Rodley Avenue, Penrith, NSW, 2750	PROJECT No. 19043 CLIENT Inglow Investments Two	MORSON REGISTRATION NUMBER 8100 ACN 159 480 056, ABN 41 159 480 056 www.morsongroup.com.au (02) 9380 4946 PO Box 170, Potts Point, NSW 1335 SHEET SHEET NAME: WEST FACADE SCALE: As indicated	DRAWING No. ISSUE No. A
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TFW1
Render Painted Finish
Dulux Handmade Linen Quarter A213
Timber Louvres with Fly Wire


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ABN 41 159 480 056 NOMINATED ARCHITECT: P Morson(8100)

ABN 41 139 460 036 NOW	MINATED ANGITTEGT. P MOISOII(6100)						
A 2021-03-04	AMENDMENT DA SUBMISSION	LEGENDS / NOTES: BR BEDROOM GAS GAS CUPBOARD RWORAINWATER OUTLET COM COMMS CUPBOARD GD GRATED DRAIN SWP STORM WATER PIT DP DOWNPIPE GEX GARBAGE EXHAUST TOH TOP OF HOB E ELECTRICAL CUPBOARD MBX MAILBOX TOW TOP OF WALL FHR FIRE HOSE REEL RL RELATIVE LEVEL TTI TACTILE INDICATORS	0 1 2 3 4 5 7 10m SCALE 1:100@A1 (1:200@A3)	PROJECT PROPOSED RESIDENTIAL FLAT BUILDING ADDRESS 44-48 Rodley Avenue, Penrith, NSW, 2750	PROJECT No. 19043 CLIENT Inglow Investments Two CLIENT Inglow Investments Two	SHEET SHEET SIZE: A1 NAME: EAST FACADE SCALE: As indicated	DRAWING No. DA21 ISSUE No. A




ISSUE No.

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	ABN 41 15	59 480 056 NOMINATED ARCHITECT: P Morson(8100)						
IS	A 2021-03-		LEGENDS / NOTES: BR BEDROOM GAS GAS CUPBOARD RWORAINWATER OUTLET COM COMMS CUPBOARD GD GRATED DRAIN SWP STORM WATER PIT DP DOWNPIPE GEX GARBAGE EXHAUST TOH TOP OF HOB E ELECTRICAL CUPBOARD MBX MAILBOX TOW TOP OF WALL FHR FIRE HOSE REEL RL RELATIVE LEVEL TTI TACTILE INDICATORS	0 1 2 3 4 5 7 10m SCALE 1:100@A1 (1:200@A3)	PROJECT PROPOSED RESIDENTIAL FLAT BUILDING ADDRESS 44-48 Rodley Avenue, Penrith, NSW, 2750	PROJECT No. 19043 CLIENT Inglow Investments Two	MORSON NOMINATED ARCHITECT - P F MORSON REGISTRATION NUMBER 8100 ACN 159 480 056, ABN 41 159 480 056 www.morsongroup.com.au (02) 9380 4946 PO Box 170, Potts Point, NSW 1335	SHEET SIZE: A1 SHEET NAME: CROSS SECTION 1 SCALE: 1:100

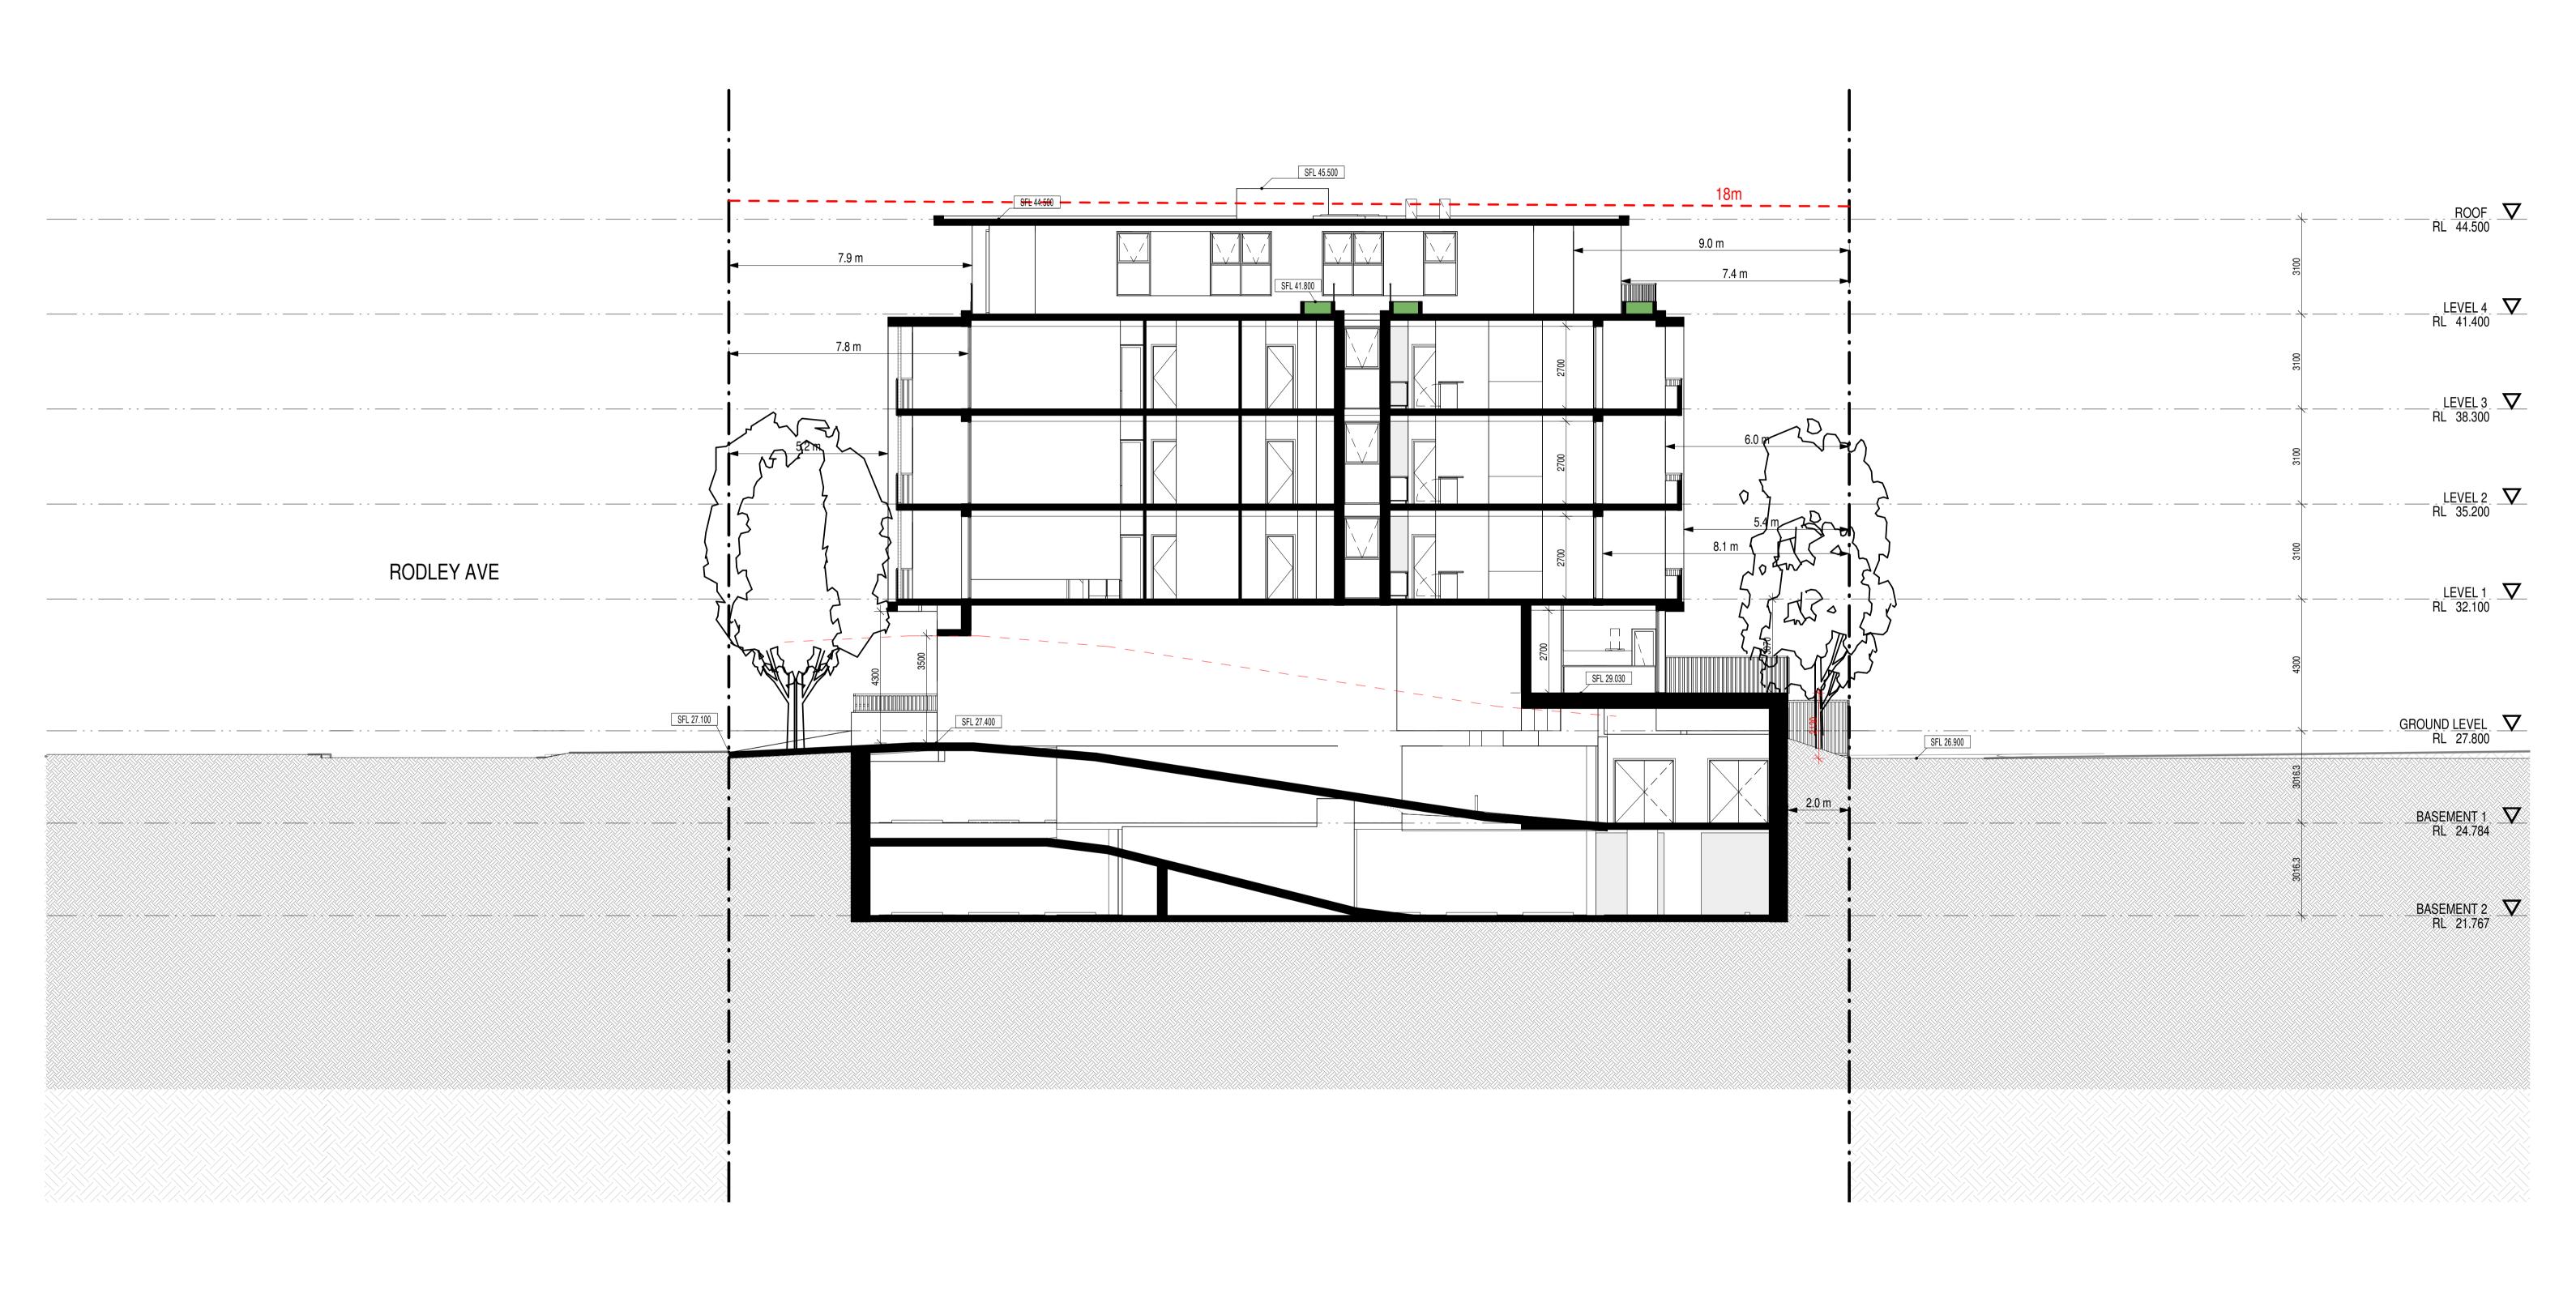

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ABN 41 159 480 056 NOMINATED ARCHITECT: P Morson(8100)

AMENDMENT LEGENDS / NOTES: BR BEDROOM GAS GAS CUPBOARD RWO RAINWATER OUTLET A 2021-03-04 DA SUBMISSION COM COMMS CUPBOARD GD GRATED DRAIN SWP STORM WATER PIT
DP DOWNPIPE GEX GARBAGE EXHAUST TOH TOP OF HOB
E ELECTRICAL CUPBOARD MBX MAILBOX TOW TOP OF WALL
FHR FIRE HOSE REEL RL RELATIVE LEVEL TTI TACTILE INDICATORS

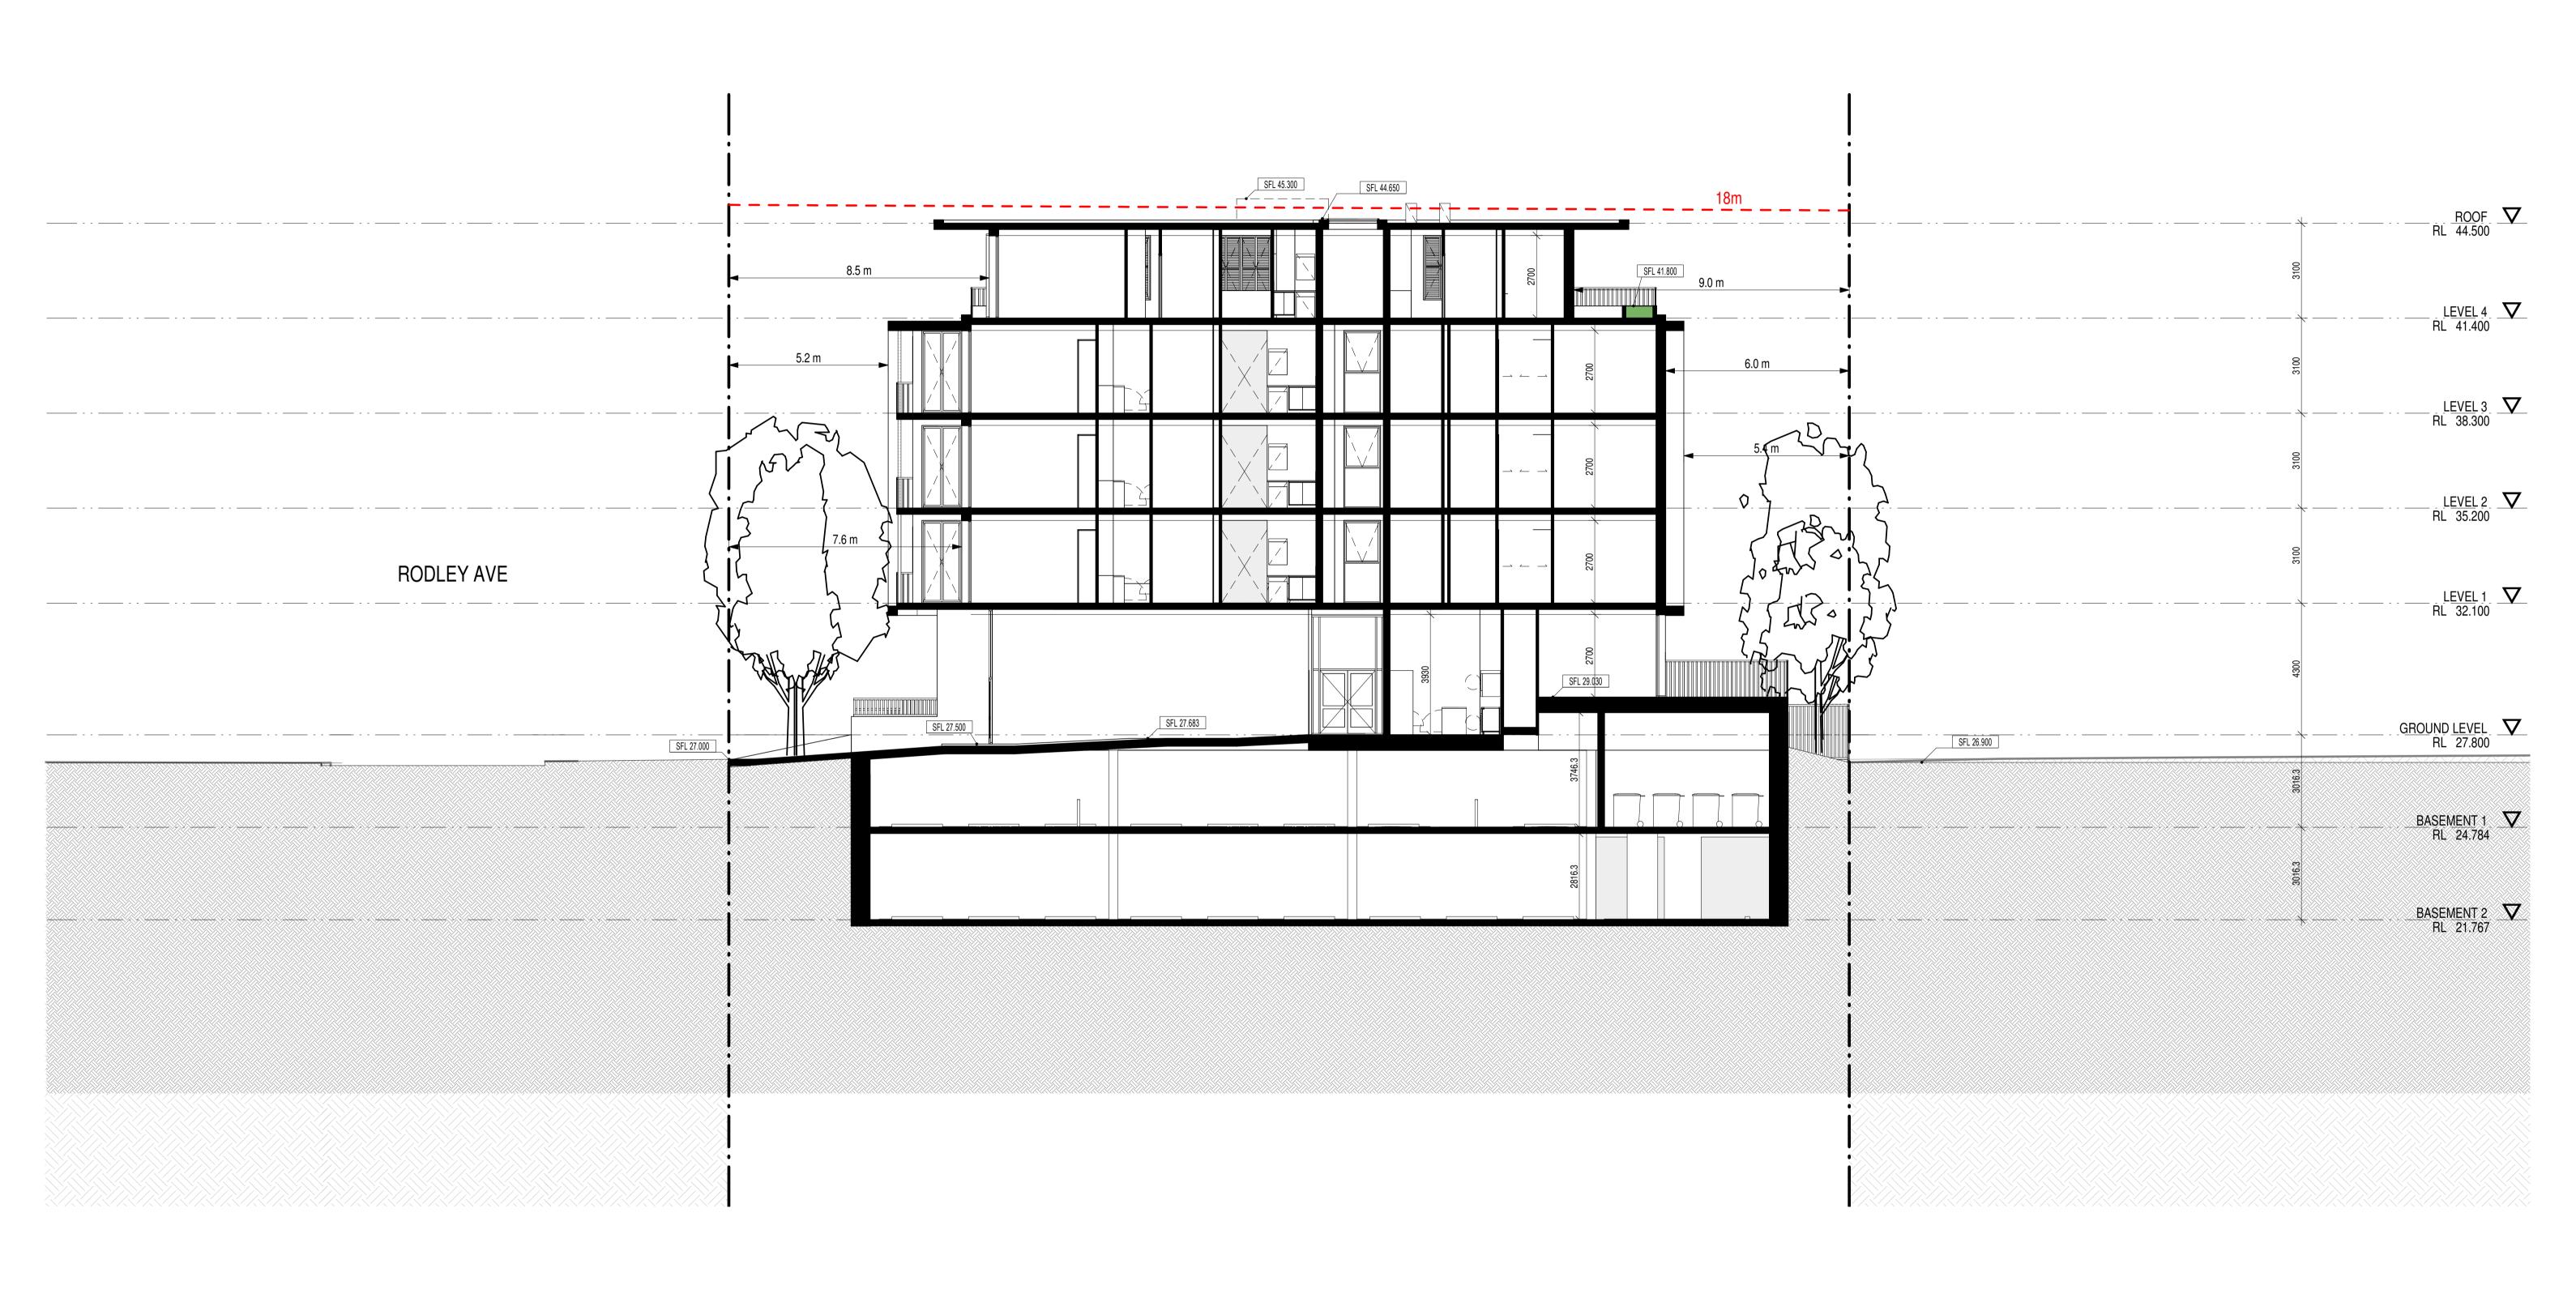PROJECT 0 1 2 3 4 5 10m SCALE 1:100@A1 (1:200@A3)

PROPOSED RESIDENTIAL FLAT BUILDING ADDRESS 44-48 Rodley Avenue, Penrith, NSW, 2750

CLIENT Inglow Investments Two

MORSON NOMINATED ARCHITECT - P F MORSON REGISTRATION NUMBER 81 ACN 159 480 056, ABN 41 159 480 05 www.morsongroup.com.au (02) 9380 4946 PO Box 170, Potts Point, NSW 1335 SCALE: 1:100

SHEET SHEET CROSS SECTION 2

ISSUE No.

ISSUE DATE




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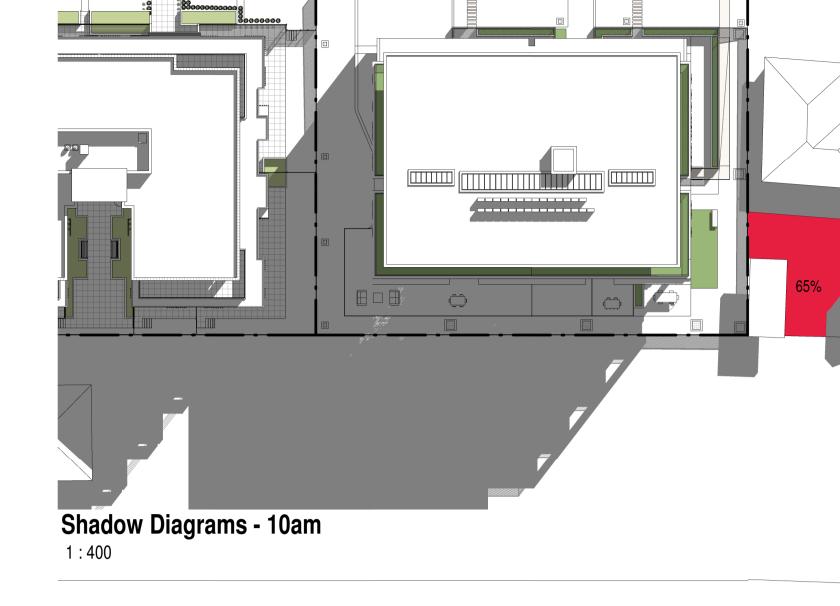
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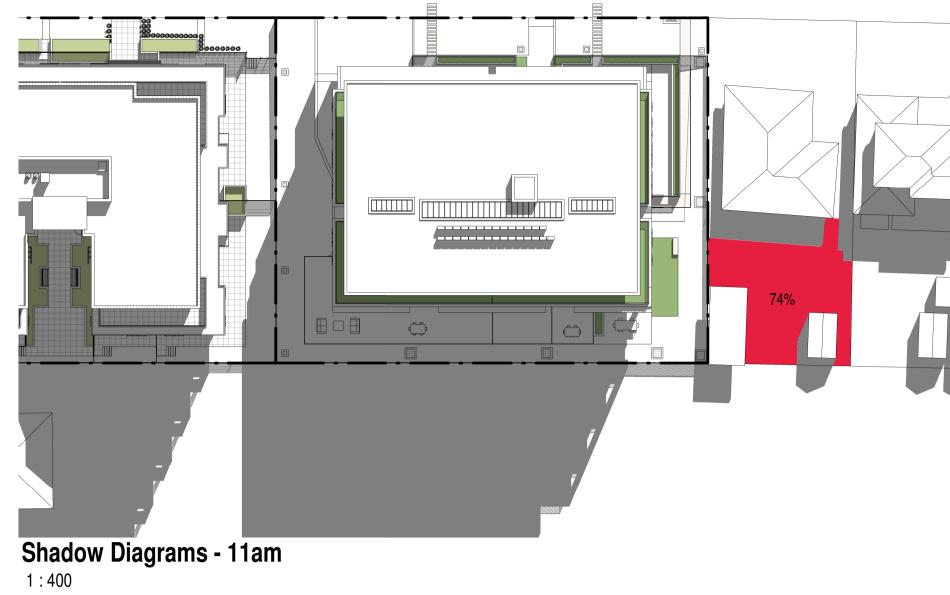
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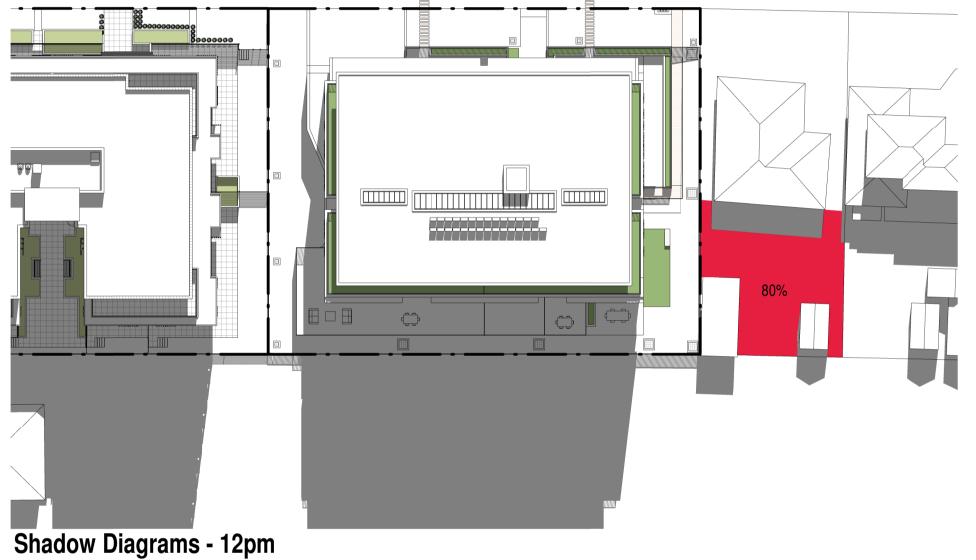
ABN 41 159 480 056 NOMINATED ARCHITECT: P Morson(8100)


F	A 2021-03	AMENDMENT LEGENDS D4 DA SUBMISSION BR B COMPON	DS / NOTES: BEDROOM GAS GAS CUPBOARD RWORAINWATER OUTLET	PROJE PROJE	ECT PROJECT No. 19043	MORSON NOMINATED ARCHITECT - P.F. SHEET SHEET LONG SECTION SHEET SHEET NAME: LONG SECTION	DA24
-		DP D	OMMS CUPBOARD GD GRATED DRAIN SWP STORM WATER PIT DOWNPIPE GEX GARBAGE EXHAUST TOH TOP OF HOB LECTRICAL CUPBOARD MBX MAILBOX TOW TOP OF WALL RE HOSE REEL RL RELATIVE LEVEL TTI TACTILE INDICATORS	0 1 2 3 4 5 7 10m ADDRE 44-48 F	RESS Rodley Avenue, Penrith, NSW, 2750 CLIENT Inglow Investments Two	MORSON REGISTRATION NUMBER 8100 ACN 159 480 056, ABN 41 159 480 056 www.morsongroup.com.au (02) 9380 4946 PO Box 170, Potts Point, NSW 1335 SHEET SHEET NAME: LONG SECTION SHEET NAME: LONG SECTION SCALE: 1:100	ISSUE No.









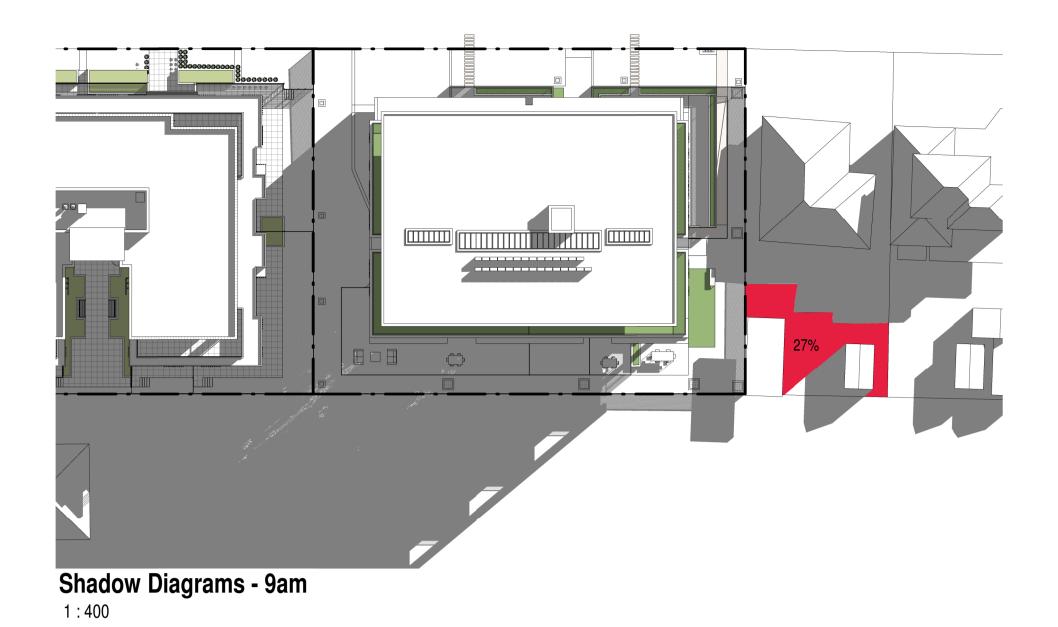

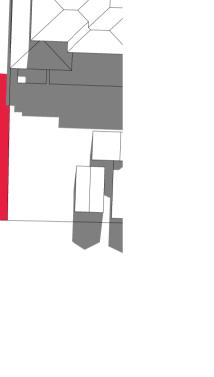

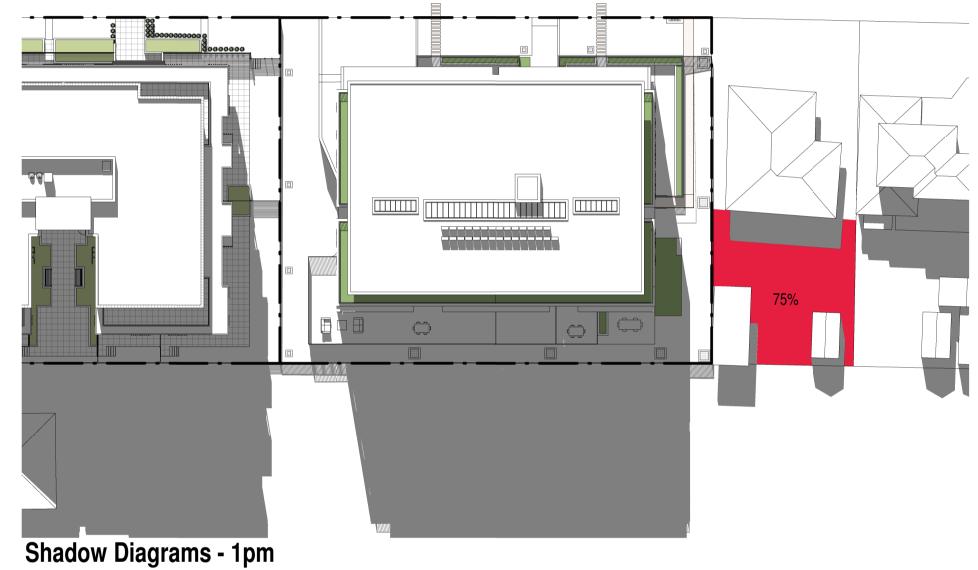

Shadow Diagrams - 2pm

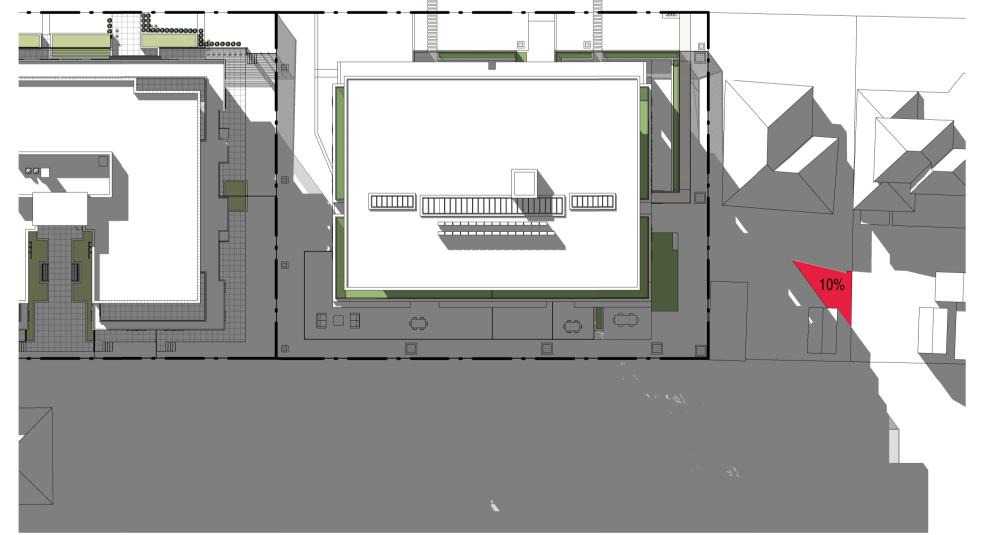

Shadow Diagrams - 3pm

1:400
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ISSUE DATE BR BEDROOM GAS GAS CUPBOARD RWO RAINWATER OUTLET A 2021-03-04 DA SUBMISSION GD GRATED DRAIN SWP STORM WATER PIT GEX GARBAGE EXHAUST TOH TOP OF HOB COM COMMS CUPBOARD E ELECTRICAL CUPBOARD MBX MAILBOX TOW TOP OF WALL
FHR FIRE HOSE REEL RL RELATIVE LEVEL TTI TACTILE INDICATORS



PROPOSED RESIDENTIAL FLAT BUILDING ADDRESS 44-48 Rodley Avenue, Penrith, NSW, 2750

CLIENT Inglow Investments Two


MORSON REGISTRATION NUMBER 8
ACN 159 480 056, ABN 41 159 480 05
www.morsongroup.com.au
(02) 9380 4946
(02) 9380 4746

SHEET SHEET SOLAR STUDY SCALE: 1:400


ISSUE No.

Version: 1, Version Date: 19/03/2021




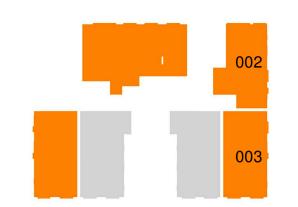


DL_GROUND LEVEL

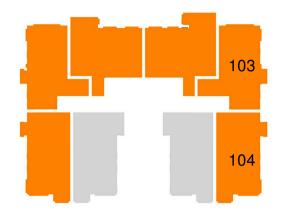


DL_LEVEL 1

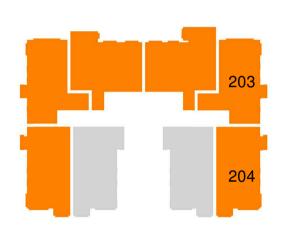

DL_LEVEL 2

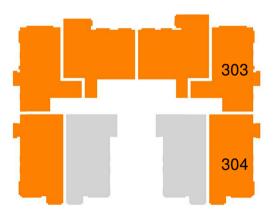

DL_LEVEL 3

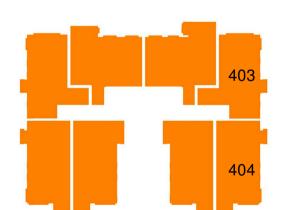

DL_LEVEL 4



DL_LEVEL 5


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ABN 41 159 480 056 NOMINATED ARCHITECT: P Morson(8100)

SEF	PP 65 COMPLI	ANCE S	CHE	EDU	LE	
Unit No.	Unit Type	Area	Cross Ventilation	Day Light Access	Kitchen 8m from Window	Parking Spaces
ROUND L	EVEL					
01	3_BD	121 m²	No	Yes	Yes	2
02	2_BD	75 m²	Yes	Yes	Yes	1
03	2_BD	77 m²	Yes	Yes	Yes	1
04	2_BD	81 m²	Yes	No	Yes	1
05	2_BD	81 m²	Yes	No	Yes	1
06	2_BD	77 m²	Yes	Yes	Yes	1
W - LEVE	L 1 2_BD	02 m²	Na	Vac	Vac	4
01 02	2_BD	82 m ² 86 m ²	No No	Yes	Yes Yes	1
03	2_BD (Adaptable)	77 m ²	Yes	Yes	Yes	1
04	2_BD (Adaptable)	77 m²	Yes	Yes	Yes	1
05	2_BD	80 m ²	Yes	No	Yes	1
	2_BD		100100000000000000000000000000000000000	No		1
06	2_BD	80 m ² 78 m ²	Yes		Yes	
07 08	2_BD	76 III ²	Yes	Yes	Yes	1
EVEL 2	2_60	77 111	162	162	162	1
01	2 BD	82 m²	No	Yes	Yes	1
02	2_BD 2_BD		No	Yes	Yes	1
03	2_BD (Adaptable)	86 m ² 77 m ²	Yes	Yes	Yes	1
04	2_BD (Adaptable)	77 m²	Yes	Yes	Yes	1
0 4 05			Yes		Yes	1
	2_BD	80 m ²		No		
06	2_BD	80 m ²	Yes	No Yes	Yes	1
07	2_BD	78 m²	Yes		Yes	1
08 EVEL 3	2_BD	77 m²	Yes	Yes	Yes	1
EVEL 3	2 BD	22 m²	No	Yes	Yes	1
	2_BD	82 m²	No	Yes	Yes	1
02	2_BD (Adentable)	86 m²				-
03 04	2_BD (Adaptable) 2_BD	77 m ² 78 m ²	Yes	Yes Yes	Yes	1
0 4 05	2_BD 2 BD	80 m ²	Yes	No	Yes	1
		80 m ²		No		1
06 07	2_BD 2 BD	78 m ²	Yes	Yes	Yes	1
07 08	2_BD 2 BD	78 m²	Yes	Yes	Yes	1
EVEL 4	2_50	77 111	162	162	165	•
01	2 BD	82 m²	No	Yes	Yes	1
02	2_BD	86 m ²	No	Yes	Yes	1
03		77 m ²	Yes	Yes	Yes	1
03 04	2_BD (Adaptable)	77 m ² 78 m ²	Yes	Yes	Yes	1
	2_BD					
05 06	2_BD	80 m ²	Yes	Yes	Yes	1
	2_BD	80 m ²	Yes	Yes	Yes	1
07 ng	2_BD	78 m ²				1
08 EVEL 5	2_BD	1111111	Yes	Yes	Yes	
01	3_BD	103 m²	Yes	Yes	Vec	2
UI	3_60	103 111	162	162	162	4







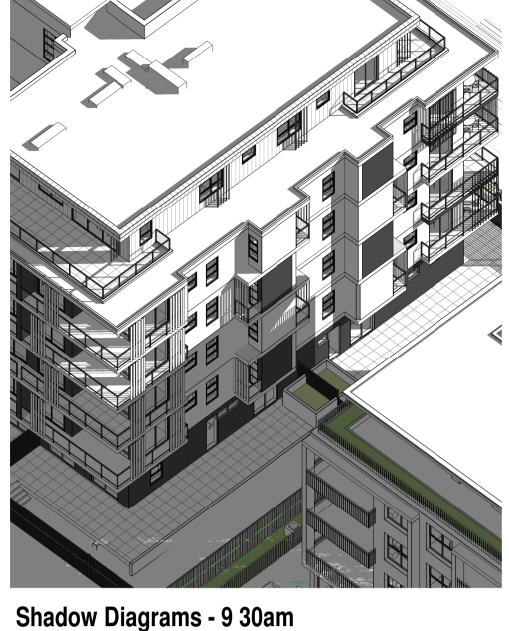



Shadow Diagrams - 10am

Shadow Diagrams - 10 30am



Shadow Diagrams - 9am





Shadow Diagrams - 11am

Shadow Diagrams - 11 30am

Shadow Diagrams - 12pm


Front Units: 002, 103, 203, 303, 403, 502

The proposed development at 44-48 Rodley Ave does not affect balcony and living room of those units from 9am to 3pm at mid winter

Rear Units: 003, 104, 204, 304, 404, 503

- -Unit 003: Currently it achieves sun access from 9am to 11am. When the building at 44-48 Rodley Ave is developed it will achieve sun access from 10:30am to 11am. It will not comply.
- -Unit 104: Currently it achieves sun access from 9am to 11:30am. When the building at 44-48 Rodley Ave is developed it will achieve sun access from 10:30am to 11:30am. It will not comply. -Unit 204: Currently it achieves sun access from 9am to 11:30am. When the building at 44-48 Rodley Ave is developed it will achieve sun access from 10am to 11:30am. It will not comply.
- -Unit 304: Currently it achieves sun access from 9am to 11:30am. When the building at 44-48 Rodley Ave is developed it will achieve sun access from 9:30am to 11:30am. It will comply.
- -Units 404 and 503 are not affected by the development at 44-48 Rodley Ave

CONCLUSION: 31 units will receive solar access from 9am to 3pm at mid winter. 73,8%

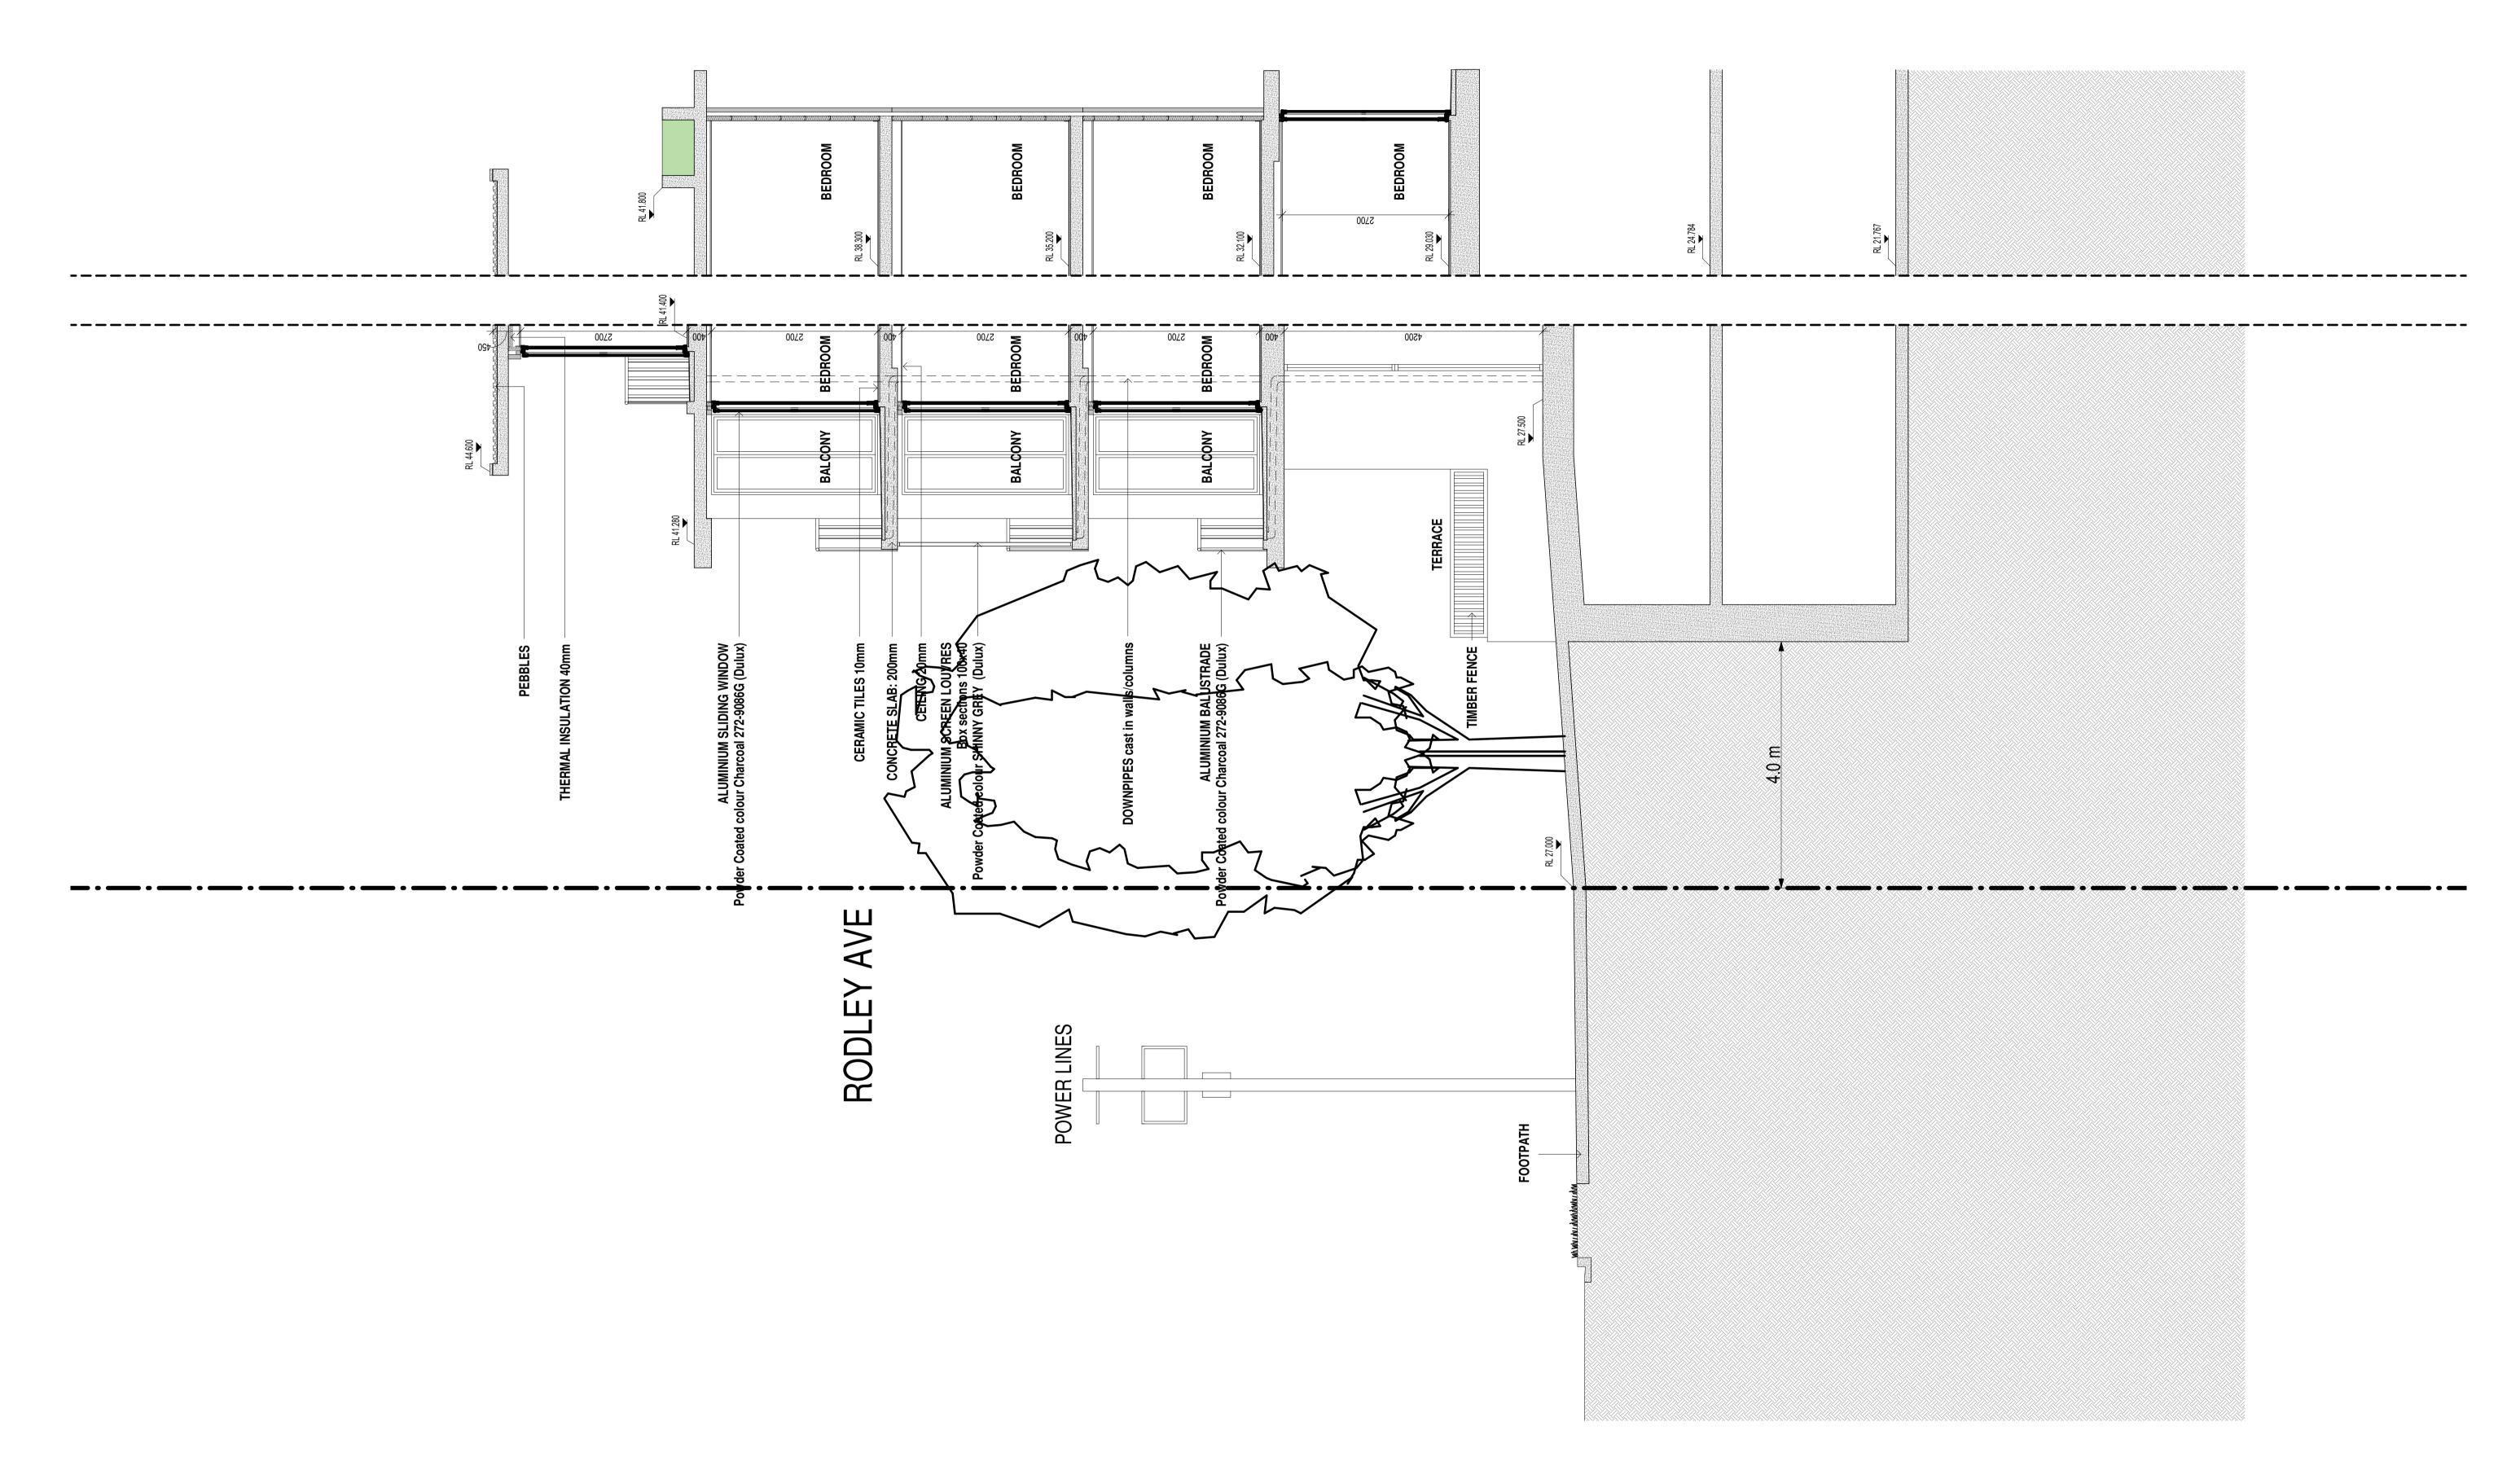


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ABN 41 159 480 056 NOMINATED ARCHITECT: P Morson(8100)

ISSUE DATE AMENDMENT LEGENDS / NOTES: SHEET SHEET SECTION 1-50 PROJECT MORSON REGISTRATION NUMBER 81 ACN 159 480 056, ABN 41 159 480 05 www.morsongroup.com.au (20) 9380 4946 BR BEDROOM GAS GAS CUPBOARD RWORAINWATER OUTLET A 2021-03-04 DA SUBMISSION PROPOSED RESIDENTIAL FLAT BUILDING COM COMMS CUPBOARD GD GRATED DRAIN SWP STORM WATER PIT
DP DOWNPIPE GEX GARBAGE EXHAUST TOH TOP OF HOB
E ELECTRICAL CUPBOARD MBX MAILBOX TOW TOP OF WALL
FHR FIRE HOSE REEL RL RELATIVE LEVEL TTI TACTILE INDICATORS ISSUE No. ADDRESS 44-48 Rodley Avenue, Penrith, NSW, 2750 CLIENT Inglow Investments Two SCALE: 1:50 SCALE 1:50@A1 (1:100@A3)



FBK1

AB-Bricks
Bowral Simmental Silver
230x76-110-240-NAT

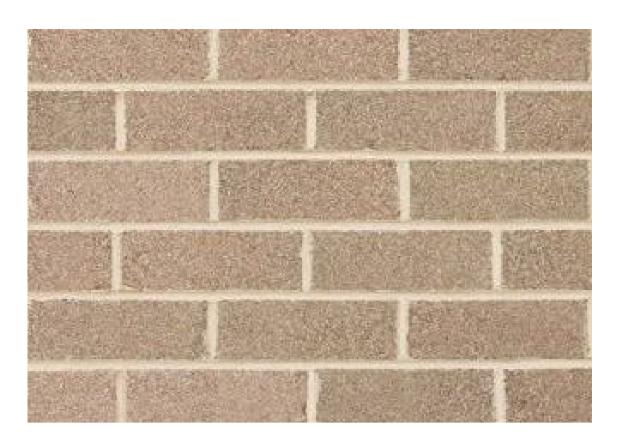Level 1-3




Render Painted Finish
Dulux Handmade Linen
Quarter A213

Awnings



Render Painted Finish
Dulux Handmade Linen
Quarter A213


Timber Louvres with Fly Wire

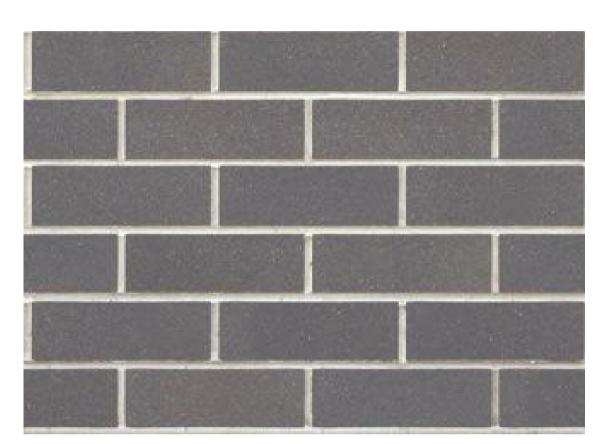

FBK2

AB-Bricks
Bowral Brahman Granite
230x76-110-240-NAT

Level 1-4

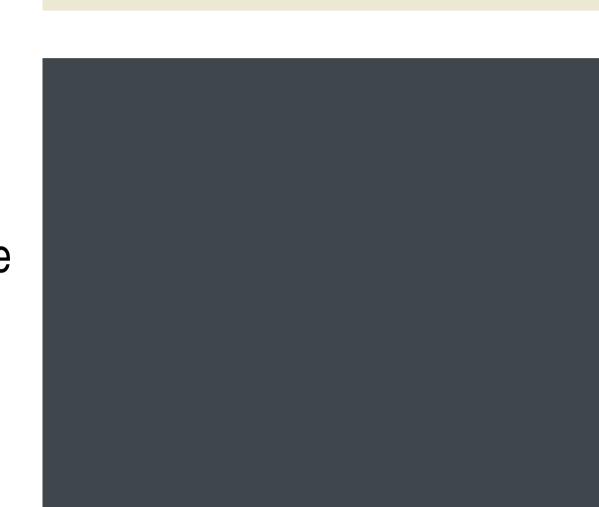

CR2

Render Painted Finish Dulux Charcoal Essence 88590

Ground Level



FBK3

AB-Bricks
Whitsunday Brampton
230x76-110-240-NAT

Level 4



Clear Glass Window



MFW1

Dulux Eternity Titanium Pearl Satin 90087728

Louvres and Window Frames



MSC₁

Dulux Eternity Titanium Pearl Satin 90087728

Fence

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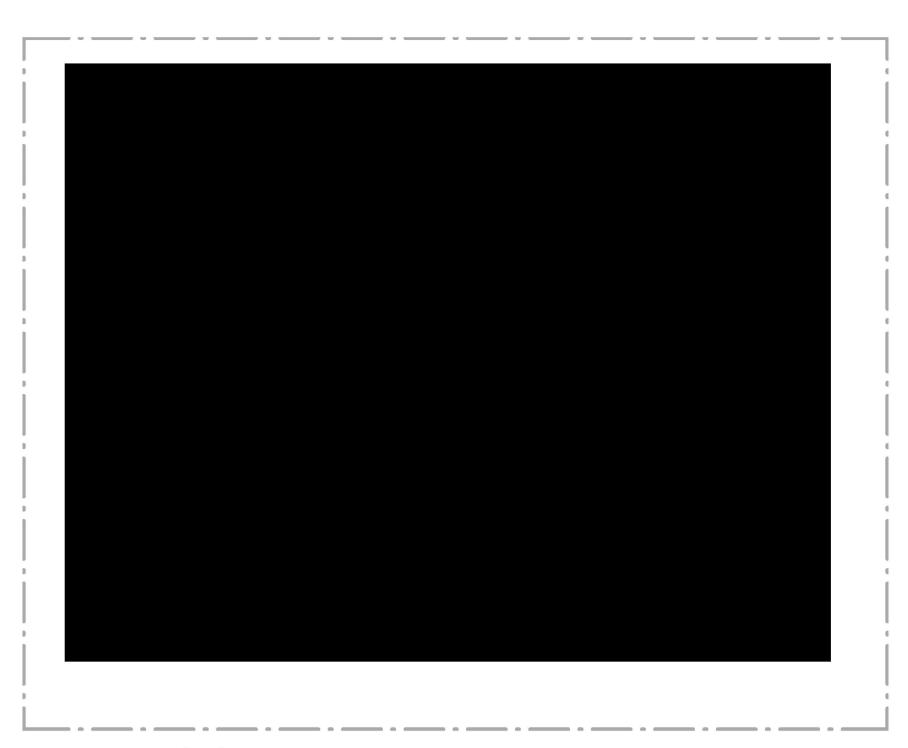
JUL	DAIL	AMENDMENT	1 2202/10/10/120		
Α	2021-03-04	DA SUBMISSION	BR BEDROOM GAS GAS CUPBOARD RWORAINWATER OUTL COM COMMS CUPBOARD GD GRATED DRAIN SWP STORM WATER PI	RWO RAINWATER OUTLET	
			DP DOWNPIPE GEX GARBAGE EXHAUST TOH TOP OF HOB	ı	
			E ELECTRICAL CUPBOARD MBX MAILBOX TOW TOP OF WALL		
			FHR FIRE HOSE REEL RL RELATIVE LEVEL TTI TACTILE INDICA	\TOR	



GROUND LEVEL WINDOWS
1:200



LEVEL 1 WINDOWS
1:200




LEVEL 2 WINDOWS

1:200



LEVEL 3 WINDOWS

1:200

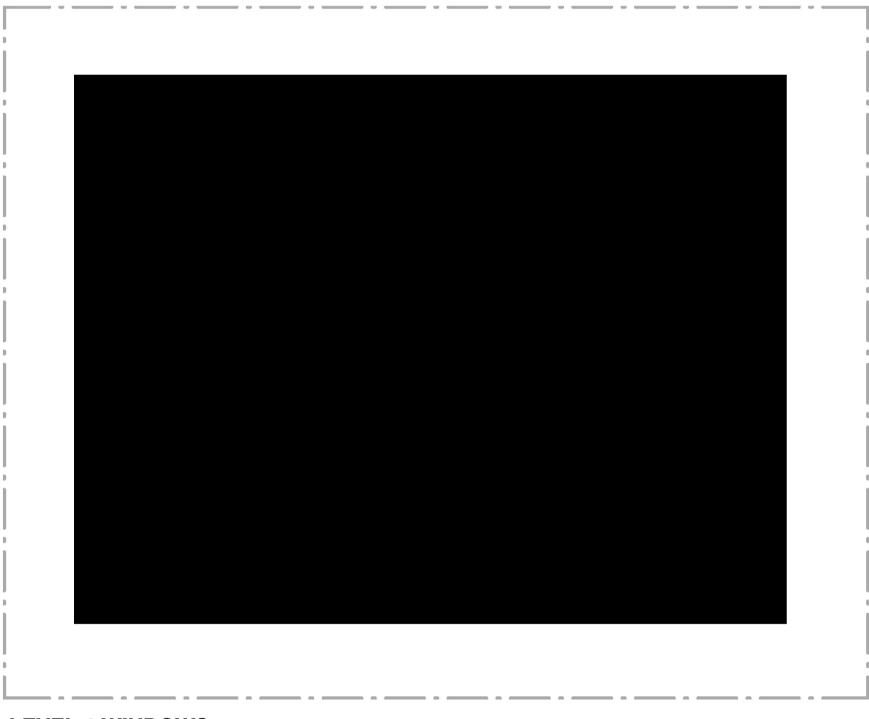

LEVEL 4 WINDOWS

1:200

WINDOW SCHEDULE
 GROUND LEVEL

 01-1
 Sliding
 4000
 3600
 0

 01-2
 Sliding
 2400
 3600
 0

 01-3
 Sliding
 2400
 3600
 0

 02-1
 Sliding
 2400
 3600
 0

 02-2
 Sliding
 5300
 3600
 0

 02-3
 Awning
 1100
 2100
 600

 02-4
 Awning
 2000
 2100
 600

 02-4
 Awning
 1990
 2100
 600

 02-5
 Awning
 1990
 2100
 600

 02-5
 Awning
 1990
 2100
 600

 03-1
 Sliding
 2400
 2700
 1230

 03-2
 Sliding
 2400
 2700
 1230

 03-3
 Sliding
 2400
 2700
 1230

 03-4
 Sliding
 2400
 2700
 1230

 03-5
 Sliding
 2400
 2700
 1230

 04-1</t **GROUND LEVEL**

		WIND	OW SC	HEDUI	LE
No.	Opening	Opening Width	Opening Height	Sill Height	Comments
VEL 0					
VEL 2	Awning	2000	2100	600	
1	Awning	1990	2100	600	Flywire Timber Louvre
2	Awning	2000	2100	600	- Tywno Timbol Louvio
2	Awning	1990	2100	600	Flywire Timber Louvre
3	Awning	1100	2100	600	,
4	Awning	1100	2100	600	
4	Awning	1090	2100	600	Flywire Timber Louvre
5	Sliding	5370	2700	0	
1	Awning	1066	1900	600	1
2	Awning	1066	1900	600	-
3	Awning	1066	1900	600	-
4 5	Casement Sliding	1300 2400	2700 2700	0	
ე 6	Sliding	2400	2700	0	+
1	Sliding	2400	2700	0	<u> </u>
2	Sliding	2400	2700	0	
3	Casement	1300	2700	0	
4	Awning	1066	1900	600	
5	Awning	1066	1900	600	
6	Awning	1066	1900	600	
1	Sliding	5370	2700	0	
2	Awning	1100	2100	600	
2	Awning	1090	2100	600	Flywire Timber Louvre
3 4	Awning	1100	2100	600	
4	Awning Awning	2000 1990	2100 2100	600	Flywire Timber Louvre
5	Awning	2000	2100	600	Flywile Hilloel Louvie
5	Awning	1990	2100	600	Flywire Timber Louvre
1	Awning	2000	2100	600	
1	Awning	1990	2100	600	Flywire Timber Louvre
2	Awning	1100	2100	600	
2	Awning	1090	2100	600	Flywire Timber Louvre
3	Sliding	4438	2700	0	
4	Awning	2000	2100	600	
5 I	Awning Sliding	2000 4337	2100 2700	600	
2	Awning	2000	2100	600	
- 3	Awning	2000	2100	600	
1	Awning	2000	2100	600	
2	Awning	2000	2100	600	
3	Sliding	4438	2700	0	
4	Awning	1100	2100	600	
4	Awning	1090	2100	600	Flywire Timber Louvre
5	Awning	2000	2100	600	Charina Timb and an
5	Awning	1990	2100	600	Flywire Timber Louvre
/EL3					
1	Awning	2000	2100	600	
1	Awning	1990	2100	600	Flywire Timber Louvre
2	Awning	2000	2100	600	
2	Awning	1990	2100	600	Flywire Timber Louvre
3	Awning	1100	2100	600	
4	Awning	1100	2100	600	Floritor Train
<u> </u>	Awning	1090	2100	600	Flywire Timber Louvre
5	Sliding Awning	5370 1066	2700	600	-
1 2	Awning	1066	1900 1900	600	+
3	Awning	1066	1900	600	+
4	Casement	1300	2700	0	
5	Sliding	2400	2700	0	
3	Sliding	2400	2700	0	
1	Sliding	2400	2700	0	
2	Sliding	2400	2700	0	
3		1300	2700	0	

	Opening	<u>8</u>	<u>8</u>	S	Comments
33-4	Awning	1066	1900	600	
33-5	Awning	1066	1900	600	
33-6	Awning	1066	1900	600	
34-1	Sliding	5370	2700	0	
34-2	Awning	1100	2100	600	
34-2	Awning	1090	2100	600	Flywire Timber Louvre
34-3	Awning	1100	2100	600	T Tywire Timber Louvie
34-4	Awning	2000	2100	600	
34-4	Awning	1990	2100	600	Flywire Timber Louvre
34-5		2000	2100	600	Flywire Hillber Louvie
34-5	Awning				Flywire Timber Louvre
	Awning	1990	2100	600	Flywire Timber Louvin
35-1	Awning	2000	2100	600	Charica Timber I amor
35-1	Awning	1990	2100	600	Flywire Timber Louvre
35-2	Awning	1100	2100	600	Charica Timber Leann
35-2	Awning	1090	2100	600	Flywire Timber Louvre
35-3	Sliding	4438	2700	0	
35-4	Awning	2000	2100	600	
35-5	Awning	2000	2100	600	
36-1	Sliding	4337	2700	0	
36-2	Awning	2000	2100	600	
36-3	Awning	2000	2100	600	
37-1	Awning	2000	2100	600	
37-2	Awning	2000	2100	600	
37-3	Sliding	4438	2700	0	
37-4	Awning	1100	2100	600	
37-4	Awning	1090	2100	600	Flywire Timber Louvr
37-5	Awning	2000	2100	600	
37-5	Awning	1990	2100	600	Flywire Timber Louve
	Awning	1990	2100	600 600	Flywire Timber Louve
41-1 41-2	Awning	1100	2100	600 600	·
41-2 41-2	Awning Awning	1100 1090	2100 2100	600 600	·
41-2 41-2 41-3	Awning Awning Sliding	1100 1090 3900	2100 2100 2700	600 600 600 0	·
41-2 41-2 41-3 41-4	Awning Awning Sliding Sliding	1100 1090 3900 2400	2100 2100 2700 2700	600 600 600 0	·
41-2 41-2 41-3 41-4 41-5	Awning Awning Sliding Sliding Sliding	1100 1090 3900 2400 2400	2100 2100 2700 2700 2700	600 600 0 0	·
41-2 41-2 41-3 41-4 41-5 41-6	Awning Awning Sliding Sliding Sliding Sliding	1100 1090 3900 2400 2400 2400	2100 2100 2700 2700 2700 2700	600 600 0 0 0	·
41-2 41-2 41-3 41-4 41-5 41-6 42-1	Awning Awning Sliding Sliding Sliding Sliding Sliding Sliding	1100 1090 3900 2400 2400 2400 2400	2100 2100 2700 2700 2700 2700 2700	600 600 600 0 0 0	·
41-2 41-2 41-3 41-4 41-5 41-6 42-1 42-2	Awning Awning Sliding Sliding Sliding Sliding Sliding Sliding Sliding Sliding	1100 1090 3900 2400 2400 2400 2400 2400	2100 2100 2700 2700 2700 2700 2700 2700	600 600 0 0 0 0 0	·
41-2 41-3 41-4 41-5 41-6 42-1 42-2 42-3	Awning Awning Sliding Sliding Sliding Sliding Sliding Sliding Sliding Sliding Sliding	1100 1090 3900 2400 2400 2400 2400 2400 2400	2100 2100 2700 2700 2700 2700 2700 2700	600 600 0 0 0 0 0 0	·
41-2 41-3 41-4 41-5 41-6 42-1 42-2 42-3 42-4	Awning Awning Sliding	1100 1090 3900 2400 2400 2400 2400 2400 2400 3900	2100 2100 2700 2700 2700 2700 2700 2700	600 600 0 0 0 0 0 0 0	·
41-2 41-3 41-4 41-5 41-6 42-1 42-2 42-3 42-4 42-5	Awning Awning Sliding Awning	1100 1090 3900 2400 2400 2400 2400 2400 2400 3900 1100	2100 2100 2700 2700 2700 2700 2700 2700	600 600 0 0 0 0 0 0 0 0 0 0	Flywire Timber Louvre
41-2 41-3 41-4 41-5 41-6 42-1 42-2 42-3 42-4 42-5 42-5	Awning Awning Sliding Awning Awning	1100 1090 3900 2400 2400 2400 2400 2400 2400 3900 1100 1090	2100 2100 2700 2700 2700 2700 2700 2700	600 600 0 0 0 0 0 0 0 0 0 0 0 0 0 0 0 0	Flywire Timber Louvre
41-2 41-2 41-3 41-4 41-5 41-6 42-1 42-2 42-3 42-4 42-5 42-5 42-6	Awning Awning Sliding Sliding Sliding Sliding Sliding Sliding Sliding Sliding Sliding Awning Awning Awning	1100 1090 3900 2400 2400 2400 2400 2400 2400 3900 1100 1090 2000	2100 2100 2700 2700 2700 2700 2700 2700	600 600 0 0 0 0 0 0 0 0 0 0 0 0 0 0 0 0	Flywire Timber Louvre
41-2 41-2 41-3 41-4 41-5 41-6 42-1 42-2 42-3 42-4 42-5 42-5 42-6 42-6	Awning Awning Sliding Sliding Sliding Sliding Sliding Sliding Sliding Sliding Sliding Awning Awning Awning Awning	1100 1090 3900 2400 2400 2400 2400 2400 2400 3900 1100 1090 2000 1990	2100 2100 2700 2700 2700 2700 2700 2700	600 600 0 0 0 0 0 0 0 0 0 0 0 0 0 0 0 0	Flywire Timber Louvre
41-2 41-2 41-3 41-4 41-5 41-6 42-1 42-2 42-3 42-4 42-5 42-5 42-6 42-6 43-1	Awning Awning Sliding Sliding Sliding Sliding Sliding Sliding Sliding Sliding Sliding Awning Awning Awning Awning Awning Awning	1100 1090 3900 2400 2400 2400 2400 2400 2400 3900 1100 1090 2000 1990 2000	2100 2100 2700 2700 2700 2700 2700 2700	600 600 0 0 0 0 0 0 0 0 0 0 0 0 0 0 0 0	Flywire Timber Louve
41-2 41-3 41-4 41-5 41-6 42-1 42-2 42-3 42-4 42-5 42-5 42-6 43-1 43-1	Awning Awning Sliding Sliding Sliding Sliding Sliding Sliding Sliding Sliding Sliding Awning Awning Awning Awning Awning Awning Awning Awning Awning	1100 1090 3900 2400 2400 2400 2400 2400 2400 3900 1100 1090 2000 1990 2000 1990	2100 2100 2700 2700 2700 2700 2700 2700	600 600 0 0 0 0 0 0 0 0 0 0 0 0 0 0 0 0	Flywire Timber Louvre
41-2 41-2 41-3 41-4 41-5 41-6 42-1 42-2 42-3 42-4 42-5 42-5 42-6 42-6 43-1 43-1 43-2	Awning Awning Sliding Sliding Sliding Sliding Sliding Sliding Sliding Sliding Sliding Awning	1100 1090 3900 2400 2400 2400 2400 2400 2400 3900 1100 1090 2000 1990 2000 1990 1100	2100 2100 2700 2700 2700 2700 2700 2700	600 600 0 0 0 0 0 0 0 0 0 0 0 0 0 600 600 600 600 600	Flywire Timber Louvre Flywire Timber Louvre Flywire Timber Louvre
41-2 41-2 41-3 41-4 41-5 41-6 42-1 42-2 42-3 42-4 42-5 42-5 42-6 43-1 43-1 43-2 43-2	Awning Awning Sliding Sliding Sliding Sliding Sliding Sliding Sliding Sliding Sliding Awning	1100 1090 3900 2400 2400 2400 2400 2400 2400 3900 1100 1090 2000 1990 2000 1990 1100 1090	2100 2100 2700 2700 2700 2700 2700 2700	600 600 0 0 0 0 0 0 0 0 0 0 0 0 0 0 0 0	Flywire Timber Louvre Flywire Timber Louvre Flywire Timber Louvre
41-2 41-2 41-3 41-4 41-5 41-6 42-1 42-2 42-3 42-4 42-5 42-5 42-6 43-1 43-1 43-2 43-2 43-3	Awning Awning Sliding Sliding Sliding Sliding Sliding Sliding Sliding Sliding Sliding Awning Sliding Awning Awning Awning Awning Awning	1100 1090 3900 2400 2400 2400 2400 2400 2400 3900 1100 1090 2000 1990 2000 1990 1100 1090 4300	2100 2100 2700 2700 2700 2700 2700 2700	600 600 0 0 0 0 0 0 0 0 0 0 0 0 0 0 0 0	Flywire Timber Louvre Flywire Timber Louvre Flywire Timber Louvre
41-2 41-3 41-4 41-5 41-6 42-1 42-2 42-3 42-4 42-5 42-6 43-1 43-1 43-2 43-2 43-3 43-4	Awning Awning Sliding Sliding Sliding Sliding Sliding Sliding Sliding Sliding Sliding Awning Sliding Sliding Sliding Sliding	1100 1090 3900 2400 2400 2400 2400 2400 2400 3900 1100 1090 2000 1990 1100 1090 4300 2400	2100 2100 2700 2700 2700 2700 2700 2700	600 600 0 0 0 0 0 0 0 0 0 0 0 0 0 0 0 0	Flywire Timber Louvre Flywire Timber Louvre Flywire Timber Louvre
41-2 41-3 41-4 41-5 41-6 42-1 42-2 42-3 42-4 42-5 42-6 43-1 43-2 43-2 43-3 43-4 43-5	Awning Awning Sliding Sliding Sliding Sliding Sliding Sliding Sliding Sliding Sliding Awning	1100 1090 3900 2400 2400 2400 2400 2400 2400 3900 1100 1090 2000 1990 1090 4300 2400 1200	2100 2100 2700 2700 2700 2700 2700 2700	600 600 0 0 0 0 0 0 0 0 0 0 0 0 0 0 0 0	Flywire Timber Louvre Flywire Timber Louvre Flywire Timber Louvre
41-2 41-3 41-4 41-5 41-6 42-1 42-2 42-3 42-4 42-5 42-6 42-6 43-1 43-2 43-2 43-3 43-4 43-5 43-6	Awning Awning Sliding Sliding Sliding Sliding Sliding Sliding Sliding Sliding Sliding Awning Sliding Sliding Sliding Sliding Sliding Sliding	1100 1090 3900 2400 2400 2400 2400 2400 2400 3900 1100 1090 2000 1990 2000 1990 1090 4300 2400 1200 2400	2100 2100 2700 2700 2700 2700 2700 2700 2700 2700 2100 2700	600 600 0 0 0 0 0 0 0 0 0 0 0 0 0 0 0 0	Flywire Timber Louvre Flywire Timber Louvre Flywire Timber Louvre
41-2 41-3 41-4 41-5 41-6 42-1 42-2 42-3 42-4 42-5 42-6 42-6 43-1 43-2 43-2 43-3 43-4 43-5 43-6 44-1	Awning Awning Sliding Sliding Sliding Sliding Sliding Sliding Sliding Sliding Sliding Awning Sliding Sliding Sliding Sliding Sliding Sliding	1100 1090 3900 2400 2400 2400 2400 2400 2400 3900 1100 1090 2000 1990 2000 1990 4300 2400 1200 2400 2400	2100 2100 2700 2700 2700 2700 2700 2700 2700 2700 2100 2100 2100 2100 2100 2100 2100 2100 2700	600 600 0 0 0 0 0 0 0 0 0 0 0 0 0 0 0 0	Flywire Timber Louvre Flywire Timber Louvre Flywire Timber Louvre
41-2 41-3 41-4 41-5 41-6 42-1 42-2 42-3 42-4 42-5 42-6 43-1 43-2 43-3 43-4 43-5 43-6 44-1 44-2	Awning Awning Sliding Sliding Sliding Sliding Sliding Sliding Sliding Sliding Sliding Awning Awning Awning Awning Awning Awning Awning Awning Awning Sliding Sliding Sliding Sliding Sliding Awning Awning Awning Awning Sliding Sliding Sliding Sliding Awning	1100 1090 3900 2400 2400 2400 2400 2400 2400 3900 1100 1090 2000 1990 2000 1990 2400 1200 2400 2400 2400 2400 2400 240	2100 2100 2700 2700 2700 2700 2700 2700 2700 2700 2100 2100 2100 2100 2100 2100 2100 2100 2700 2700 2700 2700 2700 2700 2700 2700 2100 2700	600 600 0 0 0 0 0 0 0 0 0 0 0 0	Flywire Timber Louvre Flywire Timber Louvre Flywire Timber Louvre
41-2 41-3 41-4 41-5 41-6 42-1 42-2 42-3 42-4 42-5 42-6 43-1 43-1 43-2 43-3 43-4 43-5 43-6 44-1 44-2 44-3	Awning Awning Sliding Sliding Sliding Sliding Sliding Sliding Sliding Sliding Sliding Awning Awning Awning Awning Awning Awning Awning Awning Awning Sliding	1100 1090 3900 2400 2400 2400 2400 2400 2400 3900 1100 1090 2000 1990 2000 1990 2000 1990 2400 2400 2400 2400 2400 2400 2400 2	2100 2100 2700 2700 2700 2700 2700 2700 2700 2700 2100 2100 2100 2100 2100 2100 2100 2100 2700	600 600 0 0 0 0 0 0 0 0 0 0 0 0	Flywire Timber Louvre Flywire Timber Louvre Flywire Timber Louvre
41-2 41-3 41-4 41-5 41-6 42-1 42-2 42-3 42-4 42-5 42-6 42-6 43-1 43-1 43-2 43-3 43-4 43-5 43-6 44-1 44-2 44-3 44-4	Awning Awning Sliding Sliding Sliding Sliding Sliding Sliding Sliding Sliding Sliding Awning Awning Awning Awning Awning Awning Awning Awning Awning Sliding	1100 1090 3900 2400 2400 2400 2400 2400 2400 3900 1100 1090 2000 1990 2000 1990 2000 1990 2400 1200 2400 2400 2400 2400 2400 240	2100 2100 2700 2700 2700 2700 2700 2700	600 600 0 0 0 0 0 0 0 0 0 0 0 0	Flywire Timber Louvre Flywire Timber Louvre Flywire Timber Louvre
41-2 41-3 41-4 41-5 41-6 42-1 42-2 42-3 42-4 42-5 42-6 42-6 43-1 43-1 43-2 43-3 43-4 43-5 43-6 44-1 44-2 44-3 44-4	Awning Awning Sliding Sliding Sliding Sliding Sliding Sliding Sliding Sliding Sliding Awning Awning Awning Awning Awning Awning Awning Awning Awning Sliding Awning Sliding Awning Sliding Awning Sliding Awning	1100 1090 3900 2400 2400 2400 2400 2400 2400 3900 1100 1090 2000 1990 2000 1990 2000 1990 2400 1200 2400 2400 2400 2400 2400 240	2100 2100 2700 2700 2700 2700 2700 2700	600 600 0 0 0 0 0 0 0 0 0 0 0 0	Flywire Timber Louvre Flywire Timber Louvre Flywire Timber Louvre Flywire Timber Louvre
41-2 41-2 41-3 41-4 41-5 41-6 42-1 42-2 42-3 42-4 42-5 42-6 42-6 43-1 43-1 43-2 43-3 43-4 43-5 43-6 44-1 44-2 44-3 44-5 44-5 44-5	Awning Awning Sliding Sliding Sliding Sliding Sliding Sliding Sliding Sliding Sliding Awning Awning Awning Awning Awning Awning Awning Awning Sliding Awning Sliding Awning Awning Awning Sliding Awning	1100 1090 2400 2400 2400 2400 2400 2400 2400 3900 1100 1090 2000 1990 2000 1990 1100 1090 2400 1200 2400 1200 2400 1200 2400 4300 1100 1200 2400 4300 1100 1200 2400 1200 2400	2100 2100 2700 2700 2700 2700 2700 2700	600 600 0 0 0 0 0 0 0 0 0 0 0 0	Flywire Timber Louvre Flywire Timber Louvre Flywire Timber Louvre Flywire Timber Louvre
41-2 41-3 41-4 41-5 41-6 42-1 42-2 42-3 42-4 42-5 42-6 42-6 43-1 43-1 43-2 43-3 43-4 43-5 43-6 44-1 44-2 44-3 44-4	Awning Awning Sliding Sliding Sliding Sliding Sliding Sliding Sliding Sliding Sliding Awning Awning Awning Awning Awning Awning Awning Awning Awning Sliding Awning Sliding Awning Sliding Awning Sliding Awning	1100 1090 3900 2400 2400 2400 2400 2400 2400 3900 1100 1090 2000 1990 2000 1990 2000 1990 2400 1200 2400 2400 2400 2400 2400 240	2100 2100 2700 2700 2700 2700 2700 2700	600 600 0 0 0 0 0 0 0 0 0 0 0 0	Flywire Timber Louvre

ISSUE No.

WINDOW SCHEDULE

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ABN 41 159 480 056 NOMINATED ARCHITECT: P Morson(8100)

A 2021-03-04	AMENDMENT DA SUBMISSION	DP DOWNPIPE GEX GARBAGE EXHAUST TOH TOP OF HOB	NORTH	PROJECT PROPOSED RESIDENTIAL FLAT BUILDING ADDRESS	PROJECT No. 19043	ACN 159 480 056, ABN 41 159 480 056	
		E ELECTRICAL CUPBOARD MBX MAILBOX TOW TOP OF HOB FHR FIRE HOSE REEL RL RELATIVE LEVEL TTI TACTILE INDICATORS		ADDRESS 44-48 Rodley Avenue, Penrith, NSW, 2750	CLIENT Inglow Investments Two	GROUP ** www.morsongroup.com.au (02) 9380 4946 PO Box 170, Polfts Point, NSW 1335 SCALE: 1 : 200	

