

- Notes:

  1. All demensions and levels shall be verified by Contractor on site prior to commencement of work.

  2. All detailing of drainage to poved areas shall be by others.

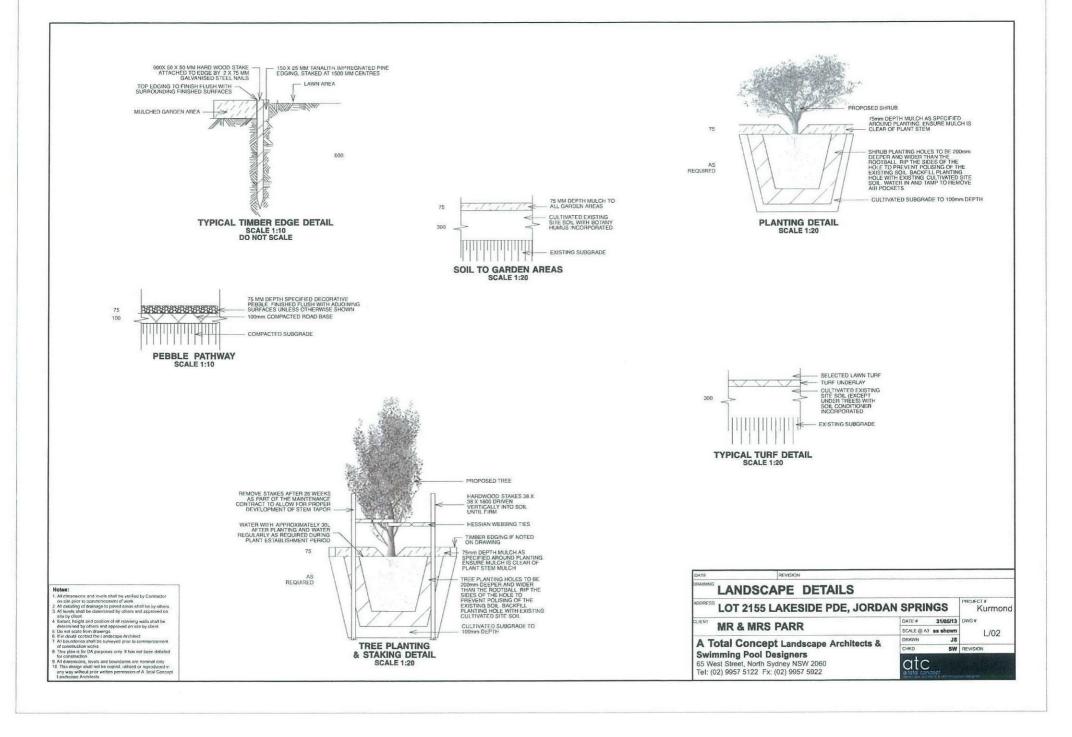
  3. All tevels shall be determined by others and approved on.
- 3. All toycle shall be delarmed by orders are sup-site by client.
  4. Estent, height and position of all retaining walls shall be determined by others and approved on site by client, to 5. Do not scale form dewings.
  5. Do not scale form dewings.
  6. If in dood correct the Landscape Architect.
  7. All boundaries shall be surveyed prior to commonomer of correlatoricke works.

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- This design shall not be copied, utilised or reproduced in any way without prior written permission of A Total Concep

### PLANTING SCHEDULE

ID	Latin Name	Common Name	Quantity	Scheduled Size	Spread	Height
ACS	Acmena smithii	Lillypilly	1	25lt	4000	8000
AB	Anigozanthos flavidus	Kangaroo Paw	8	5lt	800	800
EL	Elaeocarpus reticulatus	Blueberry Ash	1	25lt	5000	12000
LT	Lomandra 'Tanika'	Dwarf Lomandra	13	5lt	500	500
SH	Syzygium 'Cascade'	Lillypilly	4	15lt	1500	2500

DATE	REVISION			
DRAWING	PROPOSED LANDSCAPE P	LAN		
ADDRES	LOT 2155 LAKESIDE PDE, JORD	AN SPRIN	IGS	PROJECT # Kurmond
CLIENT	MR & MRS PARR	DATE#	31/05/13	DWG #
	MR & MRS PARK	SCALE @ A3	1:200	L/01
AT	otal Concept Landscape Architects &	DRAWN	JS	2701
		CHKO	SW	REVISION
65 W	mming Pool Designers est Street, North Sydney NSW 2060 02) 9957 5122 Fx: (02) 9957 5922	atc	cept	



### **OUTLINE LANDSCAPE SPECIFICATION**

Preparation by Builder: Builder shall remove all existing concrete pathways, fences, footings, walls etc. not notated to be retained and complete all necessary excavation work prior to commencement on site by Landscape Contractor (Contractor). Builder shall also install new retaining walls, kerbs, layback kerb, crossover, pathways etc. and make good all existing kerbs, gutters etc. as necessary and to approval of Council. Builder shall ensure that a minimum 450mm of topsoil in garden areas and a minimum 150mm of topsoil in lawn areas exists. Should required depths not exist Builder shall contact Landscape Architect and ask for instructions prior to completion of excavation works. Excavate as necessary, then fill with approved site topsoil to allow for minimum 500mm soil depth in garden areas and 150mm soil depth in lawn areas and to gain required shapes & levels. Ensure all garden and lawn areas drain satisfactorily. All levels & surface drainage shall be determined by others & approved on site by Head Contractor. Note: Approved imported topsoil mix may be utilised if there is insufficient site topsoil available. State in Tender a m3 rate for additional imported topsoil

and the quantities of both site topsoil and imported topsoil allowed for in Tender. initial Preparation: Vorify all dimensions & levels on site prior to commencement. Do not scale from drawings. Locate all underground & above ground services & ensure no damage occurs to them throughout contract. Spray approved weedicide to all proposed lawn & garden areas to manufacturer's directions. Remove existing concrete pathways, footings, walls etc. not notated to be retained & weeds from site. Levels indicated on Plan are nominal only and are derived from Architectural Plans &

Drawings by others. Final structural integrity of all items shall be the sole responsibility of Landscape Contractor.

Tree Protection: Trees to be retained shall be protected during site works and construction by the erection of solid barricades to the specification of Council. Storage of machinery or materials beneath canopy of trees to be retained shall not be permitted. Changes to soil level and cultivation of soil beneath canopy of trees to be retained shall not be permitted unless under direct supervision of Landscape Architect. Existing trees shall be pruned to Landscape Architects onsite instructions. Soll Preparation: Cultivate to depth of 300mm all proposed lawn & garden areas incorporating minimum 100mm depth of organic clay breaker into existing site soil. Do not cultivate beneath existing trees to be retained. In areas where fill is required gain required shapes & levels using a premium grade soil mix. In areas where excavation is required (if in clay) over excavate as required to to allow for installation of 500mm depth of premium grade topsoil mix to garden areas and 300mm depth of gain required shapes a levels using a premium grade solution is required to be allowed in state and in the shape of the sh

Lawn Edging and Stepping Stones:(1) 125 x 25mm approved tanalith impregnated pine edging shall be installed, to lines as indicated on plan and staked with approved stakes at maximum 1500mm centres at ends and changes of direction; stakes shall be nailed to edging with approved galvanised steel nails. Top of edging shall finish flush with surrounding surfaces. Top of stakes shall finish 25mm below top of edging. (II) Contractor shall install approved bricks on edge on a minimum 100mm deep x 90mm wide concrete footing with brick tor set in, to lines nominated on plan as brick edging. Bricks shall be laid with a nominal 10mm wide approved coloured mortar joint. Bricks needing to be cut shall be done so with clean sharp cuts. Top of edging shall finish flush with surrounding finished surfaces. Approved sandstone stepping stones shall be positioned as indicated on plan on a 25mm river sand bed. Approved sandstone stepping stones shall be positioned as indicated on plan on a

Retaining Walls: Positions, detail and heights of retaining walls shall be by others.

Planting: Purchase plants from an approved nursery. Plants to be healthy & true to type & species. Set out plants to positions indicated on plan. Following approval, plant holes shall be dug approximately twice width and to 100mm deeper than plant rootballs that they are to receive. Base and sides of hole shall be further lossened. Fertiliser, followed by 100mm depth of topsoil mix shall then be placed into base of hole and lightly consolidated. Base of hole shall be backfilled with surrounding topsoil and topsoil firmed into place. An approved shallow dish shall be formed to contain water around base of stem. Base of stem of plant shall finish flush with finished soil level. Once installed plant shall be thoroughly watered and maintained for the duration of the Contract.

Staking: All trees shall be staked using 2 x 38mm x 38mm x 2000mm long hardwood stakes per plant and with hessian webbing ties installed to Landscape Architect's on site instructions.

Mulching: Install 75mm depth of 25mm diameter hardwood mulch to all garden areas, coving mulch down around all plant stems & to finish flush with adjacent surfaces.

Turfing: Prepare for, level & lay cultivated Palmetto Buffulo turves to all areas nominated on plan as being lawn. Roll, water, fertillise, mow & maintain lawns as necessary until completion of maintenance period. At same time make good all existing lawn areas using same lawn type. Lawns in shade shall be over sown with an approved seed mix. Allow to retrim and return councils nature strip as required.

Fencing: Retain all existing fences unless advised otherwise by builder. Install timber paling fences to heights indicated on Plan.

Paving: Areas to be paved shall be excavated or filled to allow for installation of bedding materials. Levels and falls shall be as per Plan. Surface drainage on paving shall be towards grated drains with all drains connected to stormwater system and installed by Builder.

Irrigation: Contractor shall supply and install an approved fully automatic, vandal resistant, computerised irrigation system to all garden and lawn areas, excluding council nature strip. Entire system shall be to approval of Water Board and shall utilise pop-up sprinklers and electronic controllers. Contractor shall be responsible to ensure that system is able to satisfactorily operate on available water pressure. Power supply for use by irrigation system shall be provided to an approved location near southwest corner of residence by others and shall consist of an approved weatherproof. G.P.O. The irrigation system controller shall be housed in an approved waterproof cabinet mounted to external wall of residence. Clotheslines: Contractor shall allow for all necessary labour and materials and shall install clotheslines to positions as indicated on plan to manufacturer's instructions to approval of Landscape Architect. Clothesline type shall be equal to 'Hills

Completion: Prior to practical completion remove from site all unwanted debris occurring from work. Satisfy Council that all landscaping work has been undertaken in strict accordance with Councils landscape codes & guidelines.

Maintenance Period: A twelve month maintenance period shall be undertaken by owner or owners representative as set out herein. Owner shall have care and maintenance of all work specified under this Contract and shall rectify any defective work for a period of 52 weeks following Practical Completion of Landscape Works. This period shall be herein known as the Maintenance Period. Work shall also include for the care and maintenance of all existing vegetation to be retained and proposed vegetation. Site shall be attended at least weekly and as otherwise required. The following works shall be undertaken during the Maintenance Period.

(a) Recurrent works Undertake recurrent works throughout the Maintenance Period. These works shall include but are not limited to watering, weeding, fertilising, pest and disease control, returfing, staking and tying, replanting, cultivation, pruning, aerating, renovating, top dressing and the like.

(b) Watering Regularly water all plants and lawn areas to maintain optimal growing conditions. Contractor shall adjust the water quantity utilised with regard to climatic conditions prevalent at the time.

(c) Replacements Immediately replace plants which die or fail to thrive (at discretion of Landscape Architect) with plants of same specifies or variety and of same size and quality unless otherwise specified. Plant replacement shall be at Contractors expense, unless replacement is required due to vandalism or theft, which shall be determined by Landscape Architect. Required replacement of plants due to vandalism or theft shall be undertaken by Contractor and shall be paid for by Client at an agreed predetermined rate.

(d) Mulched surfaces Maintain mulched surfaces in clean, tidy, weed-free condition and shall reinstate mulch as necessary to maintain specified depths.

(e) Stakes & ties Adjust and/or replace stakes and ties as required. Remove stakes and ties at end of Maintenance Period if directed by Landscape Architect. (f) Lawn areas Lawn areas shall be mown at regular intervals to ensure non heading of lawn with a fine-cutting mulching mower and clippings left on lawn to mulch and self-fertilise lawn areas. Primary cut after laying of lawn by others shall be determined on site taking into consideration season, watering and growth rate of lawn. Following the primary cut all lawns shall be regularly mown as required to ensure a healthy lawn and a neat appearance. Care shall always be taken to ensure that no clippings are left on surrounding roads or garden areas after mowing. Replace lawn areas that fail to thrive at discretion of Landscape Architect. All new and made good lawn areas shall be barricaded off from pedestrian traffic by use of star pickets and brightly coloured plastic safety mesh until establishment of lawn. Barricades shall be removed upon establishment of lawn area.

(g) Weeding Remove by hand, or by carefully supervised use of weedicide, any weed growth that may occur throughout Maintenance Period. This work shall be executed at weekly intervals so that all lawn and garden areas may be observed in a weed-free condition.

- (h) Pruning Prune new and existing plants (excluding existing trees) as necessary to maintain dense foliage conditions. Any rogue branches, or branches overhanging or obstructing pathways, roads, doorways, etc., shall be removed by approved horticultural methods
- (i) Spraying Spraying for insect, fungal and disease attack shall be undertaken as required and in accordance with spray manufacturers recommendations at intervals taking into account the season of year during which landscape works are to be

(f) Tree Care Should any existing trees be damaged during construction works immediately engage an experienced arboriculturist and then undertake any rectification work recommended by arboriculturist.

### Notes:

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- on site prior to commencement of work

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- 3 Air seves since to determine the state by claim 1
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  5 If in doubt contact the Lundscape Architect.

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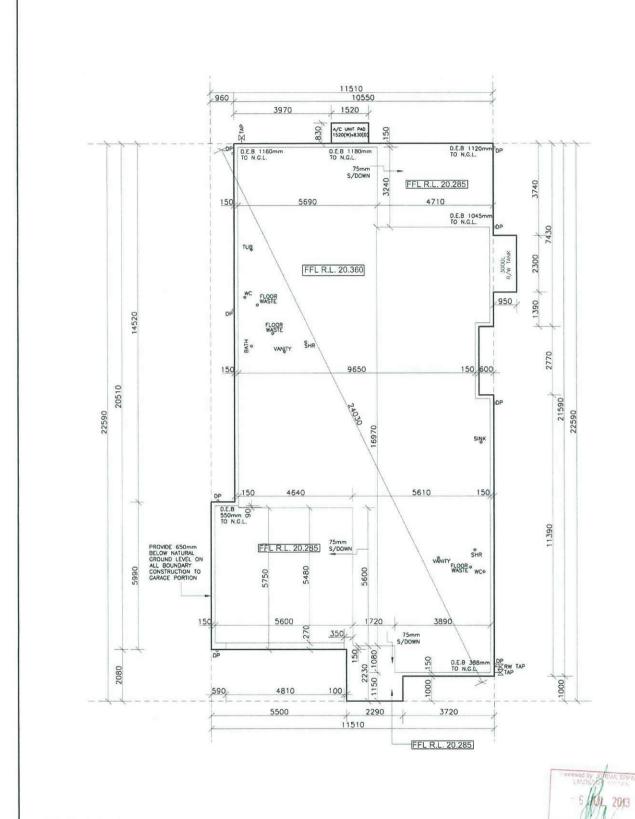
- of censtruction works.

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- for construction

  9. At dimensions, levels and boundarios are nonyriel only

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  Landscape Architects.

LANDSCAPE SPECIFICATION **LOT 2155 LAKESIDE PDE. JORDAN SPRINGS** Kurmond DATE# 31/05/13 MR & MRS PARR SCALE (2) A3 L/03 A Total Concept Landscape Architects & SW REVISION **Swimming Pool Designers** 65 West Street, North Sydney NSW 2060 atc Tel: (02) 9957 5122 Fx: (02) 9957 5922



SLAB PLAN

kurmondhomes AL, Richt's RESERVED. The claim is to googne. Grand in the country of the claim in the MR & MRS PARR 13010 **NEWPORT 24.7** BL No. 205 457C ABN 481 288 211 98 DATE: 31.05.13 TRADITIONAL Kurmond Homes PTY LTD 10 Sovereign Place, South Windsor 2756 T: 1300 764 761 F: (02) 45714015 CHECKED: SHEET: authorised by KURMOND HOMES PTY LTD LOT 2155 in DP 1168992, Ε Diamond Inclusion LAKESIDE PARADE C COPYRIGHT 1:100 DA STAGE JORDAN SPRINGS NSW 2747 L/H

### Schedule of BASIX commitments

The commitments set out below regulate how the proposed development is to be carried out. It is a condition of any development consent granted, or complying development certificate issued, for the proposed development, that BASIX commitments be complied with.

Water Commitments	Show on DA plans	Show on CC/CDC plane & spece	Certifier
Fixtures			
The applicant must install showerheads with a minimum rating of 3 star (> 7.5 but <= 9 L/min) in all showers in the development.		1	1
The applicant must install a tolet flushing system with a minimum rating of 3 star in each tolet in the development.		1	1
The applicant must install taps with a minimum rating of 3-star in the kitchen in the development.		1	000
The applicant must install basin taps with a minimum rating of 3 star in each bathroom in the development.		1	
Alternative water		And a	
Rainwater tank			
The applicant must install a namester tank of at least 3000 libes on the site. This namester tank must meet, and be installed in accordance with, the requirements of all applicable regulatory authorities.	1	1	1
The applicant must configure the reinwater tank to collect rain runoff from at least 259.65 square metres of the roof area of the development (excluding the area of the roof which drains to any stormwater tank or private dam)		/	1
The applicant must connect the rainwater tank to:			1000
all tolists in the development		1	1
<ul> <li>the cold water top that supplies each clothes washer in the development.</li> </ul>		1	1
<ul> <li>at least one outdoor top in the development (Note: NSW Health does not recommend that rainwater be used for human consumption in areas with potable water supply.)</li> </ul>		1	1

Thermal Comfort Commitments	Show on DA plans	Show on CC/CDC plans & specs	Certifier check
Floor, walls and ceiling/roof	202		
The applicant must construct the floor(s), walls, and ceiling/roof of the dwelling in accordance with the specifications listed in the table below:	1	1	1

Construction	Additional insulation required (R-Value)	Other specifications
floor - concrete slab on ground	nil	The second secon
external wall - brick verseer	1.66 (or 2.20 including construction)	
internal wall shared with garage - plasterboard	ril	
ceiling and roof - flat ceiling / pilished roof	ceiling: 3 (up), roof: foil/sarking	unventilated; dark (solar absorptance > 0.70)

Note: Insulation specified in this Certificate must be installed in accordance with Part 3, 12.1, 1 of the Building Code of Australia.

Thermal Comfort Commitments	Show on DA plans	Show on CC/CDC plans & specs	Certifier
Windows, glazed doors and skylights		the same	
The applicant must install the windows, gloced doors and sheding devices described in the table below, in accordance with the specifications listed in the table. Relevant overshadowing specifications must be satisfied for each window and glazed door.	1	1	1
The dwelling may have 1 skylight (<0.7 square metres) and up to 2 windows/glazed doors (<0.7 square metres) which are not risted in the table.	1	1	1
The following requirements must also be satisfied in relation to each window and glazed door:	1	1	1
<ul> <li>Except where the glass is "single-clear" or "single-toned", each window and glazed door must have a U-value no greater than that listed and a Solar Heat Gain Coefficient (SHO), "&gt;– 10% of that stated. Total system U-values and SHOC must be calculated in accordance with National Resistantian Ruling Coursel (NFRC) conditions.</li> </ul>			1
<ul> <li>The leading edge of each eave, pergola, verandan, balcony or assing most be no more than 500 millimeters above the head of the window or glazed door, except that a projection greater than 500 mm and up to 1500 mm above the head must be twice the value in the table.</li> </ul>	1	/	1
<ul> <li>Pergolas with polycarbonate roof or similar translucent material must have a shading coefficient of less than 0.35.</li> </ul>		1	1
<ul> <li>Unless they have adjustable shading, pergolas must have fixed batters parallel to the window or glazed door above which they are shaded, unless the pergola also shades a perpendicular window. The spacing between batters must not be more than 50 mm.</li> </ul>		1	1

Windowlglazed door no.	Orientation	Maximum area (square metres)	Туре	Shading	Overshadowing
W1,W2	s	3.06	standard aluminium, single clear (or U-value 7 63, SHGC 0 75)	eave/verandah/pergola/balcony 451-600 mm	not overshadowed
W3,W4,W5	E	4.11	standard aluminium, single clear (cr. U-value 7.63, SHGC 0.75)	eavelverandah/pergola/balcony 451-600 mm	not overshadowed
we	E	39	standard aluminium, single clear (or U-value 7.63, SHGC 0.75)	eave verandah/pergola/balcony 901-1,200 mm	not overshadowed
W7	N	7.7	standard aluminium, single clear (or U-value 7:63, SHGC 0:75)	eave/verandah/pergala/balcony >2,000 mm	not overshadowed
W8	E	5.76	standard aluminium, single clear (or U-value 7.63, SHGC 0.75)	eave/verandsh/pergola/balcony >2,000 mm	not overshadowed
W9	N	2.27	standard aluminium, single clear (or U-value 7.63, SHGC 0.75)	eavelverandah/pergola/balcony 451-600 mm	not overshadowed

W	Indowiglaced door no.	Orientation	Maximum area (square metres)	Турн	Shading	Overshadowing
W	10,W11,W12,W13	W	5.62	standard aluminium, single clear (or U-value 7.63, SHGC 0.75)	eave/verendah/pergola/balcony 451-800 mm	not overshadowed

Energy Commitments	Show on DA plans	Show on CC/CDC plans & specs	Certifier
Hot water			
The applicant must install the following hot water system in the development, or a system with a higher energy rating, gas instantaneous with a performance of 5 stars.	1	1	1
Cooling system			-
The applicant must install the following cooling system, or a system with a higher energy ruting, in at least 1 living area; 3-phase airconditioning; Energy rating: EER < 2.5		1	1
The applicant must install the following cooling system, or a system with a higher energy rating, in at least 1 bedinors: 3-phase airconditioning, Energy rating. EER < 2.5		1	1
The cooling system must provide for day/night zoning between living areas and bedrooms.		1	1
Heating system			
The applicant must install the following healing system, or a system with a higher energy rating, in at least 1 living area: 3 phase airconditioning, Energy rating: EER < 2.5		1	1
The applicant must install the following heating system, or a system with a higher energy rating, in at least 1 bedroom: 3-phase airconditioning, Energy rating, EER < 2.5		1	1
The heating system must provide for daylright zoning between living areas and bedrooms.		1	1
Ventilation			chico
The applicant must install the following exhaust systems in the development:		T	T
At least 1 Bathroom: individual fan, not ducted, Operation control: manual switch on/off		1	1
Kitchen: individual fair, ducted to facade or roof. Operation control manual switch enroll			
		1	1
Laundry, individual fan, ducted to façade or roof; Operation control: manual switch en/off		1	1
Natural lighting		War.	34
The applicant must install a window and/or skylight in the kitchen of the dwelling for natural lighting.	1	1	1
The applicant must install a window and/or skylight in 3-bathroom(s)/tollet(s) in the development for natural lighting.	1	1	1
Other	- 1/1	1/4	-
	- Service -		-

In these commitments, "applicant" means the person carrying out the development.

The applicant must install a gas cooktop & electric oven in the kitchen of the dwelling. The applicant must install a fixed outdoor clothes drying line as part of the development.

To commitments, departure means an person carrying cut the selections of the plans accompanying the development application for the proposed development (if a development application is to be lodged for the proposed development).

Commitments identified with a v in the "Show on CC/CDC plans and specs" column must be shown in the plans and specifications accompanying the application for a construction certificate (complying development certificate for the proposed development.

Commitments identified with a  $\sqrt{}$  in the "Certifier check" column must be certified by a certifying authority as having been fulfilled, before a final occupation certificate (either interim or final) for the development may be issued.

HTS RESERV	/ED	HOUSE NAME: CLIENT	***		JOB No:
REV	DATE	AMENDMENTS	BY	SHEET	DESCRIPTION
Α	05.02.13	PRELIMINARY DRAWINGS	DS	1	COVER SHEET
В	11.03.13	AMENDED PLANS AS PER CLIENT'S EMAIL	ME	2	SITE PLAN
С	18.02.13	AMENDED PLANS AND ELEVATIONS.	ME	3	GROUND FLOOR PLAN
D	24.05.13	PROVIDED WET AREA DETAILS FOR COLOURS	BAC	4	ROOF PLAN
E	31.05.13	Plans ready for developer and DA lodgement	BAC	5	ELEVATIONS
				6	ELEVATIONS
				7	SECTION
				8	SLAB PLAN
			20	9	DOOR SCHEDULE
				10	WET AREAS
				11	WET AREAS
					50 C L 00000000 100000000
				2.1	SITE ANALYSIS
					SEDIMENT & EROSION CTRL. PLAN
				2.2	CONS. WASTE MANAGEMENT &
				2.3	STORMWATER CONCEPT PLAN
	ř	ß	4	2.4	SITE COVERAGE PLAN
				2.5	CUT & FILL PLAN
				2.6	NEIGHBOURS NOTIFICATION

CLIENT'S SIGNATURE:

BL No. 205 457C ABN 481 288 211 98 Kurmond Homes PTY LTD 10 Sovereign Place, South Windsor 2756 T: 1300 764 761 F: (02) 45714015

I accept and understand the plans and documents that have

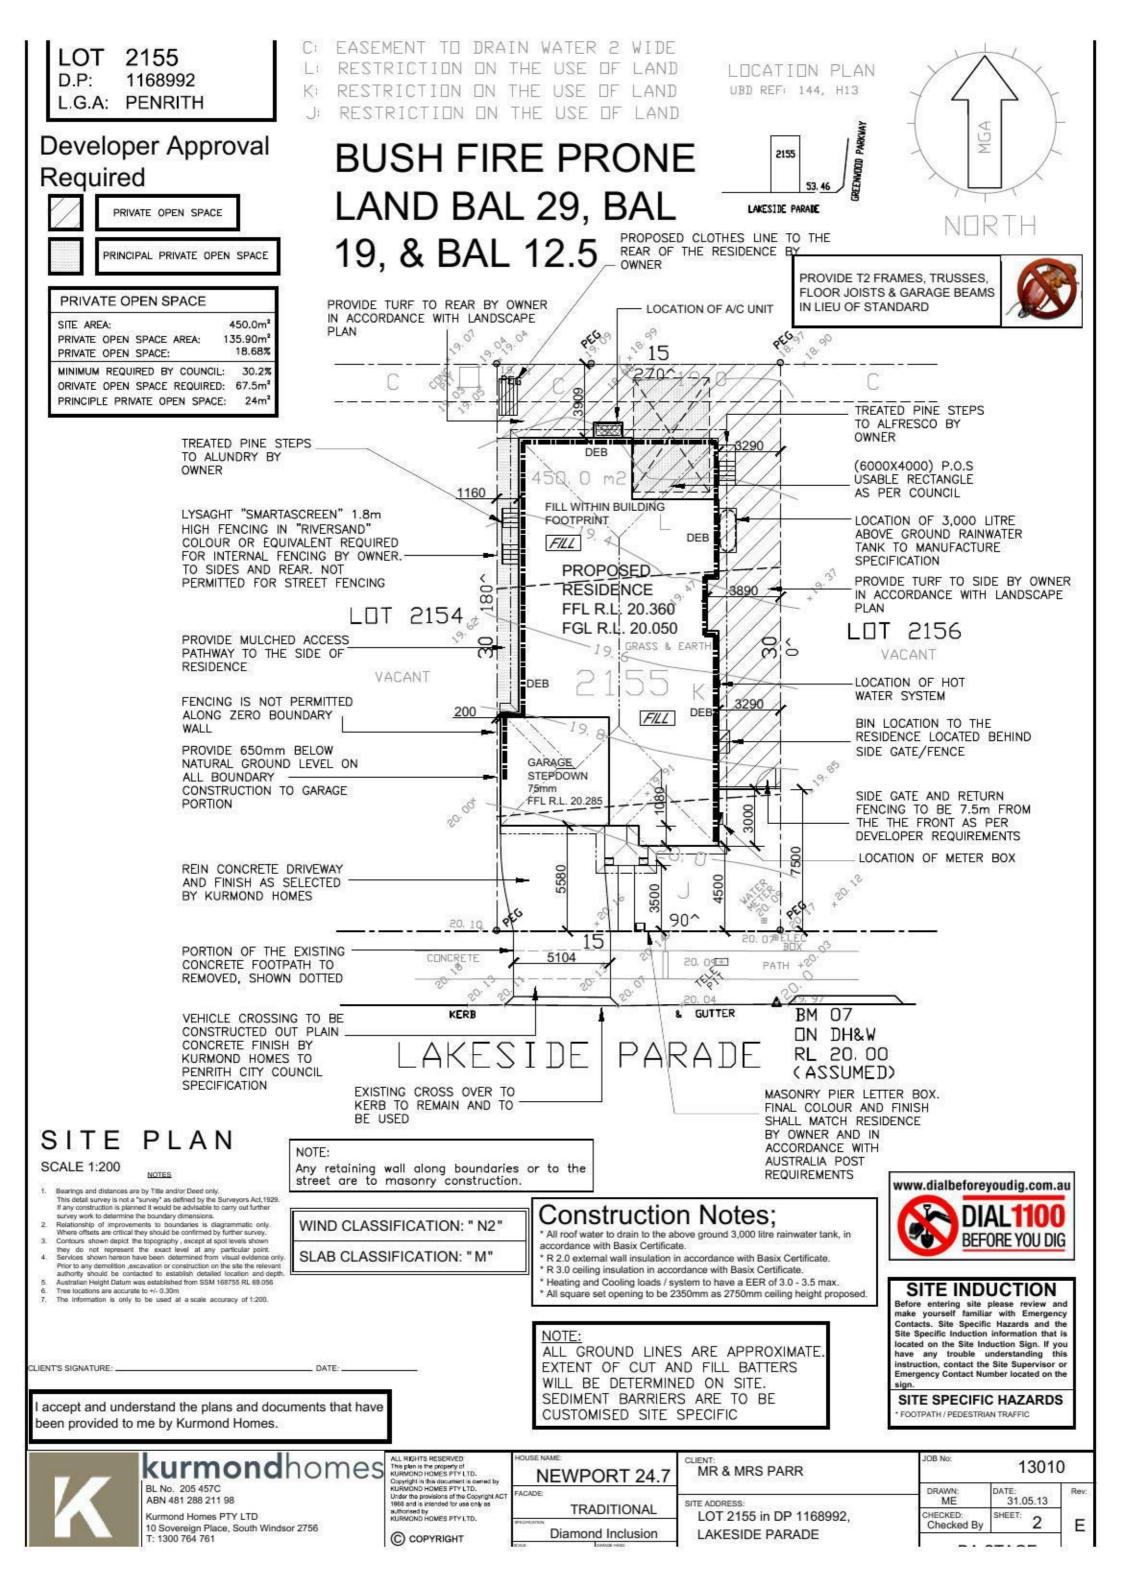
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DMENSIONS TO BE READ IN PREFERENCE TO SCALING	NTS	L/H

NEWPORT 24.7

BY SHEE	DESCRIPTIO	IN.		
LIENT: MR & MRS PARR	JOB No:	1301	13010	
65 1923	DRAWN:	DATE:	Rev:	
ITE ADDRESS:	ME	31.05.13		
LOT 2155 in DP 1168992,	CHECKED:	SHEET: 1	F	
LAKESIDE PARADE	3 1000000		-	
JORDAN SPRINGS NSW 2747	DA	STAGE		

2.7 ELECTRICAL LAYOUT



# Construction Notes; \* All roof water to drain to the above ground 3,000 litre rainwater tank, in

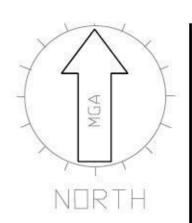
- accordance with Basix Certificate.

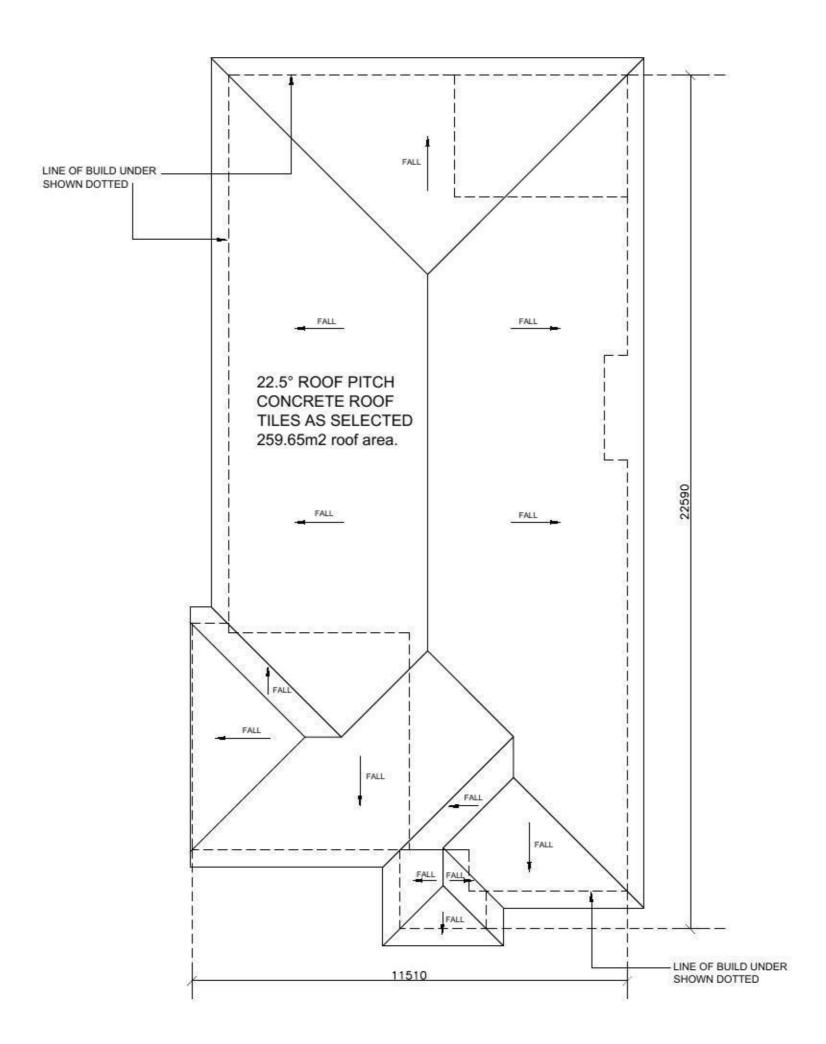
  \* R 2.0 external wall insulation in accordance with Basix Certificate.
- \* R 3.0 ceiling insulation in accordance with Basix Certificate.
- \* Heating and Cooling loads / system to have a EER of 3.0 3.5 max.

  \* All square set opening to be 2350mm as 2750mm ceiling height proposed.









# **ROOF PLAN**

CLIENT'S SIGNATURE: . DATE: \_

I accept and understand the plans and documents that have been provided to me by Kurmond Homes.



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**NEWPORT 24.7** FACADE TRADITIONAL Diamond Inclusion

MR & MRS PARR SITE ADDRESS: LOT 2155 in DP 1168992,

LAKESIDE PARADE

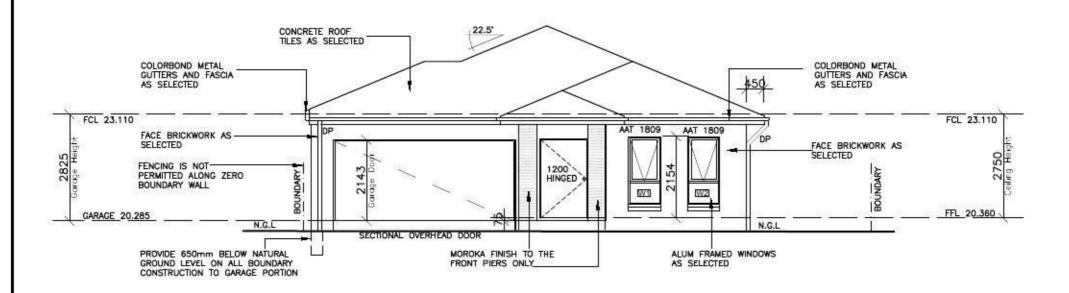
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# Construction Notes;

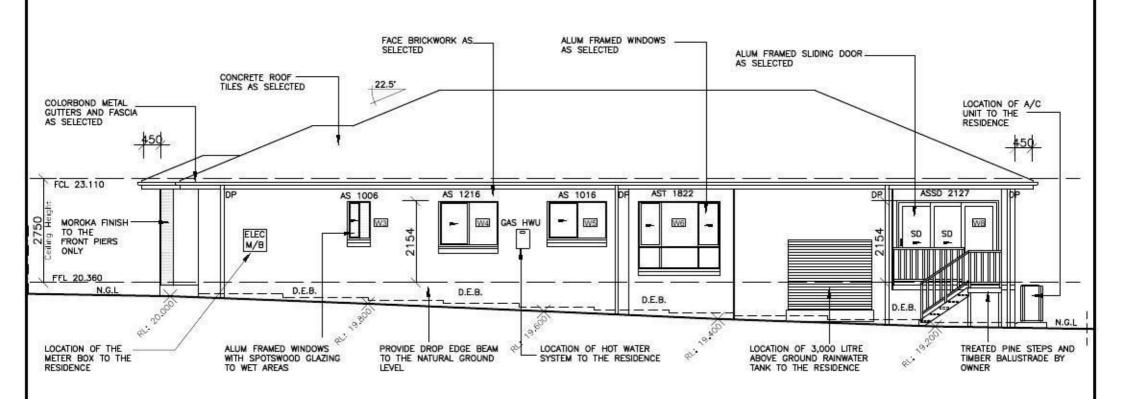
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- \* R 3.0 ceiling insulation in accordance with Basix Certificate.
- Heating and Cooling loads / system to have a EER of 3.0 3.5 max.
   All square set opening to be 2350mm as 2750mm ceiling height proposed.

PROVIDE T2 FRAMES, TRUSSES, FLOOR JOISTS & GARAGE BEAMS IN LIEU OF STANDARD



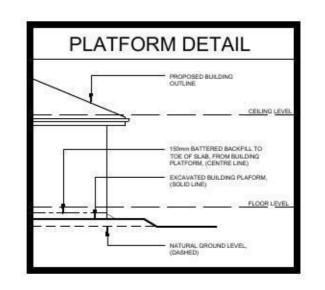






EASTERN ELEVATION Side Elevation Scale 1:100

DATE:



I accept and understand the plans and documents that have been provided to me by Kurmond Homes.



CLIENT'S SIGNATURE:

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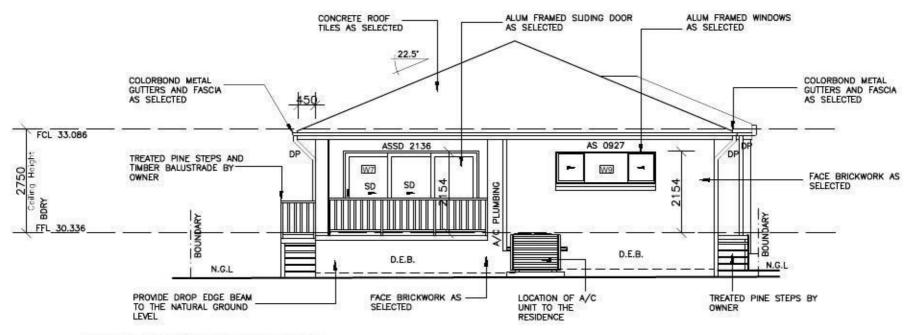
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SITE ADDRESS:	DRAWN: ME	DATE: 31.05.13	Rev
LOT 2155 in DP 1168992, LAKESIDE PARADE	CHECKED: Checked By	SHEET: 5	E

# Construction Notes;

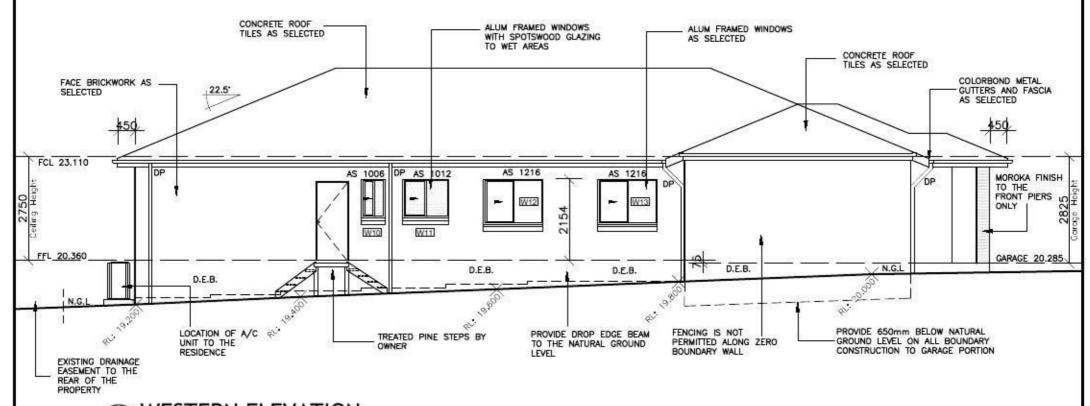
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PROVIDE T2 FRAMES, TRUSSES, FLOOR JOISTS & GARAGE BEAMS IN LIEU OF STANDARD



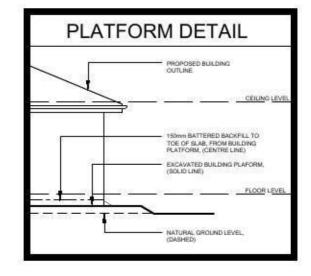






WESTERN ELEVATION Side Elevation Scale 1:100

DATE:



I accept and understand the plans and documents that have been provided to me by Kurmond Homes.



CLIENT'S SIGNATURE:

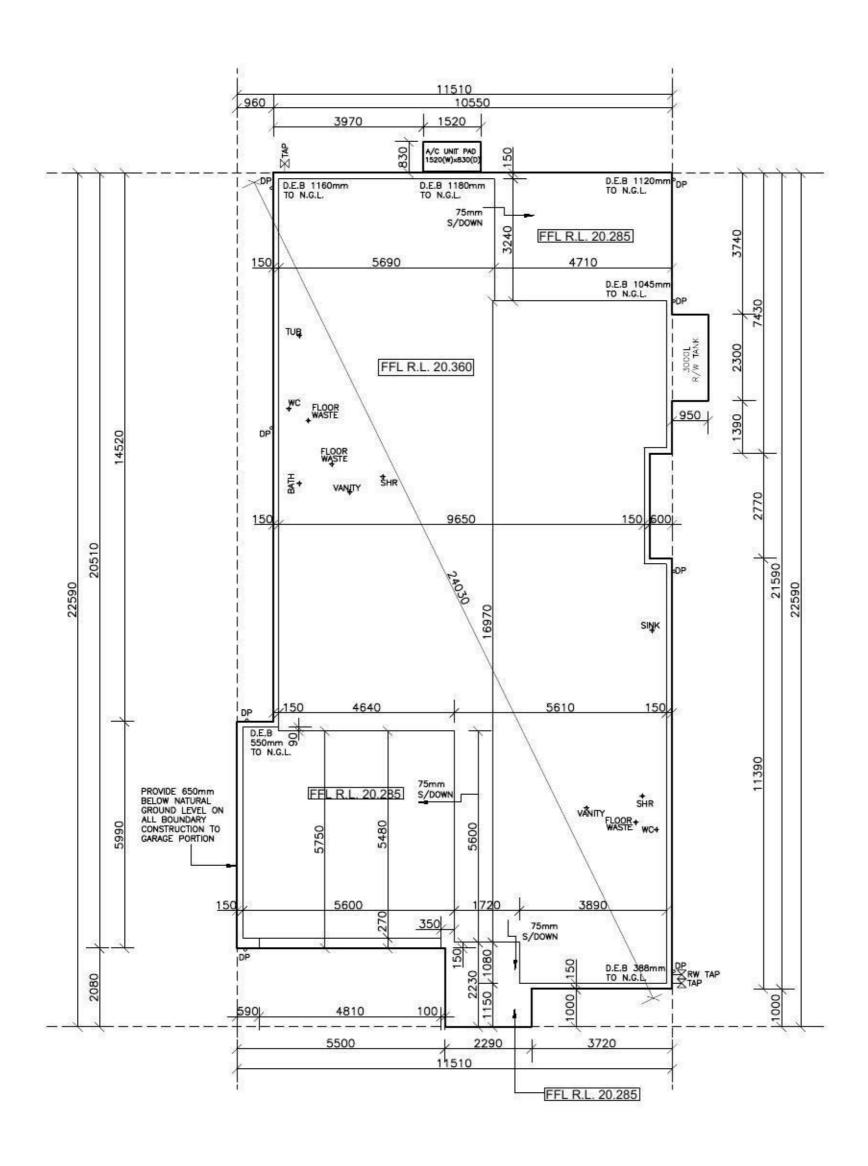
dhomes BL No. 205 457C

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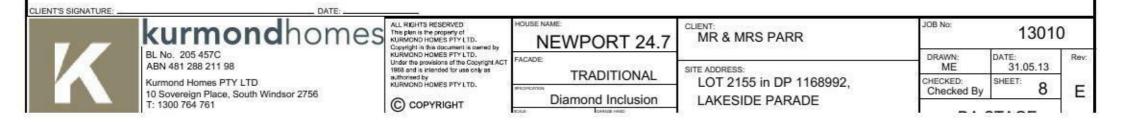
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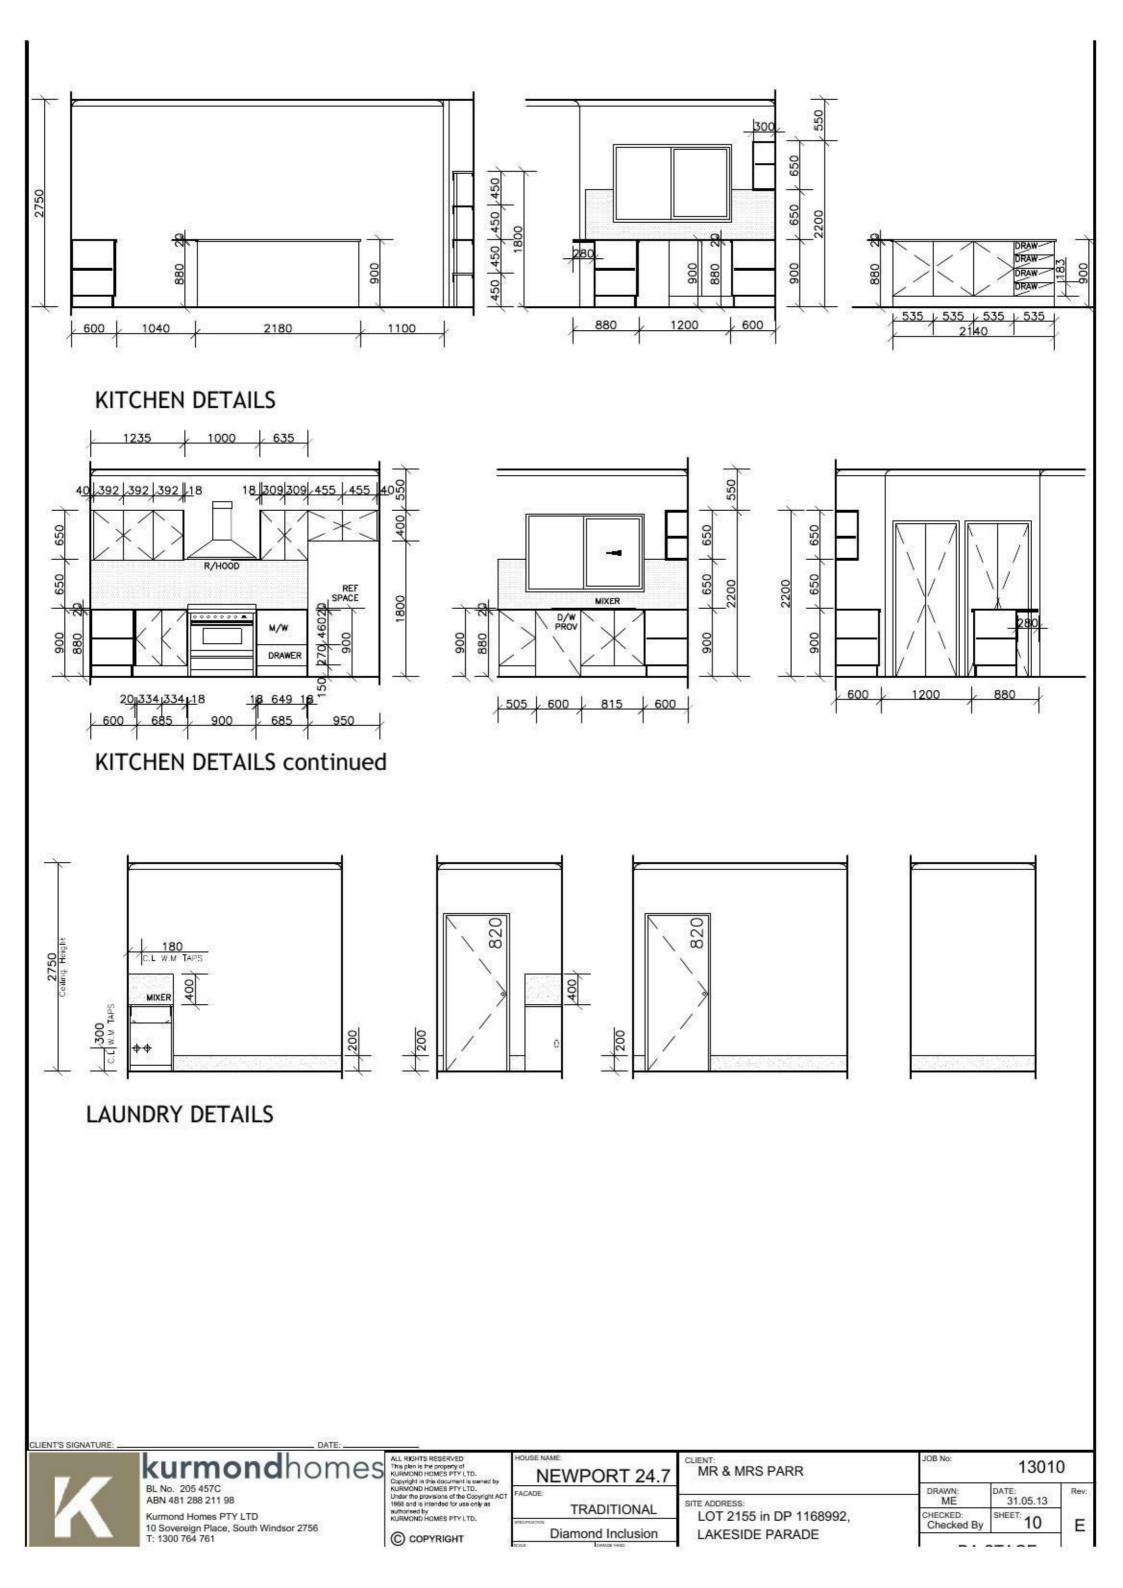
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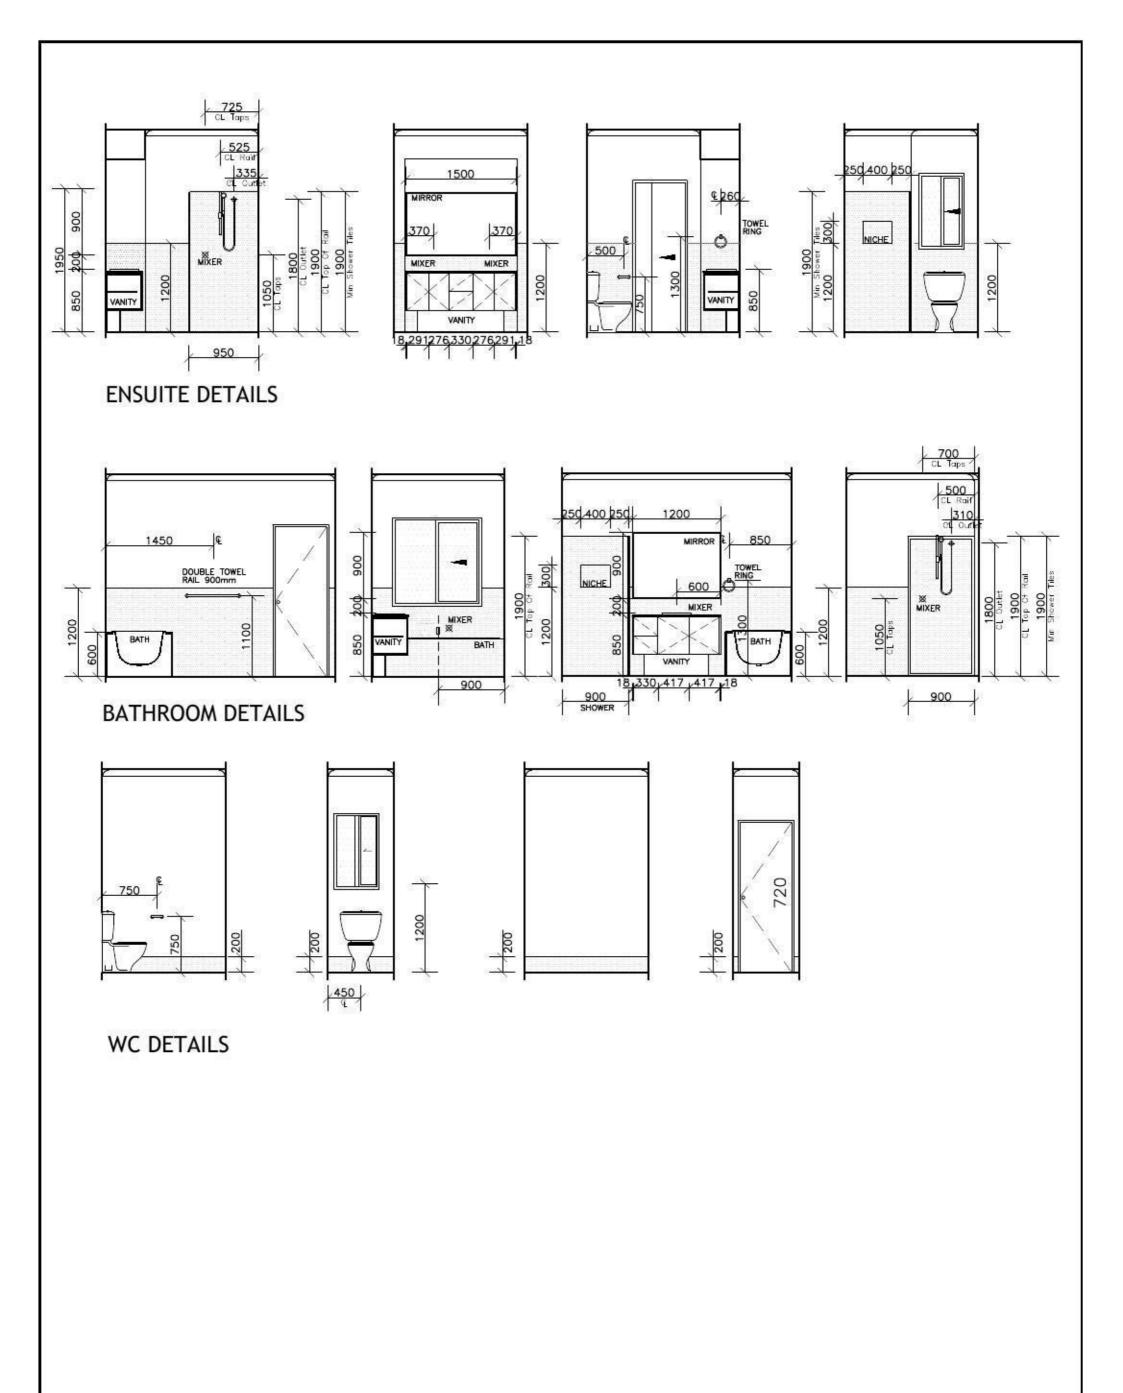
JOB No: 13010 MR & MRS PARR DATE: 31.05.13 DRAWN ME SITE ADDRESS: CHECKED: Checked By LOT 2155 in DP 1168992. SHEET: 6 E LAKESIDE PARADE

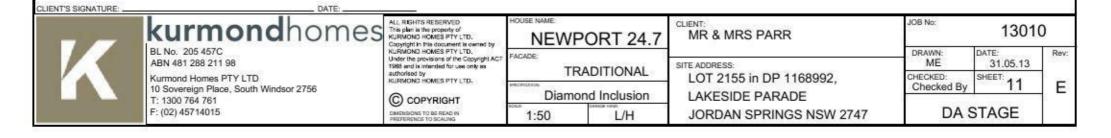


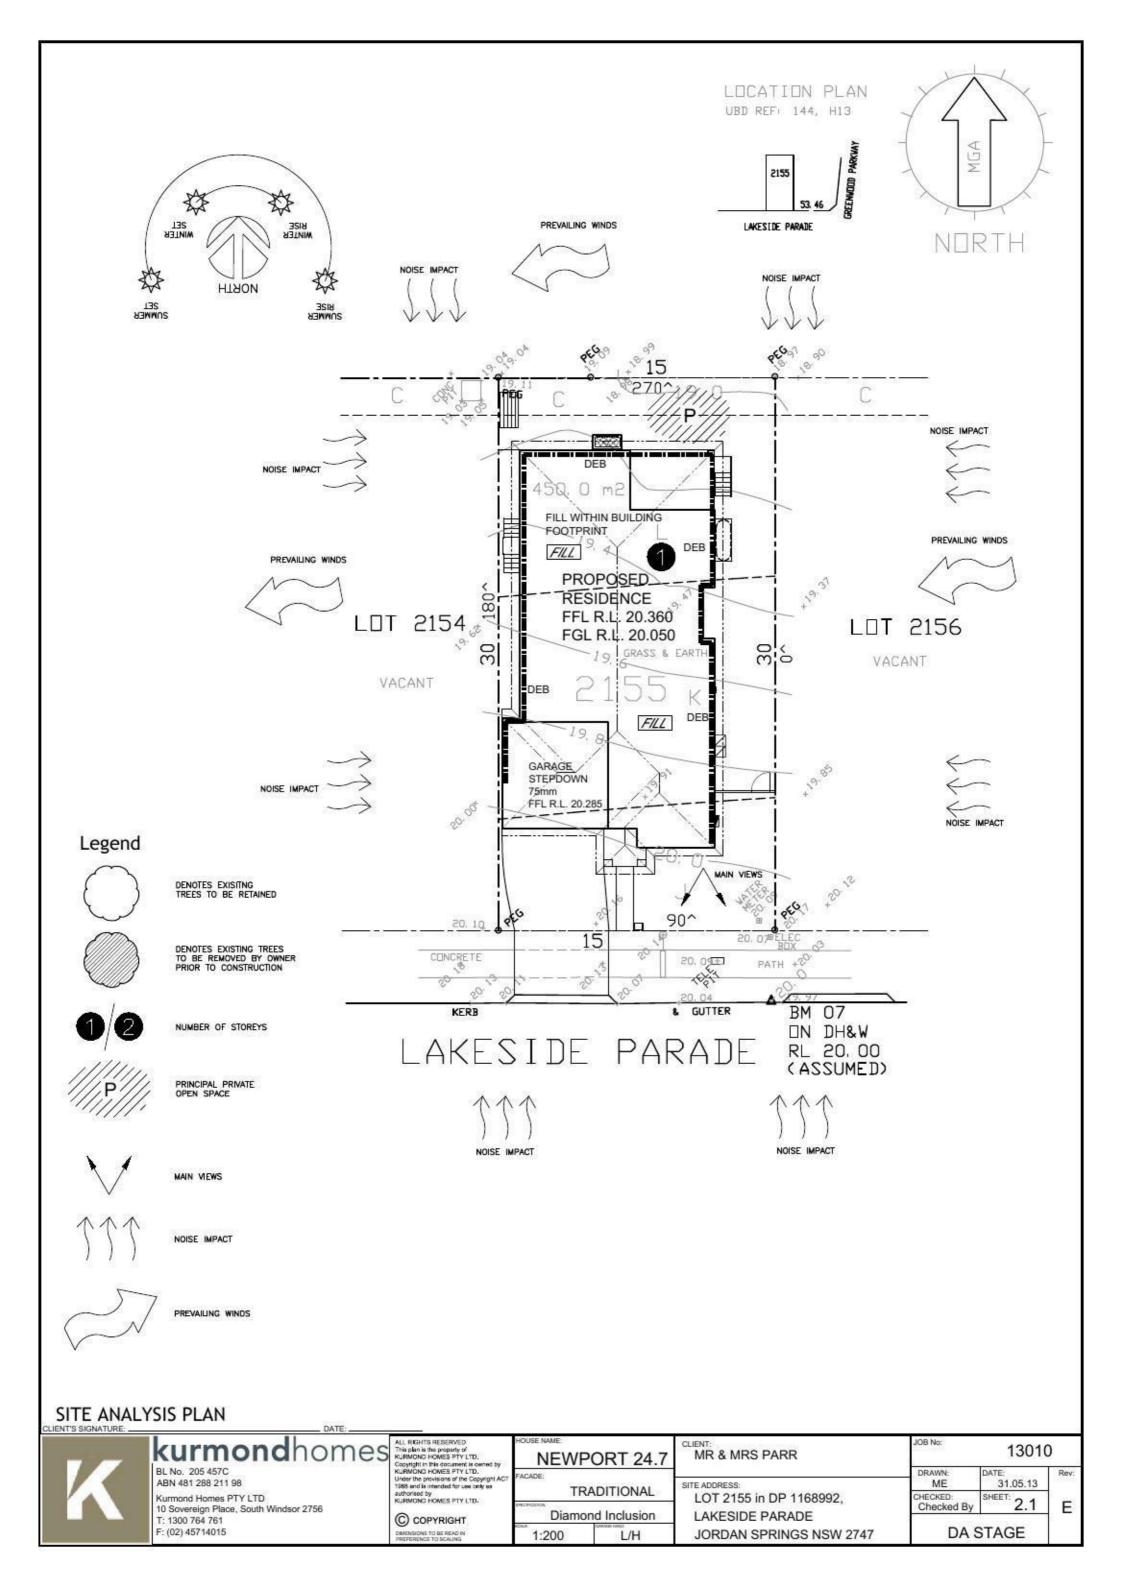
# **SLAB PLAN**

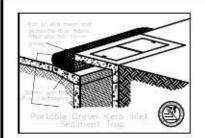


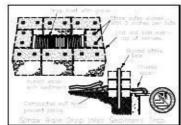


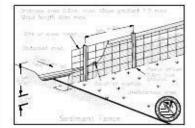


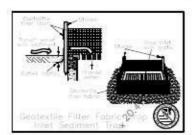


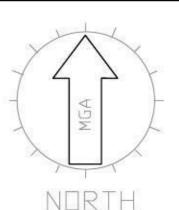


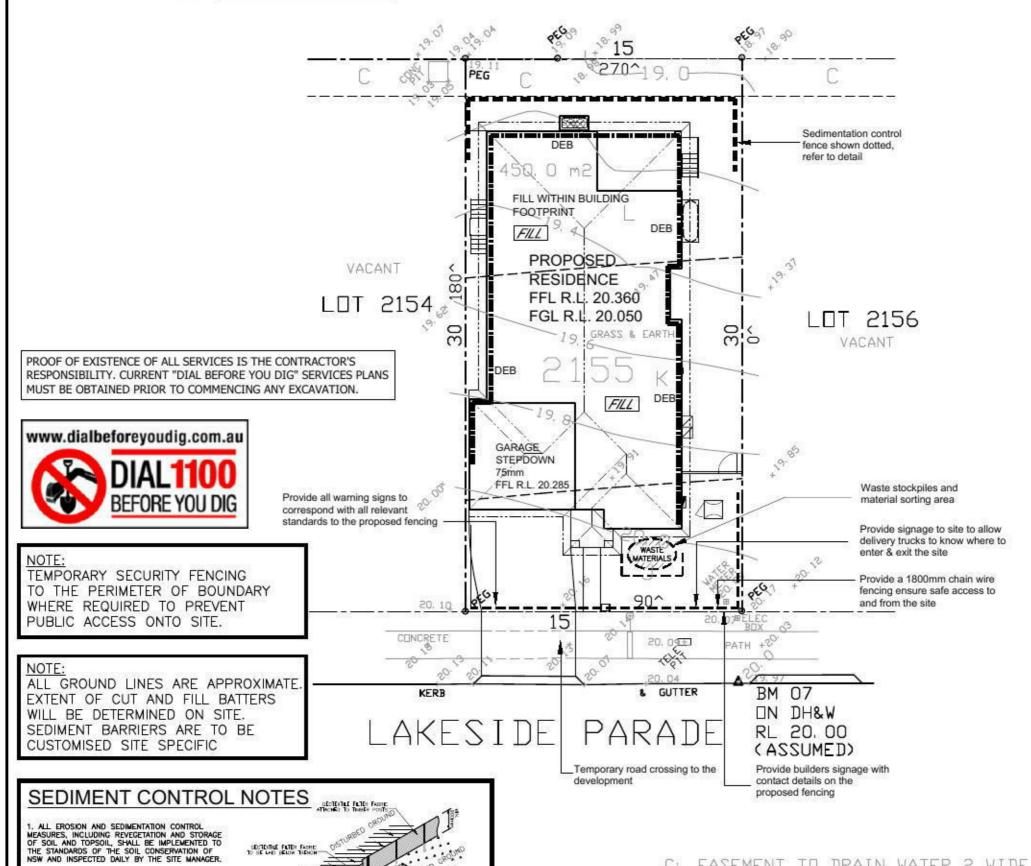












ND STABILIZED AS EARLY AS POSSIBLE DURING DEVELOPMENT. 3. SEDIMENT TRAPS SHALL BE CONSTRUCTED
AROUND ALL INLET PITS, CONSISTING OF 300mm
MDE x 300mm DEEP TRENCH.

CECTOTIVE FUTER FASHED TO BE UND BELOW THENCH

ALL SEDIMENT BASINS AND TRAPS SHALL BE CLEANED WHEN THE STRUCTURES ARE A MAXIMUM OF 60% FULL OF SOIL MATERIALS, INCLUDING THE MAINTENANCE PERIOD.

ALL DRAINAGE WORKS SHALL BE CONSTRUCTED

5. ALL DISTURBED AREAS SHALL BE REVEGITATED AS SOON AS THE RELEVANT WORKS ARE COMPLETED.

6, SOIL AND TOPSOIL STOCKPILES SHALL BE LOCATED AWAY FROM DRAINAGE LINES AND AREA WHERE WATER MAY CONCENTRATE. ALL ROADS AND FOOTPATHS TO BE SWEPT DAILY.

7. FILTER SHALL BE CONSTRUCTED BY STRETCHING A FILTER FABRIC (PROPEX OR APPROVED EQUIVALENT BETWEEN POST AT 3.0m CENTRES. FABRIC SHALL BE BURIED 150mm ALONG ITS LOWER EDGE.

8. DUST PREVENTION MEASURES TO BE MAINTAINED AT ALL TIMES.

C: EASEMENT TO DRAIN WATER 2 WIDE

RESTRICTION ON THE USE OF LAND

K: RESTRICTION ON THE USE OF LAND

J: RESTRICTION ON THE USE OF LAND

## SITE INDUCTION

Before entering site please review and make yourself familiar with Emergency Contacts. Site Specific Hazards and the Site Specific Induction information that is located on the Site Induction Sign. If you have any trouble understanding this instruction, contact the Site Supervisor or Emergency Contact Number located on the sign.

SITE SPECIFIC HAZARDS FOOTPATH / PEDESTRIAN TRAFFIC

CONSTRUCTION MANAGEMENT PLAN **EROSION & SEDIMENT CONTROL PLAN** 



## kurmondhomes BL No. 205 457C

ABN 481 288 211 98 Kurmond Homes PTY LTD 10 Sovereign Place, South Windsor 2756 T: 1300 764 761 F: (02) 45714015

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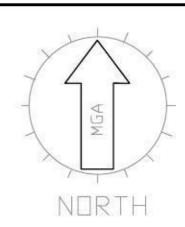
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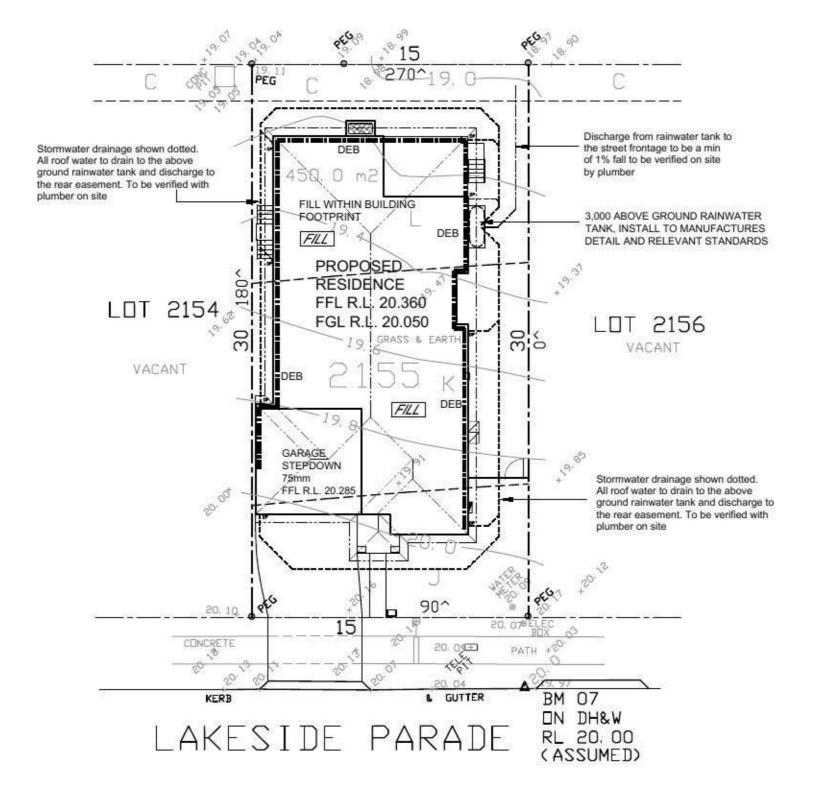
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CLIENT: MR & MRS PARR	300
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LAKESIDE PARADE	1
JORDAN SPRINGS NSW 2747	- 1

JOB No: 13010 DRAWN 31.05.13 CHECKED SHEET: 2.2 Ε DA STAGE





## STORMWATER TO REAR EASEMENT VIA RAINWATER TANK

PROOF OF EXISTENCE OF ALL SERVICES IS THE CONTRACTOR'S RESPONSIBILITY. CURRENT "DIAL BEFORE YOU DIG" SERVICES PLANS MUST BE OBTAINED PRIOR TO COMMENCING ANY EXCAVATION.

- DIAL 1100
  BEFORE YOU DIG
- CONCEPT STORMWATER MANAGEMENT PLAN

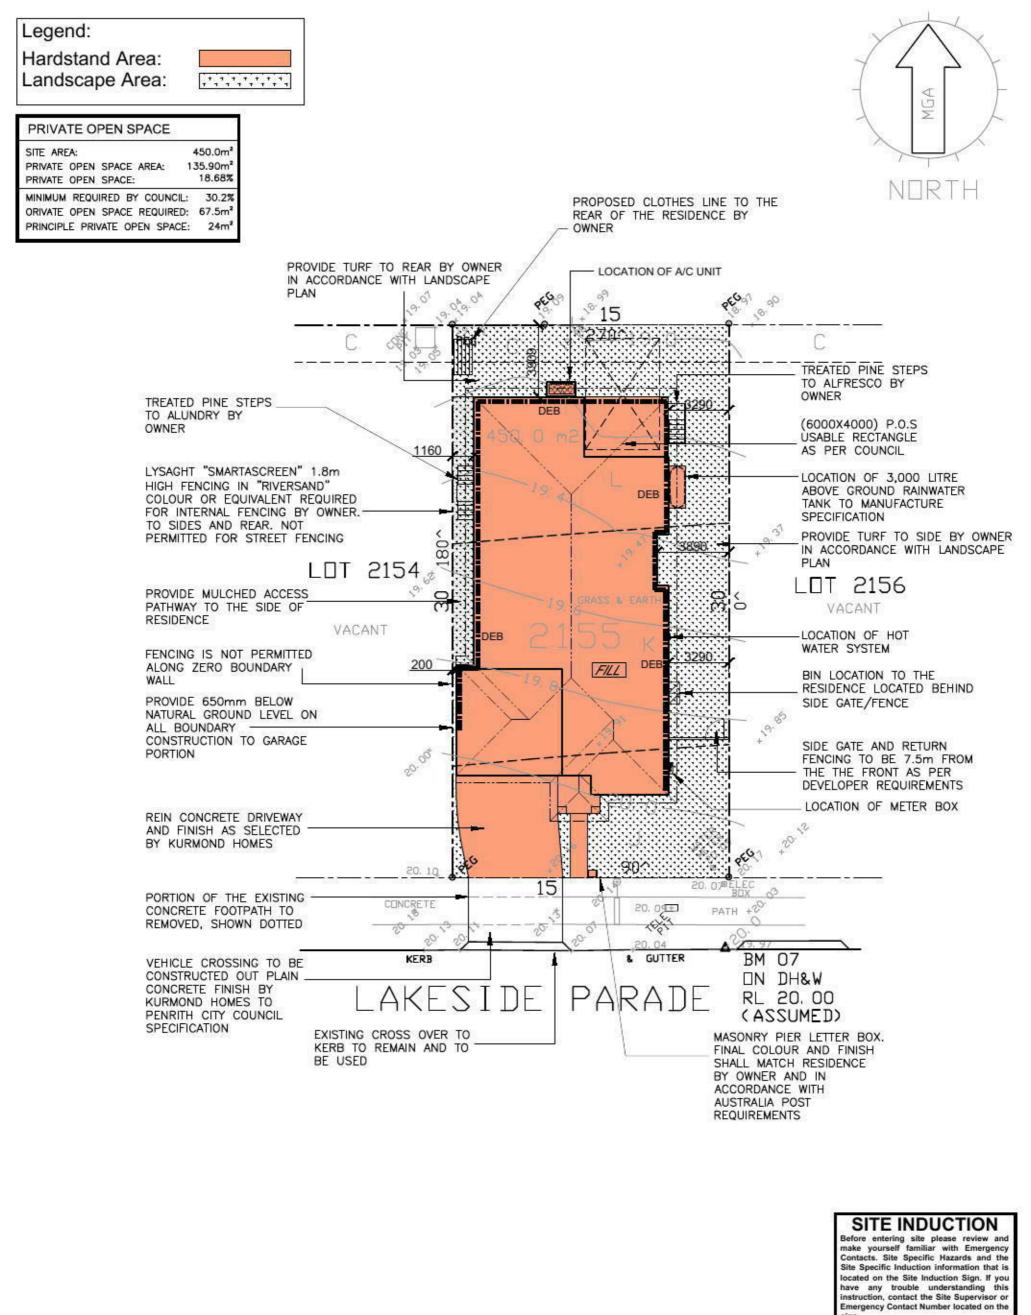
- C: EASEMENT TO DRAIN WATER 2 WIDE
- LE RESTRICTION ON THE USE OF LAND
- K: RESTRICTION ON THE USE OF LAND
- JI RESTRICTION ON THE USE OF LAND

## SITE INDUCTION

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SITE SPECIFIC HAZARDS

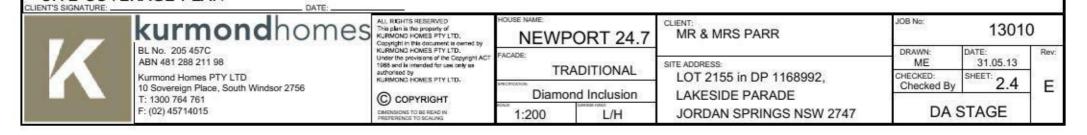
**kurmond**homes ALL RIGHTS RESERVED This plan is the property of KURMOND HOMES PTY LTD. JOB No: 13010 MR & MRS PARR **NEWPORT 24.7** Copyright in this document is owned by KURMOND HOMES PTY LTD. Under the provisions of the Copyright ACT 1988 and is intended for use only as BL No. 205 457C DRAWN ABN 481 288 211 98 SITE ADDRESS: ME 31.05.13 TRADITIONAL SHEET: 2.3 authorised by KURMOND HOMES PTY LTD. Kurmond Homes PTY LTD CHECKED LOT 2155 in DP 1168992, E 10 Sovereign Place, South Windsor 2756 Diamond Inclusion LAKESIDE PARADE T: 1300 764 761 C COPYRIGHT F: (02) 45714015 DA STAGE 1:200 JORDAN SPRINGS NSW 2747



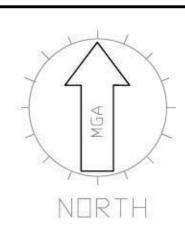
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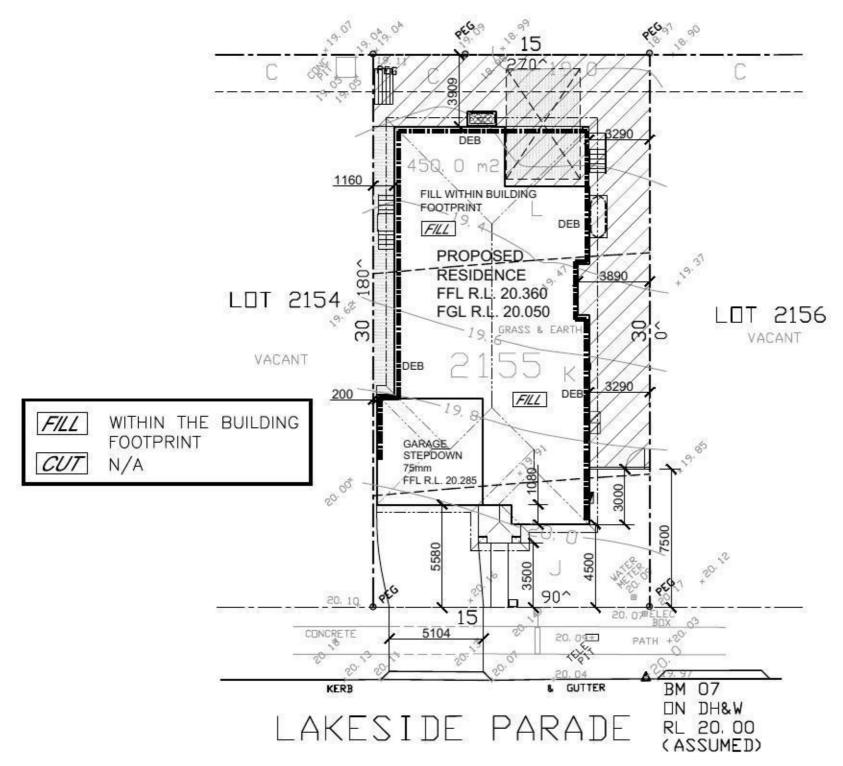
SITE SPECIFIC HAZARDS

FOOTPATH / PEDESTRIAN TRAFFIC



SITE COVERAGE PLAN





# STORMWATER TO REAR EASEMENT VIA RAINWATER TANK

PROOF OF EXISTENCE OF ALL SERVICES IS THE CONTRACTOR'S RESPONSIBILITY. CURRENT "DIAL BEFORE YOU DIG" SERVICES PLANS MUST BE OBTAINED PRIOR TO COMMENCING ANY EXCAVATION.

DIAL 1100
BEFORE YOU DIG

- C: EASEMENT TO DRAIN WATER 2 WIDE
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- K: RESTRICTION ON THE USE OF LAND
- J: RESTRICTION ON THE USE OF LAND

## SITE INDUCTION

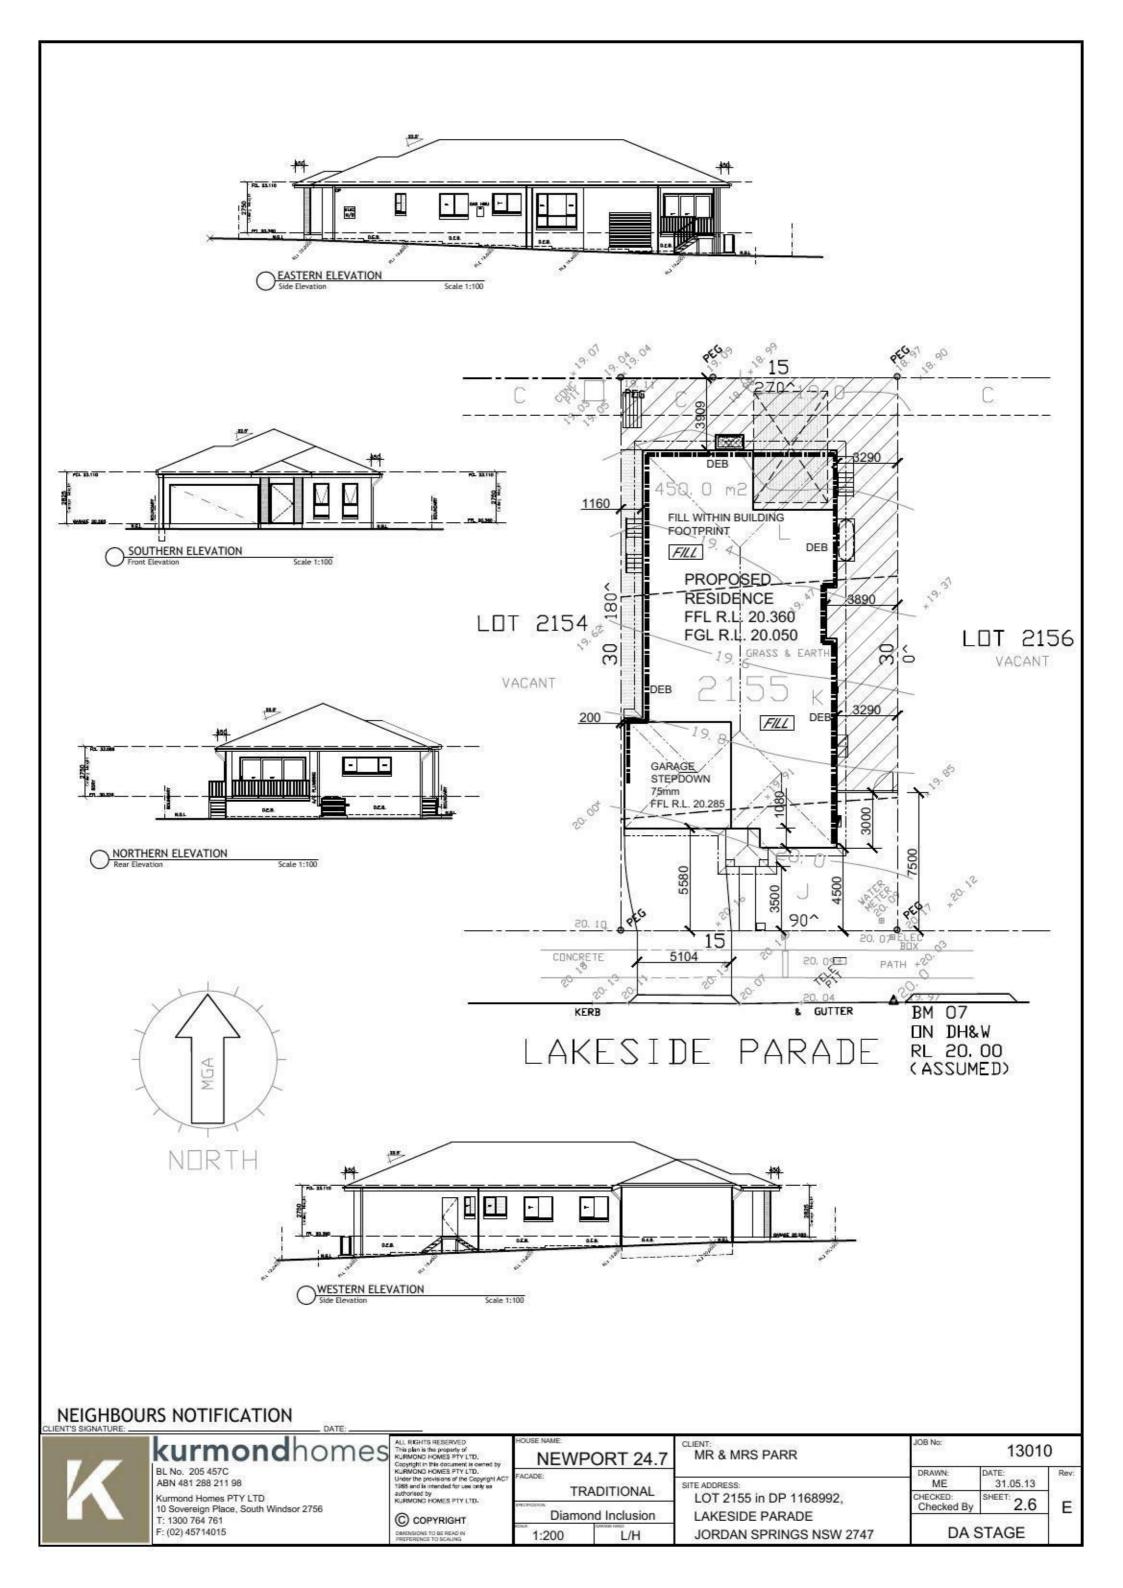
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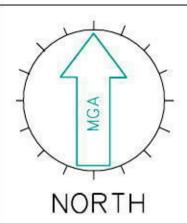
SITE SPECIFIC HAZARDS

\*FOOTPATH / PEDESTRIAN TRAFFIC

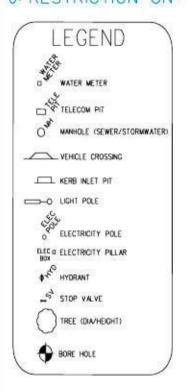
**CUT & FILL PLAN** 

<b>kurmond</b> homes	ALL RIGHTS RESERVED This plan is the property of KURMOND HOMES PTY LTD.	NEWF	ORT 24.7	CLIENT: MR & MRS PARR	JOB No:	1301	0
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10 Sovereign Place, South Windsor 2756 T: 1300 764 761	© COPYRIGHT	REALIN .	SWAGE HWC	LAKESIDE PARADE	2722405	2.5	_ E
	BL No. 205 457C ABN 481 288 211 98 Kurmond Homes PTY LTD 10 Sovereign Place, South Windsor 2756 T: 1300 764 761	BL No. 205 457C ABN 481 288 211 98 Kurmond Homes PTY LTD 10 Sovereign Place, South Windsor 2756 T: 1300 764 761  This place is the property of Rumond Homes PTY LTD. Copyright in this document is owned by Rumond Homes PTY LTD Under the provisions of the Copyright ACT 1985 and is inserted for use only as authorized by Rumond Homes PTY LTD.  © COPYRIGHT	KURMOND HOMES PTY LTD.  BL No. 205 457C ABN 481 288 211 98  Kurmond Homes PTY LTD 10 Sovereign Place, South Windsor 2756 T: 1300 764 761  Kurmond Homes PTY LTD  Copyright ACT  This plan is the property of RURMOND HOMES PTY LTD.  NEWP  FACADE:  TRESHAMOND HOMES PTY LTD  Under the provisions of the Copyright ACT 1988 and is infrarded for use only as authorised by RURMOND HOMES PTY LTD.  Copyright Total Copyright ACT  TRESHAMOND HOMES PTY LTD.  Diamo	BL No. 205 457C ABN 481 288 211 98 Kurmond Homes PTY LTD 10 Sovereign Place, South Windsor 2756 T: 1300 764 761  C COPYRIGHT  This plan is the property of RURWOND HOMES PTY LTD.  NEWPORT 24.7  NEWPORT 24.7  NEWPORT 24.7  NEWPORT 24.7  FACADE:  TRADITIONAL  WILLIAM ON HOMES PTY LTD.  O COPYRIGHT  Diamond Inclusion	KURMOND HOMES PTY LTD.  BL No. 205 457C ABN 481 288 211 98 Kurmond Homes PTY LTD 10 Sovereign Place, South Windsor 2756 T: 1300 764 761  This plan is the property of Kurmond Homes PTY LTD.  WEMPOND HOMES PTY LTD. Under the Capyright ACT 1988 and is intended for case only as authorised by Kurmond Homes PTY LTD.  TRADITIONAL Diamond Inclusion  Diamond Inclusion  LAKESIDE PARADE	KURMOND HOMES PTY LTD.  ABN 481 288 211 98  Kurmond Homes PTY LTD  10 Sovereign Place, South Windsor 2756 T: 1300 764 761  KURMOND HOMES PTY LTD.  © COPYRIGHT  NEWPORT 24.7  NEWPORT 24	KURMOND HOMES PTY LTD.  ABN 481 288 211 98  Kurmond Homes PTY LTD  10 Sovereign Place, South Windsor 2756 T: 1300 764 761  KURMOND HOMES PTY LTD.  Under the professor of the Copyright ACT 1301 TRADITIONAL  DRAWN:  TRADITIONAL  DIamond Inclusion  Diamond Inclusion  Diamond Inclusion  Diamond Inclusion  DIAMOND HOMES PTY LTD.  Diamond Inclusion  DIAMOND HOMES PTY LTD.  C COPYRIGHT  DIAMOND HOMES PTY LTD.  Diamond Inclusion  DIAMOND HOMES PTY LTD.  DIAMOND HOME





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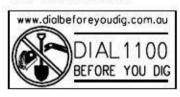
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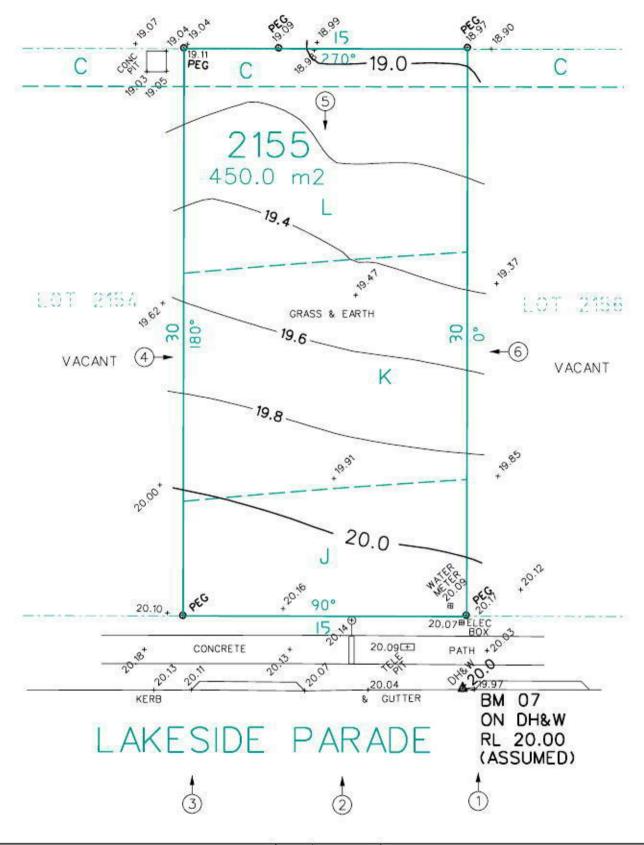
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WC,EC,TC: DENOTES SERVICE CONDUIT

SV: DENOTES STOP VALVE

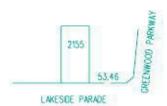
HYD: DENOTES HYDRANT





DATE







NOTE: CONTOURS SHOWN HAVE BEEN INTERPOLATED FROM SPOT LEVELS TAKEN ON-SITE AND ARE A REPRESENTATION OF THE TOPOGRAPHY ONLY.

DIMENSIONS SHOWN (BEARINGS & DISTANCES) HAVE BEEN DETERMINED BY LAND AND PROPERTY INFORMATION PLANS ONLY, BOUNDARIES HAVE NOT BEEN ACCURATELY DETERMINED.

SERVICES SHOWN HAVE BEEN LOCATED WHERE POSSIBLE BY FIELD SURVEY, PRIOR TO ANY SITE WORKS, THE RELEVANT AUTHORITY SHOULD BE CONTACTED TO DETERMINE EXACT POSITION OF ANY UNDERGROUND PIPES, CABLES ETC.

DIMENSIONS OF ANY TREES SHOWN ON THE PLAN ARE APPROXIMATE.

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NOTATION/AMENDMENT

# CONTOUR PLAN

AT LAKESIDE PARADE, JORDAN SPRINGS

LOT 2155 DP 1168992

CLIENT: KURMOND HOMES
REF: PARR 13010

ASSOCIATES
INCORPORATED ENGSURVEY PTY LTD ABN: 84 134 616 078

PH/ 9806 3000 F/9891 2806 www.donovanassociates.com 15 PARKES STREET PARRAMATTA NSW 2150

CIVIL, STRUCTURAL, HYDRAULIC ENGINEERS
REGISTERED SURVEYORS & LAND INFORMATION CONSULTANTS

### **OUTLINE LANDSCAPE SPECIFICATION**

Preparation by Builder: Builder shall remove all existing concrete pathways, fences, footings, walls etc. not notated to be retained and complete all necessary excavation work prior to commencement on site by Landscape Contractor (Contractor). Builder shall also install new retaining walls, kerbs, layback kerb, crossover, pathways etc. and make good all existing kerbs, gutters etc. as necessary and to approval of Council. Builder shall ensure that a minimum 450mm of topsoil in garden areas and a minimum 150mm of topsoil in lawn areas exists. Should required depths not exist Builder shall contact Landscape Architect and ask for instructions prior to completion of excavation works. Excavate as necessary, then fill with approved site topsoil to allow for minimum 500mm soil depth in garden areas and 150mm soil depth in garden areas and 150m

levels & surface drainage shall be determined by others & approved on site by Head Contractor. Note: Approved imported topsoil mix may be utilised if there is insufficient site topsoil available. State in Tender a m3 rate for additional imported topsoil and the quantities of both site topsoil and imported topsoil allowed for in Tender.

Initial Preparation: Verify all dimensions & levels on site prior to commencement. Do not scale from drawings. Locate all underground & above ground services & ensure no damage occurs to them throughout contract. Spray approved weedicide to all proposed lawn & garden areas to manufacturer's directions. Remove existing concrete pathways, footings, walls etc. not notated to be retained & weeds from site. Levels indicated on Plan are nominal only and are derived from Architectural Plans & Drawings by others. Final structural integrity of all items shall be the sole responsibility of Landscape Contractor. Tree Protection: Trees to be retained shall be protected during site works and construction by the erection of Solid barricades to the specification of Council. Storage of machinery or materials beneath canopy of trees to be retained shall not be

permitted. Changes to soil level and cultivation of soil beneath canopy of trees to be retained shall not be permitted unless under direct supervision of Landscape Architect. Existing trees shall be pruned to Landscape Architects onsite instructions. Soil Preparation: Cultivate to depth of 300mm all proposed lawn & garden areas incorporating minimum 100mm depth of organic clay breaker into existing site soil. Do not cultivate beneath existing trees to be retained. In areas where fill is required gain required shapes & levels using a premium grade soil mix. In areas where excavation is required to to allow for installation of 500mm depth of premium grade topsoil mix to garden areas and 300mm depth of premium grade topsoil mix to lawn areas. Undertake all required action to ensure that no rootballs of proposed plants sit in clay wells and that all garden areas and lawn areas drain satisfactorily. Note it is intended that wherever possible existing levels shall not be altered through garden and lawn areas. It is the Contractors responsibility to ensure that the end result of the project is that all lawn and garden areas drain sufficiently (both surface & subsurface), are at required finished levels and have sufficient soil depths to enable lawn and plants to thrive and grow. Should alternative works to those specified be required to achieve the above result, Contractor shall inform Builder at time of Tender and request instructions.

Lawn Edging and Stepping Stones:(i) 125 x 25mm approved tanalith impregnated pine edging shall be installed, to lines as indicated on plan and staked with approved stakes at maximum 1500mm centres at ends and changes of direction; stakes shall be nailed to edging with approved galvanised steel nails. Top of edging shall finish flush with surrounding surfaces. Top of edging (ii) Contractor shall install approved bricks on edge on a minimum 100mm deep x 90mm wide concrete footing with brick tor set in, to lines nominated on plan as brick edging. Bricks shall be laid with a nominal 10mm wide approved coloured mortar joint. Bricks needing to be cut shall be done so with clean sharp cuts. Top of edging shall finish flush with surrounding finished surfaces. Approved sandstone stepping stones shall be positioned as indicated on plan on a 25mm river sand bed. Approved sandstone stepping stones shall be positioned as indicated on plan on a 25mm river sand bed.

Retaining Walls: Positions, detail and heights of retaining walls shall be by others.

Planting: Purchase plants from an approved nursery. Plants to be healthy & true to type & species. Set out plants to positions indicated on plan. Following approval, plant holes shall be dug approximately twice width and to 100mm deeper than plant rootballs that they are to receive. Base and sides of hole shall be further loosened. Fertiliser, followed by 100mm depth of topsoil mix shall then be placed into base of hole and lightly consolidated. Base of hole shall then be watered. Remove plant container and install plant into hole. Rootball shall be backfilled with surrounding topsoil and topsoil firmed into place. An approved shallow dish shall be formed to contain water around base of stem. Base of stem of plant shall finish flush with finished soil level. Once installed plant shall be thoroughly watered and maintained for the duration of the Contract.

Staking: All trees shall be staked using 2 x 38mm x 38mm x 2000mm long hardwood stakes per plant and with hessian webbing ties installed to Landscape Architect's on site instructions.

Mulching: Install 75mm depth of 25mm diameter hardwood mulch to all garden areas, coving mulch down around all plant stems & to finish flush with adjacent surfaces.

Turfing: Prepare for, level & lay cultivated Palmetto Buffulo turves to all areas nominated on plan as being lawn, Roll, water, fertilise, mow & maintain lawns as necessary until completion of maintenance period. At same time make good all existing lawn areas using same lawn type. Lawns in shade shall be over sown with an approved seed mix. Allow to retrim and returf councils nature strip as required.

Fencing: Retain all existing fences unless advised otherwise by builder. Install timber paling fences to heights indicated on Plan.

Paying: Areas to be payed shall be excavated or filled to allow for installation of bedding materials. Levels and falls shall be as per Plan. Surface drainage on paying shall be towards grated drains with all drains connected to stormwater system and installed by Builder.

Irrigation: Contractor shall supply and install an approved fully automatic, vandal resistant, computerised irrigation system to all garden and lawn areas, excluding council nature strip. Entire system shall be to approval of Water Board and shall utilise pop-up sprinklers and electronic controllers. Contractor shall be responsible to ensure that system is able to satisfactorily operate on available water pressure. Power supply for use by irrigation system shall be provided to an approved location near southwest corner of residence by others and shall consist of an approved weatherproof G.P.O. The irrigation system controller shall be housed in an approved waterproof cabinet mounted to external wall of residence.

Clotheslines: Contractor shall allow for all necessary labour and materials and shall install clotheslines to positions as indicated on plan to manufacturer's instructions to approval of Landscape Architect. Clothesline type shall be equal to 'Hills Foldaline'

Completion: Prior to practical completion remove from site all unwanted debris occurring from work. Satisfy Council that all landscaping work has been undertaken in strict accordance with Councils landscape codes & guidelines.

Maintenance Period: A twelve month maintenance period shall be undertaken by owner or owners representative as set out herein. Owner shall have care and maintenance of all work specified under this Contract and shall rectify any defective work for a period of 52 weeks following Practical Completion of Landscape Works. This period shall be herein known as the Maintenance Period. Work shall also include for the care and maintenance of all existing vegetation to be retained and proposed vegetation. Site shall be attended at least weekly and as otherwise required. The following works shall be undertaken during the Maintenance Period.

- (a) Recurrent works Undertake recurrent works throughout the Maintenance Period. These works shall include but are not limited to watering, weeding, fertilising, pest and disease control, returfing, staking and tying, replanting, cultivation, pruning, aerating, renovating, top dressing and the like.
- (b) Watering Regularly water all plants and lawn areas to maintain optimal growing conditions. Contractor shall adjust the water quantity utilised with regard to climatic conditions prevalent at the time.
- (c) Replacements Immediately replace plants which die or fail to thrive (at discretion of Landscape Architect) with plants of same size and quality unless otherwise specified. Plant replacement shall be at Contractors expense, unless replacement is required due to vandalism or theft, which shall be determined by Landscape Architect. Required replacement of plants due to vandalism or theft shall be undertaken by Contractor and shall be paid for by Client at an agreed predetermined rate.
- (d) Mulched surfaces Maintain mulched surfaces in clean, tidy, weed-free condition and shall reinstate mulch as necessary to maintain specified depths.
- e) Stakes & ties Adjust and/or replace stakes and ties as required. Remove stakes and ties at end of Maintenance Period if directed by Landscape Architect.
- (f) Lawn areas Lawn areas shall be mown at regular intervals to ensure non heading of lawn with a fine-cutting mulching mower and clippings left on lawn to mulch and self-fertilise lawn areas. Primary cut after laying of lawn by others shall be determined on site taking into consideration season, watering and growth rate of lawn. Following the primary cut all lawns shall be required to ensure a healthy lawn and a neat appearance. Care shall always be taken to ensure that no clippings are left on surrounding roads or garden areas after mowing. Replace lawn areas that fail to thrive at discretion of Landscape Architect. All new and made good lawn areas shall be barricaded off from pedestrian traffic by use of star pickets and brightly coloured plastic safety mesh until establishment of lawn. Barricades shall be removed upon establishment of lawn area.
- (g) Weeding Remove by hand, or by carefully supervised use of weedicide, any weed growth that may occur throughout Maintenance Period. This work shall be executed at weekly intervals so that all lawn and garden areas may be observed in a veed-free condition.
- (h) Pruning Prune new and existing plants (excluding existing trees) as necessary to maintain dense foliage conditions. Any rogue branches overhanging or obstructing pathways, roads, doorways, etc., shall be removed by approved horticultural methods.
- (i) Spraying Spraying for insect, fungal and disease attack shall be undertaken as required and in accordance with spray manufacturers recommendations at intervals taking into account the season of year during which landscape works are to be
- (i) Tree Care Should any existing trees be damaged during construction works immediately engage an experienced arboriculturist and then undertake any rectification work recommended by arboriculturist.

# . All dimensions and levels shall be verified by Contractor on site prior to commencement of work. 2. All detailing of drainage to peved areas shall be by others. 3. All levels shall be determined by others and approved on 3. An invete shall be determined by drives an approved to state by client. 4. Extent, height and position of all retaining walls shall be determined by others and approved on site by client. 5. Do not scale from drawings. 6. If in doubt contact the Landscape Architect. 7. All boundaries shall be surveyed prior to commencement of construction works. 8. This plain is for DA purposes only. It has not been detailed for construction.

for construction.

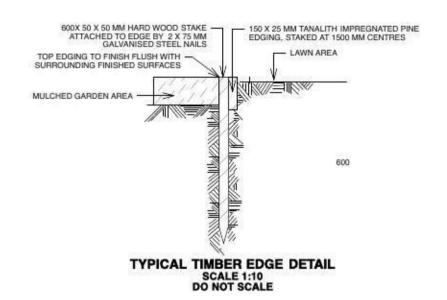
All dimensions, levels and boundaries are nominal only.

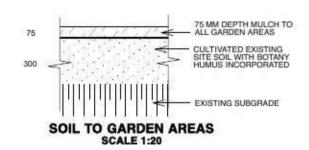
Landscape Architects.

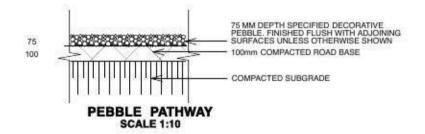
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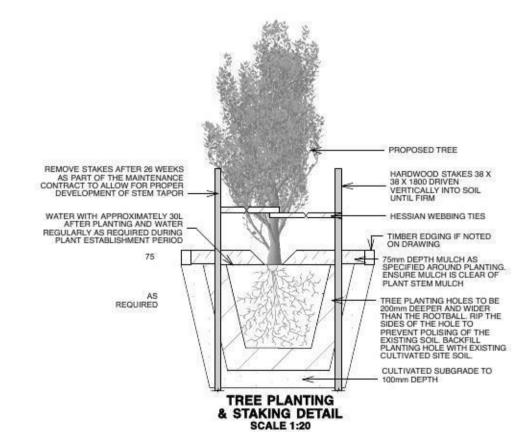
LANDSCAPE SPECIFICATION ROJECT# **LOT 2155 LAKESIDE PDE, JORDAN SPRINGS** Kurmond DATE# 31/05/13 MR & MRS PARR EA @ A3 L/03 RAWN JS A Total Concept Landscape Architects & SW REVISION **Swimming Pool Designers** 65 West Street, North Sydney NSW 2060 Tel: (02) 9957 5122 Fx: (02) 9957 5922

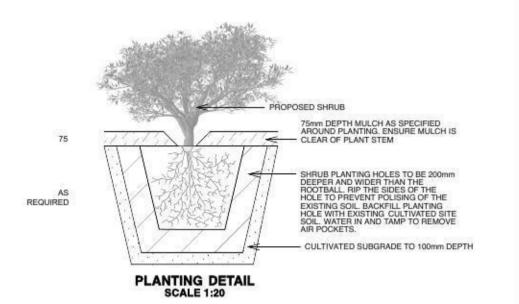
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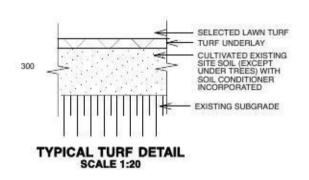












DATE	REVISION			
LAN	DSCAPE DETAILS			
ADDRESS LOT 2	2155 LAKESIDE PDE, JORDA	AN SPRI	NGS	PROJECT # Kurmond
CLIENT MD 9	MRS PARR	DATE#	31/05/13	DWG#
INIT O	MKS PAKK	SCALE @ A	as shown	L/02
A Total Co	oncept Landscape Architects &	DRAWN	JS	L/02
	Pool Designers	CHKD	SW	REVISION
65 West Street,	North Sydney NSW 2060 5122 Fx: (02) 9957 5922	ato	ncept Neat & swimmings	sool designers

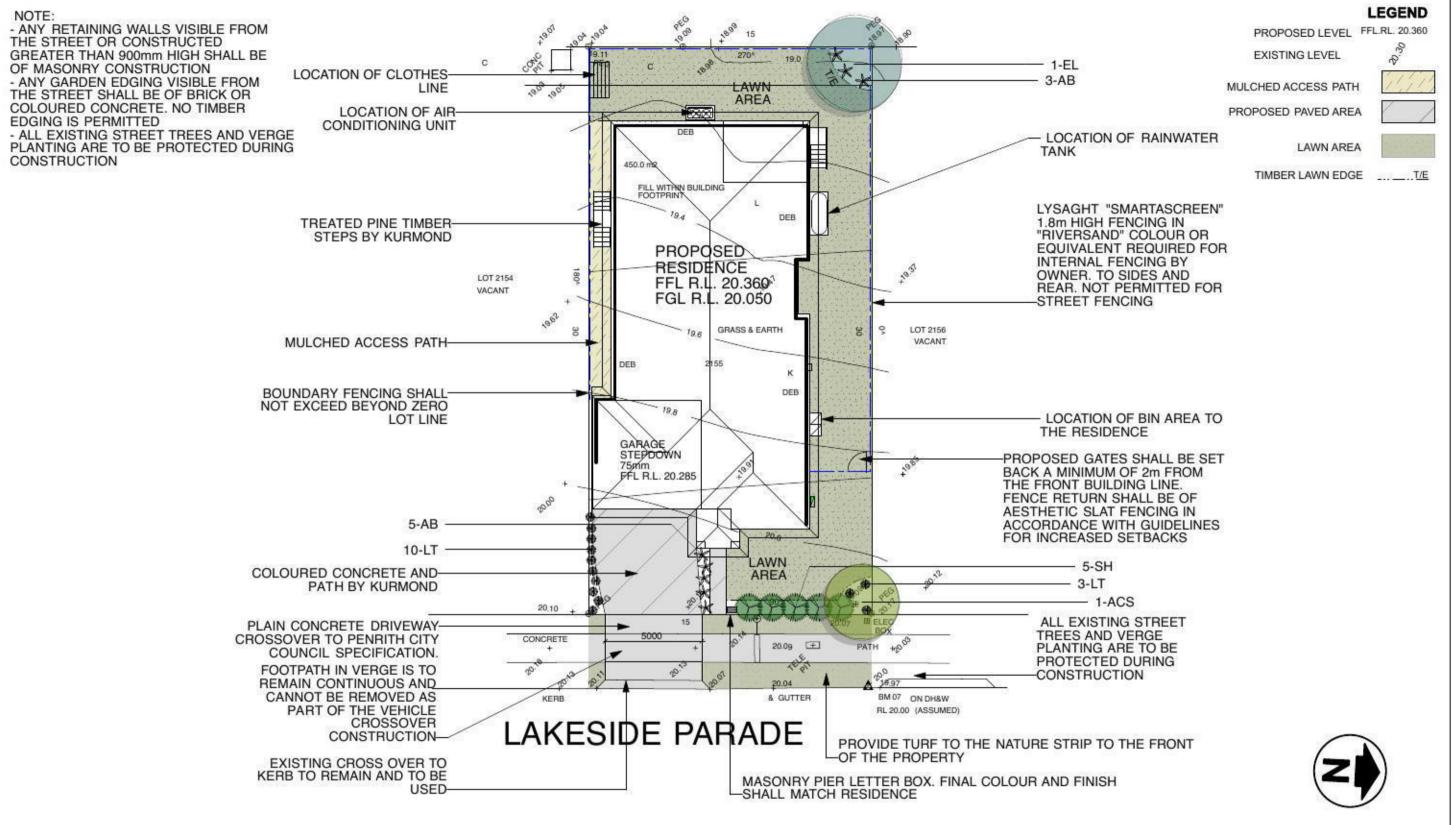
1. All dimensions and levels shall be verified by Contractor

1. All dimensions and levels shall be verified by Contractor on site prior to commencement of work.
2. All detailing of drainage to paved areas shall be by others.
3. All levels shall be determined by others and approved on site by client.
4. Extent, height and position of all retaining walls shall be determined by others and approved on site by client.
5. Do not scale from drawings.
6. If in doubt confact the Landscape Architect.
7. All boundaries shall be surveyed prior to commencement of construction works.
8. This plan is for DA purposes only. It has not been detailed for construction.

The plant is not be proposed for construction.

9. All dimensions, levels and boundaries are nominal only.

10. This design shall not be copied, utilised or reproduced in any way without prior written permission of A Total Concept Landscape Archibects.



- . All dimensions and levels shall be verified by Contractor
- on site prior to commencement of work.

  2. All detailing of drainage to paved areas shall be by others.

  3. All levels shall be determined by others and approved on
- site by client.

  Extent, height and position of all retaining walls shall be
- detamined by others and approved on site by client, to Structural Engineers detail. 5 Do not scale from drawings. 5. If in doubt contact the Landscape Architect.
- All boundaries shall be surveyed prior to commencement of construction works.
   This plan is for DA purposes only. It has not been detailed.
- All dimensions, levels and boundaries are nominal only.

  This design shall not be copied, utilised or reproduced any way without prior written permission of A Total Cont. Landscape Architects.

## PLANTING SCHEDULE

ID	Latin Name	Common Name	Quantity	Scheduled Size	Spread	Height
ACS	Acmena smithii	Lillypilly	1	25lt	4000	8000
AB	Anigozanthos flavidus	Kangaroo Paw	8	5lt	800	800
EL	Elaeocarpus reticulatus	Blueberry Ash	1	25lt	5000	12000
LT	Lomandra 'Tanika'	Dwarf Lomandra	13	5lt	500	500
SH	Syzygium 'Cascade'	Lillypilly	5	15lt	1500	2500

DATE: 22/0	07/13	REVISION 'A' Amendments made as per developers requ	est		
DRAWING	PROPOSI	ED LANDSCAPE PL	AN		
ADDRESS	LOT 2155 L	AKESIDE PDE, JORDA	N SPRIN	GS	PROJECT # Kurmond
LIENT	MR & MRS	DADD	DATE#	31/05/13	DWG#
	MK & MKS	PARK	SCALE @ A3	1:200	L/01
A T	otal Concen	t Landscape Architects &	DRAWN	JS	201
	nming Pool D		CHKD	sw	REVISION A
65 We Tel: (0	est Street, North Sy 2) 9957 5122 Fx:	vdney NSW 2060 (02) 9957 5922	atc	ept	noni designasi

### Schedule of BASIX commitments

Water Commitments	Show on DA plans	Show on CC/CDC plans & specs	Certifier
Fixtures			
The applicant must install showerheads with a minimum rating of 3 star (> 7.5 but <= 9 L/min) in all showers in the development.		1	1
The applicant must install a foliet flushing system with a minimum rating of 3 star in each toilet in the development.		1	1
The applicant must install taps with a minimum rating of 3 star in the kitchen in the development.	1	1	
The applicant must install basin taps with a minimum rating of 3 star in each bethroom in the development.		/	
Alternative water			
Rainwater tank			
The applicant must install a rainwater tank of at least 3000 litres on the site. This rainwater tank must meet, and be installed in accordance with, the requirements of all applicable regulatory authorities.	1	1	1
The applicant must configure the rainwater tank to collect rain runoff from at least 259.65 square metres of the roof area of the development (excluding the area of the roof which drains to any stormwater tank or private dam).		1	1
The applicant must connect the rainwater tank to:			
all toilets in the development		1	1
the cold water top that supplies each clothes washer in the development.		1	1
<ul> <li>at least one outdoor tap in the development (Note: NSW Health does not recommend that rainwater be used for human consumption in areas with potable water supply.)</li> </ul>		1	1

Thermal Comfort Commitments		Show on CC/CDC plans & specs	Certifier check
Floor, walls and ceiling/roof			
The applicant must construct the floor(s), walls, and ceiling roof of the dwelling in accordance with the specifications listed in the table below.	1	1	1

Construction	Additional insulation required (R-Value)	Other specifications
floor - concrete slab on ground	nil	· · · · · · · · · · · · · · · · · · ·
external wall - brick veneer	1.66 (or 2.20 including construction)	
internal wall shared with garage - plasterboard	nil	
ceiling and roof - flat ceiling / pitched roof	ceiling: 3 (up), roof: foil/sarking	unventilated, dark (solar absorptance > 0.70)

Note Insulation specified in this Certificate must be installed in accordance with Part 3.12.1.1 of the Building Code of Australia.

Thermal Comfort Commitments	Show on DA plans	Show on CC/CDC plans & specs	Certifier check
Windows, glazed doors and skylights			
The applicant must install the windows, glazed doors and shading devices described in the table below, in accordance with the specifications listed in the table. Relevant overshadowing specifications must be satisfied for each window and glazed door.	1	1	1
The dwelling may have 1 skylight (<0.7 square metres) and up to 2 windows/glazed doors (<0.7 square metres) which are not listed in the table.	1	1	1
The following requirements must also be satisfied in relation to each window and glazed door:  Except where the glass is 'single clear' or 'single toned', each window and glazed door must have a U-value no greater than that issted and a Solar Healt Gain Coefficient (SHGC) +1-10% of that listed. Total system U-values and SHGC must be calculated in accordance with National Fenerstration Rating Council (NFRC) conditions with National Fenerstration Rating Council (NFRC) conditions.	1	*	1
<ul> <li>The leading edge of each eave, pergola, verandah, balcony or awning must be no more than 500 millimetres above the head of the window or glazed door, except that a projection greater than 500 mm and up to 1500 mm above the head must be twice the value in the table.</li> </ul>	1	/	1
Pergolas with polycarbonate roof or similar translucent material must have a shading coefficient of less than 0.35.		1	1
<ul> <li>Unless they have adjustable shading, pergolas must have fixed battens parallel to the window or glazed door above which they are situated, unless the pergola also shades a perpendicular window. The spacing between battens must not be more than 50 mm.</li> </ul>		1	1

Window/glazed door no.	Orientation	Maximum area (square metres)	Туре	Shading	Overshadowing
W1,W2	S	3.06	standard aluminium, single clear (or U-value:7.63, SHGC:0.75)	eave/verandah/pergola/balcony 451-600 mm	not overshadowed
W3,W4,W5	E	4.11	standard aluminium, single clear (or U-value:7.63, SHGC:0.75)	eave verandah/pergola/balcony 451-600 mm	not overshadowed
W6	E	3.9	standard aluminium, single clear (or U-value 7.63, SHGC 0.75)	eave/verandah/pergola/balcony 901-1,200 mm	not overshadowed
W/7	N	7.7	standard aluminium, single clear (or U-value 7.63, SHGC 0.75)	eave/verandah/pergota/balcony >2,000 mm	not overshadowed
W8	E	5.76	standard aluminium, single clear (or U-value:7.63, SHGC:0.75)	eave/verandah/pergola/balcony >2,000 mm	not overshadowed
W9	N	2.27	standard aluminium, single clear (or U-value:7.63, SHGC:0.75)	eave/verandah/pergola/balcony 451-600 mm	not overshadowed

Energy Commitments	Show on DA plans	Show on CC/CDC plans & specs	Certifie check
Hot water			
The applicant must install the following hot water system in the development, or a system with a higher energy rating: gas instantaneous with a performance of 5 stars.	1	1	1
Cooling system			
The applicant must install the following cooling system, or a system with a higher energy rating, in at least 1 living area: 3-phase airconditioning; Energy rating: EER < 2.5		1	1
The applicant must install the following cooling system, or a system with a higher energy rating, in at least 1 bedroom: $3$ -phase airconditioning; Energy rating: EER $< 2.5$		1	1
The cooling system must provide for day/hight zoning between living areas and bedrooms.		1	1
Heating system			
The applicant must install the following heating system, or a system with a higher energy rating, in at least 1 living area: 3-phase airconditioning. Energy rating: EER < 2.5		1	1
The applicant must install the following heating system, or a system with a higher energy rating, in at least 1 bedroom: 3-phase airconditioning, Energy rating. EER < 2.5		1	1
The heating system must provide for day/night zoning between living areas and bedrooms.		1	1
Ventilation			
The applicant must install the following exhaust systems in the development:			
At least 1 Bathroom: individual fan, not ducted; Operation control: manual switch on/off		1	1
Kitchen: individual fan, ducted to façade or roof, Operation control: manual switch on/off			
Laundry: individual fan, ducted to façade or roof, Operation control: manual switch on/off		-	-
Laundry, Individual ran, duction to layable of foot, Operation control manual switch officing		1	1
Natural lighting			
The applicant must install a window and/or skylight in the kitchen of the dwelling for natural lighting.	1	1	1
The applicant must install a window and/or skylight in 3 bathroom(s)/toilet(s) in the development for natural lighting.	1	1	1
Other			

The applicant must install a gas cooktop & electric oven in the kitchen of the dwelling.	1	40
The applicant must install a fixed outdoor clothes drying line as part of the development.	1	
A STATE OF THE STA	And the	

no since continuents, apparati means the person carrying our time development.

Commitments identified with a \( \sqrt{i} \) in the "Show on DA plans" column must be shown on the plans accompanying the development application is to be lodged for the proposed development.

Commitments identified with a \( \sqrt{i} \) in the "Show on CCICDC plans and specs" column must be shown in the plans and specifications accompanying the application for a certificate / complying development certificate for the proposed development.

Commitments identified with a  $\sqrt{}$  in the "Certifier check" column must be certified by a certifying authority as having been fulfilled, before a final occupation certification of the development may be issued.

					2.0	NEIGHBOURS NOTIFICATION
					2.5	CUT & FILL PLAN
					2.4	SITE COVERAGE PLAN
		E   " a   a			2.3	STORMWATER CONCEPT PLAN
					2.2	CONS. WASTE MANAGEMENT &
		\$10 P				SEDIMENT & EROSION CTRL. PLAN
			The Table		2.1	SITE ANALYSIS
				1 1		
					11	WET AREAS
					10	WET AREAS
					9	DOOR SCHEDULE
			8		8	SLAB PLAN
					7	SECTION
F	15.07.13	AMENDED SITE PLAN TO DEVE	LOPER'S REQUIREMENT	MC	6	ELEVATIONS
Е	31.05.13	Plans ready for developer and DA	lodgement	BAC	5	ELEVATIONS
D	24.05.13	PROVIDED WET AREA DETAILS	FOR COLOURS	BAC	4	ROOF PLAN
С	18.02.13	AMENDED PLANS AND ELEVAT	IONS.	ME	3	GROUND FLOOR PLAN
В	11.03.13	AMENDED PLANS AS PER CLIEN	NT'S EMAIL	ME	2	SITE PLAN
Α	05.02.13	PRELIMINARY DRAWINGS		DS	1	COVER SHEET
REV	DATE	AMENDMENTS		BY	SHEET	DESCRIPTION
HTS RESERV	/ED	HOUSE NAME:	CLIENT:			JOB No:



CLIENT'S SIGNATURE:

# **kurmond**homes

Kurmond Homes PTY LTD

I accept and understand the plans and documents that have

been provided to me by Kurmond Homes.

10 Sovereign Place, South Windsor 2756 T: 1300 764 761 F: (02) 45714015

DATE:

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**NEWPORT 24.7** FACADE: TRADITIONAL Diamond Inclusion NTS L/H

MR & MRS PARR SITE ADDRESS: LOT 2155 in DP 1168992, LAKESIDE PARADE **JORDAN SPRINGS NSW 2747** 

13010 DRAWN: DATE: 15.07.13 CHECKED: SHEET: DA STAGE

2.7 ELECTRICAL LAYOUT 2.6 NEIGHBOURS NOTIFICATION

EASEMENT TO DRAIN WATER 2 WIDE LOT 2155 RESTRICTION ON THE USE OF LAND LOCATION PLAN D.P: 1168992 UBD REF: 144, H13 RESTRICTION ON THE USE OF LAND L.G.A: PENRITH RESTRICTION ON THE USE OF LAND Developer Approval **BUSH FIRE PRONE** Required LAND BAL 29, BAL LAKESIDE PARADE PRIVATE OPEN SPACE PROPOSED CLOTHES LINE TO THE 19, & BAL 12.5 REAR OF THE RESIDENCE BY PRINCIPAL PRIVATE OPEN SPACE **OWNER** PROVIDE T2 FRAMES, TRUSSES, FLOOR JOISTS & GARAGE BEAMS PRIVATE OPEN SPACE PROVIDE TURF TO REAR BY OWNER IN LIEU OF STANDARD LOCATION OF A/C UNIT IN ACCORDANCE WITH LANDSCAPE PRIVATE OPEN SPACE AREA: 135.90m<sup>2</sup> 15 PRIVATE OPEN SPACE: 18.68% MINIMUM REQUIRED BY COUNCIL: 30.2% ORIVATE OPEN SPACE REQUIRED: 67.5m PRINCIPLE PRIVATE OPEN SPACE: TREATED PINE STEPS TO ALFRESCO BY **OWNER** TREATED PINE STEPS TO ALUNDRY BY (6000X4000) P.O.S OWNER USABLE RECTANGLE AS PER COUNCIL FILL WITHIN BUILDING LYSAGHT "SMARTASCREEN" 1.8m LOCATION OF 3,000 LITRE FOOTPRINT HIGH FENCING IN "RIVERSAND" ABOVE GROUND RAINWATER FILL 9, COLOUR OR EQUIVALENT REQUIRED TANK TO MANUFACTURE FOR INTERNAL FENCING BY OWNER. SPECIFICATION TO SIDES AND REAR. NOT PROPOSED. PROVIDE TURF TO SIDE BY OWNER PERMITTED FOR STREET FENCING RESIDENCE IN ACCORDANCE WITH LANDSCAPE LOT 2154 ¢ FFL R.L. 20.360 FGL R.L. 20.050 LOT 2156 PROVIDE MULCHED ACCESS GRASS & EART 19 PATHWAY TO THE SIDE OF VACANT RESIDENCE LOCATION OF HOT VACANT DEB WATER SYSTEM FENCING IS NOT PERMITTED BIN LOCATION TO THE RESIDENCE LOCATED BEHIND 200 DEB ALONG ZERO BOUNDARY FILL SIDE GATE/FENCE PROVIDE 650mm BELOW 'AESTHETIC SLAT FENCING' NATURAL GROUND LEVEL ON GARAGE SIDE GATE AND RETURN FENCING, ALL BOUNDARY STEPDOWN 7.5M FROM THE FRONT STREET, IN CONSTRUCTION TO GARAGE FFL R.L. 20.285 ACCORDANCE WITH JORDAN SPRINGS PORTION GUIDELINES. LOCATION OF METER BOX ANY GARDEN OR LAWN EDGIING REIN CONCRETE DRIVEWAY VISIBLE FROM THE STREET IS TO AND FINISH AS SELECTED BE CONSTRUCTED OF MASONRY BY KURMOND HOMES TEXTURED OR COLOURED BRICKS BLOCKS OR COLOURED CONCRETE 90^ NO TIMBER EDGING IS PERMITTED 15 ANY EXISTING STREET TREES AND 5000 **EXISTING CONCRETE** CONCRETE 20.09 VERGE PLANTING ARE TO BE FOOTPATH TO BE REMAINED 1667 PROTECTED DURING CONSTRUCTION. & GUTTER BM 07 VEHICLE CROSSING 5M WIDE MAX. KERB TO BE CONSTRUCTED OUT PLAIN ON DH&W CONCRETE TO PCC SPECIFICATION AKESIDE PARADE RL 20,00 FINISH BY KURMOND HOMES TO PENRITH CITY COUNCIL (ASSUMED) **SPECIFICATION** EXISTING CROSS OVER TO MASONRY PIER LETTER BOX. KERB TO REMAIN AND TO FINAL COLOUR AND FINISH SHALL BE USED MATCH RESIDENCE BY OWNER SITE PLAN AND IN ACCORDANCE WITH AUSTRALIA POST REQUIREMENTS ANY RETAINING WALLS VISIBLE FORM THE STREET OR 900mm HIGH AND OVER ARE TO SCALE 1:200 NOTES BE OF MASONRY CONSTRUCTION www.dialbeforeyoudig.com.au This detail survey is not a "survey" as defined by the Surveyors Act, 1929. survey work to determine the boundary dime Construction Notes; Relationship of improvements to boundaries is diagrammatic on Where offsets are critical they should be confirmed by further survey WIND CLASSIFICATION: " N2" \* All roof water to drain to the above ground 3,000 litre rainwater tank, in Contours shown depict the topography, except at spot levels shown they do not represent the exact level at any particular point. Services shown hereon have been determined from visual evidence only Prior to any demolition, excavation or construction on the site the relevant authority should be contacted to establish detailed location and depth Australian Medical Control of the c **BEFORE YOU DIG** accordance with Basix Certificate. SLAB CLASSIFICATION: "M" \* R 2.0 external wall insulation in accordance with Basix Certificate. \* R 3.0 ceiling insulation in accordance with Basix Certificate. \* Heating and Cooling loads / system to have a EER of 3.0 - 3.5 max. Australian Height Datum was established from SSM 168755 RL 69.056 SITE INDUCTION Tree locations are accurate to +/- 0.30m \* All square set opening to be 2350mm as 2750mm ceiling height proposed. The information is only to be used at a scale accuracy of 1:200 Before entering site please review and make yourself familiar with Emergency Contacts. Site Specific Hazards and the Site Specific Induction information that is NOTE: located on the Site Induction Sign. If you ALL GROUND LINES ARE APPROXIMATE. have any trouble understanding this instruction, contact the Site Supervisor or Emergency Contact Number located on the CLIENT'S SIGNATURE EXTENT OF CUT AND FILL BATTERS WILL BE DETERMINED ON SITE. SEDIMENT BARRIERS ARE TO BE SITE SPECIFIC HAZARDS I accept and understand the plans and documents that have CUSTOMISED SITE SPECIFIC FOOTPATH / PEDESTRIAN TRAFFIC been provided to me by Kurmond Homes. JOB No: **kurmond**homes This plan is the property of KURMOND HOMES PTY LTD. Copyright in this document is ov KURMOND HOMES PTY LTD. 13010 MR & MRS PARR NEWPORT 24.7 DRAWN Under the provisions of the Copyright ACT 1968 and is intended for use only as 15.07.13 ME **TRADITIONAL** Kurmond Homes PTY LTD authorised by KURMOND HOMES PTY LTD. LOT 2155 in DP 1168992, HECKED

Diamond Inclusion

1:200

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LAKESIDE PARADE

**JORDAN SPRINGS NSW 2747** 

10 Sovereign Place, South Windsor 2756 T: 1300 764 761

F: (02) 45714015

SHEET

DA STAGE

Checked By

# Construction Notes; \* All roof water to drain to the above ground 3,000 litre rainwater tank, in

- \* R 2.0 external wall insulation in accordance with Basix Certificate.

  \* R 3.0 ceiling insulation in accordance with Basix Certificate.

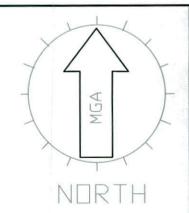
  \* R 3.0 ceiling insulation in accordance with Basix Certificate.

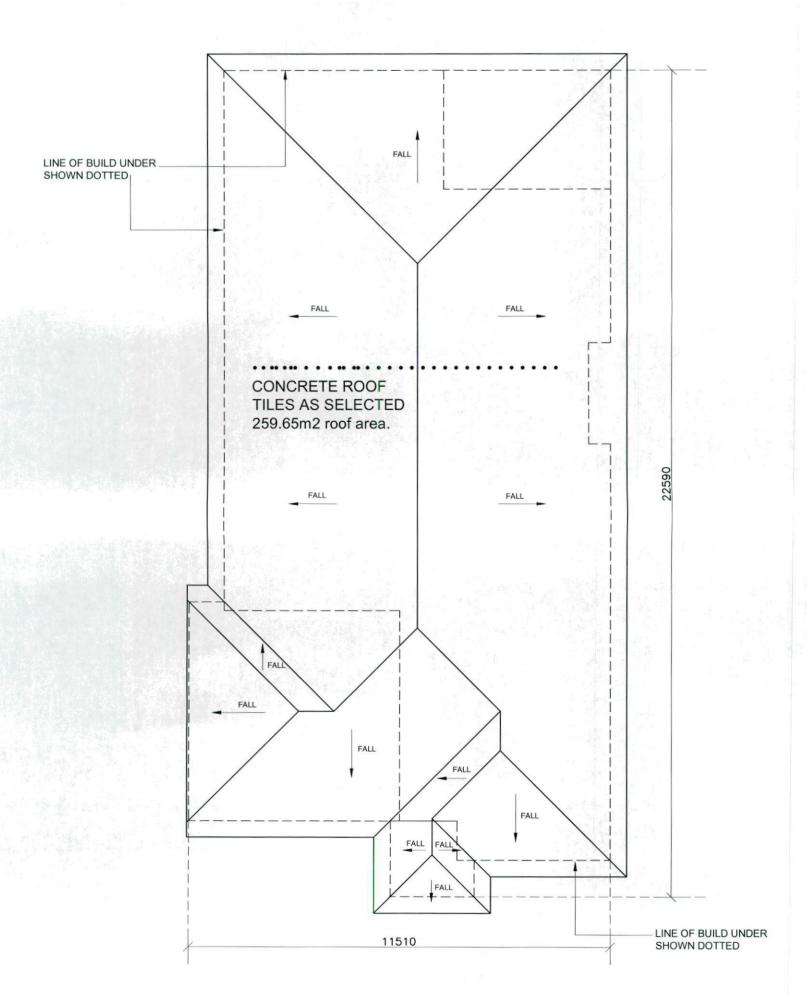
  \* Heating and Cooling loads / system to have a EER of 3.0 3.5 max.

  \* All square set opening to be 2350mm as 2750mm ceiling height proposed.

PROVIDE T2 FRAMES, TRUSSES, FLOOR JOISTS & GARAGE BEAMS IN LIEU OF STANDARD







# **ROOF PLAN**

CLIENT'S SIGNATURE: DATE:

I accept and understand the plans and documents that have been provided to me by Kurmond Homes.



10 Sovereign Place, South Windsor 2756 T: 1300 764 761 F: (02) 45714015

KURMOND HOMES PTY LTD.

BL No. 205 457C
ABN 481 288 211 98

Kurmond Homes PTY LTD

Kurmond Homes PTY LTD

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HOU	SE NAME:	
	<b>NEWPORT 24.7</b>	
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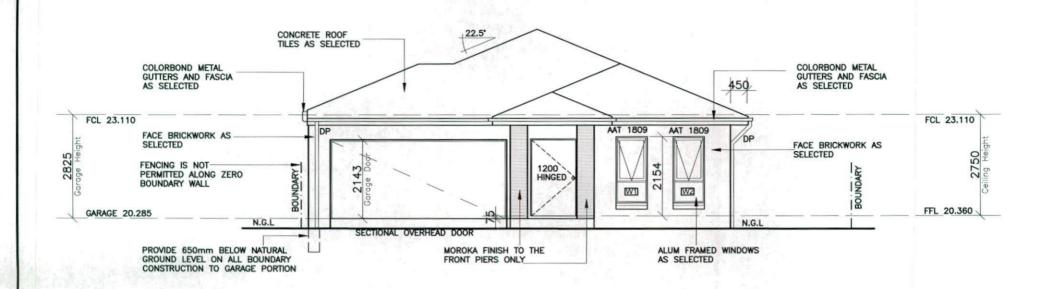
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CLIENT: MR & MRS PARR	JOB No:	13010	)
SITE ADDRESS:	DRAWN: ME	DATE: 15.07.13	Rev:
LOT 2155 in DP 1168992,	CHECKED: Checked By	SHEET: 4	F
LAKESIDE PARADE	DA S	STAGE	

- Construction Notes;
  \* All roof water to drain to the above ground 3,000 litre rainwater tank, in accordance with Basix Certificate.
- \* R 2.0 external wall insulation in accordance with Basix Certificate.
- \* R 3.0 ceiling insulation in accordance with Basix Certificate.
- \* All square set opening to be 2350mm as 2750mm ceiling height proposed.
- \* Heating and Cooling loads / system to have a EER of 3.0 3.5 max.

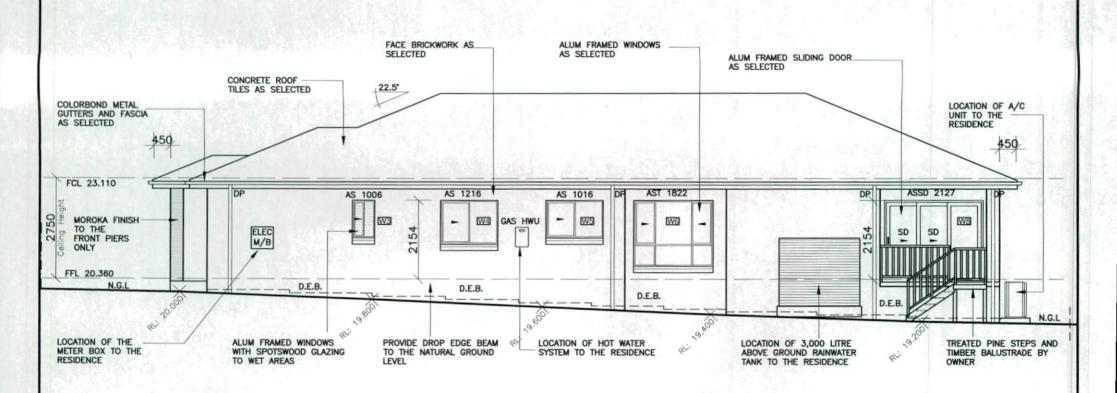
PROVIDE T2 FRAMES, TRUSSES, FLOOR JOISTS & GARAGE BEAMS IN LIEU OF STANDARD





SOUTHERN ELEVATION Front Elevation

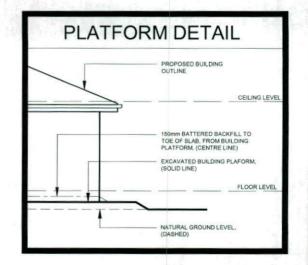
Scale 1:100





Side Elevation

Scale 1:100



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CLIENT'S SIGNATURE

# **kurmond**homes

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HOUSE NAME:	CLIE
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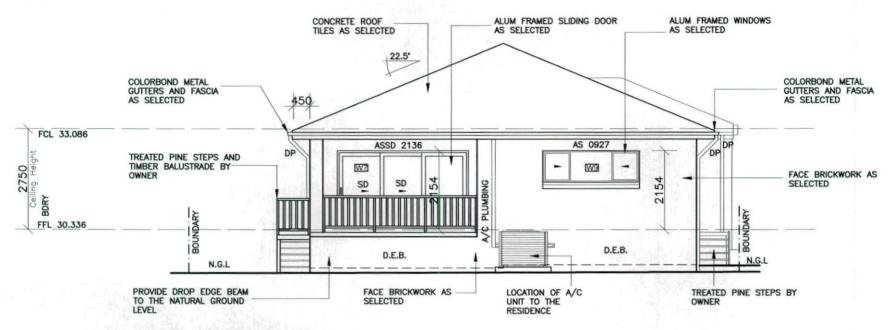
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IENT: MR & MRS PARR	JOB No: 13010		
LAKESIDE PARADE JORDAN SPRINGS NSW 2747	DRAWN: ME CHECKED:	DATE: 15.07.13 SHEET:	Rev:
	DA STAGE		F

- Construction Notes;
  \* All roof water to drain to the above ground 3,000 litre rainwater tank, in accordance with Basix Certificate.
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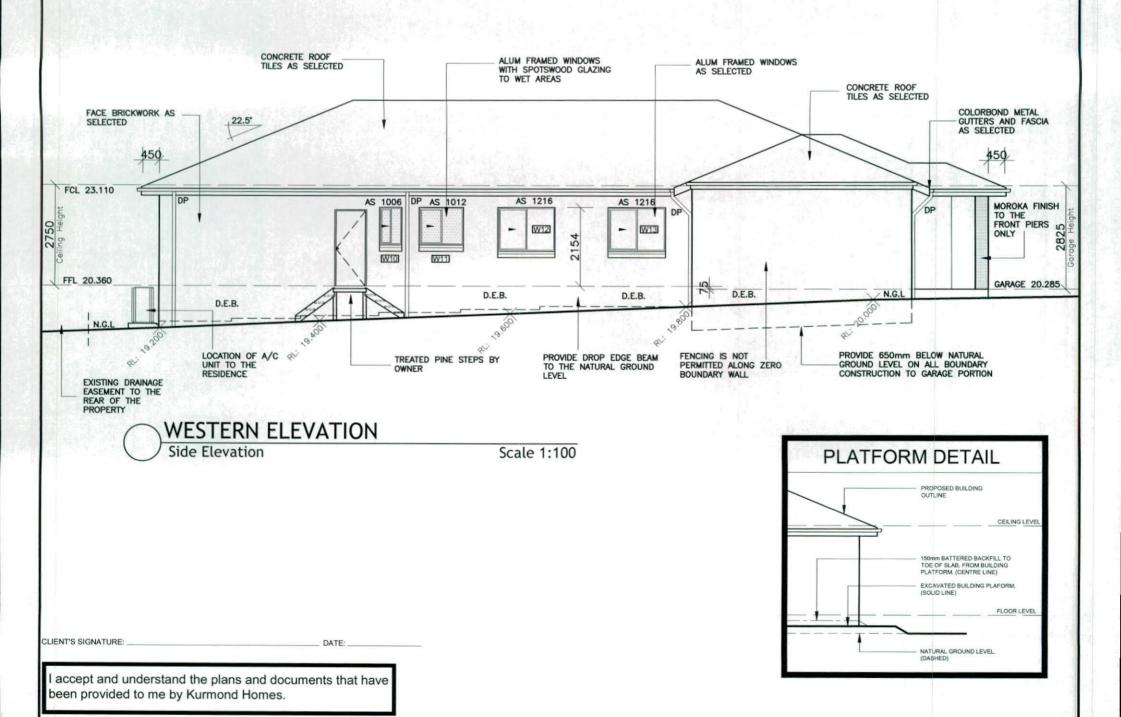
PROVIDE T2 FRAMES, TRUSSES, FLOOR JOISTS & GARAGE BEAMS IN LIEU OF STANDARD





NORTHERN ELEVATION Rear Elevation

Scale 1:100





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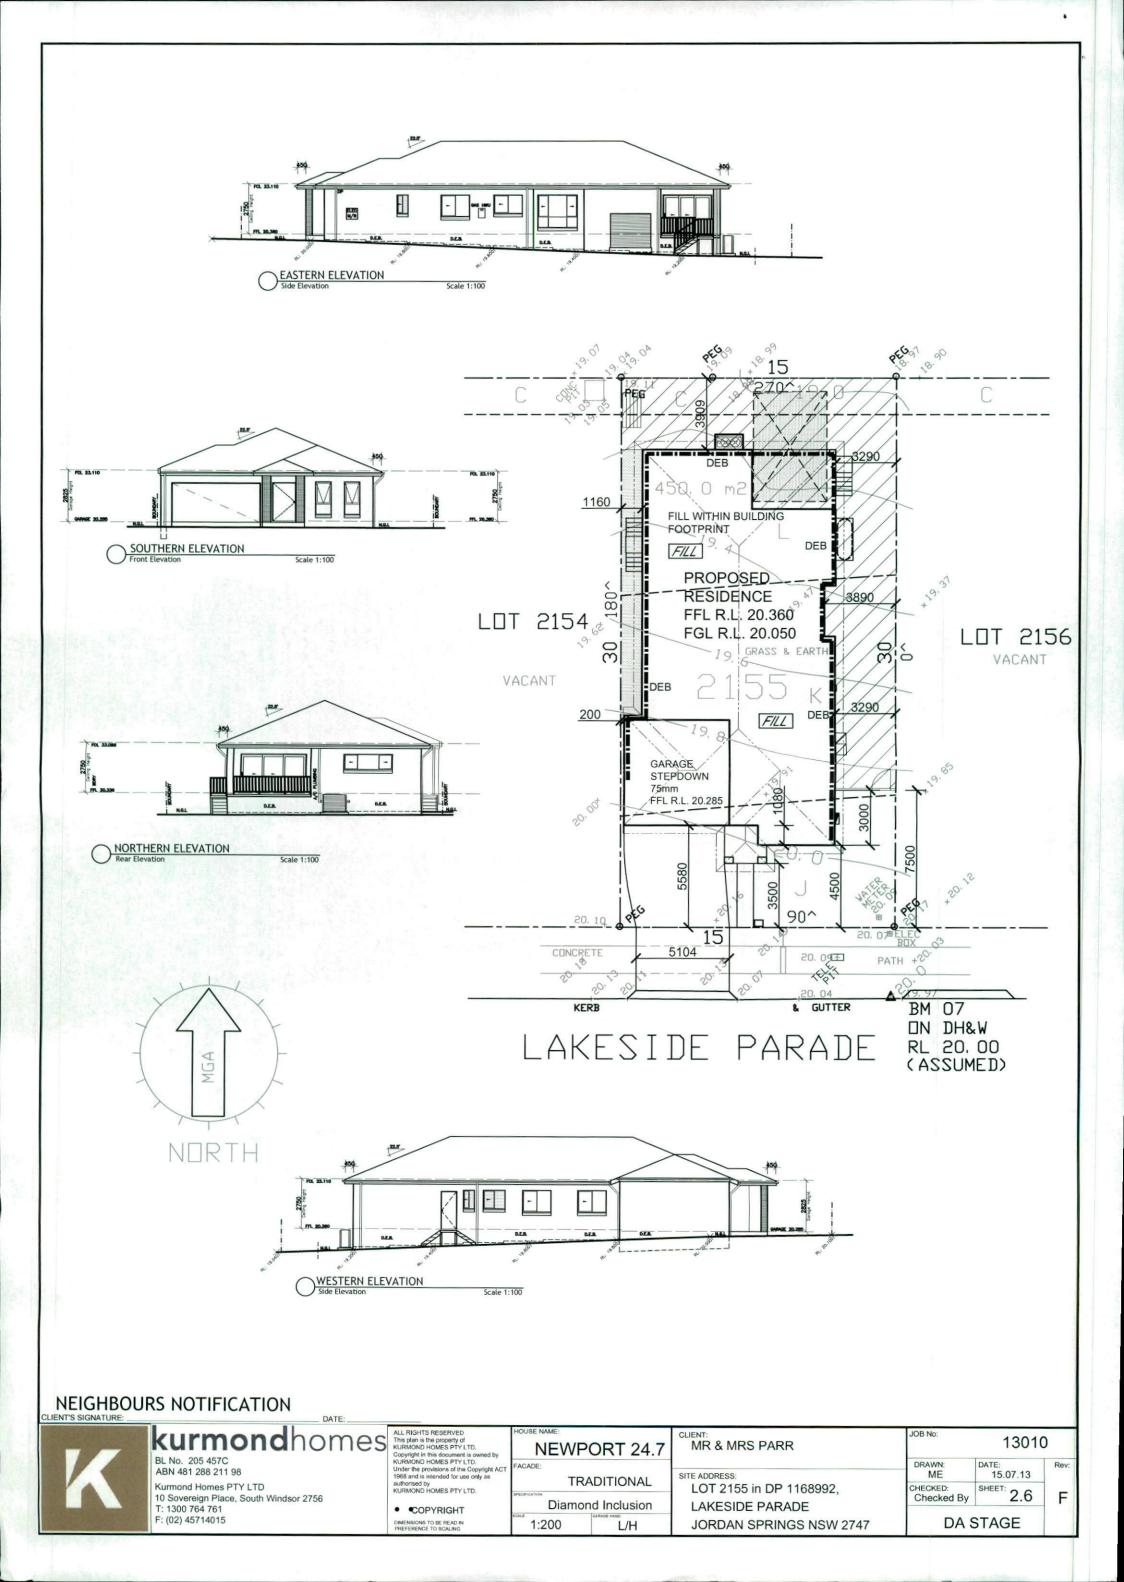
	HOUSE NAME:	
by	<b>NEWPORT 24</b>	1.
ACT	ACADE:	
	TRADITIONAL	
	Diamond Inclusion	
ACT	TRADITIONAL	

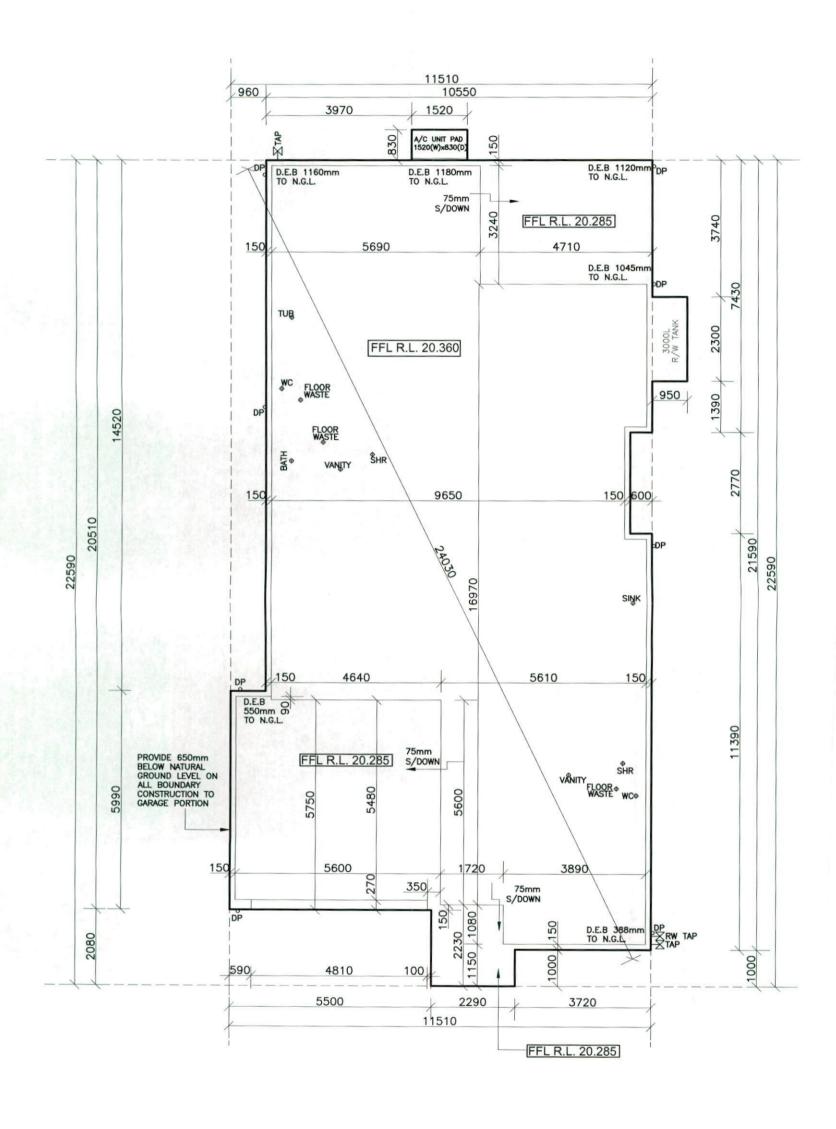
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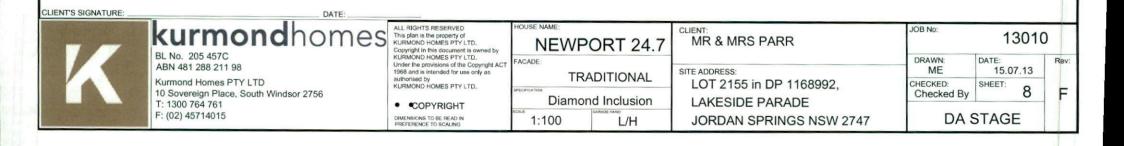
MR & MRS PARR SITE ADDRESS: LOT 2155 in DP 1168992. LAKESIDE PARADE **JORDAN SPRINGS NSW 2747** 

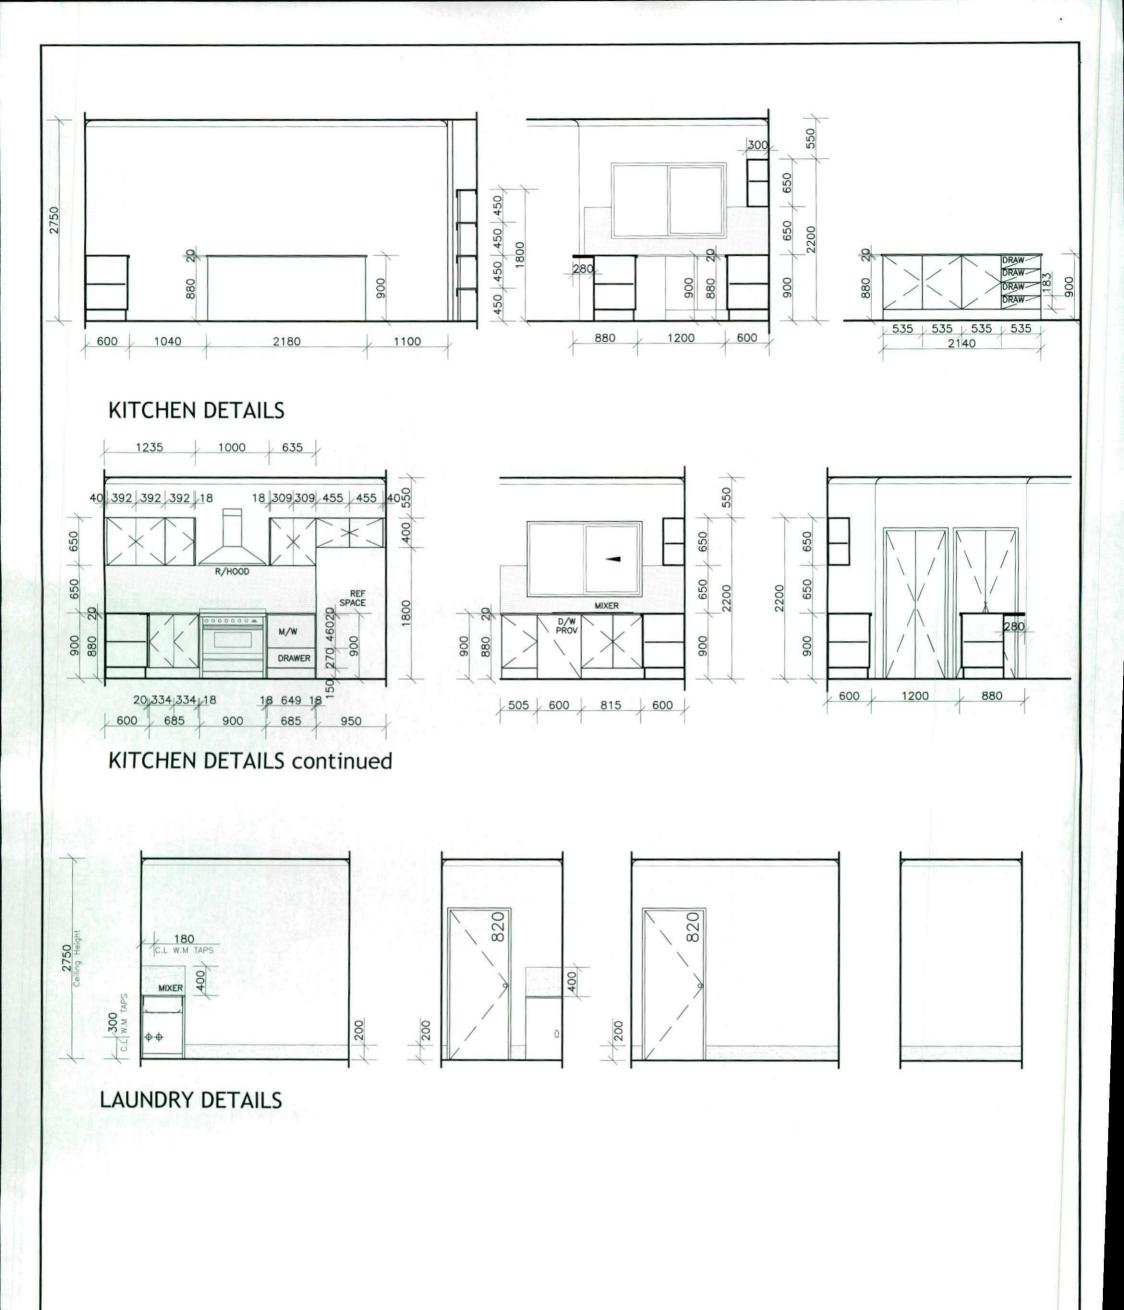
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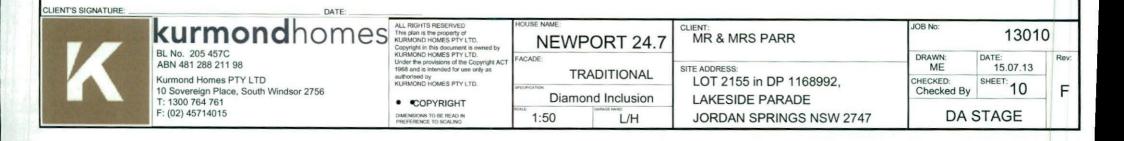


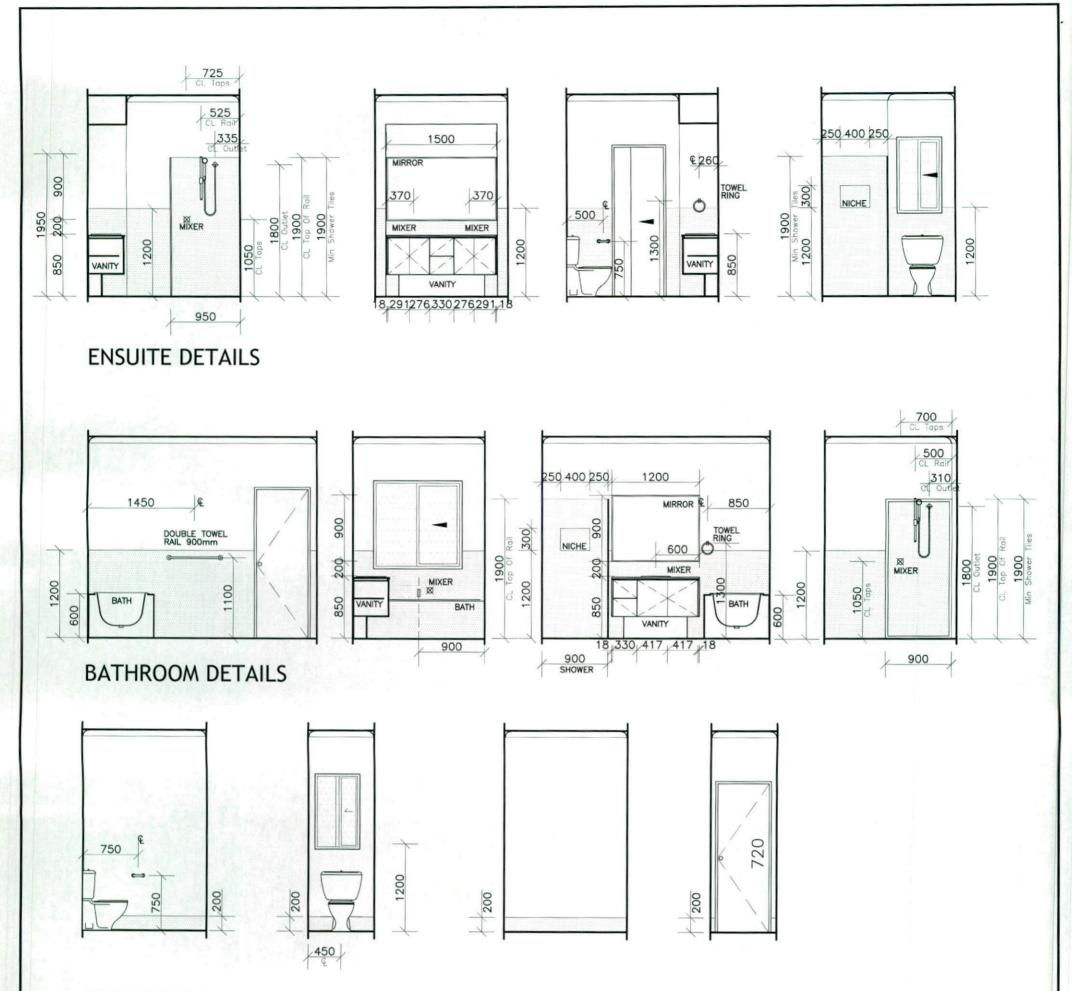


**SLAB PLAN** 









WC DETAILS



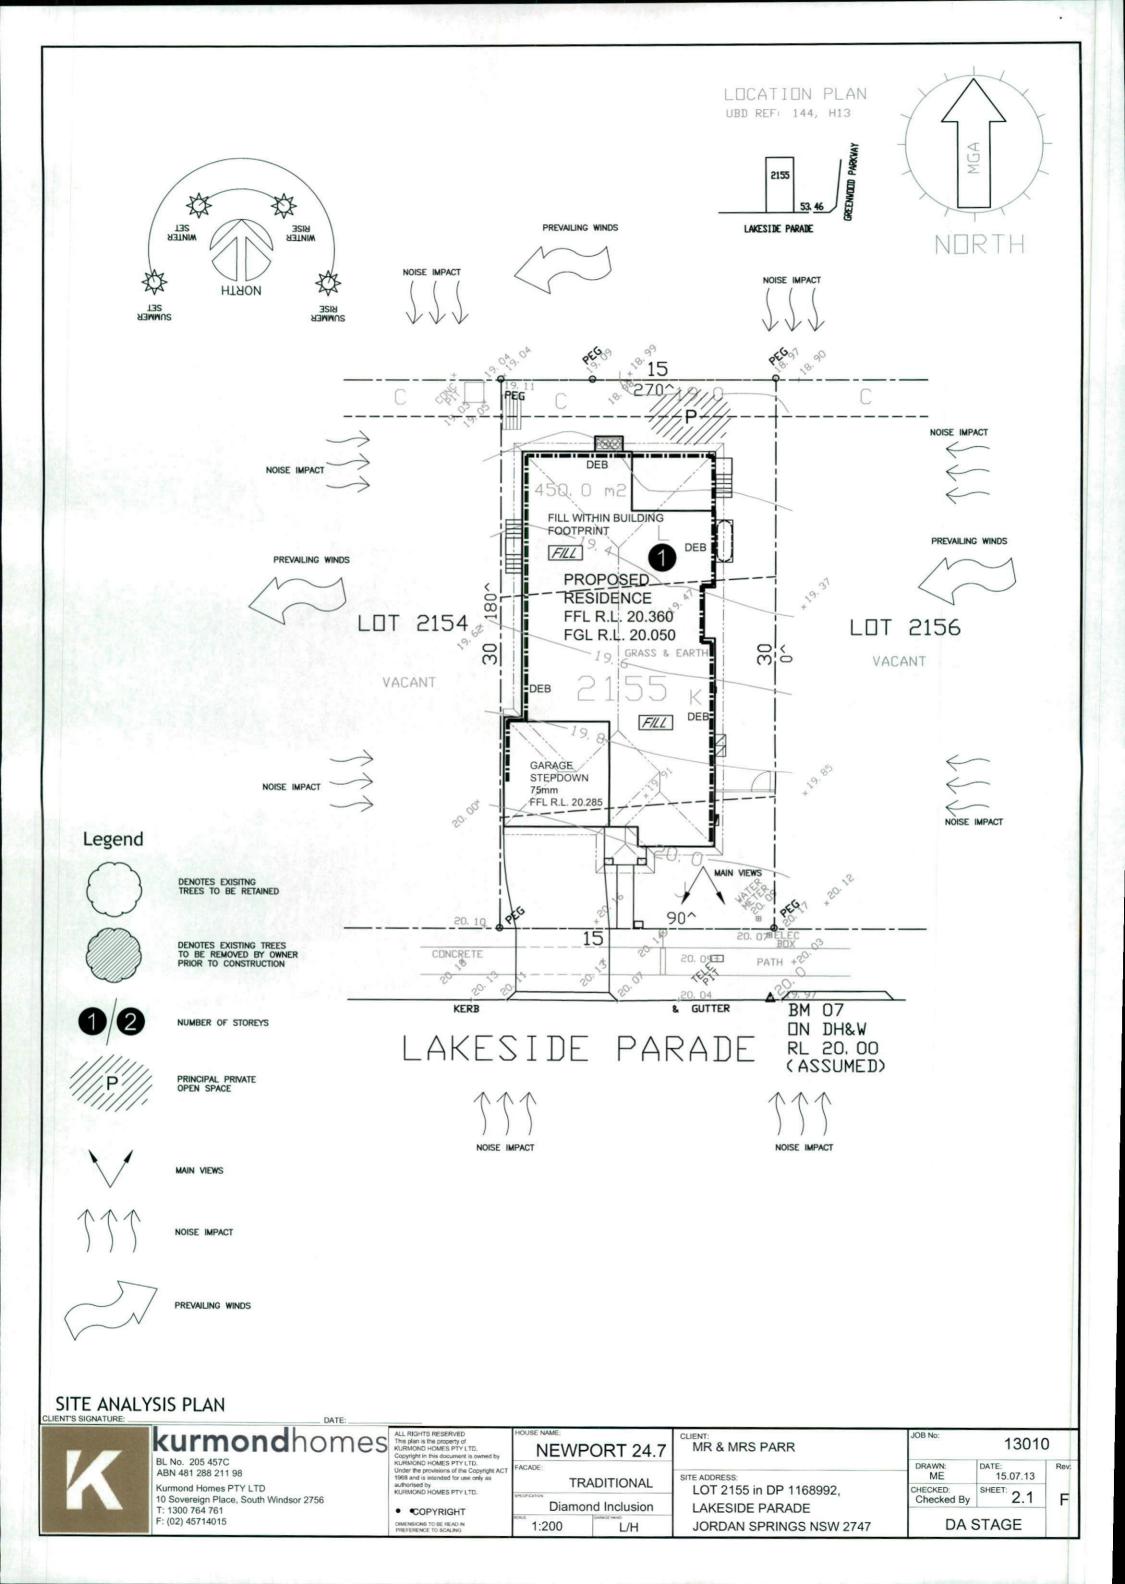
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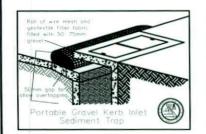
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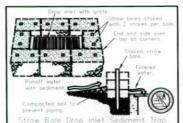
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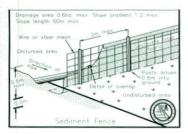
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	NEW	<b>PORT 24.7</b>
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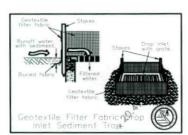
CLIENT: MR & MRS PARR	JOB No: 13010		
SITE ADDRESS:	DRAWN: ME	DATE: 15.07.13	Rev:
LOT 2155 in DP 1168992,	CHECKED: Checked By	SHEET: 11	F
LAKESIDE PARADE JORDAN SPRINGS NSW 2747	DA STAGE		

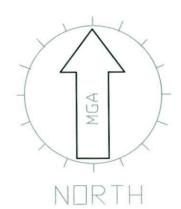


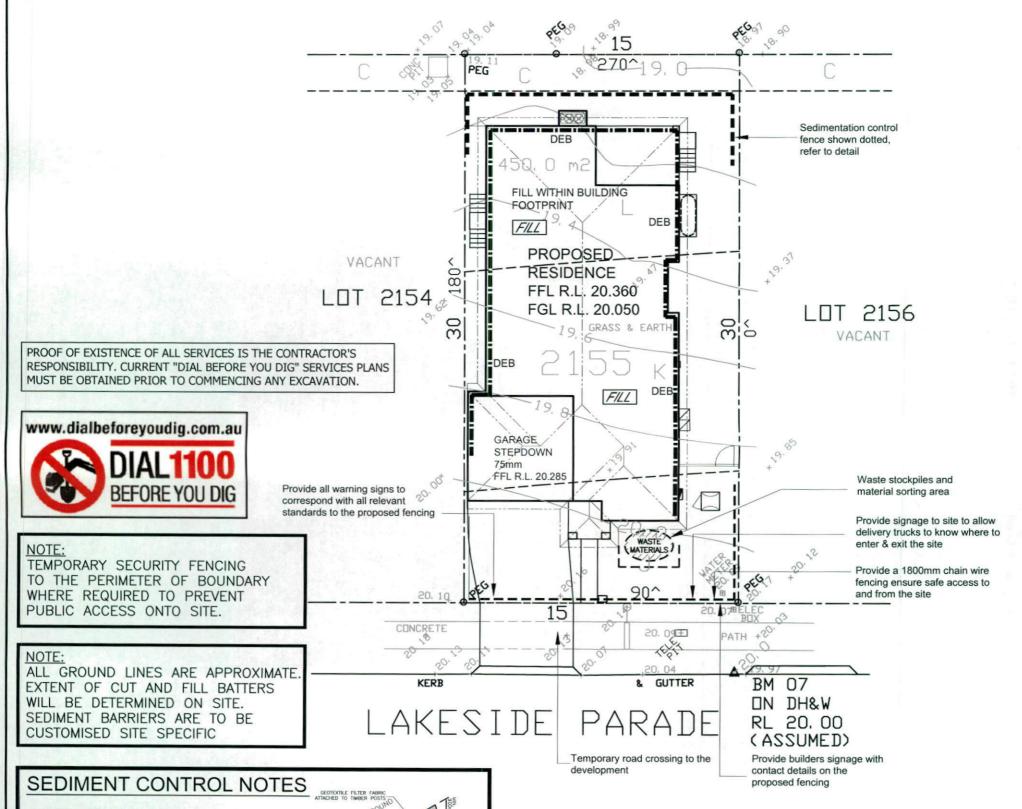












1. ALL EROSION AND SEDIMENTATION CONTROL MEASURES, INCLUDING REVEGETATION AND STORAGE OF SOIL AND TOPSOIL, SHALL BE IMPLEMENTED TO THE STANDARDS OF THE SOIL CONSERVATION OF NSW AND INSPECTED DAILY BY THE SITE MANAGER.

2. ALL DRAINAGE WORKS SHALL BE CONSTRUCTED AND STABILIZED AS EARLY AS POSSIBLE DURING DEVELOPMENT.

3. SEDIMENT TRAPS SHALL BE CONSTRUCTED AROUND ALL INLET PITS, CONSISTING OF 300mm WIDE x 300mm DEEP TRENCH.

ALL SEDIMENT BASINS AND TRAPS SHALL BE CLEANED WHEN THE STRUCTURES ARE A MAXIMUM OF 60% FULL OF SOIL MATERIALS, INCLUDING THE MAINTENANCE PERIOD.

SEDIMENT FENCE NOT TO SCALE

5. ALL DISTURBED AREAS SHALL BE REVEGITATED AS SOON AS THE RELEVANT WORKS ARE COMPLETED.

SOIL AND TOPSOIL STOCKPILES SHALL BE LOCATED AWAY FROM DRAINAGE LINES AND AREA WHERE WATER MAY CONCENTRATE. ALL ROADS AND FOOTPATHS TO BE SWEPT DAILY.

7. FILTER SHALL BE CONSTRUCTED BY STRETCHING A FILTER FABRIC (PROPEX OR APPROVED EQUIVALENT BETWEEN POST AT 3.0m CENTRES. FABRIC SHALL BE BURIED 150mm ALONG ITS LOWER EDGE.

8. DUST PREVENTION MEASURES TO BE MAINTAINED AT ALL TIMES.

C: EASEMENT TO DRAIN WATER 2 WIDE

RESTRICTION ON THE USE OF LAND

K: RESTRICTION ON THE USE OF LAND

J: RESTRICTION ON THE USE OF LAND

### SITE INDUCTION

Before entering site please review and make yourself familiar with Emergency Contacts. Site Specific Hazards and the Site Specific Induction information that is located on the Site Induction Sign. If you have any trouble understanding this instruction, contact the Site Supervisor or Emergency Contact Number located on the

SITE SPECIFIC HAZARDS FOOTPATH / PEDESTRIAN TRAFFIC

CONSTRUCTION MANAGEMENT PLAN **EROSION & SEDIMENT CONTROL PLAN** 



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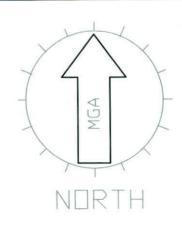
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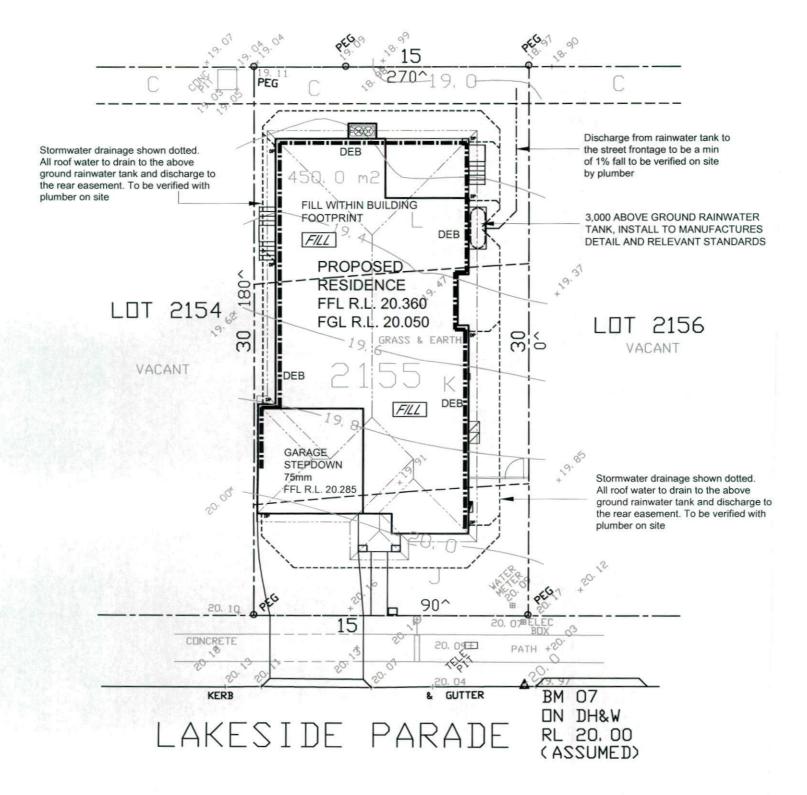
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# STORMWATER TO REAR EASEMENT VIA RAINWATER TANK

PROOF OF EXISTENCE OF ALL SERVICES IS THE CONTRACTOR'S RESPONSIBILITY. CURRENT "DIAL BEFORE YOU DIG" SERVICES PLANS MUST BE OBTAINED PRIOR TO COMMENCING ANY EXCAVATION.

- C: EASEMENT TO DRAIN WATER 2 WIDE
- RESTRICTION ON THE USE OF LAND K: RESTRICTION ON THE USE OF LAND
- J: RESTRICTION ON THE USE OF LAND

# www.dialbeforeyoudig.com.au **BEFORE YOU DIG**

## CONCEPT STORMWATER MANAGEMENT PLAN

10 Sovereign Place, South Windsor 2756

**kurmond**homes

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MR & MRS PARR

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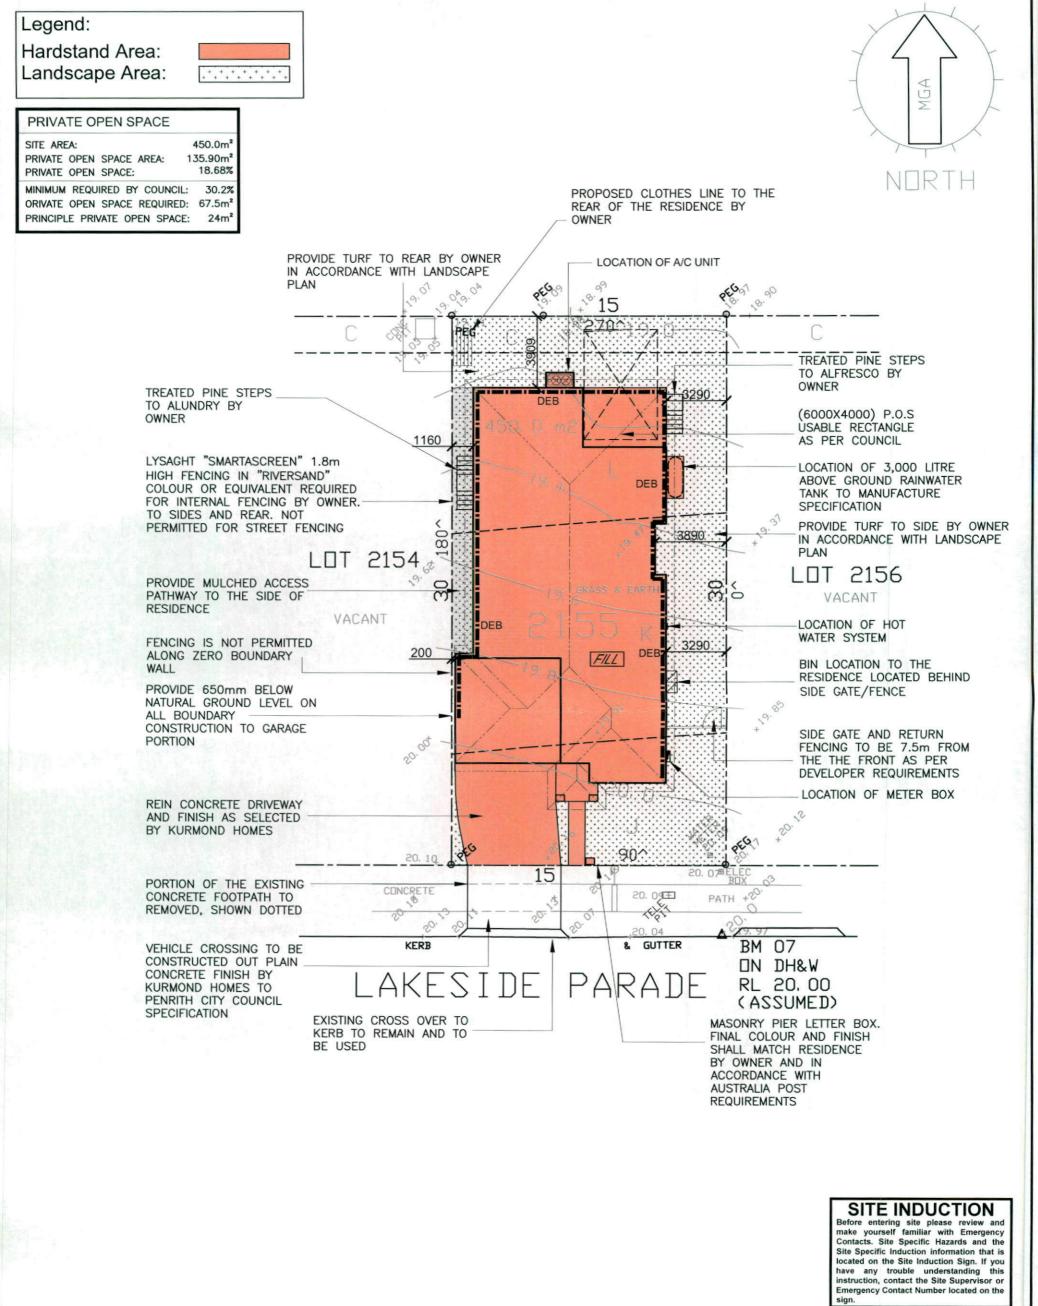
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SITE INDUCTION

SITE SPECIFIC HAZARDS

FOOTPATH / PEDESTRIAN TRAFFIC





### SITE COVERAGE PLAN

SITE SPECIFIC HAZARDS
FOOTPATH / PEDESTRIAN TRAFFIC

K

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JORDAN SPRINGS NSW 2747

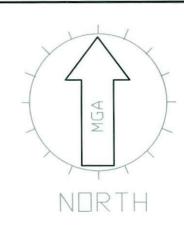
MR & MRS PARR

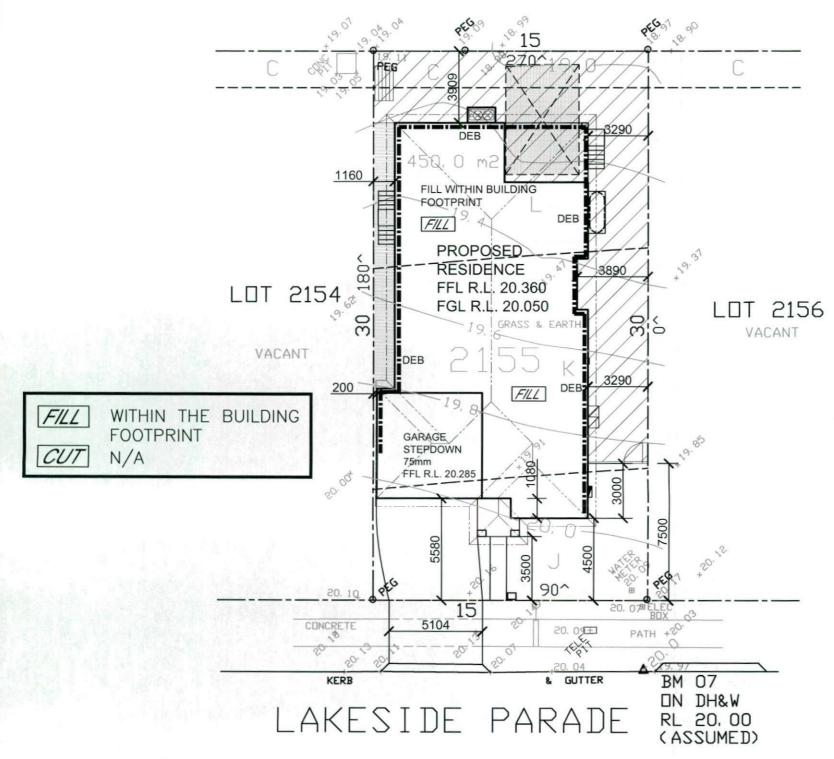
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www.dialbeforeyoudig.com.au **BEFORE YOU DIG** 

**CUT & FILL PLAN** 

- C: EASEMENT TO DRAIN WATER 2 WIDE
- RESTRICTION ON THE USE OF LAND
- K: RESTRICTION ON THE USE OF LAND
- J: RESTRICTION ON THE USE OF LAND

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