### **OUTLINE LANDSCAPE SPECIFICATION**

Preparation by Builder: Builder shall remove all existing concrete pathways, fences, footings, walls etc. not notated to be retained and complete all necessary excavation work prior to commencement on site by Landscape Contractor (Contractor). Builder shall also install new retaining walls, kerbs, layback kerb, crossover, pathways etc. and make good all existing kerbs, gutters etc. as necessary and to approval of Council. Builder shall ensure that a minimum 450mm of topsoil in garden areas and a minimum 150mm of topsoil in lawn areas exists. Should required depths not exist Builder shall contact Landscape Architect and ask for instructions prior to completion of excavation works. Excavate as necessary, then fill with approved site topsoil to allow for minimum 500mm soil depth in garden areas and 150mm soil depth in garden areas area

levels & surface drainage shall be determined by others & approved on site by Head Contractor. Note: Approved imported topsoil mix may be utilised if there is insufficient site topsoil available. State in Tender a m3 rate for additional imported topsoil

and the quantities of both site topsoil and imported topsoil allowed for in Tender.

Initial Preparation: Verify all dimensions & levels on site prior to commencement. Do not scale from drawings. Locate all underground & above ground services & ensure no damage occurs to them throughout contract. Spray approved weedicide to all proposed lawn & garden areas to manufacturer's directions. Remove existing concrete pathways, footings, walls etc. not notated to be retained & weeds from site. Levels indicated on Plan are nominal only and are derived from Architectural Plans & Drawings by others. Final structural integrity of all items shall be the sole responsibility of Landscape Contractor.

Tree Protection: Trees to be retained shall be protected during site works and construction by the erection of Solid barricades to the specification of Council. Storage of machinery or materials beneath canopy of trees to be retained shall not be permitted. Changes to soil level and cultivation of soil beneath canopy of trees to be retained shall not be permitted unless under direct supervision of Landscape Architect. Existing trees shall be pruned to Landscape Architects onsite instructions. Soil Preparation: Cultivate to depth of 300mm all proposed lawn & garden areas incorporating minimum 100mm depth of organic clay breaker into existing site soil. Do not cultivate beneath existing trees to be retained. In areas where fill is required gain required shapes & levels using a premium grade soil mix. In areas where excavation is required to to allow for installation of 500mm depth of premium grade topsoil mix to garden areas and 300mm depth of premium grade topsoil mix to lawn areas. Undertake all required action to ensure that no rootballs of proposed plants sit in clay wells and that all garden areas and lawn areas drain satisfactorily. Note it is intended that wherever possible existing levels shall not be altered through garden and lawn areas. It is the Contractors responsibility to ensure that the end result of the project is that all lawn and garden areas drain sufficiently (both surface & subsurface), are at required finished levels and have sufficient soil depths to enable lawn and plants to thrive and grow. Should alternative works to those specified be required to achieve the above result, Contractor shall inform Builder at time of Tender and request instructions.

Lawn Edging and Stepping Stones:(i) 125 x 25mm approved tanalith impregnated pine edging shall be installed, to lines as indicated on plan and staked with approved stakes at maximum 1500mm centres at ends and changes of direction; stakes shall be nailed to edging with approved galvanised steel nails. Top of edging shall finish flush with surrounding surfaces. Top of edging. (ii) Contractor shall install approved bricks on edge on a minimum 100mm deep x 90mm wide concrete footing with brick tor set in, to lines nominated on plan as brick edging. Bricks shall be laid with a nominal 10mm wide approved coloured mortar joint. Bricks needing to be cut shall be done so with clean sharp cuts. Top of edging shall finish flush with surrounding finished surfaces. Approved sandstone stepping stones shall be positioned as indicated on plan on a

Retaining Walls: Positions, detail and heights of retaining walls shall be by others.

Planting: Purchase plants from an approved nursery. Plants to be healthy & true to type & species. Set out plants to positions indicated on plan. Following approval, plant holes shall be dug approximately twice width and to 100mm deeper than plant rootballs that they are to receive. Base and sides of hole shall be further loosened. Fertiliser, followed by 100mm depth of topsoil mix shall then be placed into base of hole and lightly consolidated. Base of hole shall then be watered. Remove plant container and install plant into hole. Rootball shall be backfilled with surrounding topsoil and topsoil firmed into place. An approved shallow dish shall be formed to contain water around base of stem. Base of stem of plant shall finish flush with finished soil level. Once installed plant shall be thoroughly watered and maintained for the duration of the Contract.

Staking: All trees shall be staked using 2 x 38mm x 38mm x 2000mm long hardwood stakes per plant and with hessian webbing ties installed to Landscape Architect's on site instructions.

Mulching: Install 75mm depth of 25mm diameter hardwood mulch to all garden areas, coving mulch down around all plant stems & to finish flush with adjacent surfaces.

Turfing: Prepare for, level & lay cultivated Palmetto Buffulo turves to all areas nominated on plan as being lawn, Roll, water, fertilise, mow & maintain lawns as necessary until completion of maintenance period. At same time make good all existing lawn areas using same lawn type. Lawns in shade shall be over sown with an approved seed mix. Allow to retrim and returf councils nature strip as required.

Fencing: Retain all existing fences unless advised otherwise by builder. Install timber paling fences to heights indicated on Plan.

Paving: Areas to be paved shall be excavated or filled to allow for installation of bedding materials. Levels and falls shall be as per Plan. Surface drainage on paving shall be towards grated drains with all drains connected to stormwater system and installed by Builder.

Irrigation: Contractor shall supply and install an approved fully automatic, vandal resistant, computerised irrigation system to all garden and lawn areas, excluding council nature strip. Entire system shall be to approval of Water Board and shall utilise pop-up sprinklers and electronic controllers. Contractor shall be responsible to ensure that system is able to satisfactorily operate on available water pressure. Power supply for use by irrigation system shall be provided to an approved location near southwest corner of residence by others and shall consist of an approved weatherproof G.P.O. The irrigation system controller shall be housed in an approved waterproof cabinet mounted to external wall of residence.

Clotheslines: Contractor shall allow for all necessary labour and materials and shall install clotheslines to positions as indicated on plan to manufacturer's instructions to approval of Landscape Architect. Clothesline type shall be equal to 'Hills Foldaline

Completion: Prior to practical completion remove from site all unwanted debris occurring from work. Satisfy Council that all landscaping work has been undertaken in strict accordance with Councils landscape codes & guidelines.

Maintenance Period: A twelve month maintenance period shall be undertaken by owner or owners representative as set out herein. Owner shall have care and maintenance of all work specified under this Contract and shall rectify any defective work for a period of 52 weeks following Practical Completion of Landscape Works. This period shall be herein known as the Maintenance Period. Work shall also include for the care and maintenance of all existing vegetation to be retained and proposed vegetation. Site shall be attended at least weekly and as otherwise required. The following works shall be undertaken during the Maintenance Period.

- (a) Recurrent works Undertake recurrent works throughout the Maintenance Period. These works shall include but are not limited to watering, weeding, fertilising, pest and disease control, returfing, staking and tying, replanting, cultivation, pruning, aerating, renovating, top dressing and the like.
- (b) Watering Regularly water all plants and lawn areas to maintain optimal growing conditions. Contractor shall adjust the water quantity utilised with regard to climatic conditions prevalent at the time.
- (c) Replacements Immediately replace plants which die or fail to thrive (at discretion of Landscape Architect) with plants of same size and quality unless otherwise specified. Plant replacement shall be at Contractors expense, unless replacement is required due to vandalism or theft, which shall be determined by Landscape Architect. Required replacement of plants due to vandalism or theft shall be undertaken by Contractor and shall be paid for by Client at an agreed predetermined rate.
- (d) Mulched surfaces Maintain mulched surfaces in clean, tidy, weed-free condition and shall reinstate mulch as necessary to maintain specified depths.
- Stakes & ties Adjust and/or replace stakes and ties as required. Remove stakes and ties at end of Maintenance Period if directed by Landscape Architect.
- (f) Lawn areas Lawn areas shall be mown at regular intervals to ensure non heading of lawn with a fine-cutting mulching mower and clippings left on lawn to mulch and self-fertilise lawn areas. Primary cut after laying of lawn by others shall be determined on site taking into consideration season, watering and growth rate of lawn. Following the primary cut all lawns shall be regularly mown as required to ensure a healthy lawn and a neat appearance. Care shall always be taken to ensure that no clippings are left on surrounding roads or garden areas after mowing. Replace lawn areas that fail to thrive at discretion of Landscape Architect. All new and made good lawn areas shall be barricaded off from pedestrian traffic by use of star pickets and brightly coloured plastic safety mesh until establishment of lawn. Barricades shall be removed upon establishment of lawn area.
- (g) Weeding Remove by hand, or by carefully supervised use of weedicide, any weed growth that may occur throughout Maintenance Period. This work shall be executed at weekly intervals so that all lawn and garden areas may be observed in a weed-free condition.
- (h) Pruning Prune new and existing plants (excluding existing trees) as necessary to maintain dense foliage conditions. Any rogue branches overhanging or obstructing pathways, roads, doorways, etc., shall be removed by approved horticultural methods.
- (i) Spraying Spraying for insect, fungal and disease attack shall be undertaken as required and in accordance with spray manufacturers recommendations at intervals taking into account the season of year during which landscape works are to be
- (i) Tree Care Should any existing trees be damaged during construction works immediately engage an experienced arboriculturist and then undertake any rectification work recommended by arboriculturist.

- . All dimensions and levels shall be verified by Contractor
- on site prior to commencement of work.

  All detailing of drainage to paved areas shall be by others.

  I. All levels shall be determined by others and approved on
- site by client.

  4. Extent, height and position of all retaining warks shall be detarmined by others and approved on site by client.

  5. Do not scale from drawings.

  6. If in doubt contact the Landscape Architect.


  7. All boundaries shall be surveyed prior to commencement.


- of construction works.


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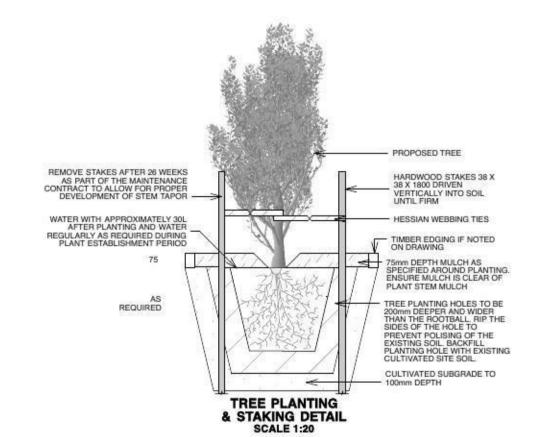





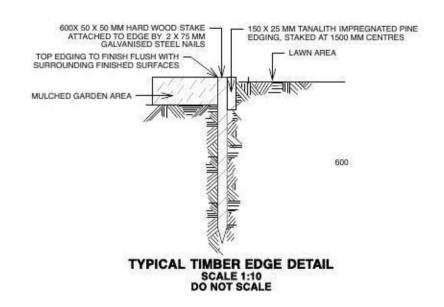


1. All dimensions and levels shall be verified by Contractor on site prior to commencement of work.
2. All detailing of drainage to praved areas shall be by others.
3. All levels shall be determined by others and approved on site by client.
4. Extent, height and position of all retaining walls shall be determined by others and approved on site by client.
5. Do not scale from drawings.
6. If in doubt contact the Landscape Architect.
7. All boundaries shall be surveyed prior to commencement of construction works.
8. This plan is for DA purposes only. It has not been detailed for construction.
9. All dimensions, levels and boundaries are nominal only.
10. This design shall not be copied, utilised or reproduced in any way without prior written permission of A Total Concept Landscape Architects.

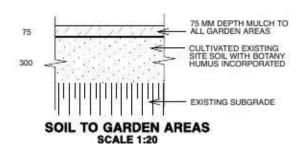
1. All dimensions and levels shall be verified by Contractor

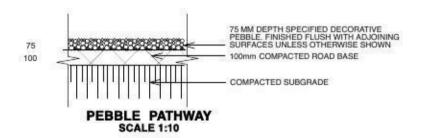

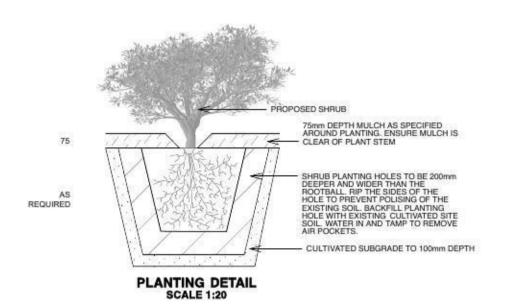

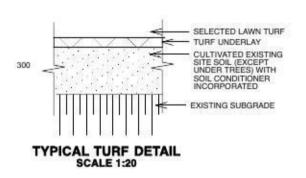

DATE		REVISION				
DRAWING	LANDSCA	PE DETAILS				
ADDRES:	LOT 2089 AL	INTA PROMENADE, JOF	RDAN SP	RINGS	PROJECT # Kurmond	
CLIENT	MD MADY	NAMILLEDI	DATE#	02/08/13	DWG#	
	MR MARK	AMILLERI	SCALE @ A	as shown	L/02	
A Total Concept Landscape Architects & JS					L/UZ	
	Swimming Pool Designers				REVISION	
65 W	est Street, North Sy 02) 9957 5122 Fx: (	dnev NSW 2060	atc	rcept ledi & winnings	sool designers	

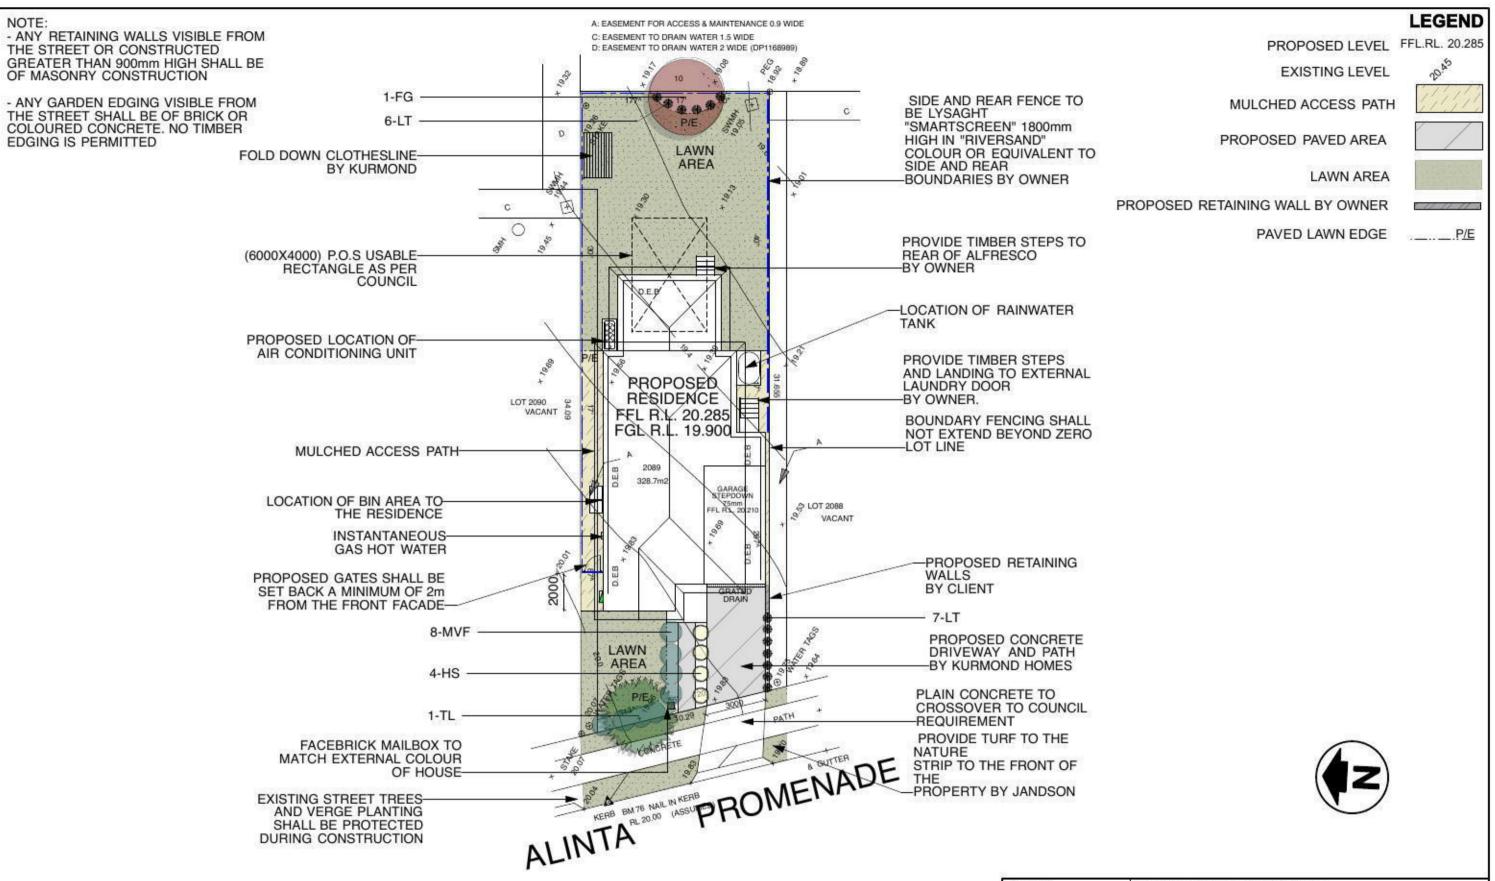

- Notes:

  1. All dimensions and levels shall be verified by Contractor on site prior to commencement of work.

  2. All detailing of drainage to paved areas shall be by others.

  3. All levels shall be determined by others and approved on each by different.
- site by client.

  Extent, height and position of all retaining walls shall be determined by others and approved on site by client, to Structural Engineers detail.


  5. Do not scale from drawings.
- If in doubt contact the Landscape Architect
- All boundaries shall be surveyed prior to commencement
- of construction works.

  This plan is for DA purposes only. It has not been detailed
- All dimensions, levels and boundaries are nominal only. This design shall not be copied, utilised or reproduced in any way without prior written permission of A Total Concept

### PLANTING SCHEDULE

ID	Latin Name	Common Name	Quantity	Scheduled Size	Spread	Height
FG	Fraxinus 'Raywood'	Claret Ash	1	45lt	4000	5000
HS	Hibbertia scandens	Climbing Guinea Flower	4	tube	1000	350
LT	Lomandra 'Tanika'	Dwarf Lomandra	13	5lt	500	500
MVF	Metrosideros 'Fiji'	NZ Xmas Bush 'Fiji'	8	15lt	1200	1200
TL	Tristianiopsis laurina	Water Gum	1	25lt	4000	7000

DATE: 16/0	99/13 REVISION W Amendments made as per de	veloper requirem	nents		
DRAWING	PROPOSED LANDSCAPE	PLA	N.		
ADDRESS	LOT 2089 ALINTA PROMENADE	, JORD	AN SPE	RINGS	PROJECT # Kurmono
CLIENT	MR MARK CAMILLERI		DATE#	02/08/13	DWG#
	MK MAKK CAMILLERI		SCALE @ A3	1:200	L/01
A To	otal Concept Landscape Architec	e 2	DRAWN	JS	ŭ
	nming Pool Designers		CHKD	SW	REVISION A
65 We	est Street, North Sydney NSW 2060 2) 9957 5122 Fx: (02) 9957 5922		atc	epl	ool designers

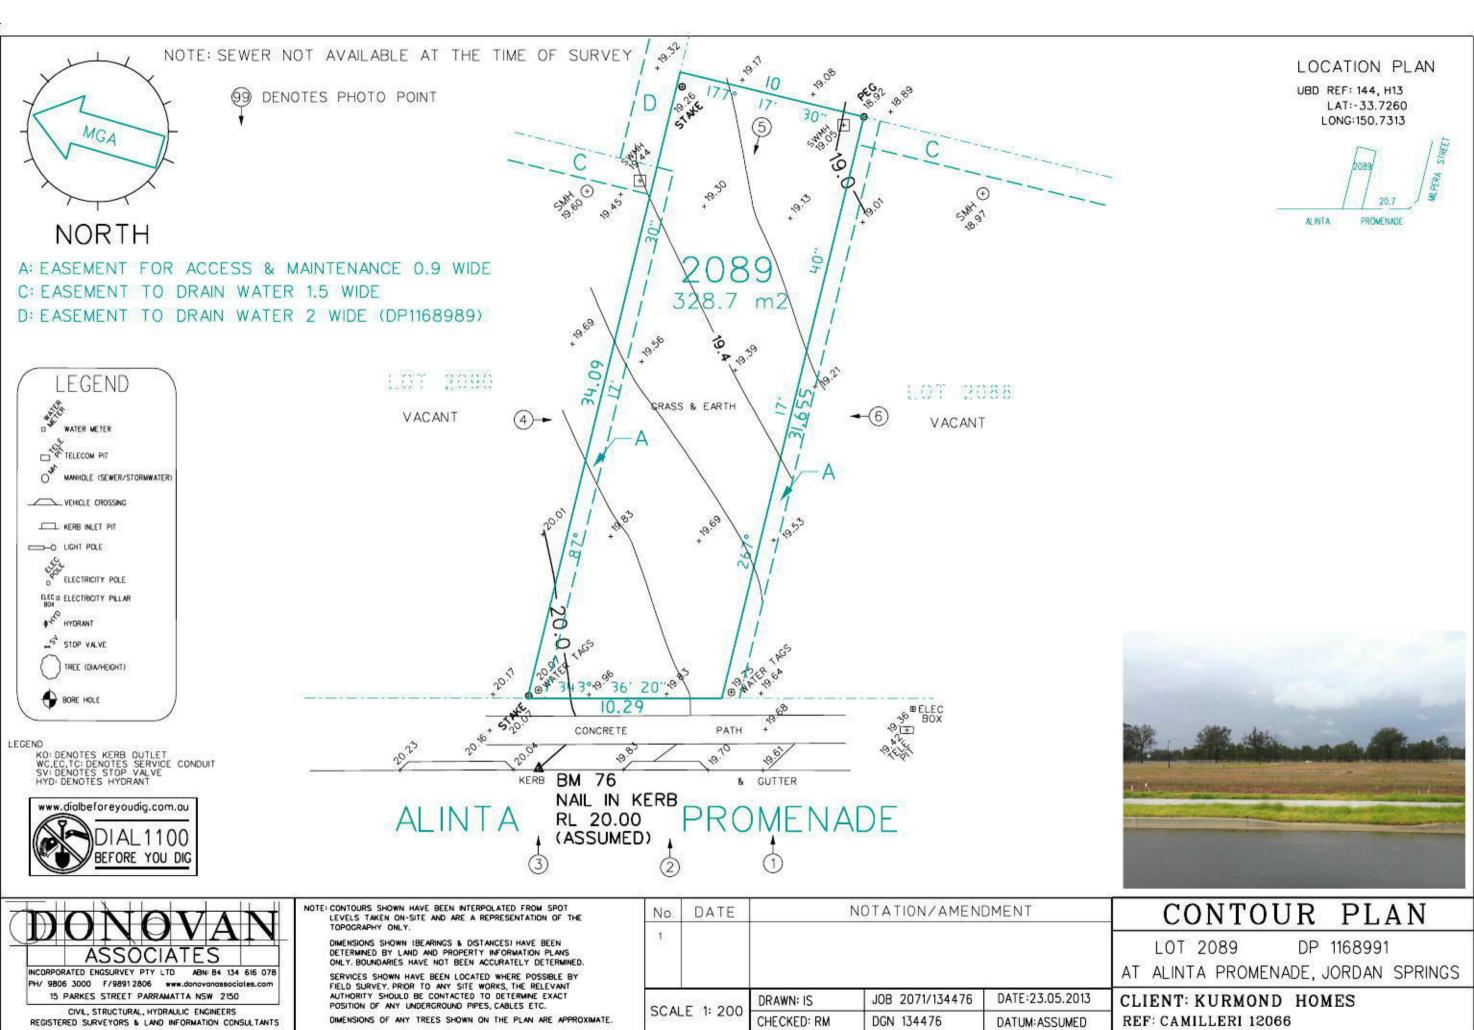



### Schedule of BASIX commitments

Floor, walls and ceiling/roof

The commitments set out below segulate how the proposed development is to be carried out. It is a condition of any development consent granted, or complying development certificate issued, for the proposed development, that BASIX commitments be complied with.

Water Commitments	Show on DA plans	Show on CC/CDC plans & specs	Certifier
Fixtures	101//		
The applicant must install showerheads with a minimum rating of 3 star (= 7.5 but == 9 Limin) in all showers in the development.	fill i	1	1
The applicant must install a tollet flushing system with a minimum rating of 4 star in each tollet in the development.		1	1
The applicant must install taps with a minimum rating of 3 star in the kitchen in the development.		1	
The applicant must install basin taps with a minimum rating of 3 star in each bathroom in the development.	J. J.	1	
Alternative water			
Rainwater tank			
The applicant must install a rainwater tank of at least 3000 litres on the site. This rainwater tank must meet, and be installed in	1	1	1

Thermal Comfort Commitments	Show on	Show on CC/CDC	Certifier
<ul> <li>at least one outdoor top in the development (Note: NSW Health does not recommend that rainwater be used for human consumption in areas with portable water supply.)</li> </ul>		1	1
the cold water tap that supplies each clothes washer in the development		1	1
all tolets in the development		1	1
The applicant must connect the nameater tank to:	717	0	1
The applicant must configure the rainwater tank to collect rain runoff from at least 156.18 square metres of the roof area of the development (excluding the area of the roof which drains to any stormwater tank or private dam).		1	1
The applicant must install a rainwater tank of at least 3000 litres on the site. This rainwater tank must meet, and be installed in accordance with, the requirements of all applicable regulatory authorities.	1	1	1
Rainwater tank		400	
Alternative water			
The applicant must install basin taps with a minimum rating of 3 star in each bathroom in the development.		1	
The applicant must install taps with a minimum rating of 3 star in the kitchen in the development.		1	

Construction	Additional insulation required (R Value)	Other specifications
toor - concrete slab on ground	ril	
oor - suspended floor above garage, framed	0.3 (or 1 including construction) (down)	
xternal wait - brick veneer	1.66 (or 2.20 including construction)	됐다.
rternal wall shared with garage - plasferboard	ril	
seiling and roof - flat ceiling / pitched roof	ceiling: 3 (up), roof: foil/sarking	unventilated; dark (solar absorptance > 0.70)

Note Insulation specified in this Certificate must be installed in accordance with Part 3.12.1.1 of the Building Code of Australia

The applicant must construct the floor(s), walls, and ceiling/roof of the dwelling in accordance with the specifications listed in the table below.

Thermal Comfort Commitments	Show on DA plans	Show on CC/CDC plans & specs	Certifier
Windows, glazed doors and skylights			
The applicant must install the windows, glazed doors and shading devices described in the table below, in accordance with the specifications listed in the table. Relevant overshadowing specifications must be satisfied for each window and glazed door.	1	1	1
The dwelling may have 1 skylight (<0.7 square metres) and up to 2 windows/glazed doors (<0.7 square metres) which are not listed in the fable.	1	1	1
The following requirements must also be satisfied in relation to each window and glazed door:	1	1	1
<ul> <li>Except where the glass is "single clear" or "single toned", each window and glazed door must have a U-value no greater than that lated and a Solar Heat Gain Coefficient (SHGC) +-10% of that lated. Total system U-values and SHGC must be calculated in accordance with National Penestration Rating Council (NFRC) conditions.</li> </ul>			1
<ul> <li>The leading edge of each eave, pergeta, verandah, balcony or awning must be no more than 500 millimetres above the head of the window or glazed door, except that a projection greater than 500 mm and up to \$500 mm above the head must be beine the value in the table.</li> </ul>	1	1	1
<ul> <li>Pergolas with polycarbonate roof or similar translucent material must have a shading coefficient of less than 0.35.</li> </ul>		1	1
<ul> <li>Unless they have adjustable shading, pergolar must have fixed tratters parallel to the window or glazed door above which they are shusted, unless the pergola also shades a perpendicular window. The spacing between batters must not be more than \$0 mm.</li> </ul>		1	1

	No. of Concession, Name of Street, or other Designation, Name of Street, Name		-		
Windowiglazed door no.	Orientation	Maximum area (square metres)	Туре	Shading	Overshadowing
W1	w	3.26	standard aluminium, single pyrolytic low-e (U-value S.7, SHGC:0.47)	none	not overshadowed
W2	9	2.18	standard aluminium, single clear (or U-value:7.63, SHGC-0.75)	none	not overshadowed
W3, W4	E	7.16	standard aluminium, single clear (or U-value:7.63, SHGC:0.75)	eave/verandsh/pergola/balcony >2,000 mm	not overshadowed
W5, W6	N	4.79	standard aluminium, single pyrolytic low-e (U-value:5.7, SHGC:0.47)	none	not overshadowed
W7, W8, W9, W10	W	4.36	standard aluminium, single clear (or U-value:7.63, SHGC:0.75)	eave/verandsh/pergola/balcony 450 mm	not overshadowed
W11, W12	S	1.26	standard aluminium, single clear (or U-value:7.63, SHGC-0.75)	eave/verandsh/pergola/balcony 450 mm	not overshadowed
Windowiglazed door no.	Orientation	Maximum area (square metres)	Туре	Shading	Overshadowing
W13, W14	E	2.9	standard aluminium, single clear (or U-value:7.63, SHGC:0.75)	eave/verandsh/pergola/balcony 450 mm	not overshadowed
W15	N	1,45	standard aluminium, single clear (or Uvelue 7 63 SHGC 0 75)	eave/verandah/pergola/balcony 450	not overshadowed

Energy Commitments	Show on DA plans	Show on CC/CDC plans & specs	Certifier check
Hot water			
The applicant must install the following hot water system in the development, or a system with a higher energy rating: gas instantaneous with a performance of 3 stars.		1	1
Cooling system			
The applicant must install the following cooling system, or a system with a higher energy rating, in at least 1 living area: 3-phase airconditioning. Energy rating: EER 2.5 - 3.0		1	1
The applicant must install the following cooling system, or a system with a higher energy rating, in at least 1 bedroom: 3-phase airconditioning. Energy rating: EER 2.5 - 3.0		1	1
The cooling system must provide for day/hight zoning between living areas and bedrooms.		1	1
Heating system			
The applicant must install the following heating system, or a system with a higher energy rating, in at least 1 living area: 3-phase airconditioning. Energy rating: EER 25 - 3.0		1	1
The applicant must install the following heating system, or a system with a higher energy rating, in at least 1 bedroom: 3-phase arconditioning, Energy rating: EER 2.5 - 3.0		1	1
The heating system must provide for dayinight zoning between living areas and bedrooms.		1	1
Ventilation			
The applicant must install the following exhaust systems in the development:	1		T
At least 1 Bathroom: individual fan, not ducted; Operation control: manual switch on/off		1	1
Kitchen; individual fan, ducted to façade or roof, Operation control: manual switch on/off			
		-	1
Laundry: individual fan, not ducted; Operation control: manual switch onloff		1	1
Natural lighting			
The applicant must install a window and/or skylight in the kitchen of the dwelling for natural lighting.	1	1	1
The applicant must install a window and/or skylight in 2 bathroom(syltoilet(s) in the development for natural lighting.	1	1	1
Other			
Energy Commitments	W 1010	Show on CC/CDC	Contillar

in these commitments, "applicant" means the person carrying out the development.

The applicant must install a gas cooktop & electric oven in the kitchen of the dwelling. The applicant must install a fixed outdoor clothes drying line as part of the development.

Commitments identified with a \_/ in the "Show on DA plans" column must be shown on the plans accompanying the development application for the proposed development (if a development application is to be lodged for the proposed development).

Commitments identified with a \_/ in the "Show on CC/CDC plans and specs" column must be shown in the plans and specifications accompanying the application for a construction certificate / complying development certificate for the proposed development.

Commitments identified with a \_/ in the "Certifier check" column must be certified by a certifying authority as having been fulfilled, before a final occupation certificate/either sterim or finall for the development may be issued.

REV	DATE	AMENDMENTS HOUSE NAME	BY	SHEET	DESCRIPTION  JOB No:
A	15.08.12	PRELIMINARY DRAWINGS	DJ	1	COVER SHEET
В	05.04.13	AMEND PRELIMS TO INCLUDE SITE LEVELS	EC	2	SITE PLAN
С	22.05.13	AMEND FRONT FACADE AS REQUESTED BY COLOURS	BAC	3	GROUND FLOOR PLAN
D	31.05.13	AMENDED LEVELS TO SUIT CONTOUR SURVEY	DJ	4	FIRST FLOOR PLAN
E	28.06.13	AMENDED AS PER CLIENT REQUEST	EC	5	ROOF PLAN
F	30.07.13	DA DRAWINGS	ME	6	ELEVATIONS
G	08.08.13	Deleted nibe wall and towell rail and extended shower screen to ensuite as requestred	BAC	7	ELEVATIONS
Н	16.08.13	Amended as per developer comments on approval	BAC	8	SECTION
				9	WET AREA DETAILS
9 9				10	WET AREA DETAILS
				11	SLAB PLAN
				12	DOOR SCHEDULE
3) - 3				2.1	SHADOW DIAGRAM
				2.2	CONST. WASTE & EROSION PLAN
32 (4 (6 ()				2.3	STORMWATER PLAN
				2.4	NEIGHBOURHOOD NOTIFICATION
20 03				2.5	CUT AND FILL

CLIENT'S SIGNATURE: -

DATE: -

BL No. 205 457C ABN 481 288 211 98 Kurmond Homes PTY LTD 10 Sovereign Place, South Windsor 2756 T: 1300 764 761 F: (02) 45714015

I accept and understand the plans and documents that have


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MR. MARK CAMILLERI	JOB No: 12066		
TE ADDRESS:	DRAWN: DJ	DATE: 16.08.13	Rev:
LOT 2089 DP 1168991	CHECKED:	SHEET: 1	G
NO. 32 ALINTA PROMENADE JORDAN SPRINGS, NSW 2747	DA STAGE		



ALL GROUND LINES ARE APPROXIMATE. EXTENT OF FILL & BATTER WILL BE DETERMINED ON SITE, SEDIMENT BARRIERS ARE TO BE CUSTOMISED SITE SPECIFIC

### SITE PLAN

- Bearings and distances are by Title and/or Deed only.

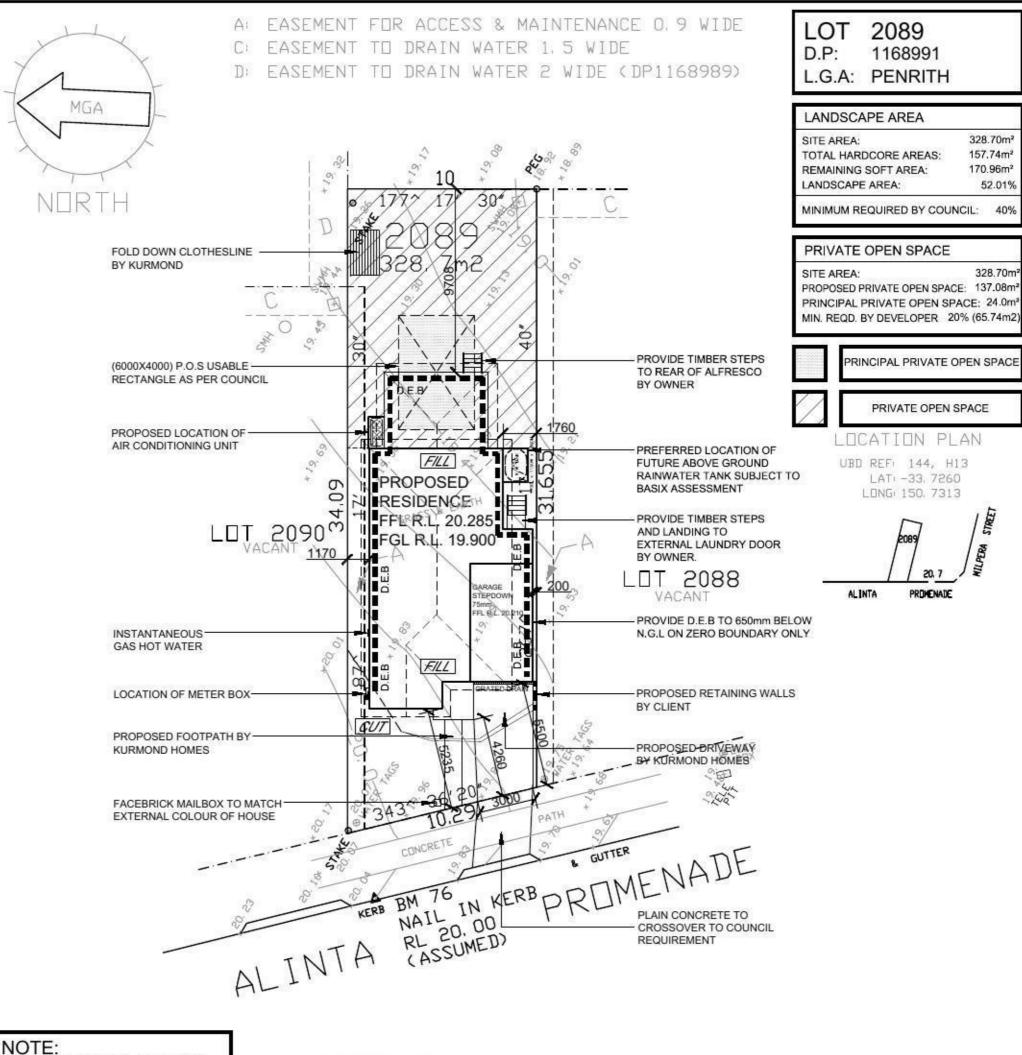  This detail survey is not a "survey" as defined by the Surveyors Act, 19 if any construction is planned it would be advisable to carry out further survey work to determine the boundary dimensions.

  Relationship of improvements to boundaries is diagrammatic only Where offsets are critical they should be confirmed by further survey.

  Conforms behave deals the proportion, except a specificies story in the proportion.

- Contours shown depict the topography, except at spot levels shown they do not represent the exact level at any particular point. Services shown hereon have been determined from visual evidence only Prior to any demolition ,excavation or construction on the site the relevant authority should be contacted to establish detailed location and de Australian Height Datum was established from SSM 168755 RL 69.056
- Tree locations are accurate to +/- 0.30m
  The information is only to be used at a scale accuracy of 1:200.

been provided to me by Kurmond Homes.

## Jordan Springs - Illoura Village Notes:

CHESE NOTES MUST BE ADDED TO YOUR SITE AND LANDSCAPE PLANS!

- ANY GARDEN OR LAWN EDGING VISIBLE FROM THE STREET IS TO BE CONSTRUCTED OF MASONRY TEXTURED OR COLOURED BRICKS, BLOCKS OR COLOURED CONCRETE - NO TIMBER EDGING IS PERMITTED.

- ANY RETAINING WALLS VISIBLE FROM THE STREET OR 900MM HIGH AND OVER ARE TO BE OF MASONRY CONSTRUCTION.

- VEHICLE CROSSOVER IS TO BE PLAN CONCRETE TO COUNCIL SPECIFICATION WIDE V.C. FOR A SINGLE GARAGE. ALL EXISTING STREET TREES AND VERGE PLANTING ARE TO BE PROTECTED DURING

### SITE INDUCTION

WIND CLASSIFICATION: " N2"

SLAB CLASSIFICATION: "H1"

Before entering site please review and make yourself familiar with Emergency Contacts. Site Specific Hazards and the Site Specific Induction information that is located on the Site Induction Sign. If you have any trouble understanding this instruction, contact the Site Supervisor or Emergency Contact Number located on the

### SITE SPECIFIC HAZARDS

- LIMITED SPACE FOR MATERIAL STOCK PILE
- FOOTPATH / PEDESTRIAN TRAFFIC
- TRAFFIC CONTROL REQUIRED DROP EDGE BEAM

# VIA RAINWATER TANK

## STORMWATER TO STREET

CLIENT'S SIGNATURE:

## kurmondhomes

DATE:

BL No. 205 457C ABN 481 288 211 98

Kurmond Homes PTY LTD 10 Sovereign Place, South Windsor 2756 T: 1300 764 761 F: (02) 45714015

I accept and understand the plans and documents that have

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NEPEAN 24 FACADE TRADITIONAL New Generation 1:200

SITE ADDRESS LOT 2089 DP 1168991 NO. 32 ALINTA PROMENADE JORDAN SPRINGS, NSW 2747


MR. MARK CAMILLERI

JOB No: 12066 DRAWN 16.08.13 DJ CHECKED SHEET G DA STAGE

LEGEND: GROUND FLOOR AREA = 43.83 m2 FIRST FLOOR AREA = 43.83 m2

156.16 m2

TOTAL ROOF AREA =

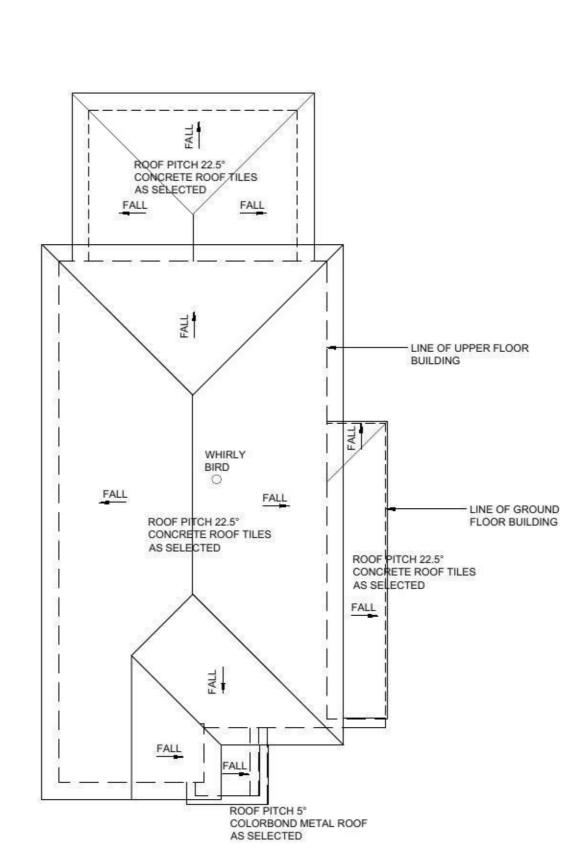

### **ROOF PLAN**

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# kurmondhomes

ABN 481 288 211 98

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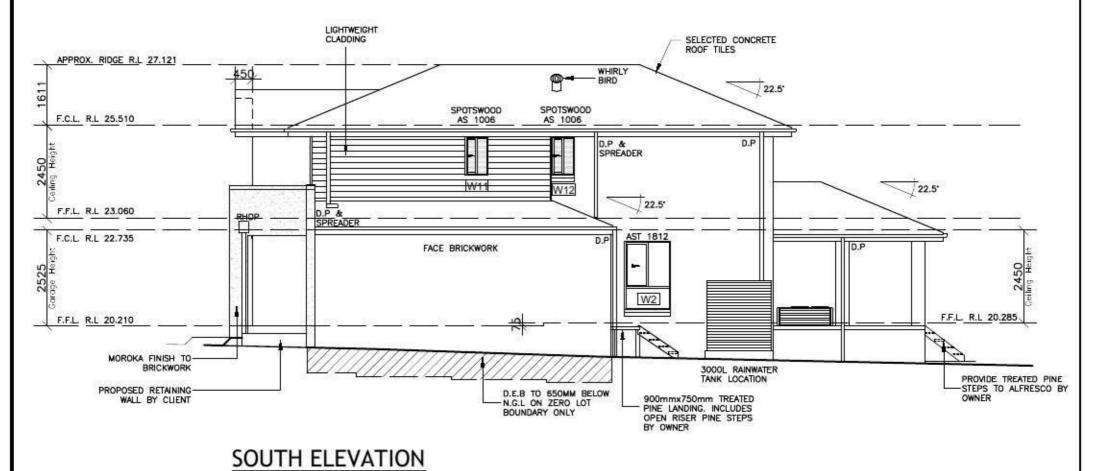
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MR. MARK CAMILLERI	JOB No:
SITE ADDRESS	DRAWN:
LOT 2089 DP 1168991	CHECKED:
NO. 32 ALINTA PROMENADE	
JORDAN SPRINGS, NSW 2747	E

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DATE: 16.08.13	Rev:
SHEET: 5	G
	16.08.13



### WEST ELEVATION FRONT ELEVATION



SIDE ELEVATION DROP EDGE BEAM AREA = 19.14m2

CLIENT'S SIGNATURE: DATE: \_

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## **kurmond**homes


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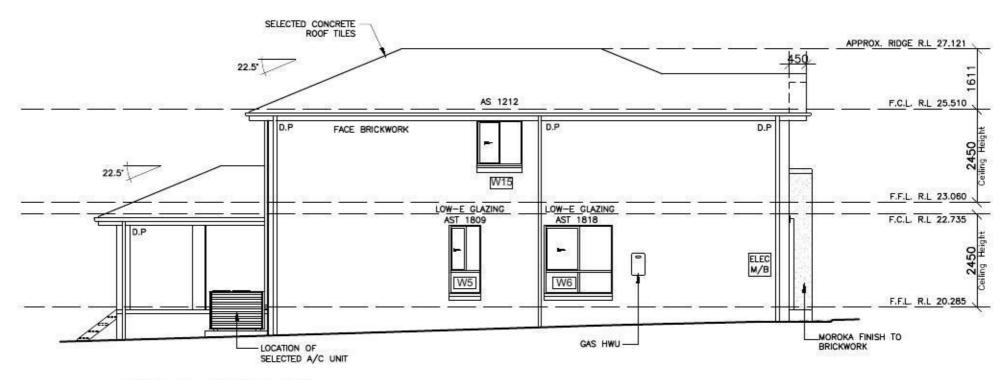
MR. MARK CAMILLER	l
SITE ADDRESS:	8
LOT 2089 DP 1168991	
NO. 32 ALINTA PROMI	ENADE
JORDAN SPRINGS, N	SW 2747

JOB No:	12066	3
DRAWN: DJ	DATE: 16.08.13	Rev:
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## **EAST ELEVATION**

REAR ELEVATION DROP EDGE BEAM AREA = 7.76m2



### **NORTH ELEVATION**

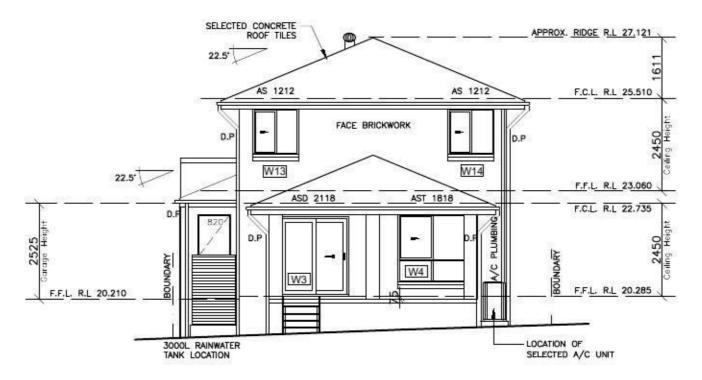SIDE ELEVATION DROP EDGE BEAM AREA = 10.5/m<sup>2</sup>

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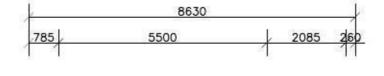
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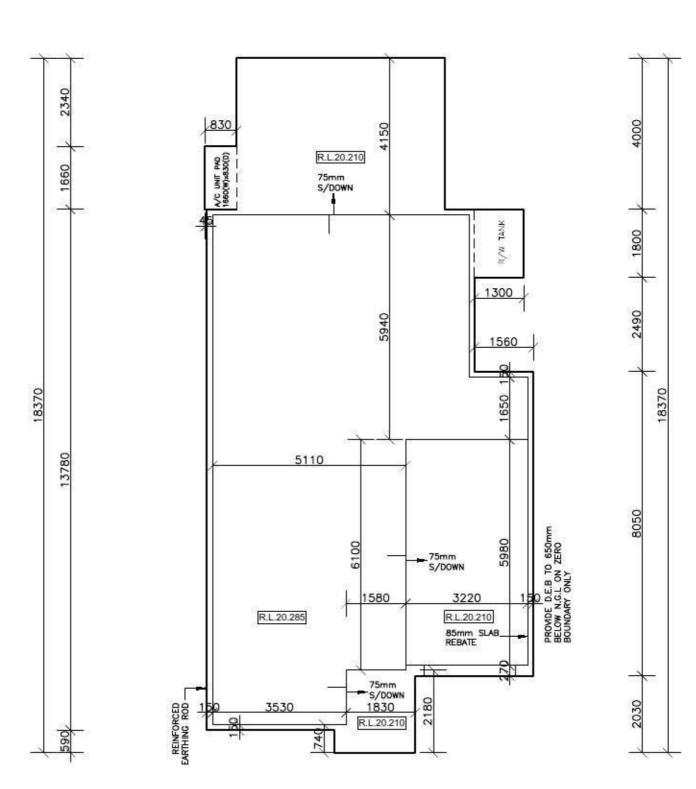
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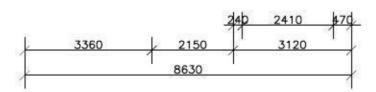
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MR. MARK CAMILLERI		
S	ITE ADDRESS: LOT 2089 DP 1168991	
	NO. 32 ALINTA PROMENADE	
	JORDAN SPRINGS, NSW 2747	

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8.13 Rev.
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## **SLAB PLAN**

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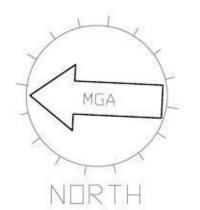
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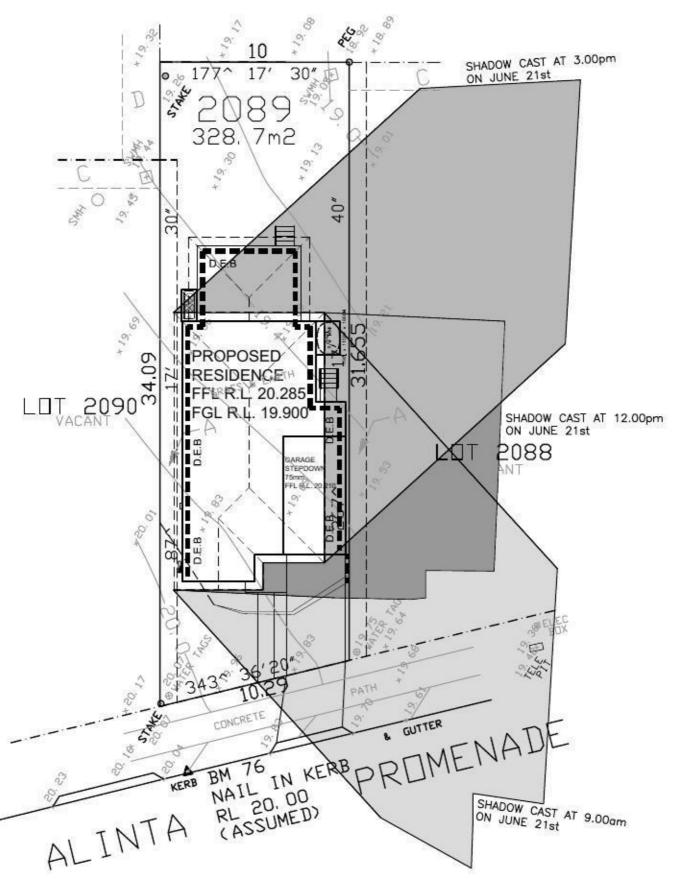
MR. MARK CAMILLERI	
SITE ADDRESS:	

TE ADDRESS:
LOT 2089 DP 1168991
NO. 32 ALINTA PROMENADE
JORDAN SPRINGS, NSW 2747

1206	6
DATE: 16.08.13	Rev:
SHEET: 11	G
	DATE: 16.08.13



2089 LOT D.P: 1168991 L.G.A: PENRITH





SHADOW CAST AT 9.00am ON JUNE 21st



SHADOW CAST AT 12.00pm ON JUNE 21st



SHADOW CAST AT 3.00pm ON JUNE 21st

SHADOW DIAGRAM - 21st JUNE TO FIRST FLOOR OF HOUSE ONLY

CLIENT'S SIGNATURE: .

DATE: \_

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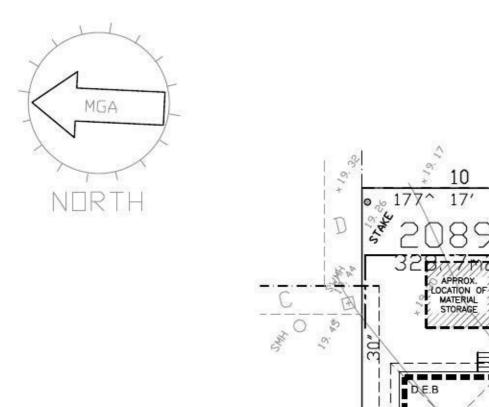
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NEPEAN 24

	MR. MARK CAMILLERI
ı	SITE ADDRESS:
4	LOT 2089 DP 1168991
	NO. 32 ALINTA PROMENADE

JORDAN SPRINGS, NSW 2747

JOB No:	1206	6
DRAWN: DJ	DATE: 16.08.13	Rev:
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2089 LOT D.P: 1168991 L.G.A: PENRITH

30" APPROX. LOCATION OF SEDIMENT FENCE PROPOSED RESIDENCE LUT S090 FFL R.L. 20.285 FGL R.L. 19.900 LOT 2088 ALL WEATHER ACCESS POSITION SEDIMENT FENCE AROUND WASTE MATERIALS BM 76 IN KERB PROMENADE

NAIL 20.00
RL 20.00
(ASSUMED) APPROX. LOCATION OF NOTE: ALINTA

TEMPORARY SECURITY FENCING TO THE PERIMETER OF BOUNDARY WHERE REQUIRED TO PREVENT PUBLIC ACCESS ONTO SITE.

NOTE:

ALL GROUND LINES ARE APPROXIMATE. EXTENT OF CUT AND FILL BATTERS WILL BE DETERMINED ON SITE. SEDIMENT BARRIERS ARE TO BE CUSTOMISED SITE SPECIFIC

### CONSTRUCTION MANAGEMENT PLAN **EROSION & SEDIMENT CONTROL PLAN**

CLIENT'S SIGNATURE:

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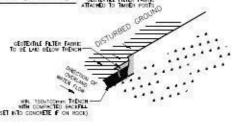
## SEDIMENT CONTROL NOTES SENERAL FILTER FABRE POSTS

1. ALL EROSION AND SEDIMENTATION CONTROL MEASURES, INCLUDING REVEGETATION AND STORAGE OF SOIL AND TOPSOIL, SHALL BE IMPLEMENTED TO THE STANDARDS OF THE SOIL CONSERVATION OF NSW AND INSPECTED DAILY BY THE SITE MANAGER.

ALL DRAINAGE WORKS SHALL BE CONSTRUCTED AND STABILIZED AS EARLY AS POSSIBLE DURING DEVELOPMENT.

SEDIMENT TRAPS SHALL BE CONSTRUCTED AROUND ALL INLET PITS, CONSISTING OF 300mm WIDE x 300mm DEEP TRENCH.

ALL SEDIMENT BASINS AND TRAPS SHALL BE CLEANED WHEN THE STRUCTURES ARE A MAXIMUM OF 60% FULL OF SOIL MATERIALS, INCLUDING THE MAINTENANCE PERIOD.



## SEDIMENT FENCE

5. ALL DISTURBED AREAS SHALL BE REVEGITATED AS SOON AS THE RELEVANT WORKS ARE COMPLETED.

6. SOIL AND TOPSOIL STOCKPILES SHALL BE LOCATED AWAY FROM DRAINAGE LINES AND AREA WHERE WATER MAY CONCENTRATE. ALL ROADS AND FOOTPATHS TO BE SWEPT DAILY.

7. FILTER SHALL BE CONSTRUCTED BY STRETCHING A FILTER FABRIC (PROPEX OR APPROVED EQUIVALENT BETWEEN POST AT 3.0m CENTRES. FABRIC SHALL BE BURIED 150mm ALONG ITS LOWER EDGE.

8. DUST PREVENTION MEASURES TO BE MAINTAINED AT ALL TIMES.



## **kurmond**homes

DATE:

BL No. 205 457C ABN 481 288 211 98

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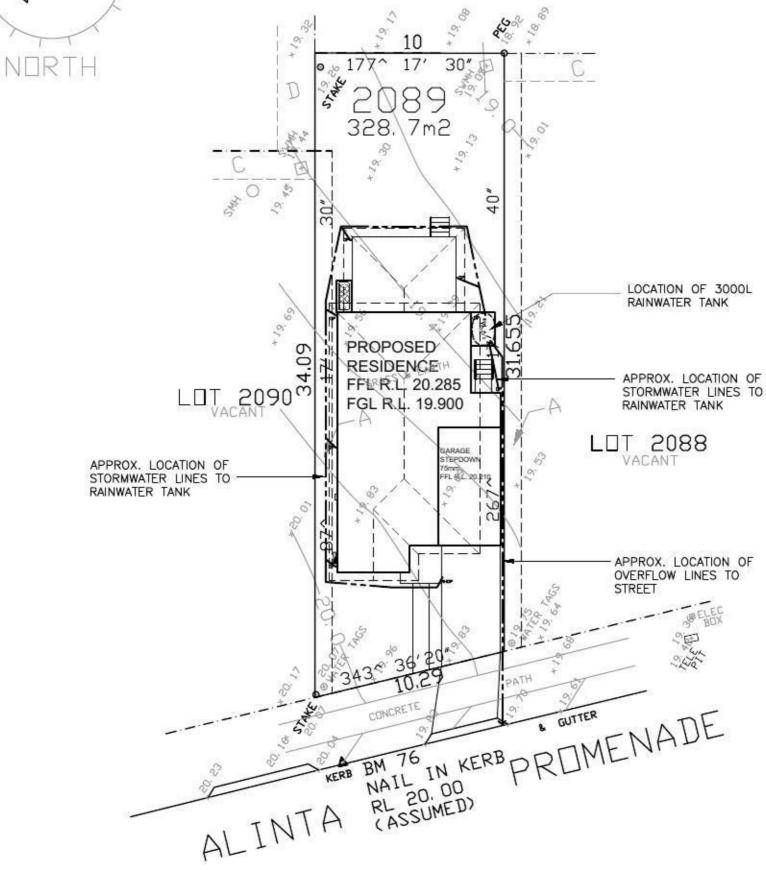
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MR. MARK CAMILLERI		
SITE ADDRESS:		
LOT 2089 DP 1168991		
NO. 32 ALINTA PROMENADE		
JORDAN SPRINGS, NSW 2747		

JOB No:	12066		
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LOT 2089 D.P: 1168991 L.G.A: PENRITH



# STORMWATER TO STREET VIA RAINWATER TANK

CONCEPT STORMWATER MANAGEMENT PLAN

CLIENT'S SIGNATURE:

DATE: \_\_

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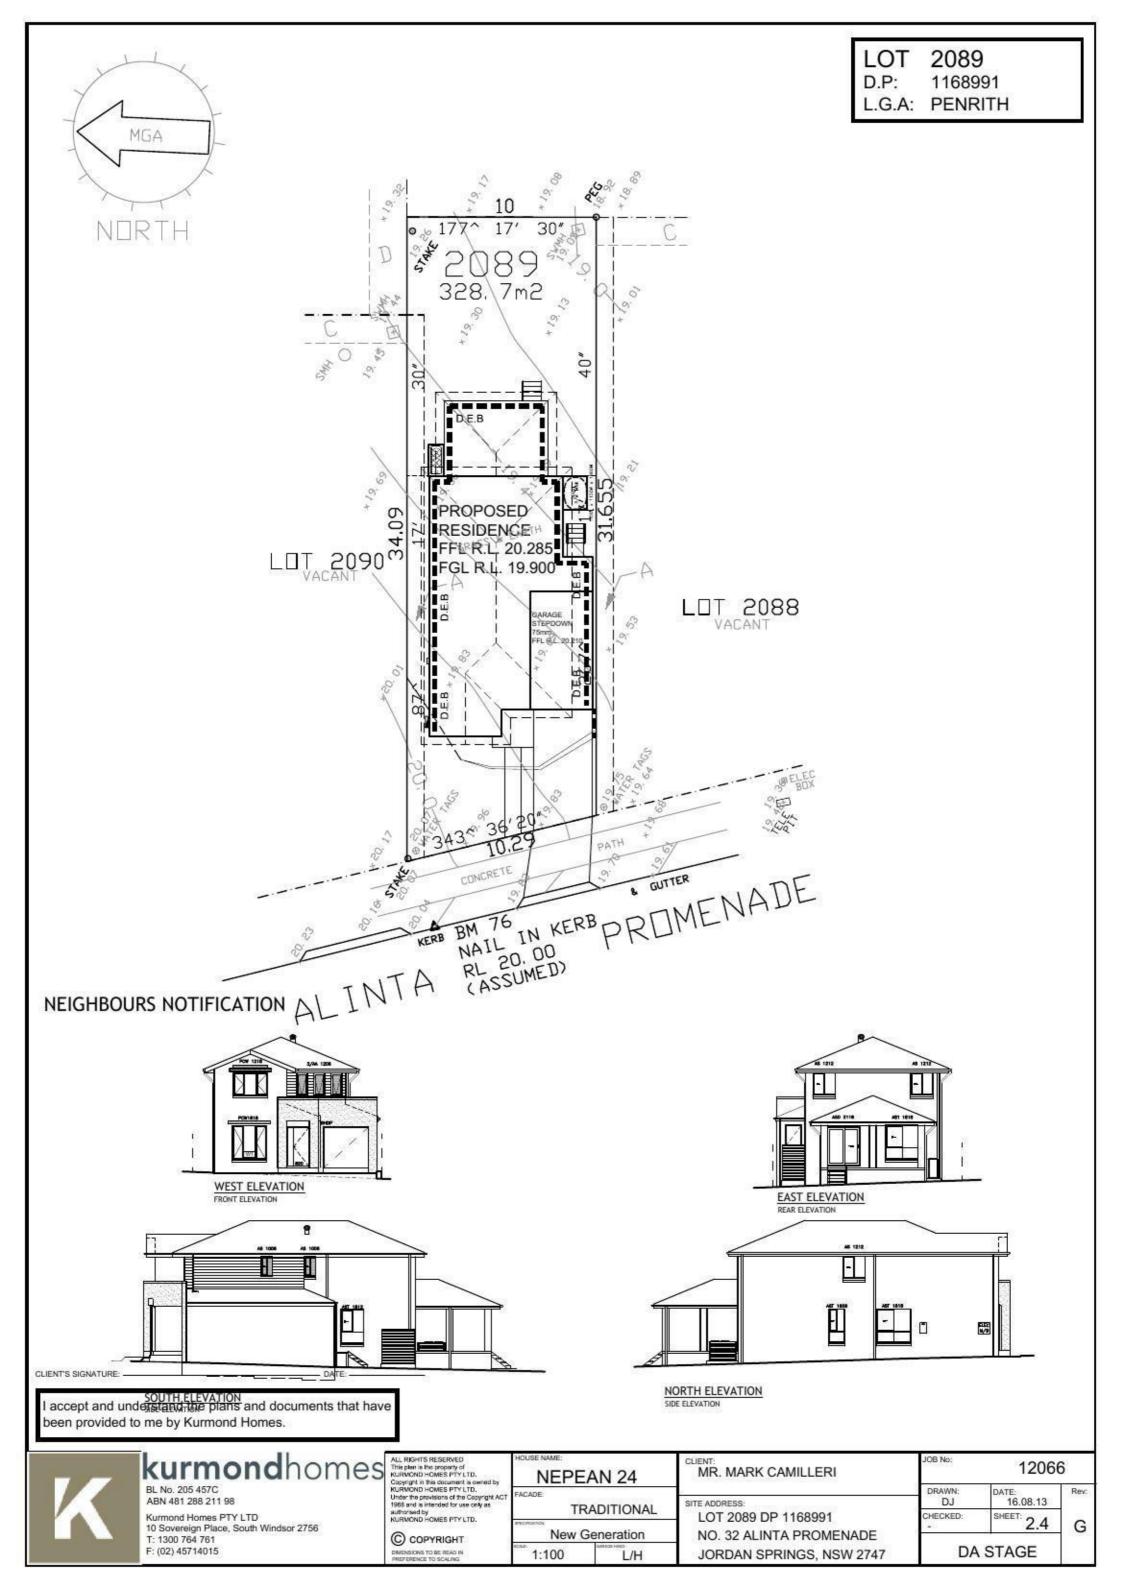



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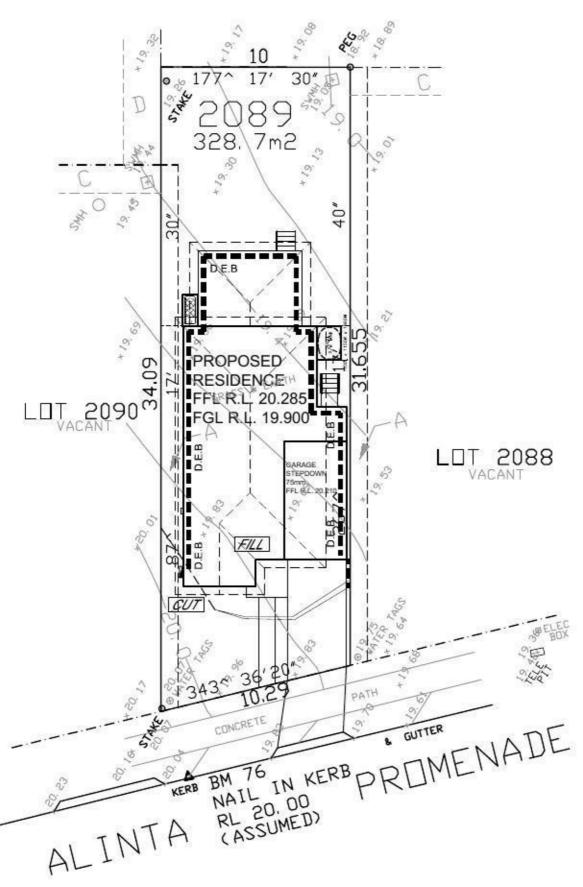
MR. MARK CAMILLERI	JOB No: 12066		
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LOT 2089 DP 1168991	CHECKED:	SHEET: 2 3	.,
NO. 32 ALINTA PROMENADE JORDAN SPRINGS, NSW 2747	DA	STAGE	26

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LOT 2089 D.P: 1168991 L.G.A: PENRITH



CUT AREA = 0.64m2 FILL AREA = 144.00m2

**CUT AND FILL** 

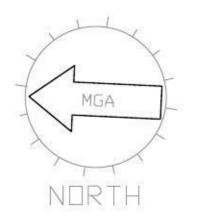CLIENT'S SIGNATURE:

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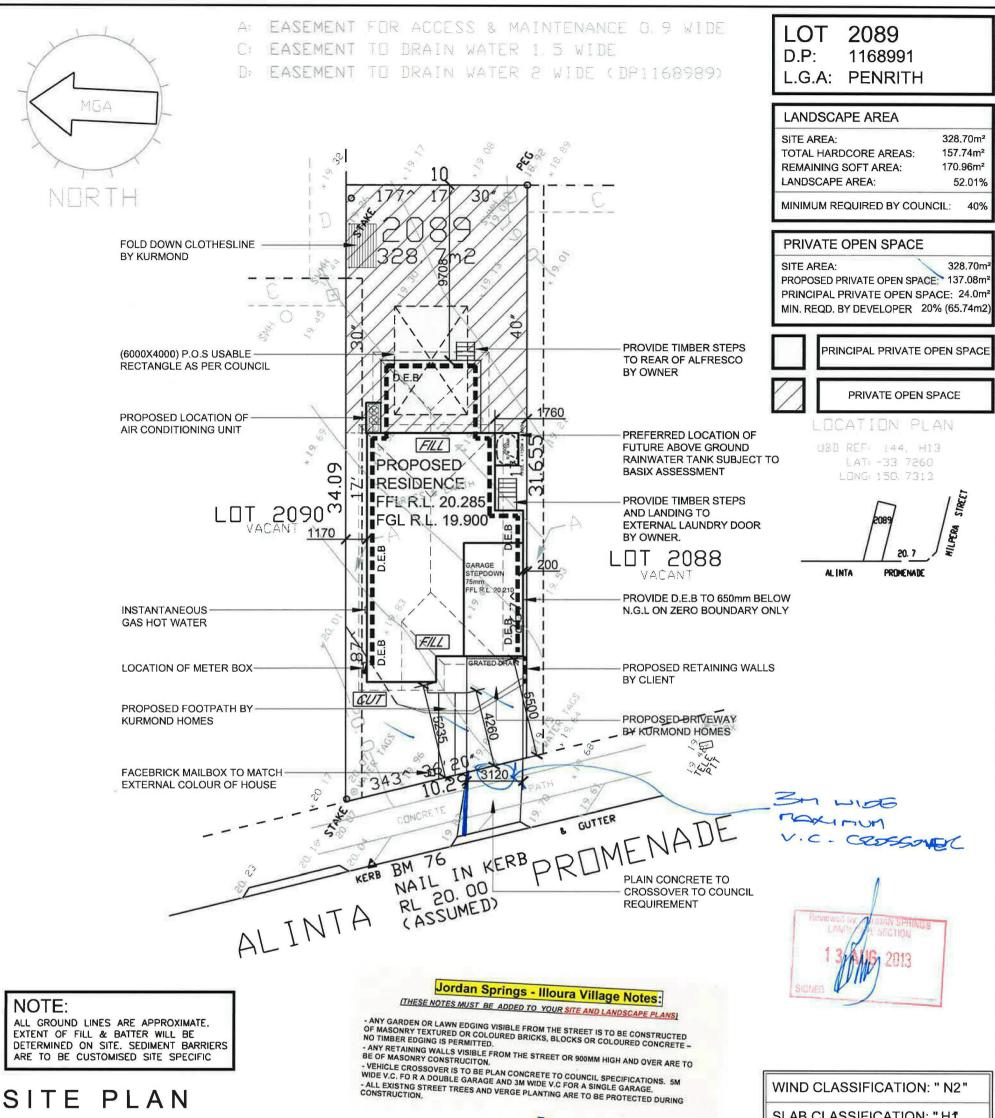
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NOTES

- Bearings and distances are by Title and/or Deed only This detail survey is not a "survey" as defined by the Surveyors Act, 1929.
- This detail survey is not a "survey" as defined by the Surveyors Act, 1929. If any construction is planned it would be advisable to carry out further survey work to determine the boundary dimensions. Relationship of improvements to boundaries is diagrammatic only. Where offsets are critical they should be confirmed by further survey. Contours shown depict the topography, except at spot levels shown they do not represent the exact level at any particular point. Services shown hereon have been determined from visual evidence only. Prior to any demolition, excavation or construction on the site the relevant authority should be contacted to establish detailed location and depth. Australian Height Datum was established from SSM 168755 RL 69 056 Tree locations are accurate to +/- 0.30m.

  The information is only to be used at a scale accuracy of 1:200.

SLAB CLASSIFICATION: "HT

### SITE INDUCTION

Before entering site please review and make yourself familiar with Emergency Contacts. Site Specific Hazards and the Site Specific Induction information that is located on the Site Induction Sign. If you have any trouble understanding this instruction, contact the Site Supervisor or **Emergency Contact Number located on the** sign.

## SITE SPECIFIC HAZARDS

- \* LIMITED SPACE FOR MATERIAL STOCK PILE
- \* FOOTPATH / PEDESTRIAN TRAFFIC \* TRAFFIC CONTROL REQUIRED
- \* DROP EDGE BEAM

### STORMWATER TO STREET VIA RAINWATER TANK

### CLIENT'S SIGNATURE:

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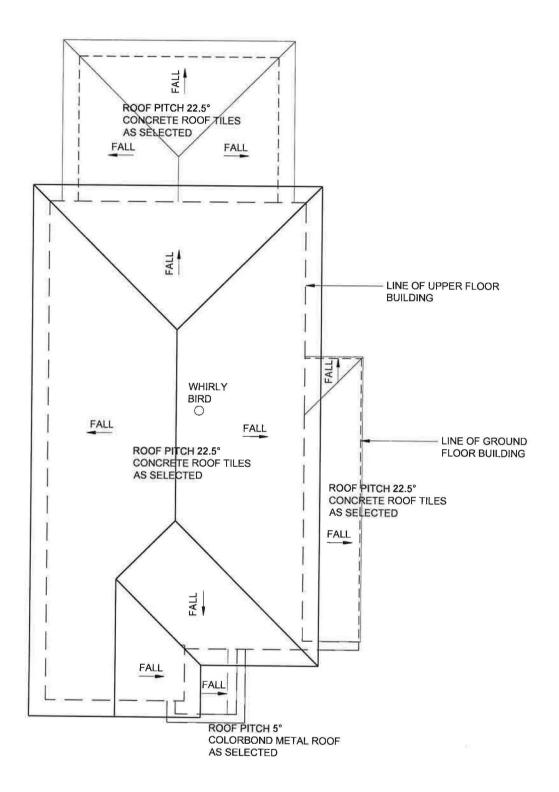
JORDAN SPRINGS, NSW 2747

MR. MARK CAMILLERI

JOB No: 12066 DRAWN 08.08.13 CHECKED: SHEET: F DA STAGE

LEGEND:
GROUND FLOOR AREA = 43.83 m2
FIRST FLOOR AREA = 112.33 m2

TOTAL ROOF AREA = 156,16 m2



## **ROOF PLAN**

CLIENT'S SIGNATURE: \_\_\_\_\_ DATE: \_\_\_\_\_

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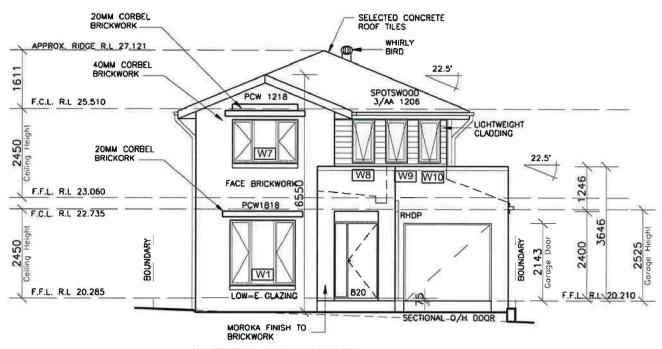
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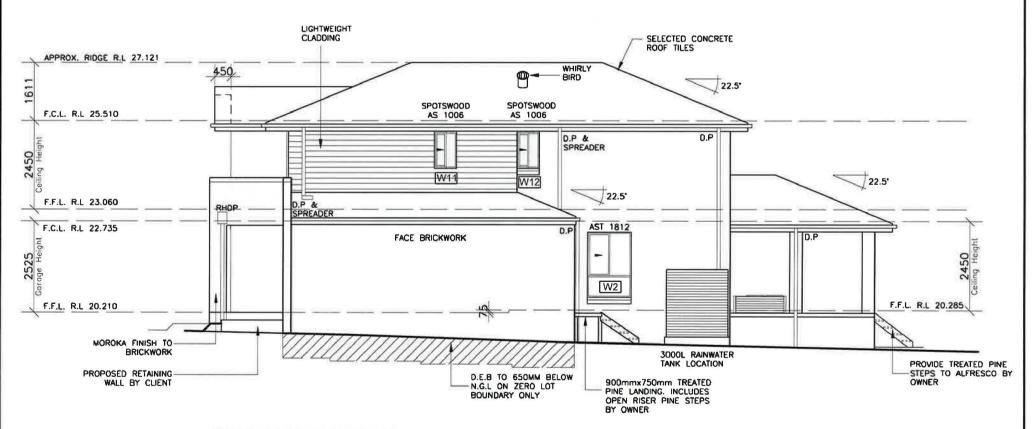
HOUSE NAME:

CLIENT: MR. MARK CAMILLERI	•
SITE ADDRESS: LOT 2089 DP 1168991	
NO. 32 ALINTA PROMENADE	
IORDAN SPRINGS NEW 2747	

JOB No:	12066	
DRAWN:	DATE: 08.08.13	Rev
CHECKED:	SHEET: 5	F
DA	STAGE	



**WEST ELEVATION** FRONT ELEVATION



### **SOUTH ELEVATION**

SIDE ELEVATION DROP EDGE BEAM AREA = 19.14m<sup>2</sup>

CLIENT'S SIGNATURE: \_ DATE: \_\_\_

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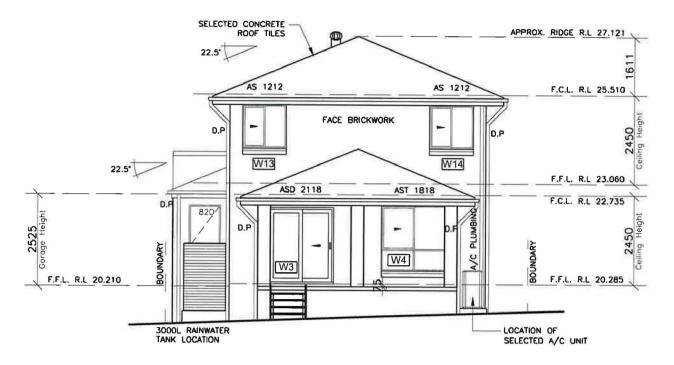
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LOT 2089 DP 1168991
NO. 32 ALINTA PROMENADE
JORDAN SPRINGS, NSW 274


CLIENT: MR. MARK CAMILLERI

JOB No:	1206	6
DRAWN:	DATE: 08.08.13	Rev:
CHECKED:	SHEET: 6	F
D/	A STAGE	



### **EAST ELEVATION**

**REAR ELEVATION** DROP EDGE BEAM AREA = 7.76m<sup>2</sup>

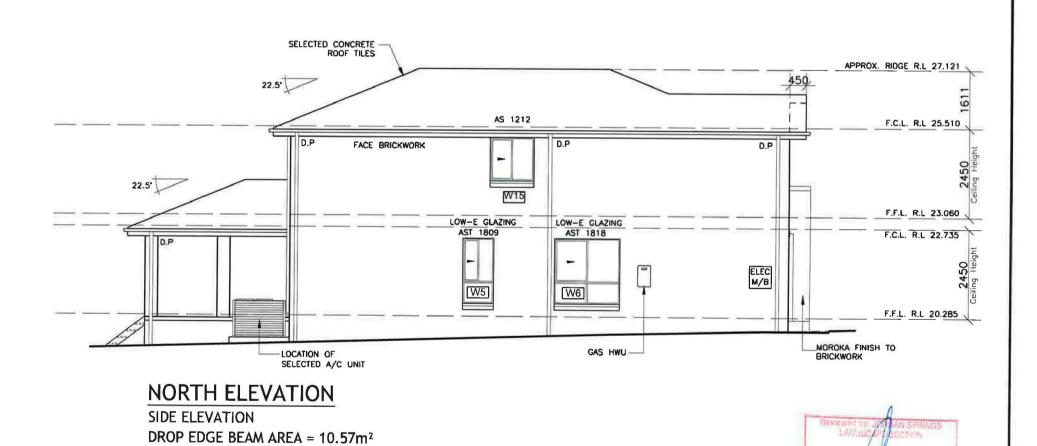

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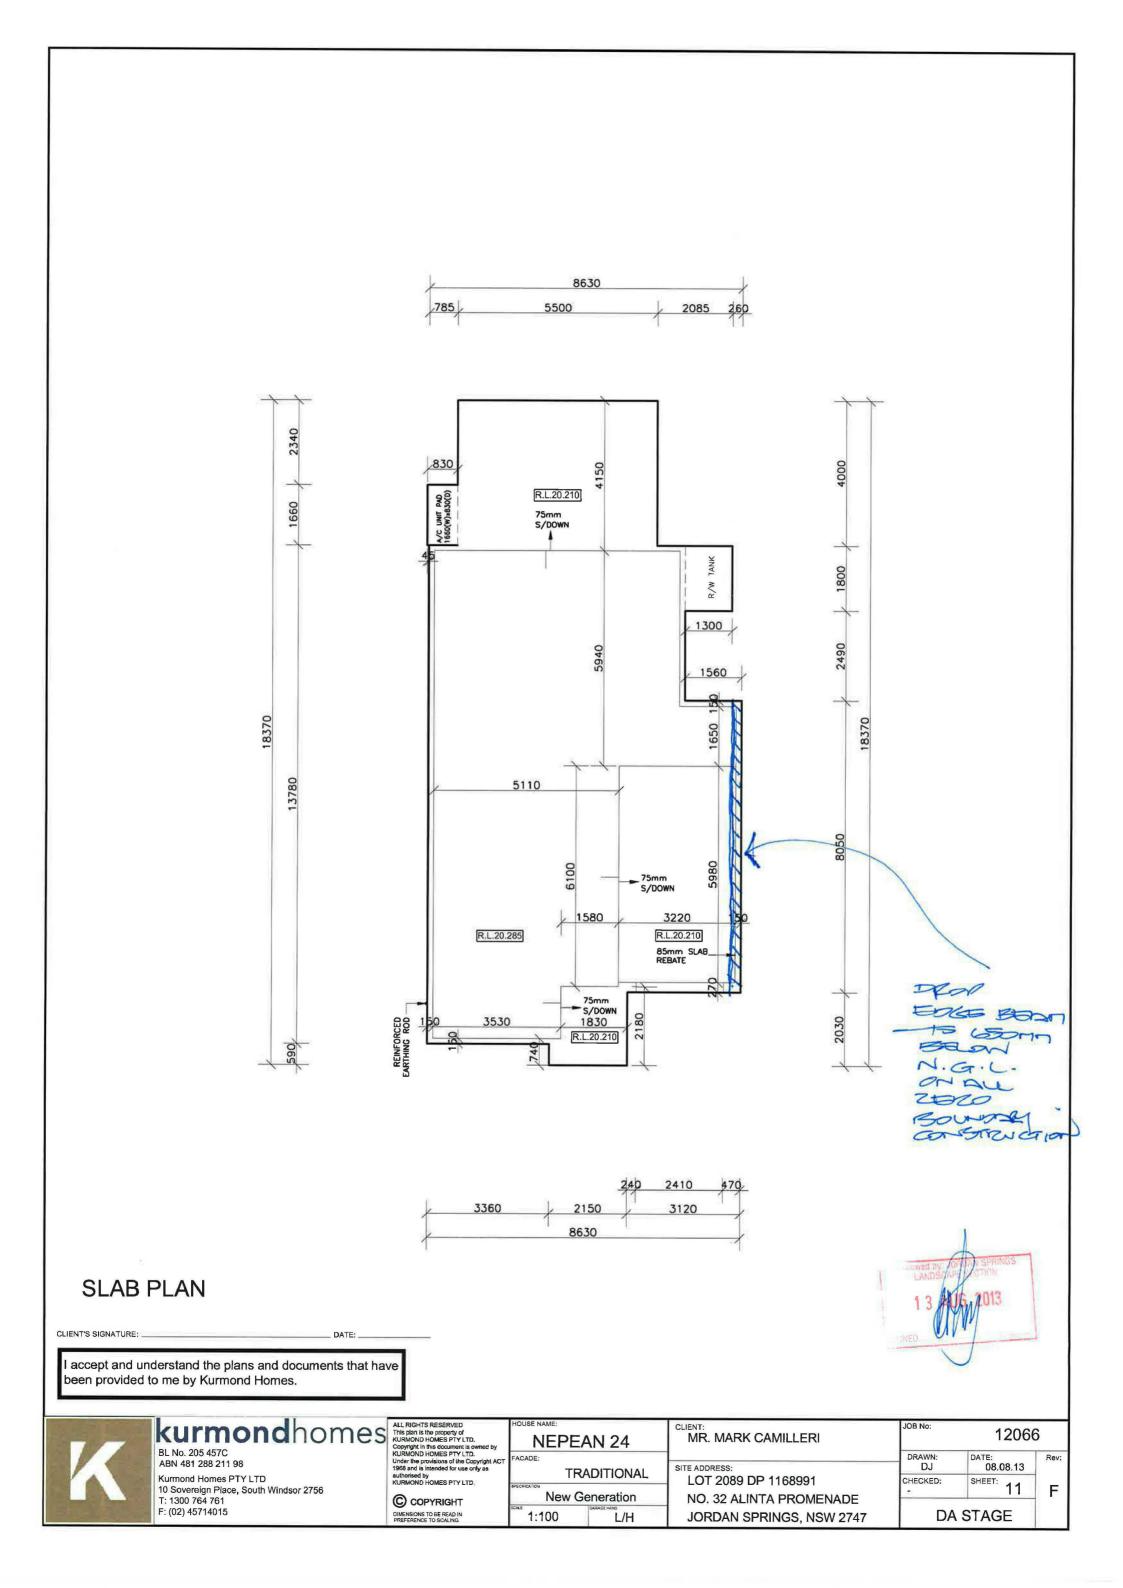
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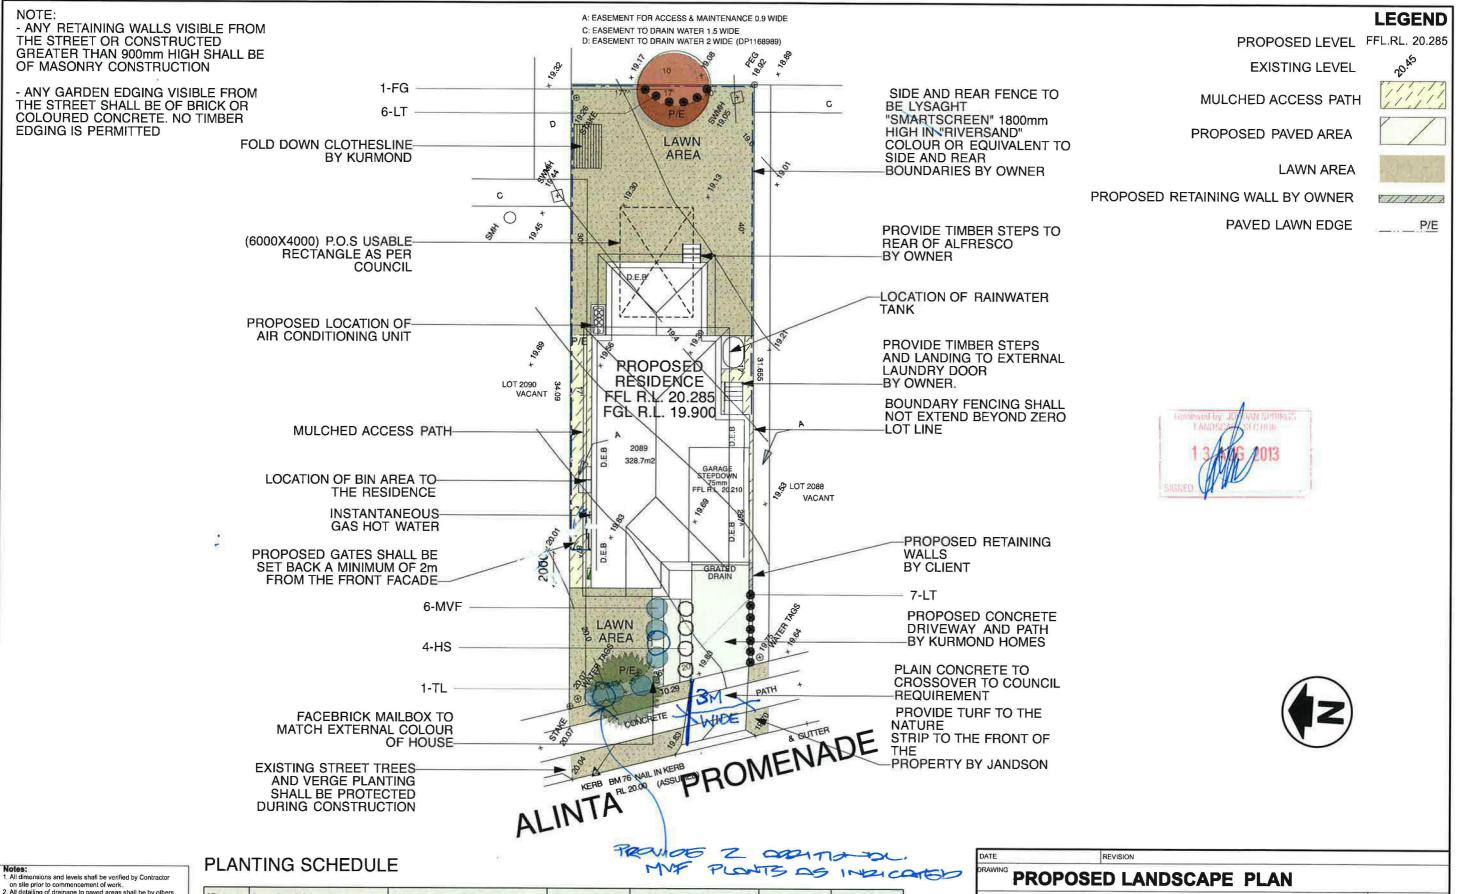
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CLIENT: MR. MARK CAMILLERI
SITE ADDRESS: LOT 2089 DP 1168991
NO. 32 ALINTA PROMENADE
JORDAN SPRINGS, NSW 2747

JOB No:	1206	6
DRAWN:	DATE: 08.08.13	Rev:
CHECKED:	SHEET: 7	F
DA	STAGE	





on sile prior to commencement of work

All detailing of drainage to paved areas shall be by others

All levels shall be determined by others and approved on

3. All levels shall be determined by others and approved on site by client.
4. Extent, height and position of all retaining walls shall be determined by others and approved on site by client, to Structural Engineers detail.
5. Do not scale from drawings.
6. If in doubt contact the Landscape Architect.


All boundaries shall be surveyed prior to commence of construction works.


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for construction 9. All dimensions, levels and boundaries are nominal only. This design shall not be copied, utilised or reproduced in any way without prior written permission of A Total Concept

ID	Latin Name	Common Name	Quantity	Scheduled Size	Spread	Height
FG	Fraxinus 'Raywood'	Claret Ash	1	45lt	4000	5000
HS	Hibbertia scandens	Climbing Guinea Flower	4	tube	1000	350
LT	Lomandra 'Tanika'	Dwarf Lomandra	13	5lt	500	500
MVF	Metrosideros 'Fiji'	NZ Xmas Bush 'Fiji'	6	15lt	1200	1200
TL	Tristianiopsis laurina	Water Gum	1	25lt	4000	7000

DATE		REVISION				
DRAWING	PROPOSE	D LANDSCAPE	PLAN			
ADDRESS	LOT 2089 AL	T 2089 ALINTA PROMENADE, JORDAN SPRINGS				PROJECT #  Kurmono
CLIENT	MR MARK CAMILLERI		DA <sup>*</sup>	TE#	02/08/13	DWG#
			SC	ALE @ A3	1:200	1/01
A Total Concept Landscape Architects & Swimming Pool Designers			Q DR.	AWN	JS	1,01
			СН	KD	SW	REVISION
65 West Street, North Sydney NSW 2060 Tel: (02) 9957 5122 Fx: (02) 9957 5922		dnev NSW 2060	C	atc	ept	



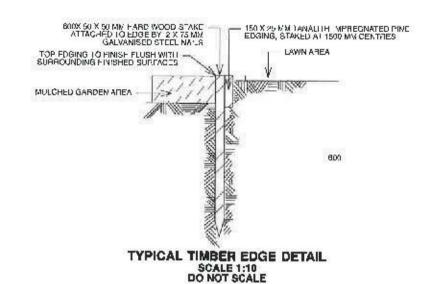

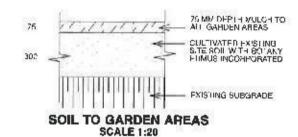75 MW DEPTH SPECIFIED DECORATIVE PEBBLE HINISHED FLUSH WITH ADJOINING SURFACES UNITES OF FEMALE SHOWN 100 COMPACTED SURGRADE

PEBBLE PATHWAY SCALE 1:10

A fild mons and act kinds shall be we find by Contractor on silv pront of commentements work.

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A fild while girl dramage to paved amous shall be by others.


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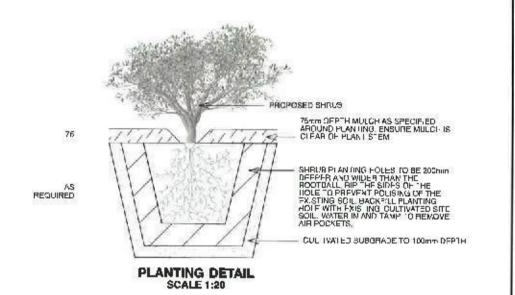
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 I in shall contact the Landscape Analyses.
 I in shall contact the Landscape Analyses.
 A limit their said the surveyed prior to commencement of construction were.
 This plants for DA parametering. I have not been detailed to construction.


To Start Eller I A durantee may, I they not been detailed for somethington.

All discretising levels and boundaries are nominal any.

This design shall not be coused, unless or speculated in any way without poor addition sear index of All Stat Contept Lambourpe Andriects.



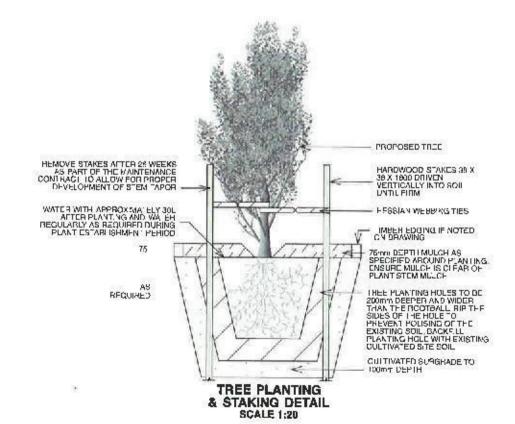

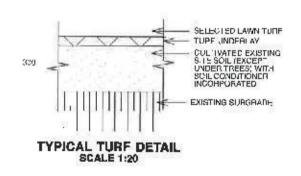

DATE	RFVIS OV	REVISION				
LAN	DSCAPE DETAILS					
ACRESS LOT 2	Kurmono					
CLENI MD M	ARK CAMILLERI	DAIL# 02/08/1	DWC V			
mil V 19	ARA CAMILLERI	BCAF@A3 as shown	L/02			
A Total Co	LIVE					
Swimming	oncept Landscape Architects & Pool Designers	Q:K2 <b>5V</b>	<b>F</b> F∀8ЮN			
65 West Street,	North Sydney NSW 2060 122 Fx: (02) 9957 5922	atc	atc a lata concept			