




2 x N12 BARS, 1200 LONG TIED TO UNDERSIDE OF FABRIC. TYPICAL BARS MAY BE DELETED IF FABRIC LAPS AT INTERNAL CORNERS (typical).

* STARTING POINT

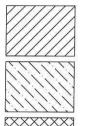

HATCHED AREA INDICATES GARAGE

HATCHED AREA INDICATES **ALFRESCO**

HATCHED AREA INDICATES PORCH.

SPECIFICATION

- This specification shall be read in conjunction with the structural drawings and the Architectural drawings and specifications.
- Setting out dimensions or member size shall not be scaled from drawings. Any discrepancy or conclusion on these drawings must be notified to the Engineer before proceeding with the work.
- These drawings are only approved when the are signed with an original
- signature by the Engineer.

 All work shall be in accordance with the requirements of all the relevant

FOUNDATIONS

- All footings and piers shall be founded on even bearing soil or rock of the same type throughout.
- The footings/piers have been designed for a safe bearing capacity of 200kPa. The foundation material shall be approved by the structural engineer or a geotechnical engineer before placing concrete in the footings/piers.
- Unless otherwise shown in these drawings piers are rouried in soft natural soils, uneven bearing conditions and fill areas. Unless otherwise specified piers shall be 400mm diameter mass concrete and spaced at 2000mm maximum centres. All footings, isolated pads, raft slab edge and internal beames shall be piered. The founding depth of the piers and the adequacy of the foundation material shall be determined on site by the structural or a geotechnical engineer.
- Excavations for drainage lines or other services must not effect slab or footing stability. The engineer must be consulted when the trench excavations are within the influence zone of the footings and slabs.
- Foundation excavations shall be kept free of water. If the bearing surface deteriorates before concrete is poured the Contractor shall clean out all loose, soft material down to the specified bearing capacity at his own expense.

CONCRETE

- All workmanship shall be in accordance with A.S.3600 except as varied by the contract documents.

 Cement is to be type A unless otherwise noted. Fc=25MPa, max. slump
- 80mm and max. aggregate size = 20mm.
- All cement shall be vibrated to ensure correct placement into the formwork. Concrete shall be cured for 7 days by keeping all exposed areas wet with water or other method approved by the Engineer.

 No concrete shall be placed until the Engineer has inspected and approved the placed reinforcement.
- All concrete used in suspended slabs shall be sampled and tested in accordance
- Clear concrete cover to reinforcement shall be 25mm for slab, 50mm for beams
- and columns or as otherwise noted on the drawings. Splices in reinforcement shall be Trench mash and fabric - 2 transverse wires
- plus 25mm, N12 500mm, N16 550 or as otherwise noted on drawings.

 Top and bottom reinforcement in slabs shall be supported in both directions at maximum centres of 600mm for bars 10mm or less, 900mm for bars 12mm and 16mm and 900mm for fabrics.
- Waterproof memembrans shall be polythene sheet with a minimum thickness of

NOTE:

FILL TO BE COMPACTED IN ACCORDANCE WITH CLAUSE 6.4.2, AS2870

NOTE: VERTICAL ARTICULATION JOINTS IN ACCORDANCE WITH CLAUSE 3.3.1.8 OF THE BUILDING CODE OF AUSTRALIA

REINFORCEMENT

WAFFLE POD SLAB PLAN

SCALE 1: 100

EXTERNAL RIB 3N12 INTERNAL RIB 1N12 SLAB MESH SL72 COVER (min.) 20mm.

POD HEIGHT SLAB THICKNESS OVERALL DEPTH RIB SPACING (max.)

225mm. unless noted otherwise 85mm.

310mm, unless noted otherwise 1100mm.

110mm.

PROPOSED SLAB PLAN AT LOT 2354 GREENWOOD PARKWAY JORDAN SPRINGS

MEARES

T- 02 8883 2891 F-02 8883 2967 street: suite 3.07, 5 Celebration Dr Bella Vista mail: PO Box 7063 Baulkham Hills MC, NSW 2153 www.mearesconsulting.com.au patrick@mearesconsulting.com.au

ABN 41 154 140 002 STRUCTURAL

CONSULTING


DRAINAGE


CIVII

				CIVIL	
URVEYED:	DRAWN: PWM	DESIGNED: PM	DATE: 25/7/2013	Sheet 1	
ATUM:	SCALE:	REVISION:	Ref. No. 6470	Of Sheets 7	


WAFFLE TYPE

RIB WIDTH

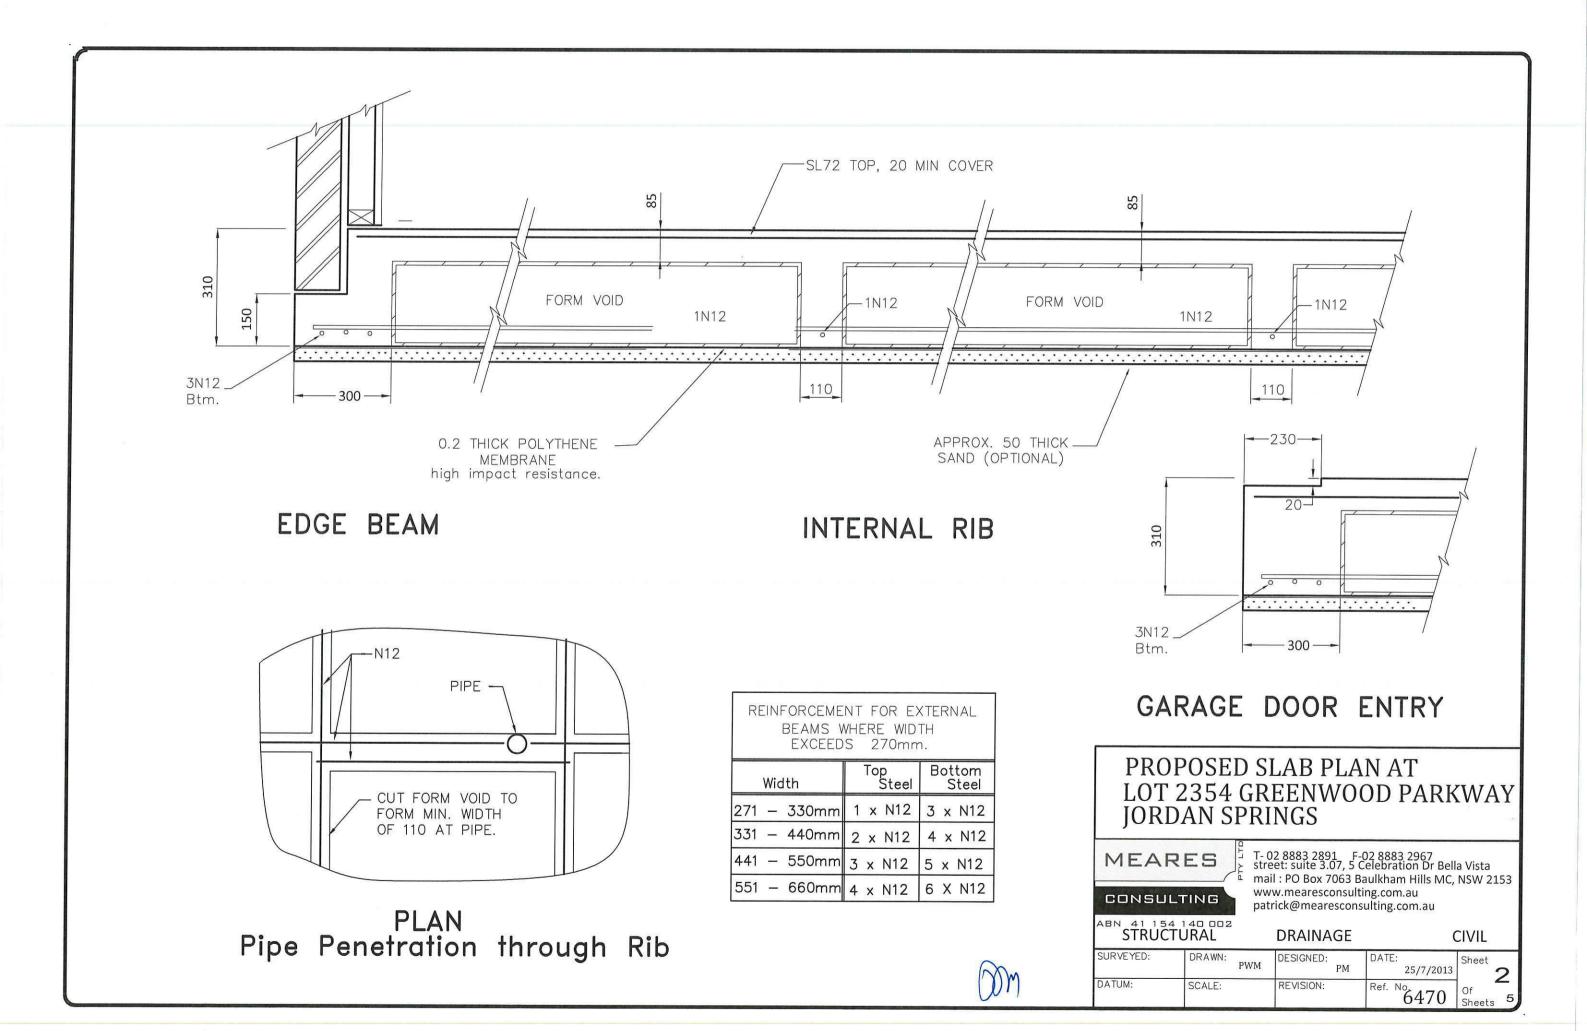


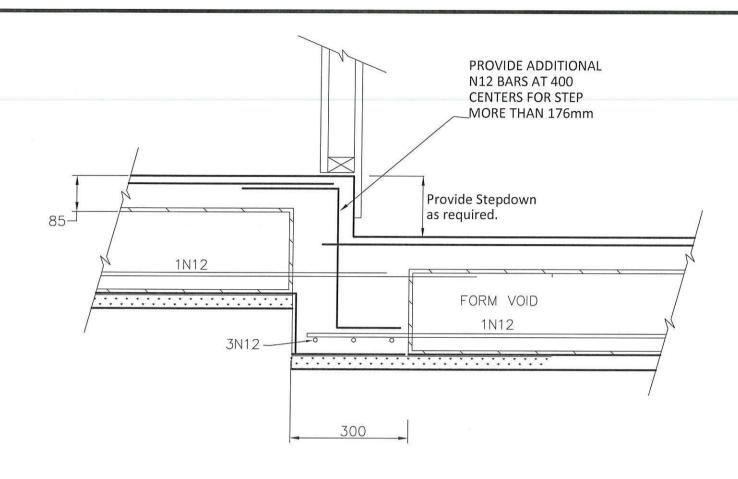

GARAGE SET-DOWN Detail

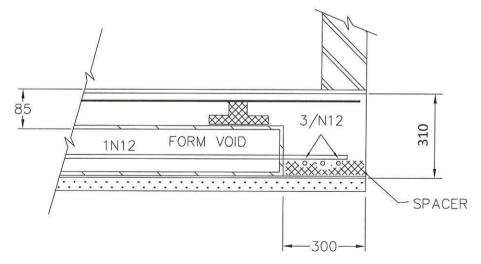


VERANDAH / GARAGE EDGE BEAM

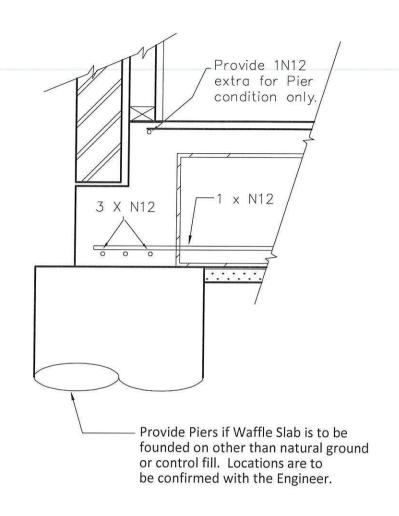

Typical Piering Requirements





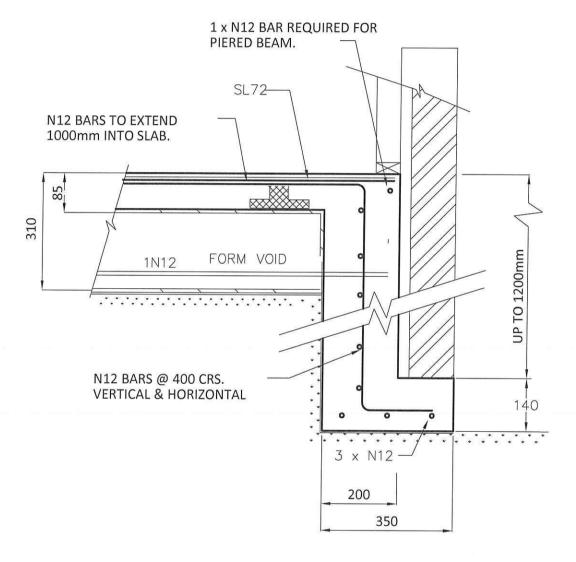

DROPPED EDGE BEAM
Detail

PROPOSED SLAB PLAN AT LOT 2354 GREENWOOD PARKWAY JORDAN SPRINGS

MEARES

T- 02 8883 2891 F-02 8883 2967 street: suite 3.07, 5 Celebration Dr Bella Vista mail: PO Box 7063 Baulkham Hills MC, NSW 2153 www.mearesconsulting.com.au patrick@mearesconsulting.com.au

CONSULTING

ABN 41 154 140 002

STRUCTURAL

DRAINAGE

CIVIL

SURVEYED: DRAWN: PWM DESIGNED: PM DATE: 25/7/2013 Sheet 4

DATUM: SCALE: REVISION: Ref. No. 6470 Of Sheets



Piering Detail.

300 Mass concrete piers. To even bearing ground.

PROPOSED PIERING PLAN AT LOT 2354 GREENWOOD PARKWAY JORDAN SPRINGS

MEARES

CONSULTING

T- 02 8883 2891 F-02 8883 2967 street: suite 3.07, 5 Celebration Dr Bella Vista mail: PO Box 7063 Baulkham Hills MC, NSW 2153 www.mearesconsulting.com.au patrick@mearesconsulting.com.au


ABN 41 154 140 002 STRUCTURAL


DRAINAGE

CIVIL

DRAWN: PWM DESIGNED: PM DATE: 25/7/2013 Sheet 5 DATUM: SCALE: REVISION: Ref. No. 6470 Of Sheets 5



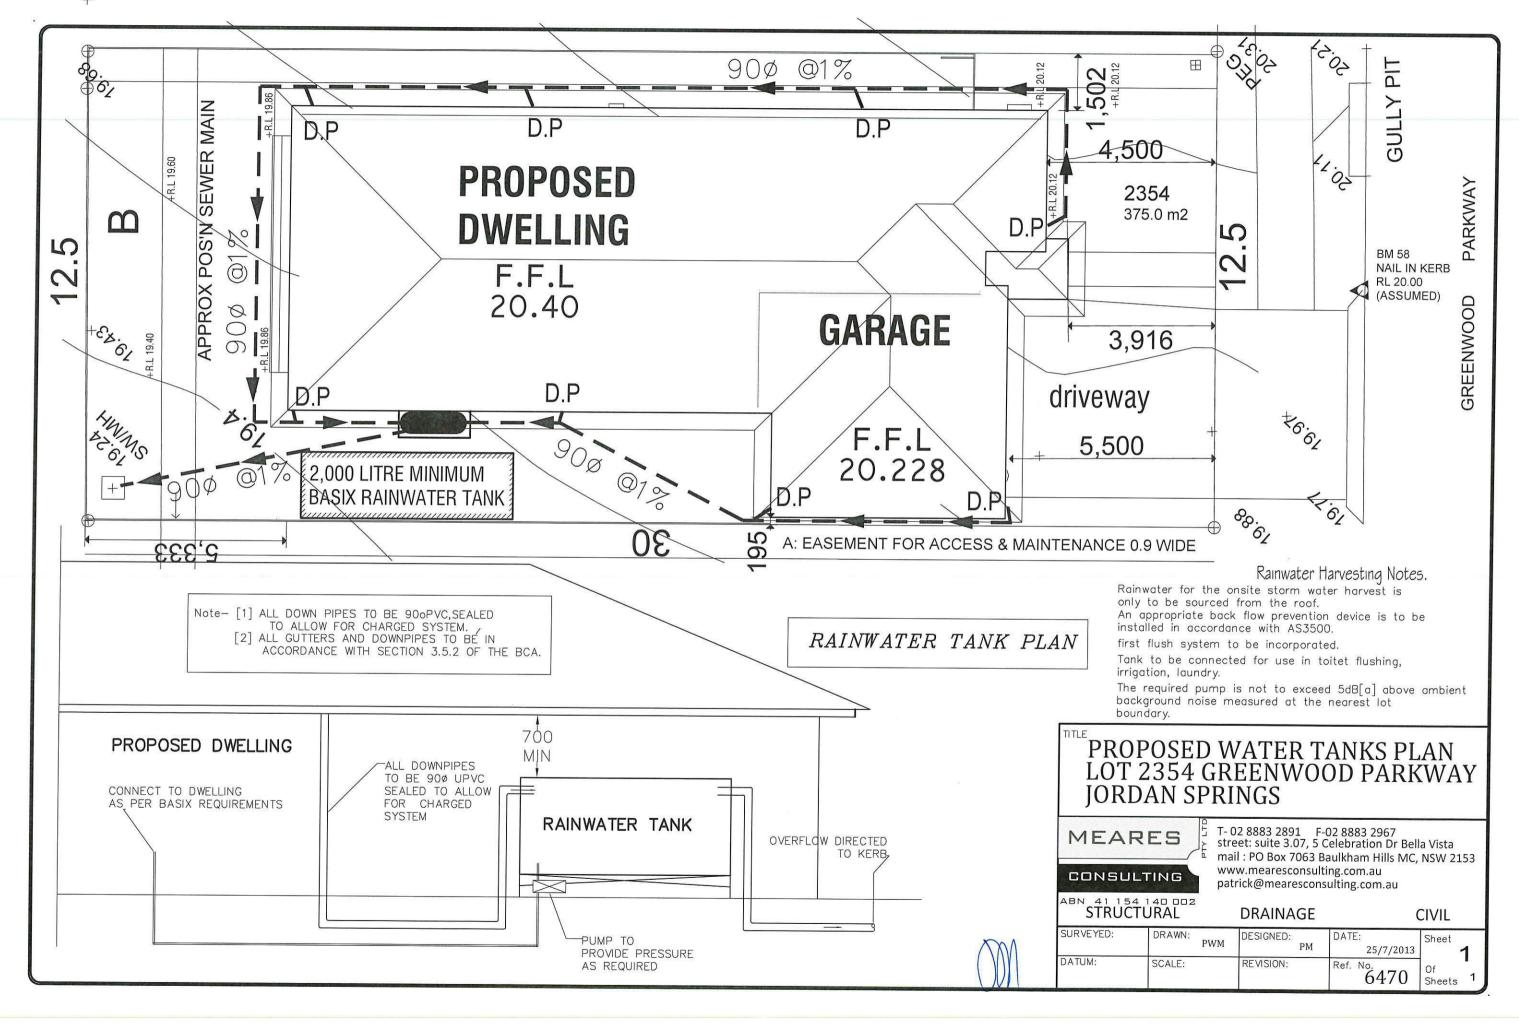

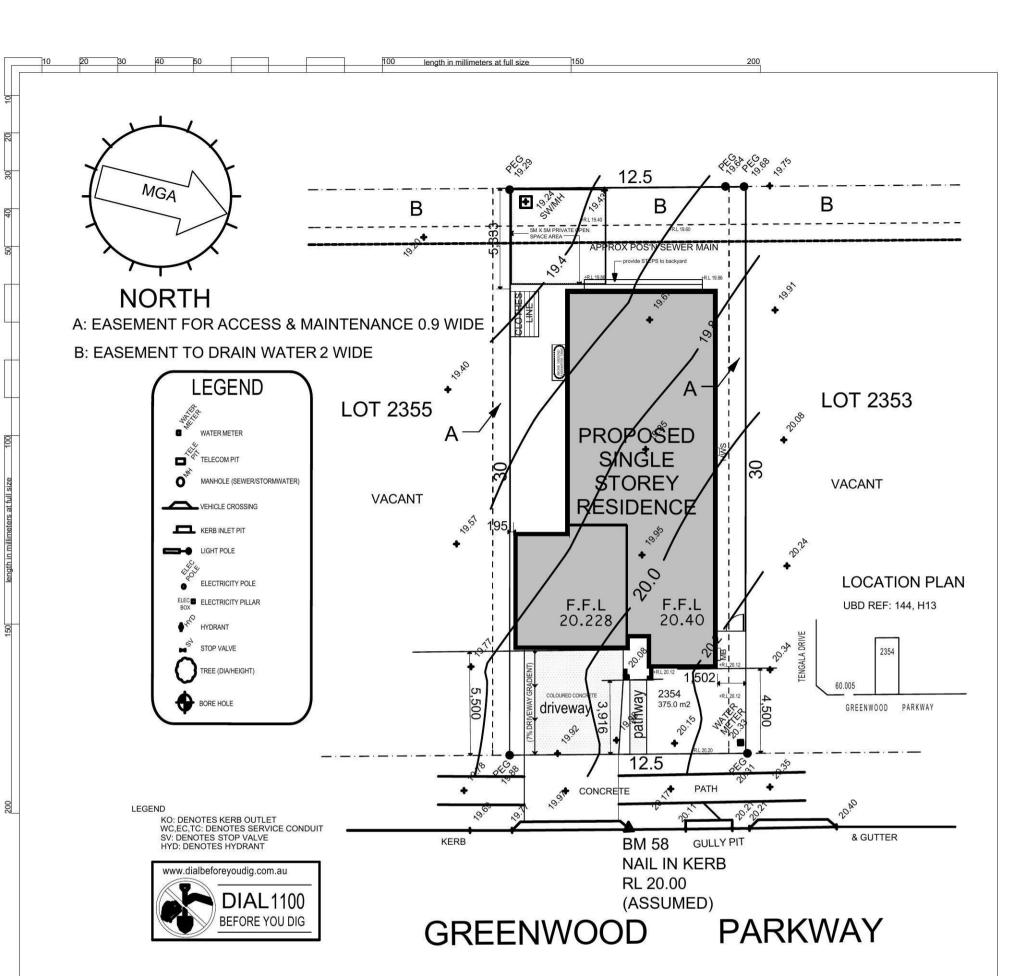



General Calculations

Allotment area = 375.00sqm Living/Garage area =174.03sqm Porch area = 2.75sqm Gross floor area = 176.78sqm Landscaped area = 166.07sqm Site Coverage = 55.72% Roof area = 202.76sqm Private Open Space = 104.98sqm

BUSHFIRE ATTACKLEVEL **BAL** 19

Building construction to comly with Section 3 & 6 of AS 3959 & Section 3.7 of PBP addendum appendix 3

Schedule of BASIX commitments

Water Commitments

Landscape

The applicant must plant indigenous or low water use species of vegetation throughout 40 square metres of the site.

The applicant must install showerheads with a minimum rating of 3 star (> 4.5 but <= 6 L/min) in all showers in the development.

The applicant must install a toilet flushing system with a minimum rating of 4 star in each toilet in the development. The applicant must install taps with a minimum rating of 5 star in the kitchen in the development.

The applicant must install basin taps with a minimum rating of 5 star in each bathroom in the development.

Alternative water Rainwater tank

The applicant must install a rainwater tank of at least 2000 litres on the site. This rainwater tank must meet, and be installed in accordance with, the requirements of all applicable regulatory authorities.

The applicant must configure the rainwater tank to collect rain runoff from at least 130 square metres of the roof area of the development (excluding the area of the roof which drains to any stormwater tank or private dam).


The applicant must connect the rainwater tank to: · all toilets in the development

• at least one outdoor tap in the development (Note: NSW Health does not recommend that rainwater be used for human consumption in areas with potable water supply.)




MERIDIAN HOMES

Drawing Title: - SITE PLAN SITE PLAN		Project No: MQ1313	Layout No.: 1/8
Scale: as noted	Date:	Plot Date:	8/08/2013
Status:	Checked By:	C:/Documents and Settings/Administrator/My Documents/meridian mq 1313 2354.pln	

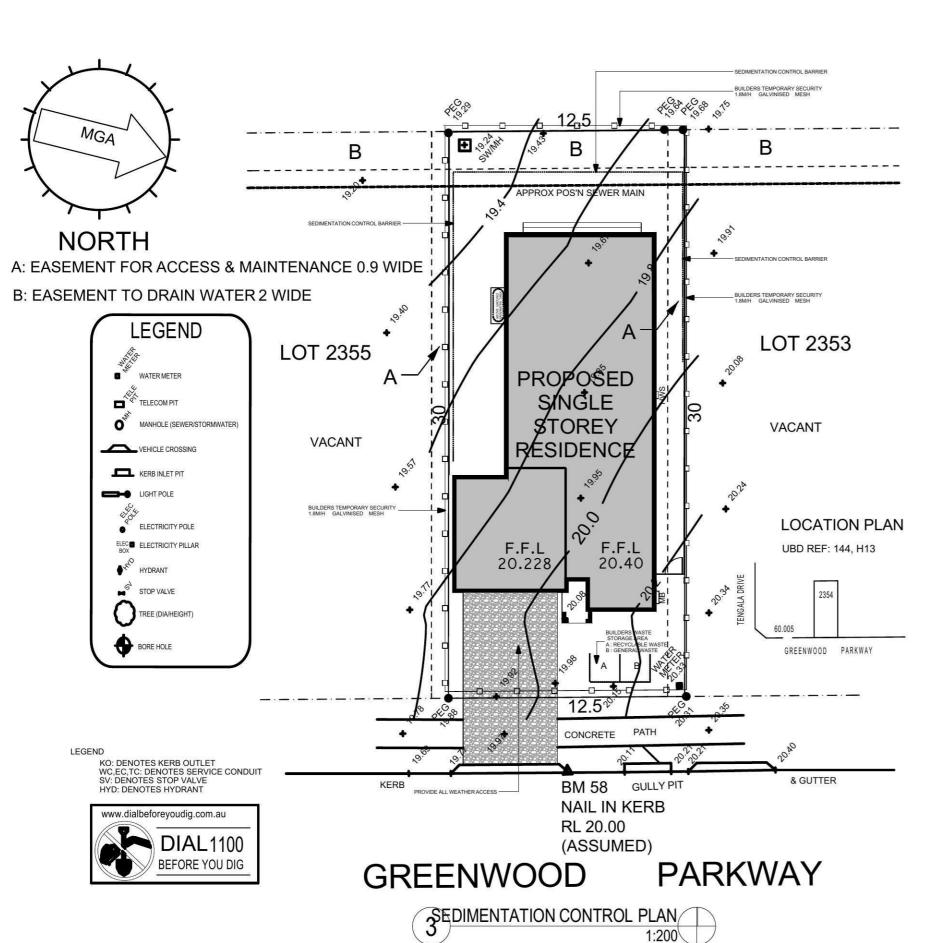

length in millimeters at full size

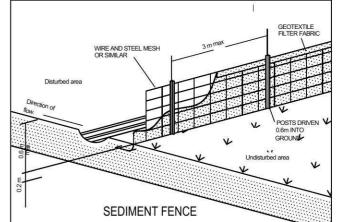

SEDIMENTAION CONTROL NOTES

1: ALL EROSION CONTROL MEASURERS ARE TO BE INSTALLED & MAINTAINED IN ACCORDANCE WITH MANAGING URBAN STORMWATER, 3rd EDITION PRODUCED BY THE NSW DEPARMENT OF HOUSING, STANDARD DRAWING (SO) NUMBERS REFERENCE CAN BE OBTAINED FROM THIS PUBLICATION

2 : ALL EROSION & SILATION CONTROL DEVICES ARE TO BE PLACED PRIOR TO THE COMMENCEMENT OF ANY CONSTRUCTIONWORKS, & ALL SILT TRAPS ARE TO HAVE DEPOSITED SILT REMOVED REGULARY DURING CONSTRUCTION 3 : ALL TREES ARE TO BE PRESERVED UNLESS INDICATED OTHERWISE ON COUCIL APPROVED DEVELOPMENT CONSENT. EXISTING GRASS COVER SHALL BE MAINTAINED EXCEPT IN AREAS CLEARED FOR BUILDINGS, PAVEMENT ETC.

4: INSTALL TEMPORARY SEDIMENT BARRIERS TO ALL INLET PITS, LIKELY TO COLLECTSILT LADDEN WATER

5 : NOT WITHSTANDING DETAILS SHOWN IT IS THE CONTRACTORS SOLE RESPONSIBILTY TO ENSURE THAT ALL SITE

ACTIVITIES COMPLY WITH THE REQUIREMENTS OF THE CLEAN WATERSACT & ALL COUNCIL REQUIREMENTS

The builder shall check and verify all dimensions ar levels and verify all errors and ofinissions to the Architect. Do not scale the drawings. Drawings sha not be used for construction purposes until issued by the Architect for construction.

All works to be set out by registered surveyor



MERIDIAN HOMES.

Meridian Homes Pty Ltd

Proposed Single Storey Residence

At : Lot 2354 DP1168993 Greenwood Parkway Jordon Springs NSW


Drawing Title:
- SEDIMENTATION CONTROL PLAN
SEDIMENTATION CONTROL PLAN,
SEDIMENTATION FENCE
Scale: as noted

Date:
Status:
Checked By:
Project No:
Drawing No.:
MQ1313

2/8

lot Date:

1/08/2013

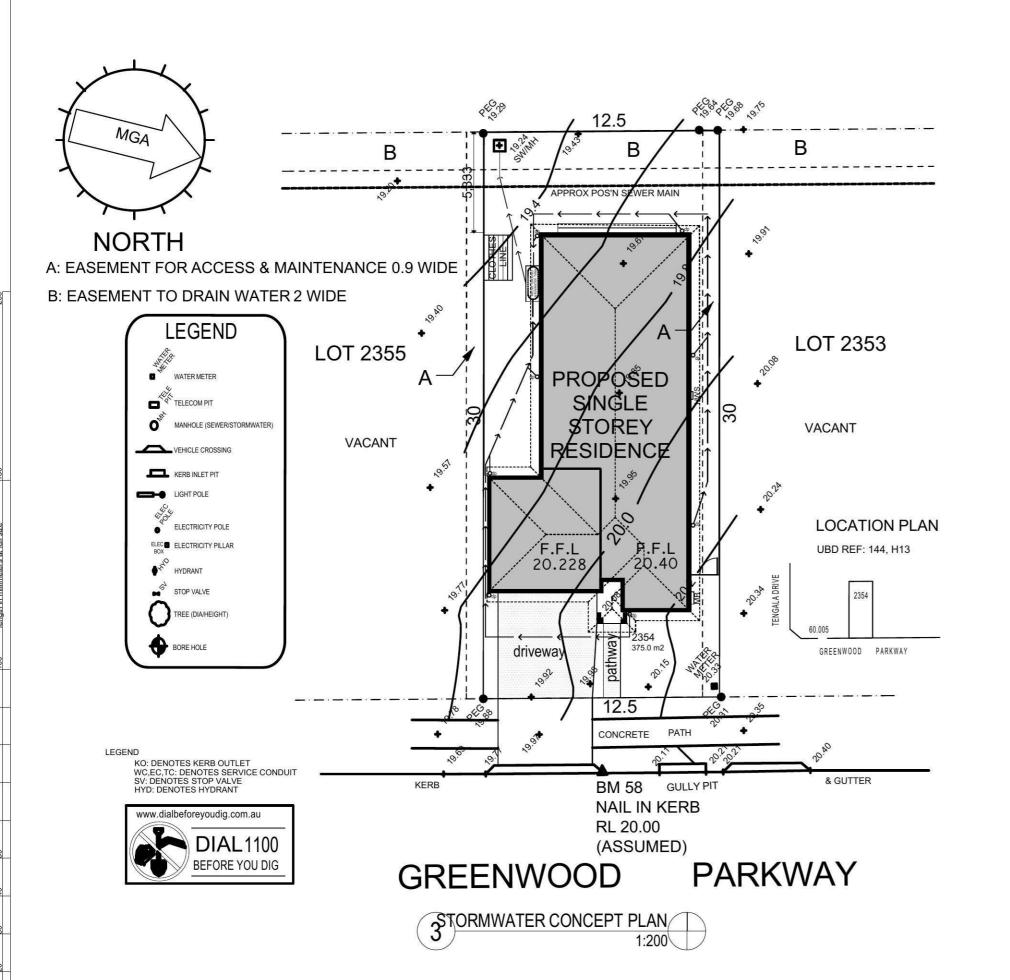

length in millimeters at full size

The builder shall check and verify all dimensions an levels and verify all errors and omissions to the Architect. Do not scale the drawings. Drawings shall not be used for construction purposes until issued by the Architect for construction.

All works to be set out by registered surveyor.



MERIDIAN HOMES.

Meridian Homes Pty Ltd

Proposed Single Storey Residence

At : Lot 2354 DP1168993 Greenwood Parkway Jordon Springs NSW

Drawing Title:
- STORMWATER CONCEPT PLAN
STORMWATER CONCEPT PLAN

 Scale:
 as noted
 Date:


 Status:
 Checked By:

 Project No:
 Drawing No.:

 MQ1313
 3/8

ot Date:

1/08/2013

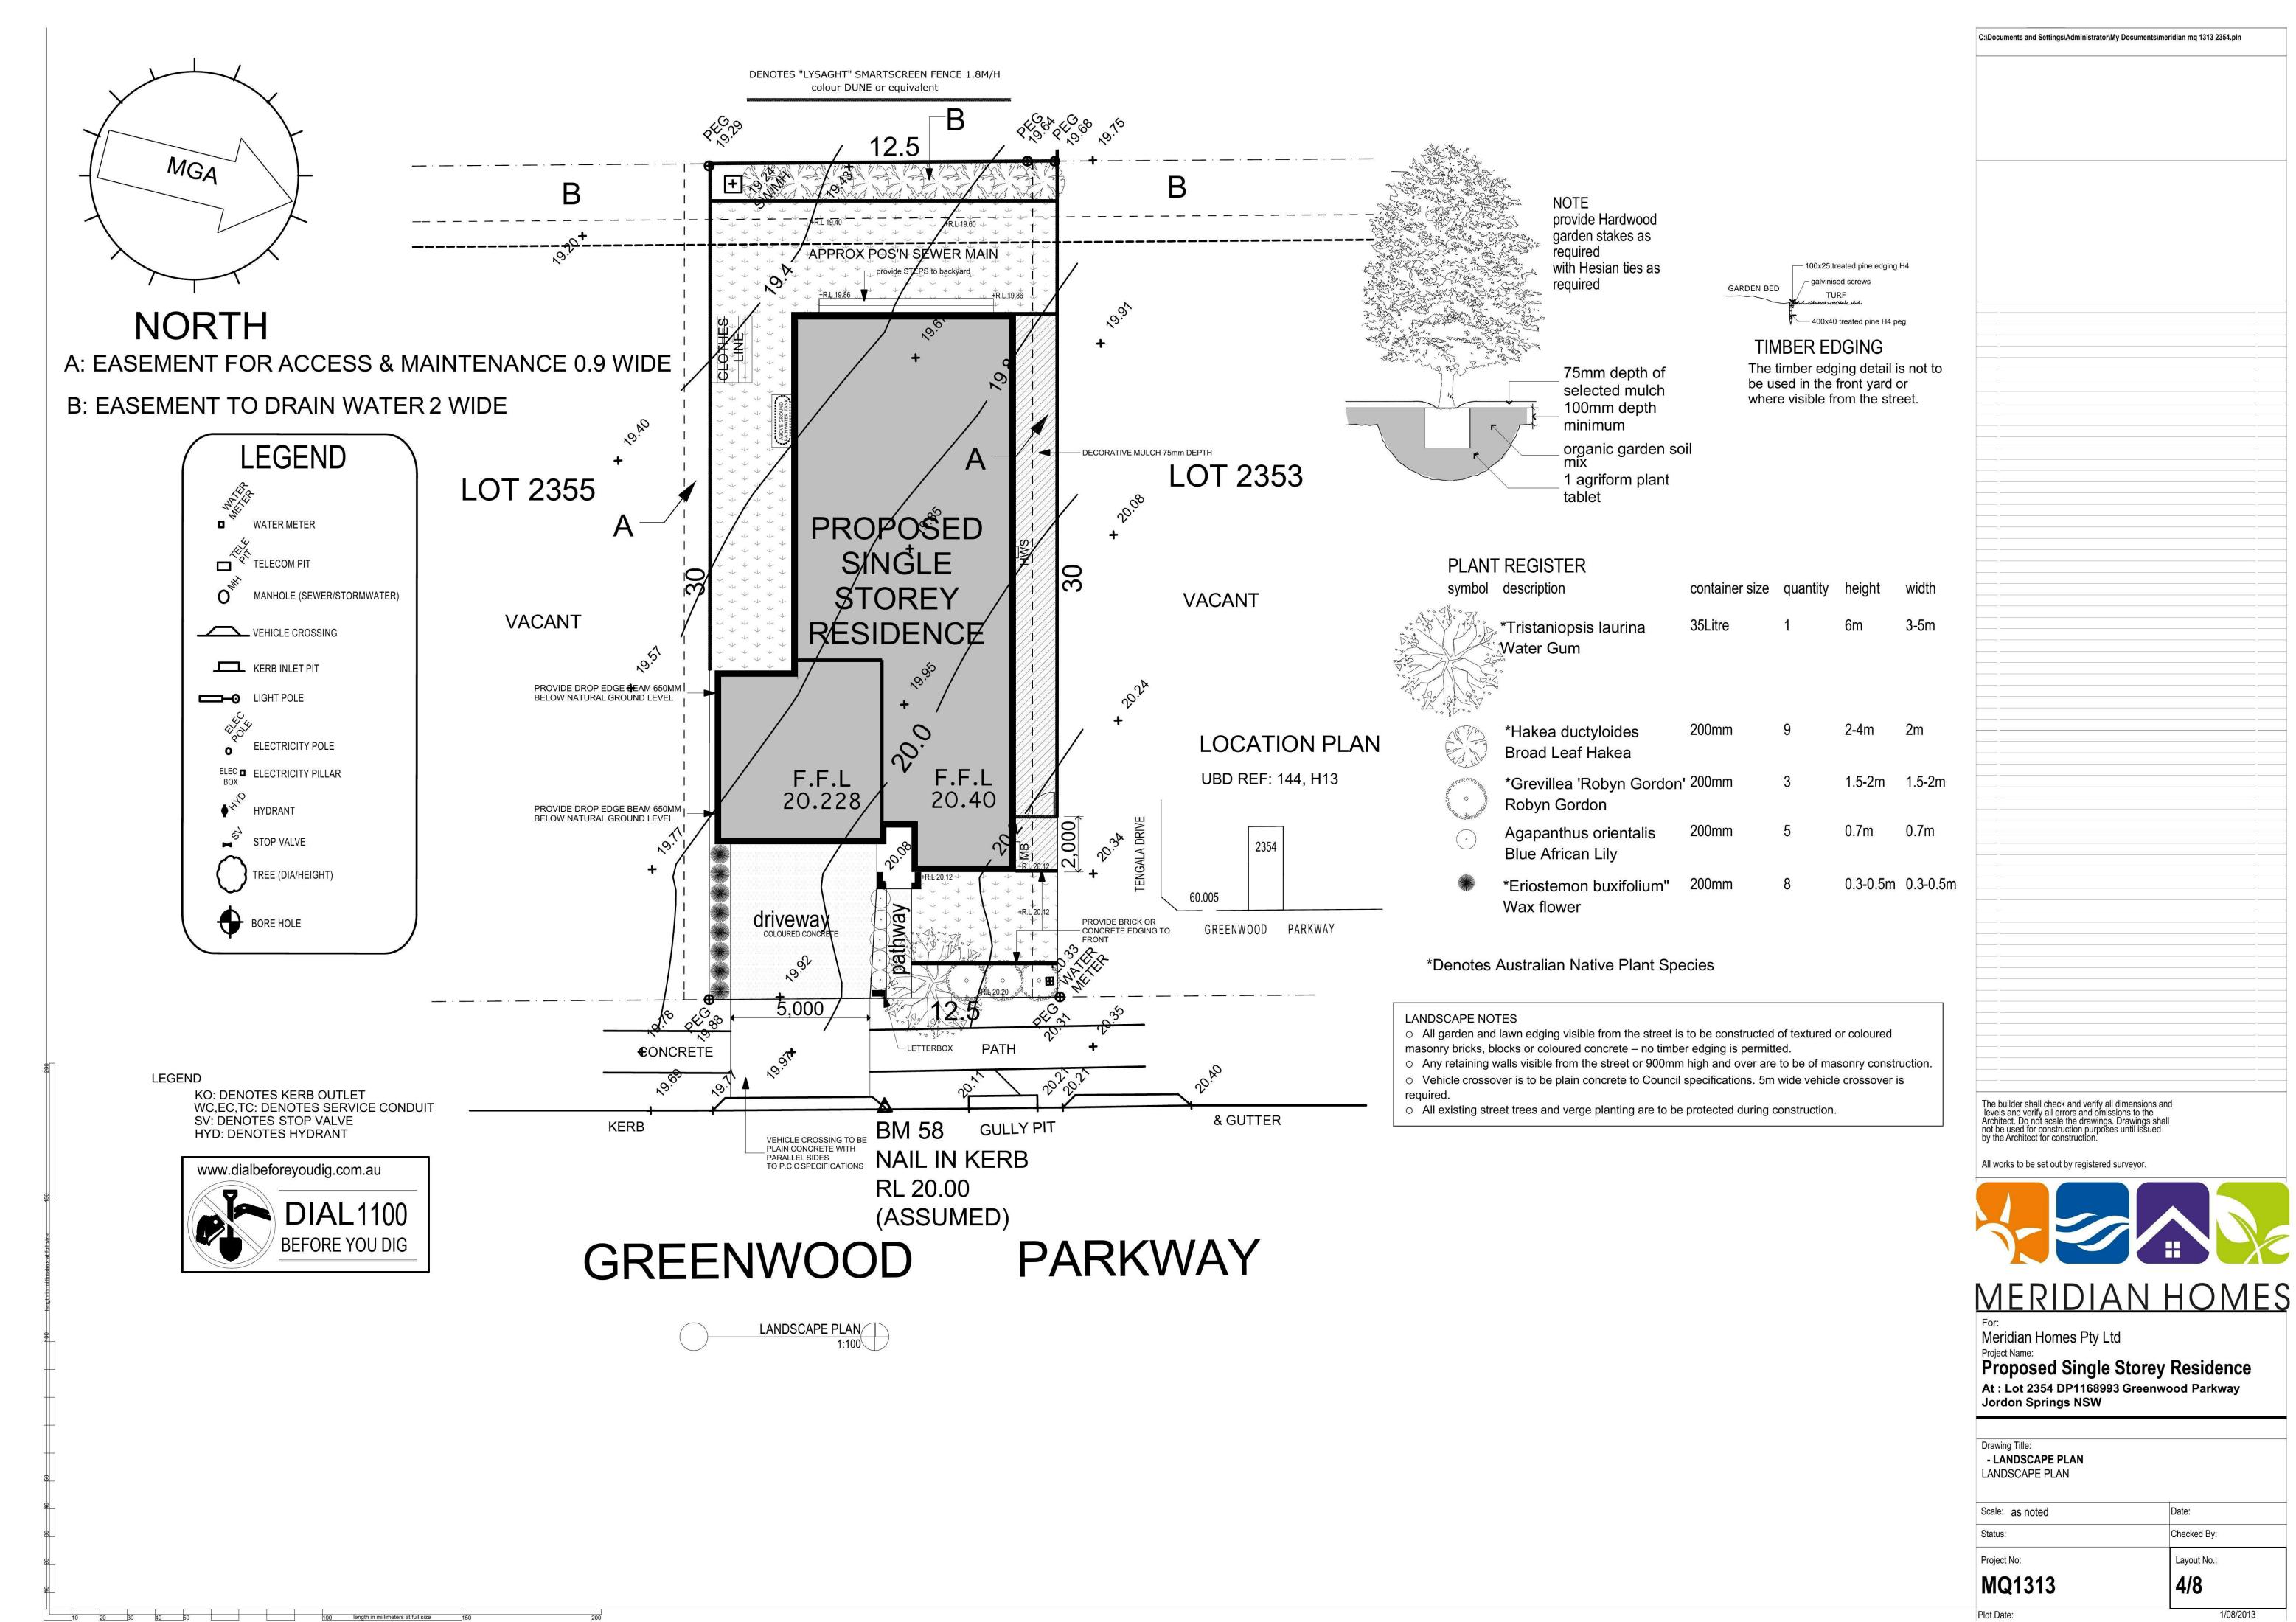

Plot Date:

1/08/2013

