# 19 TODD ROW, SAINT CLAIR PROPOSED CHILDCARE CENTRE

STORMWATER CONCEPT PLANS



## LOCALITY PLAN

DRAWING INDEX					
Drawing No.	DESCRIPTION				
000	COVER SHEET PLAN				
101	STORMWATER CONCEPT PLAN BASEMENT LEVEL SHEET 1 OF 2				
102	STORMWATER CONCEPT PLAN BASEMENT LEVEL SHEET 2 OF 2				
103	STORMWATER CONCEPT PLAN				
104	BIO-RETENTION/WSUD BASIN DETAILS, LONG SECTION, MUSIC MODEL AND RESULTS				
105	RAINWATER TANK DETAIL, REUSE AND NODE WATER BALANCE				
106	SEDIMENT & EROSION CONTROL PLAN				
107	LEVEL 1 PLAN & MISCELLANEOUS DETAILS SHEET				

NOT FOR CONSTRUCTION

															Certification By Dr. Michel Chaaya in affiliation with Joe Bacha (formerly Australian Consulting Engineers):
															Australian Consulting Engineers):
															1
Α		ISSUE	FOR S	4.55						25/01	/2022	AGN	JS	SF	
Issue		Description	1							Da	ate	Desig	n Che	cked	
0	1cn	n at full size					10cm							20cm	

Baini Design

1B Villiers street Parramatta
NSW 2150 Sydney, Australia
EMAIL:
info@bainidesign.com.au
PHONE: + 61 2 9188 8250


City of Penrith Council Level 4, 470 Church Street,
Parramatta NSW 2150

PO BOX 3579 Parramatta 2124 Company: Telford Consulting Pty Ltd


19 TODD ROW, SAINT CLAIR
PROPOSED CHILD CARE CENTRE
STORMWATER MANAGEMENT PLANS
SECTION 4.55

COVER SHEET PLAN

Scale A1 Project No. Dwg. No. 000

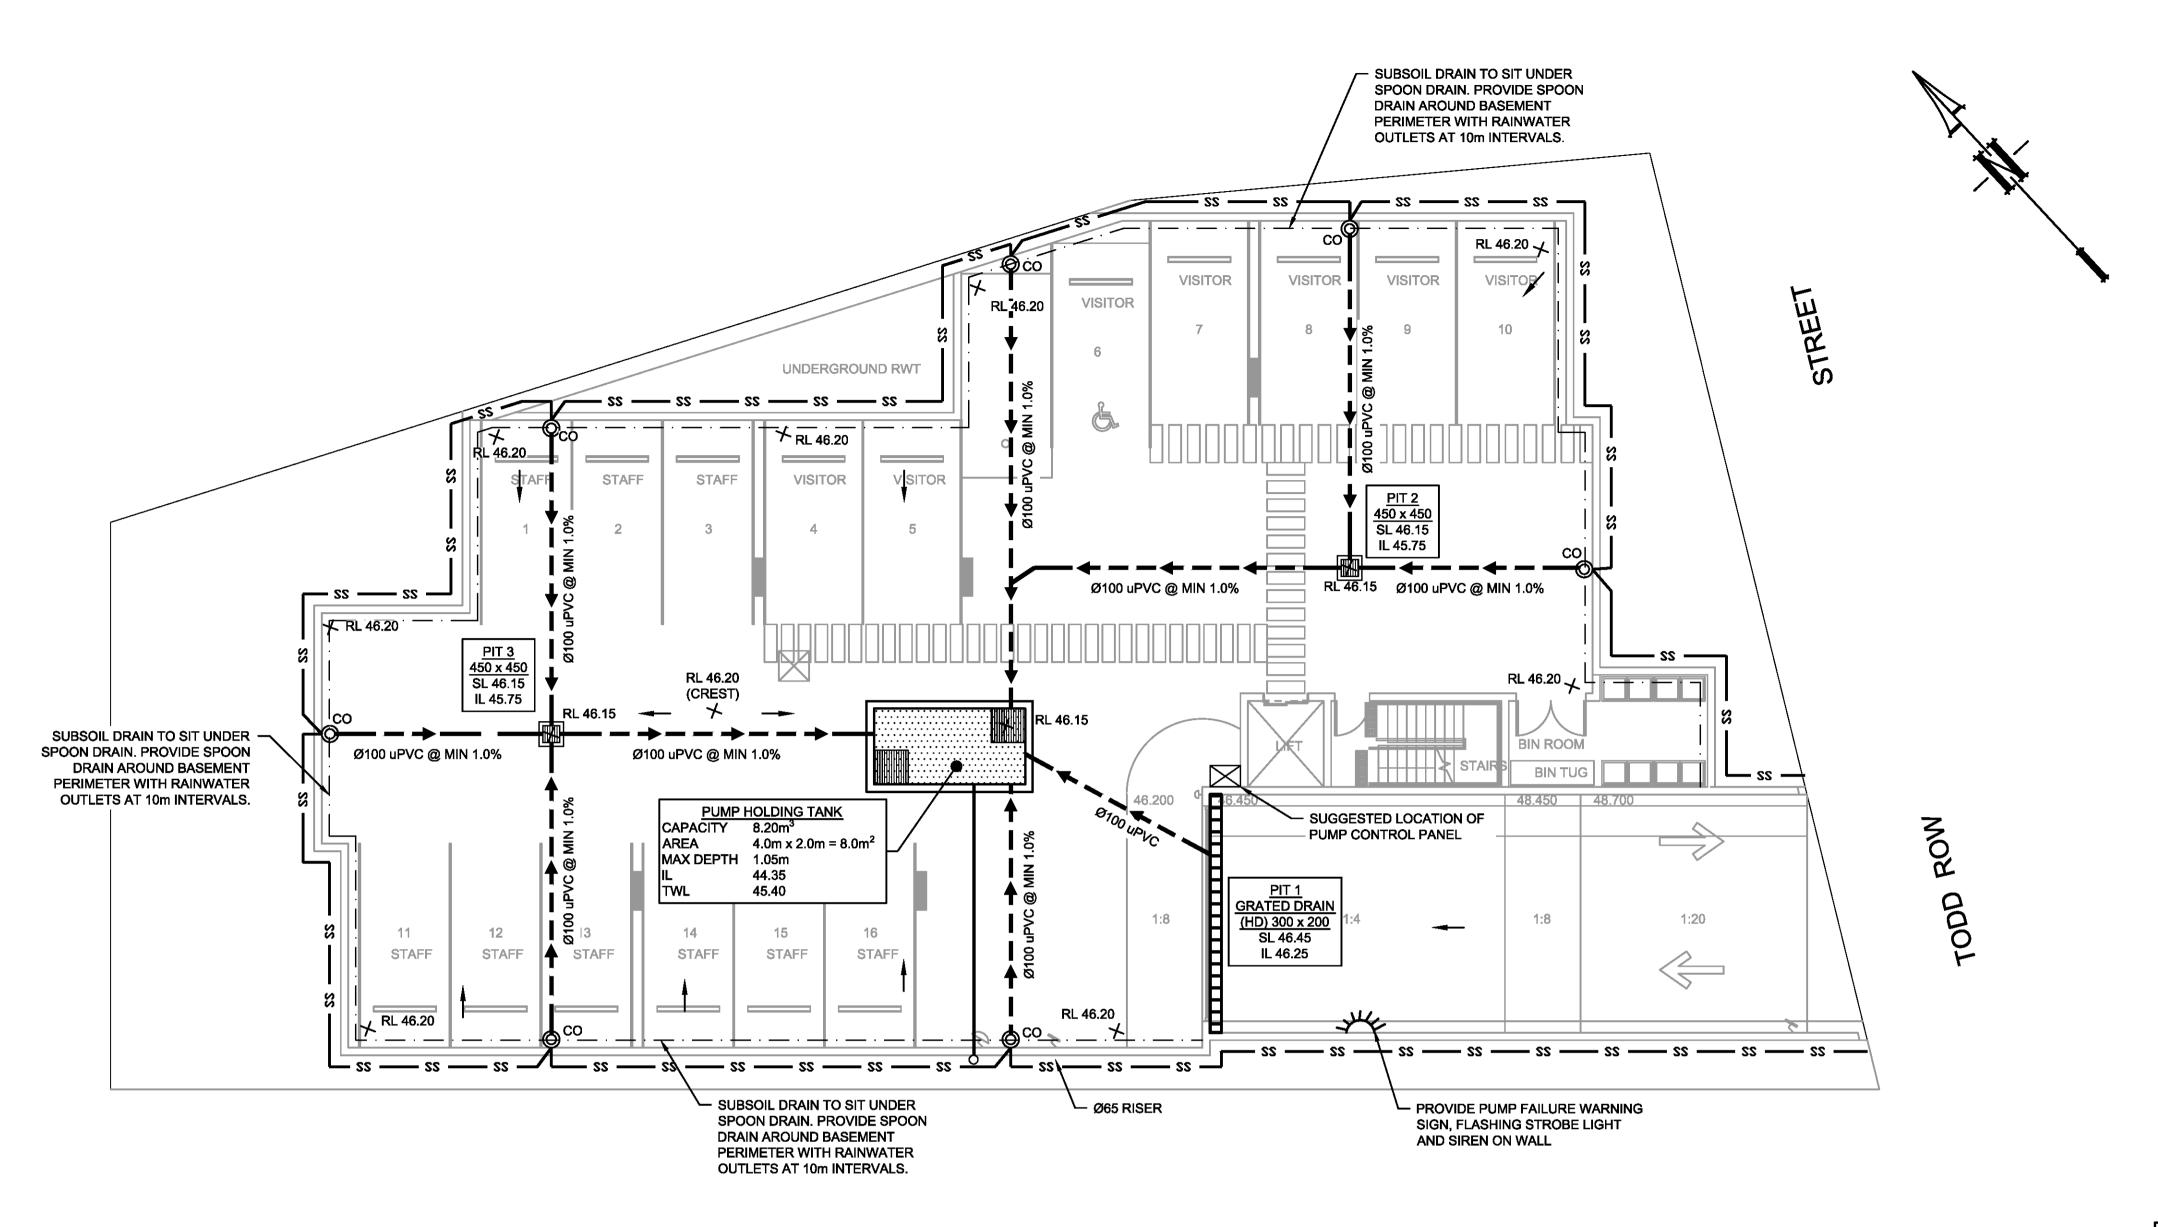



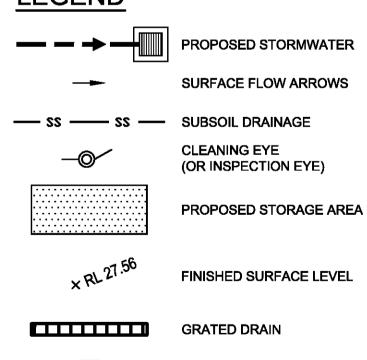

**FLOOR GRATE** 

### STANDARD PUMP OUT DESIGN NOTES

THE PUMP OUT SYSTEM SHALL BE DESIGN TO BE OPERATED IN THE FOLLOWING MANNER: 1 - THE PUMP SHALL BE PROGRAMMED TO WORK ALTERNATELY TO ALLOW BOTH PUMPS TO HAVE AN EQUAL OPERATION LOAD AND PUMP LIFE.

- 2 A FLOAT SHALL BE PROVIDED TO ENSURE OF THE MINIMUM REQUIRED WATER LEVEL IS MAINTAINED WITHIN THE SUMP AREA OF THE BELOW GROUND TANK. IN THIS REGARD THIS FLOAT WILL FUNCTION AS AN OFF SWITCH FOR THE PUMPS AT THE MINIMUM WATER LEVEL. THE SAME FLOAT SHALL BE SET TO TURN ONE OF THE PUMPS ON UPON THE WATER LEVEL IN THE TANK RISING TO APPROXIMATELY 300mm ABOVE THE MINIMUM WATER LEVEL. THE PUMP SHALL OPERATE UNTIL THE TANK IS DRAINED TO THE MINIMUM WATER LEVEL.
- 3 A SECOND FLOAT SHALL BE PROVIDE AT A HIGH LEVEL, WHICH IS APPROXIMATELY THE ROOF LEVEL OF THE BELOW GROUND TANK. THIS FLOAT SHALL START THE OTHER PUMP THAT IS NOT OPERATING AND ACTIVATE THE ALARM.
- 4 AN ALARM SYSTEM SHALL BE PROVIDE WITH A FLASHING STROBE LIGHT AND A PUMP FAILURE WARNING SIGN WHICH ARE TO BE LOCATED AT THE DRIVEWAY ENTRANCE TO THE BASEMENT LEVEL THE ALARM SYSTEM SHALL BE PROVIDED WITH A BATTERY BACK-UP IN CASE OF POWER FAILURE.
- 5 A CONFINED SPACE DANGER SIGN SHALL BE PROVIDED AT ALL ACCESS POINT TO THE PUMP-OUT STORAGE TANK IN ACCORDANCE WITH THE UPPER PARRAMATA RIVER CATCHMENT TRUST OSD HANDBOOK.

#### **BASEMENT PLAN**

**SCALE 1:100** 



# WARNING

**PUMP OUT SYSTEM** FAILURE IN BASEMENT WHEN LIGHT IS FLASHING AND SIREN SOUNDING

**BASEMENT PUMP OUT FAILURE WARNING SIGN** SIGN SHALL BE PLACED IN A CLEAR AND VISIBLE LOCATION WHERE VEHICLES ENTER THE BASEMENT

COLOURS:
"WARNING" = RED BORDER AND OTHER LETTERING = BLACK



#### CONFINED SPACE DANGER SIGN

A) A CONFINED SPACE DANGER SIGN SHALL BE POSITIONED IN A LOCATION AT ALL ACCESS POINTS, SUCH THAT IT IS CLEARLY VISIBLE TO PERSONS PROPOSING TO ENTER THE BELOW GROUND TANK/S CONFINED SPACE.

B) MINIMUM DIMENSIONS OF THE SIGN - 300mm x 450mm (LARGE ENTRIES, SUCH AS DOORS) -250mm x 180mm (SMALL ENTRIES SUCH AS GRATES & MANHOLES)

C) THE SIGN SHALL BE MANUFACTURED FROM COLOUR BONDED ALUMINUM OR POLYPROPYLENE

D) SIGN SHALL BE AFFIXED USING SCREWS AT EACH CORNER OF

THE SIGN

COLOURS:
"DANGER" & BACKGROUND = WHITE ELLIPTICAL AREA = RED RECTANGLE CONTAINING ELLIPSE = BLACK BORDER AND OTHER LETTERING = BLACK

NOT FOR CONSTRUCTION

n affiliation with Joe Bacha (formerly Australian Consulting Engineers): A ISSUE FOR S4.55 25/01/2022 | AGN | JSF Issue Description Design Checked

Baini Design 1B Villiers street Parramatta NSW 2150 Sydney, Australia EMAIL: info@bainidesign.com.au PHONE: + 61 2 9188 8250

City of Penrith Council SCALE 1:100 @ A1

Level 4, 470 Church Street,

Parramatta NSW 2150


Email: info@telfordcivil.com.au Phone: 02 7809 4931 PO BOX 3579 Parramatta 2124 Company : Telford Consulting Pty Ltd


19 TODD ROW, SAINT CLAIR PROPOSED CHILD CARE CENTRE STORMWATER MANAGEMENT PLANS | SHEET 1 OF 2 SECTION 4.55


STORMWATER CONCEPT PLAN BASEMENT LEVEL

2021380 101 1:100

Document Set ID: 9895136 Version: 1, Version Date: 01/02/2022

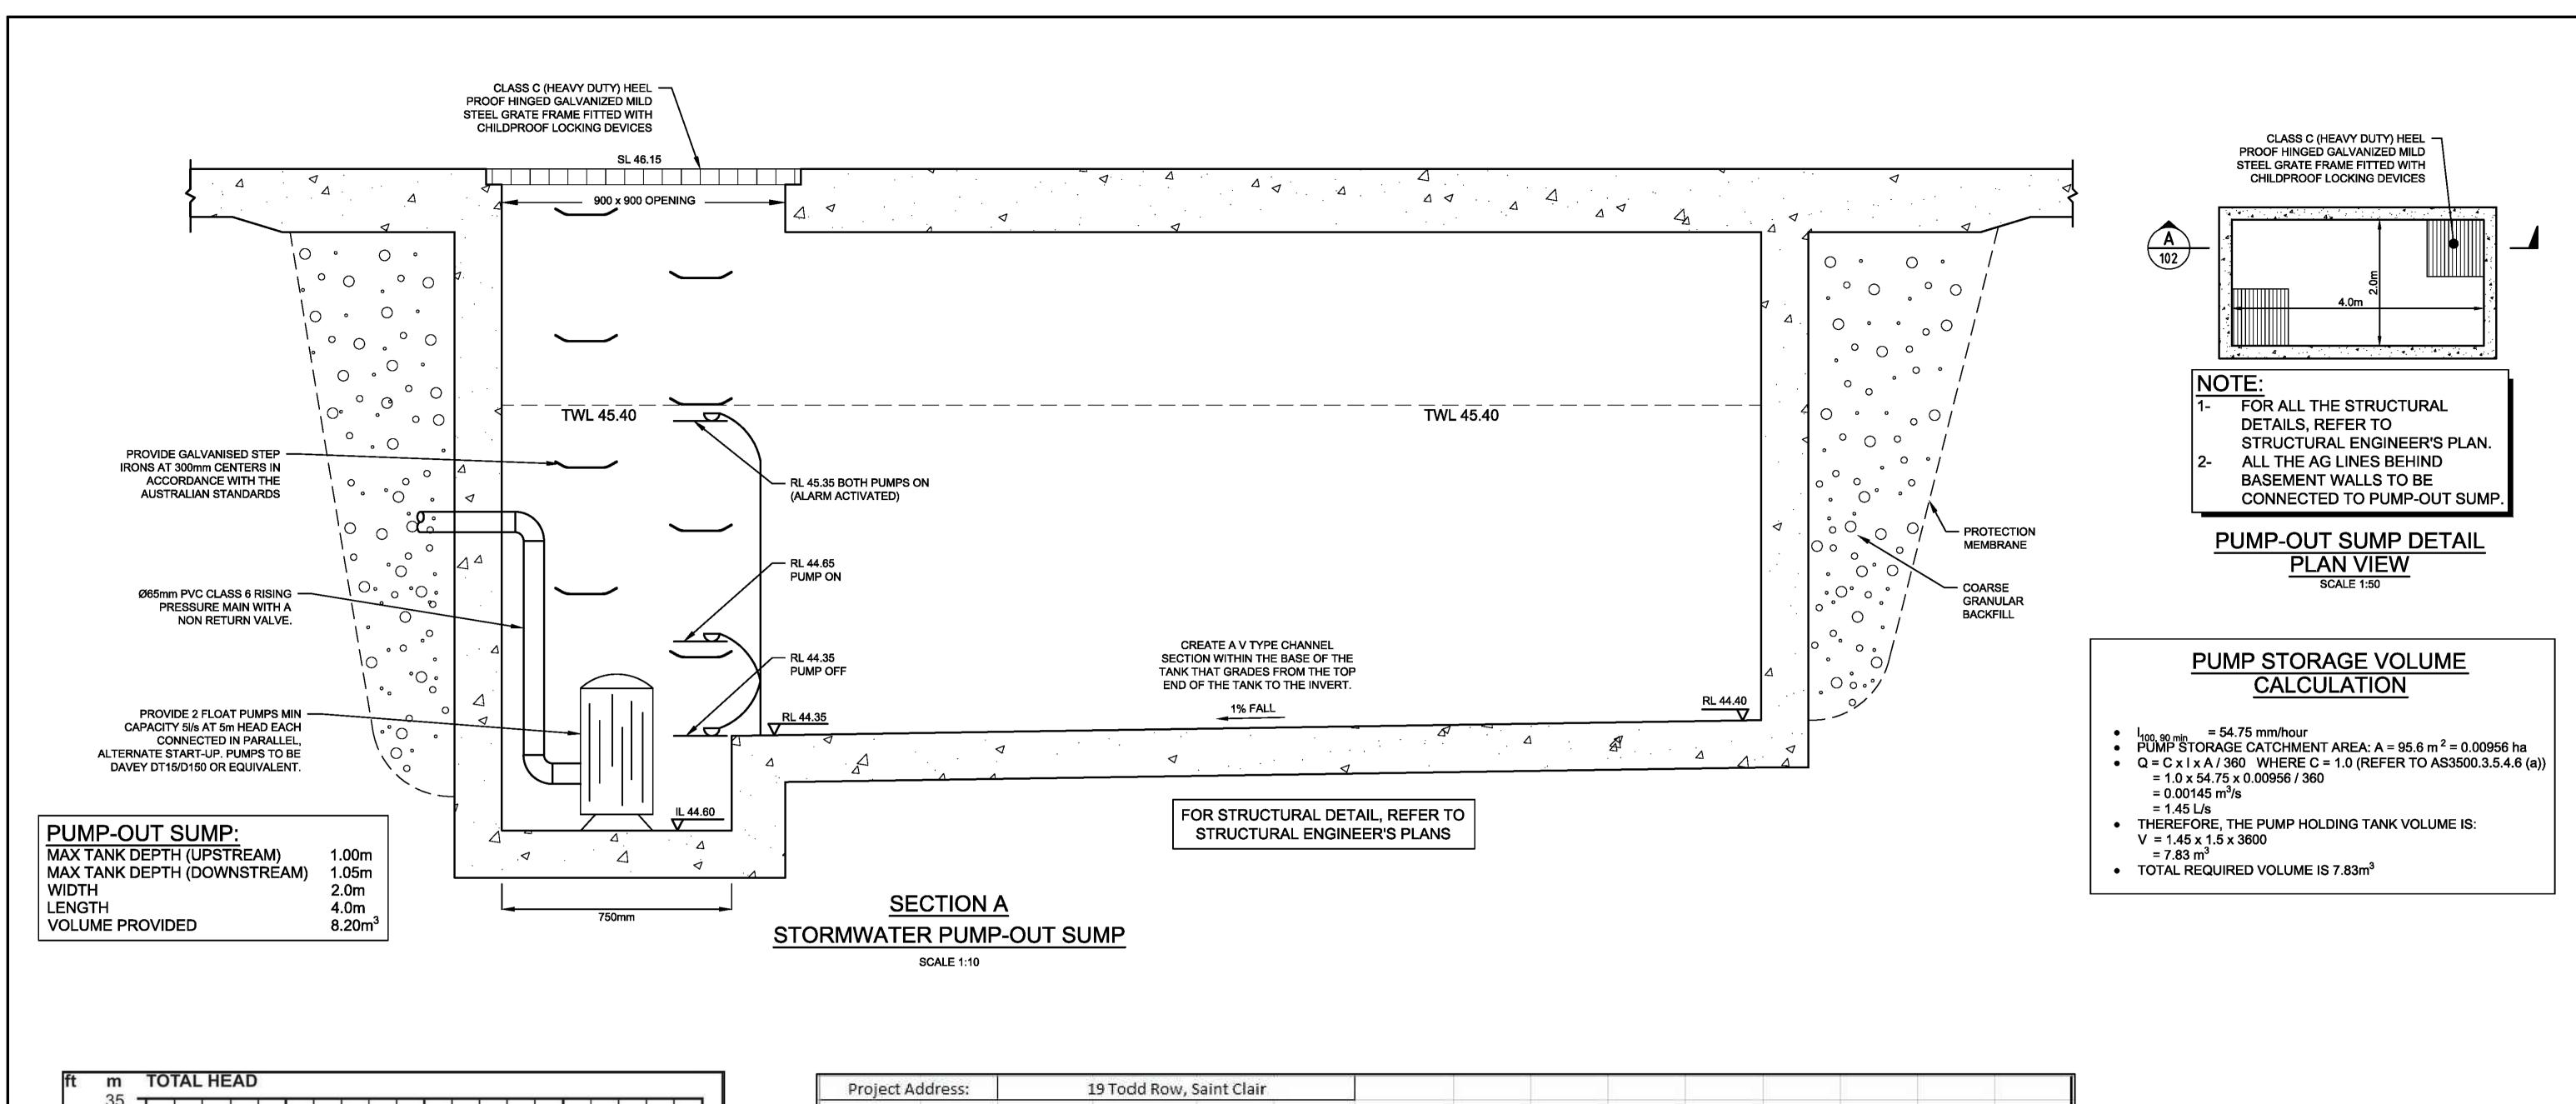

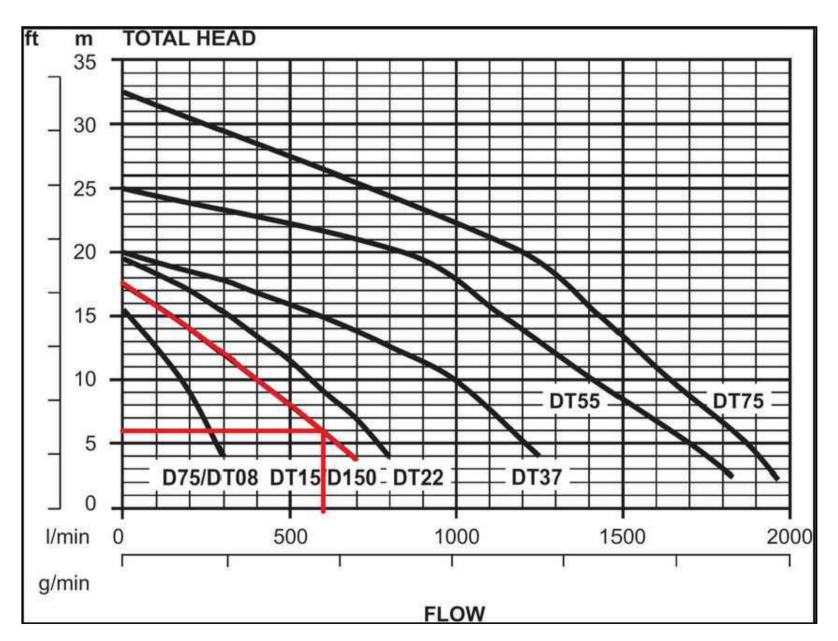

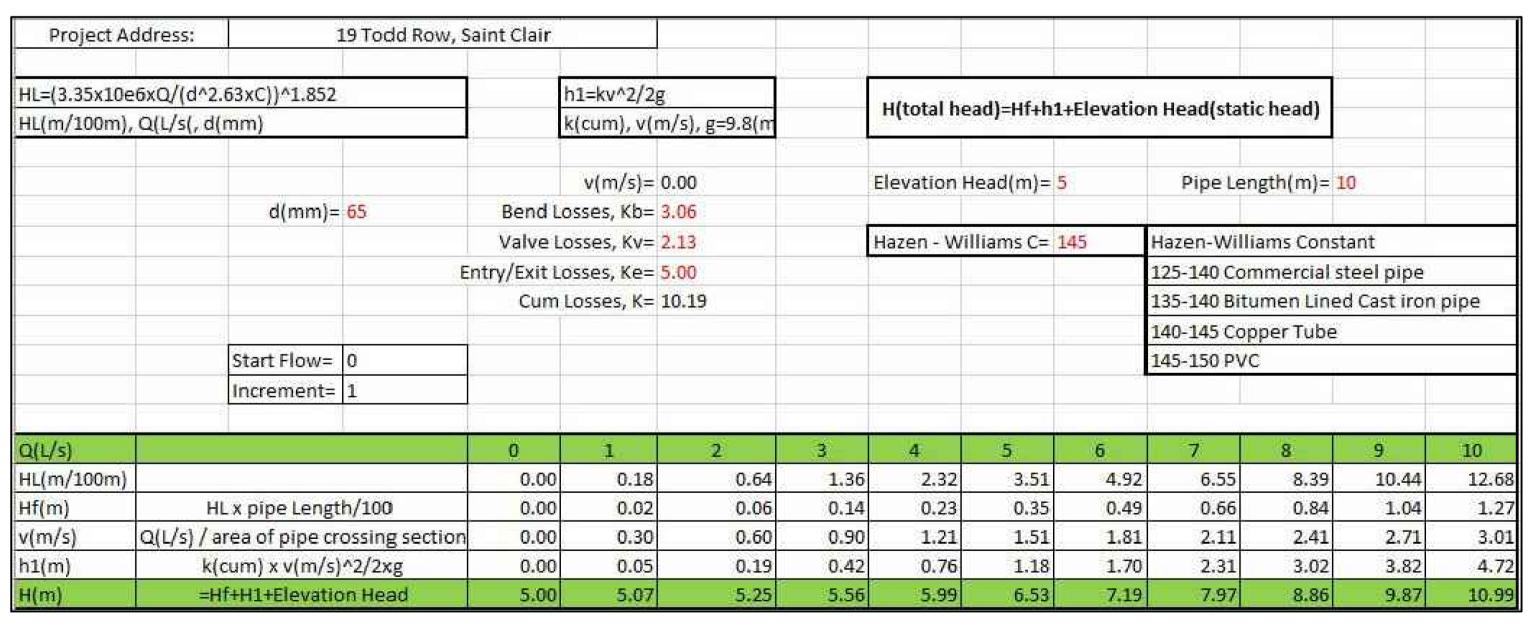

# UNDERGROUND PUMP - OUT SUMP STAGED STORAGE CALCULATIONS

DEPTH (mm)	AREA (m²)	CUMULATIVE VOLUME (m³)
0	8.0	0
100	8.0	0.6
200	8.0	1.4
300	8.0	2.2
400	8.0	3.0
500	8.0	3.8
600	8.0	4.6
700	8.0	5.6
800	8.0	6.2
900	8.0	7.0
1000	8.0	7.8
1050	8.0	8.2

NOT FOR CONSTRUCTION

Arct formerly Australian Consulting Engineers):

A ISSUE FOR S4.55

A ISSUE FOR S4.55

Date Design Checked

Arct in affiliation with Joe Bacha (formerly Australian Consulting Engineers):

A ISSUE FOR S4.55

Date Design Checked

Ph

Architect

Baini Design

1B Villiers street Parramatta
NSW 2150 Sydney, Australia
EMAIL:
info@bainidesign.com.au
PHONE: + 61 2 9188 8250

City of SCALE 1:10 @ A1

Penrith Council

Scale

0 200 400

L 1 1

SCALE 1:10 @ A1

SCALE 1:50 @ A1

Level 4, 470 Church Street,
Parramatta NSW 2150

TELFORDCIVIL

Email: info@telfordcivil.com.au
Phone: 02 7809 4931


PO BOX 3579 Parramatta 2124 Company : Telford Consulting Pty Ltd

19 TODD ROW, SAINT CLAIR
PROPOSED CHILD CARE CENTRE
STORMWATER MANAGEMENT PLANS
SECTION 4.55


Scale
A1 Project No.
2021


STORMWATER CONCEPT PLAN
BASEMENT LEVEL
SHEET 2 OF 2

As Shown Project No. Dwg. No. 102

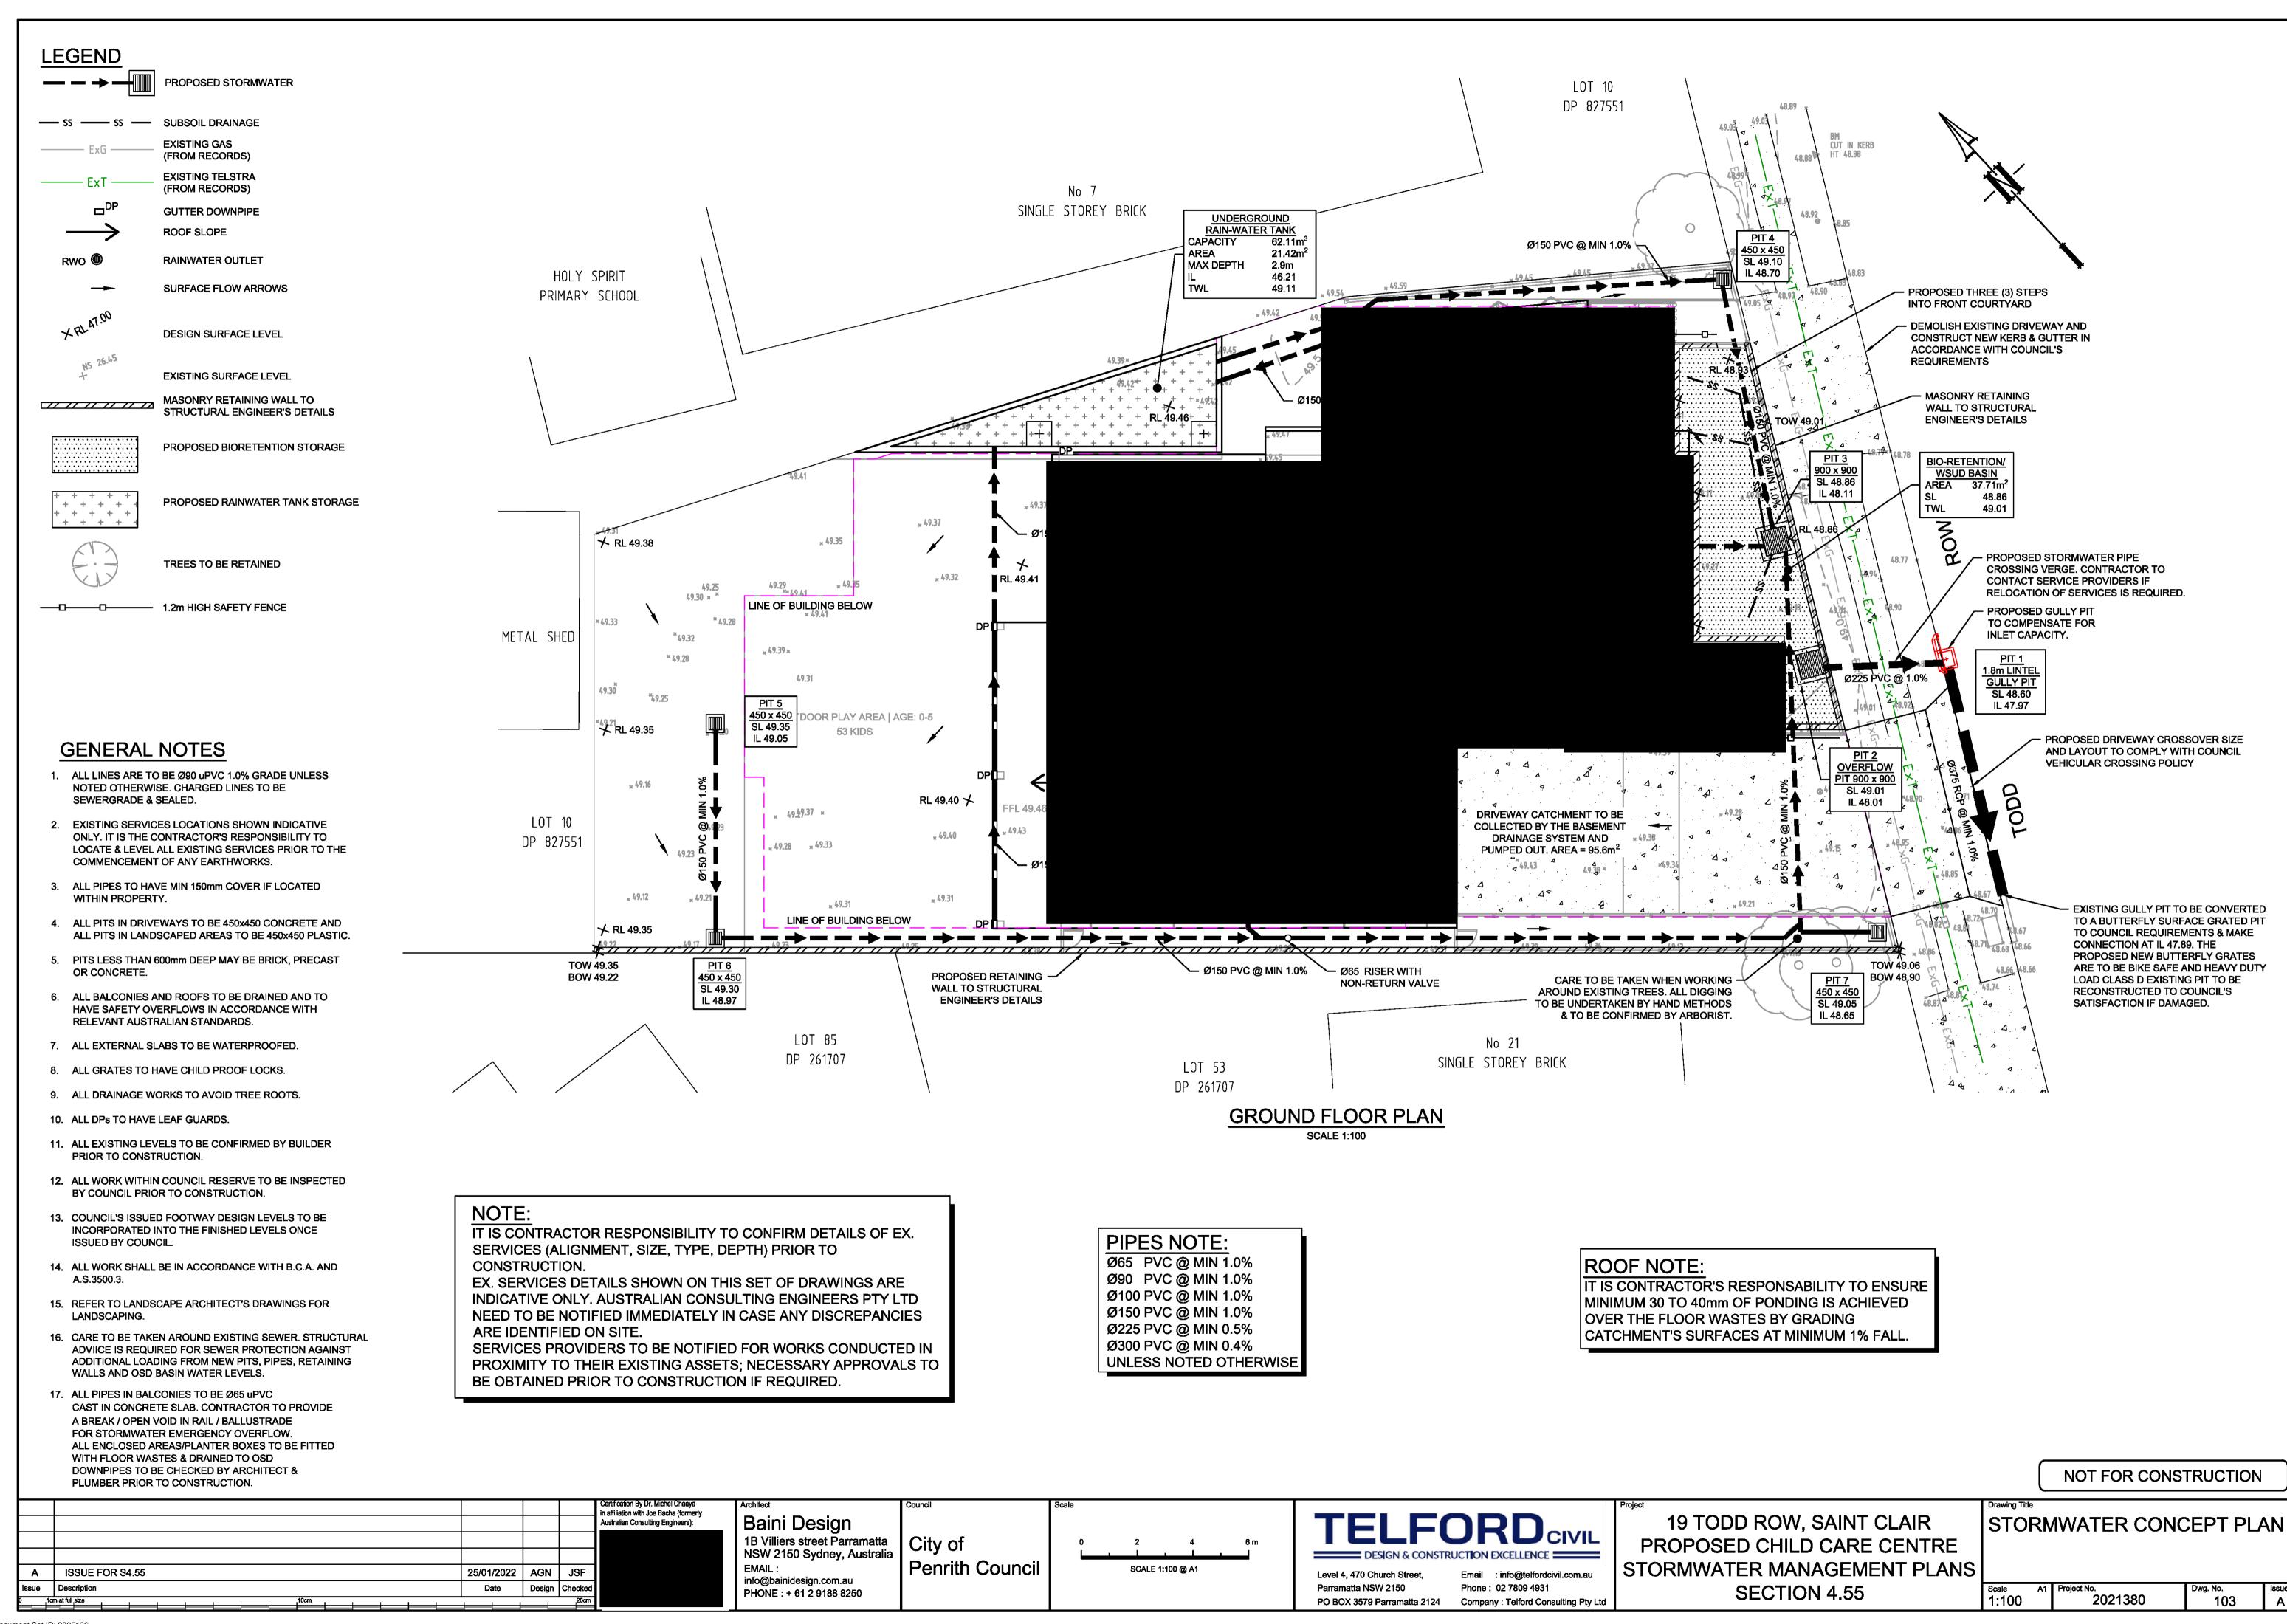

# ROOF TO RAINWATER TANK THEN TO BIO-RETENTION = 335m² (R00F) PERVIOUS TO BIO-RETENTION = 175.5m² (MIXED 100% PERVIOUS) ROOF TO BIO-RETENTION = 11.7m² (R00F)

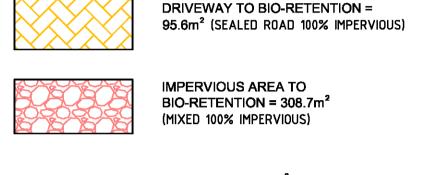

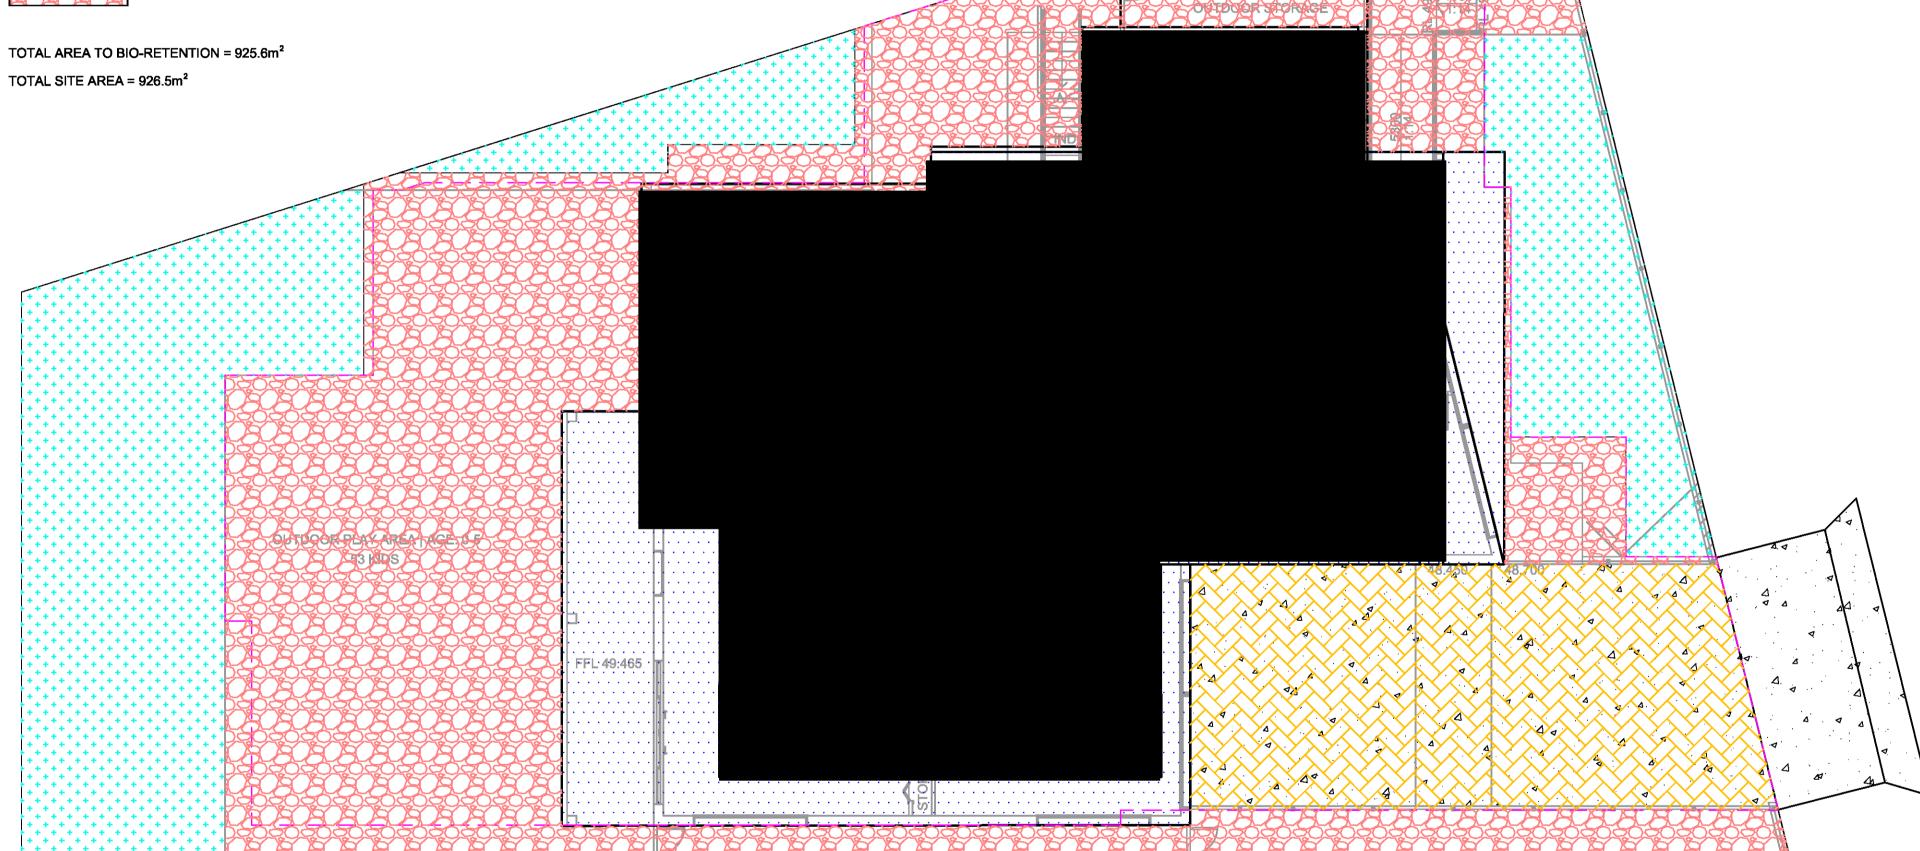

WSUD CATCHMENT PLAN
SCALE 1:100

NOT FOR CONSTRUCTION

A ISSUE FOR S4.55

Sue Description

Date Design Checked

1 Issue Description

Date Design Checked

Description

Date Design Checked

Description

Date Design Checked


Description

Date Description

Baini Design

1B Villiers street Parramatta
NSW 2150 Sydney, Australia
EMAIL:
info@bainidesign.com.au
PHONE: + 61 2 9188 8250

City of Penrith Council

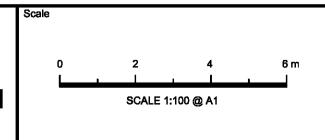

TELFORDCIVIL

DESIGN & CONSTRUCTION EXCELLENCE

Level 4, 470 Church Street,
Parramatta NSW 2150


Email: info@telfordcivil.com.au
Phone: 02 7809 4931


PO BOX 3579 Parramatta 2124 Company : Telford Consulting Pty Ltd


19 TODD ROW, SAINT CLAIR
PROPOSED CHILD CARE CENTRE
STORMWATER MANAGEMENT PLANS
SECTION 4.55


WSUD CATCHMENT PLAN

Scale A1 Project No. Dwg. No. Issue 1:100 2021380 104 A

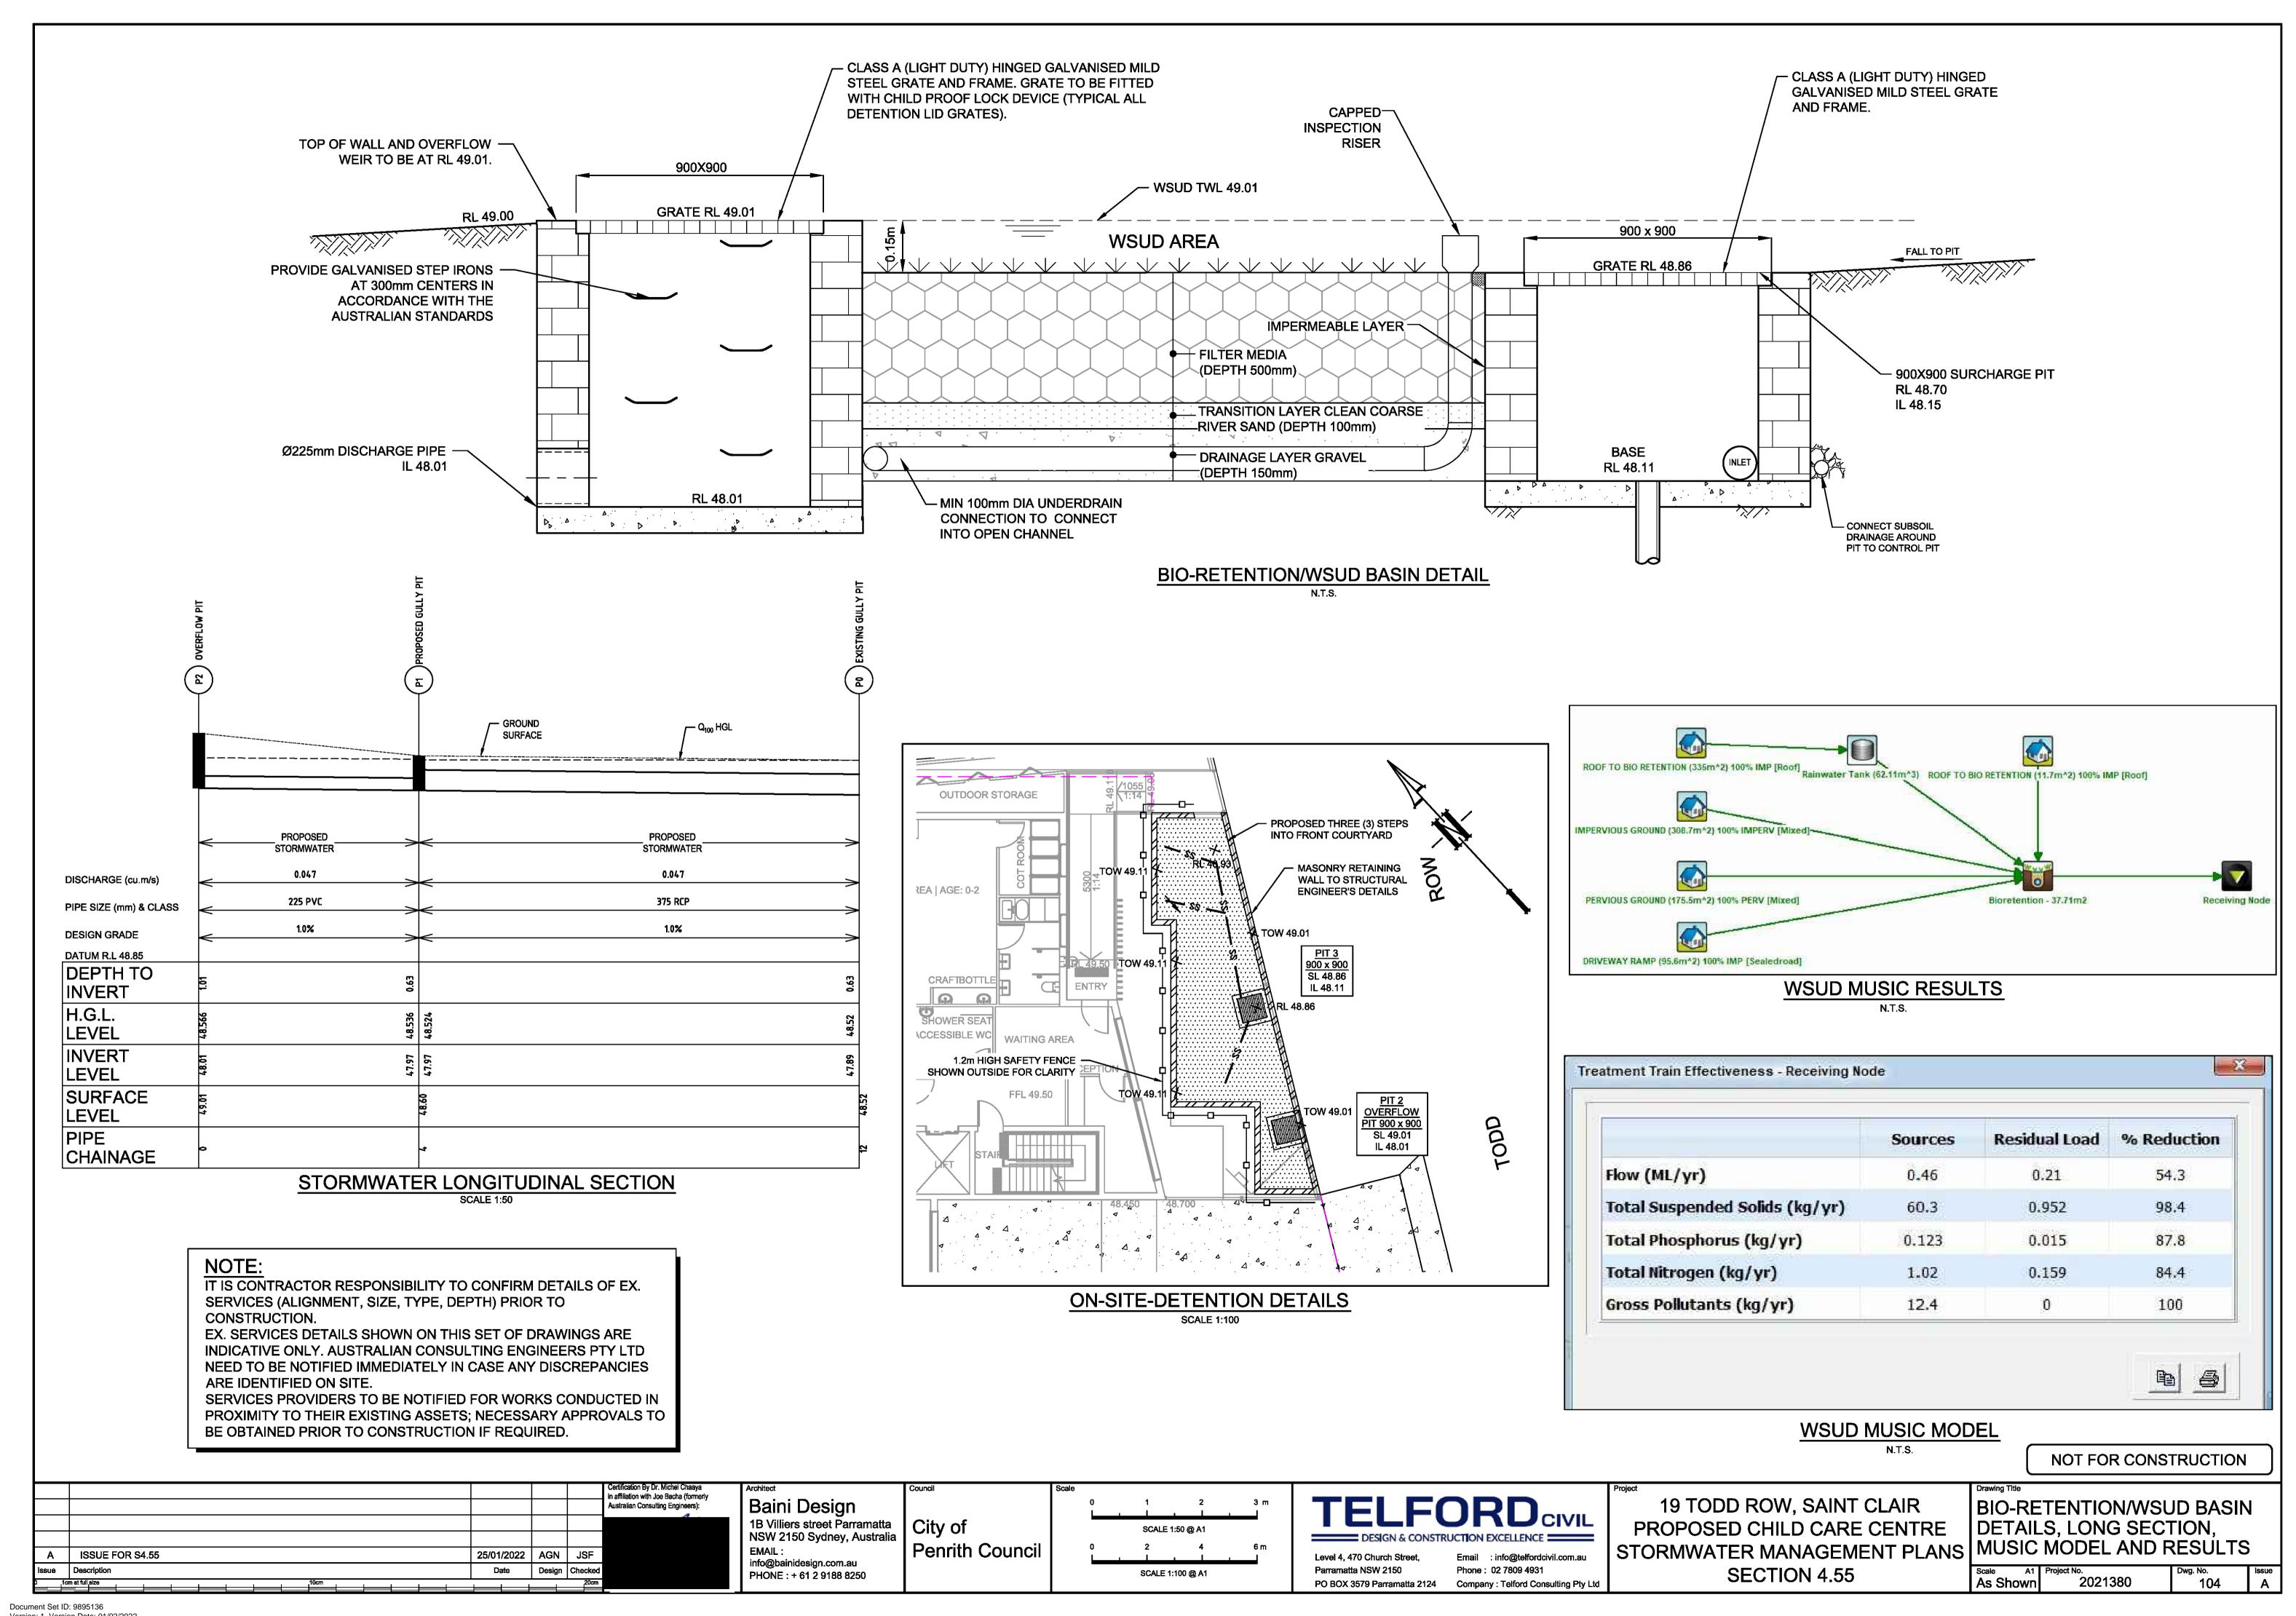

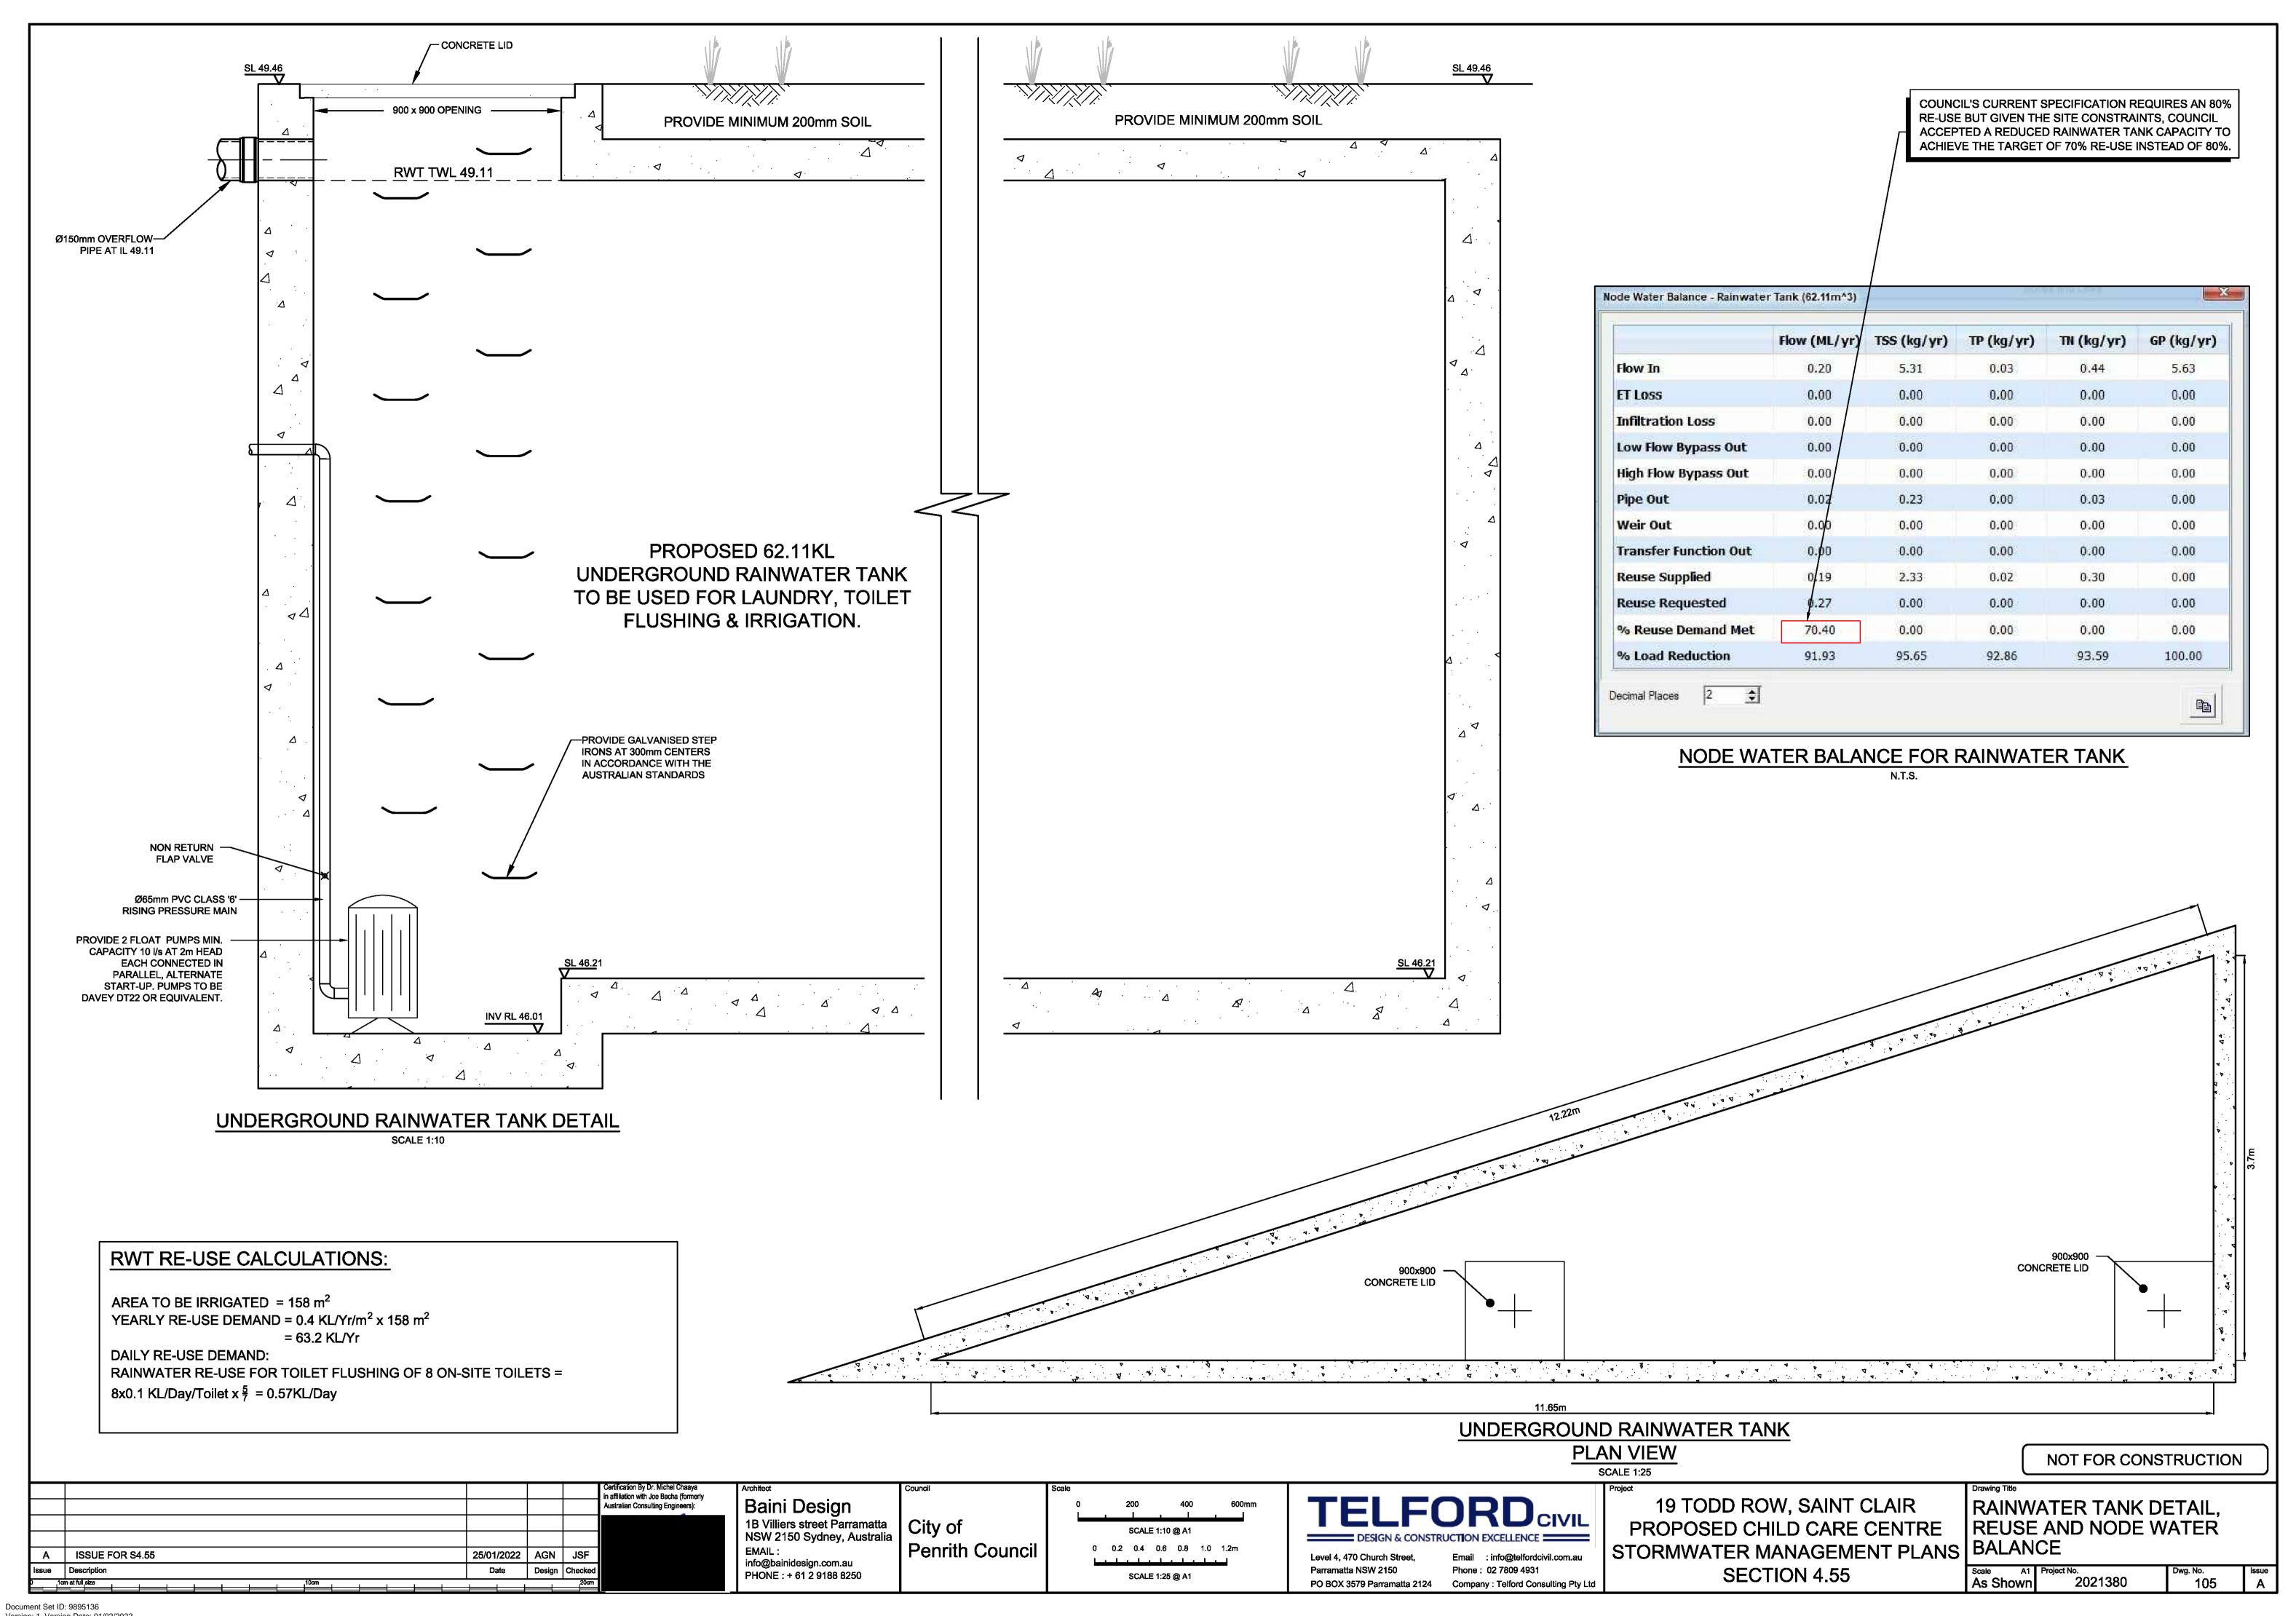

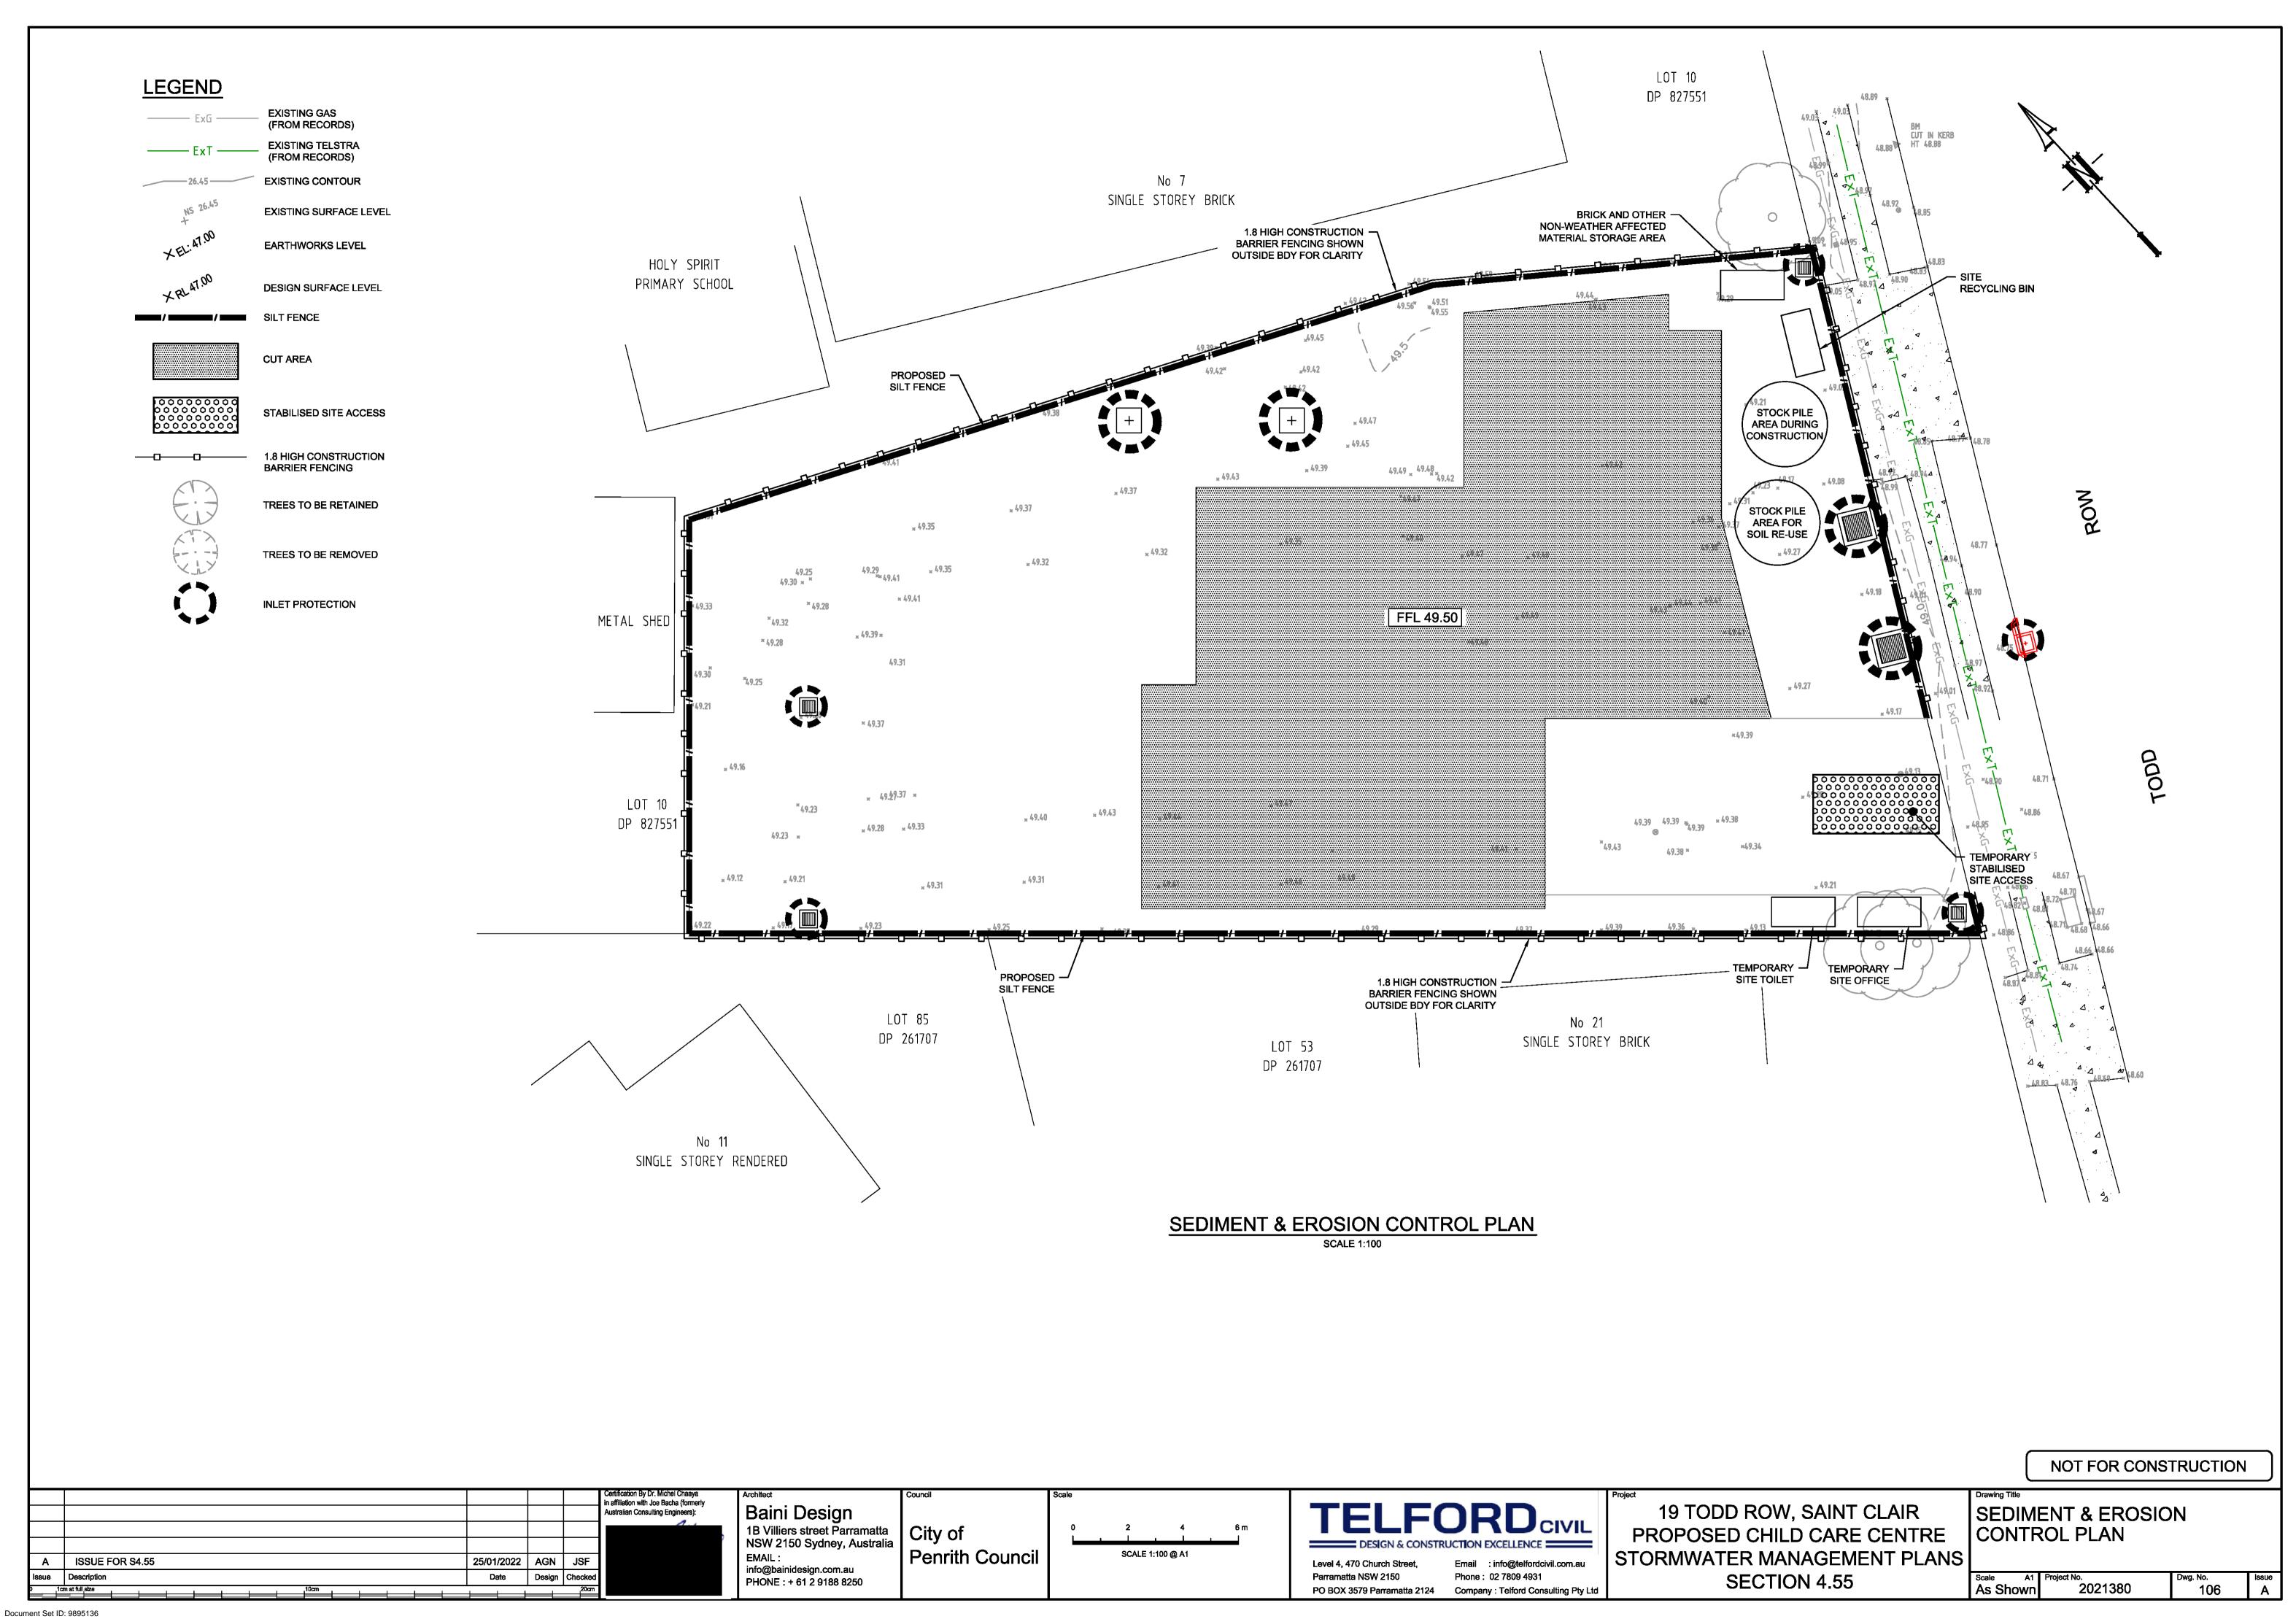

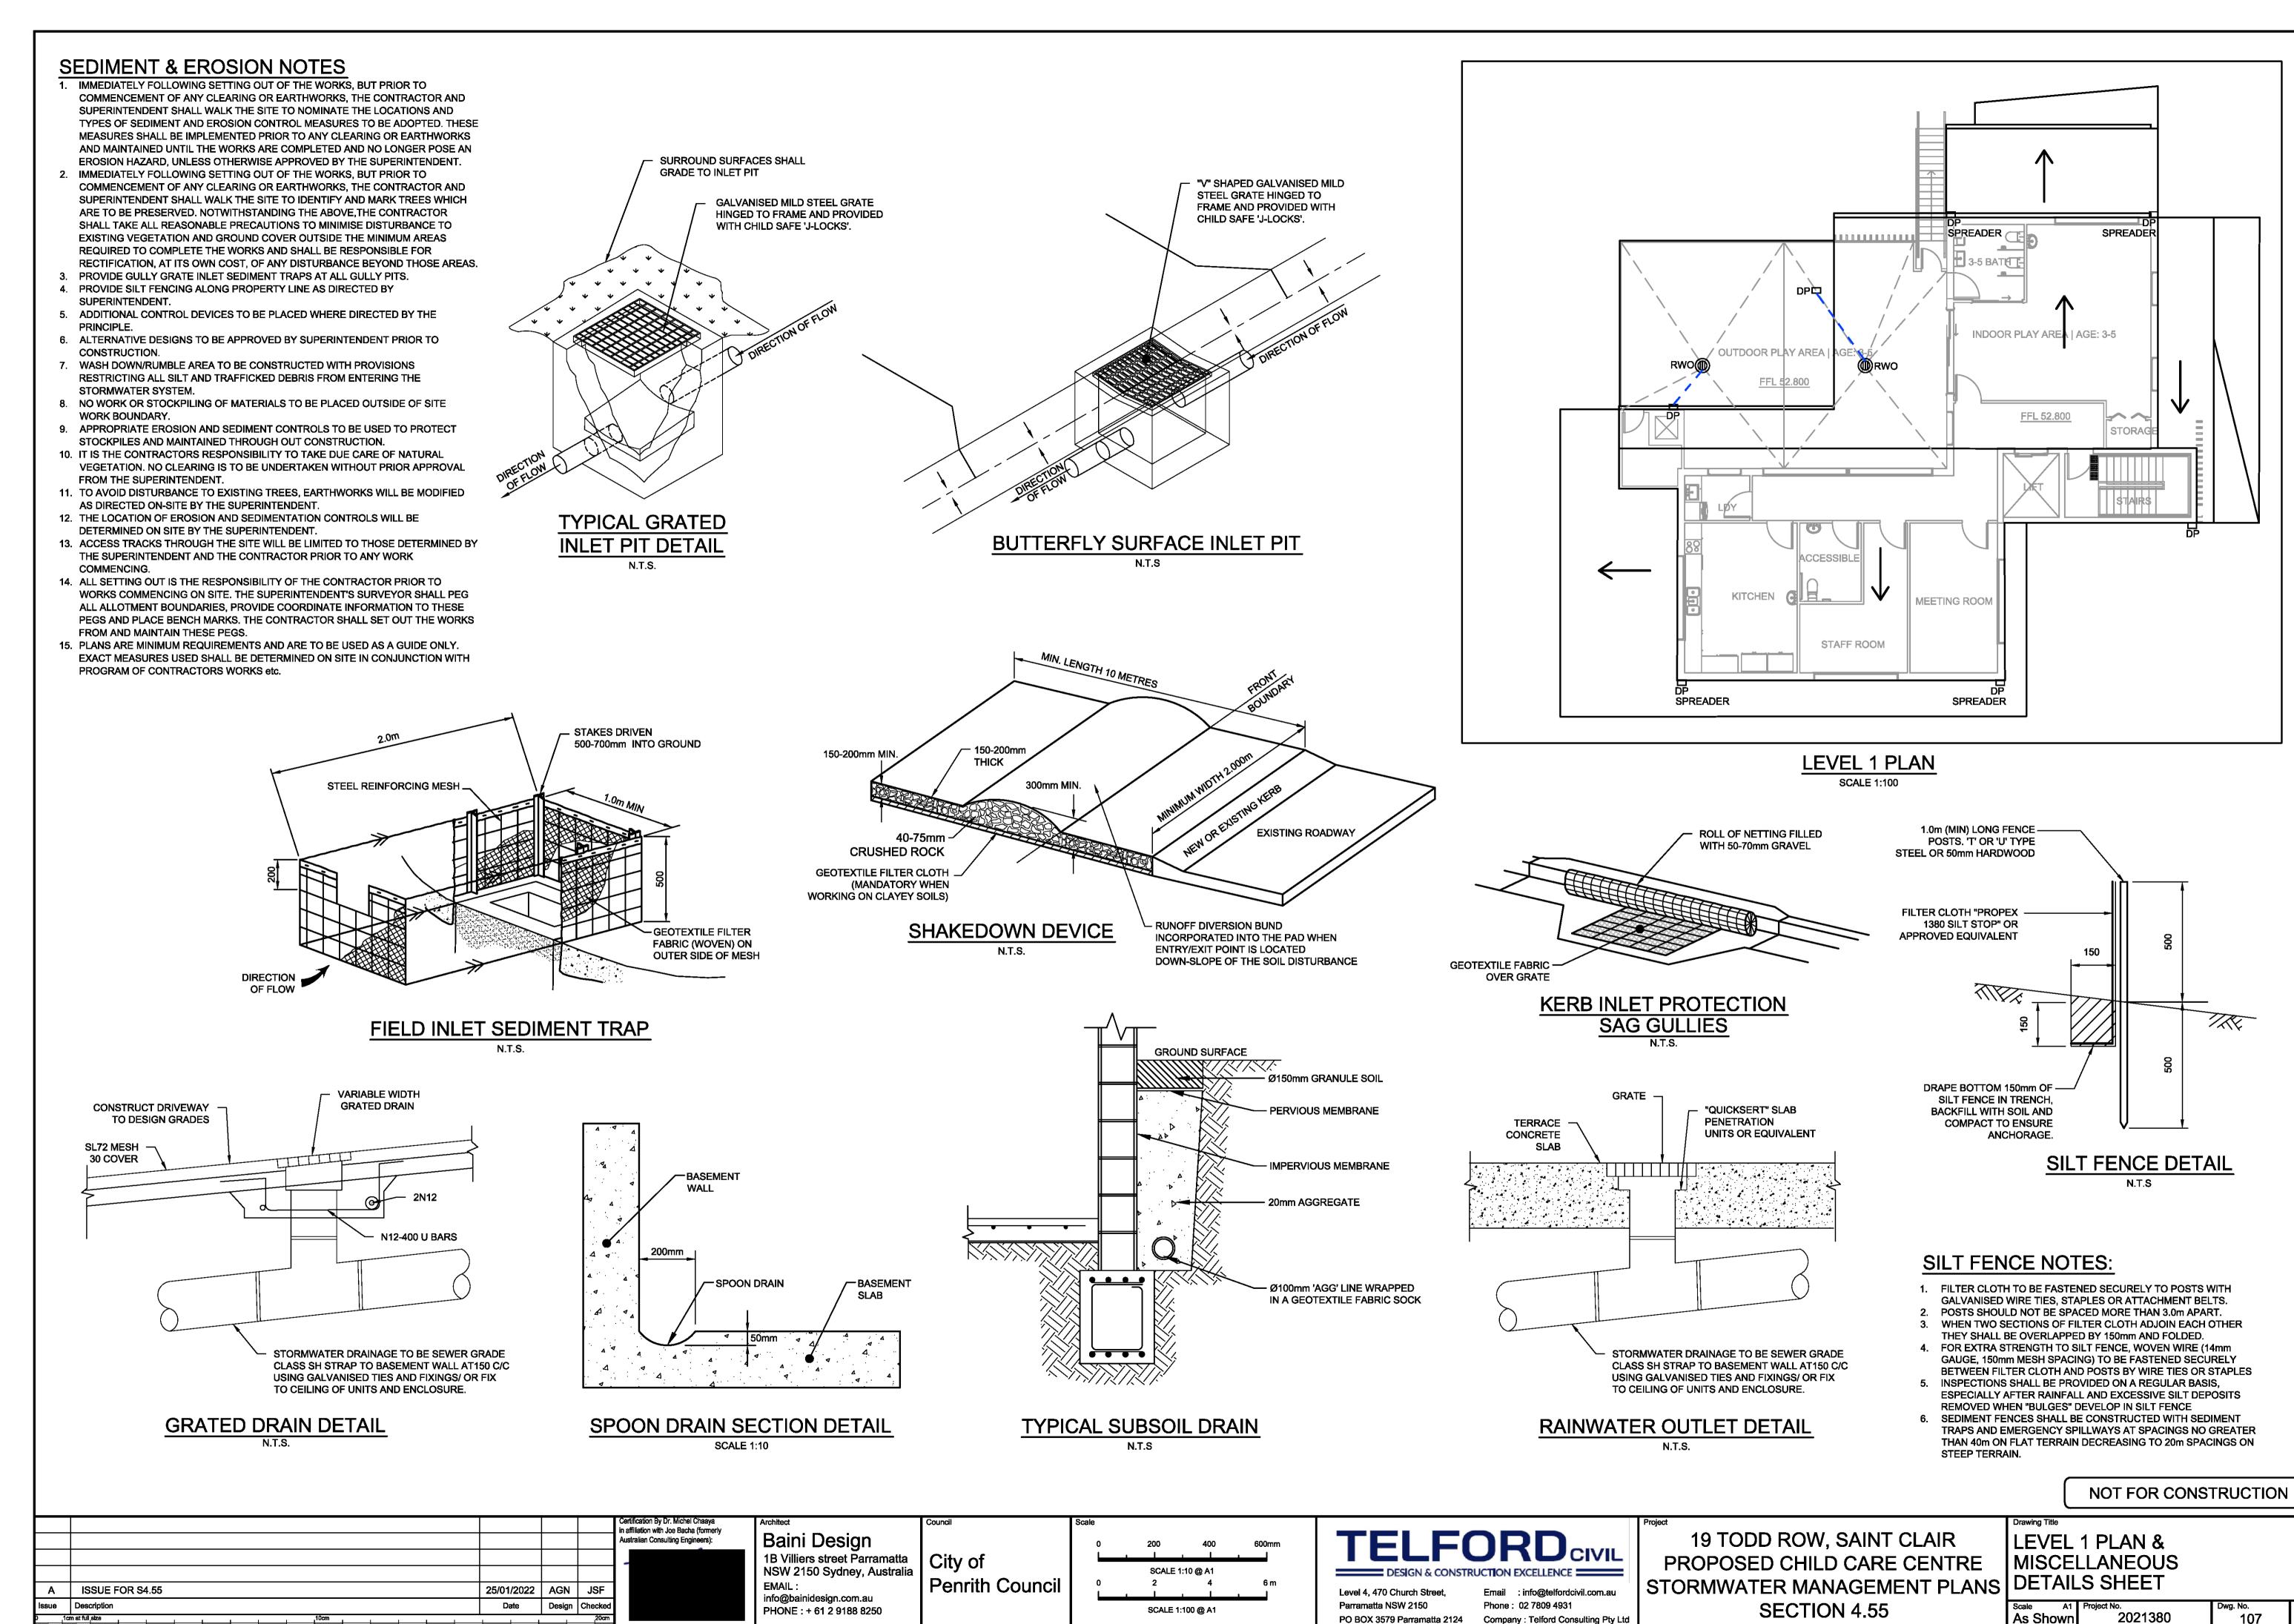

Document Set ID: 9895136 Version: 1, Version Date: 01/02/2022

1/2/

107