


LOCALITY SKETCH UBD REF: MAP 144 / D12

PROPOSED AREAS						
SITE:	300.0 m ²					
BUILDING FOOTPRINT:	176.8 m²					
DRIVEWAY & PATHWAYS:	16.8 m²					
SWIMMING POOL AREA:	NA m²					
ENTERTAINMENT AREA:	NA m²					
TOTAL:	193.6 m²					
No. of Beds:	4					
GROUND FLOOR:	144.0 m²					
FIRST FLOOR:	N/A m²					
GARAGE:	19.4 m²					
PATIO:	4.8 m ²					
BALCONY:	N/A m²					
Alfresco	8.6 m ²					
-	m²					
TOTAL:	176.8 m ²					
TOTAL LIVING AREA:	144.0 m²					
(Excl. Garage/Patio etc.)						
FLOOR SPACE RATIO:	0.48 : 1 48.0 %					
SITE COVERAGE:	64.5 %					
LANDSCAPED AREA:	106.4 m²					
	35.5 %					
BUILDING PLATFORM:	300.0 m²					
NETT CONDIT. FLOOR AREA	: TBA m²					
UNCONDITIONED FLOOR AR	REA: TBA m²					
TOTAL ROOF AREA:	205.0 m²					
HARVESTED ROOF AREA:	TBA m²					

HARVESTED ROOF AREA - NTS

920					26	
88.0						
34	(3)(3)				2.1	LANDSCAPE PLAN
N Si	0363				3. 2.	
8	(512)	3			9	ELECTRICAL PLAN
				1	8	WET AREA DETAILS
2				5	7	DRAINAGE PLAN
					6	SLAB PLAN
					5	SECTION
					4	ELEVATIONS
					3	GROUND FLOOR PLAN
					2	SITE PLAN
					1	COVER SHEET
RE	EV	DATE	AMENDMENTS	BY	SHEET	DESCRIPTION

		The Carin	ıa 19	Client: NEW LIFE HOMES Pty Ltd				
	Client signature:		BETA L/H Garage		Site Address: LOT 2281A BINALONG STREET JORDAN SPRINGS (DP 1168993)			
		Drawn: JS	Date: 31/01/2013	COL	INCIL ISSUE PLANS			
		Scale: N/A	Checked: Checked	Sheet:	Job No: 00	Rev:		

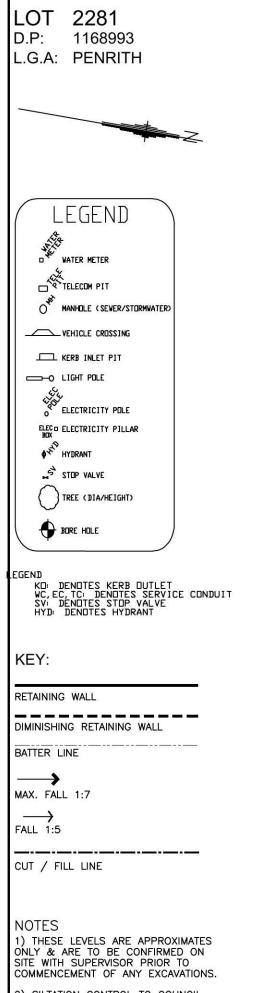

- 2) SILTATION CONTROL TO COUNCIL RÉQUIREMENTS.
- 4) NO WATERWAY OR WATERCOURSES

3) EXISTING VEGETATION ON SITE TO BE REMOVED


- 5) TERMITE PROTECTION TO AS3660.
- 6) STORMWATER TO STREET VIA TANK.



SITE PLAN

STORMWATER TO STREET


2281 600.2 m2

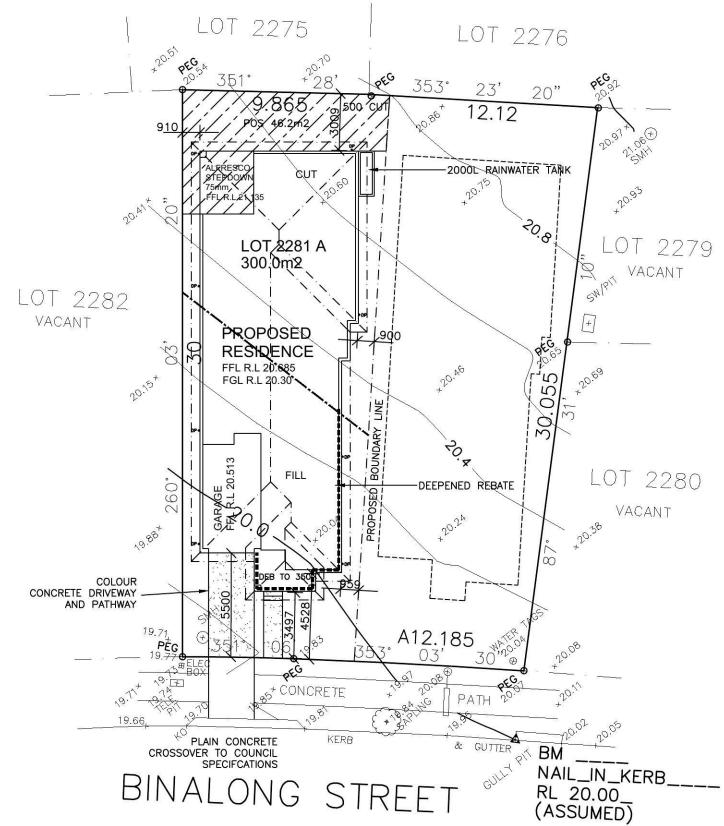

NOTE: ANY RETAINING WALL VISABLE FROM THE STREET OR 900mm HIGH AND OVER ARE TO BE OF MASONRY CONSTRUCTION

NOTE:

ALL GROUND LINES ARE APPROXIMATE. EXTENT OF FILL & BATTER WILL BE DETERMINED ON SITE, SEDIMENT BARRIERS ARE TO BE CUSTOMISED SITE SPECIFIC

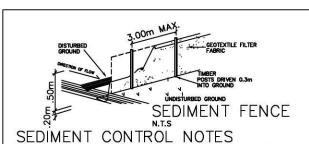

- SEDIMENT CONTROL NOTES

 1. ALL EROSION AND SEDIMENTATION CONTROL MEASURES, INCLUDING REVEGETATION AND STORAGE OF SOIL AND TOPSOIL, SHALL BE IMPLEMENTED TO THE STANDARDS OF THE SOIL CONSERVATION OF NSW.

 2. ALL DRAINAGE WORKS SHALL BE CONSTRUCTED AND STABILIZED AS EARLY AS POSSIBLE DURING DEVELOPMENT.


 3. SEDIMENT TRAPS SHALL BE CONSTRUCTED AROUND ALL INLET PITS, CONSISTING OF 300mm WIDE X 300mm DEEP TRENCH.

 4. ALL SEDIMENT BASINS AND TRAPS SHALL BE CLEANED WHEN THE STRUCTURES ARE A MAXIMUM OF 60 % FULL OF SOIL MATERIALS, INCLUDING THE MAINTENANCE PERIOD.


 5. ALL DISTURBED AREAS SHALL BE REVEGITATED AS SOON AS THE RELEVANT WORKS ARE COMPLETED.


 6. SOIL AND TOPSOIL STOCKPILES SHALL BE LOCATED AWAY FROM DRAINAGE LINES AND AREA WHERE WATER MAY CONCENTRATE.


 7. FILTER SHALL BE CONSTRUCTED BY STRETCHING A FILTER FABRIC (PROPEX OR APPROVED EQUIVALENT BETWEEN POST AT 3.0m CENTRES. FABRIC SHALL BE BURIED 150mm ALONG ITS LOWER EDGE.

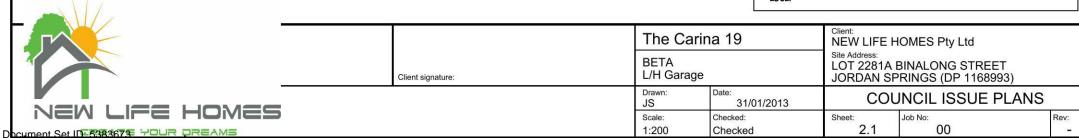



Version Date: 03/06/2014

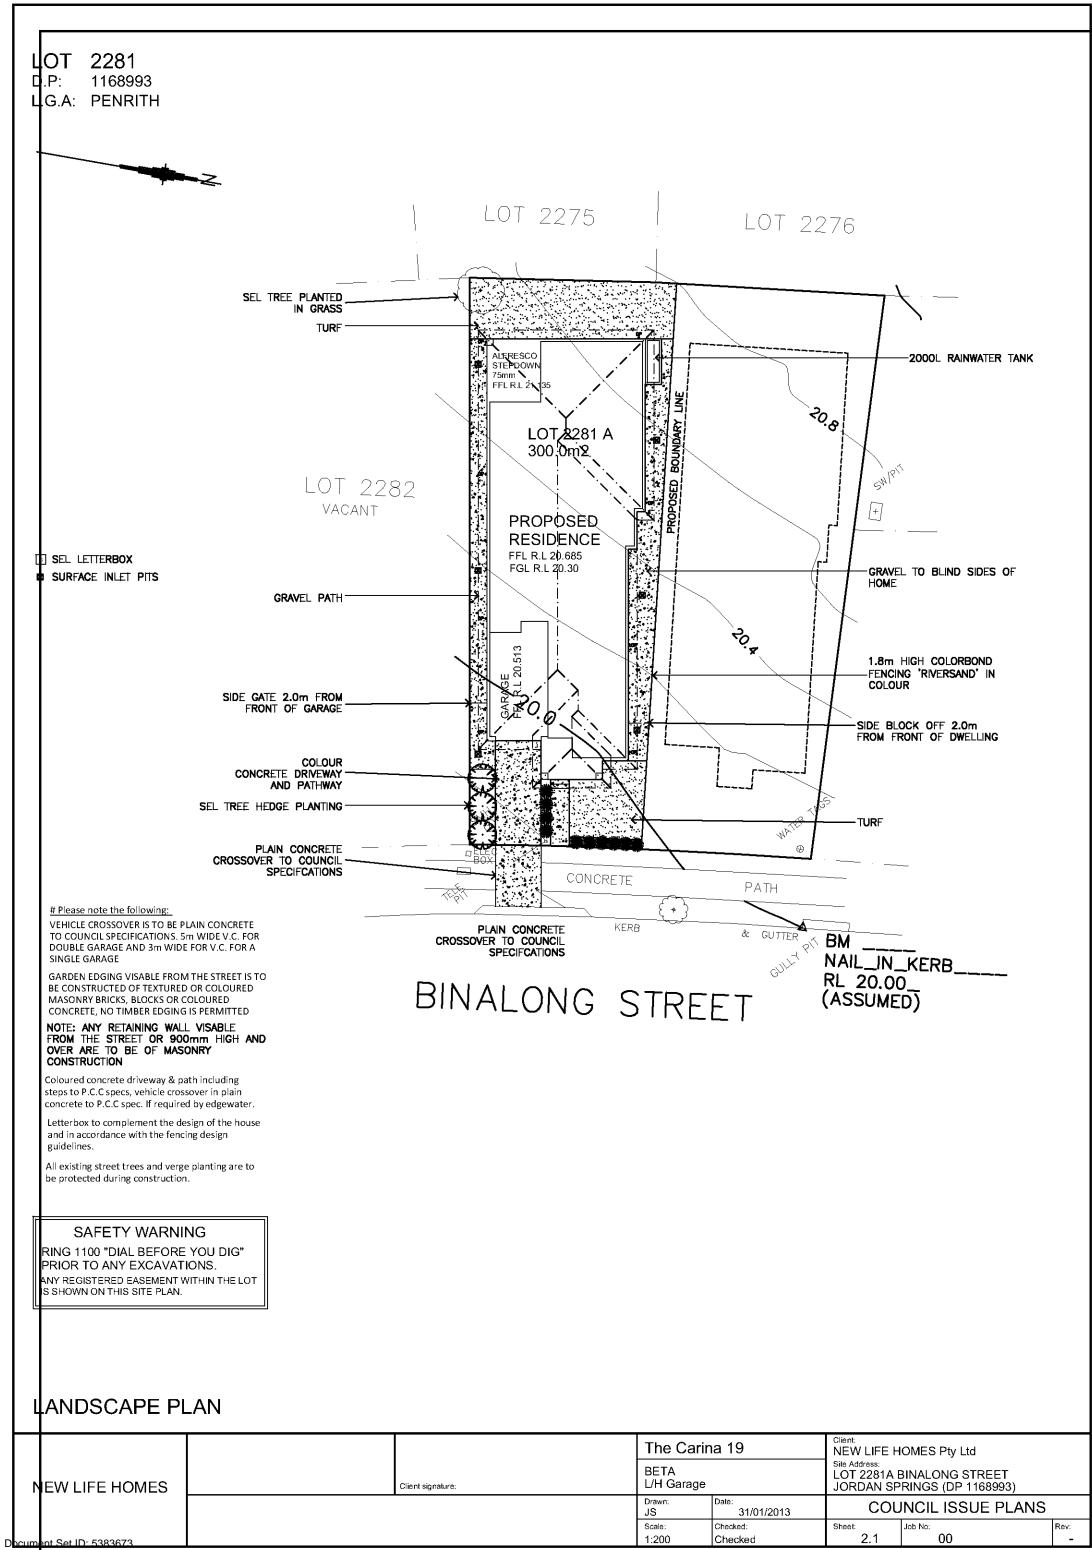

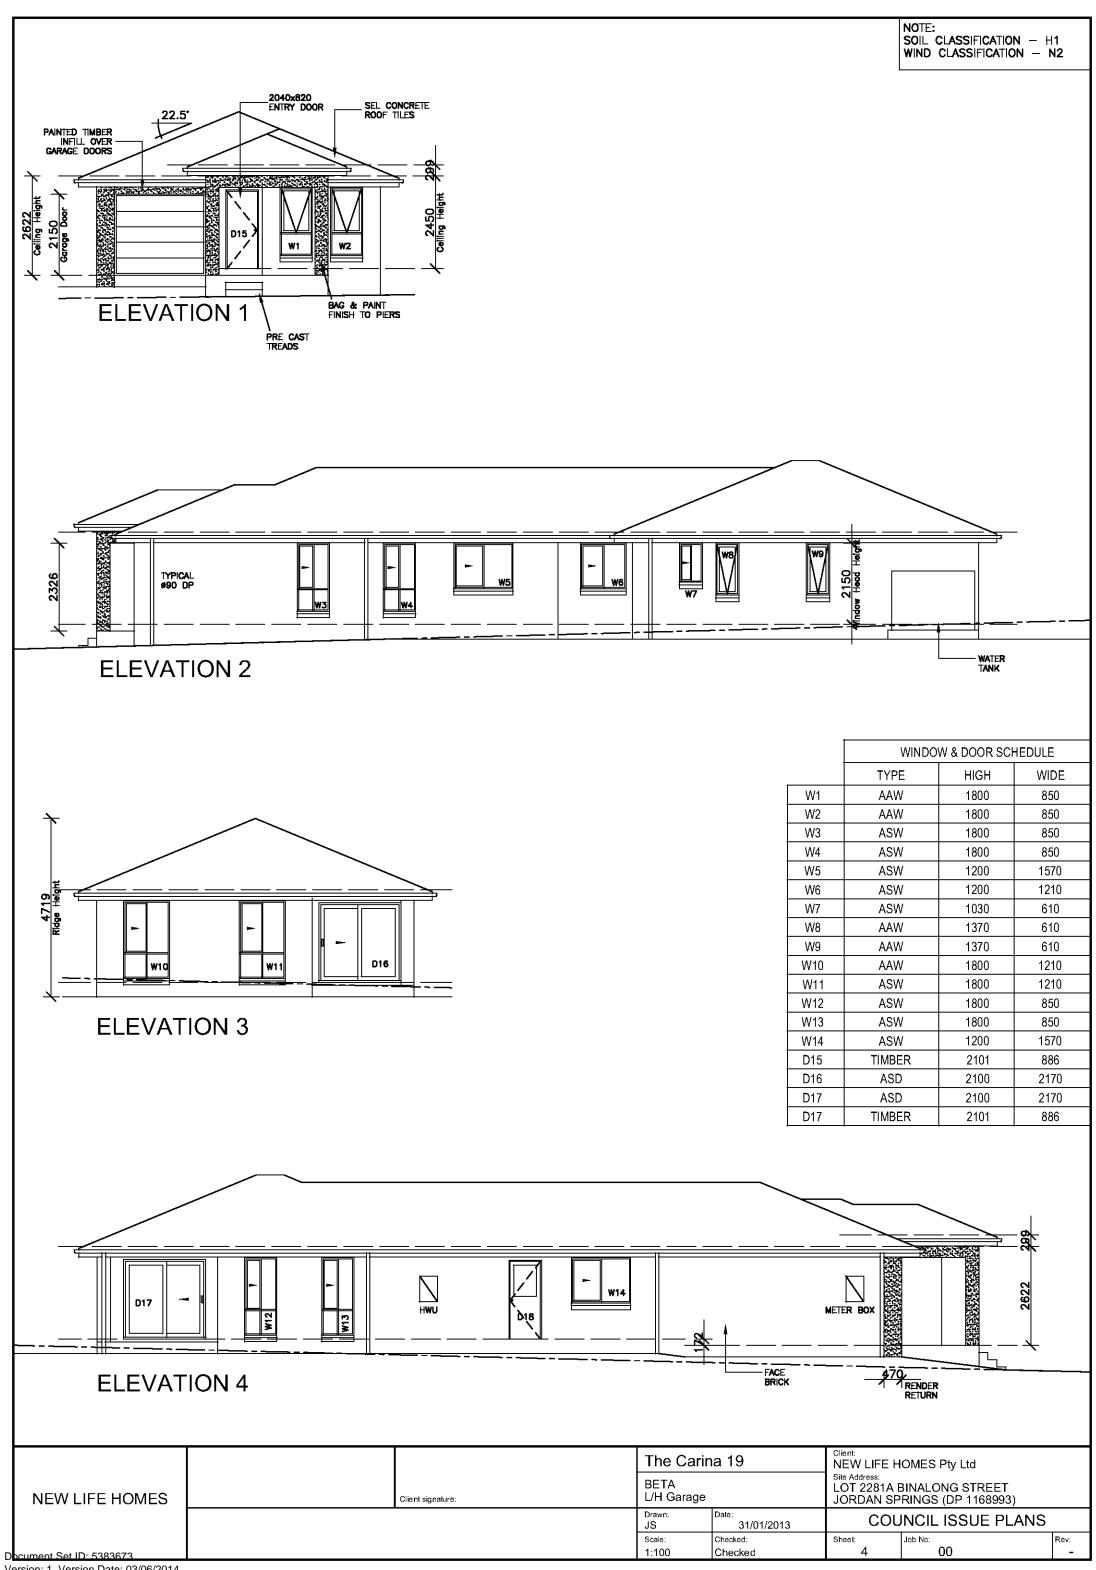

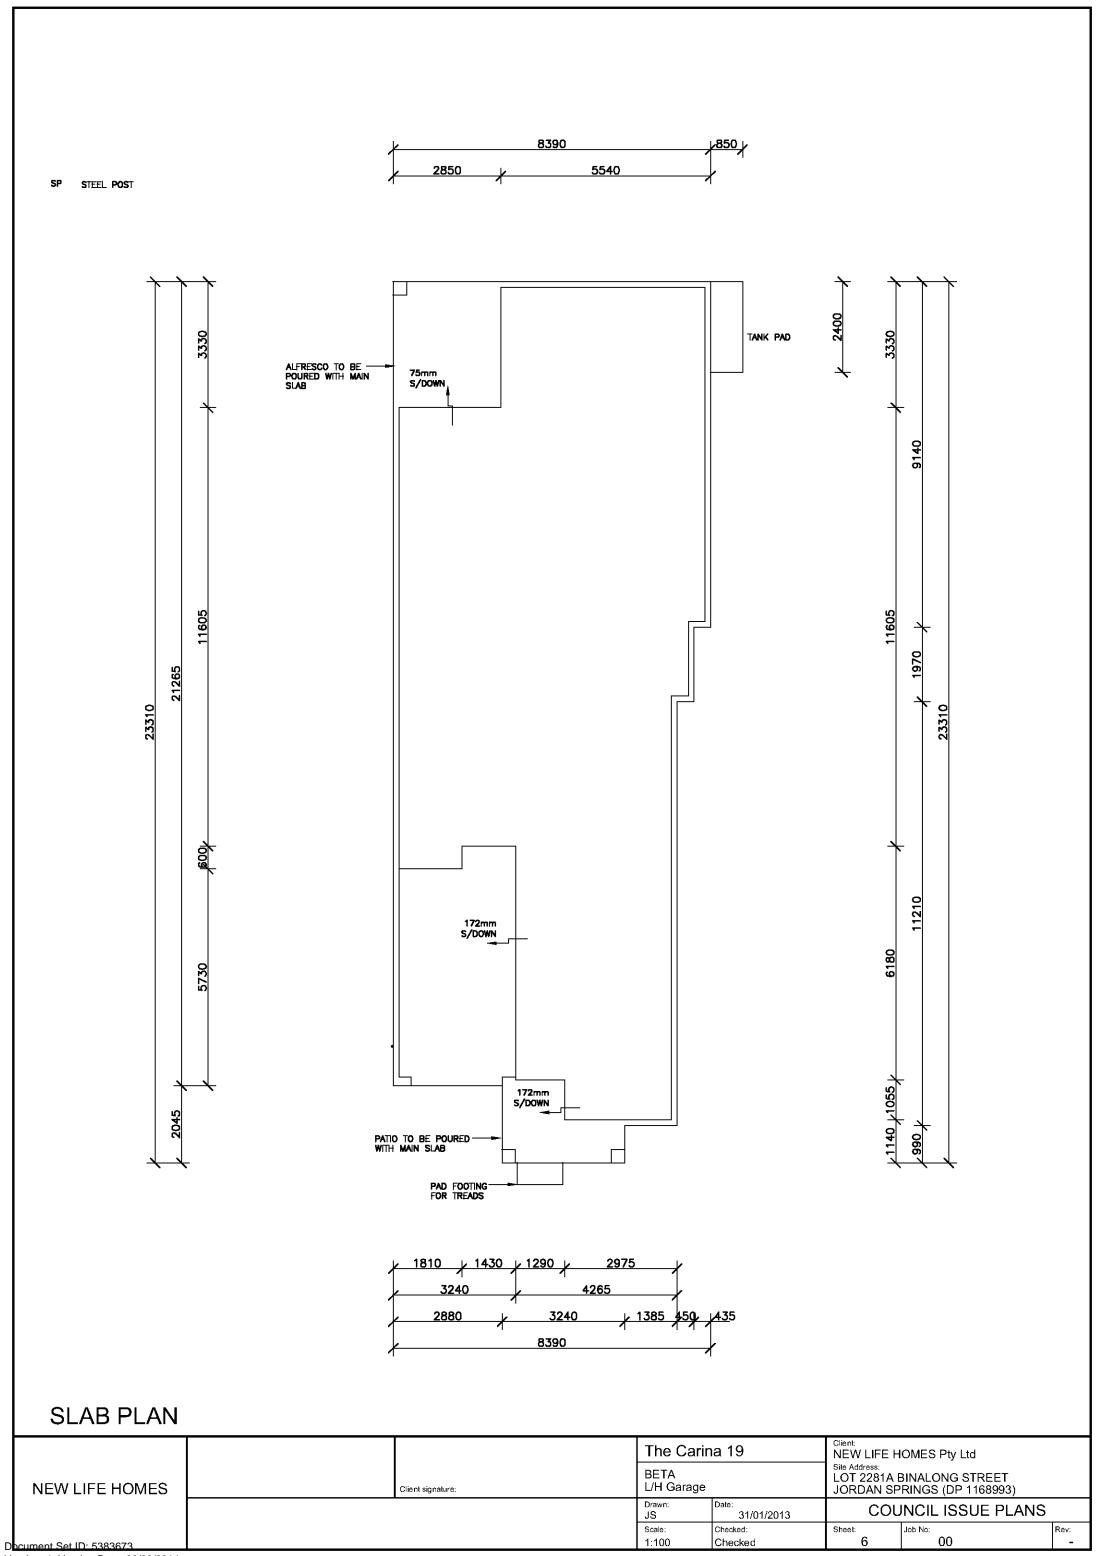

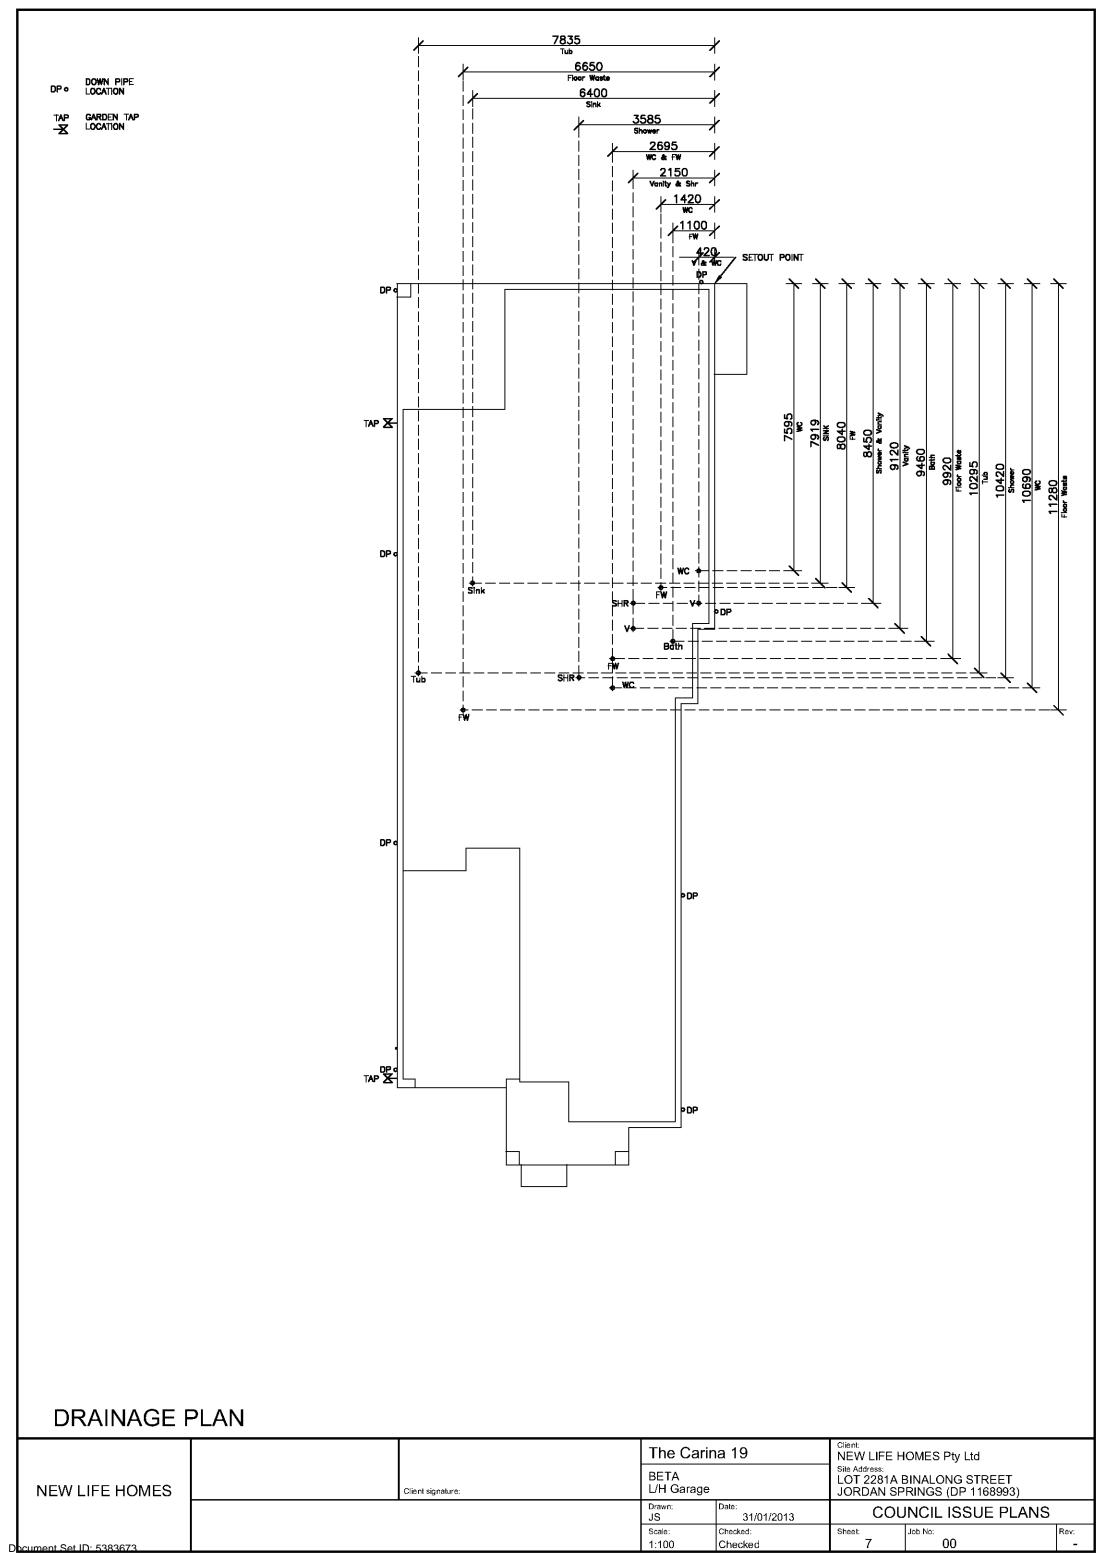

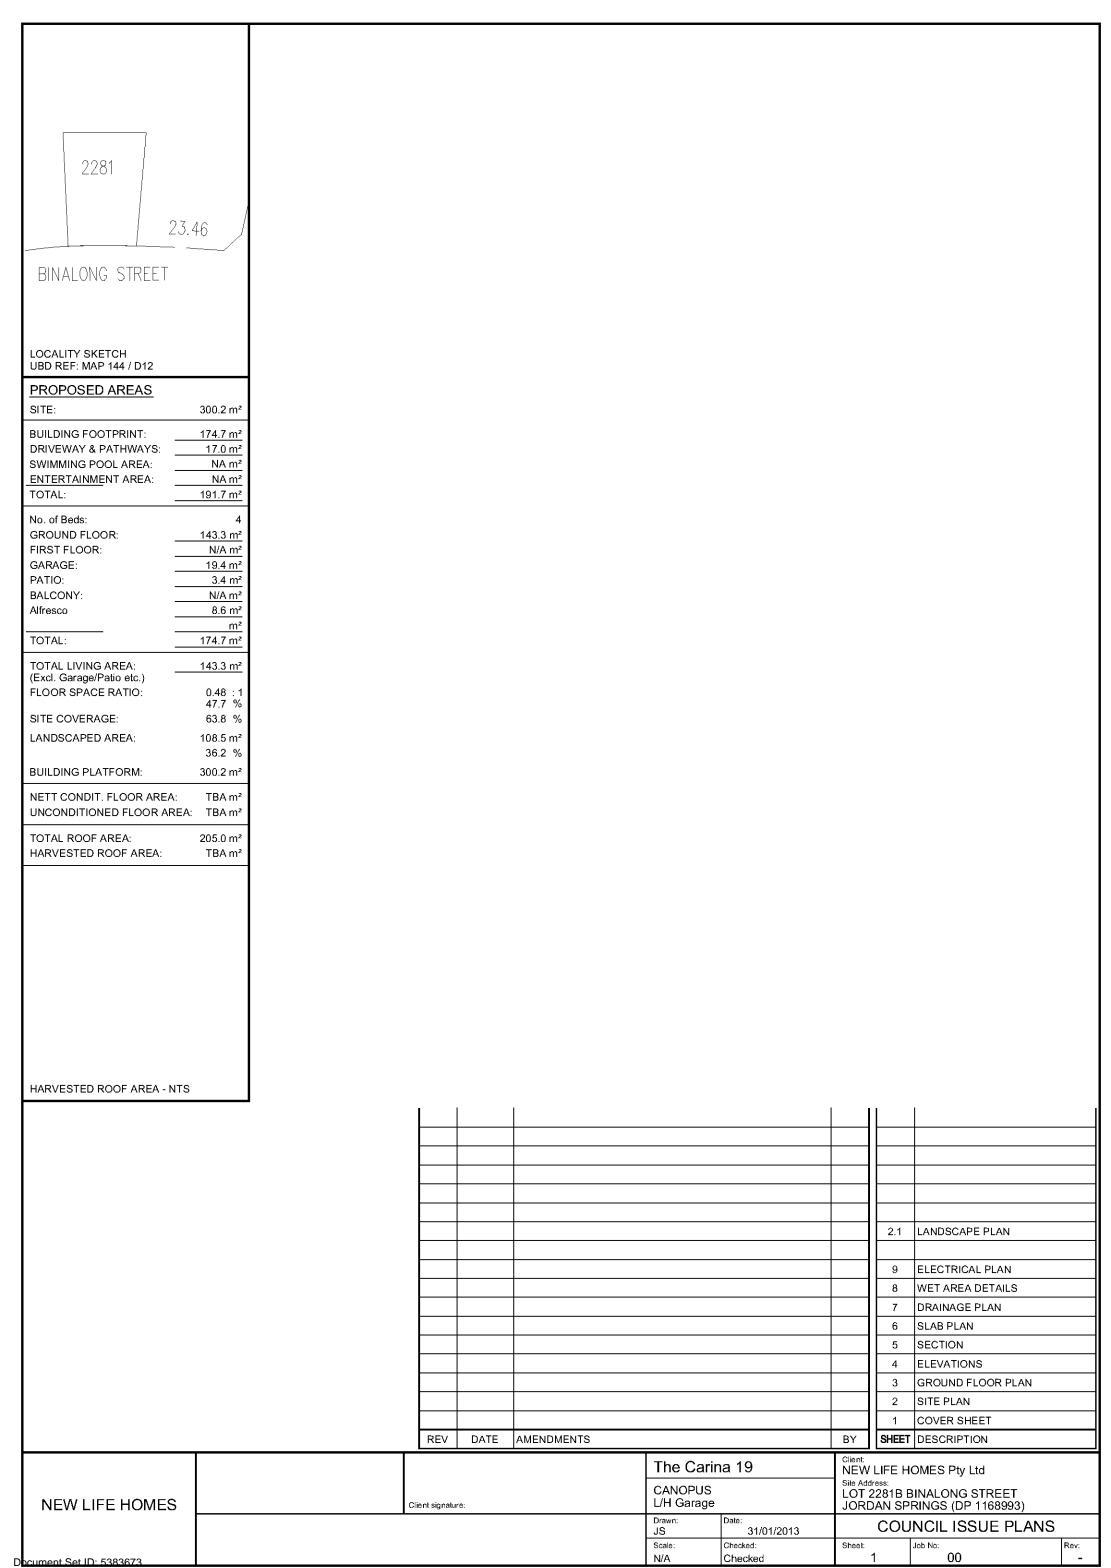




- 3) EXISTING VEGETATION ON SITE TO BE REMOVED
- 4) NO WATERWAY OR WATERCOURSES
- 5) TERMITE PROTECTION TO AS3660.
- 6) STORMWATER TO STREET VIA TANK.



NOTE:

ALL GROUND LINES ARE APPROXIMATE. EXTENT OF FILL & BATTER WILL BE DETERMINED ON SITE. SEDIMENT BARRIERS ARE TO BE CUSTOMISED SITE SPECIFIC

NOTE: ANY RETAINING WALL VISABLE FROM THE STREET OR 900mm HIGH AND OVER ARE TO BE OF MASONRY CONSTRUCTION

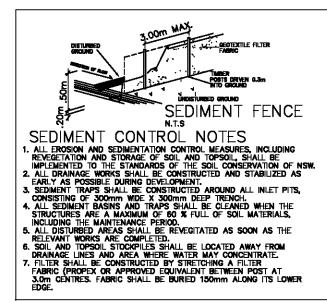

SITE PLAN

	The Carina 19		NEW LIFE HOMES Pty Ltd			
NEW LIFE HOMES	Client signature:	CANOPUS		Sile Address: LOT 2281B BINALONG STREET JORDAN SPRINGS (DP 1168993)		
		Drawn: JS	Date: 31/01/2013	COU	INCIL ISSUE PLANS	}
		Scale: 1:200	Checked: Checked	Sheet:	Job No: 00	Rev:
Document Set ID: 5383673		1.200	Checked	۷.۱		

LOT 2281 D.P: 1168993 L.G.A: PENRITH 600.2 m2 LOT 2276 10T 2275 SEL TREE PLANTED IN GRASS \oplus Tur: ALFRESCO STEPDOWN 75mm -2000L RAINWATER TANK FFL R.L 20 10 IOT 2279 LOT 2281 B VACANT 300.2m2 PROPOSED RESIDENCE. LOT 2282 FFL R.L 20.885 1.8m HIGH COLORBOND VACANT **E**GL R.L 20.50 FENCING 'RIVERSAND' IN COLOUR ■ SEL LETTERBOX SURFACE INLET PITS GRAVEL TO BLIND SIDES OF HOME GRAVEL PATH LOT 2280 VACANT SIDE GATE 2.0m FROM FRONT OF GARAGE ₹0.0 ⁵⁰0, SIDE BLOCK OFF 2.0m
FROM FRONT OF DWELLING COLOUR CONCRETE DRIVEWAY AND PATHWAY TURF. SEL TREE HEDGE PLANTING \oplus CONCRETE PATH # Please note the following: VEHICLE CROSSOVER IS TO BE PLAIN CONCRETE & GUTTER BM KERBPLAIN CONCRETE TO COUNCIL SPECIFICATIONS. 5m WIDE V.C. FOR NAIL_IN_KERB_ CROSSOVER TO COUNCIL DOUBLE GARAGE AND 3m WIDE FOR V.C. FOR A SINGLE GARAGE RL 20.00_ BINALONG STREE GARDEN EDGING VISABLE FROM THE STREET IS TO (ASSUMED) BE CONSTRUCTED OF TEXTURED OR COLOURED MASONRY BRICKS, BLOCKS OR COLOURED CONCRETE, NO TIMBER EDGING IS PERMITTED NOTE: ANY RETAINING WALL VISABLE FROM THE STREET OR 900mm HIGH AND OVER ARE TO BE OF MASONRY

CONSTRUCTION

Coloured concrete driveway & path including steps to P.C.C specs, vehicle crossover in plain concrete to P.C.C spec. If required by edgewater.

Letterbox to complement the design of the house and in accordance with the fencing design

All existing street trees and verge planting are to

SAFETY WARNING

RING 1100 "DIAL BEFORE YOU DIG" PRIOR TO ANY EXCAVATIONS. ANY REGISTERED EASEMENT WITHIN THE LOT IS SHOWN ON THIS SITE PLAN.

NOTE:

ALL GROUND LINES ARE APPROXIMATE. EXTENT OF FILL & BATTER WILL BE DETERMINED ON SITE. SEDIMENT BARRIERS ARE TO BE CUSTOMISED SITE SPECIFIC

GEOTEXTILE FILTER POSTS DRIVEN 0.3m SEDIMENT FENCE N.T.S

- N.T.S

 SEDIMENT CONTROL NOTES

 1. ALL EROSION AND SEDIMENTATION CONTROL MEASURES, INCLUDING REVEGETATION AND STORAGE OF SOIL AND TOPSOIL, SHALL BE IMPLEMENTED TO THE STANDARDS OF THE SOIL CONSERVATION OF NSW.

 2. ALL DRAINAGE WORKS SHALL BE CONSTRUCTED AND STABILIZED AS EARLY AS POSSIBLE DURING DEVELOPMENT.

 3. SEDIMENT TRAPS SHALL BE CONSTRUCTED AROUND ALL INLET PITS, CONSISTING OF 300mm WIDE X 300mm DEEP TRENCH.

 4. ALL SEDIMENT BASINS AND TRAPS SHALL BE CLEANED WHEN THE STRUCTURES ARE A MAXIMUM OF 60 % FULL OF SOIL MATERIALS, INCLUDING THE MAINTENANCE PERIOD.


 5. ALL DISTURBED AREAS SHALL BE REVEGITATED AS SOON AS THE RELEVANT WORKS ARE COMPLETED.


 6. SOIL AND TOPSOIL STOCKPILES SHALL BE LOCATED AWAY FROM DRAINAGE LINES AND AREA WHERE WATER MAY CONCENTRATE.


 7. FILTER SHALL BE CONSTRUCTED BY STRETCHING A FILTER FABRIC (PROPEX OR APPROVED EQUIVALENT BETWEEN POST AT 3.0m CENTRES. FABRIC SHALL BE BURIED 150mm ALONG ITS LOWER EDGE.


LANDSCAPE PLAN

		The Carina 19		Client: NEW LIFE HOMES Pty Ltd		
NEW LIFE HOMES	Client signature:			Site Address: LOT 2281B BINALONG STREET JORDAN SPRINGS (DP 1168993)		
		Drawn: JS	Date: 31/01/2013	COL	INCIL ISSUE PLANS	;
		Scale:	Checked:	Sheet	Job No:	Rev:
Doumant Cat ID: E202672		1:200	Checked	L 2.1	1 00	-

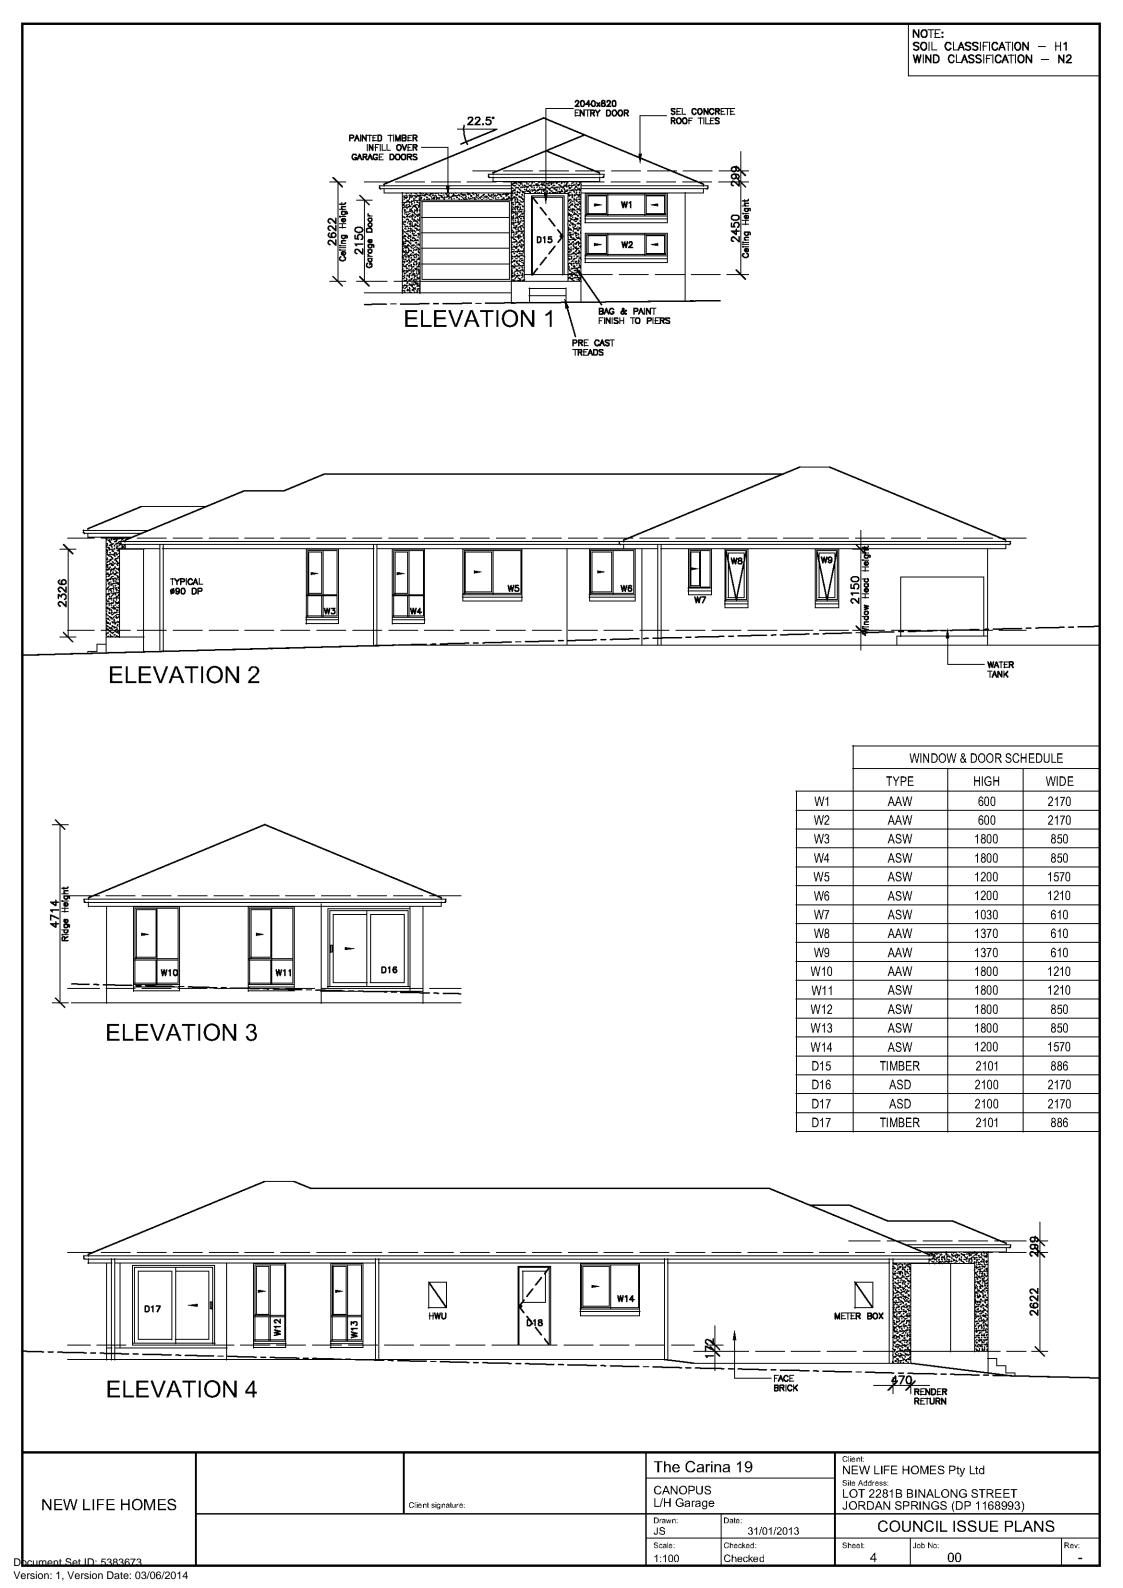

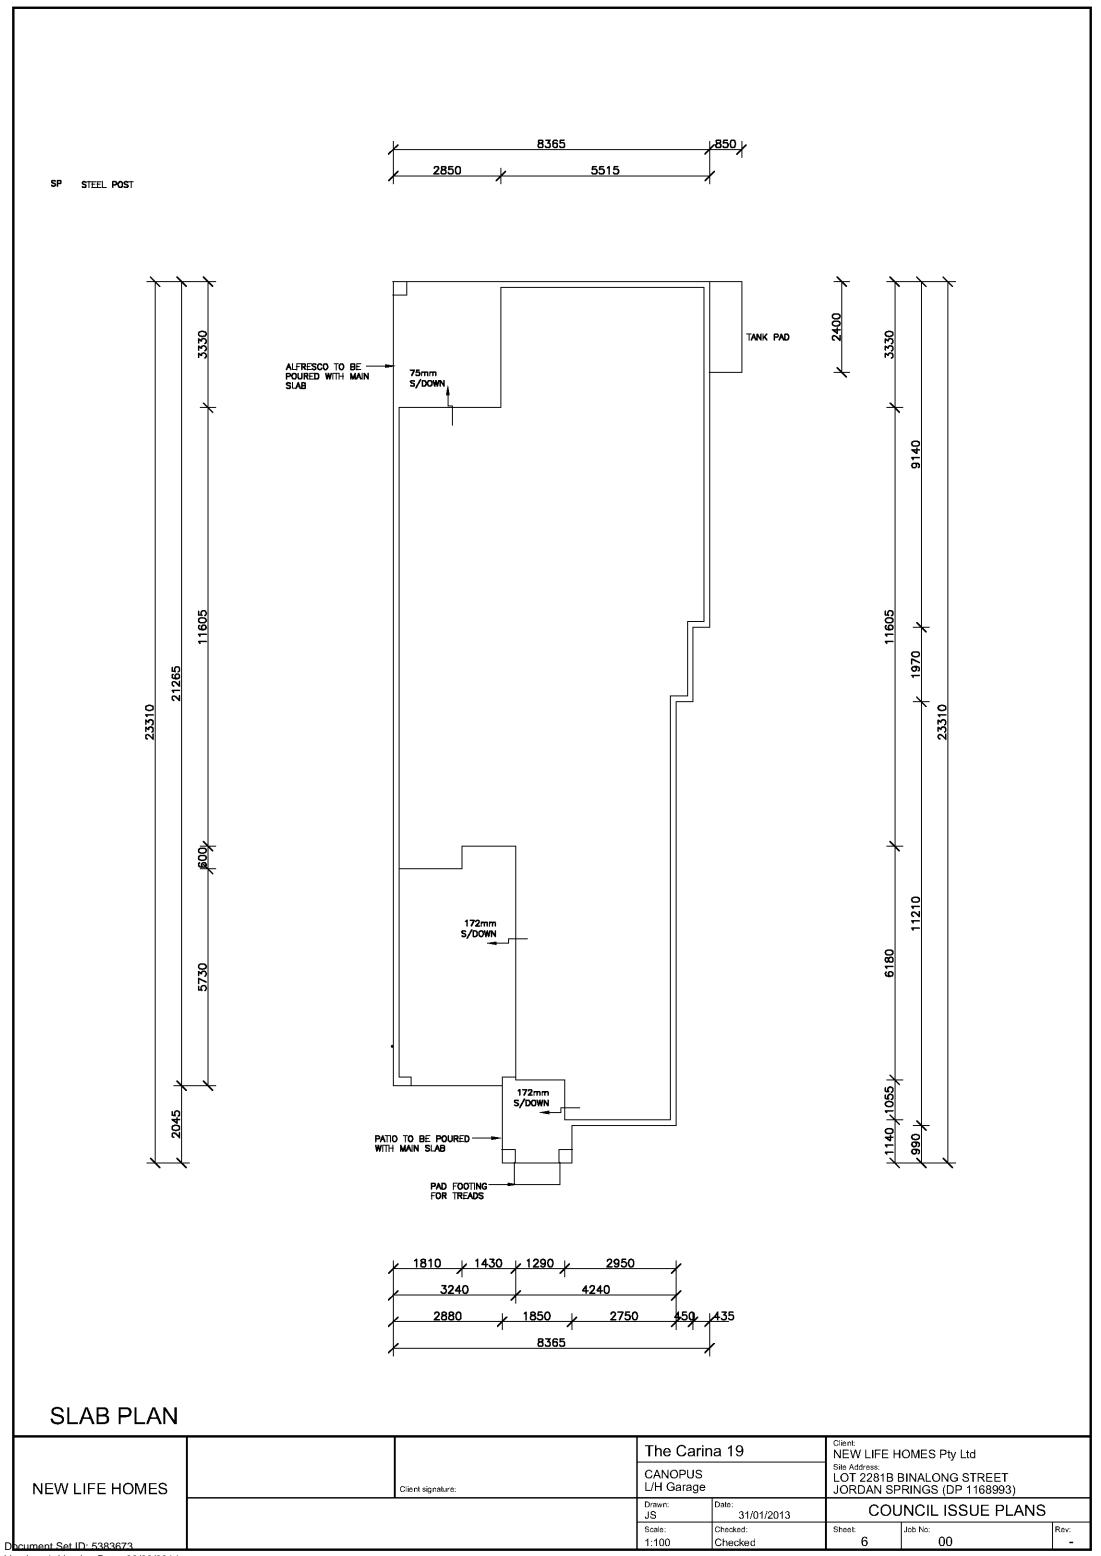

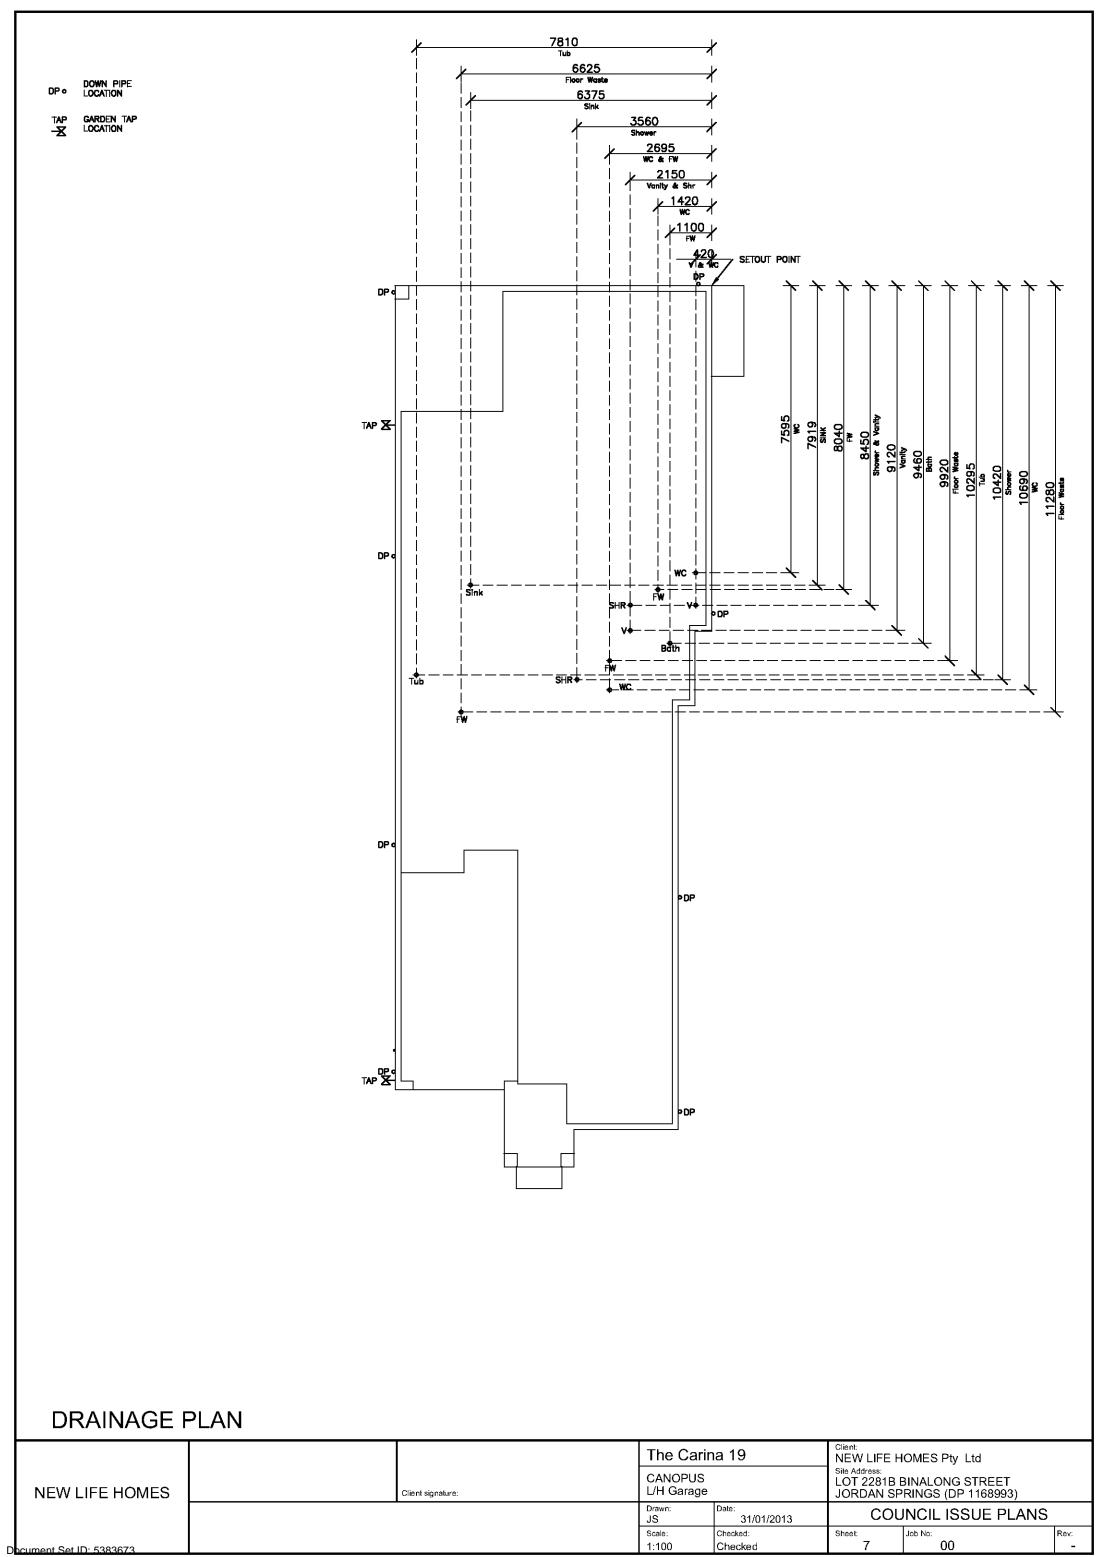

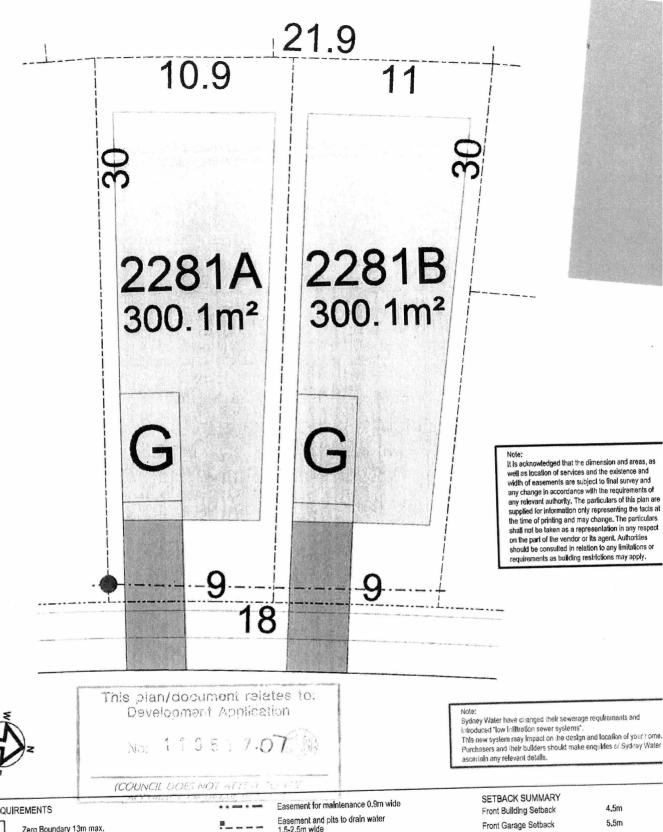

SITING REQUIREMENTS

Zero Boundary 13m max.

Single Garage Double Garage

Secondary Fronlage Articulation 10m minimum of broken roofline & building line, Must provide suitable glazing,

Optional Garage location

Increased Secondary Frontage building setback to 3.4m (garage 4.4m)

1.5-2.5m wide

Approximate sewer line / manhole location Building adjacent or over sewer must conform with Sydney Water requirements

Lot Boundary

Boundary fence provided by Lend Lease

Proposed driveway width reduced from standard due to setbacks

Construction along these boundaries must comply with Sydney Water and Penrith City Council requirements concerning zone of influence

Side Bullding Setback (≥15m Frontage)

Secondary Side Setback

Secondary Garage Setback

Rear Building Selback

5.5m

mln. 0.9m both si

Zero one side 0.9m other (as sh

1.5m (unless otherwise 2.5m

3m

Levels of Construction Stan for Bush Fire Protection (AS 3959-2009)

ILLOURA

April 2013

Lend Lea

Document Set ID: 5383673 Version: 1, Version Date: 03/06/2014

