259 WEST WILCHARD RD, CASTLEREAGH NSW

GENERAL

- THIS PLAN IS TO BE USED IN CONJUNCTION WITH ARCHITECTURAL, STRUCTURAL, & LANDSCAPING PLANS. ANY DISCREPANCIES OR OMISSIONS ARE TO BE REFERRED TO THE ENGINEER FOR RESOLUTION PRIOR TO COMMENCING WORK
- 2. ALL MATERIALS AND WORKMANSHIP IS TO MEET AS 3500.3:2015 STORMWATER DRAINAGE, BCA AND LOCAL COUNCIL DEVELOPMENT POLICIES. CONSENTS AND REQUIREMENTS.
- IT IS THE CONTRACTORS RESPONSIBILITY TO VERIEY ALL DIMENSIONS AND DRAINAGE LEVELS ON SITE PRIOR TO COMMENCEMENT OF WORKS. THIS INCLUDES EXISTING SERVICES AND/OR OTHER STRUCTURES THAT MAY AFFECT/BE AFFECTED BY THIS DESIGN PRIOR TO CONSTRUCTION.
- THIS DRAWING IS NOT TO BE USED FOR SET-OUT PURPOSES. ALL SURVEY INFORMATION, PROPOSED BUILDING LEVELS. FINISHED SURFACE LEVELS AND SITE DETAILS SHOWN IN THESE DRAWINGS ARE ESTABLISHED LIDON LEVEL S/DETAILS SLIDDLIED BY OTHERS
- FLOOR WASTE & DOWNPIPE LOCATIONS ARE INDICATIVE ONLY, ULTIMATE FLOOR WASTE & DOWNPIPE LOCATION, SIZE, & QUANTITY ARE TO BE DETERMINED BY BUILDER IN ACCORDANCE WITH RELEVANT
- 6. IT IS THE BUILDERS RESPONSIBILITY TO LOCATE AND LEVEL ALL EXISTING SERVICES OR OTHER STRUCTURES WHICH MAY AFFECT/BE AFFECTED BY THIS DESIGN PRIOR TO COMMENCEMENT OF
- ANY SUBSTITUTION OF MATERIALS SHALL BE APPROVED BY THE ENGINEER AND INCLUDED IN THE DEVELOPMENT APPLICATION.
- 8. CONTRACTORS ARE TO INVESTIGATE ALL EXISTING SERVICES AND APPLY FOR "DIAL BEFORE YOU DIG" PRIOR TO COMMENCEMENT OF CONSTRUCTION

THESE PLANS WERE PREPARED IN ACCORDANCE WITH COUNCIL'S POLICIES AND REQUIREMENTS BASIX REQUIREMENTS. AS 3500:2013. ARR (2016). ARQ (2006). BCA (2015). RELEVANT LEGISLATION, AND NSW MUSIC MODELLING GUIDELINES.

SCOPE OF WORKS

DETAILED DESIGN ND DOCUMENTATION FOR THE FOLLOWING (WHERE APPLICABLE): ROOFED, IMPERVIOUS AND PERVIOUS AREAS; RAINWATER REUSE SYSTEM; OSD; AND STORMWATER DISPOSAL

RAINWATER RE-USE SYSTEM


- ALL GUTTERS TO BE FITTED WITH LEAF GUARDS AND SUBJECT TO REGULAR INSPECTION / CLEAN
- MIN. TANK SIZE TO BE THAT SPECIFIED WITHIN DETAIL AND PLAN.
- TANKS ARE TO BE INSTALLED BY A LICENSED PLUMBER IN ACCORDANCE WITH MANUFACTURES SPECIFICATIONS AS3500 AND COUNCIL REQUIREMENTS.
- RAINWATER RETENTION FOR RE-USE AS SPECIFIED BY BASIX CERTIFICATE.

MINIMUM PIPE COVER		
O.L OF PIPE TO F.S.L		
	MIN. COV	/ER (mm)
LOCATION	CAST IRON, DUCTILE IRON, GALV. STEEL	OTHER AUTHORISED PRODUCTS ⁽¹⁾
1. NOT SUBJECT TO VEHICULAR LOADING:		
a. WITHOUT PAVEMENT-		
i. FOR SINGLE DWELLINGS	0	100
ii. FOR ITEMS OTHER THAN i.	0	300
b. WITH PAVEMENT OF BRICK OR UNREINFORCED CONCRETE	0 (2)	50 ⁽²⁾
2. SUBJECT TO VEHICULAR LOADING:		
a. OTHER THAN ROADS-		
i. WITHOUT PAVEMENT	300	450
ii. WITH PAVEMENT OF:		
- REINFORCED CONCRETE FOR HEAVY VEHICULAR		
LOADINGS	0 (2)(3)	100 (2)(3)
- BRICK/UNREINFORCED CONCRETE FOR LIGHT		
VEHICULAR LOADING	0 ⁽²⁾⁽³⁾	75 ⁽²¹³⁾
b. ROADS-		
i. SEALED	300	500 ⁽³⁾
ii. UNSEALED	300	500 ⁽³⁾
3. SUBJECT TO CONSTRUCTION EQUIPTMENT OR IN EMBANKMENT CONDITIONS	300	500 ⁽³⁾


⁽¹⁾ INCLUDES OVERLAY ABOVE TOP OF THE PIPE NOT LESS THAN 50mm THICK

(2) BELOW THE UNDERSIDE OF THE PAVEMENT.

(3) SUBJECT TO COMPLAINCE WITH AS 1762, AS 2033, AS 2566.1, AS 3725, AS 4060

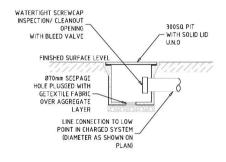

TYPICAL CHARGED LINE CLEAN-OUT PIT SECTION

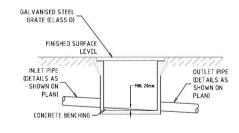

TYPICAL GRATED SURFACE INLET PIT SECTION

- MINIMUM PIPE GRADE AS SPECIFIED IN TABLE BELOW. MINIMUM DIAMETER IS TO BE (U.N.O): Ø100mm WHERE LINE RECEIVES ROOF WATER.
- Ø150mm WHERE LINE RECEIVES RUN-ON FROM PAVED/UNPAVED EXTERNAL SURFACES
- PIPE EMBEDMENT IS TO BE IN ACCORDANCE WITH LOCAL AUTHORITY SPEC., AS 3500.3, AS 2032 FOR PVC. & AS 3725 FOR FCR/RCP PIPEWORK.
- SUBSOIL DRAINAGE SHALL BE PROVIDED TO ALL RETAINING WALLS AND EMBANKMENTS WITH THE LINES FEEDING INTO THE STORMWATER DRAINAGE SYSTEM

MINIMUM SITE PIPE GRADIENT			MINIMUM INTERNAL DIMENSIONS			
	(U.N.O)		FOR ST	ORMWATE	R PITS	
DIAMETER Ø (mm)	MIN. GRADE	MIN. % SLOPE		MIN. INTERNAL	DIMENSIONS (mm)	
≤ Ø150	1:100	1%	OUTLET(mm)	WIDTH	LENGTH	
225	1:200	0.5%	≤ 600	450	450	
300	1:250	0.4%	> 600 TO ≤ 900	600	600	
375	1:300	0.33%	> 600 TO ≤ 900	600	900	
			> 1200	900	900	

- ALL PITS TO BE FITTED WITH APPROVED GALAVANISED STEEL GRATES AND TO BE SUITABLE FOR THE FOLLOWING LOAD RATING (U.N.O):
- CLASS-B MIN. FOR LANDSCAPED AREAS
- CLASS-C WHERE SUBJECT TO VEHICULAR TRAFFIC
- 2 ALL PITS FITTED WITH CHILDPRODE SPRING LOCKING 1-ROLTS
- GRATED COVERS OF PITS > 600SQ mm ARE TO BE HINGED & OFFSET FROM OBSTRUCTIONS TO ALLOW FOR FULL OPENING.
- 4. PROVIDE STEP IRONS TO STORMWATER PITS > 1200mm IN DEPTH.
- 5. PIT BASES ARE TO BE BENCHED LEVEL TO THE I.L OF THE OUTLET PIPE (NO SUMP U.N.O), WITH A MIN. FALL OF 20mm BETWEEN THE INLET AND OUTLET PIPE I.Ls. ALL PIPES SHOULD BE CUT FLUSH WITH THE WALL OF THE PITS.
- 6. PRECAST PITS ARE TO BE SET ON A 75mm CONCRETE BASE AND BACKFILLED WITH CONCRETE TO HALF THE PIT'S HEIGHT.
- WATER SHOULD NOT BE PERMITTED TO POND WITHIN THE DRAINAGE SYSTEM.

A.H.D	AUSTRALIAN HEIGHT DATUM	N.T.S	NOT TO SCALE
A.R.I	AVERAGE RECURRENCE INTERVAL	0.F	OVERFLOW
0.0	CLEAN-OUT PIT	0.L.	OBVERT LEVEL
DP	DOWNPIPE	0.S.D	ON-SITE DETENTION
D/S	DOWNSTREAM	R.C.P	REINFORCED CONCRETE PIPE
FF	FIRST FLUSH DEVICE	R.H.S	RECTANGULAR HOLLOW SECTION
F.F.L	FINISHED FLOOR LEVEL	R.L.	REDUCED LEVEL
F.G.L	FINISHED GARAGE LEVEL	R.W.T	RAIN-WATER TANK
F.W	FLOOR WASTE	S.L	SURFACE LEVEL
G.S.I.P	GRATED SURFACE INLET PIT	SQ	SQUARE
H.G.L	HYDRAULIC GRADE LINE	TYP.	TYPICAL
I.L.	INVERT LEVEL	T.W.L	TOP WATER LEVEL
I.P	INSPECTION POINT	U/S	UPSTREAM
N.S.L.	NATURAL SURFACE LEVEL	U.N.O	UNLESS NOTED OTHERWISE

ALL DIMENSIONS ARE IN METRES UNLESS NOTED OTHERWISE

A-02	20/12/2019	L.T.S	R.A.S	L.T.S	UPDATE WITH SHED
A-01	22/10/2019	L.T.S	R.A.S	L.T.S	INITIAL RELEASE FOR D.A.
REV	DATE	DES.	DRN.	APP.	REVISION DETAILS




ENGINEERING AND ENVIRONMENTAL CONSULTANTS broadcrest.com.au | contact@broadcrest.com.au | 1300 554 945 ENVIRONMENTAL FLOOD STORMWATER GEOTECHNICAL ACOUSTICS WASTEWATER BROADCREST CONSULTING PTY LTD | ACN 622 508 187

PROJECT DESCRIPTION	SHEET
PROPOSED RESIDENCE	TITLE & GENERAL NOTES
PROJECT SITE	PLAN
259 WEST WILCHARD RD, CASTLEREAGH	SCP - STORMWATER CONCEPT PLAN
LGA	CLIENT
PENRITH CITY COUNCIL	MR. & MRS. SMITH


0410-SW NTS @ NTS @ A1 1 05 3




Document Set ID: 8974771 Version: 1. Version Date: 24/12/2019

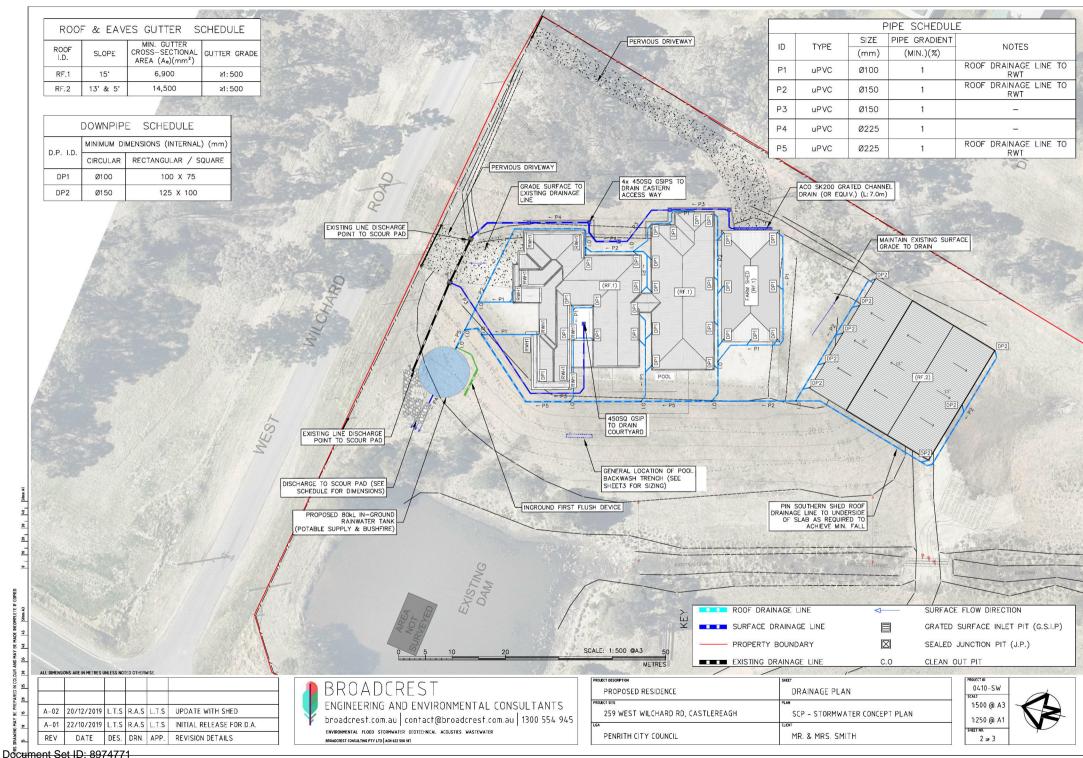

Version: 1, Version Date: 24/12/2019

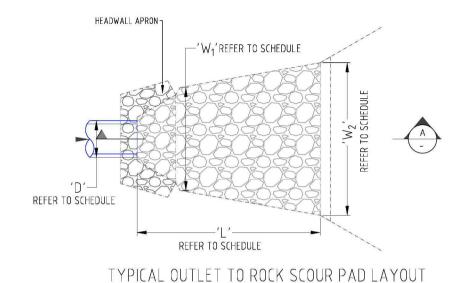

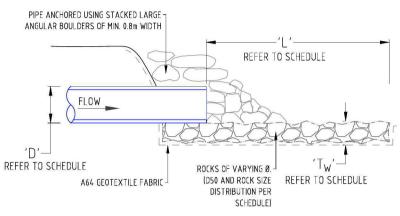

OUTLET TO ROCK SCOUR PAD SECTION A-A

NTS NOTES:

- HEADWALL APRON MAY BE OF CONCRETE-PRECAST OR STACKED ROCK CONSTRUCTION (AS SHOWN). WHERE STACKED ROCK, MINIMUM 0.8m WIDTH ROCKS ARE TO BE USED.
- ROCK IS TO BE GRADED IN ACCORDANCE WITH ROCK SIZES NOMINATED IN SCHEDULE.
- SIZING PER 5%AEP 5min STORM EVENT.

				OUT	LET SCOUR P	AD SCHEDULE		0.											
	DECICN			ROCK PROPERTIES				PAD DIMENSIONS											
ID	DESIGN DISCHARGE 'Q _D '	DESIGN MAX VELOCITY 'V _D '	OUTLET 'D'	TLET 'D' ROCK FINISH		SIZE DISTRIBUTION			MIN. PAD PAD LENGTH WIDTH		w1' WIDTH 'W2'								
	[m ³ /s]	[m/s]	[mm]								[mm]	'D50/D90'	'D50/D90'	'D50/D90'	[mm]	[mm]	[m]	[m]	[m]
RT OUTLET	0.076	1.91	225	ANGULAR	100	1.00	100	140	3.0	0825	1.2								

BOX GUTTER MINIMUM DIMENSIONS:(W x Ha) Hr-25mm RAINHEAD (SIZE TO SCHEDULE)

RAINH	EAD SCHEDULE
DIMENSION I.D.	MINIMUM DIMENSIONS (INTERNAL) (mm)
DP	CIRCULAR: Ø100
w	300
Ha	101 (MIN.)
Lr	120
Hr	125

BOX GUTTER RAINHEAD DETAIL - RH.1

- NOTE:

 1. SEE RAINHEAD SCHEDULE FOR DIMENSIONS. 2. RAINHEAD WITDH = BOX GUTTER WIDTH 'W'
- 3. THE RAINHEAD IS TO BE FULLY SEALED TO THE BOX GUTTER AND THE FRONT OF THE RAINHEAD LEFT OPEN ABOVE THE OVERFLOW WEIR.

- POOL BACKWASH ABSORPTION TRENCH SIZING:


 1. SAND FILTER SYSTEM @ 300LPM BACKWASH FOR RECOMMENDED 2MIN DURATION = 600 L TOTAL DISCHARGE.
- GRAVEL ONLY TRENCH AT 0.35 VOID RATIO, TOTAL TRENCH VOLUME REQUIRED = 1.714m³.
- 3. TRENCH DIMENSIONS:
 - L: 4.8m, D: 0.6m, W: 0.6m

LL DIMENSI	ONS ARE IN METRES I	JNLESS NOT	ED OTHERV	WISE.	


A 02	20/12/2019	LTC	DAC	LIC	LIDDATE WITH CHED
A-02 A-01	22/10/2019	- TOTAL TOTAL	H102 -101 h-		UPDATE WITH SHED INITIAL RELEASE FOR D.A.
REV	DATE		DRN.		REVISION DETAILS



PROJECT DESCRIPTION	SHEET
PROPOSED RESIDENCE	OUTLET AND RAINHEAD DETAIL
PROJECT SITE	PLAN
259 WEST WILCHARD RD, CASTLEREAGH	SCP - STORMWATER CONCEPT PLAN
LGA	CLIENT
PENRITH CITY COUNCIL	MR. & MRS. SMITH

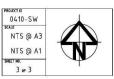

Document Set ID: 8974771 Version: 1, Version Date: 24/12/2019

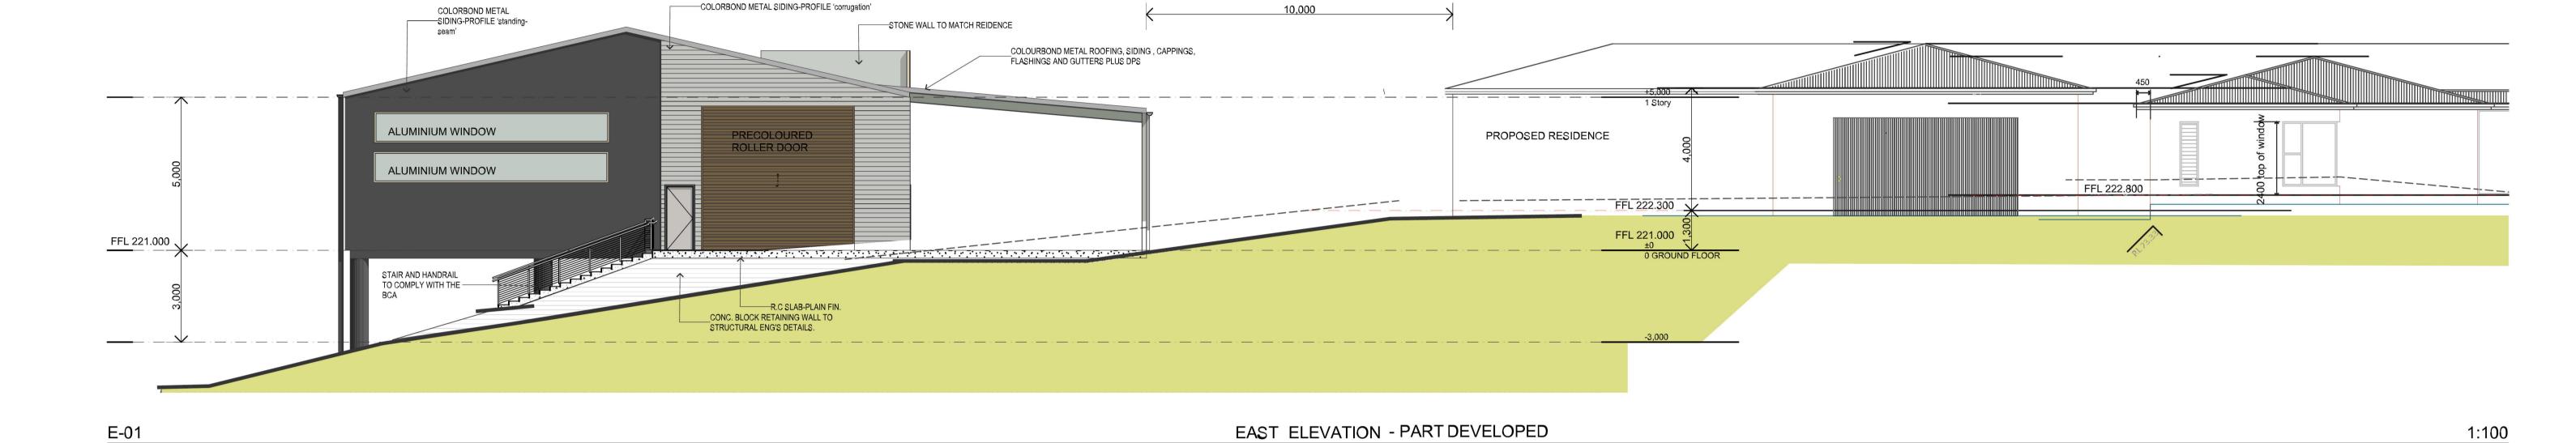




COLOUR SCHEME

WALL- COLORBOND METAL SIDING-PROFILE 'standing-seam'- COLOUR Monument steel Matt finish WALL- COLORBOND METAL SIDING-PROFILE 'corrugation'- COLOUR Surf Mist finish ROOF- COLORBOND METAL ROOFING-PROFILE 'corrugation'- COLOUR Surf Mist finish DOWNPIPES, GUTTERS-COLORBOND METAL-COLOUR Monument steel Matt finish COLUMNS, CONC. BLOCK WALL- PAINTED COLOUR Monument steel Matt finish STONE WALL- TO MATCH EXISTING RESIDENCE NB:STONE WALLTO BE STRUCTURALLY SOUND-REFER TO STRUCTURAL ENGINEER'S DETAILS GARAGE ROLLER DOORS- TO MATCH EXISTING RESIDENCE OR TIMBER LOOK-A-LIKE

3 Des Du Rieu Prafting computer aided drafting	ABN : 48 792 049 442		DAPLANS - SKETCH PLANS ONLY TO BE READ IN CONJUNCTION WITH THE PROPOSED MAIN RESIDENCE	PROPOSED SHED AND AWNING	259 , LOT 1 Castlereagh Road PENRITH NSW 2750	REVISION NO.	DRAWN BY:	DD 11/12/2019
Building Designer	General Notes The Builder shall check all dimensions and levels on site prior to construction.			OUTNIT:	DRAWING TITLE :	DRAWING NO.	PROJECT NO.	
Mobile Phone 0459 473 242 Address: 3 MONTROSE ROAD WINMALEE NSW 2777 P +02 47541140 E desdurieu@gmail.com	Notify any errors, discrepancies or omissions to the Designer. Drawings shall not be used for construction purposes until issued for construction. Do not scale drawings. All boundaries and contours subject to survey C:\Users\User\Documents\Archicad Dogs\User\St Kelly Smith-shed.pin	A DA SUBMISSION TO COUNCIL REVID DESCRIPTION	A1 SHEET, ACTUAL SCALE A3 SHEET, SCALE 1:200	MR MATTHEW SMITH & MRS KELLY SMITH	DA ELEVATIONS NORTH ELEVATION E-01	DA 300	Plot Date:	551

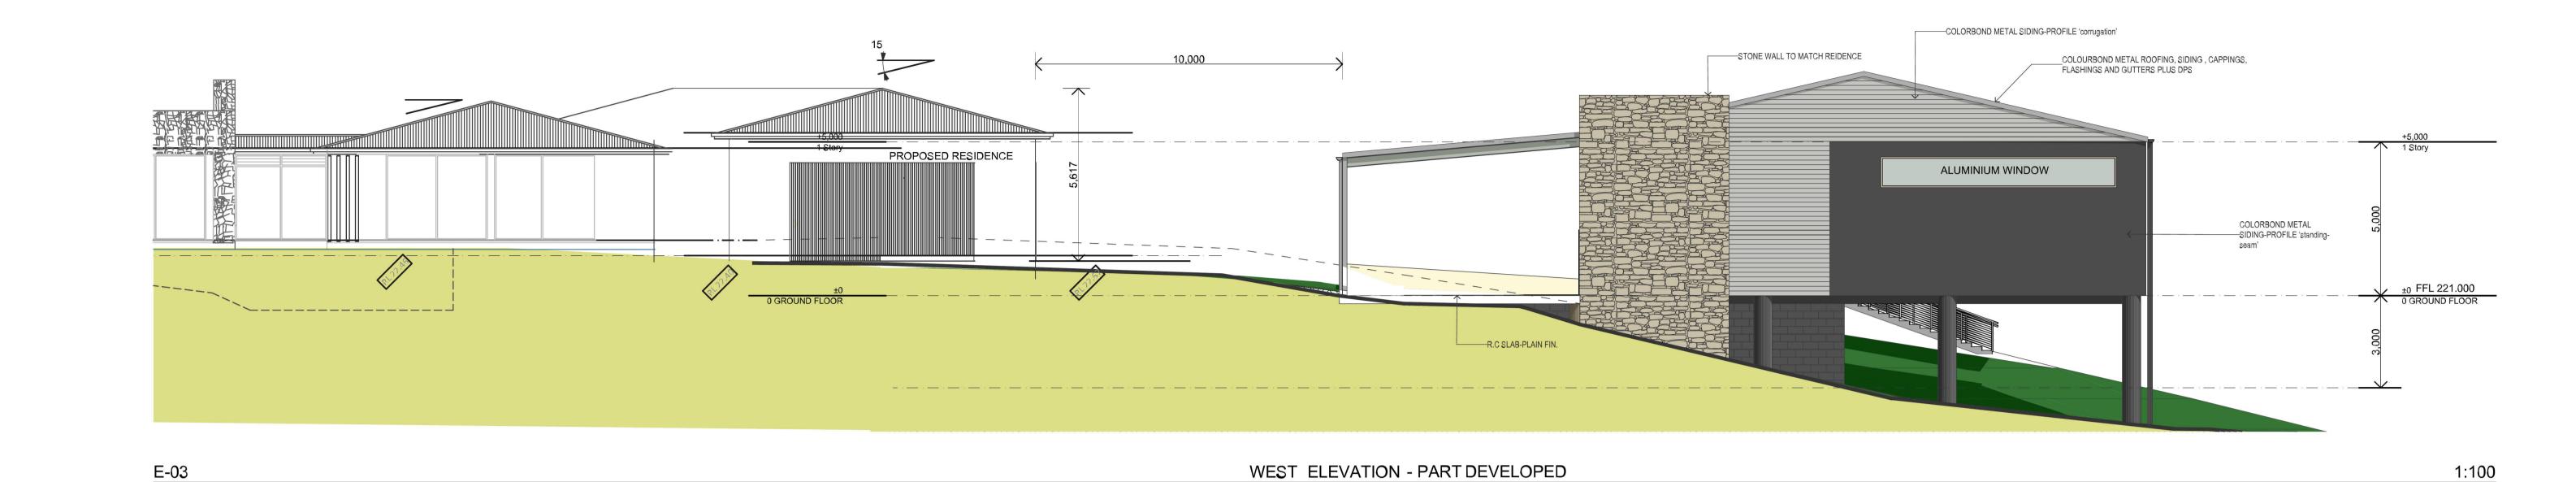











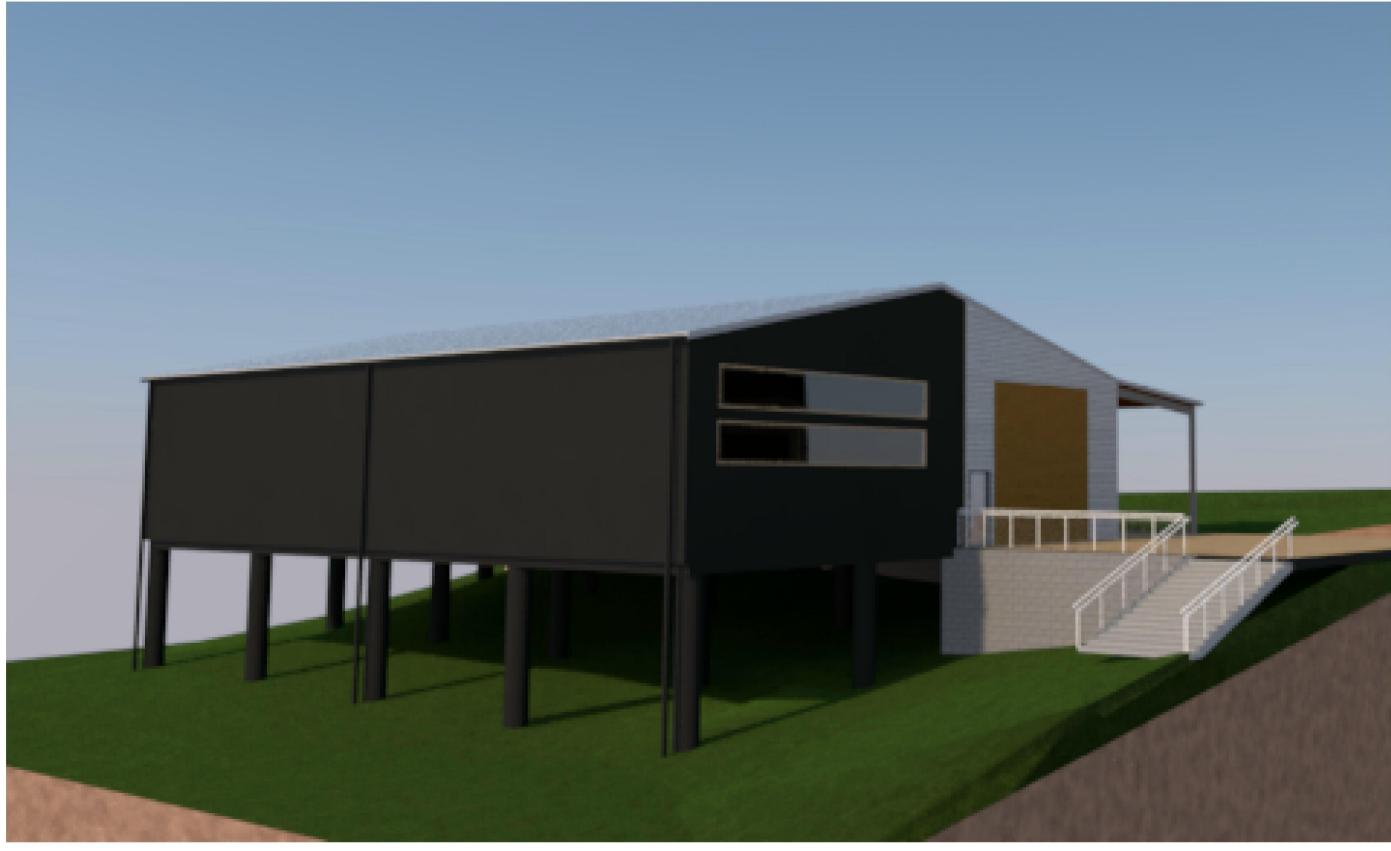

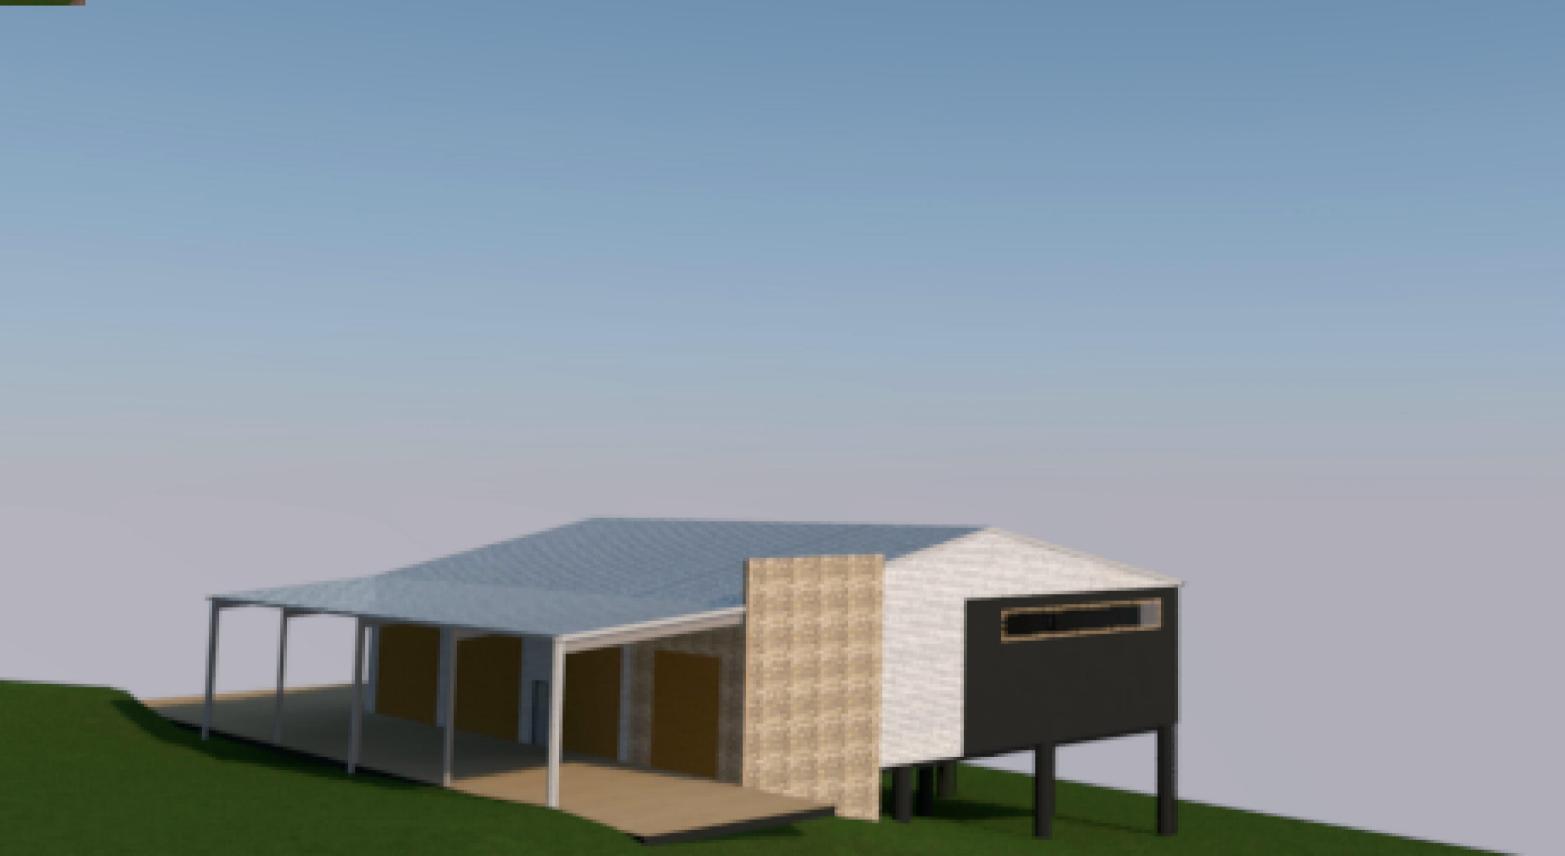

VIEWING NORTH FROM THE REAR OF THE BLOCK

VIEWING SOUTH FROM THE PROPOSED RESIDENCE



DAPLANS - SKETCH PLANS ONLY TO BE READ IN CONJUNCTION WITH THE PROPOSED MAIN RESIDENCE

A1 SHEET , ACTUAL SCALE A3 SHEET , SCALE 1:200

PROJECT NAME: PROPOSED SHED AND **AWNING**

MR MATTHEW SMITH & MRS KELLY SMITH


259,LOT 1 Castlereagh Road PENRITH NSW 2750

GENERAL INFO

PERSPECTIVES

REVISION NO.

11/12/2019 PROJECT NO. **DA 001** 551

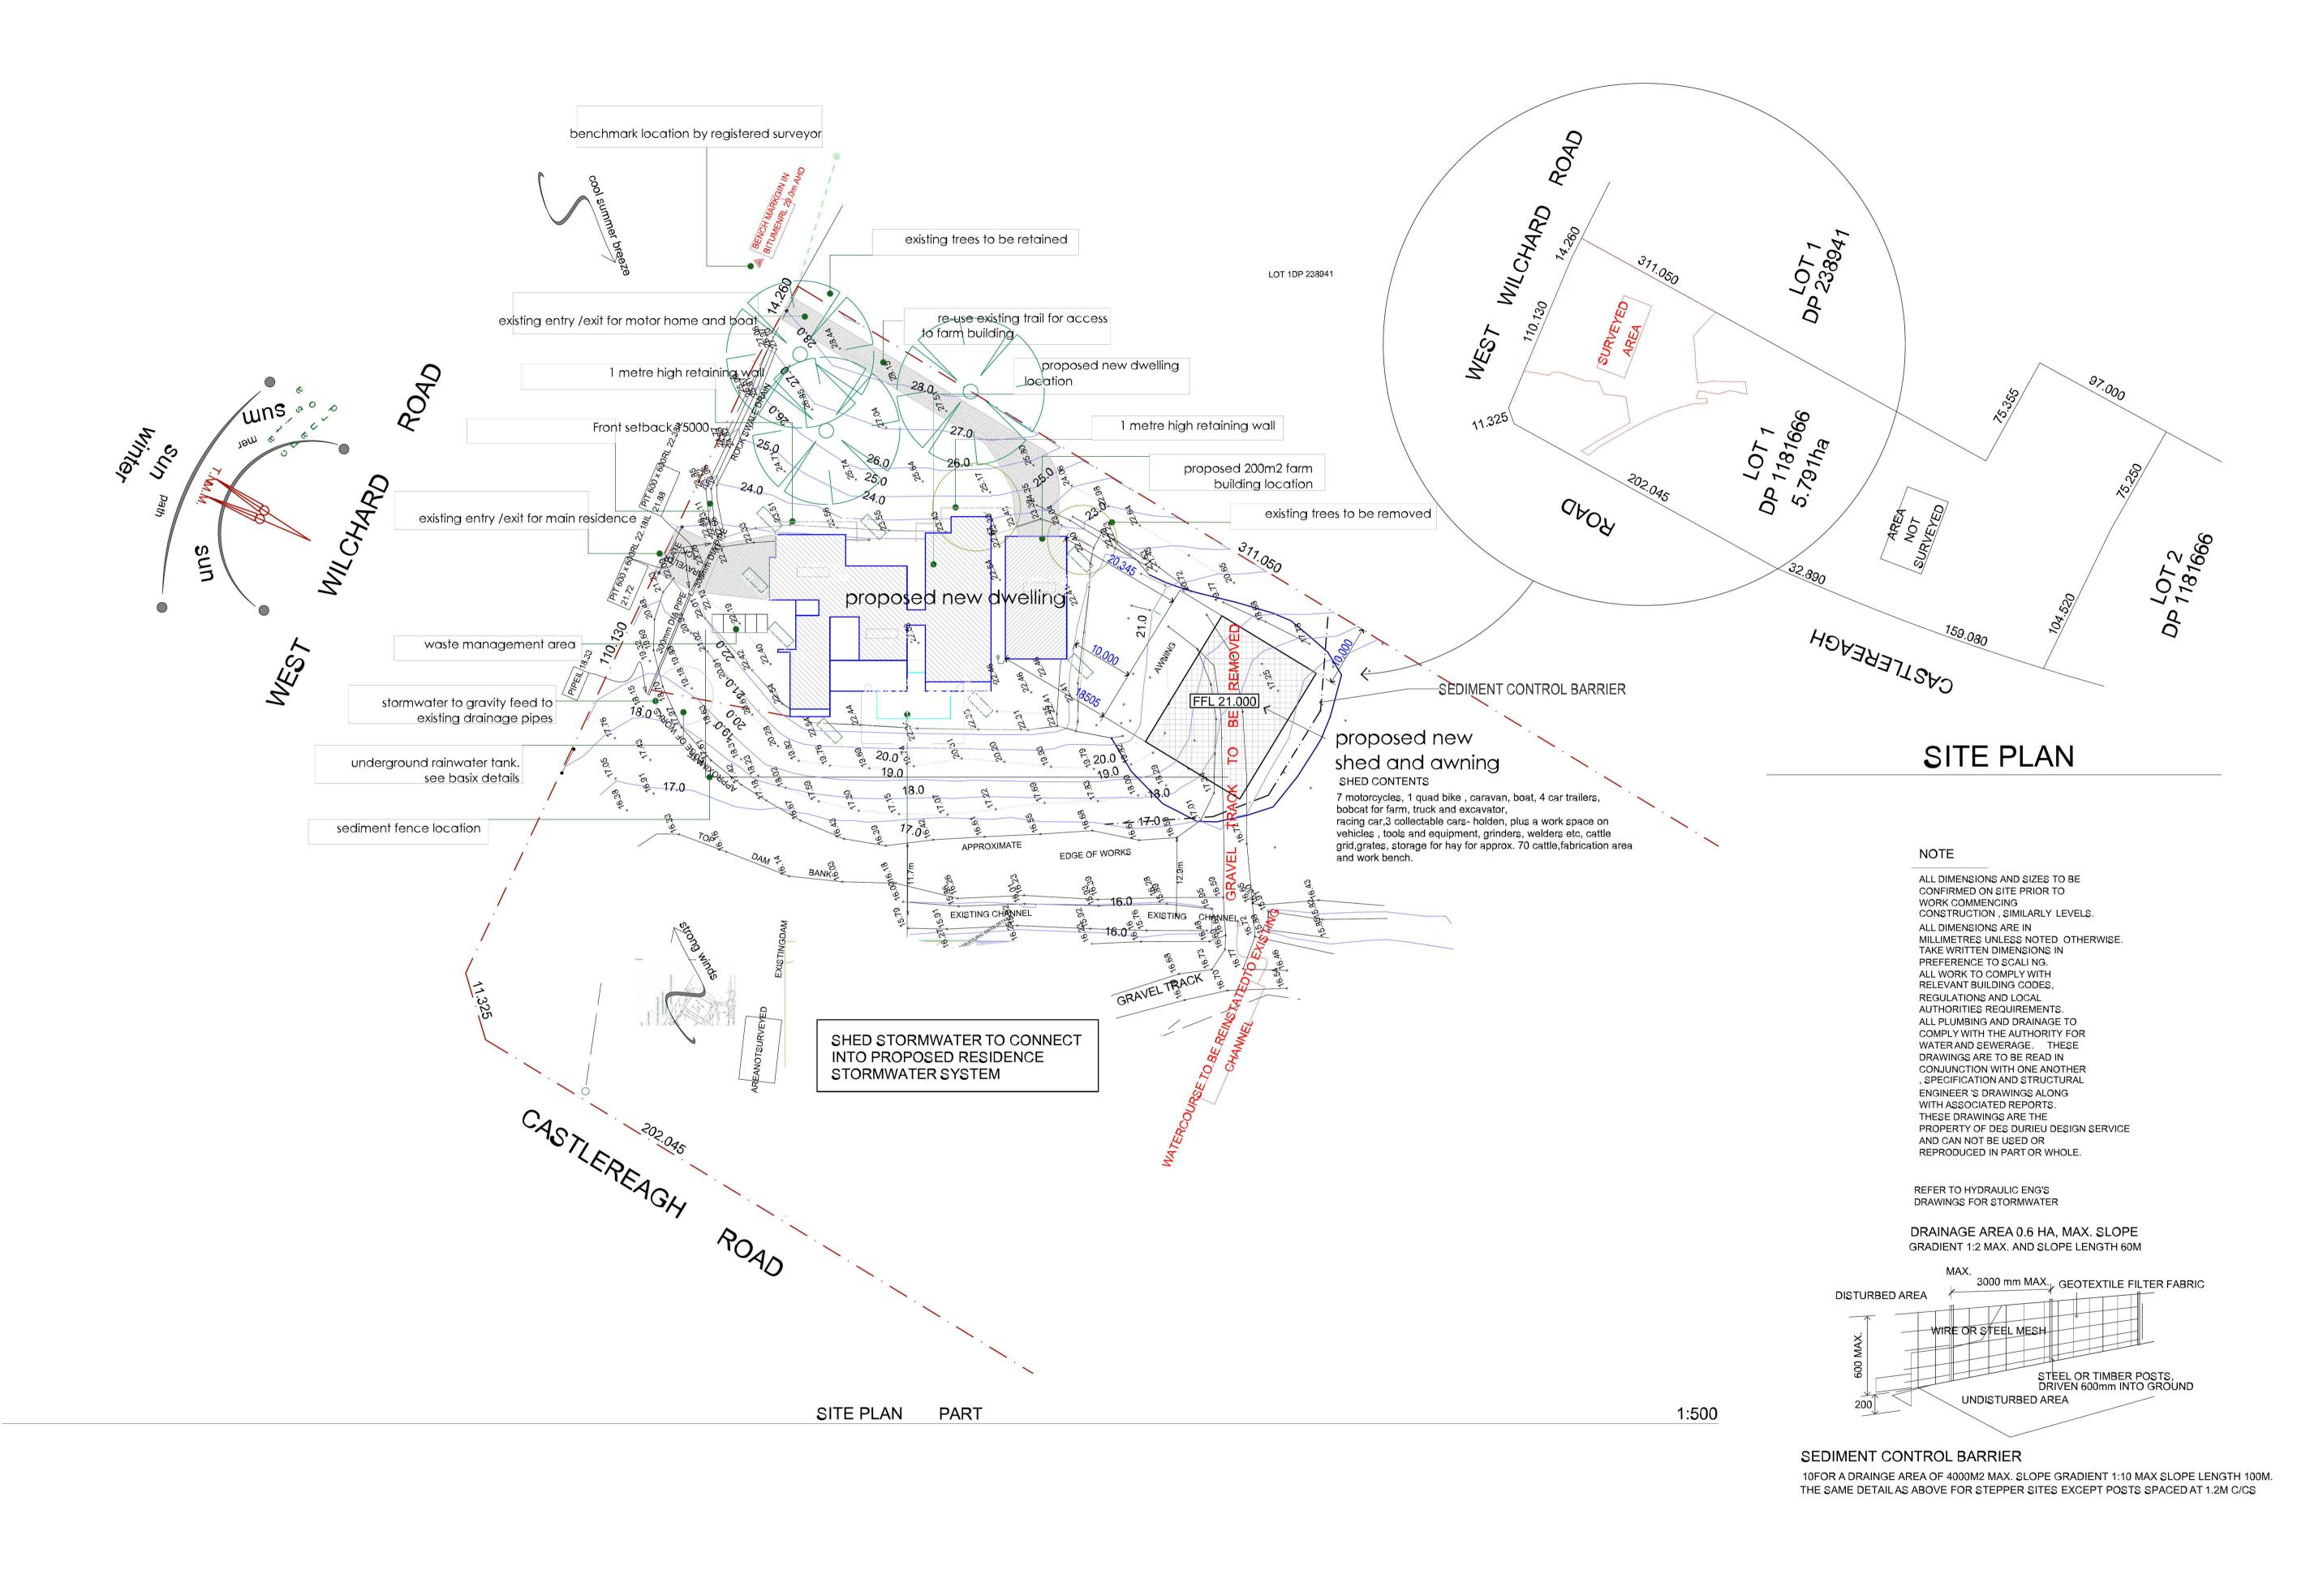


PROJECT NAME: REVISION NO. DRAWN BY: ABN: 48 792 049 442 DA PLANS - SKETCH PLANS ONLY 259, LOT 1 Castlereagh Road PENRITH PROPOSED SHED AND A NSW 2750 **AWNING** computer aided drafting TO BE READ IN CONJUNCTION WITH THE PROPOSED MAIN RESIDENCE 11/12/2019 General Notes


The Builder shall check all dimensions and levels on site prior to construction.

Notify any errors, discrepancies or omissions to the Designer.

Drawings shall not be used for construction purposes until issued for construction. **Building Designer DRAWING TITLE:** PROJECT NO. A1 SHEET, ACTUAL SC/1000 A3 SHEET, SCALE 1:200 Mobile Phone 0459 473 242 SITE AND LOCATION MR MATTHEW SMITH & MRS KELLY SMITH **DA 002** 551 Address: 3 MONTROSE ROAD WINMALEE NSW 2777
P +02 47541140 | | E desdurieu@gmail.com | All boundaries and contours subject to survey SITE PLAN DA SUBMISSION TO COUNCIL 12/12/2019

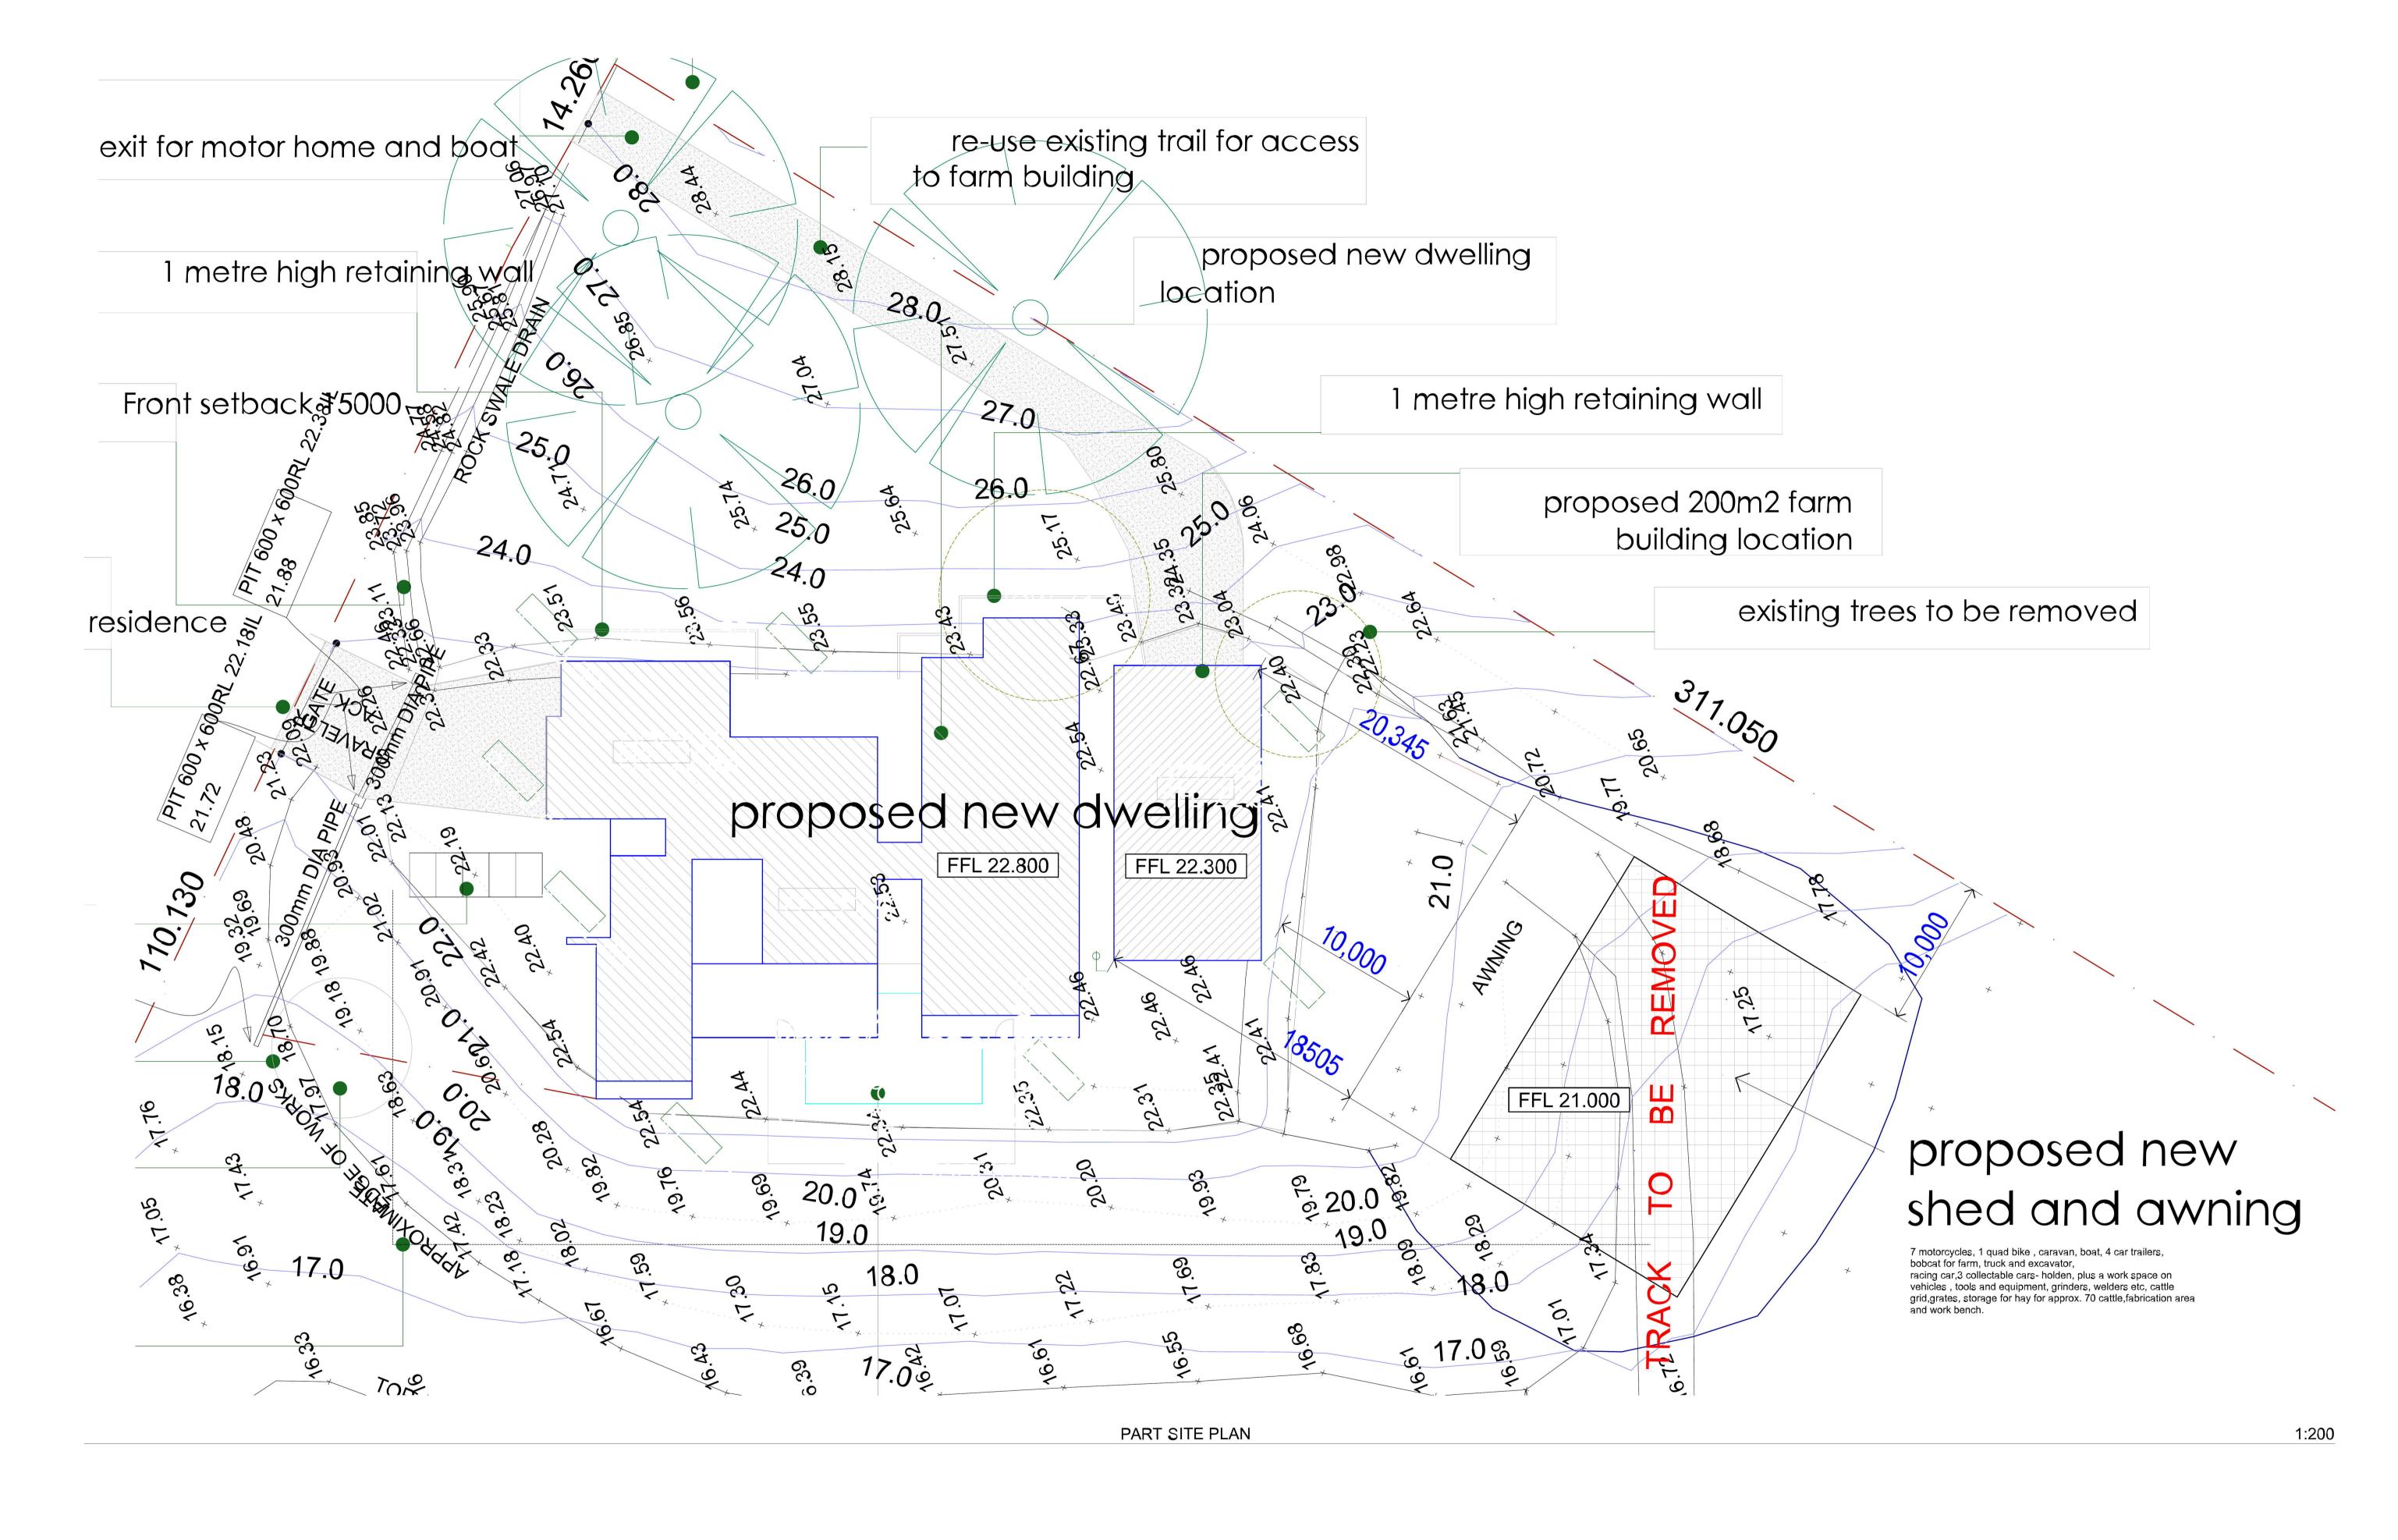





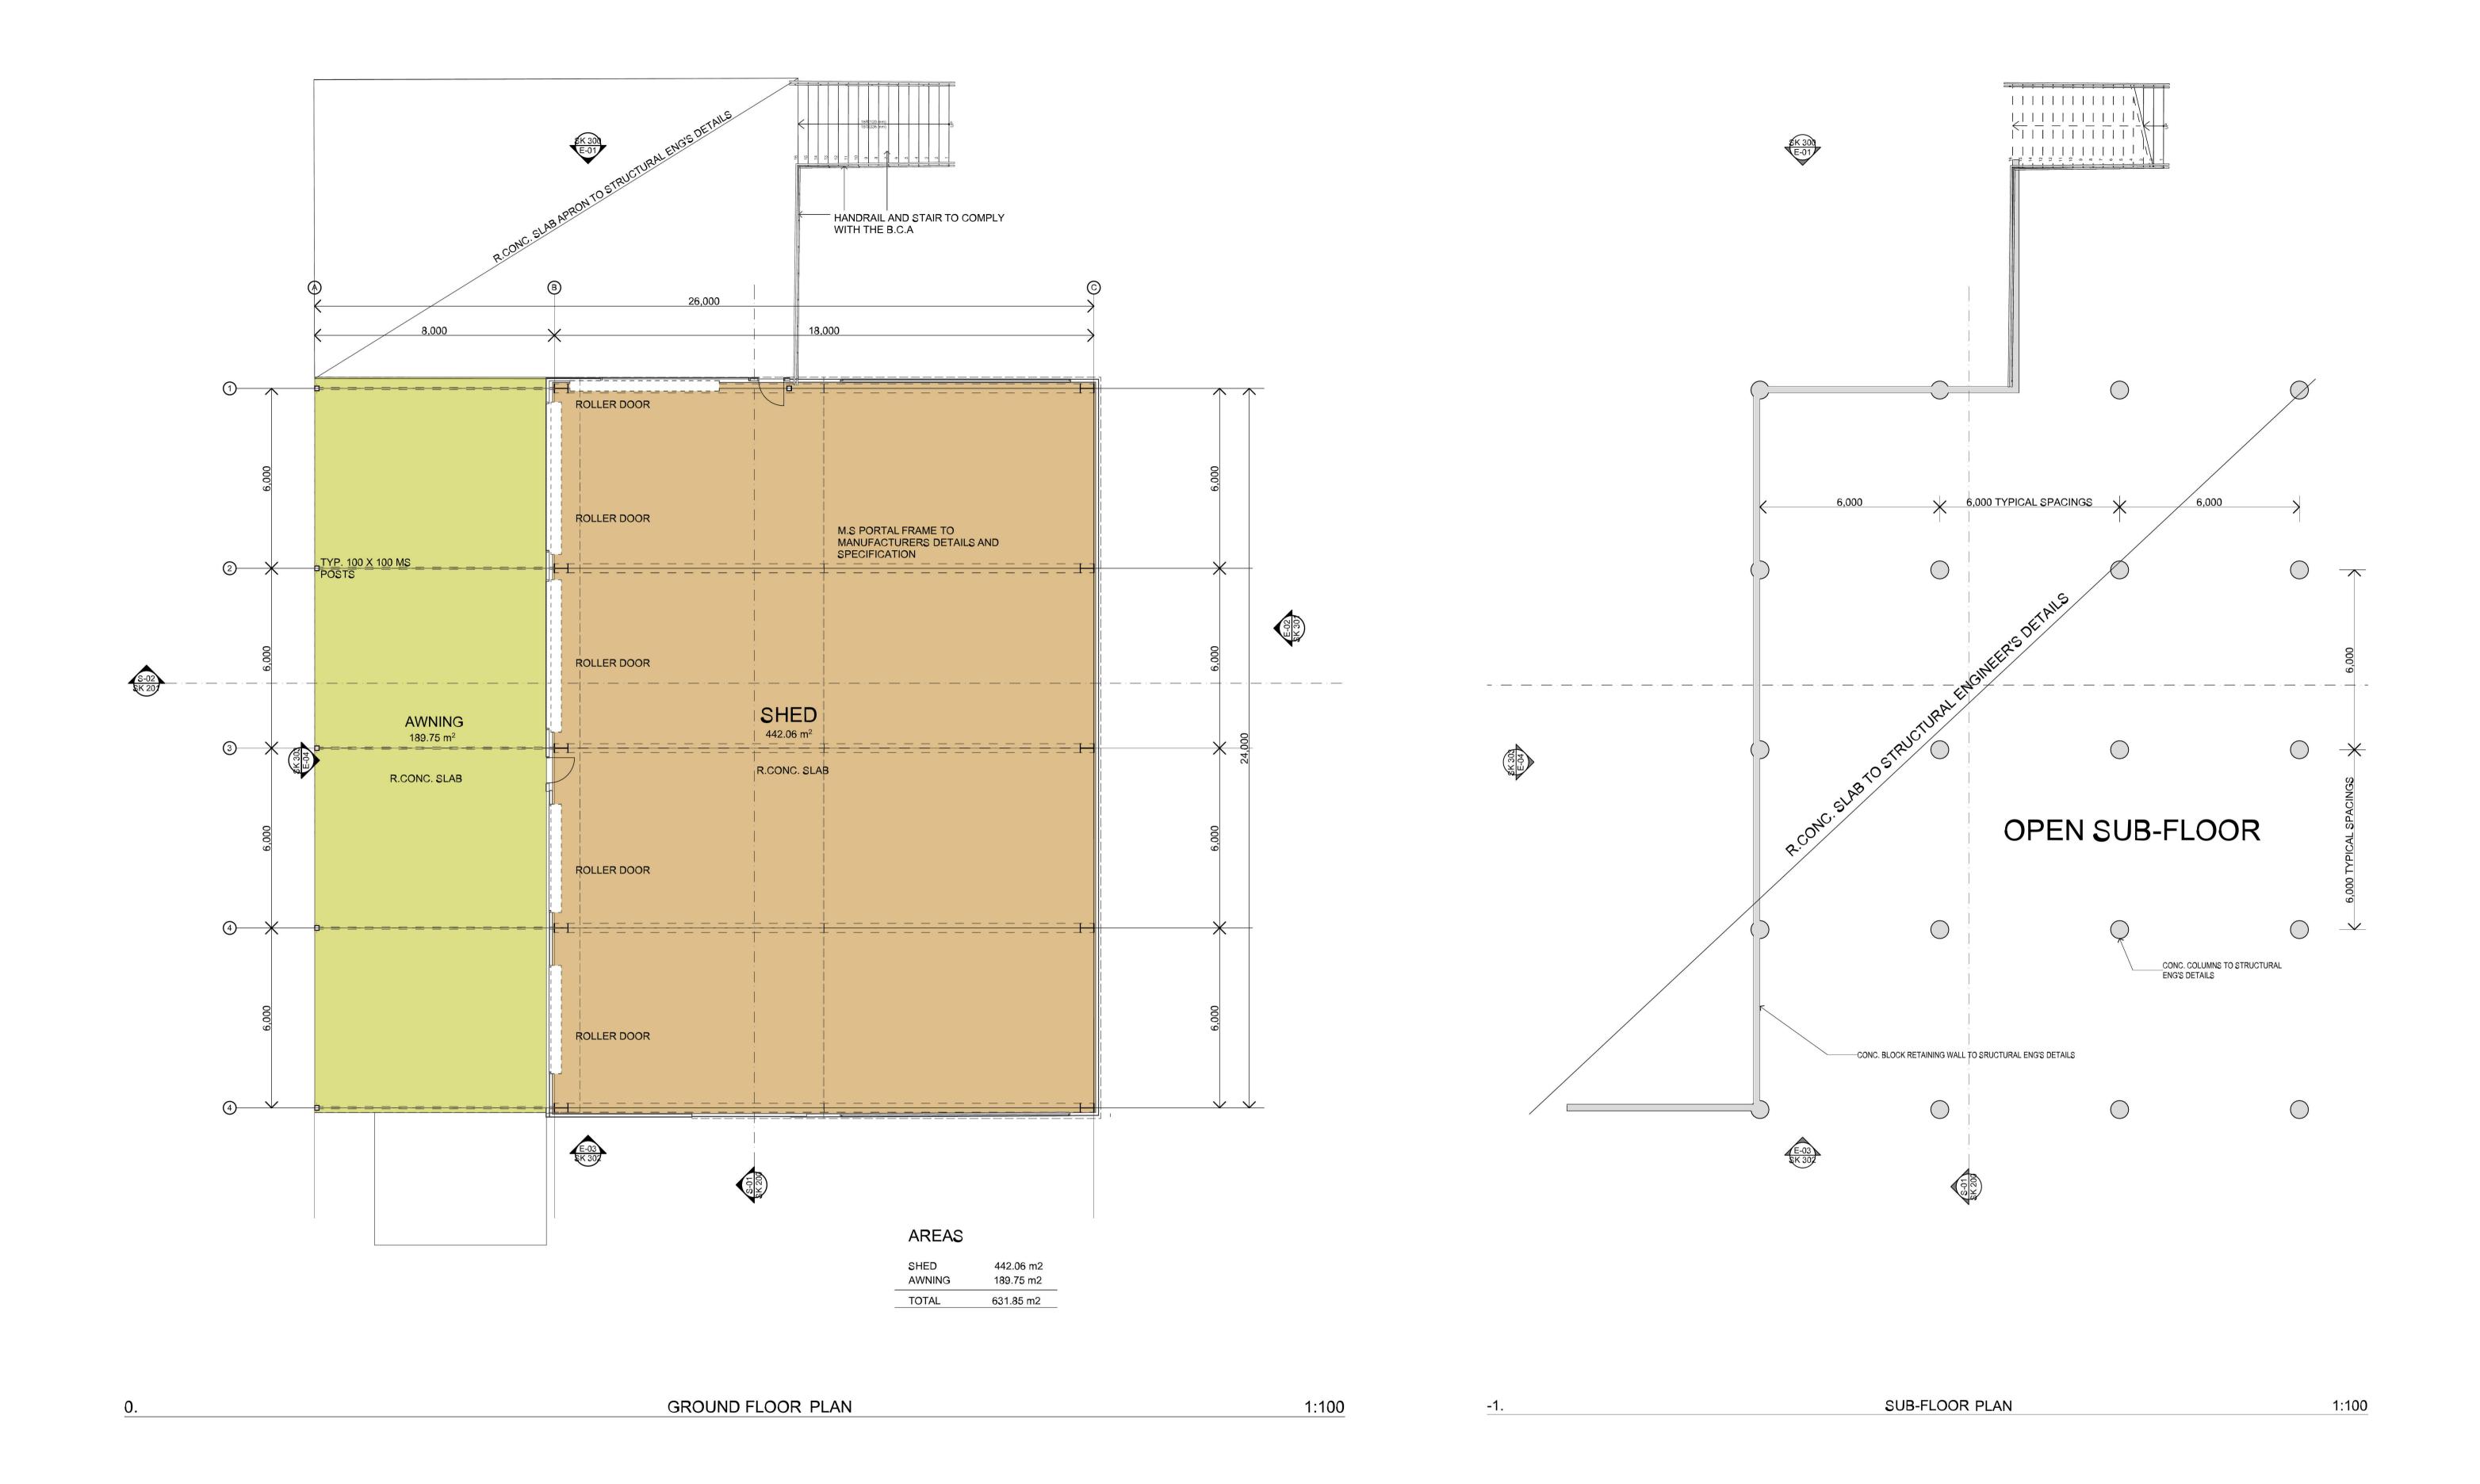


3 Des Du Rieu Prafting computer aided drafting	ABN : 48 792 049 442		DA PLANS - SKETCH PLANS ONLY TO BE READ IN CONJUNCTION WITH THE PROPOSED MAIN RESIDENCE	PROPOSED SHED AND AWNING	259 , LOT 1 Castlereagh Road PENRITH NSW 2750	REVISION NO.	DRAWN BY: DATE: 11/12/26
Building Designer	General Notes The Builder shall check all dimensions and levels on site prior to construction.				DRAWING TITLE:	DRAWING NO.	PROJECT NO.
Mobile Phone 0459 473 242 Address: 3 MONTROSE ROAD WINMALEE NSW 2777 P +02 47541140 E desdurieu@gmail.com	Notify any errors, discrepancies or omissions to the Designer. Drawings shall not be used for construction purposes until issued for construction. Do not scale drawings. All boundaries and contours subject to survey	A DA SUBMISSION TO COUNCIL 11/12/19	A1 SHEET , ACTUAL SCALE A3 SHEET , SCALE 1:200	MR MATTHEW SMITH & MRS KELLY SMITH	DA PLANS GROUND FLOOR	DA 100	5

13° ROOF PITCH M.S. PORTAL FRAME TO MANUFACTURERS DETAILS AND SPECIFICATIONS

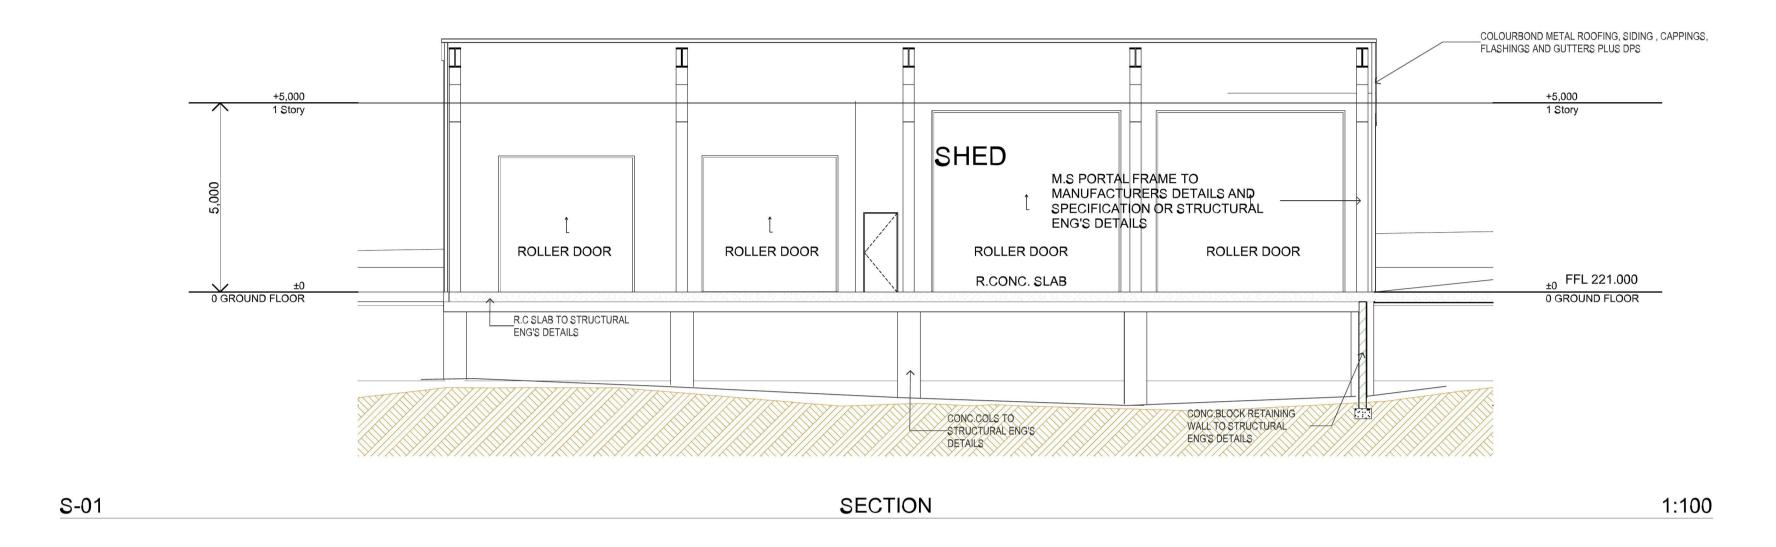

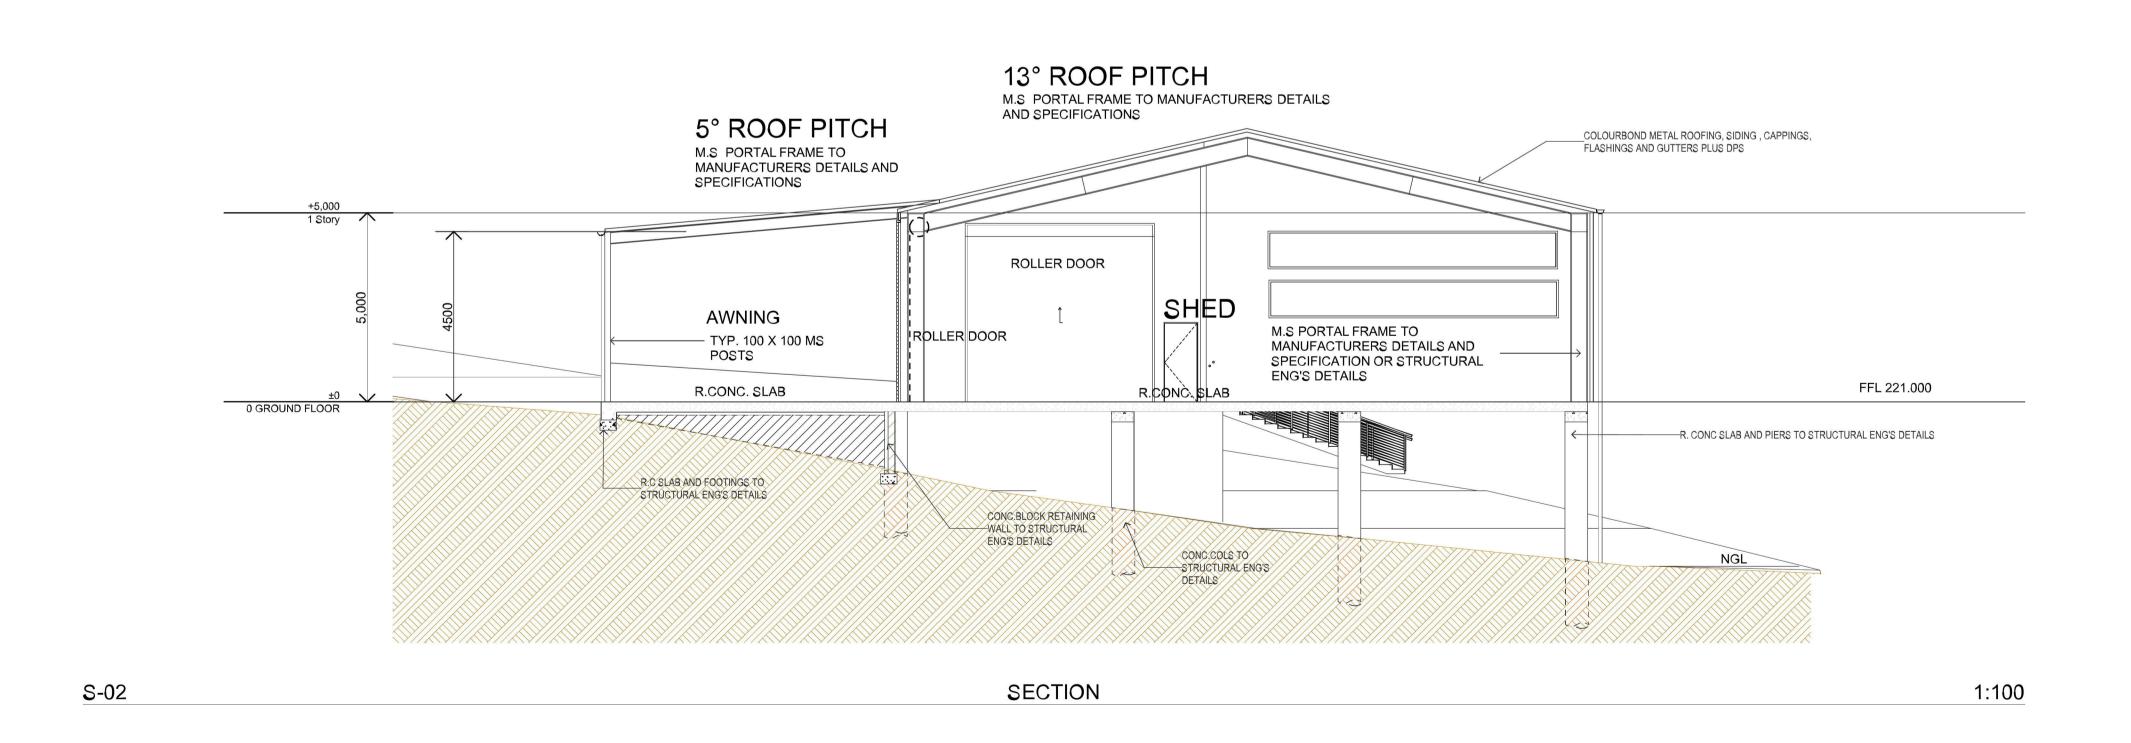



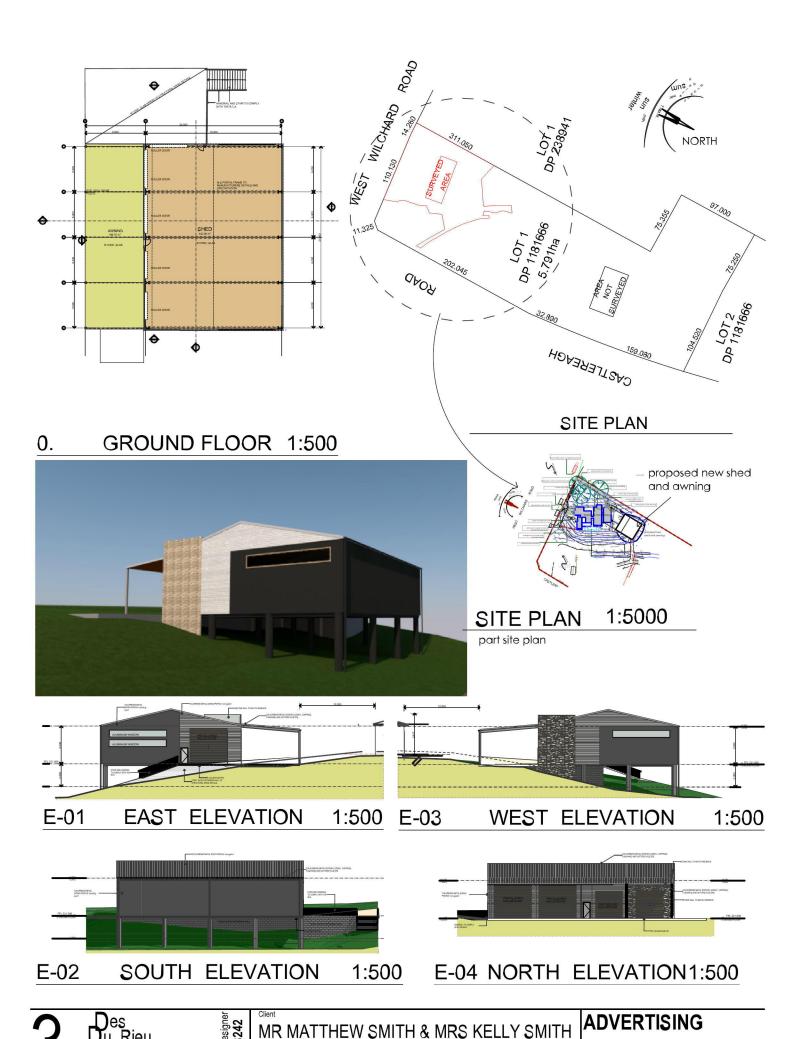

Des Du Rieu Computer aided drafting at ID: 89747771 SK 500 PROPOSED SHED AND AWNING Plot Date 12/12/2019 Document Set ID: 8974771

Version: 1, Version Date: 24/12/2019