DEVELOPMENT APPLICATION FOR 50-UNIT RESIDENTIAL FLAT BUILDING & 90 PLACE CHILDCARE CENTRE 71 PARK AVENUE, KINGSWOOD

	DRAWING REGISTER
SHEET NUMBER	SHEET TITLE

INTRODUCTORY

DA-000	DRAWING LIST
DA-001	SITE ANALYSIS
DA-002	SURVEY PLAN
DA-003	STREETSCAPE
DA-004	PHOTOMONTAGE

FLOOR PLANS


DA-009	SITE PLAN
DA-010	BASEMENT 2 PLAN
DA-011	BASEMENT 1 PLAN
DA-012	GROUND FLOOR PLAN
DA-013	LEVEL 1 PLAN
DA-014	LEVEL 2 PLAN
DA-015	LEVEL 3 PLAN
DA-016	LEVEL 4 PLAN
DA-017	LEVEL 5 PLAN

ELEVATIONS, SECTIONS & DETAILS

DA-021	SOUTH ELEVATION AND MATERIALS & FINISHES
DA-022	EAST ELEVATION AND MATERIALS & FINISHES
DA-023	WEST ELEVATION AND MATERIALS & FINISHES
DA-024	NORTH ELEVATION AND MATERIALS & FINISHES
DA-031	SECTION A - A
DA-032	SECTION B - B
DA-041	ACCESS DRIVEWAY PROFILES

MISCELLANEOUS


SHADOW DIAGRAMS JUNE 21
ADAPTABLE UNIT LAYOUTS
HEIGHT PLANE DIAGRAM
SEPP65 COMPLIANCE TABLES & UNIT SCHEDULE
GFA/FSR CALCULATIONS
LANDSCAPE & DEEP SOIL AREA CALCULATIONS
COMMUNAL OPEN SPACE CALCULATIONS
CROSS VENTILATION DIAGRAMS
SOLAR ACCESS DIAGRAMS - 1
SOLAR ACCESS DIAGRAMS - 2 AND SCHEUDLE

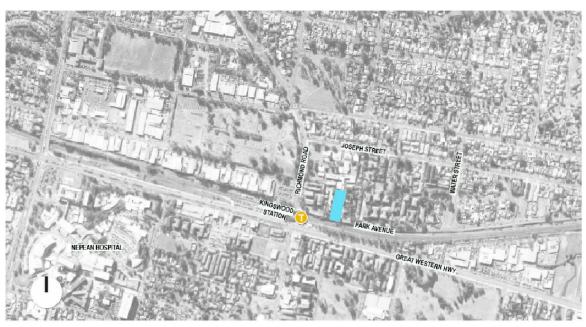


AERIAL PHOTO

DEVELOPMENT APPLICATION -


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				PAM CORNERSTONE P/L	planning, urban design, landscape orchitecture, architecture, interior design ABN 44 087 958 423 SUITE 91, 24-32 PIRRAMA ROAD PYEMONI NSW 2009	Reproduction or publication of the whole or part of the drawing without a license of the owner of the copyright is an infringement of copyright.	71 Park Avenue	DRAWING LIST	Drawn by LN	Check by S.B
					TEL (612) 9029 7286 EMAIL: admin@stephenbowersarchitects.com stephen.bowers@stephenbowersarchitects.com REGISTERED ARCHITECT - STEPHEN BOWERS (5810)	Do not scale drawings Verify all dimension on site Report any discrepencies in documents to Architect	Kingswood NSW 2747		Drawing No. DA - 000 Cad file path.	Revision -

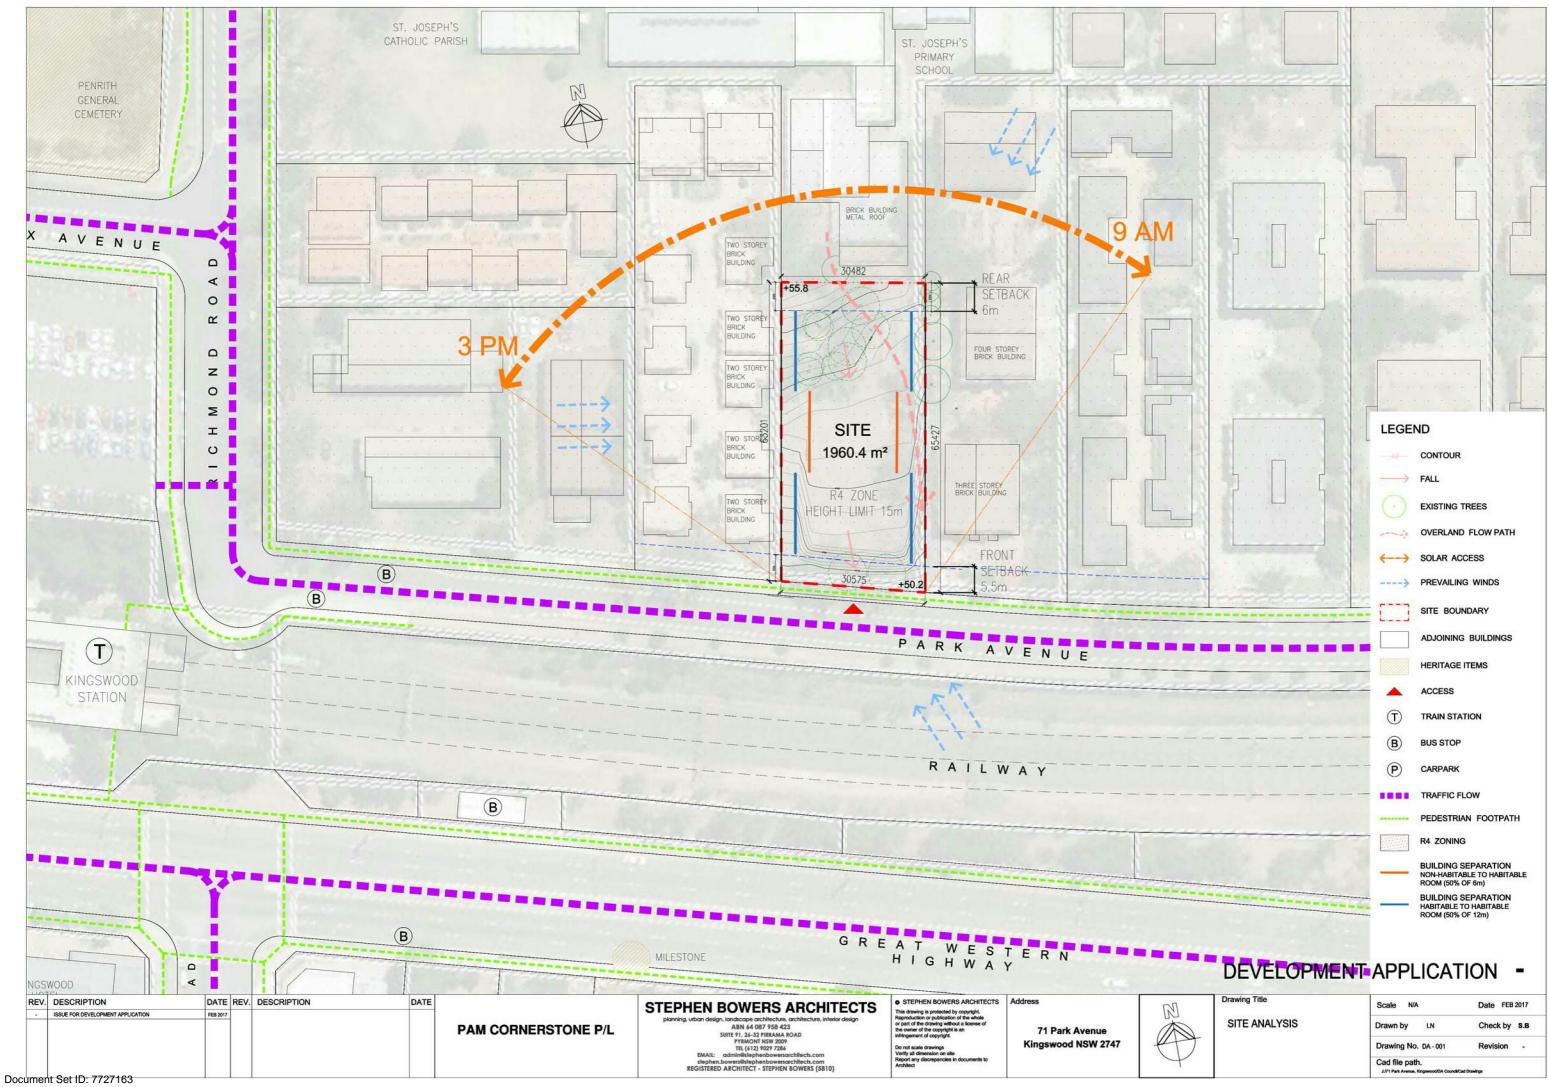


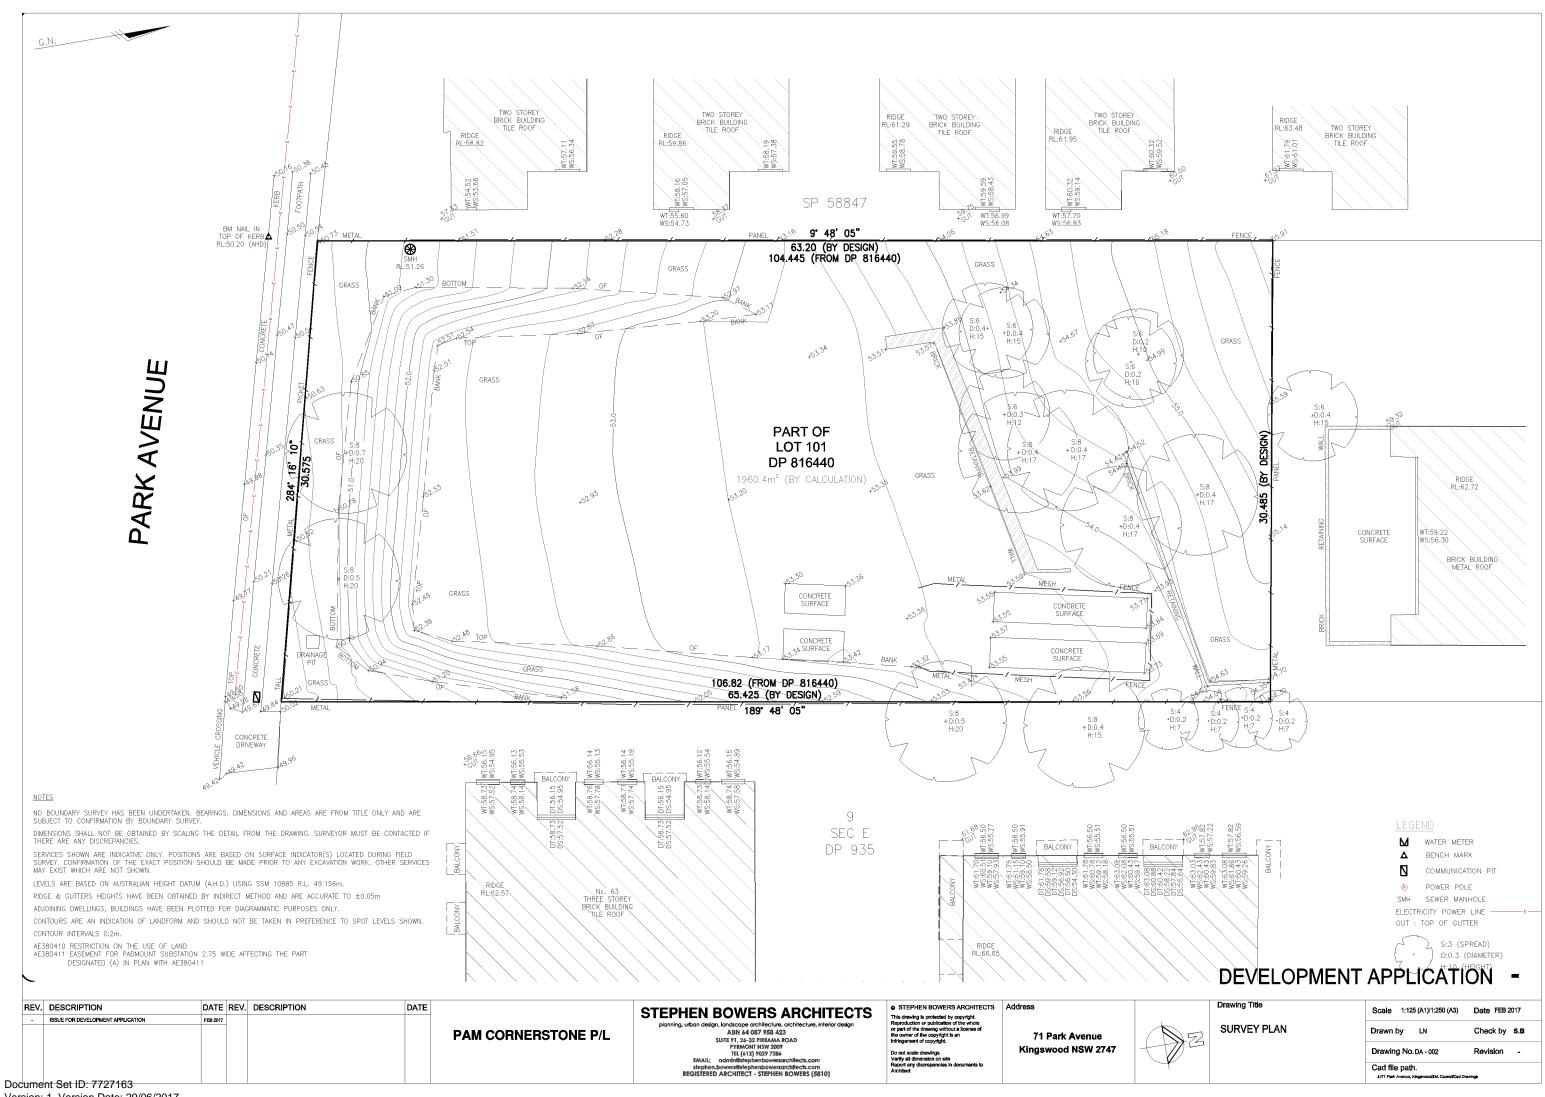






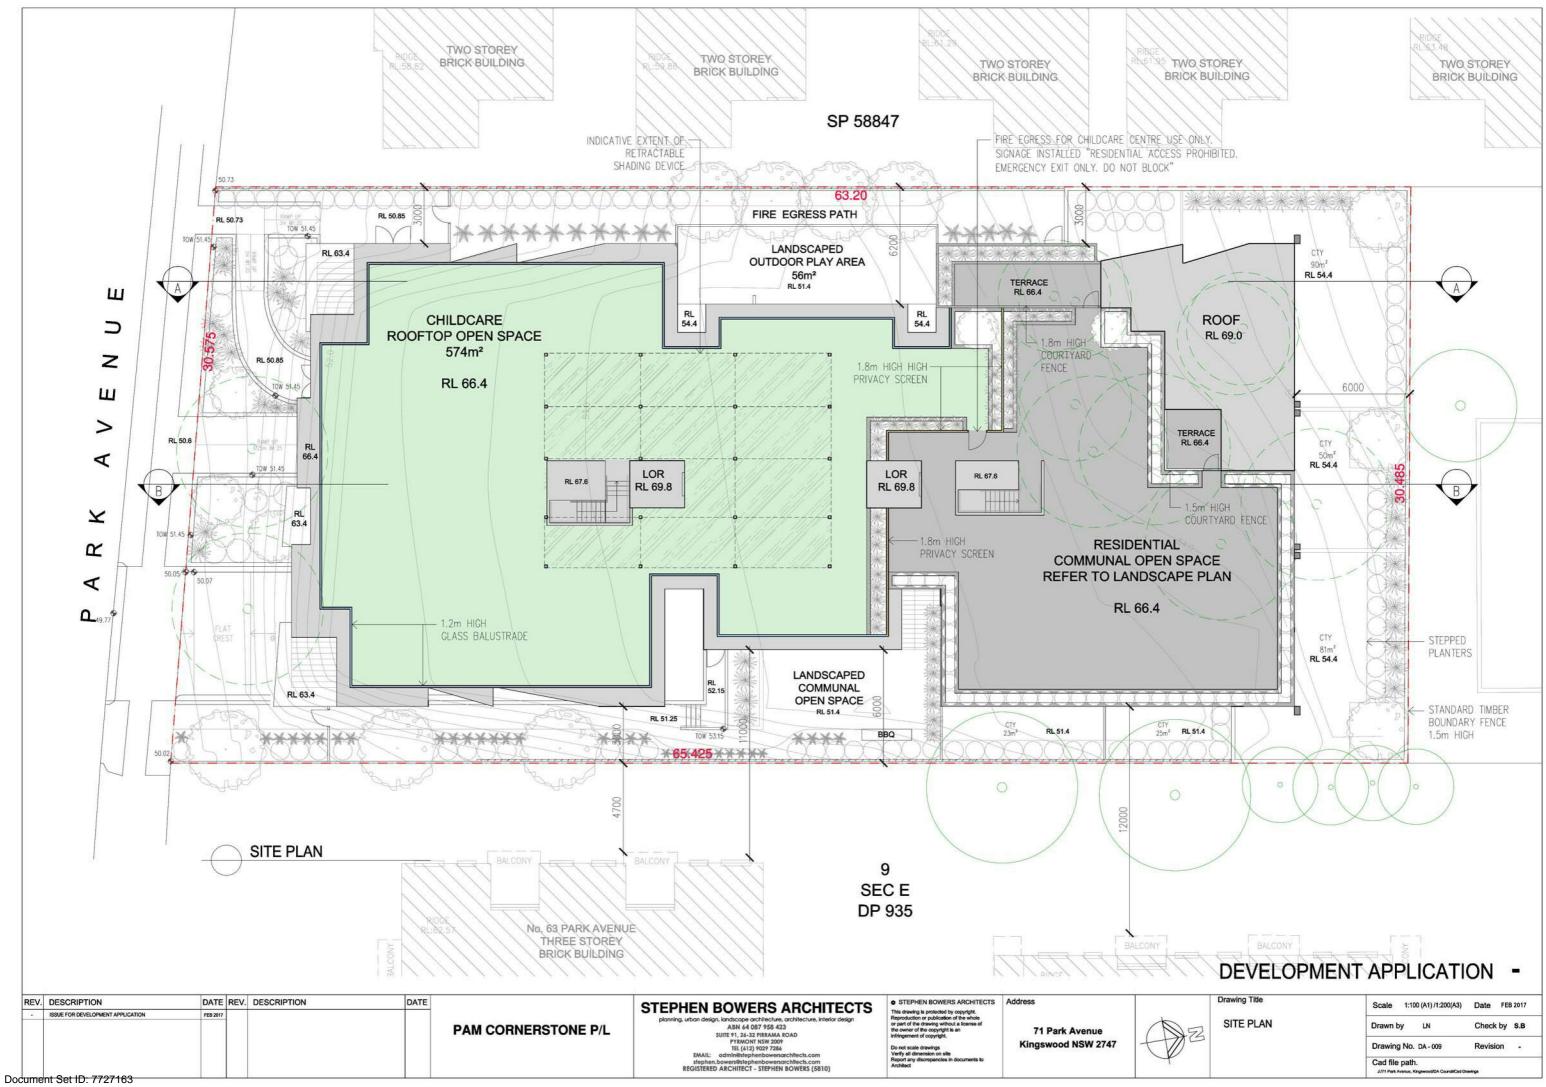

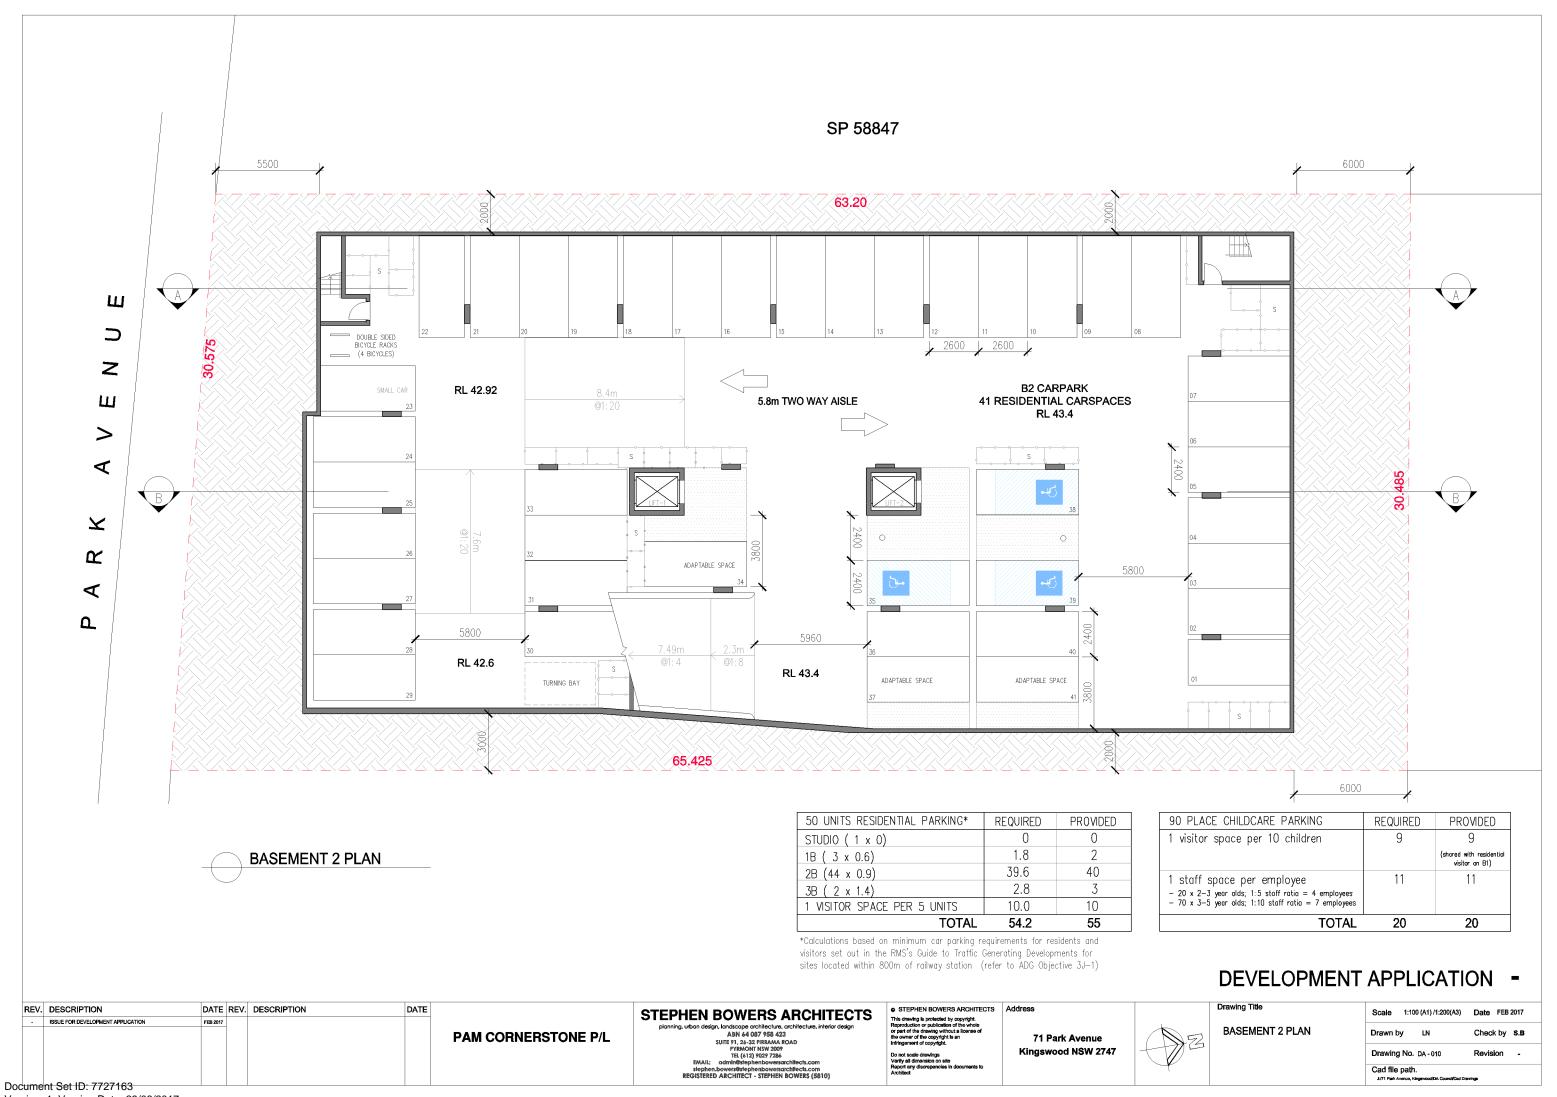

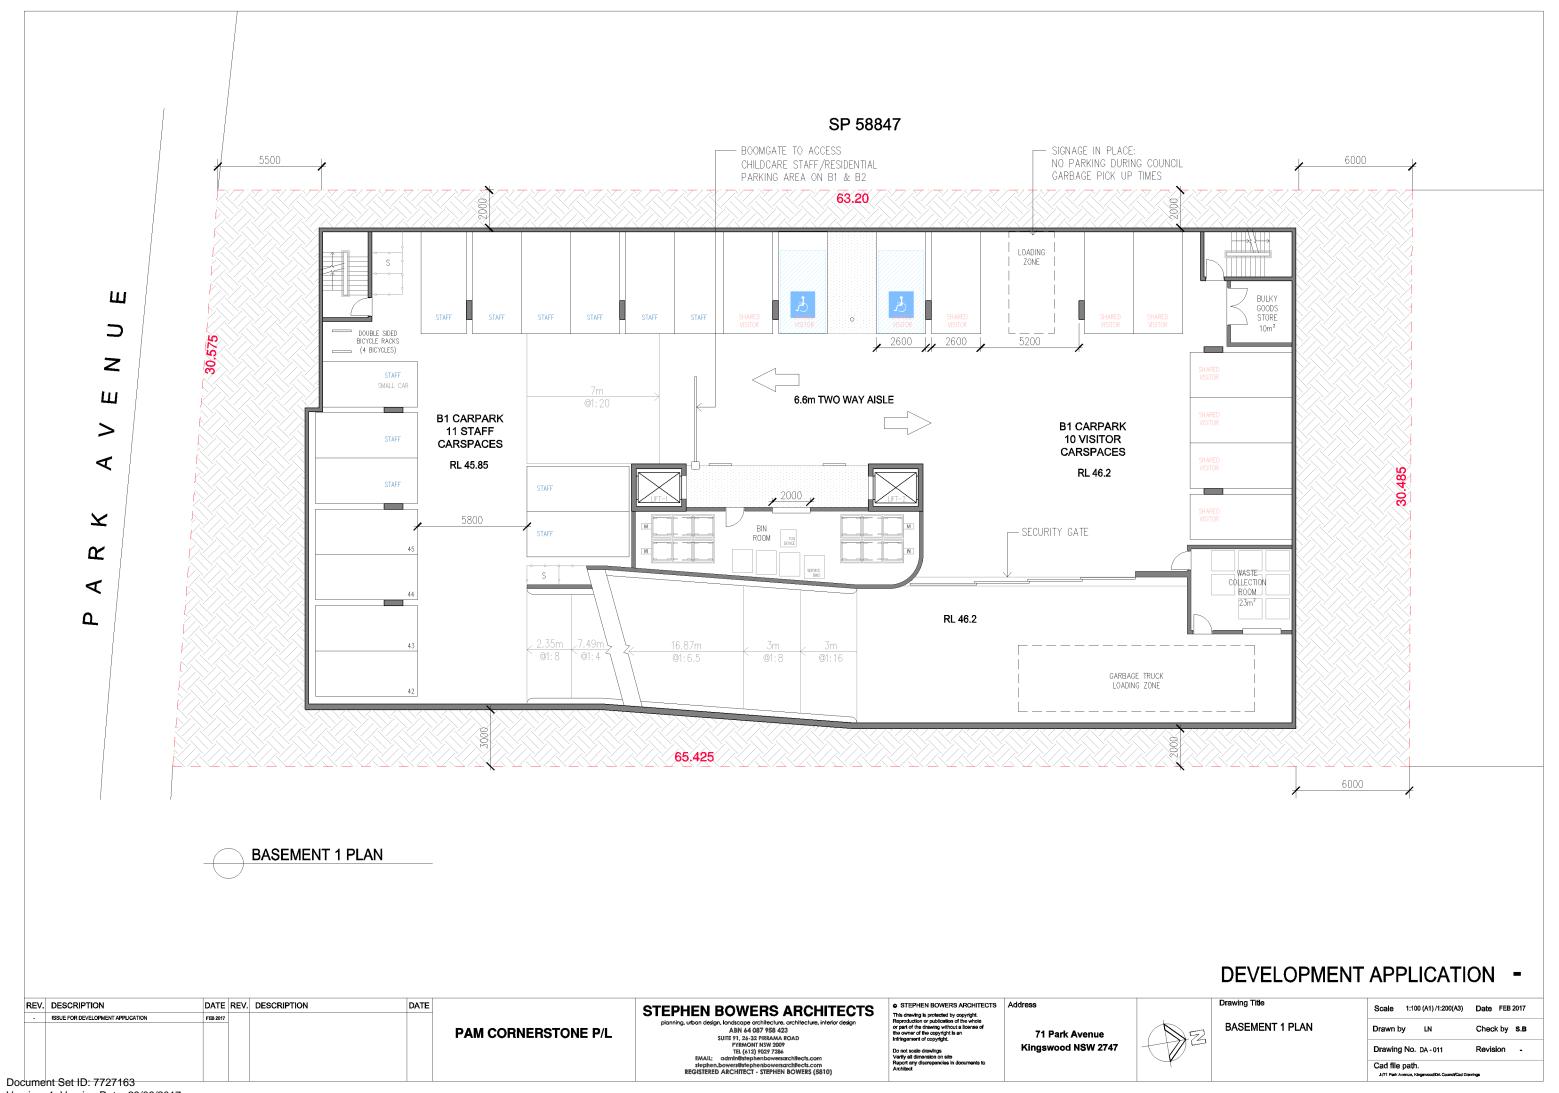



SOUTH ELEVATION AND

LEGEND

- A PORTALS: RENDER & PAINT DULUX COLOUR 'PEPLUM QUARTER'
- B POWDERCOATED METAL BATTENS -TIMBER FINISH
- C RENDER & PAINT -DULUX COLOUR 'TIMELESS GREY'
- D 'L' ANGLE DULUX POWDERCOAT METAL NEW HAMMERSLEY BROWN
- E CLEAR GLASS BALUSTRADE
- F VERTICAL BALUSTERS 'DULUX POWDERCOAT BLACK
- G PERGOLA
- H RENDER & PAINT ENTRY FEATURE DULUX COLOUR 'JUBILATION'
- J ROOF DULUX POWDERCOAT 'WOODLAND GREY'
- K RENDER & PAINT DULUX COLOUR 'STEPNEY'
- L RENDER & PAINT DULUX COLOUR 'PEPLUM HALF'

MATERIALS & FINISHES

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Drawing Title REV. DESCRIPTION DATE REV. DESCRIPTION STEPHEN BOWERS ARCHITECTS Address DATE Scale 1:100 (A1) /1:200(A3) Date FEB 2017 STEPHEN BOWERS ARCHITECTS andscape architecture, a ABN 64 087 958 423 SOUTH ELEVATION AND PAM CORNERSTONE P/L 71 Park Avenue SUITE 91, 26-32 PIRRAMA ROAD PYRMONT NSW 2009 TEL (612) 9029 7286 EMAIL: admin@stephenbowersarchitec MATERIALS & FINISHES Kingswood NSW 2747 Drawing No. DA - 021 Revision -Cad file path. stephen.bowers@stephenbowersarchitects.com REGISTERED ARCHITECT - STEPHEN BOWERS (5810)







E CLEAR GLASS BALUSTRADE

F VERTICAL BALUSTERS ' DULUX POWDERCOAT BLACK

G PERGOLA

D 'L' ANGLE

LEGEND

TIMBER FINISH C RENDER & PAINT -

H RENDER & PAINT ENTRY FEATURE DULUX COLOUR 'JUBILATION'

J ROOF - DULUX POWDERCOAT 'WOODLAND GREY'

K RENDER & PAINT DULUX COLOUR 'STEPNEY'

L RENDER & PAINT DULUX COLOUR 'PEPLUM HALF' NORTH ELEVATION AND MATERIALS & FINISHES

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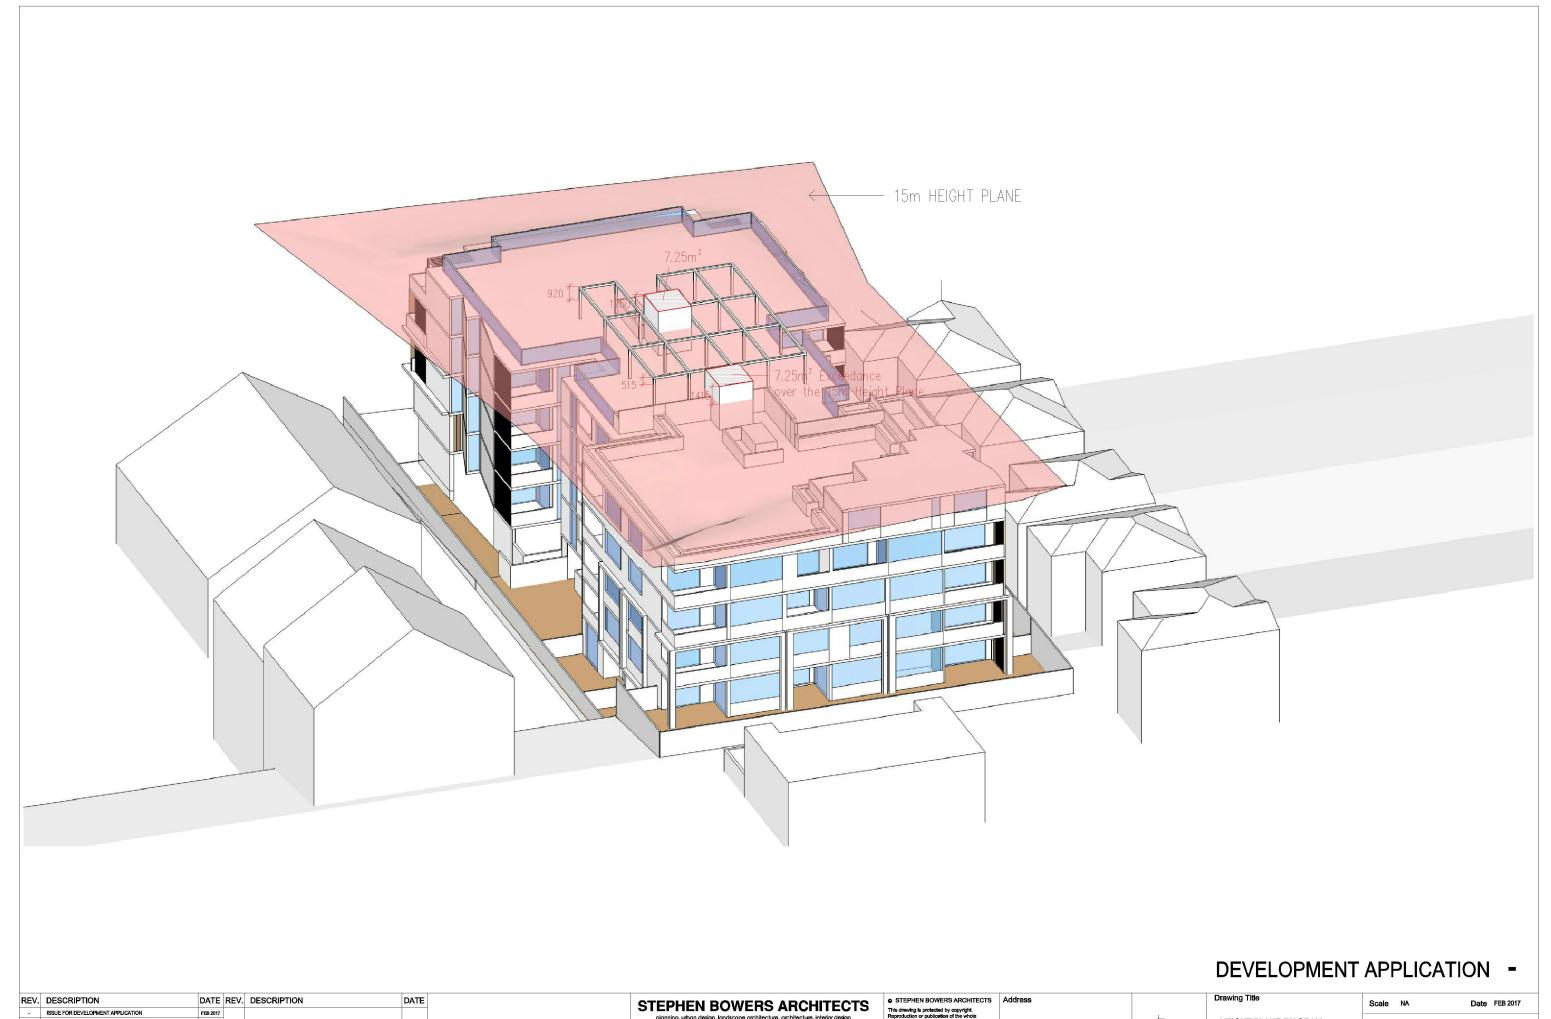
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Document Set ID: 7727163 Version: 1, Version Date: 29/06/2017



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71 Park Avenue Kingswood NSW 2747

HEIGHT PLANE DIAGRAM

Drawing No. DA - 081 Cad file path.

LEVEL	Nett Area (m2)	G	L1	L2	L3	L4	SUBT	TOTAL	PERCENTAGE
STUDIO	41m ²	1	-	-	-	-	1	1	2%
1B	50m ²	1	2	-	-	-	3	3	6%
2B	71m²	-	-	-	-	1	1		000/
2B	75 - 83m²	2	10	11	11	9	43	44	88%
3B	95m²	-	-	-	_	2	2	2	4%
TOTAL		4	12	11	11	12	50	50	100%

LANDSCAPED AREA

Penrith DCP - The minimum amount of landscaped area to be provided on a site shall be 35% of the site area.

SITE AREA	1960.4 m ²
LEVEL	LANDSCAPED AREA
GROUND LEVEL	483.1 m ²
LEVEL 1	231.6 m ²
LEVEL 5	925.0 m ²
TOTAL	1639.7 m ²
% LANDSCAPE AREA	83.6%

DEEP SOIL AREA

Residential Flat Building; Apartment Design Guide 2015

Deep soil zones are to meet the following minmum requirement: 7% of the site area for sites greater then 1500m²

SITE AREA	1960.4 m ²
LEVEL	DEEP SOIL AREA
GROUND LEVEL	185.2 m ²
TOTAL	185.2 m ²
% DEEP SOIL	9.4%


COMMUNAL OPEN SPACE
Residential Flat Building; Apartment Design Guide 2015
Communal open space has a minimum area equal to 25% of


SITE AREA	1960.4 m ²
LEVEL	COMMUNAL OPEN SPACE
GROUND LEVEL	177.5 m ²
LEVEL 5 (ROOF TOP)	317.0 m ²
TOTAL	494.5 m ²
% COMMUNAL OPEN SPACE	25.2 %


Level	Unit No.	Bedroom	Nett Area (m²)	Bal/ Cty (m²)	Min Internal Storage (m ³)	Min External Storage (m ³)	Adaptability	Solar Access (2hr between 9am - 3pm on winter solstice)	Cross Ventilation
	1	STUDIO	41	10	2	2			
GE	2	1B	50	15	3	3	✓		
Level GF L1 L2	3	2B	75	23	4	4			✓
	4	2B	79	25	4	4			
	5	2B	76	10	4	4		✓	✓
	6	2B	75	90	4	4		✓	
	7	2B/2S	83	50	4	4		✓	
	8	2B	76	81	4	4		✓	✓
	9	2B	75	10	4	4		✓	✓
11	10	2B	75	10	4	4			✓
LI	11	2B	75	10	4	4		✓	✓
	12	2B	76	10	4	4		✓	
	13	1B	50	8	3	3		✓	✓
	14	1B	50	8	3	3			
	15	2B	76	10	4	4		✓	✓
	16	2B	75	10	4	4	✓		✓
	17	2B	76	10	4	4		✓	✓
	18	2B	75	10	4	4		✓	
	19	2B	76	10	4	4		✓	✓
	20	2B	75	10	4	4		✓	✓
	21	2B	75	10	4	4			✓
L2	22	2B	75	10	4	4		✓	✓
	23	2B	76	10	4	4		✓	
	24	2B	80	10	4	4		√	✓
	25	2B/2S	81	10	4	4			
	26	2B	76	10	4	4		✓	✓
	27	2B	75	10	4	4	✓	✓	✓
	28	2B	76	10	4	4		✓	✓
	29	2B	75	10	4	4		✓	
	30	2B/2S	77	10	4	4		✓	
	31	2B	75	10	4	4		✓	✓
	32	2B	75	10	4	4		✓	✓
L3	33	2B	75	10	4	4			✓
	34	2B	75	10	4	4		✓	✓
	35	2B	76	10	4	4		✓	
	36	2B	80	12	4	4		✓	✓
	37	2B	76	11	4	4		✓	✓
	38	2B	75	10	4	4	✓	✓	1
	39	2B	76	10	4	4		✓	1
	40	2B/2S	71	26	4	4		✓	
	41	3B/2S	95	17	5	5		✓	
	42	3B	95	14	5	5		1	✓
	43	2B	75	10	4	4		✓	✓
	44	2B	75	10	4	4		✓	✓
L4	45	2B	75	10	4	4		✓	✓.
	46	2B	76	10	4	4		✓	
	47	2B	80	12	4	4		✓	✓
	48	2B/2S	75	10	4	4			
	49	2B	76	10	4	4		✓	✓
	50	2B	75	10	4	4	✓	✓	✓
						NO. OF UNITS : % REQUIRED : % PROVIDED :	5 10% 10%	39 70% 78%	33 60% 66%
						NCE ACHIEVED :	~	✓	✓

DEVELOPMENT APPLICATION -


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						stephen.bowers@stephenbowersgrchitects.com REGISTERED ARCHITECT - STEPHEN BOWERS (5810)	Architect				Cad file path.	Carl Drawtorn

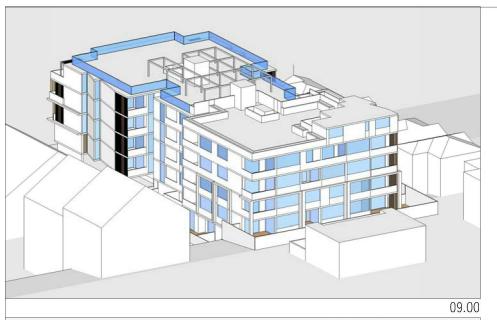


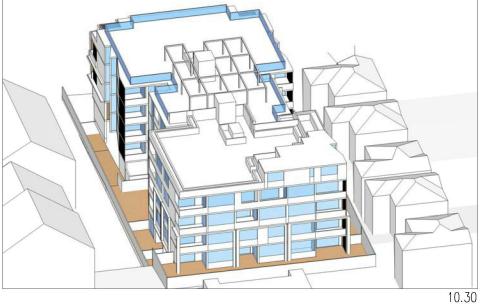


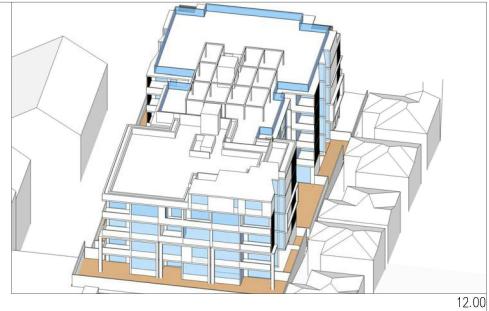




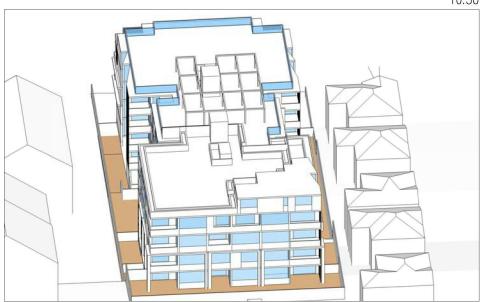

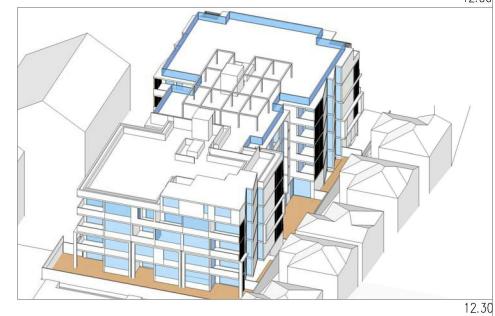

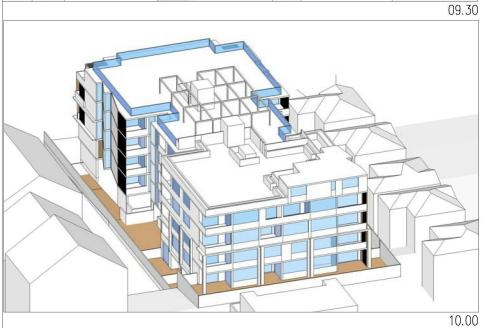

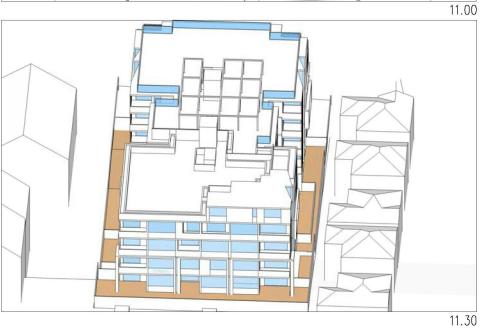

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STEPHEN BOWERS ARCHITECTS

g, urban design, landscope architecture, architecture, interior design ABN 64 087 958 423
SUITE 91, 24-32 PIRRAMA ROAD
PYBMOHT NSW 2009
TEL (612) 9029 7286
EMAIL: administration benoversarchitects.com
stephen.bowersarchitects.com

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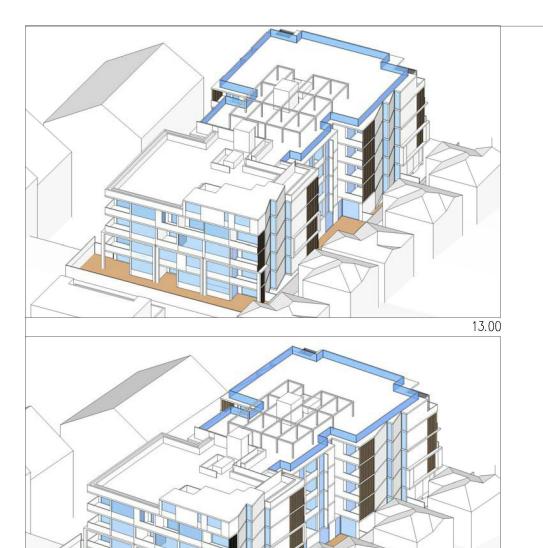
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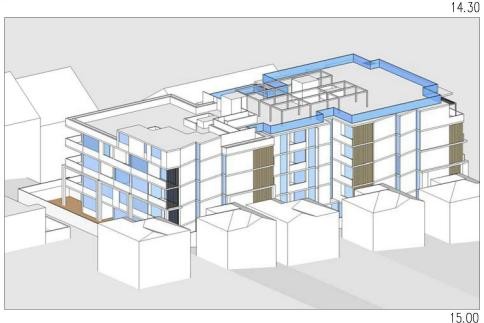
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SOLAR ACCESS DIAGRAMS (21ST JUNE 9AM - 12:30PM)

Scale NA	Date FEB 2017
Drawn by LN	Check by S.B
Drawing No. DA - 091	Revision -







SOLAR ACCESS SCHEDULE SOLAR ACCESS TOTAL HOURS(HRS) LEVEL UNIT NO GF 10 L1 13 L2 22 . L3 . L4 6 4 0 1 15 5 7 1 0 0 0 1 10 Number of uni 11 < 2 HRS 2 HRS OR MORE % of uni 22.0% 78.0% receiving solar

NOTE: Apartment Design Guide 2015 4A.5 — At least 70% of all apartments in a building should receive a minimum of 2 hours direct sunlight in mid winter in the Sydney Metropolitan Area and in the Newcastle and Wollongong local government areas, and at least 2 hours direct sunlight elsewhere in NSW

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-	ISSUE FOR DEVELOPMENT APPLICATION	FEB 2017			

PAM CORNERSTONE P/L

13.30

14.00

STEPHEN BOWERS ARCHITECTS


rban design, landscape architecture, archit ABN 64 087 958 423 SUITE 91, 26-32 PIRRAMA ROAD PYRMONT NSW 2009 TEL (612) 9029 7286 EMAIL: admin@stephenbowersarchite stephen.bowers@stephenbowersgrchitects.com REGISTERED ARCHITECT - STEPHEN BOWERS (5810) STEPHEN BOWERS ARCHITECTS Address


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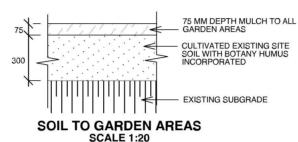
Drawing Title SOLAR ACCESS DIAGRAMS (21ST JUNE 1PM - 3PM)


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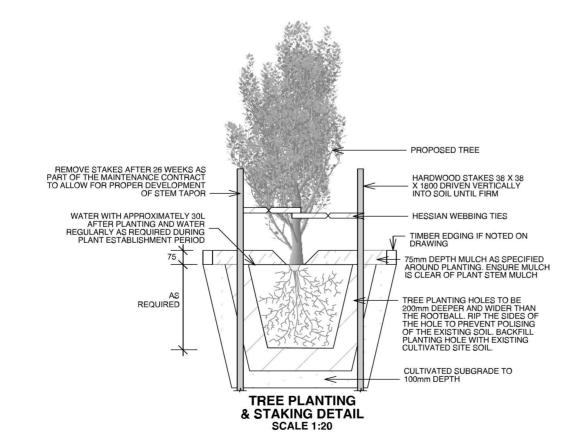
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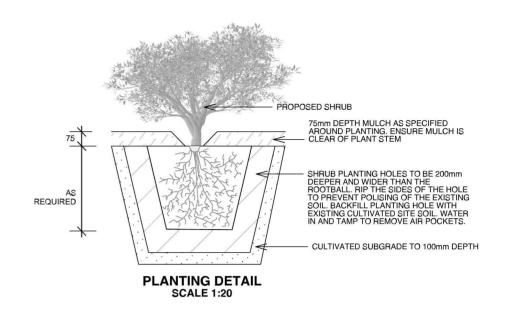







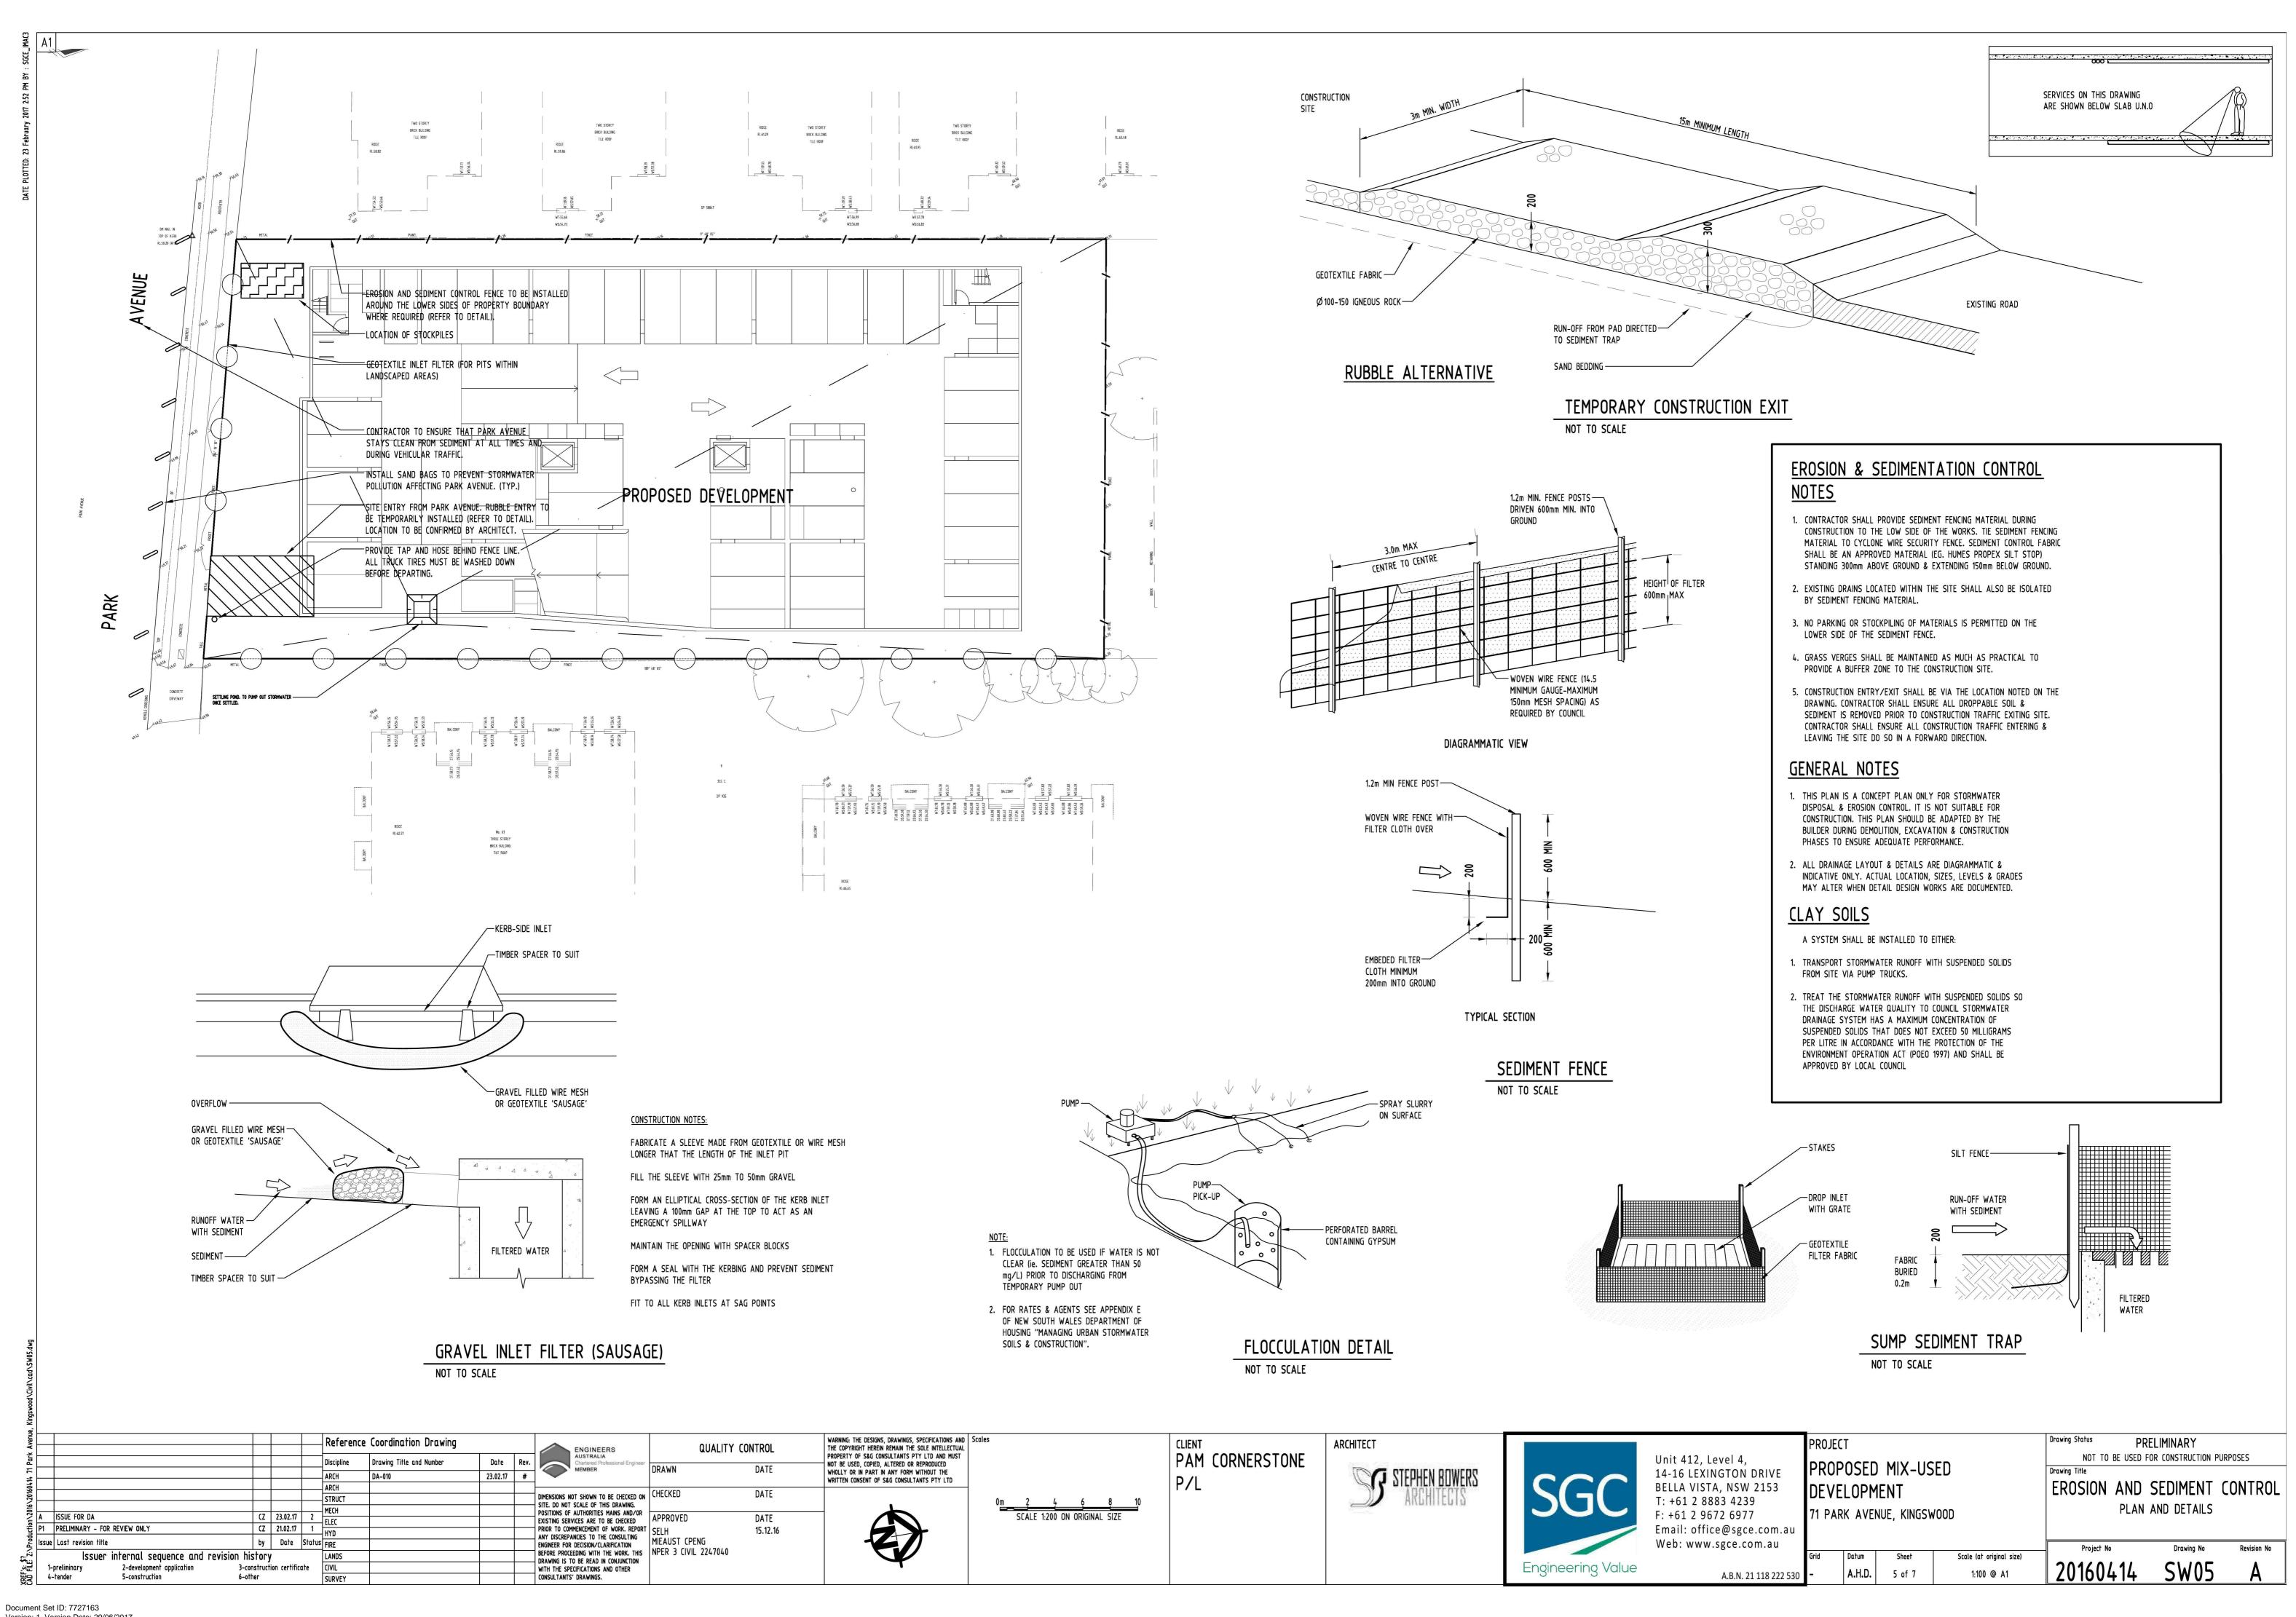

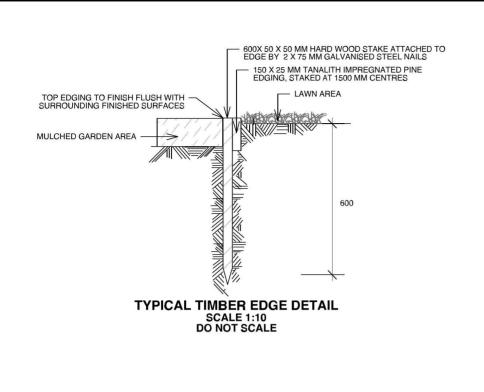

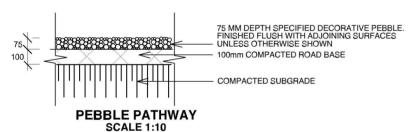

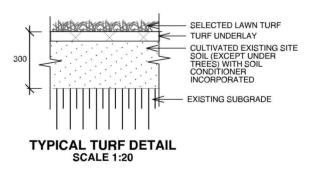

LANDSCAPE DETAILS								
ADDRESS 71 PARK AV, KINGS WOOD	PROJECT STEP	# HEN BOWERS ARCHITECT						
PAM CORNERSTONE P/L	DATE #	24/01/17	DWG#					
FAMICORNERSTONE F/L	SCALE @ A3	1:200		1 /04				
A Total Concept Landscape Architects &	DRAWN	JC		L/ U-T				
Swimming Pool Designers	CHKD	JRS	REVISION					
Swimming Pool Designers 65 West Street, North Sydney NSW 2060 Tel: (02) 9957 5122 Fx: (02) 9957 5922	atotal consideration	cept ects & swimming p	ool designers =					

All divensions and levels shall be verified by Contractor on site prior to commencement of work.
 All detailing of drainage to paved areas shall be by others.
 All levels shall be determined by others and approved on

S. All evels shall be determined by due a and approved in site by client.
 Extent, height and position of all retaining walls shall be determined by others and approved on site by client.
 Do not scale from drawings.
 If in doubt contact the Landscape Architect.

7. All boundaries shall be surveyed prior to commencement

of construction works.

3. This plan is for DA purposes only. It has not been detailed

nor construction.

9. All dimensions, levels and boundaries are nominal only.

10. This design shall not be copied, utilised or reproduced in any way without prior written permission of A Total Concept Landscape Architects.

OUTLINE LANDSCAPE SPECIFICATION

Preparation by Builder: Builder shall remove all existing concrete pathways, fences, footings, walls etc. not notated to be retained and complete all necessary excavation work prior to commencement on site by Landscape Contractor (Contractor). Builder shall also install new retaining walls, kerbs, layback kerb, crossover, pathways etc. and make good all existing kerbs, gutters etc. as necessary and to approval of Council. Builder shall ensure that a minimum 450mm of topsoil in garden areas and a minimum 150mm of topsoil in lawn areas exists. Should required depths not exist Builder shall contact Landscape Architect and ask for instructions prior to completion of excavation works. Excavate as necessary, then fill with approved site topsoil to allow for minimum 500mm soil depth in garden areas and 150mm soil depth in lawn areas and to gain required shapes & levels. Ensure all garden and lawn areas drain satisfactorily. All

levels & surface drainage shall be determined by others & approved on site by Head Contractor. Note: Approved imported topsoil available. State in Tender a m3 rate for additional imported topsoil and the quantities of both site topsoil and imported topsoil allowed for in Tender.

Initial Preparation: Verify all dimensions & levels on site prior to commencement. Do not scale from drawings. Locate all underground & above ground services & ensure no damage occurs to them throughout contract. Spray approved weedicide to all proposed lawn & garden areas to manufacturer's directions. Remove existing concrete pathways, footings, walls etc. not notated to be retained & weeds from site. Levels indicated on Plan are nominal only and are derived from Architectural Plans &

Drawings by others. Final structural integrity of all items shall be the sole responsibility of Landscape Contractor.

Tree Protection: Trees to be retained shall be protected during site works and construction by the erection of solid barricades to the specification of Council. Storage of machinery or materials beneath canopy of trees to be retained shall not be permitted. Changes to soil level and cultivation of soil beneath canopy of trees to be retained shall not be permitted unless under direct supervision of Landscape Architect. Existing trees shall be pruned to Landscape Architects onsite instructions. Soil Preparation: Cultivate to depth of 300mm all proposed lawn & garden areas incorporating minimum 100mm depth of organic clay breaker into existing site soil. Do not cultivate beneath existing trees to be retained. In areas where fill is required gain required shapes & levels using a premium grade soil mix. In areas where excavation is required (if in clay) over excavate as required to to allow for installation of 500mm depth of premium grade topsoil mix to lawn areas. Undertake all required action to ensure that no rootballs of proposed plants sit in clay wells and that all garden areas and lawn areas drain satisfactorily. Note it is intended that wherever possible existing levels shall not be altered through garden and lawn areas. It is the Contractors responsibility to ensure that the end result of the project is that all lawn and garden areas drain sufficiently (both surface & subsurface), are at required finished levels and have sufficient soil depths to enable lawn and plants to thrive and grow. Should alternative works to those specified be required to achieve the above result, Contractor shall inform Builder at time of Tender and request instructions.

Lawn Edging and Stepping Stones:(i) 125 x 25mm approved tanalith impregnated pine edging shall be installed, to lines as indicated on plan and staked with approved stakes at maximum 1500mm centres at ends and changes of direction; stakes

shall be nailed to edging with approved galvanised steel nails. Top of edging shall finish flush with surrounding surfaces. Top of stakes shall finish 25mm below top of edging. (ii) Contractor shall install approved bricks on edge on a minimum 100mm deep x 90mm wide concrete footing with brick tor set in, to lines nominated on plan as brick edging. Bricks shall be laid with a nominal 10mm wide approved coloured mortar joint. Bricks needing to be cut shall be done so with clean sharp cuts. Top of edging shall finish flush with surrounding finished surfaces. Approved sandstone stepping stones shall be positioned as indicated on plan on a 25mm river sand bed. Approved sandstone stepping stones shall be positioned as indicated on plan on a 25mm river sand bed.

Retaining Walls: Positions, detail and heights of retaining walls shall be by others.

Planting: Purchase plants from an approved nursery. Plants to be healthy & true to type & species. Set out plants to positions indicated on plan. Following approval, plant holes shall be dug approximately twice width and to 100mm deeper than plant rootballs that they are to receive. Base and sides of hole shall be further loosened. Fertiliser, followed by 100mm depth of topsoil mix shall then be placed into base of hole and lightly consolidated. Base of hole shall then be watered. Remove plant container and install plant into hole. Rootball shall be backfilled with surrounding topsoil and topsoil firmed into place. An approved shallow dish shall be formed to contain water around base of stem. Base of stem of plant shall finish flush with finished soil level. Once installed plant shall be thoroughly watered and maintained for the duration of the Contract.

Staking: All trees shall be staked using 2 x 38mm x 2000mm long hardwood stakes per plant and with hessian webbing ties installed to Landscape Architect's on site instructions. Mulching: Install 75mm depth of 25mm diameter hardwood mulch to all garden areas, coving mulch down around all plant stems & to finish flush with adjacent surfaces.

Turfing: Prepare for, level & lay cultivated Palmetto Buffulo turves to all areas nominated on plan as being lawn. Roll, water, fertilise, mow & maintain lawns as necessary until completion of maintenance period. At same time make good all existing lawn areas using same lawn type. Lawns in shade shall be over sown with an approved seed mix. Allow to retrim and returf councils nature strip as required. **Fencing:** Retain all existing fences unless advised otherwise by builder. Install timber paling fences to heights indicated on Plan.

Paving: Areas to be paved shall be excavated or filled to allow for installation of bedding materials. Levels and falls shall be as per Plan. Surface drainage on paving shall be towards grated drains with all drains connected to stormwater system and installed by Builder.

Irrigation: Contractor shall supply and install an approved fully automatic, vandal resistant, computerised irrigation system to all garden and lawn areas, excluding council nature strip. Entire system shall be to approval of Water Board and shall utilise pop-up sprinklers and electronic controllers. Contractor shall be responsible to ensure that system is able to satisfactorily operate on available water pressure. Power supply for use by irrigation system shall be provided to an approved location near southwest corner of residence by others and shall consist of an approved weatherproof G.P.O. The irrigation system controller shall be housed in an approved waterproof cabinet mounted to external wall of residence.

Clotheslines: Contractor shall allow for all necessary labour and materials and shall install clotheslines to positions as indicated on plan to manufacturer's instructions to approval of Landscape Architect. Clothesline type shall be equal to 'Hills

Completion: Prior to practical completion remove from site all unwanted debris occurring from work. Satisfy Council that all landscaping work has been undertaken in strict accordance with Councils landscape codes & guidelines.

Maintenance Period: A twelve month maintenance period shall be undertaken by owner or owners representative as set out herein. Owner shall have care and maintenance of all work specified under this Contract and shall rectify any defective work for a period of 52 weeks following Practical Completion of Landscape Works. This period shall be herein known as the Maintenance Period. Work shall also include for the care and maintenance of all existing vegetation to be retained and proposed vegetation. Site shall be attended at least weekly and as otherwise required. The following works shall be undertaken during the Maintenance Period.

(a) Recurrent works Undertake recurrent works throughout the Maintenance Period. These works shall include but are not limited to watering, weeding, fertilising, pest and disease control, returfing, staking and tying, replanting, cultivation, pruning, aerating, renovating, top dressing and the like.

(b) Watering Regularly water all plants and lawn areas to maintain optimal growing conditions. Contractor shall adjust the water quantity utilised with regard to climatic conditions prevalent at the time.

- (c) Replacements Immediately replace plants which die or fail to thrive (at discretion of Landscape Architect) with plants of same species or variety and of same size and quality unless otherwise specified. Plant replacement shall be at Contractors expense, unless replacement is required due to vandalism or theft, which shall be determined by Landscape Architect. Required replacement of plants due to vandalism or theft shall be undertaken by Contractor and shall be paid for by Client at an agreed predetermined rate.
- (d) Mulched surfaces Maintain mulched surfaces in clean, tidy, weed-free condition and shall reinstate mulch as necessary to maintain specified depths.

(e) Stakes & ties Adjust and/or replace stakes and ties as required. Remove stakes and ties at end of Maintenance Period if directed by Landscape Architect.

- (f) Lawn areas Lawn areas shall be mown at regular intervals to ensure non heading of lawn with a fine-cutting mulching mower and clippings left on lawn to mulch and self-fertilise lawn areas. Primary cut after laying of lawn by others shall be determined on site taking into consideration season, watering and growth rate of lawn. Following the primary cut all lawns shall be regularly mown as required to ensure a healthy lawn and a neat appearance. Care shall always be taken to ensure that no clippings are left on surrounding roads or garden areas after mowing. Replace lawn areas that fail to thrive at discretion of Landscape Architect. All new and made good lawn areas shall be barricaded off from pedestrian traffic by use of star pickets and brightly coloured plastic safety mesh until establishment of lawn. Barricades shall be removed upon establishment of lawn area.
- (g) Weeding Remove by hand, or by carefully supervised use of weedicide, any weed growth that may occur throughout Maintenance Period. This work shall be executed at weekly intervals so that all lawn and garden areas may be observed in a eed-free condition.
- (h) Pruning Prune new and existing plants (excluding existing trees) as necessary to maintain dense foliage conditions. Any roque branches, or branches overhanging or obstructing pathways, roads, doorways, etc., shall be removed by approved horticultural methods.
- (i) Spraying Spraying for insect, fungal and disease attack shall be undertaken as required and in accordance with spray manufacturers recommendations at intervals taking into account the season of year during which landscape works are to be implemented.
- (j) Tree Care Should any existing trees be damaged during construction works immediately engage an experienced arboriculturist and then undertake any rectification work recommended by arboriculturist.


- 1. All dimensions and levels shall be verified by Contracto
- 1. All dimensions and levels shall be verified by Contractor on site prior to commencement of work.
 2. All detailing of drainage to paved areas shall be by others.
 3. All levels shall be determined by others and approved on site by client.
 4. Extent, height and position of all retaining walls shall be determined by others and approved on site by client.
 5. Do not scale from drawings.
 6. If in doubt contact the Landscape Architect.
 7. All boundaries shall be surveyed prior to commencement of construction works.

- of construction works.

 This plan is for DA purposes only. It has not been detailed
- for construction.

 All dimensions, levels and boundaries are nominal only. This design shall not be copied, utilised or reproduced in any way without prior written permission of A Total Concept Landscape Architects.

LANDSCAPE SPECIFICATION 71 PARK AV, KINGS WOOD STEPHEN BOWER DATE # 24/01/17 PAM CORNERSTONE P/L SCALE @ A3 1:200 L/05 DRAWN IC. A Total Concept Landscape Architects & CHKD JRS REVISION Swimming Pool Designers 65 West Street, North Sydney NSW 2060 Tel: (02) 9957 5122 Fx: (02) 9957 5922 atc

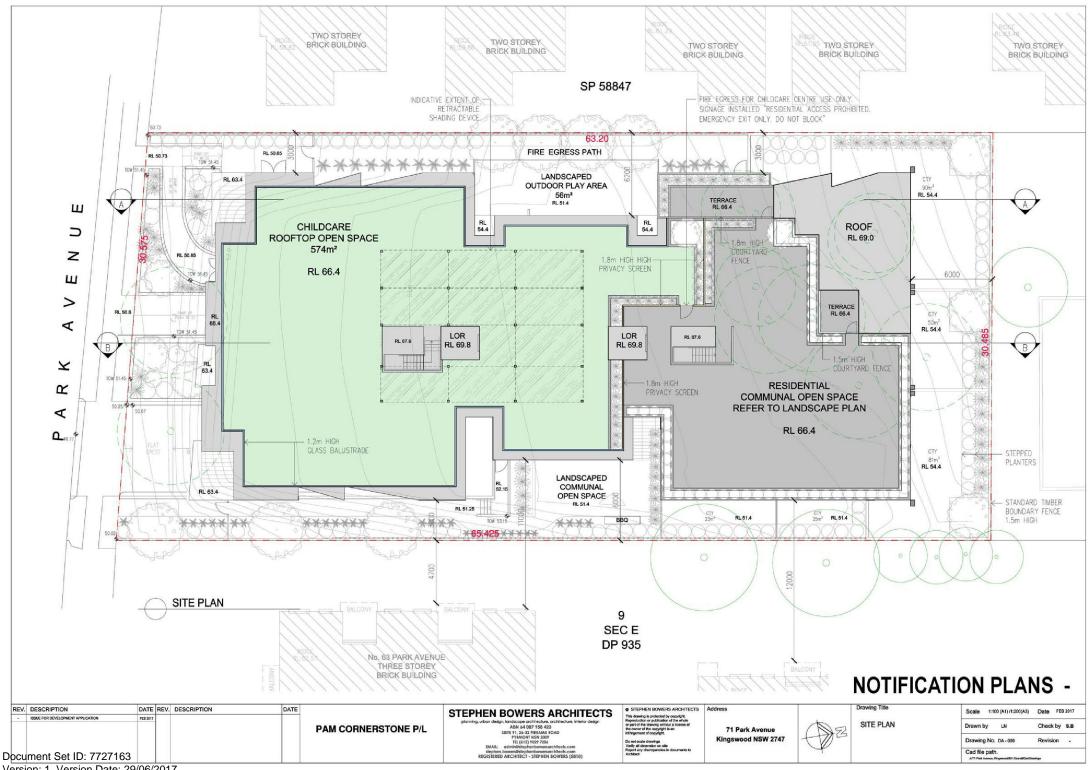



LEGEND

- A PORTALS: RENDER & PAINT DULUX COLOUR 'PEPLUM QUARTER'
- B POWDERCOATED METAL BATTENS -TIMBER FINISH
- C RENDER & PAINT -DULUX COLOUR 'TIMELESS GREY'
- D 'L' ANGLE DULUX POWDERCOAT METAL NEW HAMMERSLEY BROWN
- E CLEAR GLASS BALUSTRADE
- F VERTICAL BALUSTERS 'DULUX POWDERCOAT BLACK
- G PERGOLA
- H RENDER & PAINT ENTRY FEATURE DULUX COLOUR 'JUBILATION'
- J ROOF DULUX POWDERCOAT 'WOODLAND GREY'
- K RENDER & PAINT DULUX COLOUR 'STEPNEY'
- L RENDER & PAINT
 DULUX COLOUR 'PEPLUM HALF'

SOUTH ELEVATION AND MATERIALS & FINISHES

NOTIFICATION PLANS -

Drawing Title REV. DESCRIPTION DATE REV. DESCRIPTION DATE STEPHEN BOWERS ARCHITECTS Address STEPHEN BOWERS ARCHITECTS Scale 1:100 (A1) /1:200(A3) Date FEB 2017 ISSUE FOR DEVELOPMENT APPLICA g, urban design, inndicasa architecture, architecture, interior ANN 44 987 754 423 SUITE 91, 24.32 PIERAMA ECAD FYLMANT ISW 2009 TEL (413) 1909 7286 EMAIL: administration province blocks, com-speknin Dowersitration province blocks, com-registration Activities—1 services (5010) REGISTRED ACTIVITED—1 STEPHE BOWERS (5010) SOUTH ELEVATION AND PAM CORNERSTONE P/L 71 Park Avenue MATERIALS & FINISHES Kingswood NSW 2747 Drawing No. DA - 021 Revision -Cad file path. Document Set ID: 7727163







LEGEND

- A PORTALS: RENDER & PAINT DULUX COLOUR 'PEPLUM QUARTER'
- B POWDERCOATED METAL BATTENS -TIMBER FINISH
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REGISTRED ARCHITECT - STEPHEN BOWERS (5810) NORTH ELEVATION Drawn by PAM CORNERSTONE P/L 71 Park Avenue MATERIALS & FINISHES Kingswood NSW 2747 Drawing No. DA-024 Revision -Cad file path, Document Set ID: 7727163

PROPOSED MIX-USED DEVELOPMENT 71 PARK AVENUE, KINGSWOOD STORMWATER CONCEPT DESIGN



LOCALITY PLAN

PREPARED BY:

ARCHITECT:



CLIENT:

PAM CORNERSTONE P/L

