

- ALL WORKMANSHIP AND MATERIALS SHALL BE IN ACCORDANCE WITH AS2783 1992.
- THE SETTING OUT DIMENSIONS SHALL BE CHECKED ON SITE PRIOR TO COMMENCING EXCAVATION.
- ANY UNFORSEEN VARIATIONS TO THE ASSUMED SITE CONDITIONS SHALL BE REFERRED TO THE ENGINEER PRIOR TO PROCEEDING.
- THE WALKWAYS AND COPINGS HAVE BEEN DESIGNED FOR A LIVE LOAD OF 4kPa. THE ENGINEER SHALL BE NOTIFIED OF ANY PROPOSED VARIATION TO THIS PRIOR TO PLACING THE REINFORCEMENT
- PRIOR TO EMPTYING THE POOL, THE OWNER SHALL ENSURE THAT ALL EXTERNAL GROUNDWATER HAS BEEN REMOVED FROM THE BASE AND WALLS OF THE
- THE ENGINEER SHALL BE NOTIFIED IF THE POOL IS OUT OF THE GROUND BY MORE THAN 900.
- THE DETAILS PRESENTED ON THE FOLLOWING SHEETS COMPLY WITH THE REQUIREMENTS OF AS2783-1992.

CONCRETE

- ALL WORKMANSHIP SHALL BE IN ACCORDANCE WITH AS3600
- ALL CONCRETE SHALL HAVE A MINIMUM 28 DAY CONCRETE COMPRESSIVE STRENGTH OF 25MPa AND HAVE A MAXIMUM AGGREGATE SIZE OF 10mm AND A MAXIMUM SLUMP OF 80mm UNLESS NOTED OTHERWISE.
- WHERE THE POOL IS LOCATED WITHIN 1km OF LARGE EXPANSES OF SALT WATER THE CONCRETE SHELL SHALL HAVE A MINIMUM 28 DAY CONCRETE
- CONCRETE SIZES SHOWN DO NOT INCLUDE FINISH AND MUST NOT BE REDUCED OR HOLED IN ANY WAY WITHOUT THE APPROVAL OF THE ENGINEER. HOWEVER, THE RADIUS OR CONCRETE THICKNESS MAY BE INCREASED.
- UNLESS OTHERWISE NOTED, CLEAR CONCRETE COVER SHALL BE IN ACCORDANCE WITH AS2783-1992.
- CONCRETE COVER SHALL BE MAINTAINED BY THE USE OF APPROVED CHAIRS AT APPROXIMATELY 750 CROSS CENTRES
- ALL CONCRETE SHALL BE CURED BY THE OWNER FOR A MINIMUM OF 7 DAYS AFTER POURING BY KEEPING ALL EXPOSED SURFACES WET WITH WATER.
- S NOTATION TO REINFORCEMENT DENOTES GRADE 230 DEFORMED BAR.
- UNLESS OTHERWISE NOTED, ALL REINFORCEMENT LAPS SHALL BE A MINIMUM OF 500mm
- PROVIDE 10mm CONTROL JOINTS IN THE WALKWAY FINISH AT MAXIMUM 4000 CENTRES AND AT POINTS OF RE-ENTRANT CORNERS IN PLAN.
- C11 PROVIDE 10mm CONTROL JOINTS BETWEEN THE PERIMETER EDGE OF THE POOL AND ALL ABUTTING CONCRETE OR MASONRY FINISHES.

FOUNDATION

- THE DESIGN OF THE POOL HAS BEEN BASED ON BEING SUPPORTED BY UNIFORM NATURAL GROUND WITH A MINIMUM SAFE BEARING VALUE OF 150kPa (UNLESS SHOWN AS SUSPENDED ON PIERS). THE BUILDER SHALL NOTIFY THE ENGINEER IF ANY OTHER GROUND CONDITIONS ARE ENCOUNTERED PRIOR TO COMPLETING THE EXCAVATION. THE BUILDER SHALL ALSO NOTIFY THE ENGINEER IF A CLASS 'H', 'E' OR 'P' SUBGRADE IS ENCOUNTERED.
- THE EXCAVATION SHALL BE KEPT FREE OF WATER. ANY SOFTENED SUBGRADE MATERIAL SHALL BE REMOVED AND REPLACED WITH COMPACTED GRANULAR FILL PRIOR TO PROCEEDING.
- THE UNDERSIDE OF THE POOL SHALL BE SEPARATED FROM THE SUBGRADE WITH A 200µm POLYTHENE MEMBRANE OVER 50 CRUSHED STONE, COARSE AGGREGATE OR OTHER MATERIAL AS APPROVED BY THE ENGINEER.
- ANY PROPOSED EXCAVATIONS WHICH ARE TO BE WITHIN THE ZONE OF INFLUENCE OF AN EXISTING STRUCTURE SHALL BE REFERRED TO THE ENGINEER PRIOR TO COMMENCEMENT

Structural details only certified by: Keighran and Associates Pty Ltd

ABN 25 003 832 291

BE (Hons), MEngSor, FIEAust, CPEng Registered NPER 3719 (Structural & Civil)



PROPOSED SWIMMING POOL STRUCTURAL DETAILS

FOR: AGIUS

AT: 64 NINTH AVE, JORDAN SPRINGS. NSW

4/05/17 DATE: SHEET 1 OF 1 DRAWN:

SEDIMENT FENCE DETAIL

Drainage PLAN

NOT TO SCALE

17S2413

CONTRACT No./DRAWING No.

SITE CALCULATION

SITE AREA = 2333m2 RESIDENCE etc.= 300m2 GARAGE= 65m2 DRIVEWAY/ PATHS= 80m2 PROPOSED POOL/COPING = 70m2 TOTAL B.U.A. = 515m2 = 23% LANDSCAPED AREA = 77%

SEDIMENT CONTROL FENCE SEE DETAIL PROPOSED CONCRETE POOL THE PROPOSED POOL TO COMPLY WITH THE SWIMMING POOL ACT AND REGULATIONS. 14000 approx W TO B 1200 HIGH CHILD PROOF SAFETY FENCE AND SELF CLOSING, SELF LOCKING GATE TO AS1926 AND LOCAL COUNCIL REQUIREMENTS (BY OTHERS) 4000 setback T0 Βι BOUNDARY FENCING TO COMPLY WITH THE SWIMMING POOL ACT AND REGULATIONS. FILTER 🛛 <u>DWELLING</u> LOT 6218 4000 setback 42.5m bdy

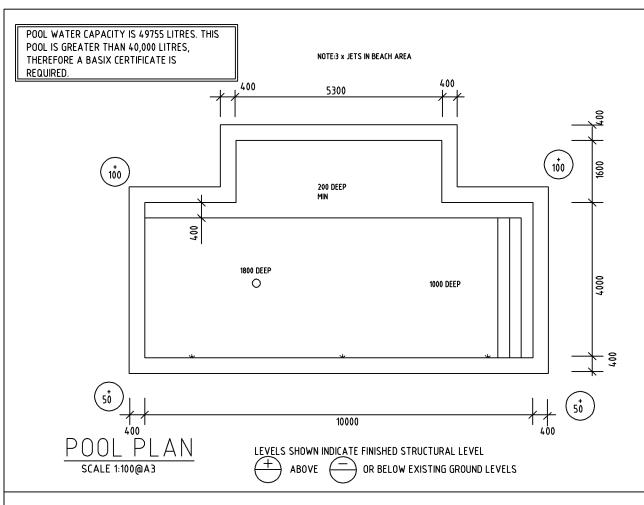
NINTH AVE

▼ DATUM - CONCRETE SLAB of Alfresco as marked, Pool to be 300 BELOW the datum.

BLUE HAVEN POOLS SOUTH PTY LTD

Site Plan & Pool Plans prepared by Blue Haven Pools & Spas Pty Ltd

68 Hume Highway Lansvale NSW 2166
Document Set 10: 7671926 (Fax: 102) 9754 2906



- ALL WORKMANSHIP AND MATERIALS SHALL BE IN ACCORDANCE WITH AS2783 1992.
- THE SETTING OUT DIMENSIONS SHALL BE CHECKED ON SITE PRIOR TO COMMENCING EXCAVATION.
- ANY UNFORSEEN VARIATIONS TO THE ASSUMED SITE CONDITIONS SHALL BE REFERRED TO THE ENGINEER PRIOR TO PROCEEDING.
- THE WALKWAYS AND COPINGS HAVE BEEN DESIGNED FOR A LIVE LOAD OF 4kPa. THE ENGINEER SHALL BE NOTIFIED OF ANY PROPOSED VARIATION TO THIS PRIOR TO PLACING THE REINFORCEMENT
- PRIOR TO EMPTYING THE POOL, THE OWNER SHALL ENSURE THAT ALL EXTERNAL GROUNDWATER HAS BEEN REMOVED FROM THE BASE AND WALLS OF THE
- THE ENGINEER SHALL BE NOTIFIED IF THE POOL IS OUT OF THE GROUND BY MORE THAN 900.
- THE DETAILS PRESENTED ON THE FOLLOWING SHEETS COMPLY WITH THE REQUIREMENTS OF AS2783-1992.

CONCRETE

- ALL WORKMANSHIP SHALL BE IN ACCORDANCE WITH AS3600
- ALL CONCRETE SHALL HAVE A MINIMUM 28 DAY CONCRETE COMPRESSIVE STRENGTH OF 25MPa AND HAVE A MAXIMUM AGGREGATE SIZE OF 10mm AND A MAXIMUM SLUMP OF 80mm UNLESS NOTED OTHERWISE.
- WHERE THE POOL IS LOCATED WITHIN 1km OF LARGE EXPANSES OF SALT WATER THE CONCRETE SHELL SHALL HAVE A MINIMUM 28 DAY CONCRETE
- CONCRETE SIZES SHOWN DO NOT INCLUDE FINISH AND MUST NOT BE REDUCED OR HOLED IN ANY WAY WITHOUT THE APPROVAL OF THE ENGINEER. HOWEVER, THE RADIUS OR CONCRETE THICKNESS MAY BE INCREASED.
- UNLESS OTHERWISE NOTED, CLEAR CONCRETE COVER SHALL BE IN ACCORDANCE WITH AS2783-1992.
- CONCRETE COVER SHALL BE MAINTAINED BY THE USE OF APPROVED CHAIRS AT APPROXIMATELY 750 CROSS CENTRES.
- ALL CONCRETE SHALL BE CURED BY THE OWNER FOR A MINIMUM OF 7 DAYS AFTER POURING BY KEEPING ALL EXPOSED SURFACES WET WITH WATER.
- S NOTATION TO REINFORCEMENT DENOTES GRADE 230 DEFORMED BAR.
- UNLESS OTHERWISE NOTED, ALL REINFORCEMENT LAPS SHALL BE A MINIMUM OF 500mm
- PROVIDE 10mm CONTROL JOINTS IN THE WALKWAY FINISH AT MAXIMUM 4000 CENTRES AND AT POINTS OF RE-ENTRANT CORNERS IN PLAN.
- [C11] PROVIDE 10mm CONTROL JOINTS BETWEEN THE PERIMETER EDGE OF THE POOL AND ALL ABUTTING CONCRETE OR MASONRY FINISHES.

FOUNDATION

- THE DESIGN OF THE POOL HAS BEEN BASED ON BEING SUPPORTED BY UNIFORM NATURAL GROUND WITH A MINIMUM SAFE BEARING VALUE OF 150kPa (UNLESS SHOWN AS SUSPENDED ON PIERS). THE BUILDER SHALL NOTIFY THE ENGINEER IF ANY OTHER GROUND CONDITIONS ARE ENCOUNTERED PRIOR TO COMPLETING THE EXCAVATION. THE BUILDER SHALL ALSO NOTIFY THE ENGINEER IF A CLASS 'H', 'E' OR 'P' SUBGRADE IS ENCOUNTERED.
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- THE UNDERSIDE OF THE POOL SHALL BE SEPARATED FROM THE SUBGRADE WITH A 200µm POLYTHENE MEMBRANE OVER 50 CRUSHED STONE, COARSE AGGREGATE OR OTHER MATERIAL AS APPROVED BY THE ENGINEER.
- ANY PROPOSED EXCAVATIONS WHICH ARE TO BE WITHIN THE ZONE OF INFLUENCE OF AN EXISTING STRUCTURE SHALL BE REFERRED TO THE ENGINEER PRIOR TO COMMENCEMENT Structural details only certified by:

BLUE HAVEN POOLS SOUTH PTY LTD

Site Plan & Pool Plans prepared by Blue Haven Pools & Spas Pty Ltd 68 Hume Highway Lansvale NSW 2166

Document Set ID 7671926 (Fax: 002) 9754 2906

BE (Hons), MEngSor, FIEAust, CPEng Registered NPER 3719 (Structural & Civil)

Keighran and Associates Pty Ltd

DATE 4./5./17...



PROPOSED SWIMMING POOL STRUCTURAL DETAILS

FOR: AGIUS

AT: 64 NINTH AVE, JORDAN SPRINGS. NSW

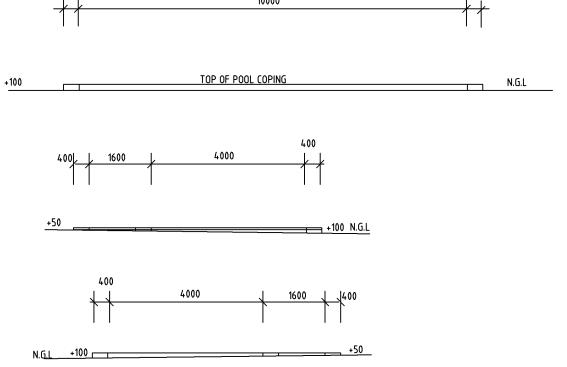
4/05/17 DATE:

DRAWN:


SHEET 1 OF 1

CONTRACT No./DRAWING No.

17S2413



ELEVATIONS SCALE 1: 100,

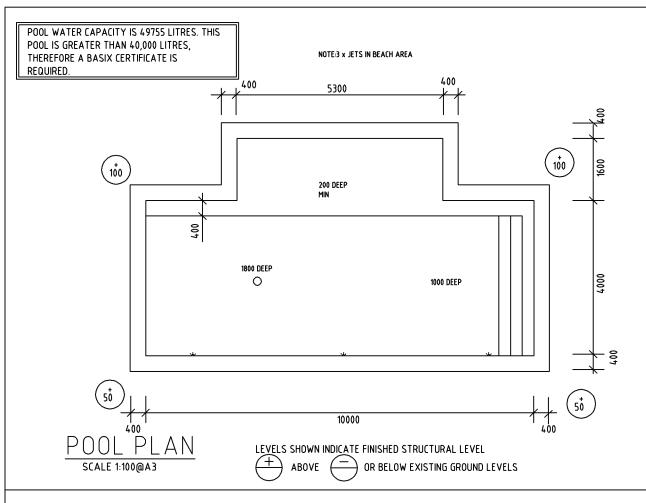

- ALL WORKMANSHIP AND MATERIALS SHALL BE IN ACCORDANCE WITH AS2783 1992.
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- THE ENGINEER SHALL BE NOTIFIED IF THE POOL IS OUT OF THE GROUND BY MORE THAN 900.
- THE DETAILS PRESENTED ON THE FOLLOWING SHEETS COMPLY WITH THE REQUIREMENTS OF AS2783-1992.

CONCRETE

- ALL WORKMANSHIP SHALL BE IN ACCORDANCE WITH AS3600
- ALL CONCRETE SHALL HAVE A MINIMUM 28 DAY CONCRETE COMPRESSIVE STRENGTH OF 25MPa AND HAVE A MAXIMUM AGGREGATE SIZE OF 10mm AND A MAXIMUM SLUMP OF 80mm UNLESS NOTED OTHERWISE.
- WHERE THE POOL IS LOCATED WITHIN 1km OF LARGE EXPANSES OF SALT WATER THE CONCRETE SHELL SHALL HAVE A MINIMUM 28 DAY CONCRETE
- CONCRETE SIZES SHOWN DO NOT INCLUDE FINISH AND MUST NOT BE REDUCED OR HOLED IN ANY WAY WITHOUT THE APPROVAL OF THE ENGINEER. HOWEVER, THE RADIUS OR CONCRETE THICKNESS MAY BE INCREASED.
- UNLESS OTHERWISE NOTED, CLEAR CONCRETE COVER SHALL BE IN ACCORDANCE WITH AS2783-1992.
- CONCRETE COVER SHALL BE MAINTAINED BY THE USE OF APPROVED CHAIRS AT APPROXIMATELY 750 CROSS CENTRES
- ALL CONCRETE SHALL BE CURED BY THE OWNER FOR A MINIMUM OF 7 DAYS AFTER POURING BY KEEPING ALL EXPOSED SURFACES WET WITH WATER.
- S NOTATION TO REINFORCEMENT DENOTES GRADE 230 DEFORMED BAR.
- UNLESS OTHERWISE NOTED, ALL REINFORCEMENT LAPS SHALL BE A MINIMUM OF 500mm
- PROVIDE 10mm CONTROL JOINTS IN THE WALKWAY FINISH AT MAXIMUM 4000 CENTRES AND AT POINTS OF RE-ENTRANT CORNERS IN PLAN.
- PROVIDE 10mm CONTROL JOINTS BETWEEN THE PERIMETER EDGE OF THE POOL AND ALL ABUTTING CONCRETE OR MASONRY FINISHES.

FOUNDATION

- THE DESIGN OF THE POOL HAS BEEN BASED ON BEING SUPPORTED BY UNIFORM NATURAL GROUND WITH A MINIMUM SAFE BEARING VALUE OF 150kPa (UNLESS SHOWN AS SUSPENDED ON PIERS). THE BUILDER SHALL NOTIFY THE ENGINEER IF ANY OTHER GROUND CONDITIONS ARE ENCOUNTERED PRIOR TO COMPLETING THE EXCAVATION. THE BUILDER SHALL ALSO NOTIFY THE ENGINEER IF A CLASS 'H', 'E' OR 'P' SUBGRADE IS ENCOUNTERED.
- THE EXCAVATION SHALL BE KEPT FREE OF WATER. ANY SOFTENED SUBGRADE MATERIAL SHALL BE REMOVED AND REPLACED WITH COMPACTED GRANULAR FILL PRIOR TO PROCEEDING.
- THE UNDERSIDE OF THE POOL SHALL BE SEPARATED FROM THE SUBGRADE WITH A 200µm POLYTHENE MEMBRANE OVER 50 CRUSHED STONE, COARSE AGGREGATE OR OTHER MATERIAL AS APPROVED BY THE ENGINEER.
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Structural details only certified by: Keighran and Associates Pty Ltd

ABN 25 003 832 291

BE (Hons), MEngSd, FIEAust, CPEng



PROPOSED SWIMMING POOL STRUCTURAL DETAILS

FOR: AGIUS

▼ DATUM - CONCRETE SLAB of Alfresco as

marked, Pool to be 300 BELOW the datum.

AT: 64 NINTH AVE, JORDAN SPRINGS. NSW

Erosion and sediment control PLAN

SITE CALCULATION

SITE AREA = 2333m2 RESIDENCE etc.= 300m2 GARAGE= 65m2 DRIVEWAY/ PATHS= 80m2 PROPOSED POOL/COPING = 70m2 TOTAL B.U.A. = 515m2 = 23% LANDSCAPED AREA = 77%

SEDIMENT CONTROL FENCE SEE DETAIL PROPOSED CONCRETE POOL THE PROPOSED POOL TO COMPLY WITH THE SWIMMING POOL ACT AND REGULATIONS. 14000 approx W TO B 1200 HIGH CHILD PROOF SAFETY FENCE AND SELF CLOSING, SELF LOCKING GATE TO AS1926 AND LOCAL COUNCIL REQUIREMENTS (BY OTHERS) 4000 setback T0 Βι BOUNDARY FENCING TO COMPLY WITH THE SWIMMING POOL ACT AND REGULATIONS. FILTER 🖂 LOT 6218 4000 seltback DRIVEWAY STOCKPILE 42.5m bdy

WASTE MANAGEMENT PLAN

NINTH AVE

ALL EXCAVATED MATERIAL TO BE REMOVED FROM SITE ALL CONSTRUCTION MATERIAL TO BE REMOVED FROM SITE

SEDIMENTATION BARRIER TO BE ERECTED TO PREVENT RUN -OFF INTO ADJOINING NEIGHBOURS PROPERTY

SANDBAGS TO BE USED TO PREVENT RUN-OFF INTO STORMWATER SYSTEM

4/05/17

BLUE HAVEN POOLS SOUTH PTY LTD

Site Plan & Pool Plans prepared by Blue Haven Pools & Spas Pty Ltd 68 Hume Highway Lansvale NSW 2166

Document Set ID 7671926 (Fax: 002) 9754 2906

Registered NPER 3719 (Structural & Civil)

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SHEET 1 OF 1

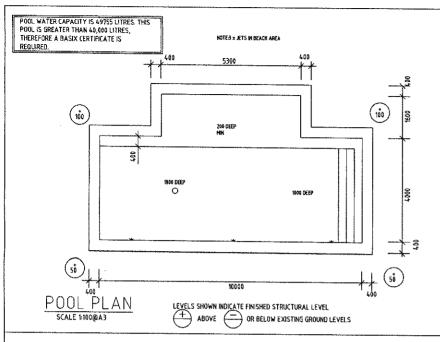
SEDIMENT FENCE DETAIL

NOT TO SCALE

CONTRACT No./DRAWING No.

17S2413

DATE:



- ALL WORKMANSHIP AND MATERIALS SHALL BE IN ACCORDANCE WITH AS2783 1992.
- THE SETTING OUT DIMENSIONS SHALL BE CHECKED ON SITE PRIOR TO COMMENCING EXCAVATION
- ANY UNFORSEEN VARIATIONS TO THE ASSUMED SITE CONDITIONS SHALL BE REFERRED TO THE ENGINEER PRIOR TO PROCEEDING.
- THE WALKWAYS AND COPINGS HAVE BEEN DESIGNED FOR A LIVE LOAD OF 44Pa. THE ENGINEER SHALL BE NOTIFIED OF ANY PROPOSED VARIATION TO THIS PRIOR TO PLACING THE REINFORCEMENT
- 65 PRIOR TO EMPTYING THE POOL, THE OWNER SHALL ENSURE THAT ALL EXTERNAL GROUNDWATER HAS BEEN REMOVED FROM THE BASE AND WALLS OF THE
- THE ENGINEER SHALL BE NOTIFIED IF THE POOL IS OUT OF THE GROUND BY MORE THAN 900.
- THE DETAILS PRESENTED ON THE FOLLOWING SHEETS COMPLY WITH THE REQUIREMENTS OF AS2783-1992.

CONCRETE

- ALL WORKMANSHIP SHALL BE IN ACCORDANCE WITH AS3600.
- ALL CONCRETE SHALL HAVE A MINIMUM 28 DAY CONCRETE COMPRESSIVE STRENGTH OF 25MP3 AND HAVE A MAXIMUM AGGREGATE SIZE OF 10mm AND A MAXIMUM SLUMP OF BOININ UNLESS NOTED OTHERWISE.
- WHERE THE POOL IS LOCATED WITHIN 1km OF LARGE EXPANSES OF SALT WATER THE CONCRETE SHELL SHALL HAVE A MINIMUM 28 DAY CONCRETE COMPRESSIVE STRENGTH OF 32MPa
- CONCRETE SIZES SHOWN DO NOT INCLUDE FINISH AND MUST NOT BE REDUCED OR HOLED IN ANY WAY WITHOUT THE APPROVAL OF THE ENGINEER. HOWEVER, THE RADIUS OR CONCRETE THICKNESS MAY BE INCREASED.
- UNLESS OTHERWISE NOTED, CLEAR CONCRETE COVER SHALL BE IN ACCORDANCE WITH AS2783-1992.
 CONCRETE COVER SHALL BE MAINTAINED BY THE USE OF APPROVED CHAIRS AT APPROXIMATELY 750 CROSS CENTRES.
- ALL CONCRETE SHALL BE CURED BY THE OWNER FOR A MINIMUM OF 7 DAYS AFTER POURING BY KEEPING ALL EXPOSED SURFACES WET WITH WATER.
- S NOTATION TO REINFORCEMENT DENOTES GRADE 230 DEFORMED BAR.
- UNLESS OTHERWISE NOTED, ALL REINFORCEMENT LAPS SHALL BE A MINIMUM OF 500mm.
- PROVIDE 10mm CONTROL JOINTS IN THE WALKWAY FINISH AT MAXIMUM 4000 CENTRES AND AT POINTS OF RE-ENTRANT CORNERS IN PLAN. PROVIDE 10mm CONTROL JOINTS BETWEEN THE PERIMETER EDGE OF THE POOL AND ALL ABUTTING CONCRETE OR MASONRY FRUSHES.

FOUNDATION

- THE DESIGN OF THE POOL HAS BEEN BASED ON BEING SUPPORTED BY UNIFORM NATURAL GROUND WITH A MINIMUM SAFE BEARING VALUE OF ISORPA (UNLESS SHOWN AS SUSPENDED ON PIERS). THE BUILDER SHALL NOTIFY THE ENGINEER IF ANY OTHER GROUND CONDITIONS ARE ENCOUNTERED PRIOR TO COMPLETING THE EXCAVATION. THE BUILDER SHALL ALSO NOTIFY THE ENGINEER IF A CLASS 'H', 'E' OR 'P' SUBGRADE IS ENCOUNTERED.
- THE EXCAVATION SHALL BE KEPT FREE OF WATER, ANY SOFTENED SUBGRADE MATERIAL SHALL BE REMOVED AND REPLACED WITH COMPACTED GRANULAR
- THE UNDERSIDE OF THE POOL SHALL BE SEPARATED FROM THE SUBGRADE WITH A 200µm POLYTHENE MEMBRANE OVER 50 CRUSHED STONE, COARSE AGGREGATE OR OTHER MATERIAL AS APPROVED BY THE ENGINEER.
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BLUE HAVEN POOLS SOUTH PTY LTD

Bite Plan & Pool Plans prepared by Blue Haven Pools & Spas Pty Ltd \$8 Hume Highway Lansvale NSW 2166

Document Set 1D: 767 1926

Consulting Structural and Civil Engineers DATE 4 /5 / 17

BE (Hons), MEngSol, FlEAust, CPEng Registered NPER 3719 (Structural & Civil)



▼ DATUM - CONCRETE SLAB of Alfresco as

marked, Pool to be 300 BELOW the datum.

AGIUS

4/05/17 DATE:

DRAWN:

1752413

SHEET 1 OF 4

CONTRACT No./DRAWING No.

DWELLING

LOT 6218

42.5m bdv

14000 approx W TO B 4000 setback

FILTER 12

THE PROPOSED POOL TO COMPLY WITH THE SWIMMING POOL ACT AND REGULATIONS. 1200 HIGH CHILD PROOF SAFETY FENCE AND SELF CLOSING, SELF LOCKING GATE TO AS1926 AND LOCAL COUNCIL REQUIREMENTS (BY OTHERS)

SEDIMENT CONTROL FENCE

4000 setback

BOUNDARY FENCING TO COMPLY WITH THE SWIMMING POOL ACT AND REGULATIONS.

PROPOSED CONCRETE POOL

SITE CALCULATION

SITE AREA = 2333m2 RESIDENCE etc.= 300m2 GARAGE- 45m2 DRIVEWAY/ PATHS= 80m2 PROPOSED POOL/COPING = 70m2 TOTAL B.U.A. = 515m2 = 23% LANDSCAPED AREA = 77%

NINTH AVE

SEDIMENT FENCE DETAIL

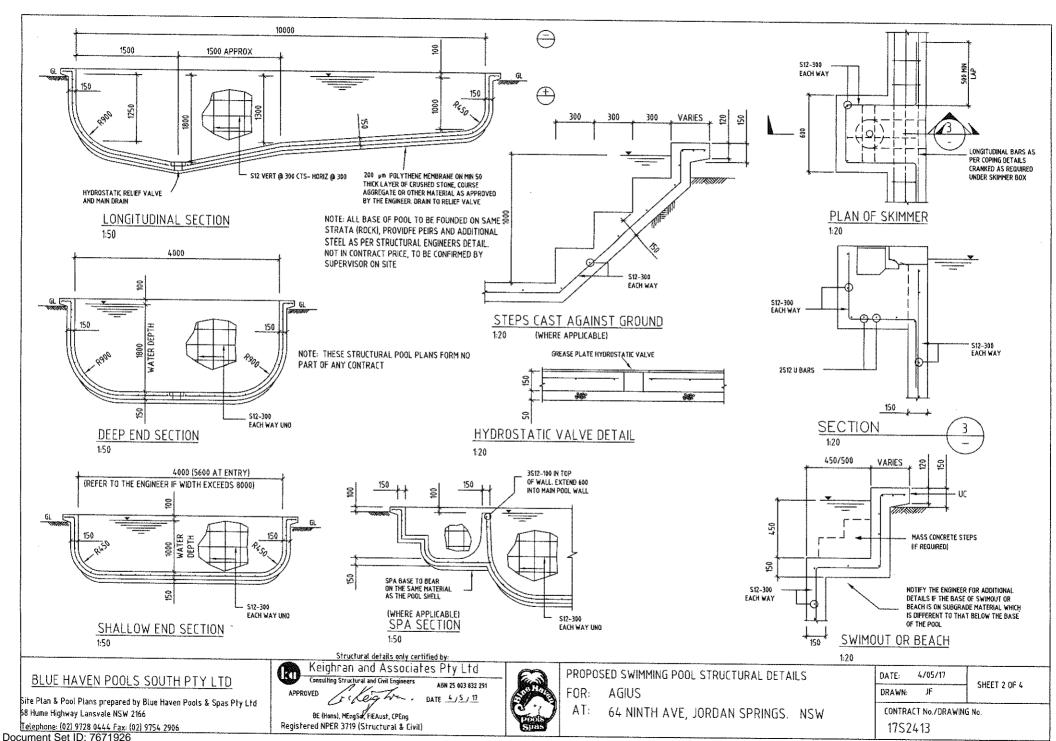
SITE PLAN SEALE 1: 400,

Keighran and Associates Pty Ltd PROPOSED SWIMMING POOL STRUCTURAL DETAILS ABN 25 003 832 291

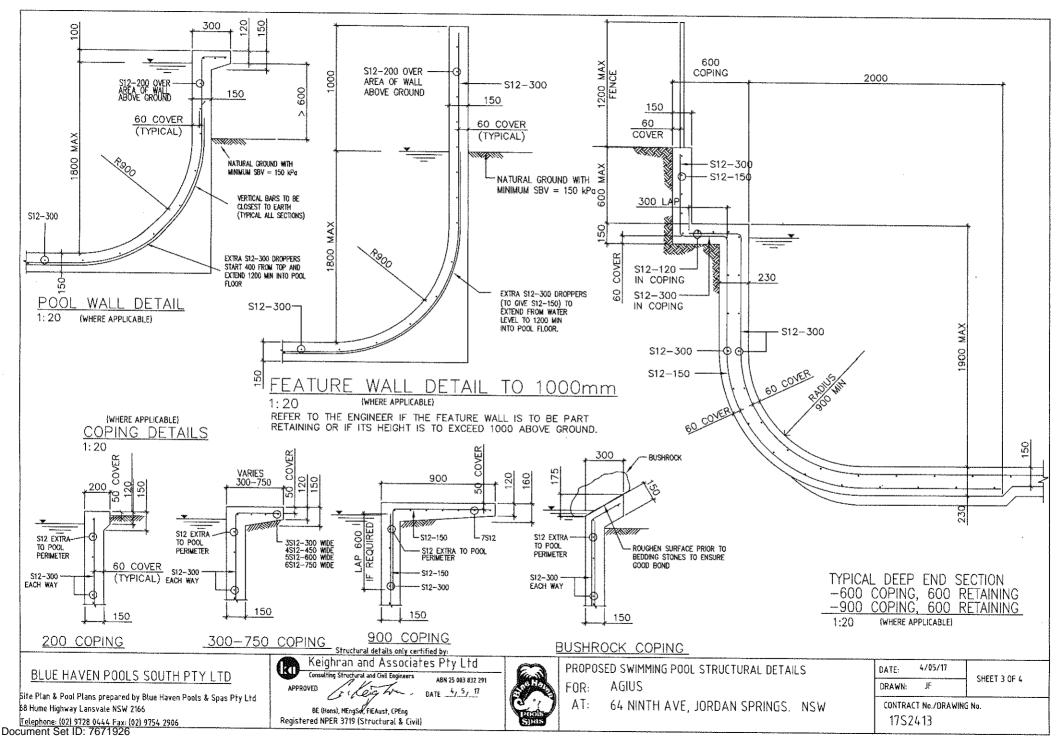
FOR:

64 NINTH AVE, JORDAN SPRINGS. NSW

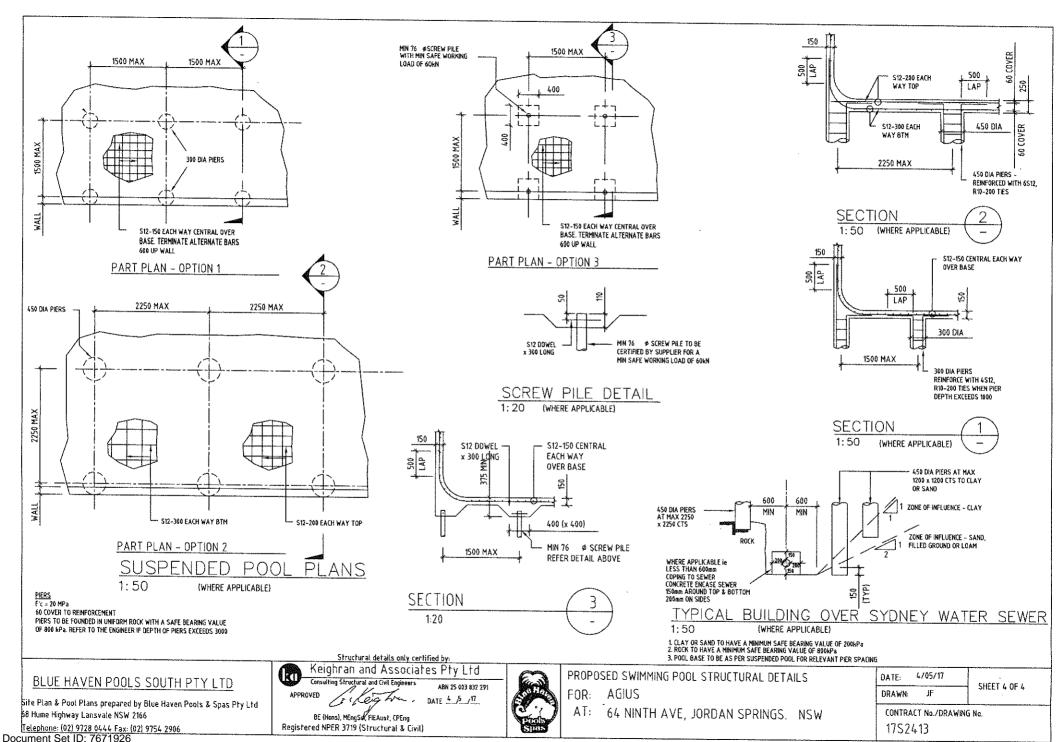
Version: 2. Version Date: 19/06/2017



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