

CAD FILENAME: X:\2018 - RHCO\18374 - 12 Anthony Cres Penrith\ACAD\18374 - 12 Anthony Crescent Kingswood - DETAIL SURVEY.dwg

есте 66 66 66 66 66 66 66 66 66 66 66 66 66	BENCHMARK BENCHMARK DH IN TOP KERB R.L. = 38.65
PLAN OF DETAIL AND	
LOT 67 IN DP 2 12 ANTHONY CRESCE	And a second
CLIENT: ZAC HOMES - REF:218	
L.G.A.: PENRITH	JOB REF: 18374

No. 14

SINGLE

STOREY

CLAD

RESIDENCE

PANEL

39.25+

A9.23

A9.25

2t

20

WT41.92

AWNING

39.25+

39.1A+

4

DGE

R

GT 42.63

8°48'00"

41.155

No. 12

SINGLE

STOREY

HARDBOARD

RESIDENCE

EAVE

FENCE

20

01

F.L 38.72

30.02

1

GT 42.16

No. 10

SINGLE STOREY

HARDBOARD

RESIDENCE

**TILE ROOF** 

15

**ORIGIN OF LEVELS:** 

SSM13702 (GNSS)

DATE: 25.05.2018

VERSION No.: A

R.L.=41.812 (SCIMS)

DATUM: AUSTRALIAN HEIGHT DATUM

WT 41.92

EAVE

A9.28

-39.09+

43.34

BOOF 20

£9.07

29

38.88

25

8

939.00

tage METAL

\_ \_

100.00

# BOARDING HOUSE DEVELOPMENT LOT 67, 12 ANTHONY CRESCENT, KINGSWOOD, DP 212261





design + interiors

po box 3029 putney nsw 2112, australia www.dawsonvu.com.au trang@dawsonvu.com.au 0438 297 973 michael@dawsonvu.com.au 0438 297 962

Document Set ID: 8607813 Version: 1, Version Date: 08/03/2019

#### 04.02.2019

## **BOARDING HOUSE DEVELOPMENT** LOT 67, 12 ANTHONY CRESCENT, KINGSWOOD, DP 212261





design + interiors

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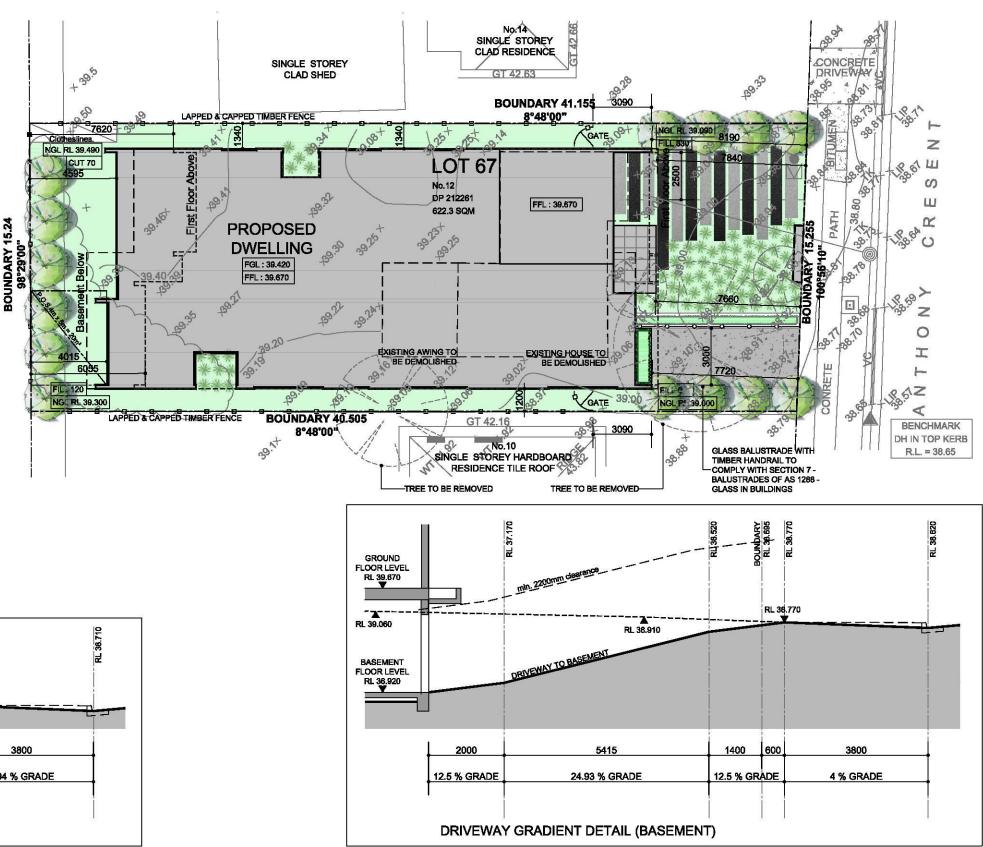



#### GENERAL NOTES

- A. THIS SURVEY IS SPECIFICALLY FOR CONTOUR PURPOSES ONLY. THE BOUNDARIES OF THE SUBJECT PROPERTY HAVE NOT BEEN INVESTIGATED
- B. AREAS AND DIMENSIONS ARE SUBJECT TO SURVEY C. SERVICES SHOWN HAVE BEEN DERIVED FROM VISUAL EVIDENCE APPARENT AT THE
- TIME OF SURVEY. THE RELEVANT SERVICE AUTHORITY SHALL BE CONTACTED TO VERIFY THE EXISTENCE AND POSITION OF ALL SERVICES PRIOR TO THE COMMENCEMENT OF ANY CONSTRUCTION OR EXCAVATION
- D. CONTOURS ARE INDICATIVE OF SURFACE TOPOGRAPHY ONLY. SURVEYED SPOT LEVELS ARE THE ONLY VALUES TO BE RELIED ON FOR REDUCED LEVELS ON PARTICULAR FEATURES.


#### **PROJECT SUMMARY :**


LAND ZONING :	<b>R3 - MEDIUM DENSITY RESIDENTIAL</b>
PRECINCT :	PENRITH CITY COUNCIL
SITE AREA :	622.3 SQM
MAX BUILDING HEIGHT :	8.5M TO TOP OF ROOF
MAX BUILDING HEIGHT PROVIDED :	8.445M TO TOP OF ROOF
LANDSCAPE AREA REQUIRED :	40% x SITE AREA = 248.92 SQM
LANDSCAPE AREA PROVIDED :	251.29 SQM
P.O.S. REQUIRED :	Min 20 SQM (4M X 5M)
P.O.S. PROVIDED :	20 SQM (4M X 5M)
	PER 2 BOARDING ROOMS = 10 SPACES
CARPARKING PROVIDED :	9 SPACES + 1 DISABLED SPACE
MOTORBIKE PARKING :	4 BICYCLE SPACES & 4 MOTORBIKE



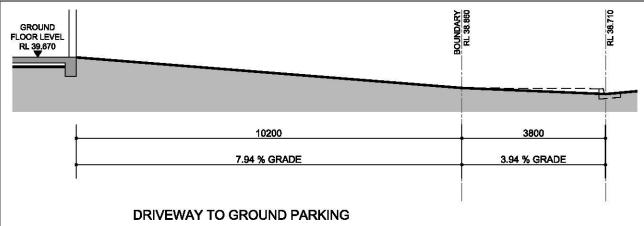


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po box 3029 putney nsw 2112				_	
www.dawsonvu.com.au	04.02.19	D	Reduce R1 to 15.9sqm		
trang@dawsonvu.com.au	31.01.19	С	Revised DA submission		
0438 297 973	16.11.18	В	Revised DA submission		
michael@dawsonvu.com.au	05.11.18	Α	DA submission		
0438 297 962	Date	Revision	issue		

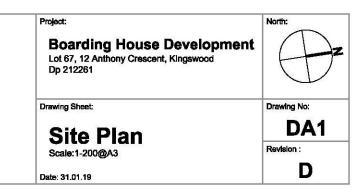

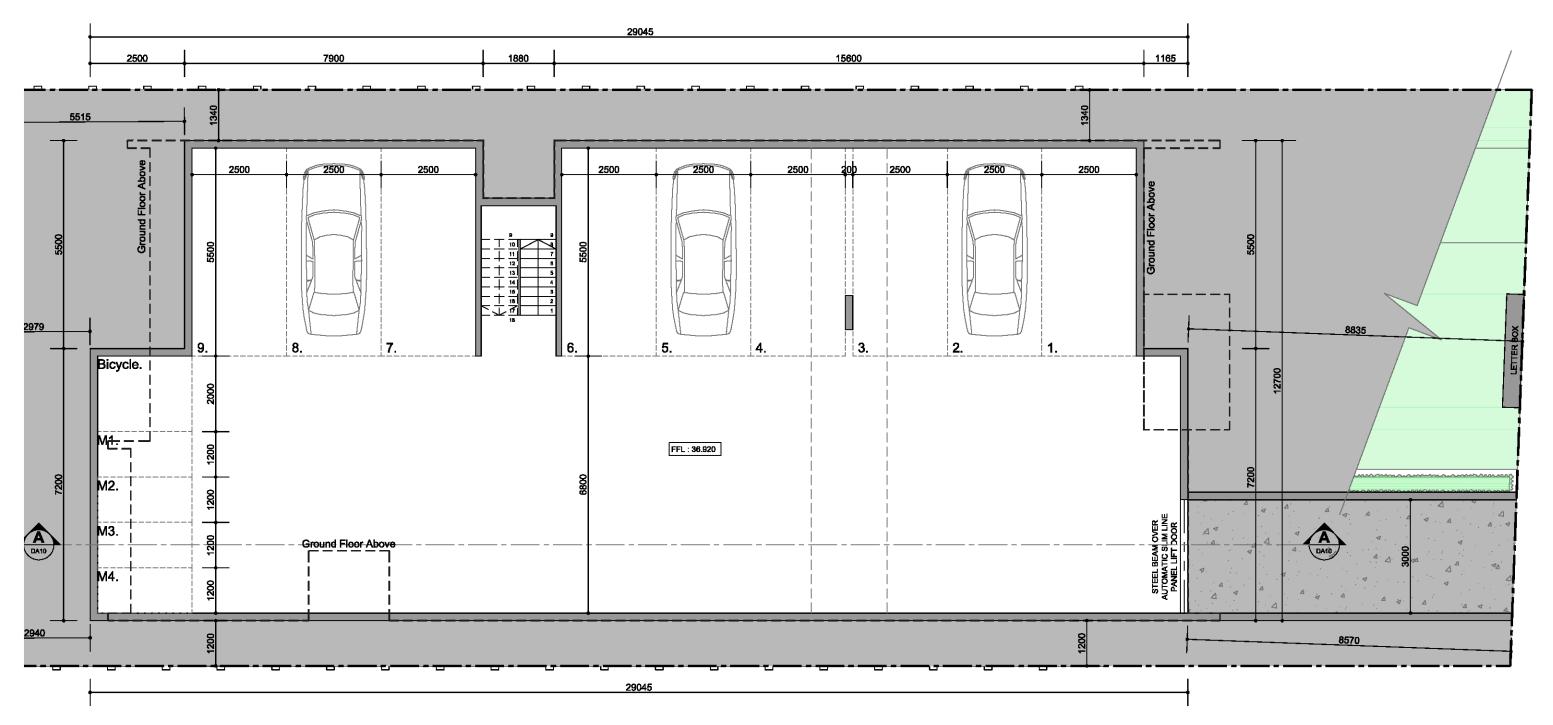

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po box 3029 putney nsw 2112					WET AREA CONSTRUCTION TO COMPLY WITH AUSTRALIAN STANDARD 3740     ALL ENCLOSED WATER CLOSET DOORS ARE TO SWING OUT OR TO BE PROVIDED WITH LIFT OFF HINGES OR THE LIKE IF THE DOOR IS	Drawing Sheet	Drawing No:
www.dawsonvu.com.au	04.02.19	D	Reduce R1 to 15.9sqm		WITHIN 1200MM OF THE PAN IN ACCORDANCE WITH THE REQUIREMENTS OF CLAUSE 3.8.3.3 OF VOLUME 2 OF THE NCCS (BCA)		DA2
trang@dawsonvu.com.au	31.01.19	С	Revised DA submission		<ul> <li>SMOKE ALARMS WILL BE PROVIDED IN ACCORDANCE WITH THE REQUIREMENTS OF PART 3.7.2 OF VOLUME 2 OF NCCS - BCA</li> <li>ALL STAIRS WILL BE CONSTRUCTED IN ACCORDANCE WITH THE REQUIREMENTS OF CLAUSE 3.9.1.2 OF VOLUME 2 OF THE NCCS-BCA</li> </ul>	Basement Plan	DA2
0438 297 973	16.11.18	В	Revised DA submission		• THE FINISH OF ALL OF THE STAIRS WILL MEET THE REQUIREMENTS OF CLAUSE 3.9.1.4 OF VOLUME 2 OF THE NCCS-BCA	Scale:1-100@A3	Revision :
michael@dawsonvu.com.au	05.11.18	Α	DA submission		ALL LANDINGS PROVIDED WILL MEET THE REQUIREMENTS OF CLAUSE 3.9.1.5 OF VOLUME 2 OF THE NCCS-BCA     ALL BALUSTRADES SERVICING THE STAIRS WILL MEET THE REQUIREMENTS OF CLAUSE 3.9.2.3 OF VOLUME 2 OF THE NCCS-BCA		
0438 297 962	Date	Revision	Issue		• ALL HANDRAILS TO THE STAIRS IN ACCORDANCE WITH CLAUSE 3.9.2.4 OF VOLUME 2 OF THE NCCS - BCA.	Date: 31.01.19	

AREA	
Basement	346.39 sqm
Living Area (GF)	329.55 sqm
Living Area (FF)	316.00 sqm
Front Porch	8.36 sqm
Total	1000.30 sqm
	107.67 sq

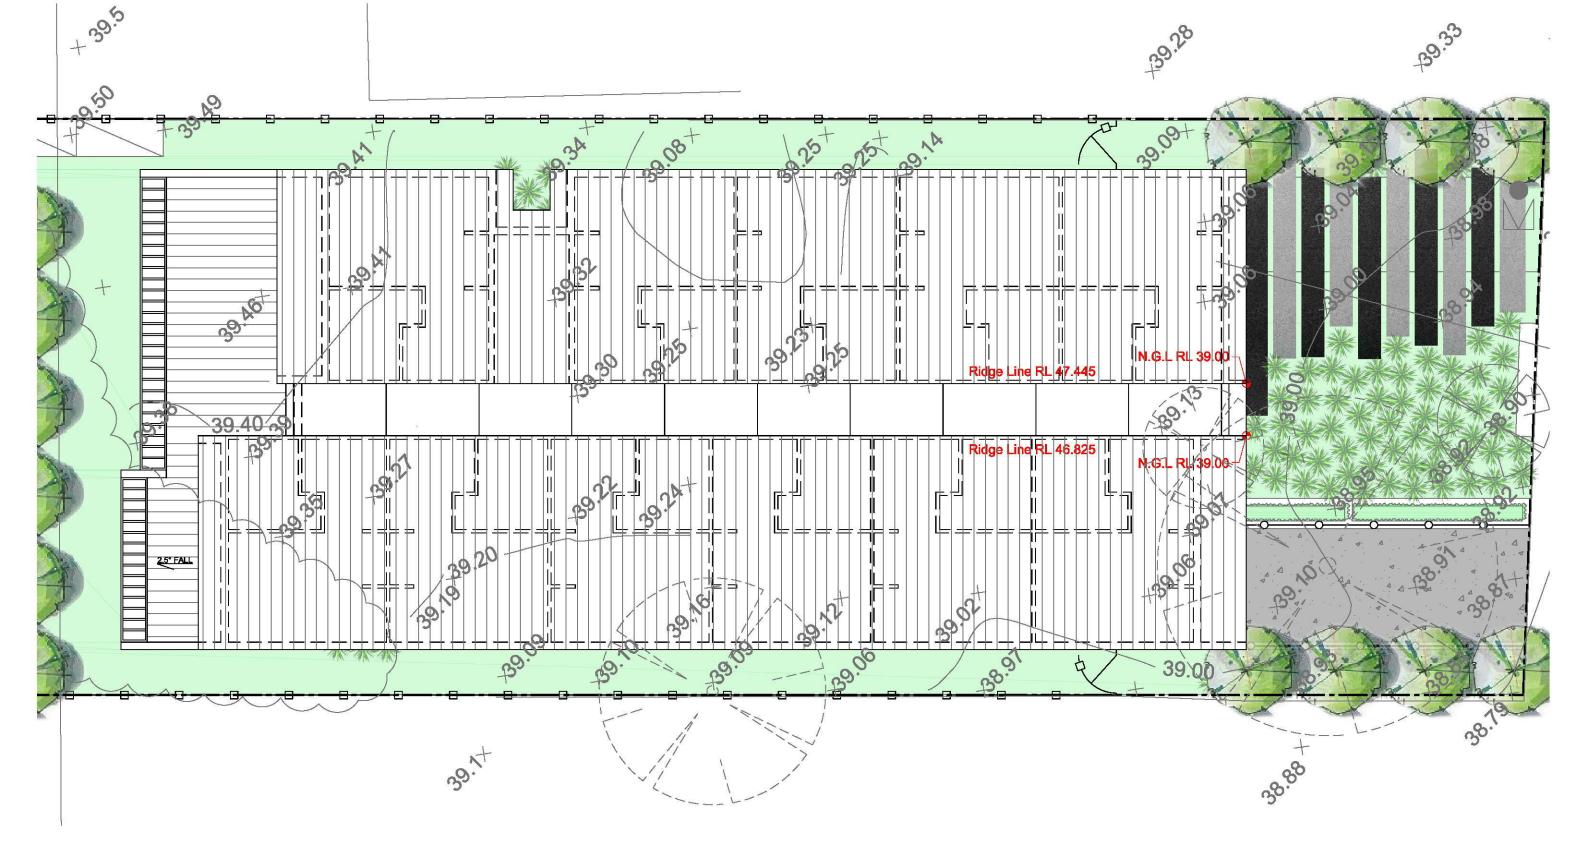

po box 3029 putney nsw 2112 www.dawsonvu.com.au trang@dawsonvu.com.au 0438 297 973 michael@dawsonvu.com.au 0438 297 962	04.02.19 31.01.19 16.11.18 05.11.18 Date	D C B A Revision	Reduce R1 to 15.9sqm Revised DA submission Revised DA submission DA submission	WET AREA CONSTRUCTION TO COMP     ALL ENCLOSED WATER CLOSET DOO     WITHIN 1200MM OF THE PAN IN ACCO     SMOKE ALARMS WILL BE PROVIDED I     ALL STAIRS WILL BE CONSTRUCTED I     THE FINISH OF ALL OF THE STAIRS W     ALL LANDINGS PROVIDED WILL MEET     ALL BALUSTRADES SERVICING THE S	<ul> <li>GUTTERS AND DOWNPIPES TO COMPLY WITH AUSTRALIAN STANDARD 3500.3 OR 3500.5</li> <li>WET AREA CONSTRUCTION TO COMPLY WITH AUSTRALIAN STANDARD 3740</li> <li>ALL ENCLOSED WATER CLOSET DOORS ARE TO SWING OUT OR TO BE PROVIDED WITH LIFT OFF HINGES OR THE LIKE IF THE DO WITHIN 1200MM OF THE PAN IN ACCORDANCE WITH THE REQUIREMENTS OF CLAUSE 3.8.3.3 OF VOLUME 2 OF THE NCCS (BCA)</li> <li>SMOKE ALARMS WILL BE PROVIDED IN ACCORDANCE WITH THE REQUIREMENTS OF PART 3.7.2 OF VOLUME 2 OF THE NCCS - BCA</li> <li>ALL STAIRS WILL BE CONSTRUCTED IN ACCORDANCE WITH THE REQUIREMENTS OF CLAUSE 3.9.1.2 OF VOLUME 2 OF THE NCCS- THE FINISH OF ALL OF THE STAIRS WILL MEET THE REQUIREMENTS OF CLAUSE 3.9.1.4 OF VOLUME 2 OF THE NCCS-BCA</li> <li>ALL LANDINGS PROVIDED WILL MEET THE REQUIREMENTS OF CLAUSE 3.9.1.4 OF VOLUME 2 OF THE NCCS-BCA</li> <li>ALL BALUSTRADES SERVICING THE STAIRS WILL MEET THE REQUIREMENTS OF CLAUSE 3.9.2.3 OF VOLUME 2 OF THE NCCS-BCA</li> <li>ALL BALUSTRADES SERVICING THE STAIRS WILL MEET THE REQUIREMENTS OF CLAUSE 3.9.2.3 OF VOLUME 2 OF THE NCCS-BCA</li> <li>ALL BALUSTRADES SERVICING THE STAIRS WILL MEET THE REQUIREMENTS OF CLAUSE 3.9.2.3 OF VOLUME 2 OF THE NCCS-BCA</li> <li>ALL BALUSTRADES SERVICING THE STAIRS WILL MEET THE REQUIREMENTS OF CLAUSE 3.9.2.3 OF VOLUME 2 OF THE NCCS-BCA</li> </ul>
design + interiors pobox 3029 putney nsw 2112	5			written consent from Dawsonvu Pty Ltd. Do not scale from these drawings, use written dimensions only. IF THERE ARE ANY DISCREPANCIES, DO NOT ASSUME, CONTACT MICHAEL DIRECT: 0438 297 962	WET AREA CONSTRUCTION TO COMPLY WITH AUSTRALIAN STANDARD 3740     ALL ENCLOSED WATER CLOSET DOORS ARE TO SWING OUT OR TO BE PROVIDED WITH LIFT OFF HINGES OR THE LIKE IF THE DO
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CS -	Project:	North:
	Boarding House Development Lot 67, 12 Anthony Crescent, Kingswood Dp 212261	
RIS	Drawing Sheet	Drawing No:
3CA	Roof Plan	DA5
	Scale:1-100@A3	Revision :
	Date: 31.01.19	D



				Notes:	BUILDING CODE OF AUSTRALIA ( VOLUME 2 OF THE NATIONAL CONSTRUCTION CODE SERIES - BUILDING CODE OF AUSTRALIA (NCC
dawsonvu				This drawing all drawings,sketches and illustrations are copyright of Dawsonvu Pty Ltd. It may not be used without written consent from Dawsonvu Pty Ltd.	BCA) 2016 ) & AUSTRALIAN STANDARD NOTE: • ALL FIRST FLOOR BEDROOM WINDOWS WITH RESTRICTED OPENING TO COMPLY WITH CLAUSE 3.9.2.5 OF THE BCA • NON-SLIP NOSING'S OR TREADS TO STAIRS TO COMPLY WITH CLAUSE 3.9.1.4 OF THE BCA
design + interiors				Do not scale from these drawings, use written dimensions only. IF THERE ARE ANY DISCREPANCIES, DO NOT ASSUME, CONTACT MICHAEL DIRECT: 0438 297 962	<ul> <li>ALL MASONRY WALLS TO HAVE EXPANSION JOINTS TO COMPLY WITH BCA REQUIREMENTS</li> <li>TERMITE CONTROL TO AS 3660.1</li> <li>A HIGH IMPACT VAPOR BARRIER TO COMPLY AS PER THE REQUIREMENTS OF CLAUSE 3.2.2.6 OF THE BCA;</li> <li>MASONRY CONSTRUCTION TO COMPLY WITH AUSTRALIAN STANDARD 3500.3 OR 3500.5</li> </ul>
po box 3029 putney nsw 2112 www.dawsonyu.com.gu	04.02.19	D	Reduce R1 to 15.9sqm	-	WET AREA CONSTRUCTION TO COMPLY WITH AUSTRALIAN STANDARD 3740     ALL ENCLOSED WATER CLOSET DOORS ARE TO SWING OUT OR TO BE PROVIDED WITH LIFT OFF HINGES OR THE LIKE IF THE DOO     WITHIN 1200MM OF THE PAN IN ACCORDANCE WITH THE REQUIREMENTS OF CLAUSE 3.8.3.3 OF VOLUME 2 OF THE NCCS (BCA)
	31.01.19	С	Revised DA submission	1	SMOKE ALARMS WILL BE PROVIDED IN ACCORDANCE WITH THE REQUIREMENTS OF PART 3.7.2 OF VOLUME 2 OF NCCS - BCA     ALL STAIRS WILL BE CONSTRUCTED IN ACCORDANCE WITH THE REQUIREMENTS OF CLAUSE 3.9.1.2 OF VOLUME 2 OF THE NCCS-B
	16.11.18	В	Revised DA submission		THE FINISH OF ALL OF THE STAIRS WILL MEET THE REQUIREMENTS OF CLAUSE 3.9.14 OF VOLUME 2 OF THE NCCS-BCA     ALL LANDINGS PROVIDED WILL MEET THE REQUIREMENTS OF CLAUSE 3.9.1.5 OF VOLUME 2 OF THE NCCS-BCA
	05.11.18	Α	DA submission	]	• ALL BALUSTRADES SERVICING THE STAIRS WILL MEET THE REQUIREMENTS OF CLAUSE 3.9.2.3 OF VOLUME 2 OF THE NCCS-BCA
0438 297 962	Date	Revision	Issue		* ALL HANDRAILS TO THE STAIRS IN ACCORDANCE WITH CLAUSE 3.9.2.4 OF VOLUME 2 OF THE NCCS - BCA.

A (NCCS -	Project	North:
	Boarding House Development Lot 67, 12 Anthony Crescent, Kingswood Dp 212261	
e door is XA) XA	Drawing Sheet	Drawing No:
CCS-BCA	North Elevation	Revision :
BCA	Date: 31.01.19	D




www.ddwsonwo.com.do	4.02.19		Reduce R1 to 15.9sqm Revised DA submission	Notes: This drawing all drawings, sketches and illustrations are copyright of Dawsonvu Pty Ltd. It may not be used without written consent from Dawsonvu Pty Ltd. Do not scale from these drawings, use written dimensions only. IF THERE ARE ANY DISCREPANCIES, DO NOT ASSUME, CONTACT MICHAEL DIRECT: 0438 297 962	Building code of Australia ( yolume 2 of the national construction code series - building code of Australia (nc BCA) 2016) & Alistralian Standard Note:           • ALL FIRST FLOOR BEDROOM WINDOWS WITH RESTRICTED OPENING TO COMPLY WITH CLAUSE 3.9.2.5 OF THE BCA           • NON-SLIP NOSING'S OR TREADS TO STAIRS TO COMPLY WITH CLAUSE 3.9.4.6 F THE BCA           • ALL FIRST FLOOR BEDROOM WINDOWS WITH RESTRICTED OPENING TO COMPLY WITH CLAUSE 3.9.2.5 OF THE BCA           • ALL MASONRY WALLS TO HAVE EXPANSION JOINTS TO COMPLY WITH BCA REQUIREMENTS           • TERMITE CONTROL TO AS 3660.1           • A HIGH IMPACT VAPOR BARRIER TO COMPLY AS PER THE REQUIREMENTS OF CLAUSE 3.2.2.6 OF THE BCA;           • MASONRY CONSTRUCTION TO COMPLY WITH AUSTRALIAN STANDARD 3700           • GUTTERS AND DOWNPIPES TO COMPLY WITH AUSTRALIAN STANDARD 3500.3 OR 3500.5           • WET AREA CONSTRUCTION TO COMPLY WITH AUSTRALIAN STANDARD 3740           • ALL ENCLOSED WATER CLOSET DOORS ARE TO SWITH THE REQUIREMENTS OF CLAUSE 3.8.3.3 OF VOLUME 2 OF THE NCCS (BCA)           • SMOKE ALARMS WILL BE PROVIDED IN ACCORDANCE WITH THE REQUIREMENTS OF PART 3.7.2 OF VOLUME 2 OF THE NCCS (BCA)           • SMOKE ALARMS WILL BE CONSTRUCTOED IN ACCORDANCE WITH THE REQUIREMENTS OF PART 3.7.2 OF VOLUME 2 OF THE NCCS
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STEEL MATT COLORBOND ROOF 11° PITCH ALUMINUM PERGOLA PAINTED FINISHED TO SELECTED LIGHTWEIGHT MATERIAL METAL ROOF 2.5° PITCH STEEL MATT COLORBOND

ALUMINUM

\_RENDERED FINISH AS SELECTED

IA (NCCS -	Project	North:
	Boarding House Development Lot 67, 12 Anthony Crescent, Kingswood Dp 212261	
HE DOOR IS	Drawing Sheet	Drawing No:
ICA NCCS-BCA	South Elevation	DA7
	Scale:1-100@A3	Revision :
S-BCA	Date: 31.01.19	D

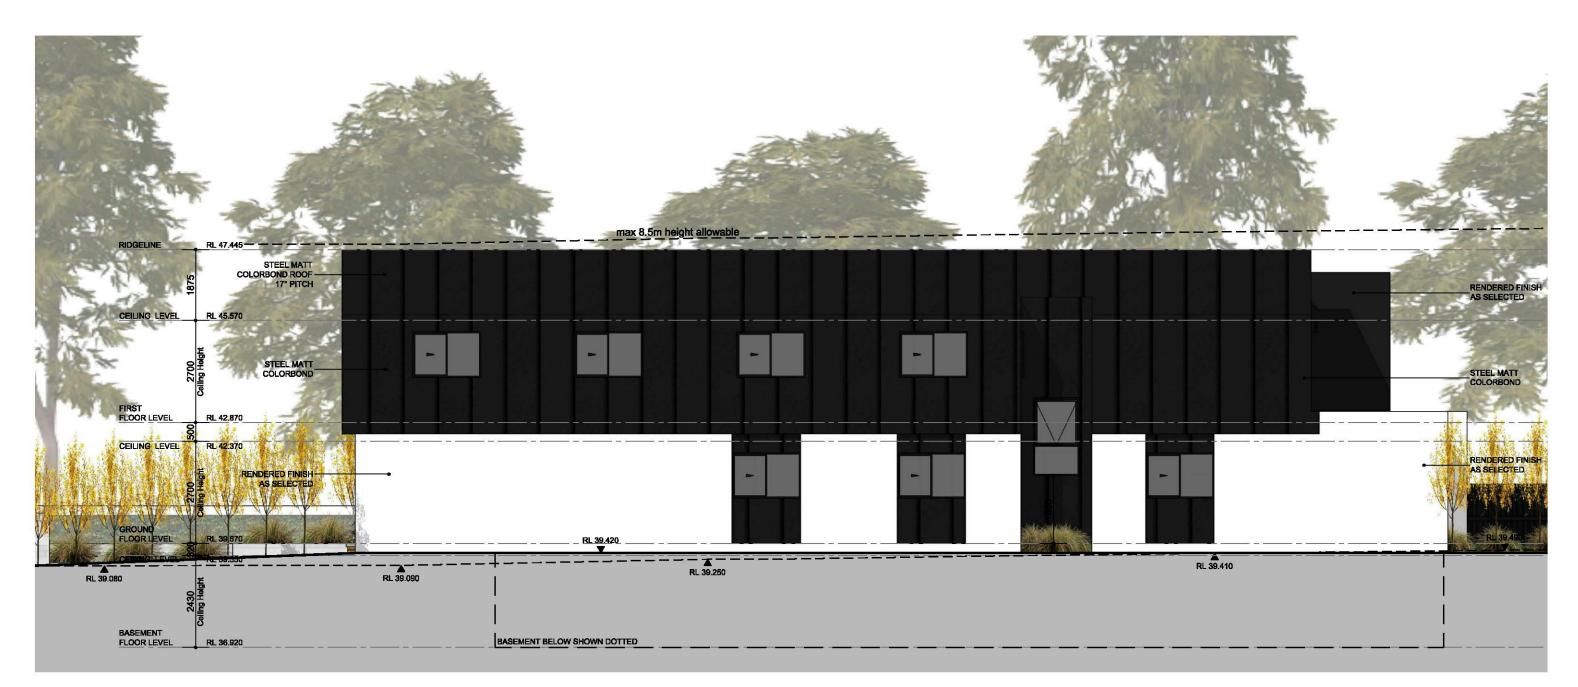

West Elevation

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design + interiors				Do not scale from these drawings, use written dimensions only. IF THERE ARE ANY DISCREPANCIES, DO NOT ASSUME, CONTACT MICHAEL DIRECT: 0438 297 962	• TERMITE CONTROL TO AS 3660.1 • A HIGH IMPACT VAPOR BARRIER TO COMPLY AS PER THE REQUIREMENTS OF CLAUSE 3.2.2.6 OF THE BCA; • MASONRY CONSTRUCTION TO COMPLY WITH AUSTRALIAN STANDARD 3700 • GUITERS AND DOWNPIPES TO COMPLY WITH AUSTRALIAN STANDARD 3500.3 OR 3500.5
po box 3029 putney nsw 2112					• WET AREA CONSTRUCTION TO COMPLY WITH AUSTRALIAN STANDARD 3740     • ALL ENCLOSED WATER CLOSET DOORS ARE TO SWING OUT OR TO BE PROVIDED WITH LIFT OFF HINGES OR THE LIKE IF THE DO
www.dawsonvu.com.au	04.02.19	D	Reduce R1 to 15.9sqm		WITHIN 1200MM OF THE PAN IN ACCORDANCE WITH THE REQUIREMENTS OF CLAUSE 3.8.3.3 OF VOLUME 2 OF THE NCCS (BCA)
trang@dawsonvu.com.au	31.01.19	C	Revised DA submission		<ul> <li>SMOKE ALARMS WILL BE PROVIDED IN ACCORDANCE WITH THE REQUIREMENTS OF PART 3.7.2 OF VOLUME 2 OF NCCS - BCA</li> <li>ALL STAIRS WILL BE CONSTRUCTED IN ACCORDANCE WITH THE REQUIREMENTS OF CLAUSE 3.9.1.2 OF VOLUME 2 OF THE NCCS</li> </ul>
0438 297 973	16.11.18	В	Revised DA submission		• THE FINISH OF ALL OF THE STAIRS WILL MEET THE REQUIREMENTS OF CLAUSE 3.9.1.4 OF VOLUME 2 OF THE NCCS-BCA
michael@dawsonvu.com.au	05.11.18	Α	DA submission		<ul> <li>ALL LANDINGS PROVIDED WILL MEET THE REQUIREMENTS OF CLAUSE 3.9.1.5 OF VOLUME 2 OF THE NCCS-BCA</li> <li>ALL BALUSTRADES SERVICING THE STARS WILL MEET THE REQUIREMENTS OF CLAUSE 3.9.2.3 OF VOLUME 2 OF THE NCCS-BC/</li> </ul>
0438 297 962	Date	Revision	Issue		ALL HANDRAILS TO THE STAIRS IN ACCORDANCE WITH CLAUSE 3.9.2.4 OF VOLUME 2 OF THE NCCS - BCA.


CCS -	Project	North:
	Boarding House Development Lot 67, 12 Anthony Crescent, Kingswood Dp 212261	
ORIS	Drawing Sheet	Drawing No:
BCA	West Elevation	DA8
<b></b>	Scale:1-100@A3	Revision :
	Date: 31.01.19	D




East Elevation

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po box 3029 putney nsw 2112				]	WET AREA CONSTRUCTION TO COMPLY WITH AUSTRALIAN STANDARD 3740     ALL ENCLOSED WATER CLOSET DOORS ARE TO SWING OUT OR TO BE PROVIDED WITH LIFT OFF HINGES OR THE LIKE IF THE DO
	04.02.19	D	Reduce R1 to 15.9sqm	]	WITHIN 1200MM OF THE PAN IN ACCORDANCE WITH THE REQUIREMENTS OF CLAUSE 3.8.3.3 OF VOLUME 2 OF THE NCCS (BCA)
trang@dawsonvu.com.au	31.01.19	C	Revised DA submission	]	<ul> <li>SMOKE ALARMS WILL BE PROVIDED IN ACCORDANCE WITH THE REQUIREMENTS OF PART 3.7.2 OF VOLUME 2 OF NCCS - BCA</li> <li>ALL STAIRS WILL BE CONSTRUCTED IN ACCORDANCE WITH THE REQUIREMENTS OF CLAUSE 3.9.1.2 OF VOLUME 2 OF THE NCCS</li> </ul>
	16.11.18	В	Revised DA submission		• THE FINISH OF ALL OF THE STAIRS WILL MEET THE REQUIREMENTS OF CLAUSE 3.9.1.4 OF VOLUME 2 OF THE NCCS-BCA
	05.11.18	Α	DA submission	]	<ul> <li>ALL LANDINGS PROVIDED WILL MEET THE REQUIREMENTS OF CLAUSE 3.9.1.5 OF VOLUME 2 OF THE NCCS-BCA</li> <li>ALL BALUSTRADES SERVICING THE STAIRS WILL MEET THE REQUIREMENTS OF CLAUSE 3.9.2.3 OF VOLUME 2 OF THE NCCS-BCA</li> </ul>
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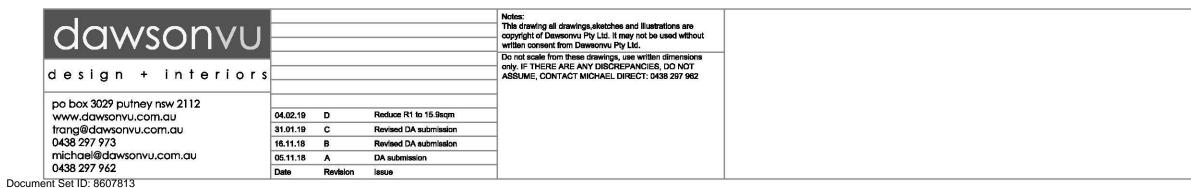
(NCCS -	Project	North:		
	Boarding House Development Lot 67, 12 Anthony Crescent, Kingswood Dp 212261			
DOOR IS	Drawing Sheet East Elevation	Drawing No:		
U-0-10UA	Scale:1-100@A3	Revision :		
CA	Date: 31.01.19	D		

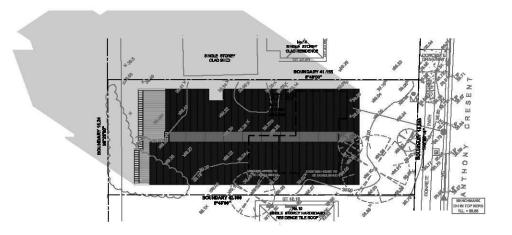

#### SHADOW CAST AT 09:00 ON JUNE 21st

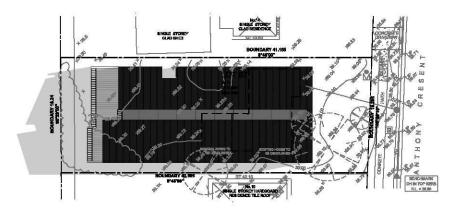

#### SHADOW CAST AT 12:00 ON JUNE 21st




Version: 1, Version Date: 08/03/2019


SINGLE STOREY

SHADOW CAST AT 15:00 ON JUNE 21st



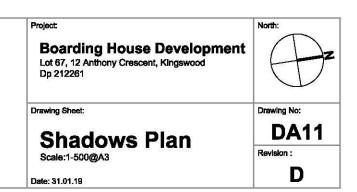

PREVAILING

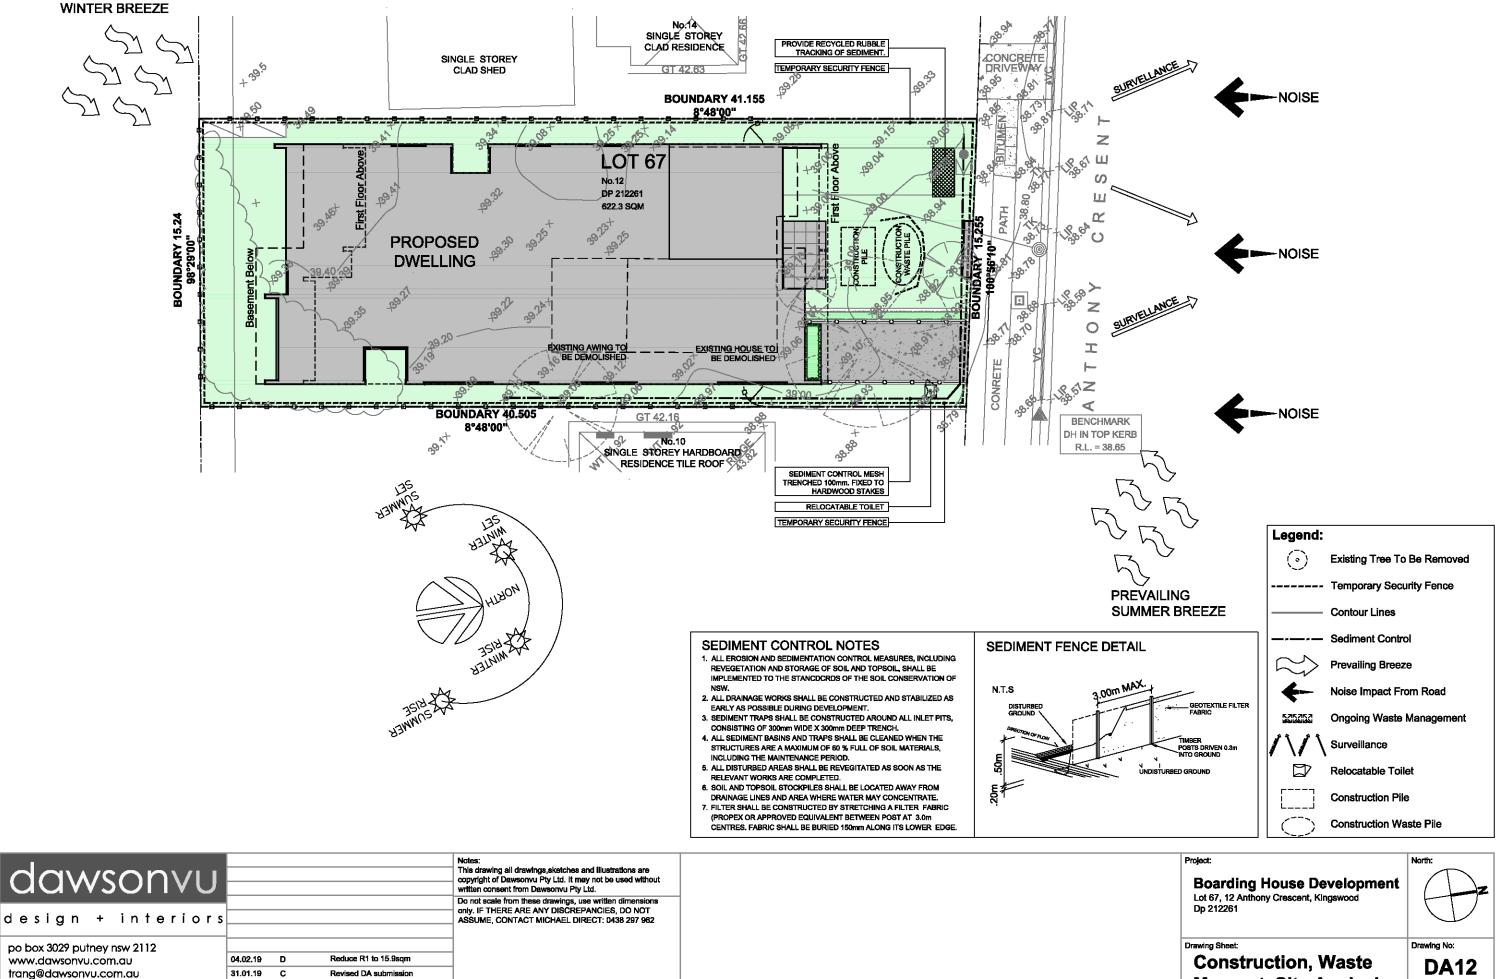


po box 3029 putney nsw 2112 www.dawsonvu.com.au trang@dawsonvu.com.au 0438 297 973 michael@dawsonvu.com.au 0438 297 962

D	Reduce R1 to 15.9sqm
С	Revised DA submission
В	Revised DA submission
Α	DA submission
Revision	lssue
	C B A

Document Set ID: 8607813 Version: 1, Version Date: 08/03/2019 Mngmnt, Site Analysis Scale:1-200@A3

Date: 31.01.19

**DA12** Revision : D

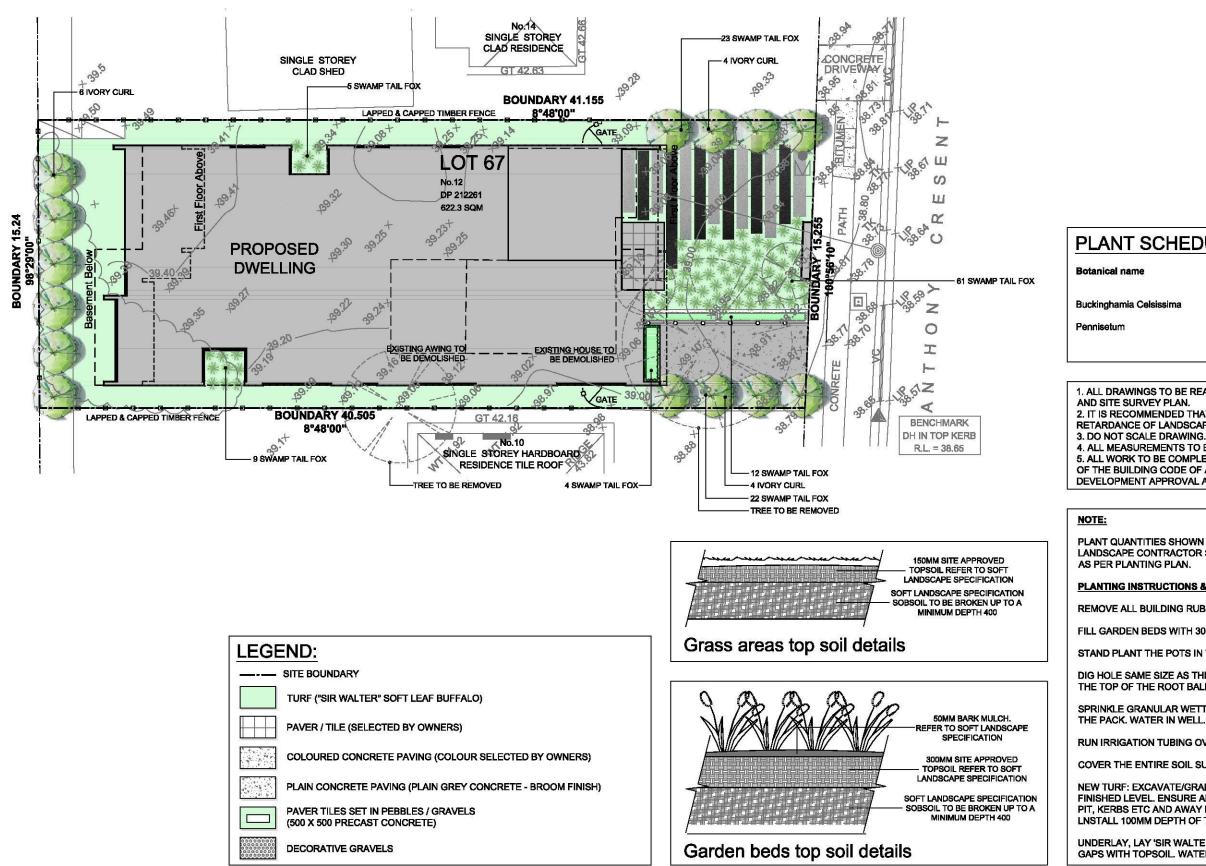

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po box 3029 putney nsw 2112 www.dawsonyu.com.au	04.02.19	D	Reduce R1 to 15.9sgm	_	
trang@dawsonvu.com.au	31.01.19		Revised DA submission	—	
0438 297 973	16.11.18	В	Revised DA submission		
michael@dawsonvu.com.au	05.11.18	Α	DA submission		
0438 297 962	Date	Revision	Issue		

SCHEDULE									
e	Common name	Suppliy Size	Mature Height	Quantity					
Celsissima	Ivory Curl	100L	8m	13					
	Swamp Tail Fox	30mm	1m	136					

## 1. ALL DRAWINGS TO BE READ IN CONJUNCTION WITH ARCHITECTURAL PLANS

2. IT IS RECOMMENDED THAT DRIP IRRIGATION BE PROVIDED TO ASSIST IN FIRE RETARDANCE OF LANDSCAPED AREAS.

4. ALL MEASUREMENTS TO BE VERIFIED ON SITE PRIOR TO COMMENCEMENT. 5. ALL WORK TO BE COMPLETED IN ACCORDANCE WITH THE RELEVANT REQUIREMENTS OF THE BUILDING CODE OF AUSTRALIA, AUSTRALIAN STANDARDS, AND APPLICABLE DEVELOPMENT APPROVAL AUTHORITIES.

PLANT QUANTITIES SHOWN ON PLANTING PLAN TO BE USED AS A GUIDE ONLY. THE LANDSCAPE CONTRACTOR SHALL ENSURE THAT CORRECT QUANTITIES ARE INSTALLED

#### PLANTING INSTRUCTIONS & SPECIFICATION :

REMOVE ALL BUILDING RUBBLE AND WEEDS FROM GARDEN BEDS.

FILL GARDEN BEDS WITH 300MM ORGANIC GARDEN MIX.

STAND PLANT THE POTS IN THEIR POSITION ACCORDING TO THE PLANTING PLAN.

DIG HOLE SAME SIZE AS THE POT. REMOVE THE PLANT FROM THE POT. PLANT SO THAT THE TOP OF THE ROOT BALL IS LEVEL WITH THE SOIL.

SPRINKLE GRANULAR WETTING AGENT AND FERTILIZER ACCORDING TO DIRECTIONS ON

RUN IRRIGATION TUBING OVER THE SOIL.

COVER THE ENTIRE SOIL SURFACE WITH 7SMM MULCH.

NEW TURF: EXCAVATE/GRADE AREAS TO BE TURFED TO 120MM BELOW REQUIRED FINISHED LEVEL. ENSURE ALL SURFACE WATER RUN-OFF IS DIRECTED TOWARDS INLET PIT, KERBS ETC AND AWAY FROM BUILDING.FURTHER RIP THE SUBGRADE TO 150MM. **LNSTALL 100MM DEPTH OF TURF** 

UNDERLAY, LAY 'SIR WALTER BUFFALO' TURF ROLLS CLOSELY BUTTED. FILL ANY SMALL GAPS WITH TOPSOIL. WATER THOROUGHLY.

Project:	North:
Boarding House Development Lot 67, 12 Anthony Crescent, Kingswood Dp 212261	
Drawing Sheet:	Drawing No:
Landscape Plan	DA10
Scale:1-200@A3	Revision :
Date: 31.01.19	D



## FRONT VIEW FROM THE STREET



# C

**RIGHT VIEW** 

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design + interiors

po box 3029 putney nsw 2112 www.dawsonvu.com.au trang@dawsonvu.com.au 0438 297 973 michael@dawsonvu.com.au 0438 297 962 Document Set ID: 8607813

Version: 1, Version Date: 08/03/2019

Date	Revision	Issue
05.11.18	Α	DA submission
16.11.18	В	Revised DA submission
31.01.19	C	Revised DA submission
04.02.19	D	Reduce R1 to 15.9sqm

LEFT VIEW

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**REAR VIEW** 








### FRONT VIEW FROM THE STREET



FRONT VIEW FROM THE STREET



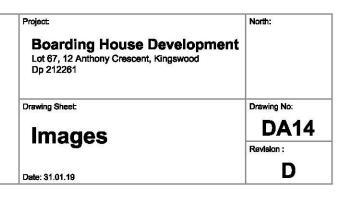





METAL ROOF - STANDING SEAM CLADDING MATT FINISH BLACK COLORBOND



**GUTTER & FASCIA** COLOUR: MONUMENT



RENDER FINISH COLOUR: MONUMENT

RENDER FINISH COLOUR: WHITE

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po box 3029 putney nsw 2112 www.dawsonyu.com.au	04.02.19	D	Reduce R1 to 15.9sqm	-
trang@dawsonvu.com.au	31.01.19	С	Revised DA submission	1
0438 297 973	16.11.18	в	Revised DA submission	1
michael@dawsonvu.com.au	05.11.18	Α	DA submission	]
0438 297 962	Date	Revision	Issue	

Document Set ID: 8607813 Version: 1, Version Date: 08/03/2019



GARAGE DOOR/ CEDAR CLADDING COLOUR : STAINED





#### STANDING SEAM CLADDING MATT FINISH BLACK COLORBOND





WINDOW/DOOR COLOUR : BLACK


Project	North:
Boarding House Development Lot 67, 12 Anthony Crescent, Kingswood Dp 212261	
Drawing Sheet	Drawing No:
Colour + Material	DA15
Schedule	Revision :
Date: 31.01.19	D

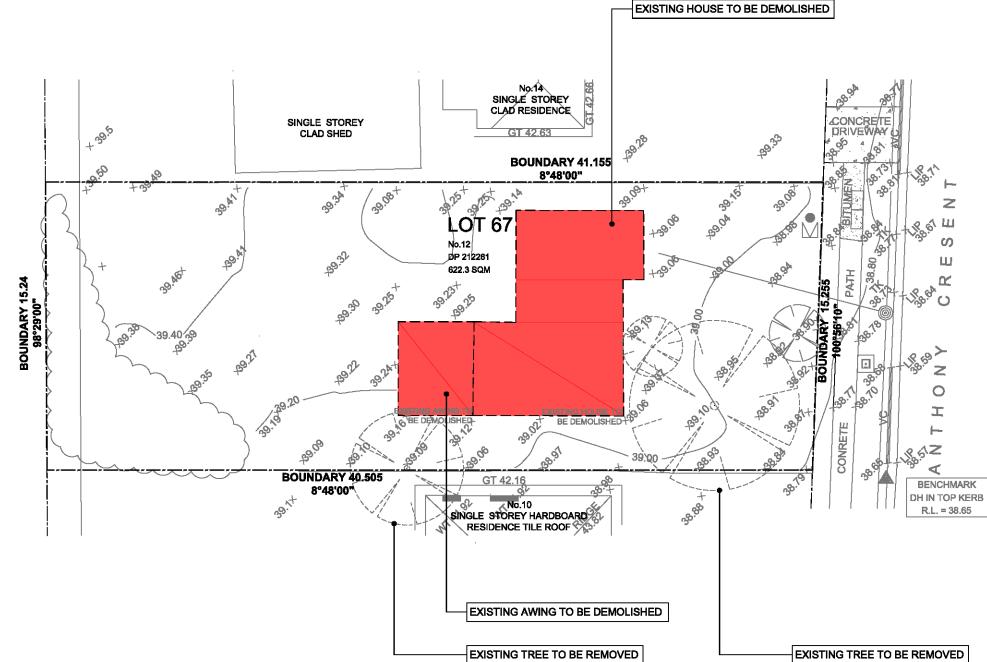

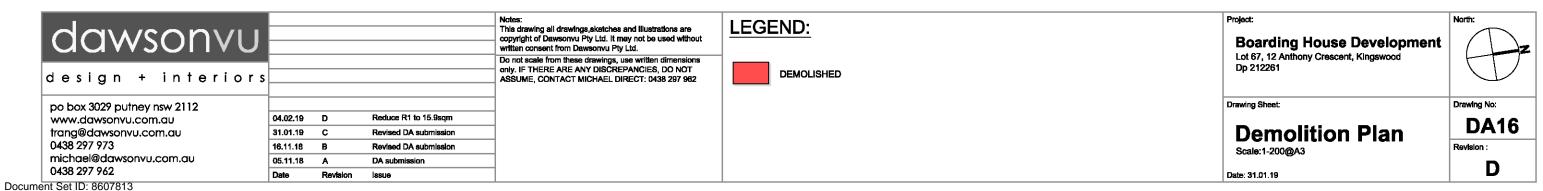

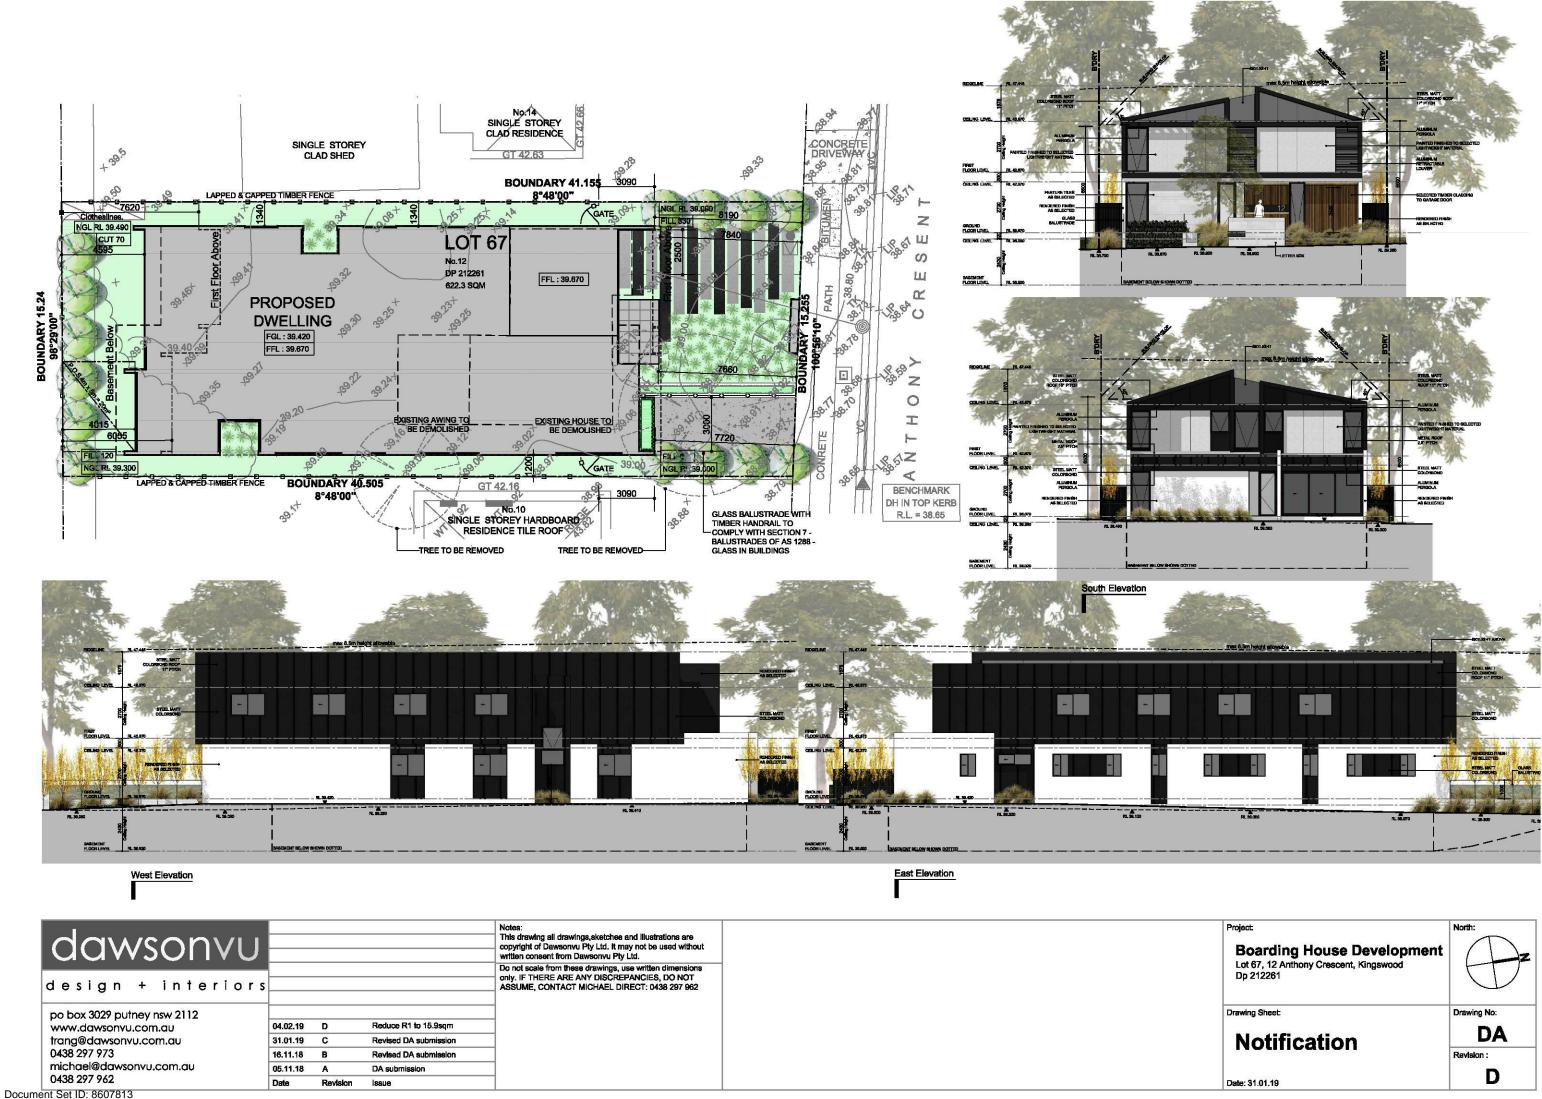

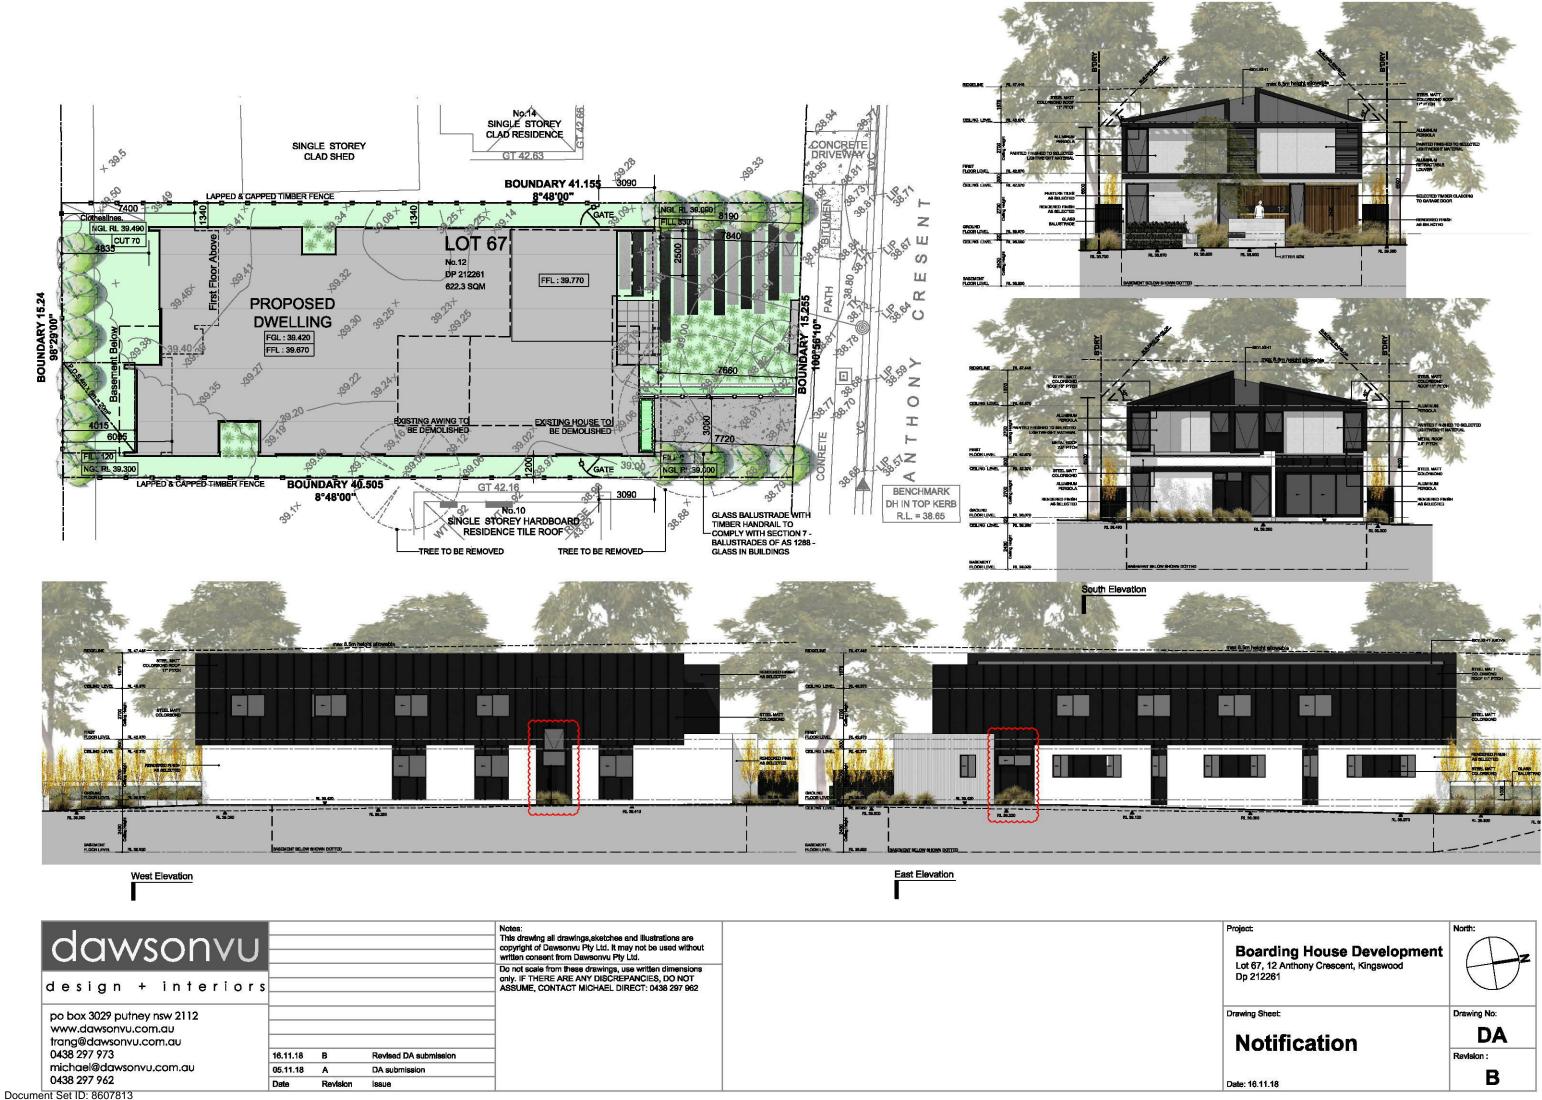

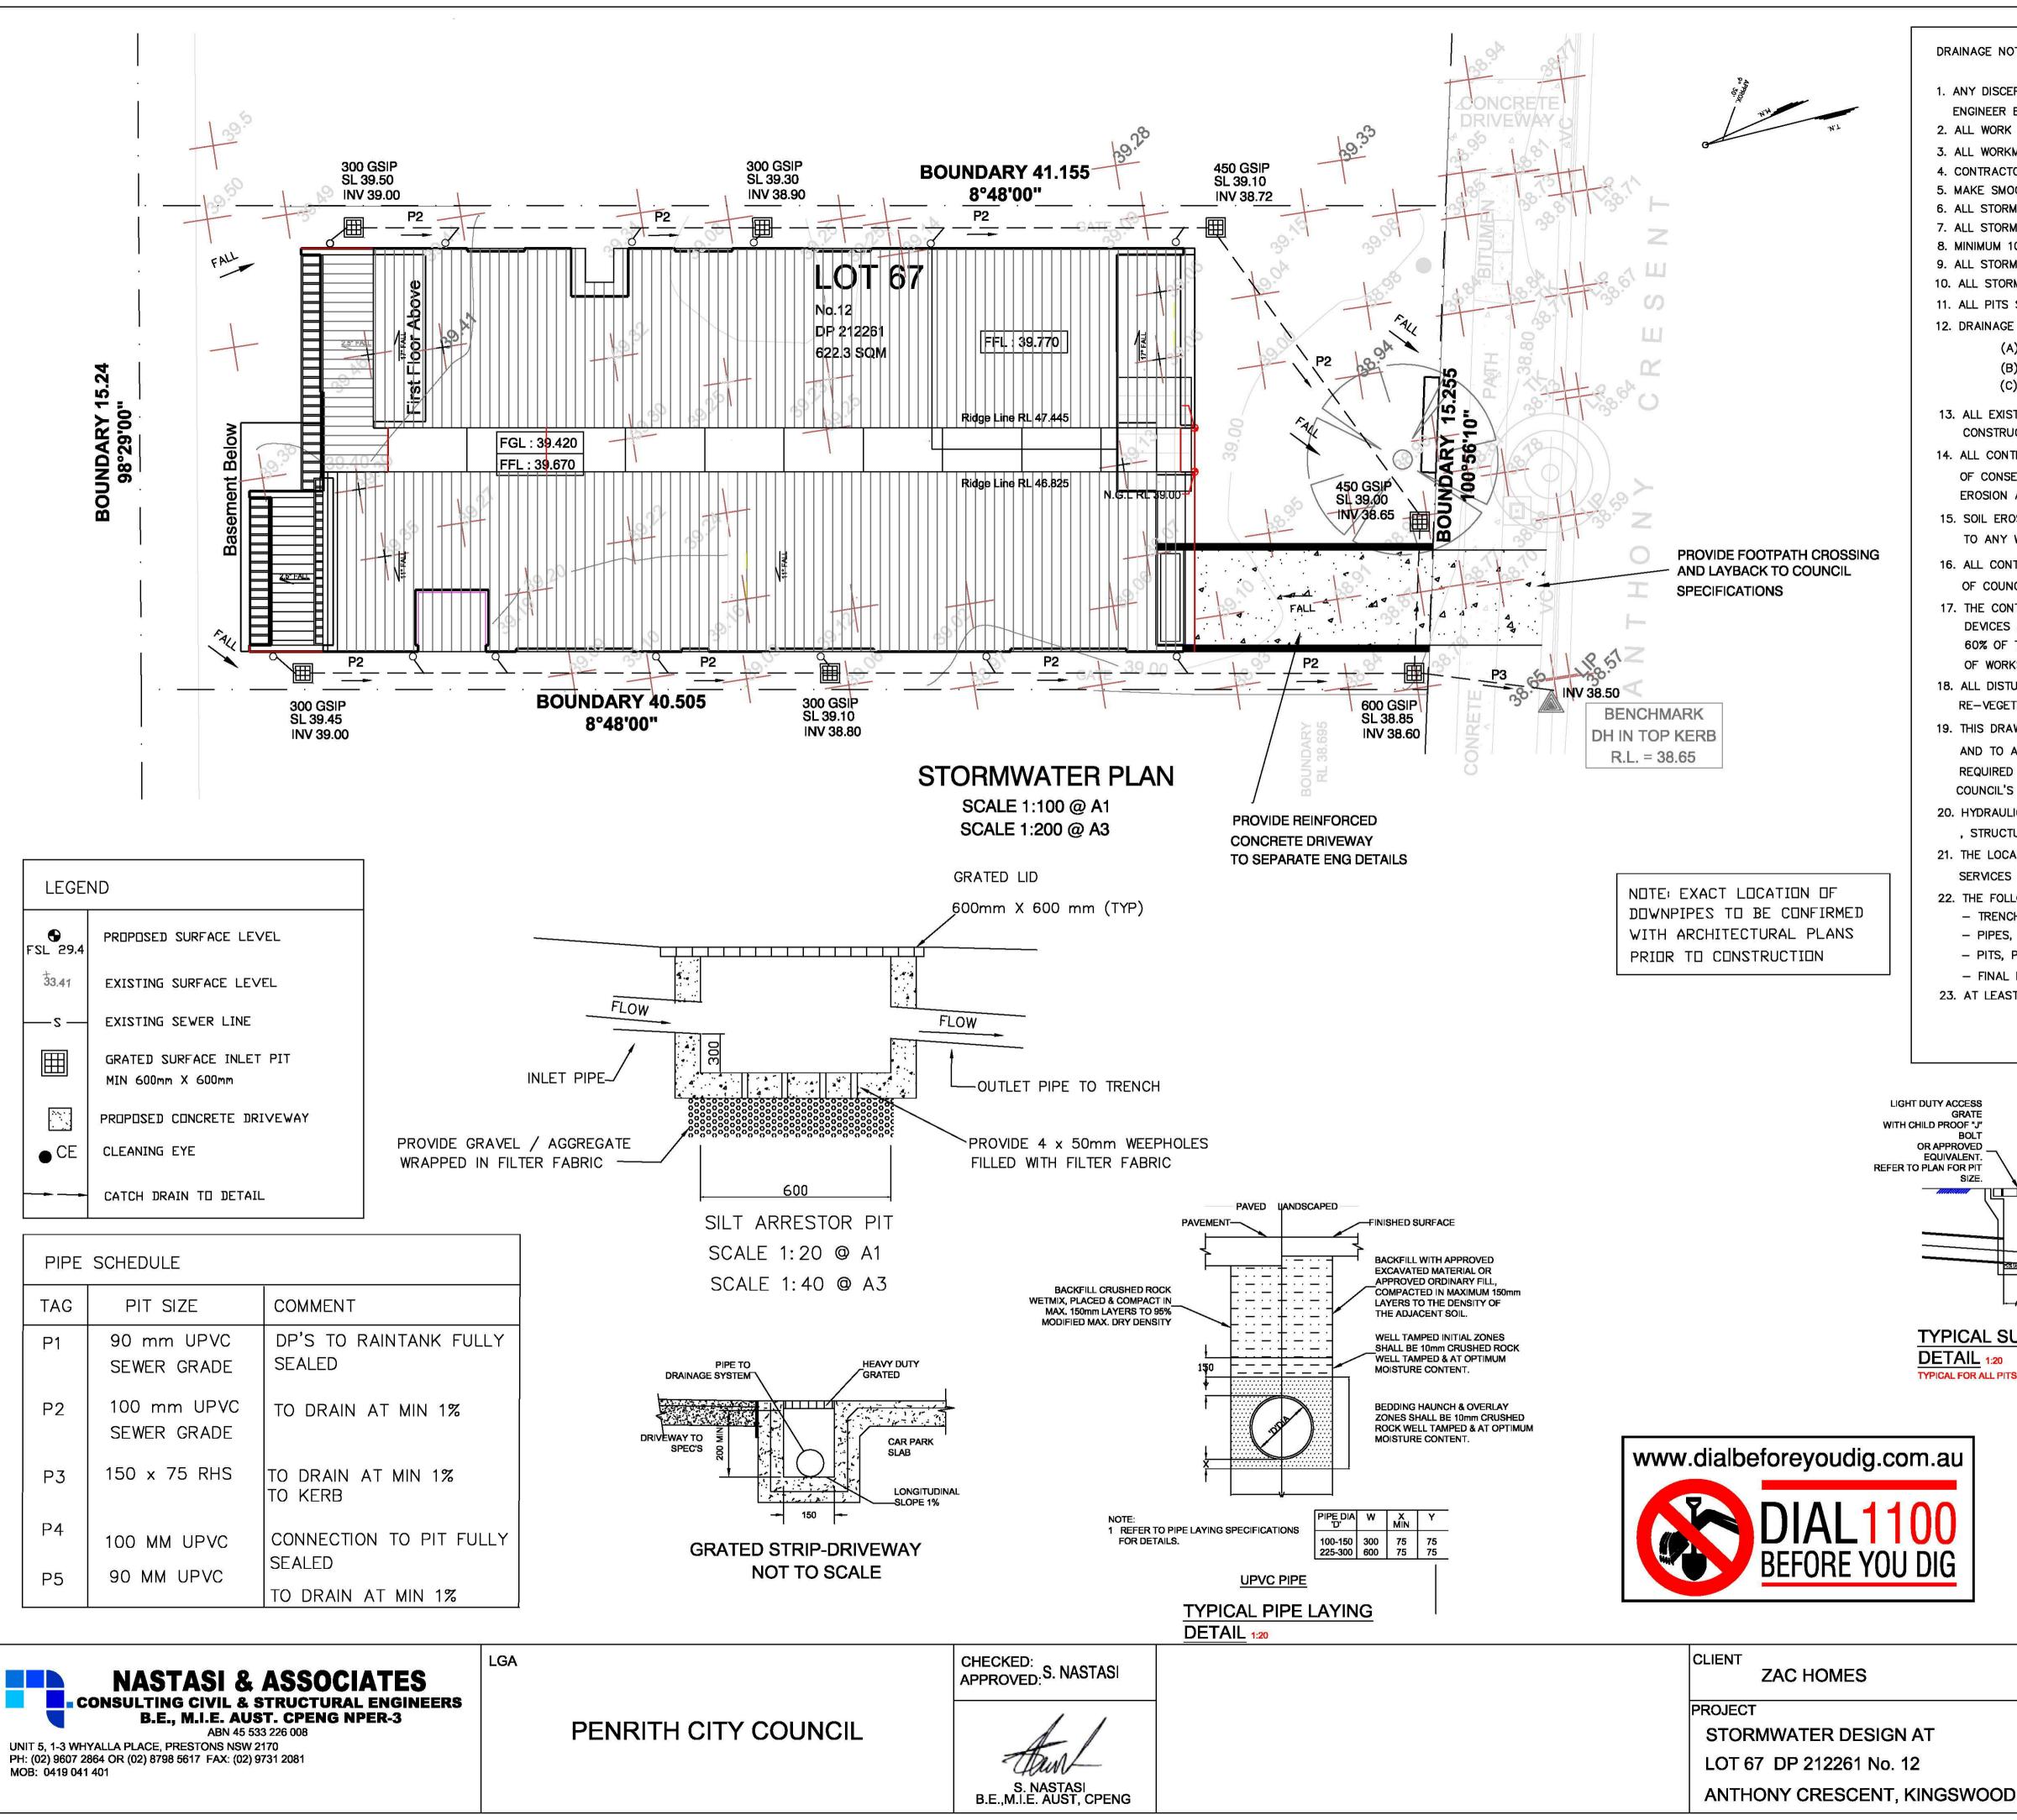


## DRAINAGE NOTES: 1. ANY DISCEREPANCY OR CONFUSION ON THESE DRAWINGS MUST BE NOTIFIED TO THE ENGINEER BEFORE PROCEEDING FURTHER ON THE WORKS 2. ALL WORK SHALL BE IN ACCORDANCE WITH COUNCIL SPECIFICATIONS 3. ALL WORKMANSHIP AND MATERIALS SHALL COMPLY WITH THE RELEVANT SAA CODES. 4. CONTRACTOR SHALL VERIFY THE VALUE OF THE BM PRIOR TO COMMENCEMENT OF WORK 5. MAKE SMOOTH JUNCTION WITH EXISTING WORKS 6. ALL STORMWATER PIPES AND PITS SHALL BE INSTALLED INACCORDANCE WITH AS3500.3 7. ALL STORMWATER PIPES UNDER TRAFFICABLE AREAS SHALL BE SEWER GRADE UPVC 8. MINIMUM 100MM COVER TO NATURAL SURFACE OR UNDERSIDE OF PAVEMENT. 9. ALL STORMWATER PIPES FROM DOWNPIPES SHALL BE 100MM DIA UPVC AT 1% MIN UNO 10. ALL STORMWATER PIPES FROMPITS SHALL BE 150MM DIA UPVC LAID AT 1% MIN UNO 11. ALL PITS SHALL BE PRE-CAST OR CASTIN-SITU CONCRETE OR APPROVED EQUIVALENT 12. DRAINAGE CALCULATIONS AND CAPACITIES HAVE BEEN ASSESSED AS FOLLOWS: (A) 10 YR ARI FOR PITS AND PIPES (B) 20 YR ARI FOR EAVES AND GUTTERS (C) 100 YR ARI FOR BOX GUTTERS - UNO 13. ALL EXISTING SERVICES IN THE ROAD RESERVE SHALL BE IDENTIFIED PRIOR TO CONSTRUCTION AND RELOCATED AS REQUIRED AT OWNERS EXPENSE. 14. ALL CONTROL MEASURES USED SHALL BE INACCORDANCE WITH THE DEPARTMENT OF CONSERVATION AND LAND MANAGEMENT PUBLICATION DATED 1992 TITLED " URBAN EROSION AND SEDIMENT CONTROL " 15. SOIL EROSION AND SEDIMENT CONTROL MEASURES SHALL BE SET IN PLACE PRIOR TO ANY WORKS COMMENCING 16. ALL CONTROL MEASURES SHALL ALSO BE INSTALLED TO THE SATIDFACTION OF COUNCIL'S ENGINEER 17. THE CONTRACTOR SHALL REGULARLY MAINTAIN ALL SEDIMENT AND EROSION CONTROL DEVICES AND REMOVE ACCUMULATED SILT FROM SUCH DEVICES BEFORE NO MORE THAN 60% OF THEIR CAPACITY IS LOST. NO SILT SHALL BEPLACED OUTSIDE THE LIMIT OF WORKS 18. ALL DISTURBED AREAS SHALL BE STABILISED BY MEANS OF LANDSCAPING, TURF OR RE-VEGETATED AS SOON AS POSSIBLE. 19. THIS DRAWING OUTLINES THE MINIMUM MEASURES TO BE TAKEN TO CONTROL EROSION AND TO ARREST THE TRANSPORT OF SEDIMENT. ADDITIONAL MEASURES MAY BE REQUIRED TO SUIT STAGING OF WORKS OR AS DIRECTED BY THE SUPERINTENDENT OR COUNCIL'S ENGINEER. 20. HYDRAULIC DRAWINGS SHOULD BE READ IN CONJUCTION WITH RELEVANT ARCHITECTURAL , STRUCTURAL, MECHANICAL, ELECTRICAL, CIVIL WORKS DRAWINGS AND SPECIFICATIONS 21. THE LOCATIONS OF EXISITING SERVICES ARE APPROXIMATE ONLY. EXACT LOCATION OF SERVICES SHALL BE VERIFIED PRIOR TO COMMENCEMENT OF WORK 22. THE FOLLOWING POINTS SHALL BE HOLD POINTS DURING CONSTRUCTION: - TRENCH AND BEDDING PRIOR TO LAYING OF PIPES. - PIPES, PRIOR TO BACKFILLING - PITS, PRIOR TO BACKFILLING - FINAL INSPECTION 23. AT LEAST 24HRS NOTICE SHALL BE GIVEN TO COUNCIL FOR AN INSPECTION GRATED DRAIN GRATE CONCRETE BOL 1 CONTRACTOR TO EXCAVATE 14 C -& BACKFILL PIT AS PER PIPE LAYING SPECIFICATION 100Ø OUTLET SIZE **GRATED FLOOR WASTE OUTLET** NOT TO SCALE 'B' x 'D' CONCRETE BENCHING/SHAPING TO BASE OF ALL PITS -AS PER PLAN-**TYPICAL SURFACE INLET PIT** DETAIL 1:20

TYPICAL FOR ALL PITS IN NON TRAFFIC AREAS.

ANTHONY A.DWG ISSUE 26-10-18 ISSUED FOR APPROVAL Α ISSUE DATE REVISIONS SN DRAWN: TITLE DATE: 26/10/2018 **DRAINAGE PLAN** AS NOTED PIPE SCHEDULE SCALE: **ISSUED FOR PIT DETAIL** APPROVAL LEGENDS SHEET 1 DF 3 JOB No: 15755


www.dialbeforeyoudig.com.au



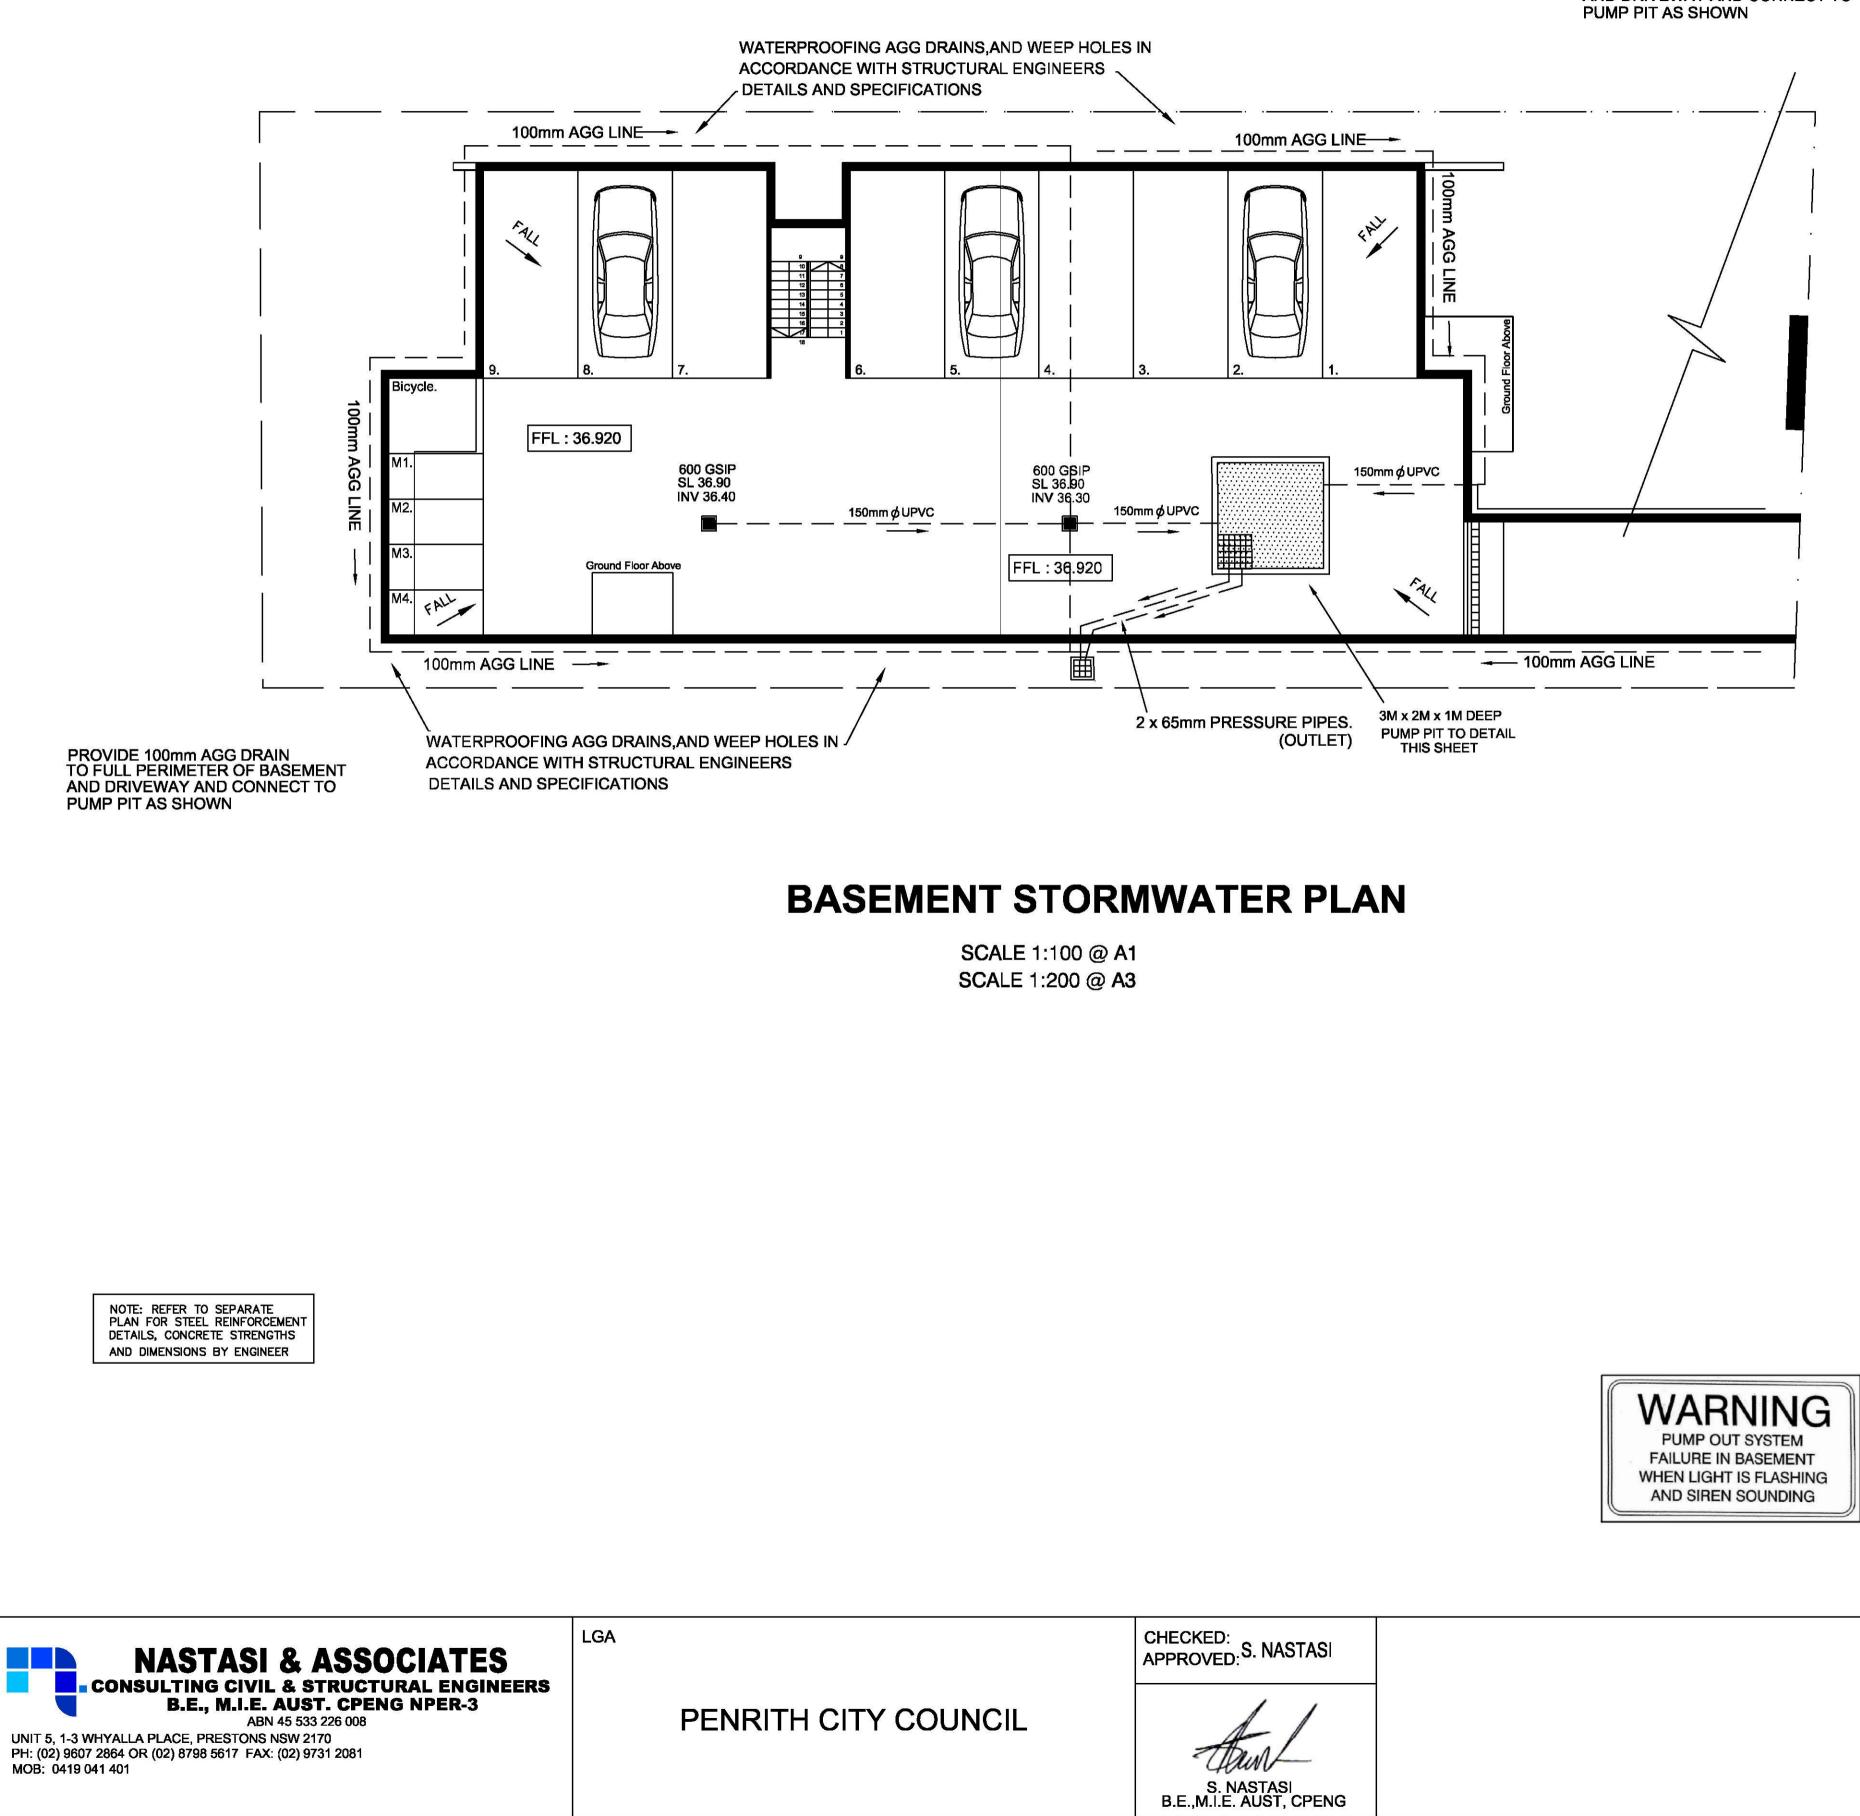

# PROVIDE 100mm AGG DRAIN TO FULL PERIMETER OF BASEMENT AND DRIVEWAY AND CONNECT TO


STORAGE TANK.

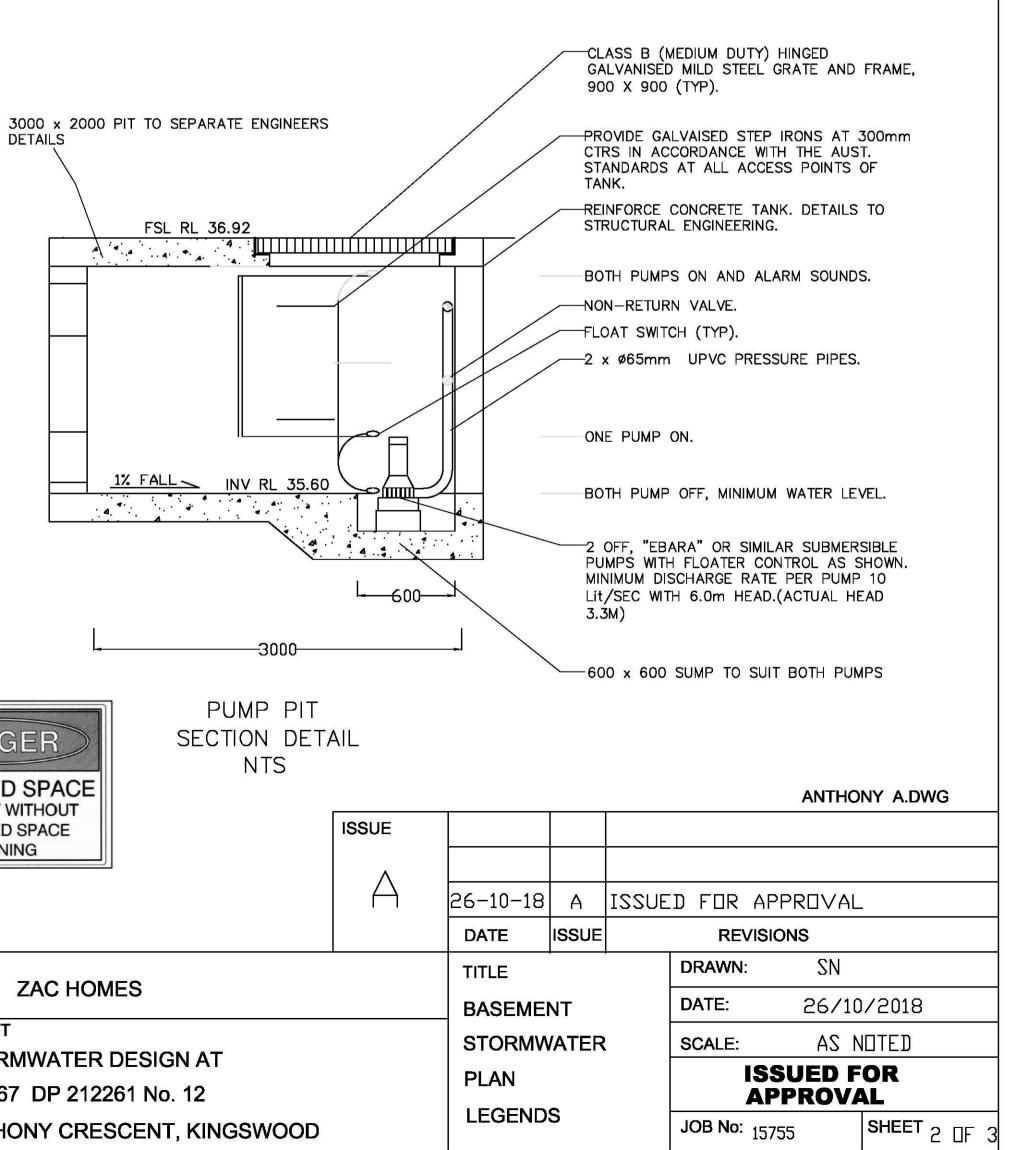



CLIENT

PROJECT STORMWATER DESIGN AT LOT 67 DP 212261 No. 12 ANTHONY CRESCENT, KINGSWOOD

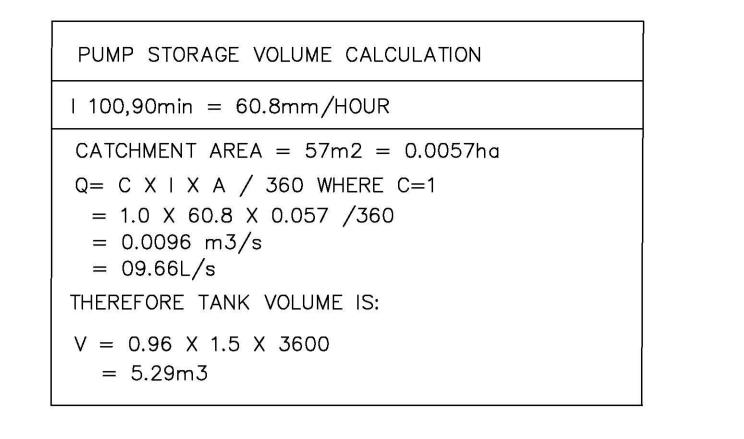


#### STANDARD PUMP OUT DESIGN NOTE:

THE PUMP OUT SYSTEM SHALL BE DESIGNED TO BE OPERATED IN THE FOLLOWING MANNER: 1. THE PUMPS SHALL BE PROGRAMMED TO WORK ALTERNATELY TO ALLOW BOTH PUMPS TO HAVE AN EQUAL OPERATION LOAD AND PUMP LIFE.

2. A FLOAT SHALL BE PROVIDED TO ENSURE THAT THE MINIMUM REQUIRED WATER LEVEL IS MAINTAINED WITHIN THE SUMP AREA OF THE BELOW GROUND TANK. IN THIS REGARD THIS FLOAT WILL FUNCTION AS AN OFF SWITCH FOR THE PUMPS AT THE MINIMUM WATER LEVEL. THE SAME FLOAT SHALL BE SET TO TURN ONE OF THE PUMPS ON UPON THE WATER LEVEL IN THE TANK RISING TO APPROXIMATELY 300mm ABOVE THE MINIMUM WATER LEVEL. THE PUMP SHALL OPERATE UNTIL THE TANK IS DRAINED TO THE MINIMUM WATER LEVEL. 3. A SECOND FLOAT SHALL BE PROVIDED AT A HIGH LEVEL, WHICH IS APPROXIMATELY THE ROOF

LEVEL OF THE BELOW GROUND TANK. THIS FLOAT SHALL START THE OTHER PUMP THAT IS NOT OPERATING AND ACTIVATE THE ALARM.

4. AN ALARM SYSTEM SHALL BE PROVIDED WITH A FLASHING STROBE LIGHT AND PUMP FAILURE WARNING SIGN WHICH ARE TO BE LOCATED AT HE DRIVEWAY ENTRANCE TO THE BASEMENT LEVEL. THE ALARM SYSTEM SHALL BE PROVIDED WITH A BATTERY BACK UP IN CASE OF POWER FAILURE 5. A CONFINED SPACE DANGER SIGN SHALL BE PROVIDED AT ALL ACCESS POINTS TO THE PUMP OUT

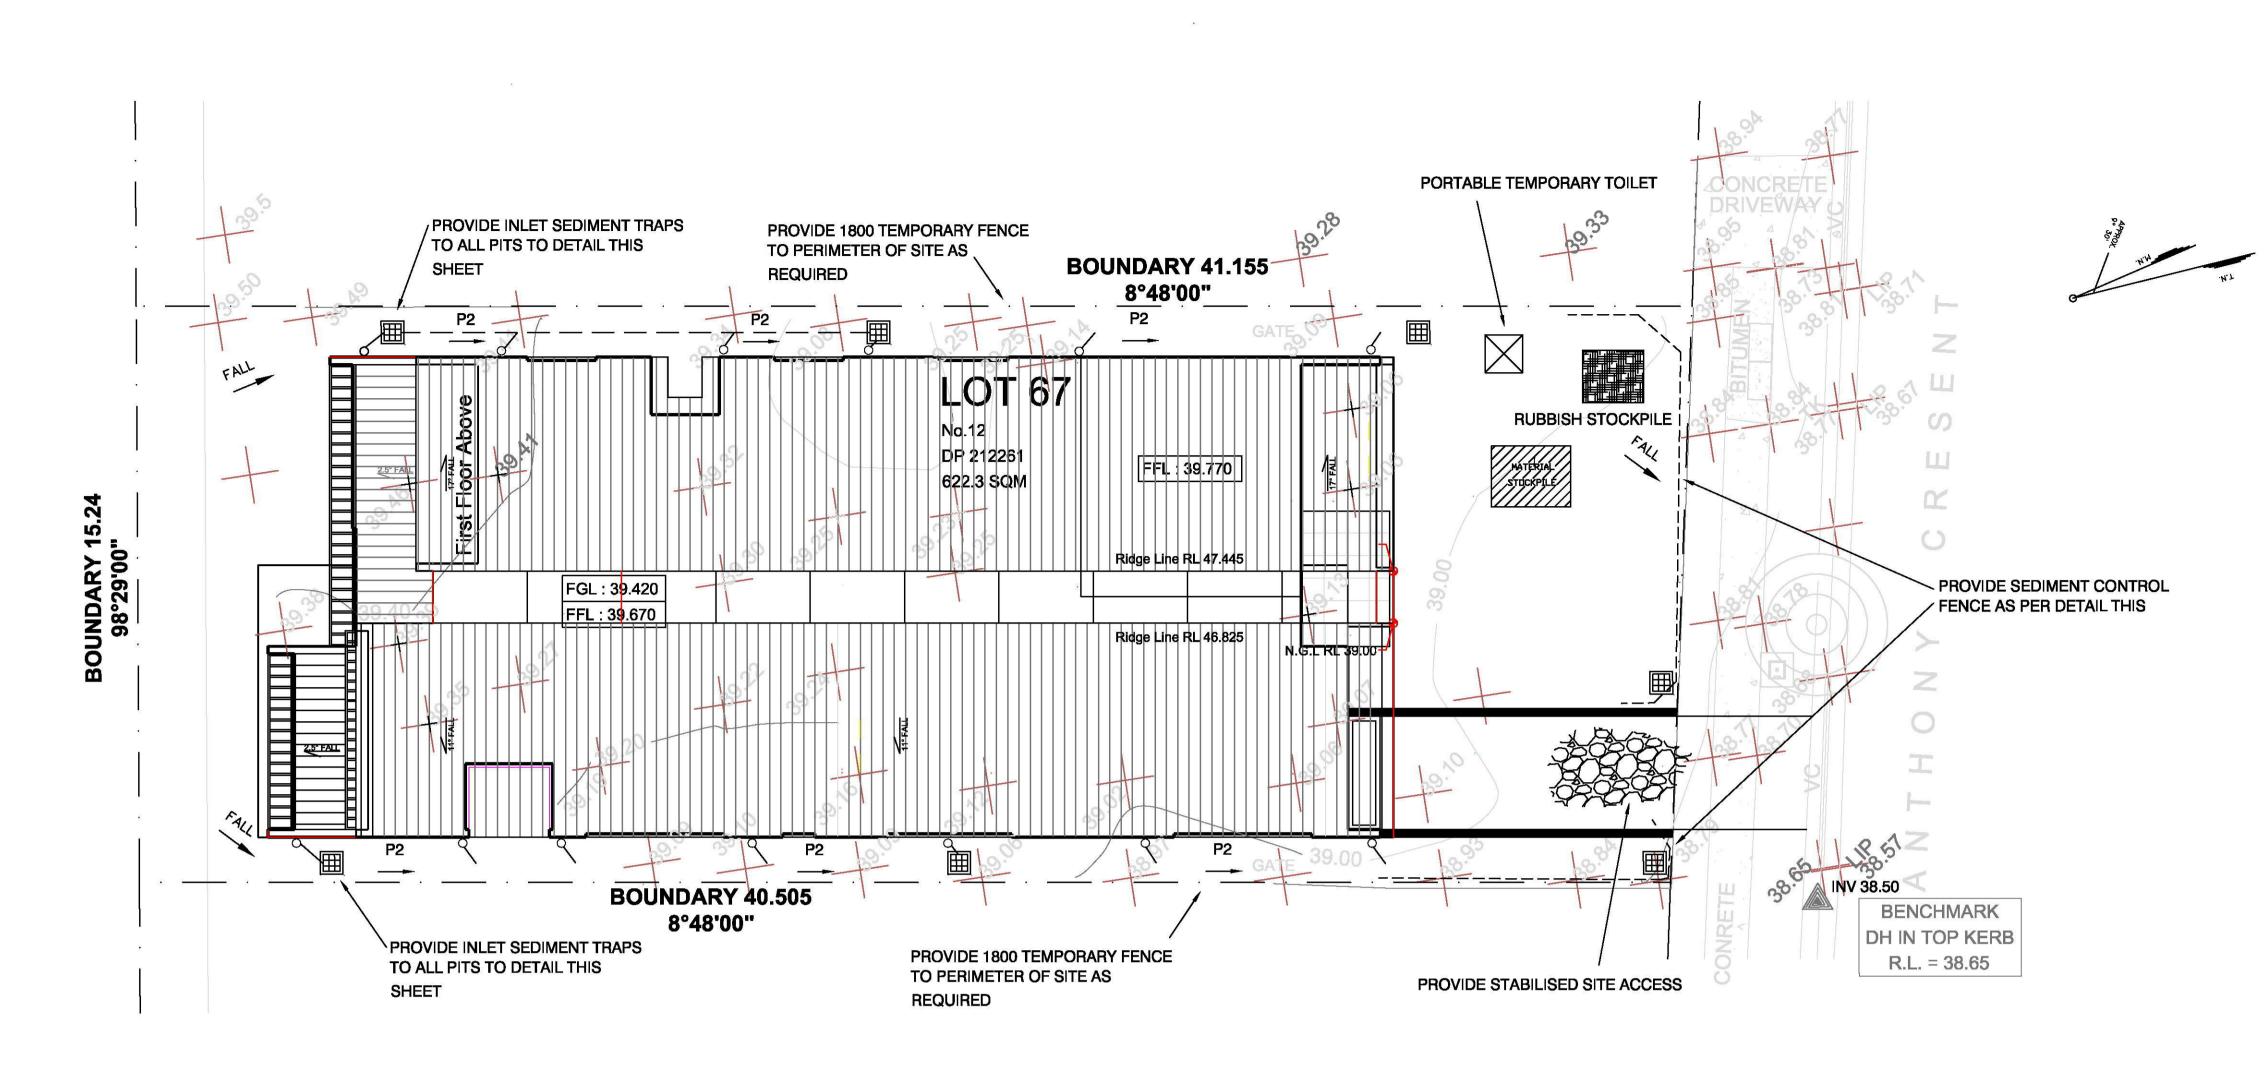






PENRITH COUNCIL


# **SOIL EROSION &** SEDIMENT CONTROL PLAN


SCALE 1:100 @ A1 SCALE 1:200 @ A3

> REFER TO SHEET NO 1 FOR SOIL EROSION AND SEDIMENT CONTROL NOTES

							ANTHOM	NY A.DWG
		ISSUE						
		$\mid A$	26-10-18	А	ISSUE	D FOR APPR		
			DATE	ISSUE		REVISIONS	S	
CHECKED: APPROVED: S. NASTASI	CLIENT ZAC HOMES		TITLE	5. N		DRAWN:	SN	
APPROVED: O. TOTOT			SOIL ERC	SION	&	DATE:	26/10.	/2018
	PROJECT STORMWATER DESIGN AT		SEDIMEN		NTROL	SCALE:	AS NI	JTED
Abunk	LOT 67 DP 212261 No. 12		PLAN				JED FOR	
S NASTASI			DETAILS			40113 606-050422 025-056 00	- 1007 - 1008 - 1008 - 1008 - 1008 - 1008 - 1008 -	84
S. NASTASI B.E.,M.I.E. AUST, CPENG	ANTHONY CRESCENT, KINGSWOOD		PIT DETA	<b>NL</b>		JOB No: 15755		SHEET 3 DF 3

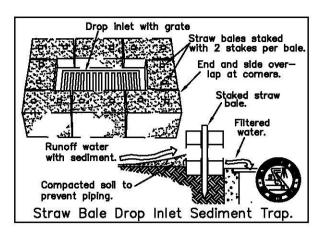

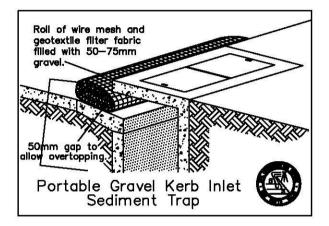

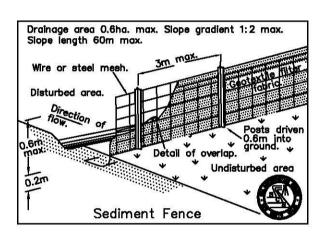

Geotextile filter fabric. Runoff water with sediment.	Stakes	Stakes	Drop inlet with grate.
Buried fabric	Filtered water.	۳. اسلا	
	Geotextile filter fabric.		
Geotextile Inlet Se	Filter Fo ediment	ıbric Dr Trap.	op 🛞