Proposed Mixed Use Development

17-23 Hope Street, Penrith

TRAFFIC AND PARKING ASSESSMENT REPORT

1 September 2021

Ref 21374



Suite 6, 20 Young Street, Neutral Bay NSW 2089 - PO Box 1868, Neutral Bay NSW 2089 Ph: 9904 3224

TABLE OF CONTENTS

1.	INTRODUCTION	1
2.	PROPOSED DEVELOPMENT	4
3.	TRAFFIC ASSESSMENT	8
4.	PARKING ASSESSMENT	15
API	PENDIX A ARCHITECTURAL PLANS	

LIST OF ILLUSTRATIONS

Figure 1 Location Figure 2 Site

APPENDIX B

Figure 3 Road Hierarchy

Figure 4 Existing Traffic Controls

SWEPT TURN PATHS

VARGA TRAFFIC PLANNING PTY LTD

1. INTRODUCTION

This report has been prepared to accompany a development application to Council for a

mixed use development proposal to be located at 17-23 Hope Street, Penrith (Figures 1 and

2).

The proposed development involves the demolition of the four existing dwelling houses on

the site to facilitate the construction of a new mixed use residential/medical/retail

development.

Off-street parking is to be provided in new two-level basement parking area, in accordance

with Council requirements. Vehicular access to the basement parking area is to be provided

via a new driveway located off Hope Street.

The purpose of this report is to assess the traffic and parking implications of the development

proposal and to that end this report:

describes the site and provides details of the development proposal

reviews the road network in the vicinity of the site

reviews the public transport services available in the vicinity of the site

estimates the traffic generation potential of the development proposal

assesses the traffic implications of the development proposal in terms of road network

capacity

reviews the geometric design features of the proposed parking and loading facilities for

compliance with the relevant codes and standards


assesses the adequacy and suitability of the quantum of off-street parking and loading


provided on the site.

1

Document Set ID: 9737408

Version: 1, Version Date: 16/09/2021

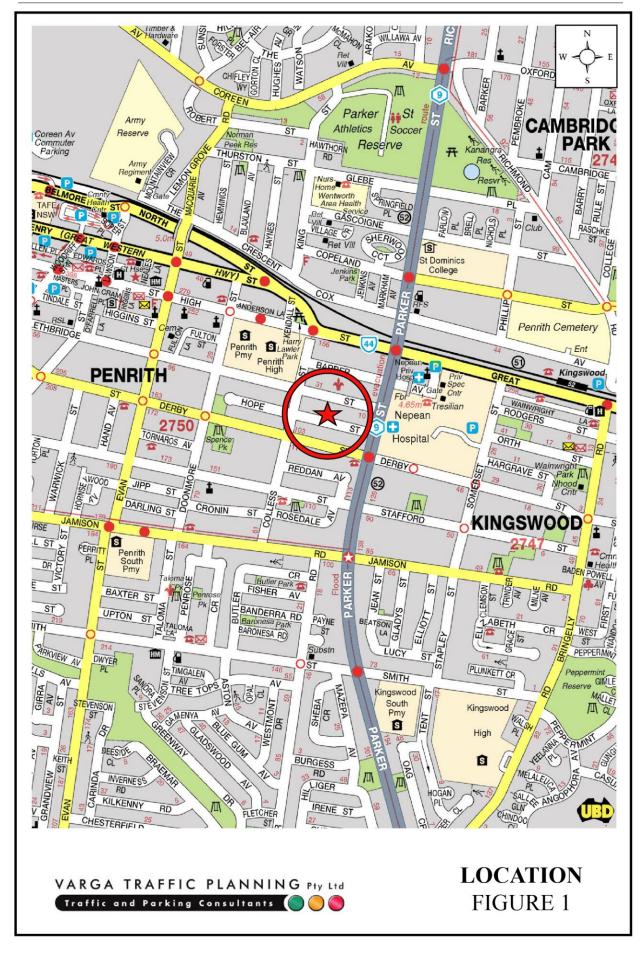

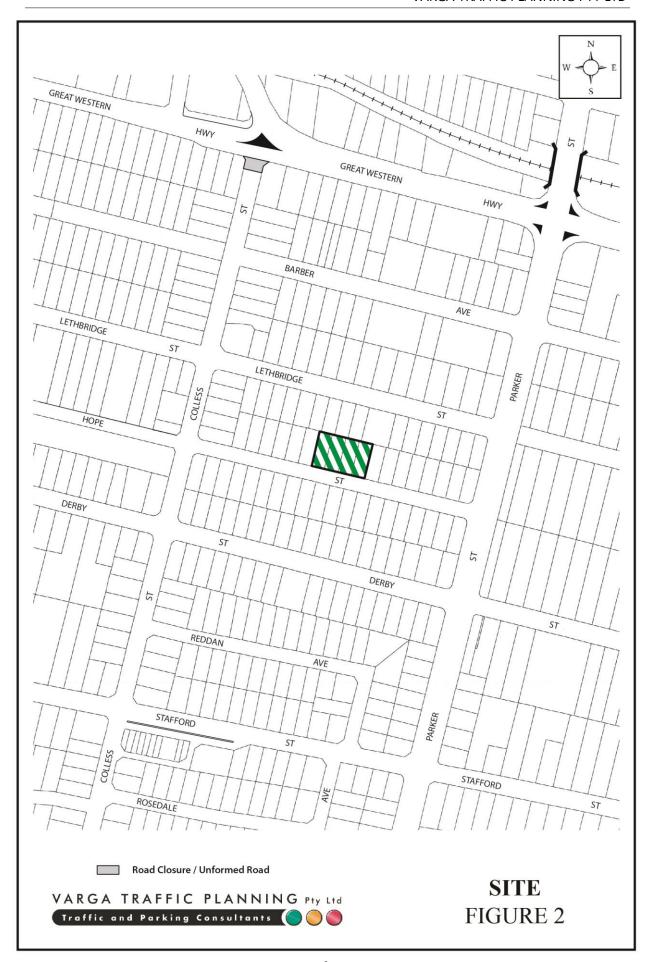

2. PROPOSED DEVELOPMENT

Site

The subject site is located on the northern side of Hope Street, approximately midway in between Parker Street and Colless Street. The site has a street frontage approximately 61m in length to Hope Street and occupies an area of approximately 2,440m².

The site is located approximately 1.4km walking distance to/from Kingswood railway station, and approximately 2km walking distance to/from Penrith railway station and the heart of Penrith town centre.

A recent aerial image of the site and its surroundings is reproduced below.



The subject site is currently occupied by four dwelling houses, all with off-street parking. Vehicular access to the respective sites is provided off Hope Street.

Streetview images at Hope Street site frontage are reproduced on the following pages.







VARGA TRAFFIC PLANNING PTY LTD

Proposed Development

The proposed development involves the demolition of the four existing dwelling houses on

the site to facilitate the construction of a new mixed use residential/medical/retail

development.

A total of 50 residential apartments are proposed in the new building as follows:

1 bedroom apartments:

9

2 bedroom apartments:

36

3 bedroom apartments:

5

TOTAL APARTMENTS:

50

A medical tenancy is also proposed on the western corner of the ground floor level fronting

Hope Street, with a floor area of 199m². The indicative staff comprise 2 health care

professionals and 1 support staff.

A neighbourhood shop is also proposed on the eastern corner of the ground floor level

fronting Hope Street, with a floor area of 120m².

Off-street parking is proposed for a total of 76 cars, comprising 55 residential spaces, 10

visitor spaces (including a shared car wash bay), 7 medical spaces, 4 retail spaces, in a new

two-level basement parking area, in accordance with Council's requirements. Vehicular

access to the parking facilities is to be provided via a new entry/exit driveway located

towards the eastern end of the Hope Street site frontage.

Loading/servicing for the proposed development is expected to be undertaken by a variety of

commercial vehicles up to and including Council's 10.5m long garbage truck, with a

dedicated loading area to be located in the north-eastern corner of the site. The proposed

loading area includes a turntable, thereby allowing all trucks to enter and exit the site in a

forward direction at all times. Vehicular access to the loading area is to be provided via a new

entry/exit driveway located at the eastern end of the Hope Street site frontage, adjacent to the

abovementioned driveway.

6

Plans of the proposed development have been prepared by *Urban Link* and are reproduced in Appendix A.

VARGA TRAFFIC PLANNING PTY LTD

3. TRAFFIC ASSESSMENT

Road Hierarchy

The road hierarchy allocated to the road network in the vicinity of the site by the Roads and

Maritime Services is illustrated on Figure 3.

Great Western Highway is classified by the RMS as a State Road and provides the key east-

west road link in the area, linking Parramatta to Emu Plains. It typically carries three traffic

lanes in each direction in the vicinity of the site, with opposing traffic flows separated by a

central median island and turning bays provided at key locations.

Parker Street/The Northern Road are also classified by the RMS as a State Roads and provide

the key north-south road link in the area, linking Bligh Park to Narellan. It typically carries

three traffic lanes in each direction in the vicinity of the site, with opposing traffic flows

separated by a central median island and turning bays provided at key locations.

Jamison Road (west of Parker Street) is classified by the RMS as a Regional Road and

provides a secondary east-west road link through the local area between Parker Street and

Mulgoa Road. It typically carries two traffic lanes in each direction in the vicinity of the site

with kerbside parking permitted at selected locations.

Hope Street is a local, unclassified road which is primarily used to provide vehicular and

pedestrian access to frontage properties. Kerbside parking is generally permitted on both

sides of the road, subject to signposted restrictions.

Existing Traffic Controls

The existing traffic controls which apply to the road network in the vicinity of the site are


illustrated on Figure 4. Key features of those traffic controls are:

a 70 km/h SPEED LIMIT which applies to Parker Street

8

Document Set ID: 9737408

Version: 1, Version Date: 16/09/2021

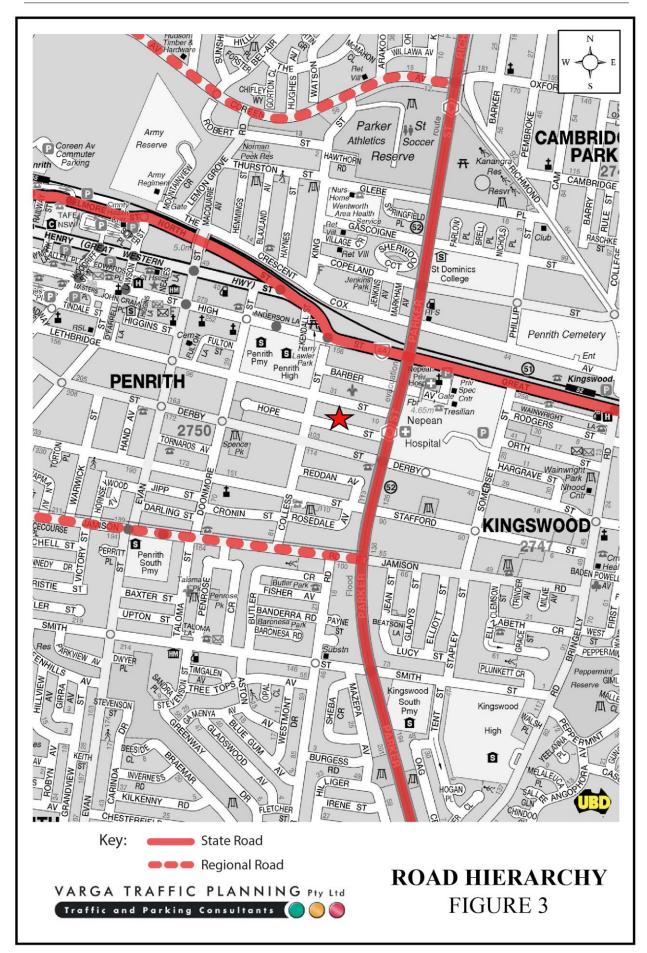



a 60 km/h SPEED LIMIT which applies to High Street and the Great Western Highway

within the vicinity of the site

a 50 km/h SPEED LIMIT which applies to Hope Street and all other local roads in the

area

• a 40 km/h SCHOOL SPEED ZONE which applies within the vicinity of Penrith Public

School and Penrith High School

• GIVE WAY SIGNS in Hope Street where it intersects with Parker Street and Colless

Street

■ TRAFFIC SIGNALS in Parker Street where it intersects with the Great Western

Highway and Derby Street

• a CENTRAL MEDIAN ISLAND in Parker Street which precludes right turn

movements into and out of Hope Street.

Existing Public Transport

The existing public transport services available in the vicinity of the site are illustrated on the

following page. There are 6 bus services which operate within the vicinity of the site,

comprising:

• Route 677: Richmond to Penrith via Londonderry

Route 774: Mount Druitt to Penrith via Nepean Hospital

• Route 775: Mount Druitt to Penrith via Erskine Park

Route 776: Mount Druitt to Penrith via St Clair

Route 780: Mount Druitt to Penrith via Ropes Crossing


• Route 789: Luddenham to Penrith

Kingswood railway station is located approximately 1.4km walking distance east of the site

and Penrith railway station is located approximately 2km walking distance north-west of the

site. Both situated on the T1 Western Line, operating between Emu Plains to the City.

11

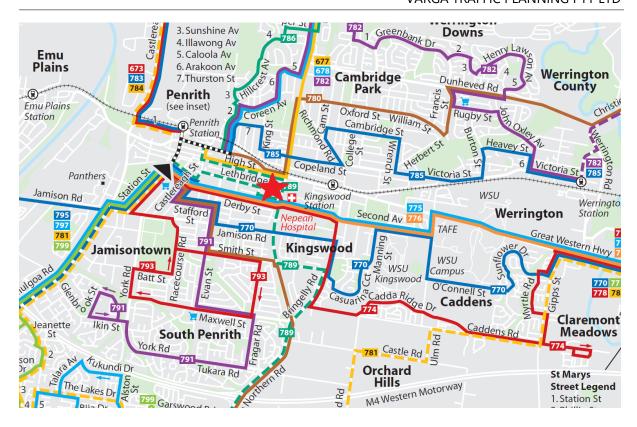

Projected Traffic Generation

The traffic implications of development proposals primarily concern the effects of the *additional* traffic flows generated as a result of a development and its impact on the operational performance of the adjacent road network.

An indication of the traffic generation potential of the development proposal is provided by reference to the Roads and Maritime Services publication *Guide to Traffic Generating Developments, Section 3 - Landuse Traffic Generation (October 2002)* and the updated traffic generation rates in the recently published RMS *Technical Direction* (TDT 2013/04a) document.

The *TDT 2013/04a* document states that it replaces those sections of the RMS *Guidelines* indicated, and must be followed when RMS is undertaking trip generation and/or parking demand assessments.

The RMS *Guidelines* and the updated TDT 2013/04a are based on extensive surveys of a wide range of land uses and nominate the following traffic generation rates which are applicable to the residential development proposal:

VARGA TRAFFIC PLANNING PTY LTD

High Density Residential Flat Dwellings

AM: 0.19 peak hour vehicle trips per unit

PM: 0.15 peak hour vehicle trips per unit

The RMS Guidelines also make the following observation in respect of high density

residential flat buildings:

Definition

A high density residential flat building refers to a building containing 20 or more dwellings. This does

not include aged or disabled persons housing. High density residential flat buildings are usually more

than 5 levels, have basement level car parking and are located in close proximity to public transport

services. The building may contain a component of commercial use.

Factors

The above rates include visitors, staff, service/delivery and on-street movements such as taxis and pick-

up/set-down activities.

However, the RMS *Guidelines* and the *TDT 2013/04a* does not nominate a traffic generation

rate for specialised medical clinics, referring only to conventional extended hours medical

centres, or for small, local shops, referring only to major regional shopping centres

incorporating supermarkets and department stores. For the purposes of this assessment, the

traffic generation rate nominated in the TDT 2013/04a for "office blocks" has been adopted

in respect of the medical and retail components of the development proposal.

Office Blocks

AM Peak – 1.6 peak hour vehicle trips per 100m² GFA

PM Peak – 1.2 peak hour vehicle trips per 100m² GFA

Application of the above traffic generation rates to the various components of the

development proposal yields a traffic generation potential of approximately 15 vehicle trips

per hour (vph) during the weekday AM peak period and approximately 11 vph during the

weekday PM peak period, as set out on the following page:

13

Projected Future Traffic Generation Potential

	AM	PM
Residential (50 apartments):	9.5 vph	7.5 vph
Medical tenancy (199m²):	3.2 vph	2.4 vph
Neighbourhood Shop (120m²):	1.9 vph	1.4 vph
TOTAL TRAFFIC GENERATION POTENTIAL:	14.6 vph	11.3 vph

That projected future level of traffic generation potential should however, be offset or *discounted* by the volume of traffic which could reasonably be expected to be generated by the existing uses of the site, in order to determine the *nett increase* (or decrease) in traffic generation potential expected to occur as a consequence of the current development proposal.

The *TDT 2013/04a* nominates the following traffic generation rates which are applicable to the existing development:

Low Density Residential Dwellings

AM: 0.95 peak hour vehicle trips per dwellingPM: 0.99 peak hour vehicle trips per dwelling

Application of the above traffic generation rates to the four existing dwelling houses on the site yields a traffic generation potential of approximately 4 vph during both the AM and PM commuter peak periods.

Accordingly, it is likely that the proposed development will result in a *nett increase* in the traffic generation potential of the site of approximately 11 vph during the AM commuter peak period and approximately 7 vph during the PM commuter peak period, as set out below:

Projected Nett Increase in Peak Hour Traffic Generation Potential of the site as a consequence of the development proposal

	AM	PM
Projected Future Traffic Generation Potential:	14.6 vph	11.3 vph
Less Existing Traffic Generation Potential:	-3.8 vph	-4.0 vph
NETT INCREASE IN TRAFFIC GENERATION POTENTIAL:	10.8 vph	7.3 vph

In any event, that projected level of traffic generation potential of the site as a consequence of the development proposal is minimal, consistent with the zoning objectives of the site and will clearly not have any unacceptable traffic implications in terms of road network capacity.

4. PARKING IMPLICATIONS

Existing Kerbside Parking Restrictions

Given the residential nature of Hope Street and the surrounding area, there are generally no kerbside parking restrictions which apply in the vicinity of the site, including along the site frontage. Excluding the small section directly outside of 25-31 Hope Street which is 'No Parking – Waste Collection and Removalist Vehicles Excepted.'

Off-Street Parking Provisions

The off-street car parking requirements applicable to the development proposal are specified in *Penrith Development Control Plan 2014, C10 Transport Access and Parking* document in the following terms:

Residential Flat Buildings

bedroom apartment:
 space per dwelling
 bedroom apartment:
 space per dwelling
 bedroom apartment:
 spaces per dwelling
 Visitors:
 space per 5 dwellings

Service Bay: 1 space for every 40 dwellings
Carwash Bay: 1 space for every 50 dwellings

Medical Centres

3 spaces per health care professional practising at any one time, plus

1 space per receptionist/support staff

Neighbourhood Shops

1 space per 30m²

Application of the above parking requirements to the various components outlined in the development proposal yields an off-street parking requirement of 73 parking spaces as set out on the following page:

15

Residents (50 apartments): 55 spaces
Visitors: 10 spaces
Medical Centre (1 health care professional + 1 support staff): 4 spaces
Neighbourhood Shop (120m²): 4 spaces
TOTAL: 73 spaces

The proposed development makes provision for a total of 76 off-street car parking spaces, comprising 55 residential spaces, 10 visitor spaces (including a shared car was bay), 7 medical centre spaces and 4 retail spaces, thereby satisfying Council's *DCP 2014* parking requirements.

The geometric design layout of the proposed car parking facilities has been designed to comply with the relevant requirements specified in the Standards Australia publication *Parking Facilities Part 1 - Off-Street Car Parking AS2890.1:2004* in respect of parking bay dimensions, ramp grades and aisle widths.

Driver Sight Distance/Visibility

The driver sight distance/visibility requirements applicable to the proposed vehicular access driveway have been designed to comply with Figure 3.2 – Sight Distance requirements at Access Driveways and also Figure 3.3 – Minimum Sight Lines for Pedestrian Safety in AS2890.1.

In this regard, 2.5m x 2.0m visibility splays are provided on the exit side of the site entry/exit basement driveway towards the eastern end of the front boundary, and on the entry and exit side of the service driveway at the eastern end of the front boundary.

Loading/Servicing Provisions

The proposed new mixed-use building is expected to be serviced by a variety of commercial vehicles up to and including Council's 10.5m long garbage truck. A loading area to be located in the north-eastern corner of the site, designed with a mechanical turntable. The manoeuvring area has been designed to accommodate the swept turning path requirements of these 10.5m long rigid trucks, allowing them to enter and exit the site in a forward direction at all times, as reproduced in Appendix B.

16

In summary, the proposed parking and loading facilities satisfy the relevant requirements specified in both Council's *DCP 2014* as well as the Australian Standards and it is therefore concluded that the proposed development will not have any unacceptable parking or loading implications.

17

APPENDIX A

ARCHITECTURAL PLANS




Copyright URBAN LINK PTY LTD ©

1. CONTRACTOR MUST VERIFY ALL DIMENSIONS ON SITE BEFORE COMMENCING WORK OR PREPARING SHOP DRAWINGS.

2. DO NOT SCALE DRAWINGS.

3. CONTRACTOR TO CHECK UNDERGROUND SERVICES BEFORE COMMENCING WORKS BY CONTACTING DIAL BEFORE YOU DIG. IF DIAL BEFORE YOU DIG INFORMATION IS PROVIDED WITH THIS DOCUMENTATION IT SHALL BE ASSUMED NOT TO BE CURRENT AND CONTRACTOR SHALL MAKE THEIR OWN ENQUIRES.

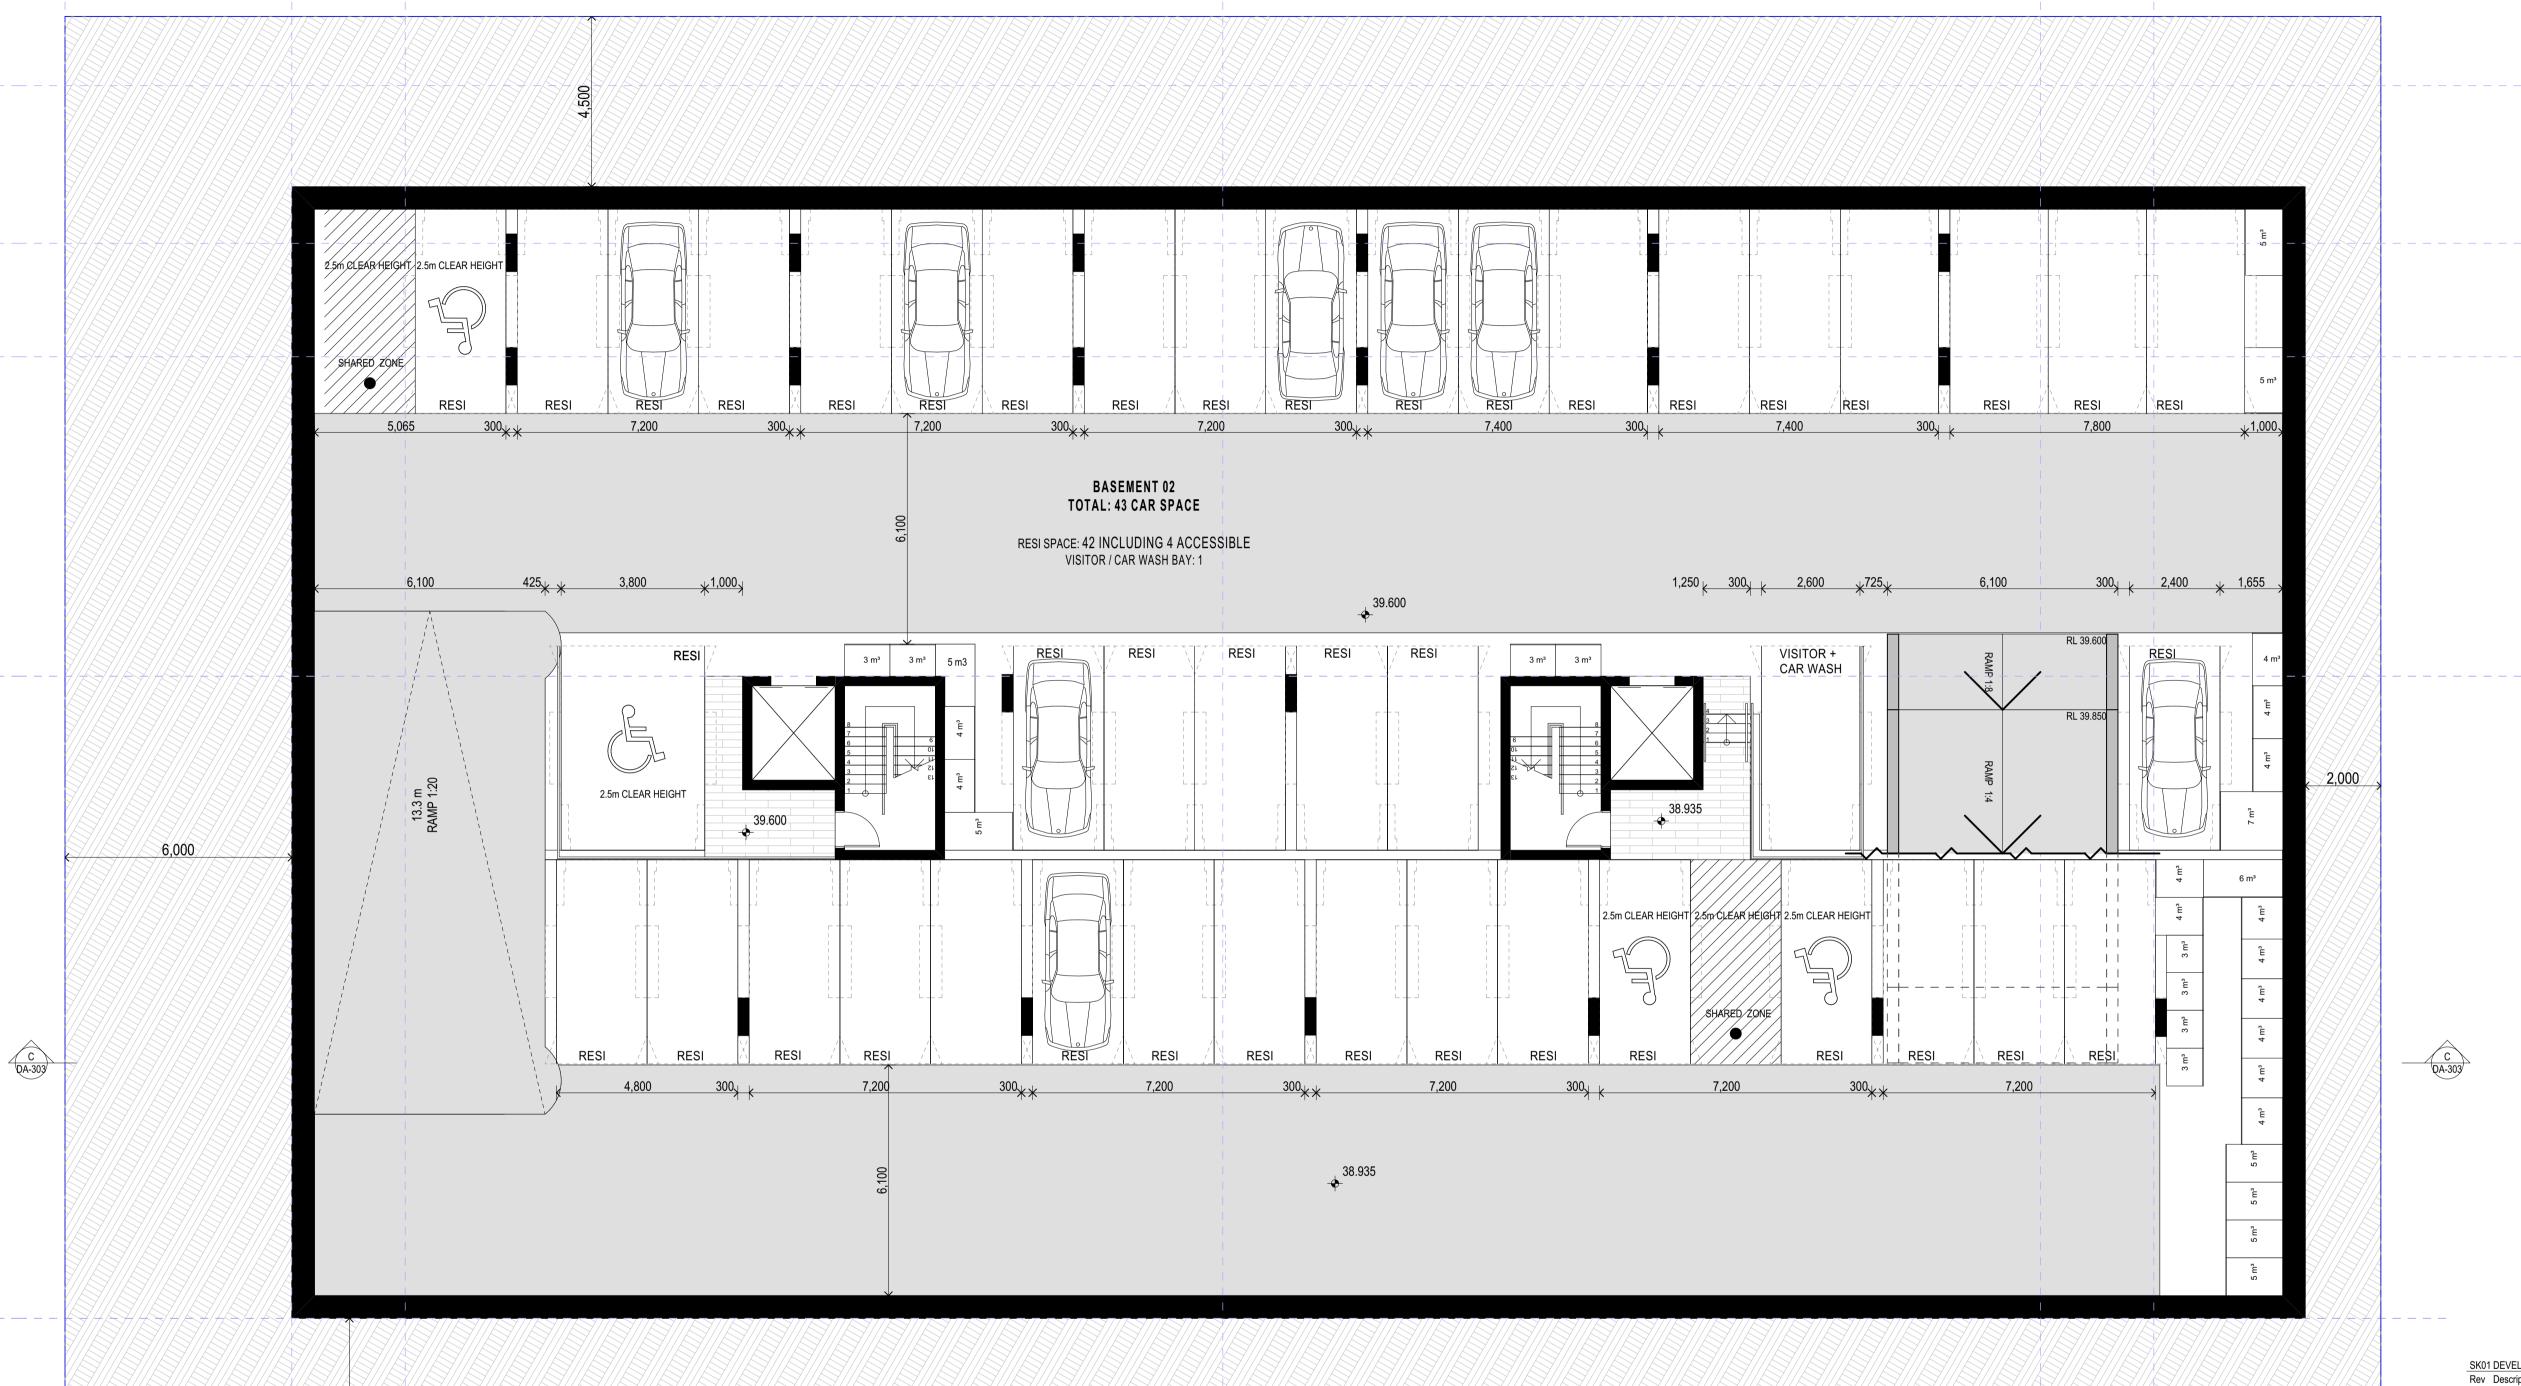

SK01 DEVELOPMENT APPLICATION
Rev Description

17 - 23 Hope St Penrith MIXED USE MULTI RESIDENTIAL

17-23 Hope St Sydney NSW 2750 Australia

URBAN ET LINK
Business Address: Level 10, 11-15 Deane Street, Burwood NSW 21

Postal Address: PO BOX 2223 Burwood North NSW 2134
Phone Number: +61 2 9745 2014
Nominated Architects:
Ziad Boumelhem Reg no 8008
Youssef El Khawaja Reg no 8933

Drawing Title
FLOOR PLANS
BASEMENT 02

Scale
1:100 @A1 Sheet Size



Project Number
2021-011
Status


DEVELOPMENT APPLICATION

BASEMENT 02
SCALE 1:100



Copyright URBAN LINK PTY LTD ©

1. CONTRACTOR MUST VERIFY ALL DIMENSIONS ON SITE BEFORE COMMENCING WORK OR PREPARING SHOP DRAWINGS. 2. DO NOT SCALE DRAWINGS.
3. CONTRACTOR TO CHECK UNDERGROUND SERVICES
BEFORE COMMENCING WORKS BY CONTACTING DIAL BEFORE YOU DIG. IF DIAL BEFORE YOU DIG INFORMATION IS ASSUMED NOT TO BE CURRENT AND CONTRACTOR SHALL MAKE THEIR OWN ENQUIRES.

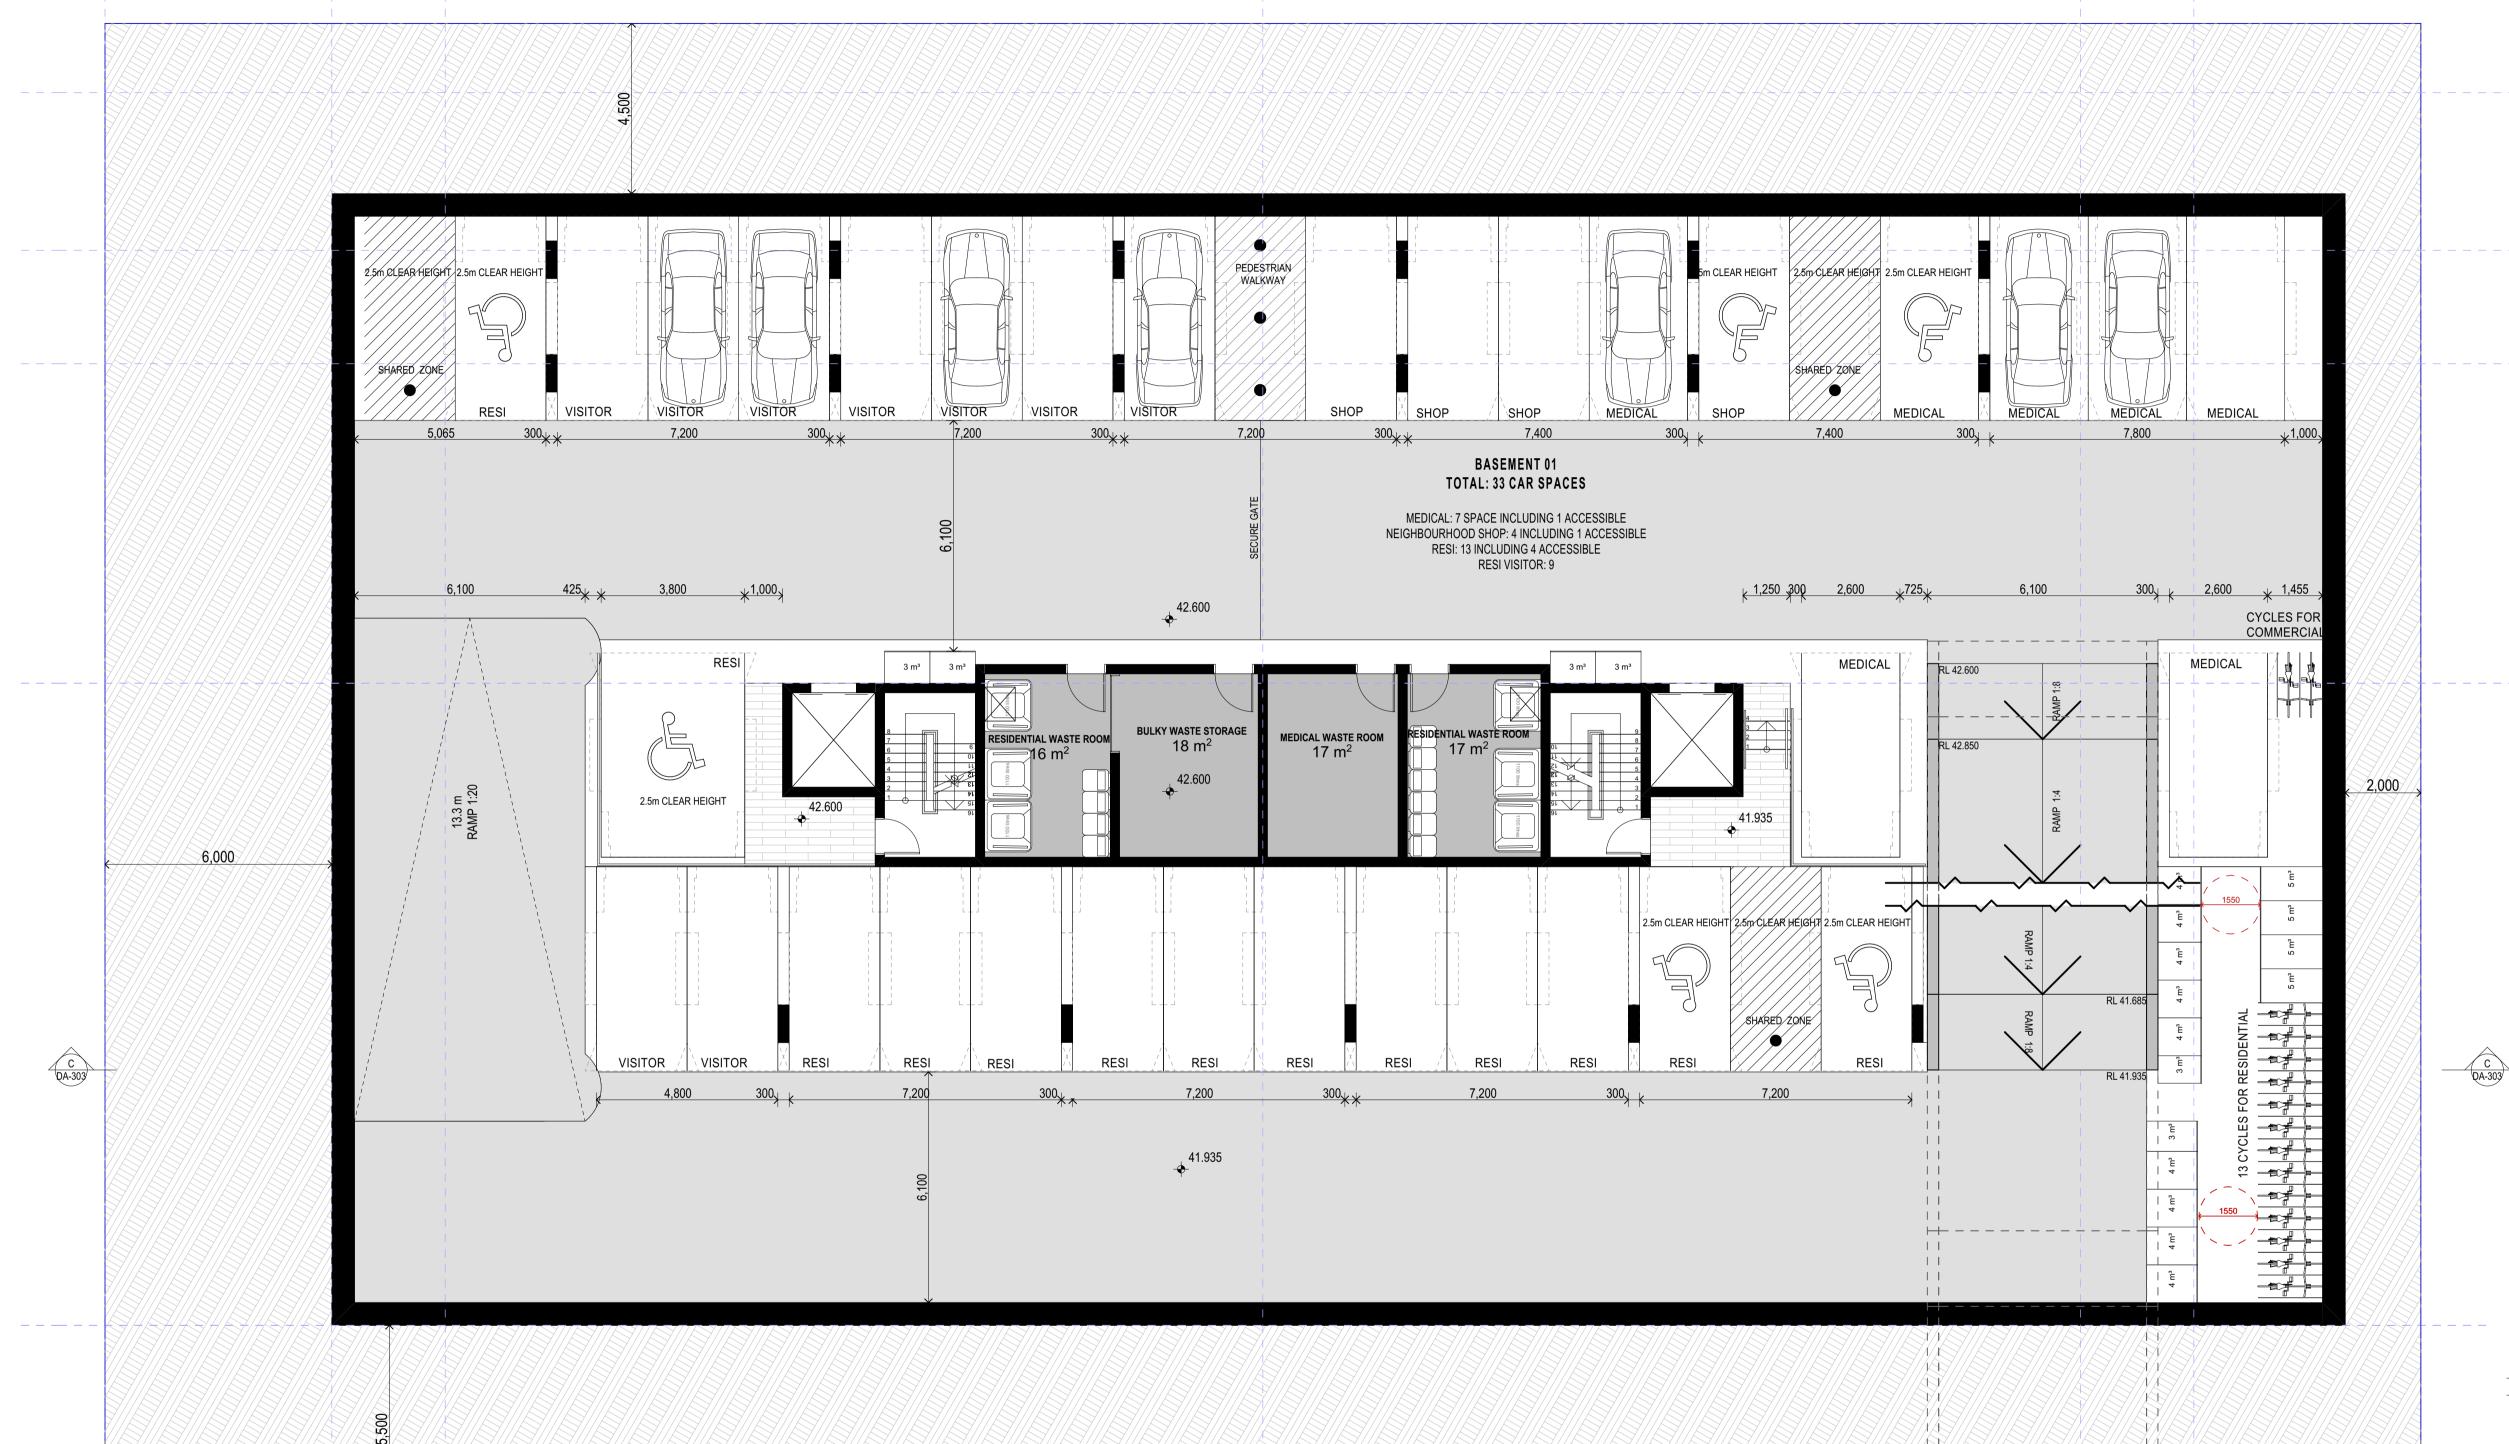

SK01 DEVELOPMENT APPLICATION
Rev Description

17 - 23 Hope St Penrith MIXED USE MULTI RESIDENTIAL

17-23 Hope St Sydney NSW 2750 Australia

F/V.E

71/15


TVAS

Postal Address: PO BOX 2223 Burwood North NSW 2134
Phone Number: +61 2 9745 2014
Nominated Architects:
Ziad Boumelhem Reg no 8008
Youssef El Khawaja Reg no 8933

Drawing Title
FLOOR PLANS BASEMENT 01

1:100 @A1 Sheet Size


Project Number

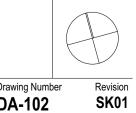


27.07.2021 GJ Date App'd

Drawing Number **DA-102** 2021-011

DEVELOPMENT APPLICATION

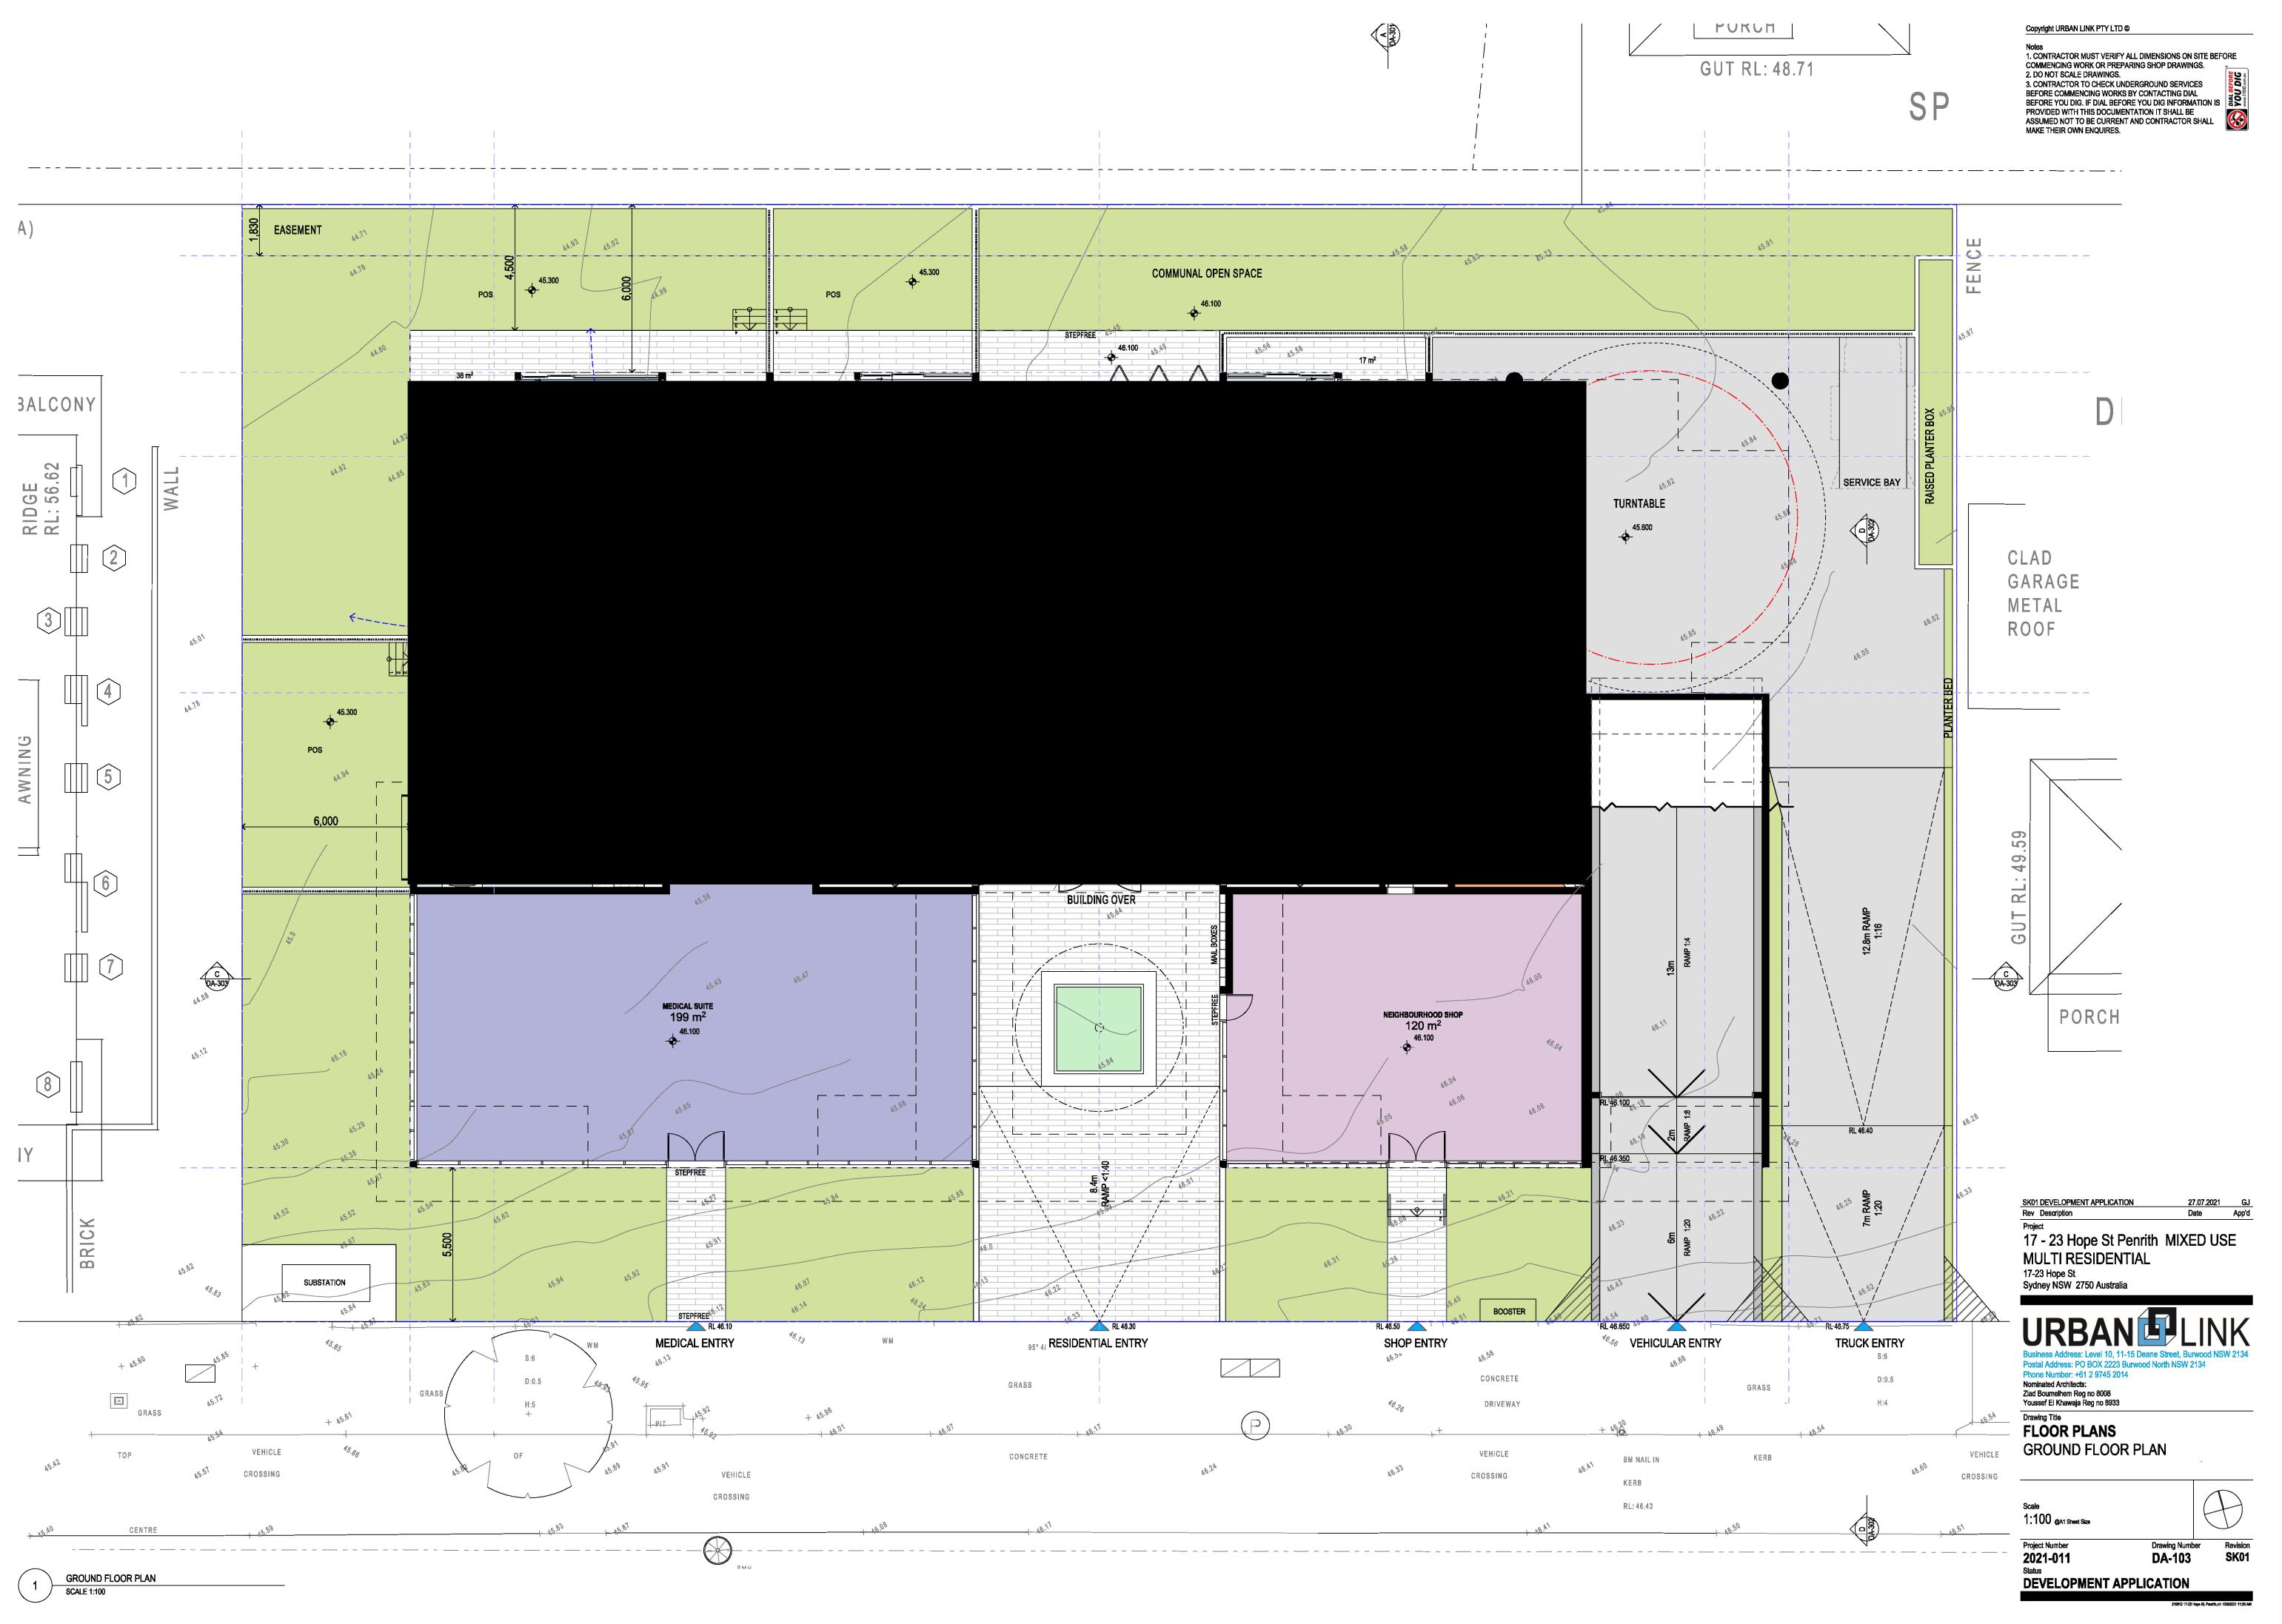

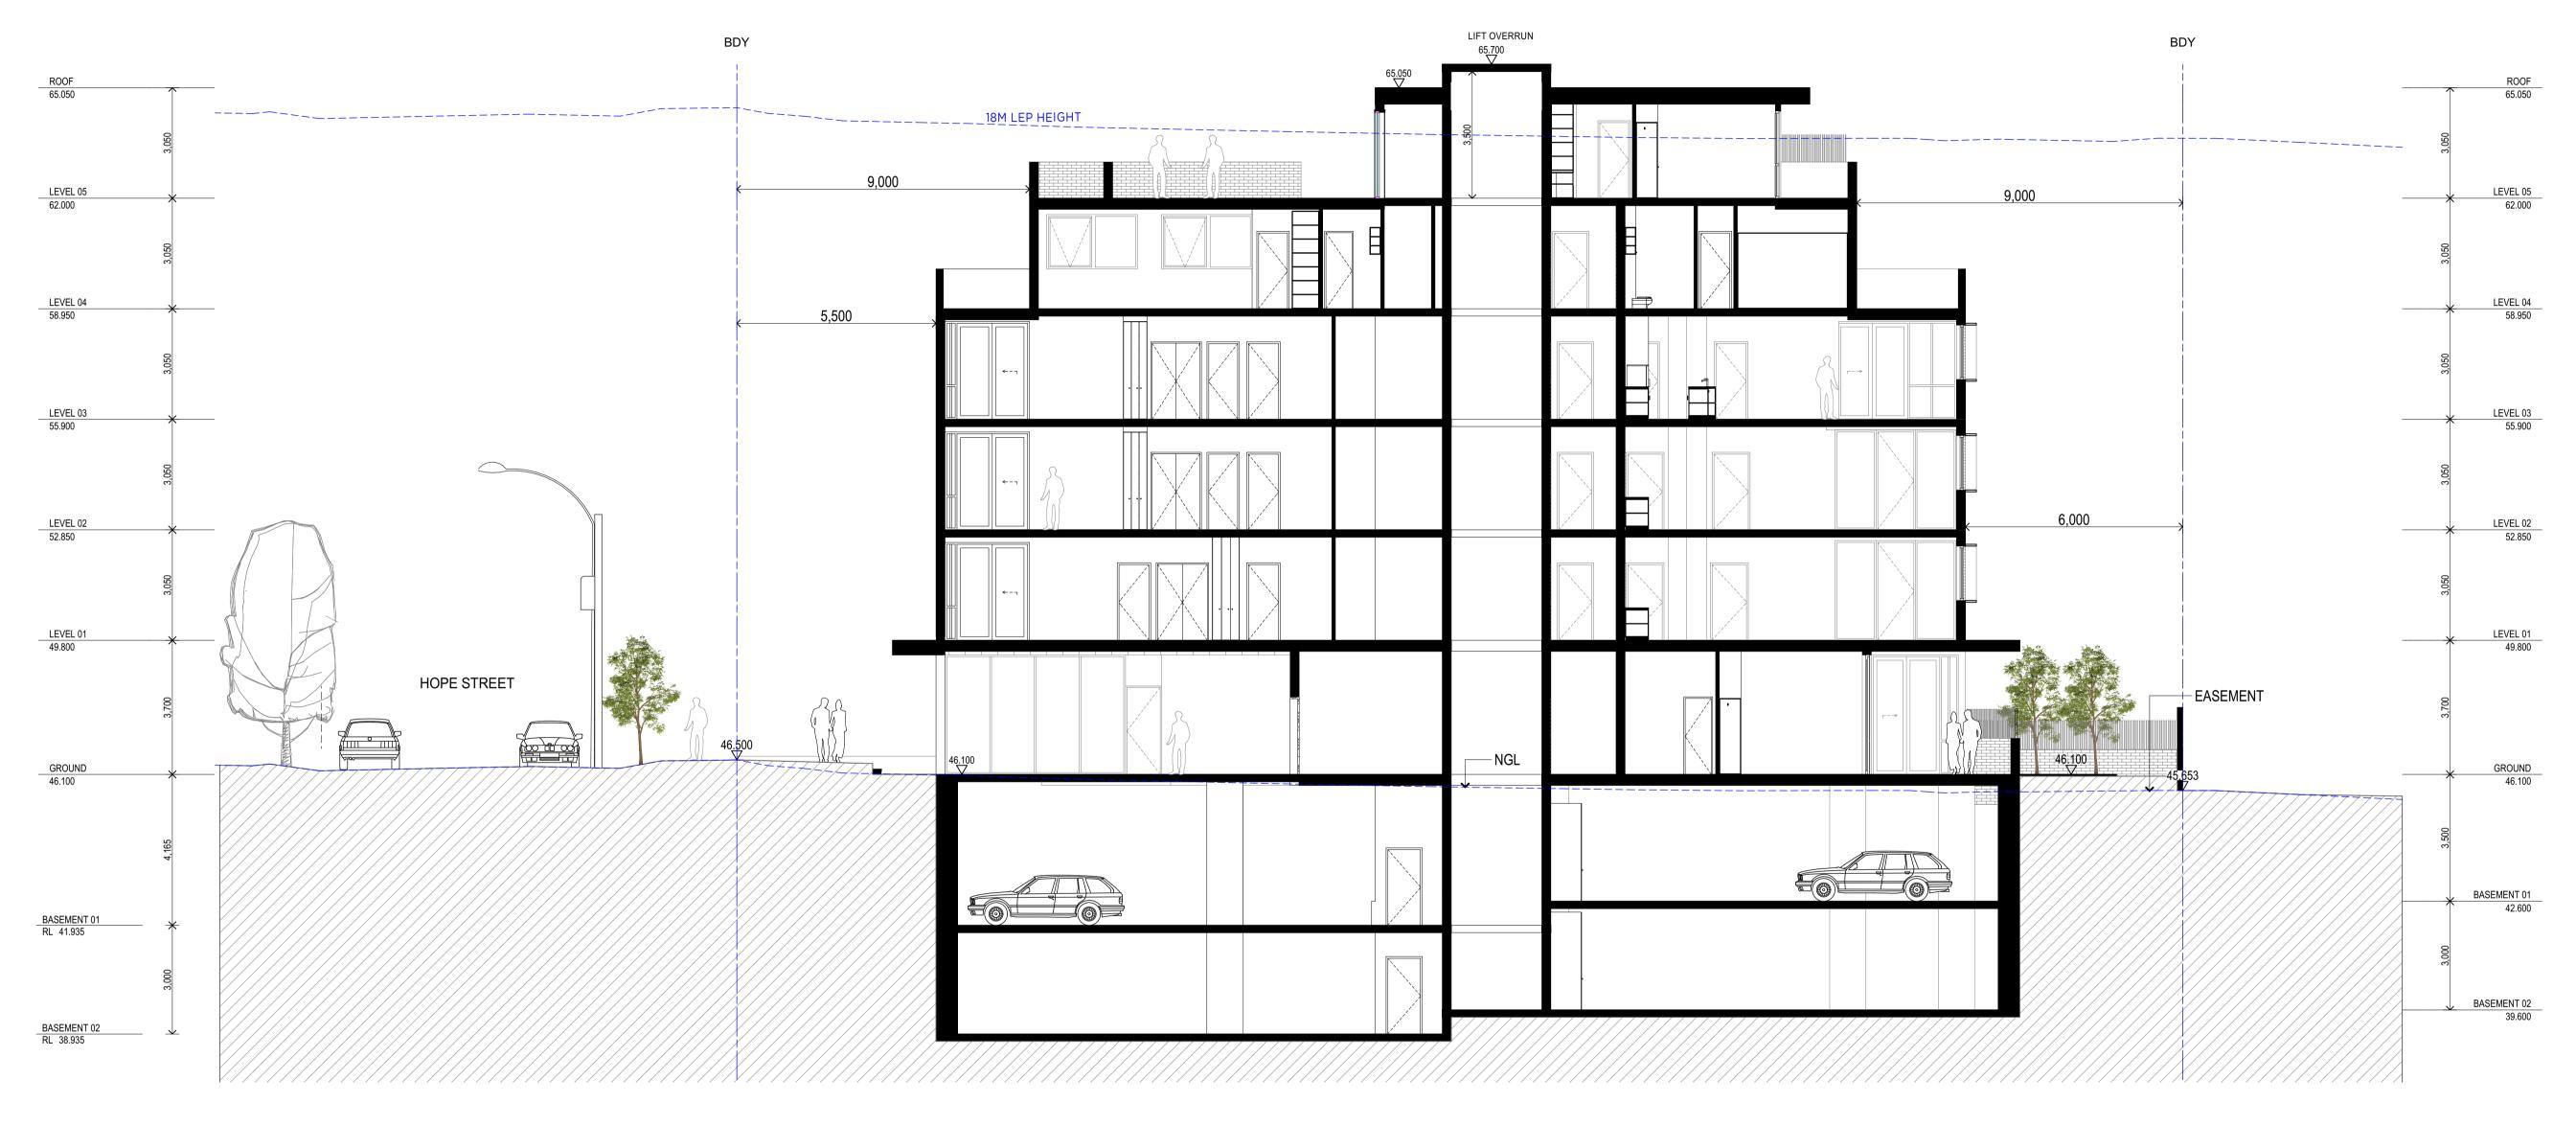

SK01 DEVELOPMENT APPLICATION
Rev Description

17 - 23 Hope St Penrith MIXED USE MULTI RESIDENTIAL


17-23 Hope St Penrith NSW Australia

Postal Address: PO BOX 2223 Burwood North NSW 2134
Phone Number: +61 2 9745 2014
Nominated Architects:
Ziad Boumelhem Reg no 8008
Youssef El Khawaja Reg no 8933

Drawing Title
SECTIONS


SECTION A

1:100 @A1 Sheet Size

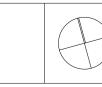

Project Number Drawing Number **DA-301** 2021-011

DEVELOPMENT APPLICATION

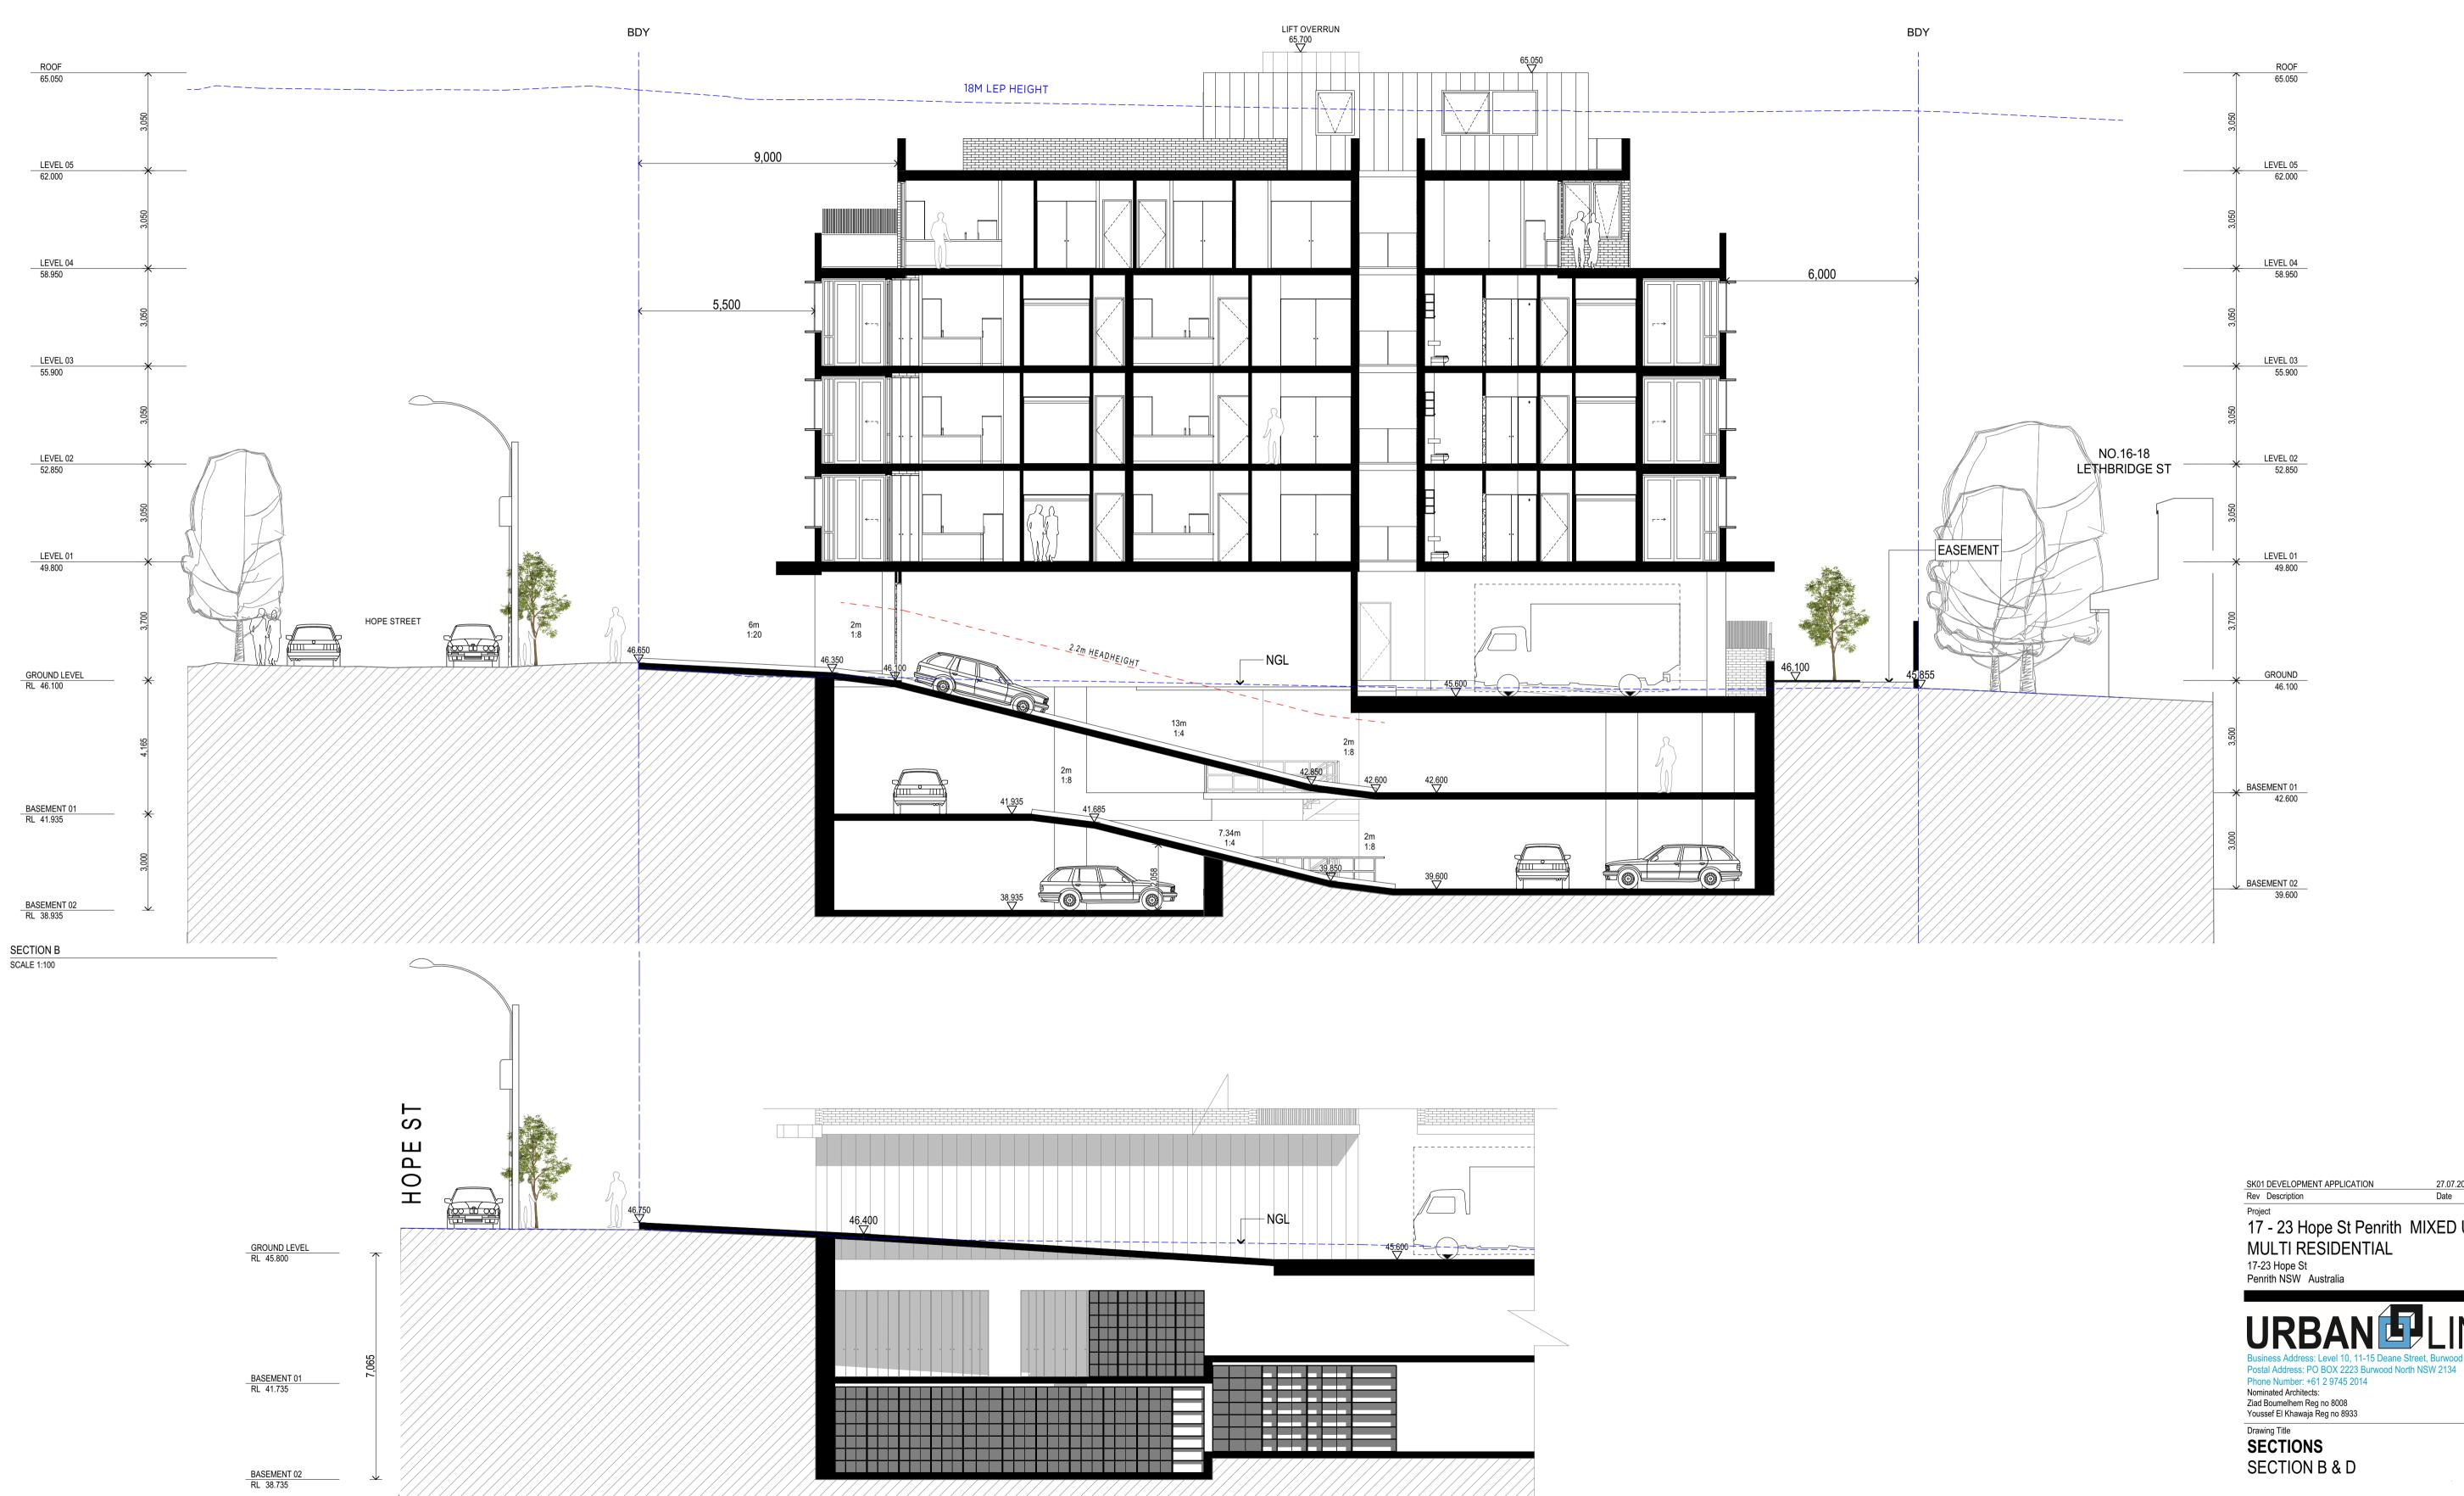


17 - 23 Hope St Penrith MIXED USE MULTI RESIDENTIAL

1:100 @A1 Sheet Size

Project Number

Drawing Number **DA-302** 2021-011

SECTION B SCALE 1:100

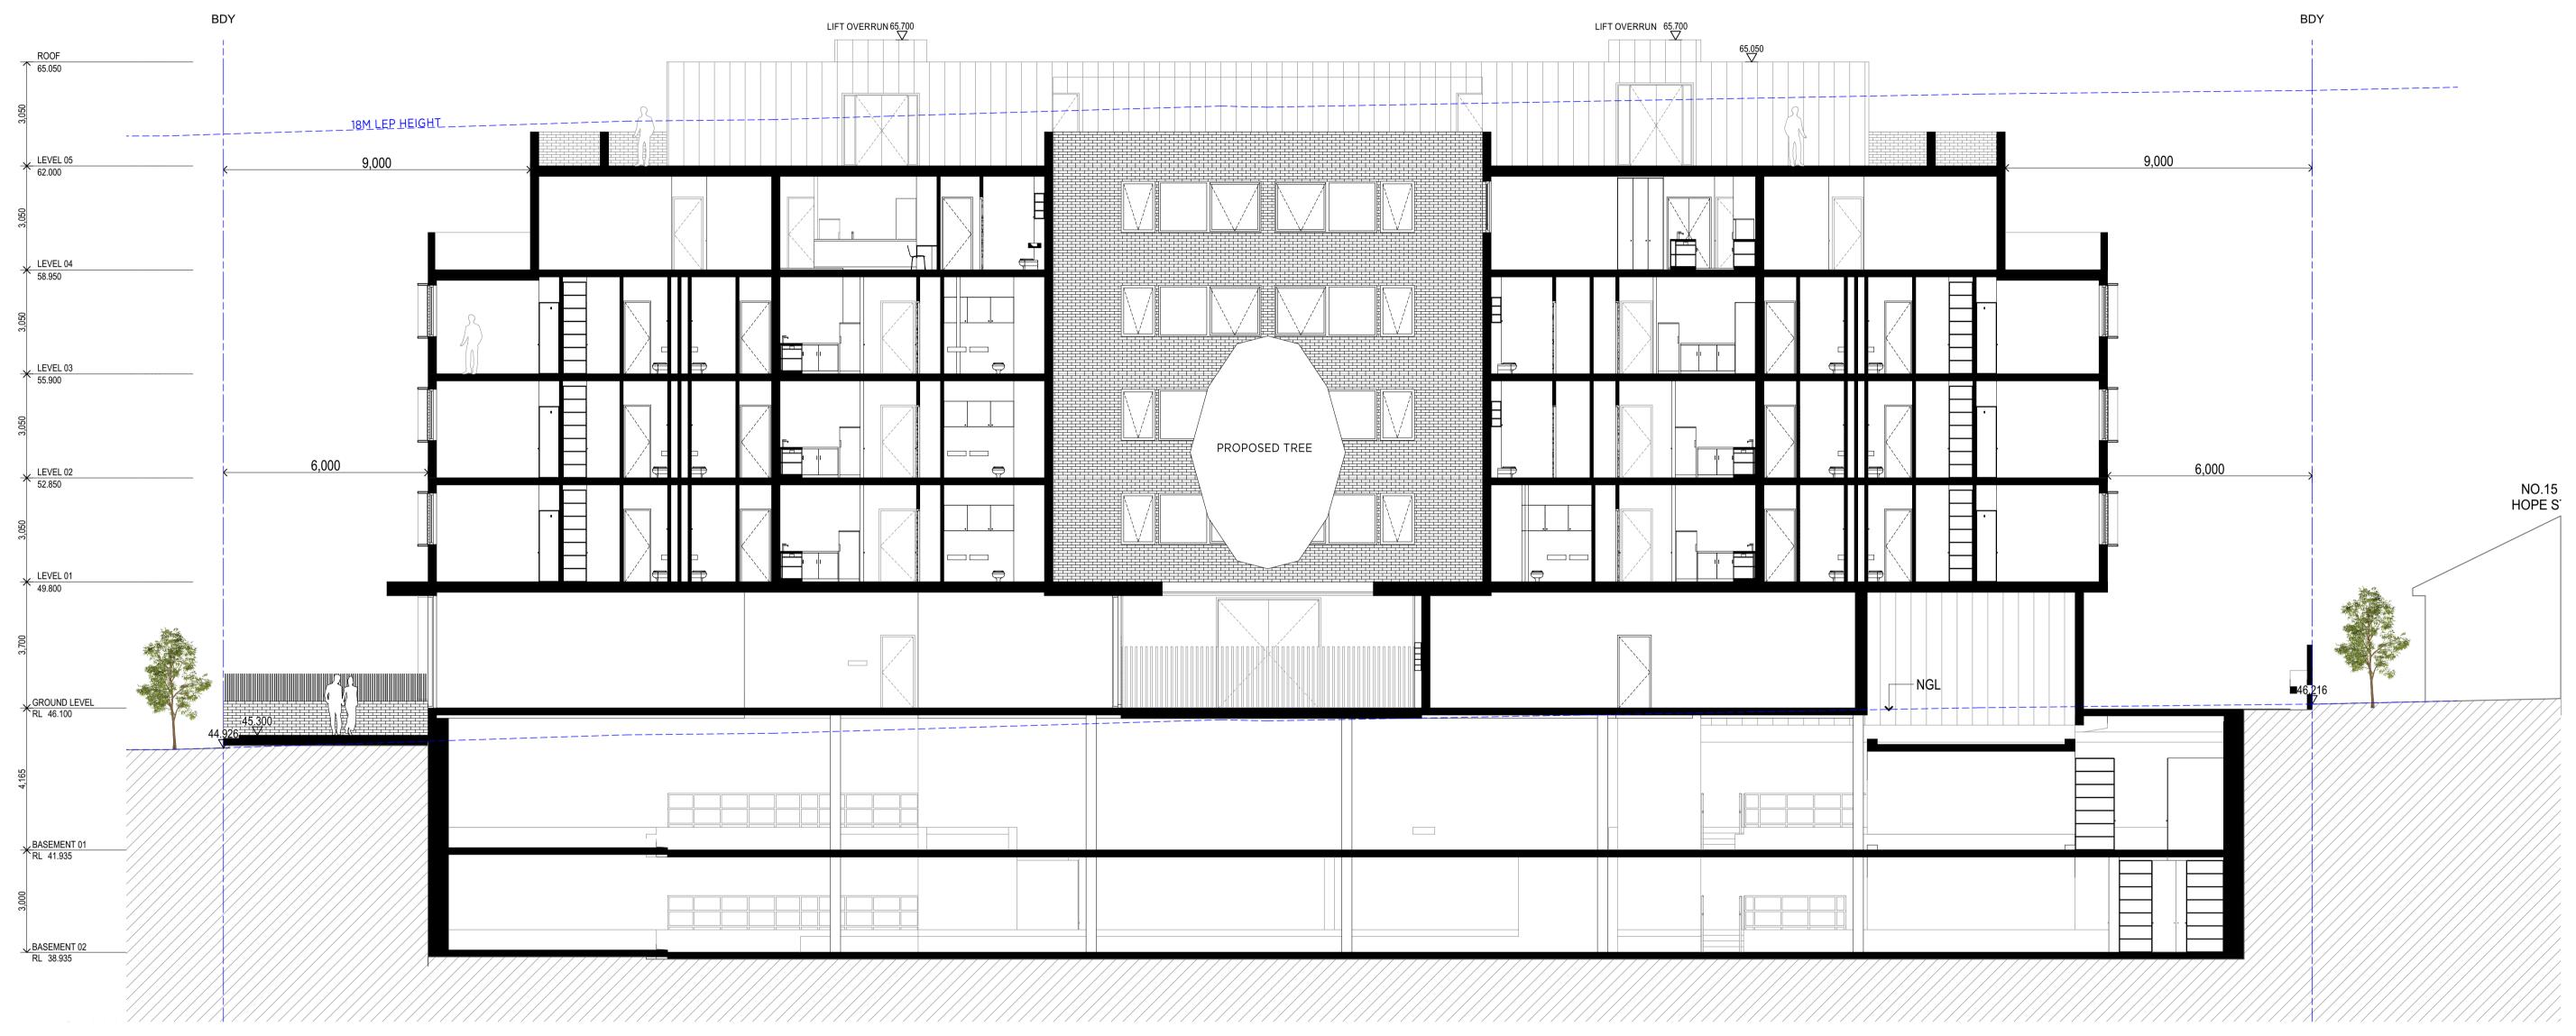

SK01 DEVELOPMENT APPLICATION
Rev Description

17 - 23 Hope St Penrith MIXED USE MULTI RESIDENTIAL


17-23 Hope St Penrith NSW Australia

Postal Address: PO BOX 2223 Burwood North NSW 2134
Phone Number: +61 2 9745 2014
Nominated Architects:
Ziad Boumelhem Reg no 8008
Youssef El Khawaja Reg no 8933

Drawing Title
SECTIONS SECTION C

1:100 @A1 Sheet Size

Project Number

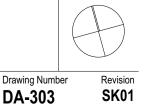


Drawing Number DA-303 2021-011


DEVELOPMENT APPLICATION

APPENDIX B

SWEPT TURN PATHS

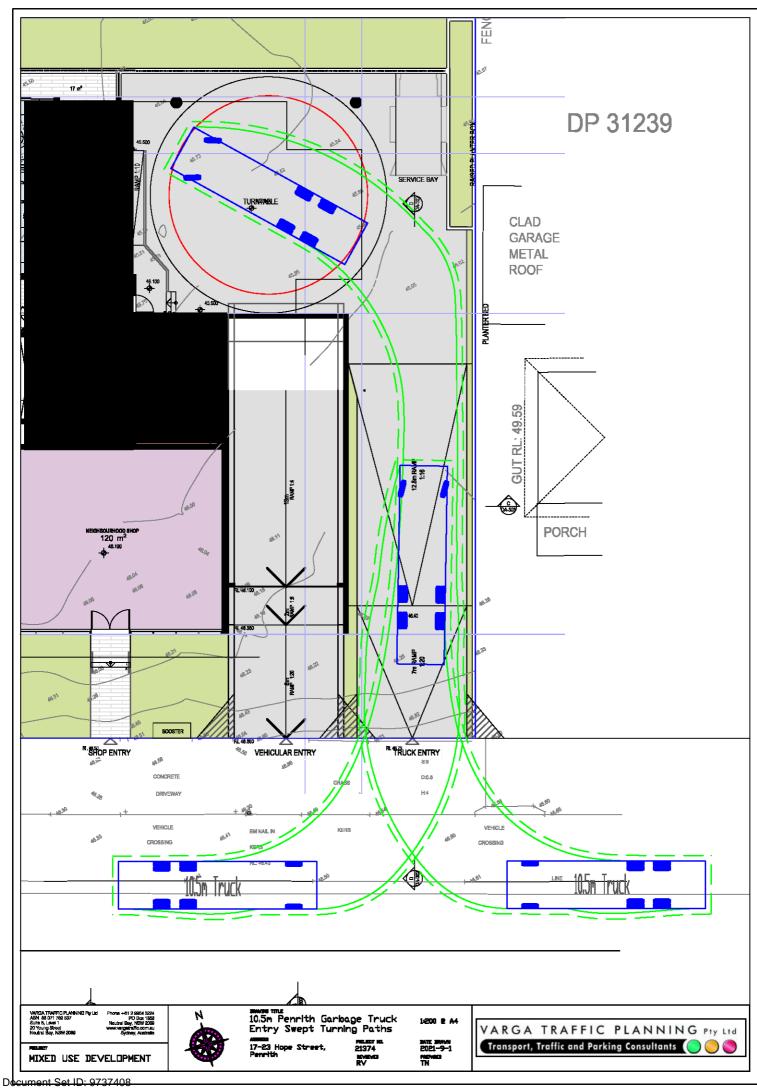

Version: 1, Version Date: 16/09/2021

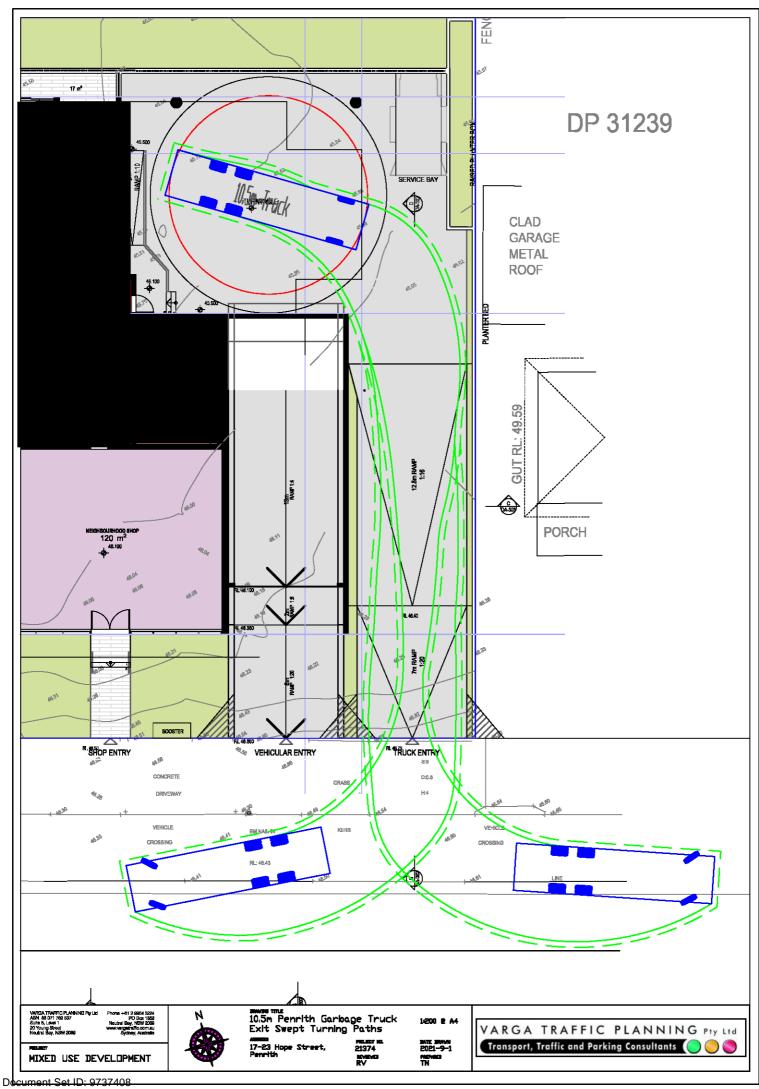

Version: 1, Version Date: 16/09/2021