

Driving success through valuable advice

Proposed Hotel, St Marys Rugby League Club For FDC Construction and Fitout

Section 96, Traffic and Parking Statement

For the attention of: Peter Stait

16 February 2017



Version: 1, Version Date: 07/03/2017



Document Control

Our Reference:

T2-1860, Proposed Hotel, St Marys Rugby League Club, Section 96 Traffic and Parking Statement

FDC Construction and Fitout

ISSUE	DATE	ISSUE DETAILS	AUTHOR	REVIEWED
1	10 th January 2017	Draft Report	SW	KW
2	20 th January 2017	Revised Report	SW	KW
3	30 th January 2017	Final Revised Report	SW	KW
4	16 th February 2017	Updated Final Report	SW	KW

Contact

Steve Wellman
02-8920 0800
0421 810 979
Steve.Wellman@parkingconsultants.com

COMMERCIAL IN CONFIDENCE

The information contained in this report, including any intellectual property rights arising from designs developed and documents created, is confidential and proprietary to Parking & Traffic Consultants (PTC).

This report may only be used by the person/organisation to whom it is addressed for the stated purpose for which it is provided and must not be imparted to or reproduced, in whole or in part, by any third person without the prior written approval of a PTC authorised representative. PTC reserves all legal rights and remedies in relation to any infringement of its rights in respect of its intellectual property and/or confidential information.

© 2016

PARKING & TRAFFIC CONSULTANTS Suite 102, 506 Miller Street Cammeray NSW 2062

> Ph. +61 2 8920 0800 Fax +61 2 8076 8665



Contents

1	Introduction	1
1.1	Project Summary	1
1.2	Purpose of this Report	
2	Proposal	3
2.1	Development Site	
2.2	The Approved Development	
2.3	The Section 96 Proposal	5
3	Existing Transport Facilities	6
3.1	Road Hierarchy	
3.2	Public Transport	
4	Access and Car Park Assessment	10
4.1	Vehicular Access	10
4.1.1	General Vehicles	10
4.1.2	Coaches	12
4.1.3	Service Vehicles	13
4.2	Car Park Arrangement	15
4.3	Pedestrian Access	15
5	Conclusion	16
J	COLICIOSIOIT	10
Attach	hment 1 – Architectural Drawings	18
Attach	hment 2 – Car Park Turning Paths and Compliance Review	20



1 Introduction

1.1 Project Summary

FDC Construction and Fitout has engaged Parking and Traffic Consultants (PTC) on behalf of the client, St Marys Rugby League Club, to prepare a Traffic and Parking Assessment to accompany a Section 96 Application to the Penrith City Council to modify an existing development consent for the proposed Hotel at the St Marys Rugby League Club, St Marys. Refer to Figure 1 for the site location.

The amendment to the approval proposes the following:

- · Reconfiguration of the parking layout and circulation,
- Provision of a dedicated service vehicle access and egress driveway at the western end of Boronia Road,
- Relocation of the boom gate access control,
- Increase in parking provision of 12 car parking spaces, and
- Minor modifications to the pedestrian access through the car park.



Figure 1 – Site Location

Proposed Hotel, St Marys Rugby League Club, Section 96 Parking & Traffic Statement.



1.2 Purpose of this Report

This report presents the following considerations in relation to the Traffic and Parking assessment of the Proposal:

- Section 2 A description of the project,
- Section 3 A description of the road network serving the development property,
- Section 4 Assessment of the revised car park, vehicular access and internal circulation arrangements in relation to compliance with the relevant standards, and
- Section 5 Conclusion



2 Proposal

2.1 Development Site

The existing St Marys Rugby League Club occupies an area of approximately 11,305 m² and includes lounges, gaming areas, function rooms, licensed bar areas and retail. Currently vehicular access to the eastern area of the site is via a one way inbound driveway off Boronia Road and egress is via a one way outbound driveway, also off Boronia Road.

The existing layout of the eastern area of the site is shown in Figure 2.



Figure 2 – Existing Site Layout, Eastern Area



2.2 The Approved Development

The current approved proposal is to extend the ground and first floor areas on the eastern side of the club to provide a 123 room hotel and modify the parking and access layouts to provide a port cochere and parking for 157 vehicles in the south east corner of the site.

The approved parking and access layout is shown in Figure 3.

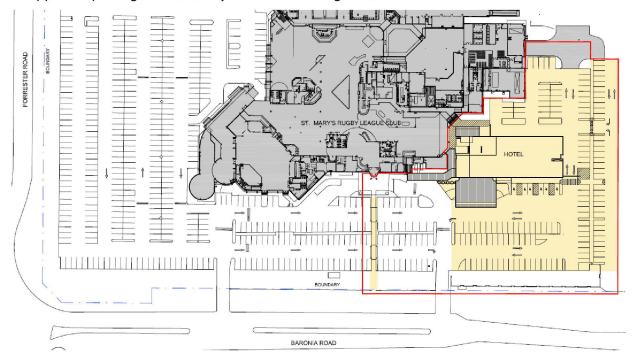


Figure 3 – The Approved Development



2.3 The Section 96 Proposal

This report has been prepared to accompany an application to modify the existing consent under Section 96 of the Environmental Planning and Assessment Act to;

- · Reconfigure the parking layout and circulation,
- Provide a dedicated service vehicle access and egress driveway at the western end of Boronia Road,
- Relocate the boom gate access control,
- Increase in the parking provision of 12 car parking spaces, and
- Make minor modifications to the pedestrian access through the car park.

The Section 96 Proposal is shown in Figure 4, Attachment 2 and is discussed further in Section 4.

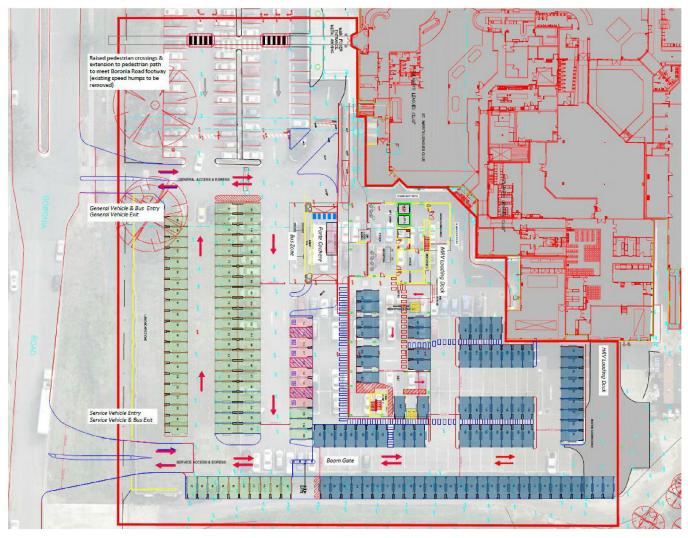


Figure 4 – The Section 96 Proposal

Proposed Hotel, St Marys Rugby League Club, Section 96 Parking & Traffic Statement.



3 Existing Transport Facilities

3.1 Road Hierarchy

The St Marys Rugby Leagues Club is located in the suburb of St Marys and is serviced by Forrester Road (Regional Road) and Boronia Road (Local Road). The surrounding road network servicing the area comprises of a number of Regional and State Roads, making the site easily accessible from different regions of the metropolitan area. The local road network in this area also comprises of local roads providing direct access to the surrounding retail, commercial and residential land-use.

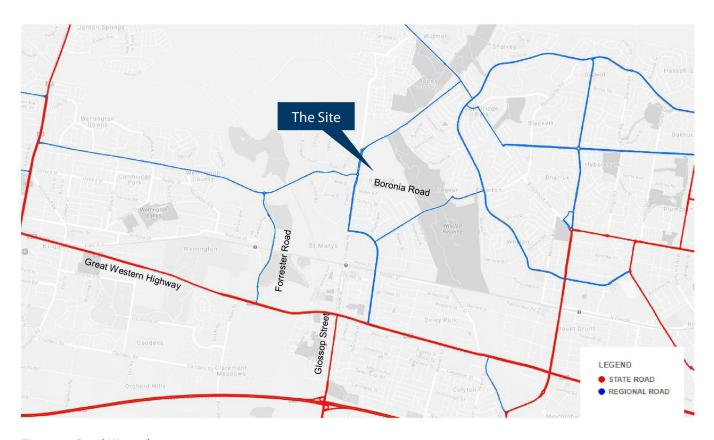


Figure 5- Road Hierarchy

The NSW administrative road hierarchy comprises the following road classifications, which angle with the generic road hierarchy as follows:

- State Roads Freeways and Primary Arterials (RMS Managed)
- Regional Roads Secondary or sub arterials (Council Managed, Part funded by the State)
- Local Roads Collector and local access roads (Council Managed)

Proposed Hotel, St Marys Rugby League Club, Section 96 Parking & Traffic Statement.

6



Table 1 – External Road Network – Great Western Highway			
Great Western Highway			
Road Classification	State Road		
Alignment	East - West		
Number of Lanes	3 lanes in each direction		
Carriageway Type	Divided		
Carriageway Width	23 metres		
Speed Limit	60 kph		
School Zone	No		
Parking Controls	No Parking		
Forms Site Frontage	No		



Figure 6 – Great Western Highway, eastbound towards Glossop Street (Source: Google Streetview 2015)

Table 2 – External Road Network – Glossop Street / Forrester Road					
Glossop Street / Forrester Road					
Road Classification	Regional Road				
Alignment	North - South				
Number of Lanes	2 lanes in each direction				
Carriageway Type	Divided				
Carriageway Width	20 metres				
Speed Limit	60 kph				
School Zone	No				
Parking Controls	No Stopping				
Forms Site Frontage	Yes				



Figure 7 – Forrester Road, northbound towards Boronia Road (Source: Google Streetview 2015)

Proposed Hotel, St Marys Rugby League Club, Section 96 Parking & Traffic Statement.

T2-1860



Table 3 – External Road Network – Boronia Road

Table 3 – External Road Network – Boronia Road			
Boronia Road			
Road Classification	Local Road		
Alignment	East - West		
Number of Lanes	1 lane in each direction (western end)		
Carriageway Type	Divided		
Carriageway Width	17 metres		
Speed Limit	50 kph		
School Zone	No		
Parking Controls	No Restriction		
Forms Site Frontage	Yes		



Figure 8 – Boronia Road viewed eastbound from Forrester Road (Source: Google Streetview 2015)



3.2 Public Transport

The St Marys Rugby League Club is serviced by two (2) bus routes which operate from the two (2) bus stops located adjacent to the site on Forrester Road, as shown in Figure 9.



Figure 9 – Bus Stops adjacent to development site

These services are operated by Sydney Buses and are summarised in the following:

Route 759: This service operates between St Marys and Mount Druitt and runs approximately every 30 minutes on weekdays and at 60 minute intervals on the weekends.

Route 780: This service operates between Penrith and Mount Druitt and runs approximately every 30 minutes on weekdays and at 60 minute intervals on the weekends.



4 Access and Car Park Assessment

4.1 Vehicular Access

The revised layout proposes access and egress to the site as set out in the following sections, and details of these arrangements are shown in Attachment 2.

4.1.1 General Vehicles

General vehicles (private cars) will enter and exit the site via the 11.0m wide 'Central Access' driveway on Boronia Road, leading to a 7.0m roadway, as shown in Figure 10. This driveway will be revised to provide both access and egress for cars.

This driveway will provide access to the general club parking in the south east corner of the site and the hotel designated parking on the eastern side of the site.

This driveway will also provide access to the 'Port Cochere' located at the club/hotel entrance.

Circulation within the general parking area will be generally clockwise in direction to reduce conflicts and direct access to the parking areas and the access and egress driveway.

Circulation within the Hotel car parking area will be two-way, with the exception of the undercroft parking which will be one way anticlockwise.

Access between the two areas is controlled by a boom gate.

Vehicle swept paths have been assessed using a B99 vehicle.

The sight distance requirements are described in Section 3.2 of AS2890.1 and are prescribed on the basis of the posit speed limit or 85th percentile vehicle speeds along the frontage road.

Boronia Road has a posted speed limit of 50 kph, which requires a desirable visibility distance of 69 metres and a minimum distance of 45 metres. Observations along Boronia Road indicate that the speed limit is adhered to. The driveway is located in a position where sufficient sight distance is provided.



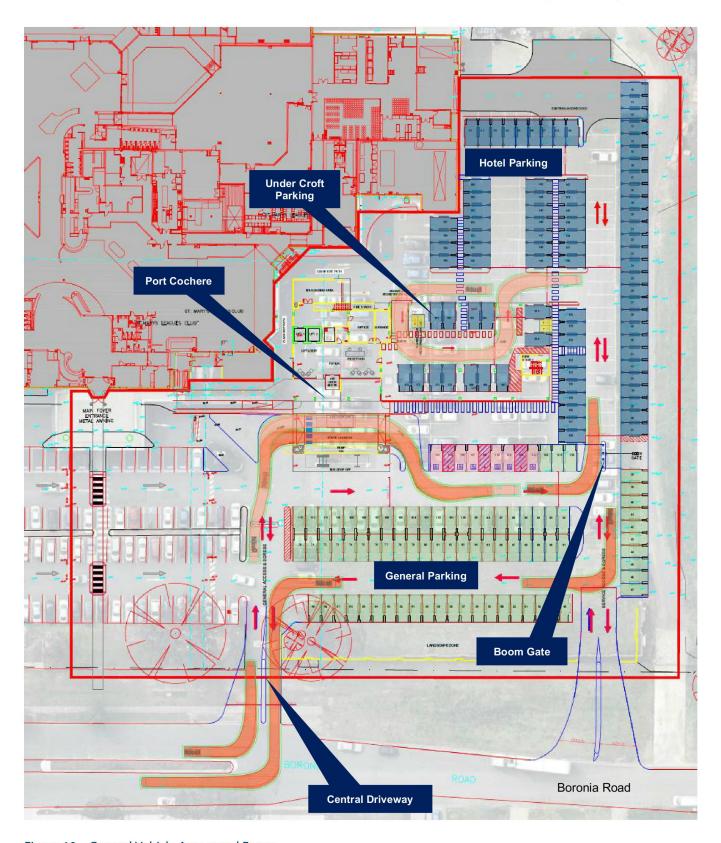


Figure 10 – General Vehicle Access and Egress

Proposed Hotel, St Marys Rugby League Club, Section 96 Parking & Traffic Statement.

T2-1860



4.1.2 Coaches

Coaches will access the site via the central driveway, proceed to the coach drop off area adjacent to the port cochere and exit the site via the proposed eastern Boronia Road driveway, as shown in Figure 11.

Vehicle swept paths have been assessed using a 12.5m rigid vehicle.

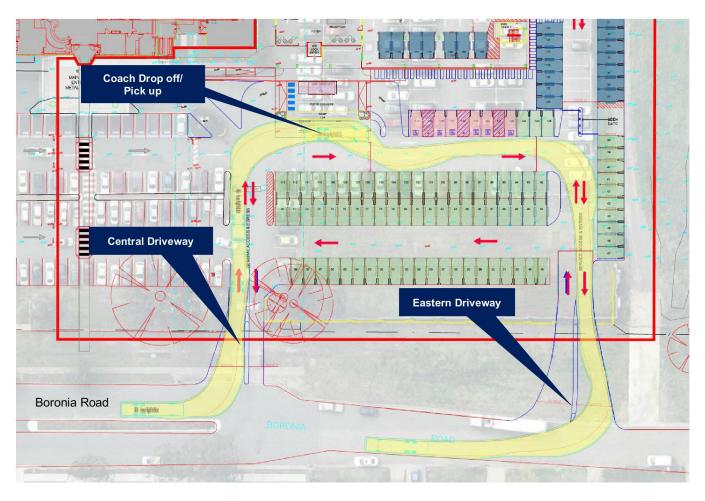


Figure 11 - Coach Access and Egress



4.1.3 Service Vehicles

Two service areas are proposed as part of the development;

- Medium Rigid Vehicle (8.8m) loading dock at the rear of the hotel; and
- Heavy Rigid Vehicle (12.5m) loading dock (existing) on the eastern side of the club.

Access and egress to these loading docks will be via the proposed 14.5m wide 'Eastern Driveway' leading onto a 7.0m wide roadway, as shown in Figure 12.

This access and egress arrangement will provide a segregated area for service vehicles to access the site, therefore providing a safer arrangement for both general and service vehicle access and reduce potential conflicts between the two differing user groups.

Service vehicles will access the loading dock areas via the boom gate between the general and hotel parking areas and a management system will be put in place to limit the use of the loading docks to one vehicle at a time and therefore limit the use of the eastern driveway vehicle to one vehicle at a time and reduce potential conflicts. Also, service vehicle access will be limited to outside peak activity times within the car park areas, to limit the potential conflicts where service vehicles are required to manoeuvre in parking aisles.

The sight distance requirements are described in Section 3.2 of AS2890.1 and are prescribed on the basis of the posted speed limit or 85th percentile vehicle speeds along the frontage road.

Boronia Road has a posted speed limit of 50 kph, which requires a desirable visibility distance of 69 metres and a minimum distance of 45 metres. Observations along Boronia Road indicate that the speed limit is adhered to. The driveway is located in a position where sufficient sight distance is provided.



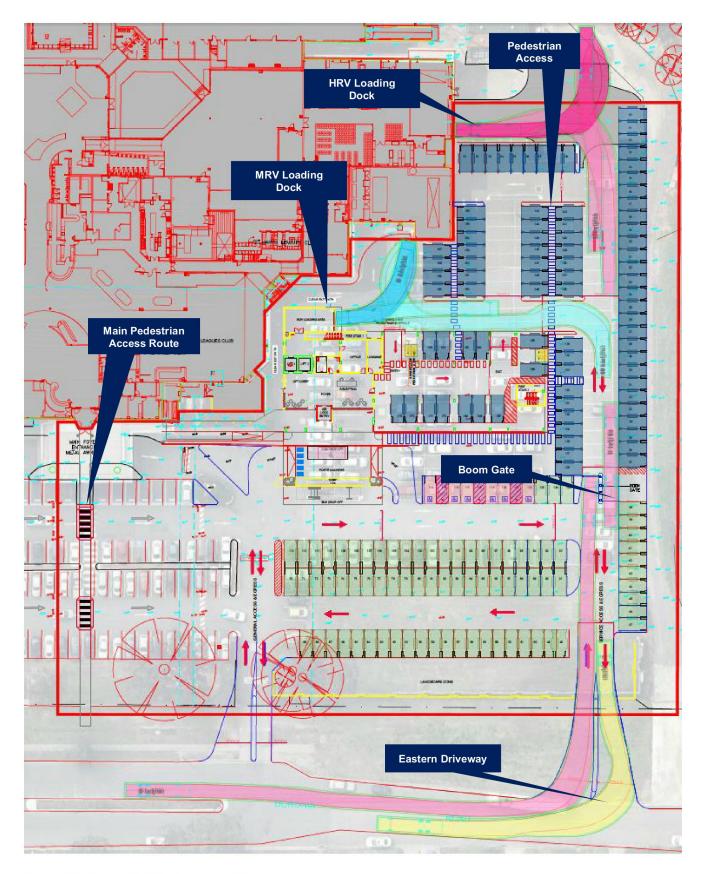


Figure 12 – Service Vehicle Access and Egress

Proposed Hotel, St Marys Rugby League Club, Section 96 Parking & Traffic Statement.

14

T2-1860



4.2 Car Park Arrangement

The car park access arrangement, internal circulation and parking arrangements have been designed in accordance with the requirements of Section 2 of AS2890.1.

Table 1.1 of AS2890.1 presents a number of classifications applicable to different land-uses. According to the Table, the most appropriate car park classification applicable to the subject car park will be a Class 2 facility, which is suitable for "Long-term city and town centre parking, sports facilities, entertainment centres, hotels, motels and airport visitors".

The parking space dimensions and associated aisle widths for each classification are presented in Table 2.2, and accordingly, a Class 2 facility requires parking space dimensions of 2.5 x 5.4 metres with an access aisle width of 5.8 metres. The proposed car park has been deigned to provide compliant parking space widths of 2.5 metres and an aisle width of a 5.8 metres (minimum), which complies with the minimum requirement. An assessment of all elements of the car park has been undertaken including column locations and aisle extensions and in this regard, the car park design complies with the requirements of AS2890.1.

Included in the car park arrangements is the provision of six (6) accessible spaces. These spaces have been assessed against the requirements of Section 2 of AS 2890.6 'Off Street Parking for People with Disabilities'. The standard requires parking space dimensions of 2.4 x 5.4 metres with a shared space of 2.4 metres width between spaces. An assessment of all elements of the car park has been undertaken and in this regard, the car park design complies with the requirements of AS2890.6.

4.3 Pedestrian Access

Within the hotel parking area, pedestrian access routes have been provided at a minimum width of 1.2m, to allow safe passage from the parking areas to the two access points to the hotel.

In addition, the main pedestrian access route to the existing foyer is to be extended south to Boronia road and the crossings within the car park are to be provided as raised pedestrian crossings. In conjunction with this the two speed humps directly to the east of the main pedestrian access route are to be removed.

Locations of these routes are shown in Figure 12.



5 Conclusion

In summary, this Section 96 proposal seeks to provide;

- A reconfiguration of the parking layout and circulation,
- The provision of a dedicated service vehicle access and egress driveway at the western end of Boronia Road,
- A Relocated boom gate to control access between the general and hotel parking areas,
- A minor increase in the parking provision, and
- Improvements to the pedestrian access through the car park.

The car parking, internal circulation, vehicular access arrangements and visibility have been designed in accordance with the relevant standards, being AS2890 Part 1, Part 2 and Part 6 having regard for geometry and safety.

The segregated access driveways should provide for safer access and egress for the different user groups and therefore provide a better user experience.


A loading dock management plan will be provided (at a later stage) to manage the use of the loading facilities and reduce potential conflicts within the car parking and loading areas.





Attachment 1 – Architectural Drawings



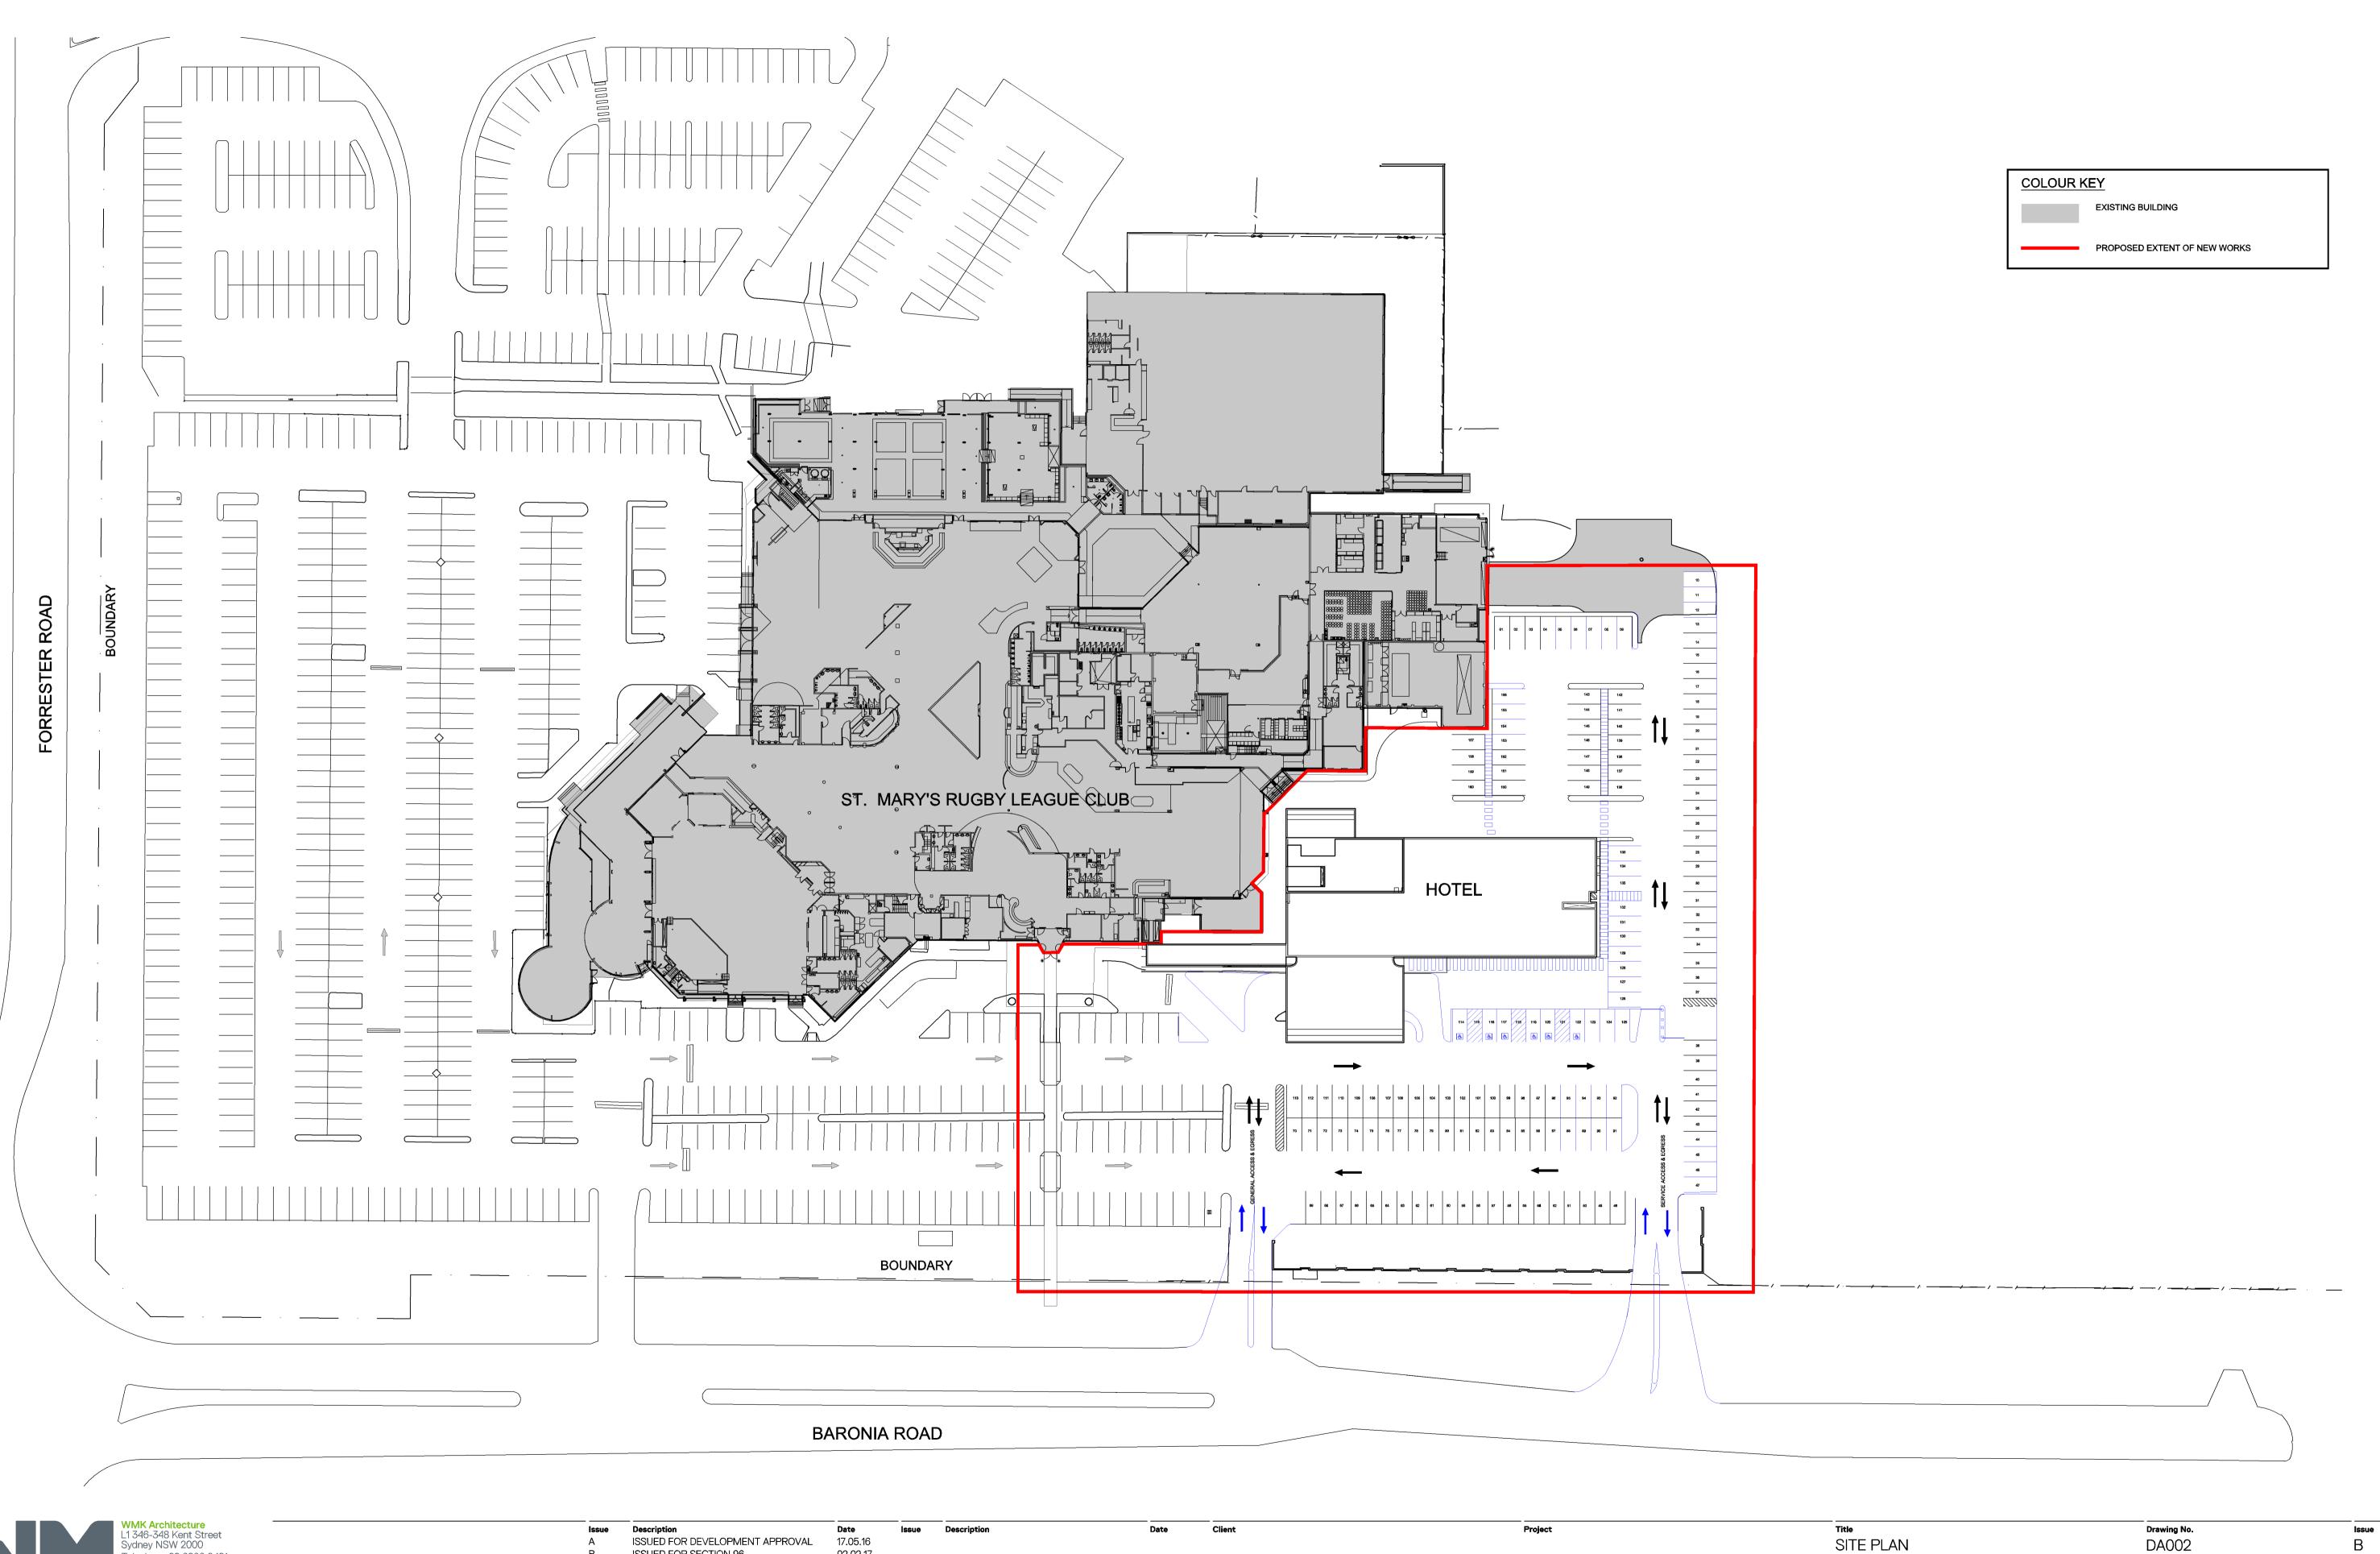


WMK Architecture
L1 346-348 Kent Street
Sydney NSW 2000
Telephone 02 9299 0401
Facsimile 02 9299 0402
wmkarchitecture.com
ABN 25 082 956 929

Document Set ID: 7559471
Version: 1, Version Date: 07/03/2017

SSUED FOR DEVELOPMENT APPROVAL 17.05.16
3 ISSUED FOR SECTION 96 02.02.17

Dimensioned Drawings to take precedence over scaling. Contractor to verify all dimensions on site before construction. All inconsistencies to be reported to the Architect immediately. This drawing and its contents remain the copyright of WMK Architecture Pty Ltd ®

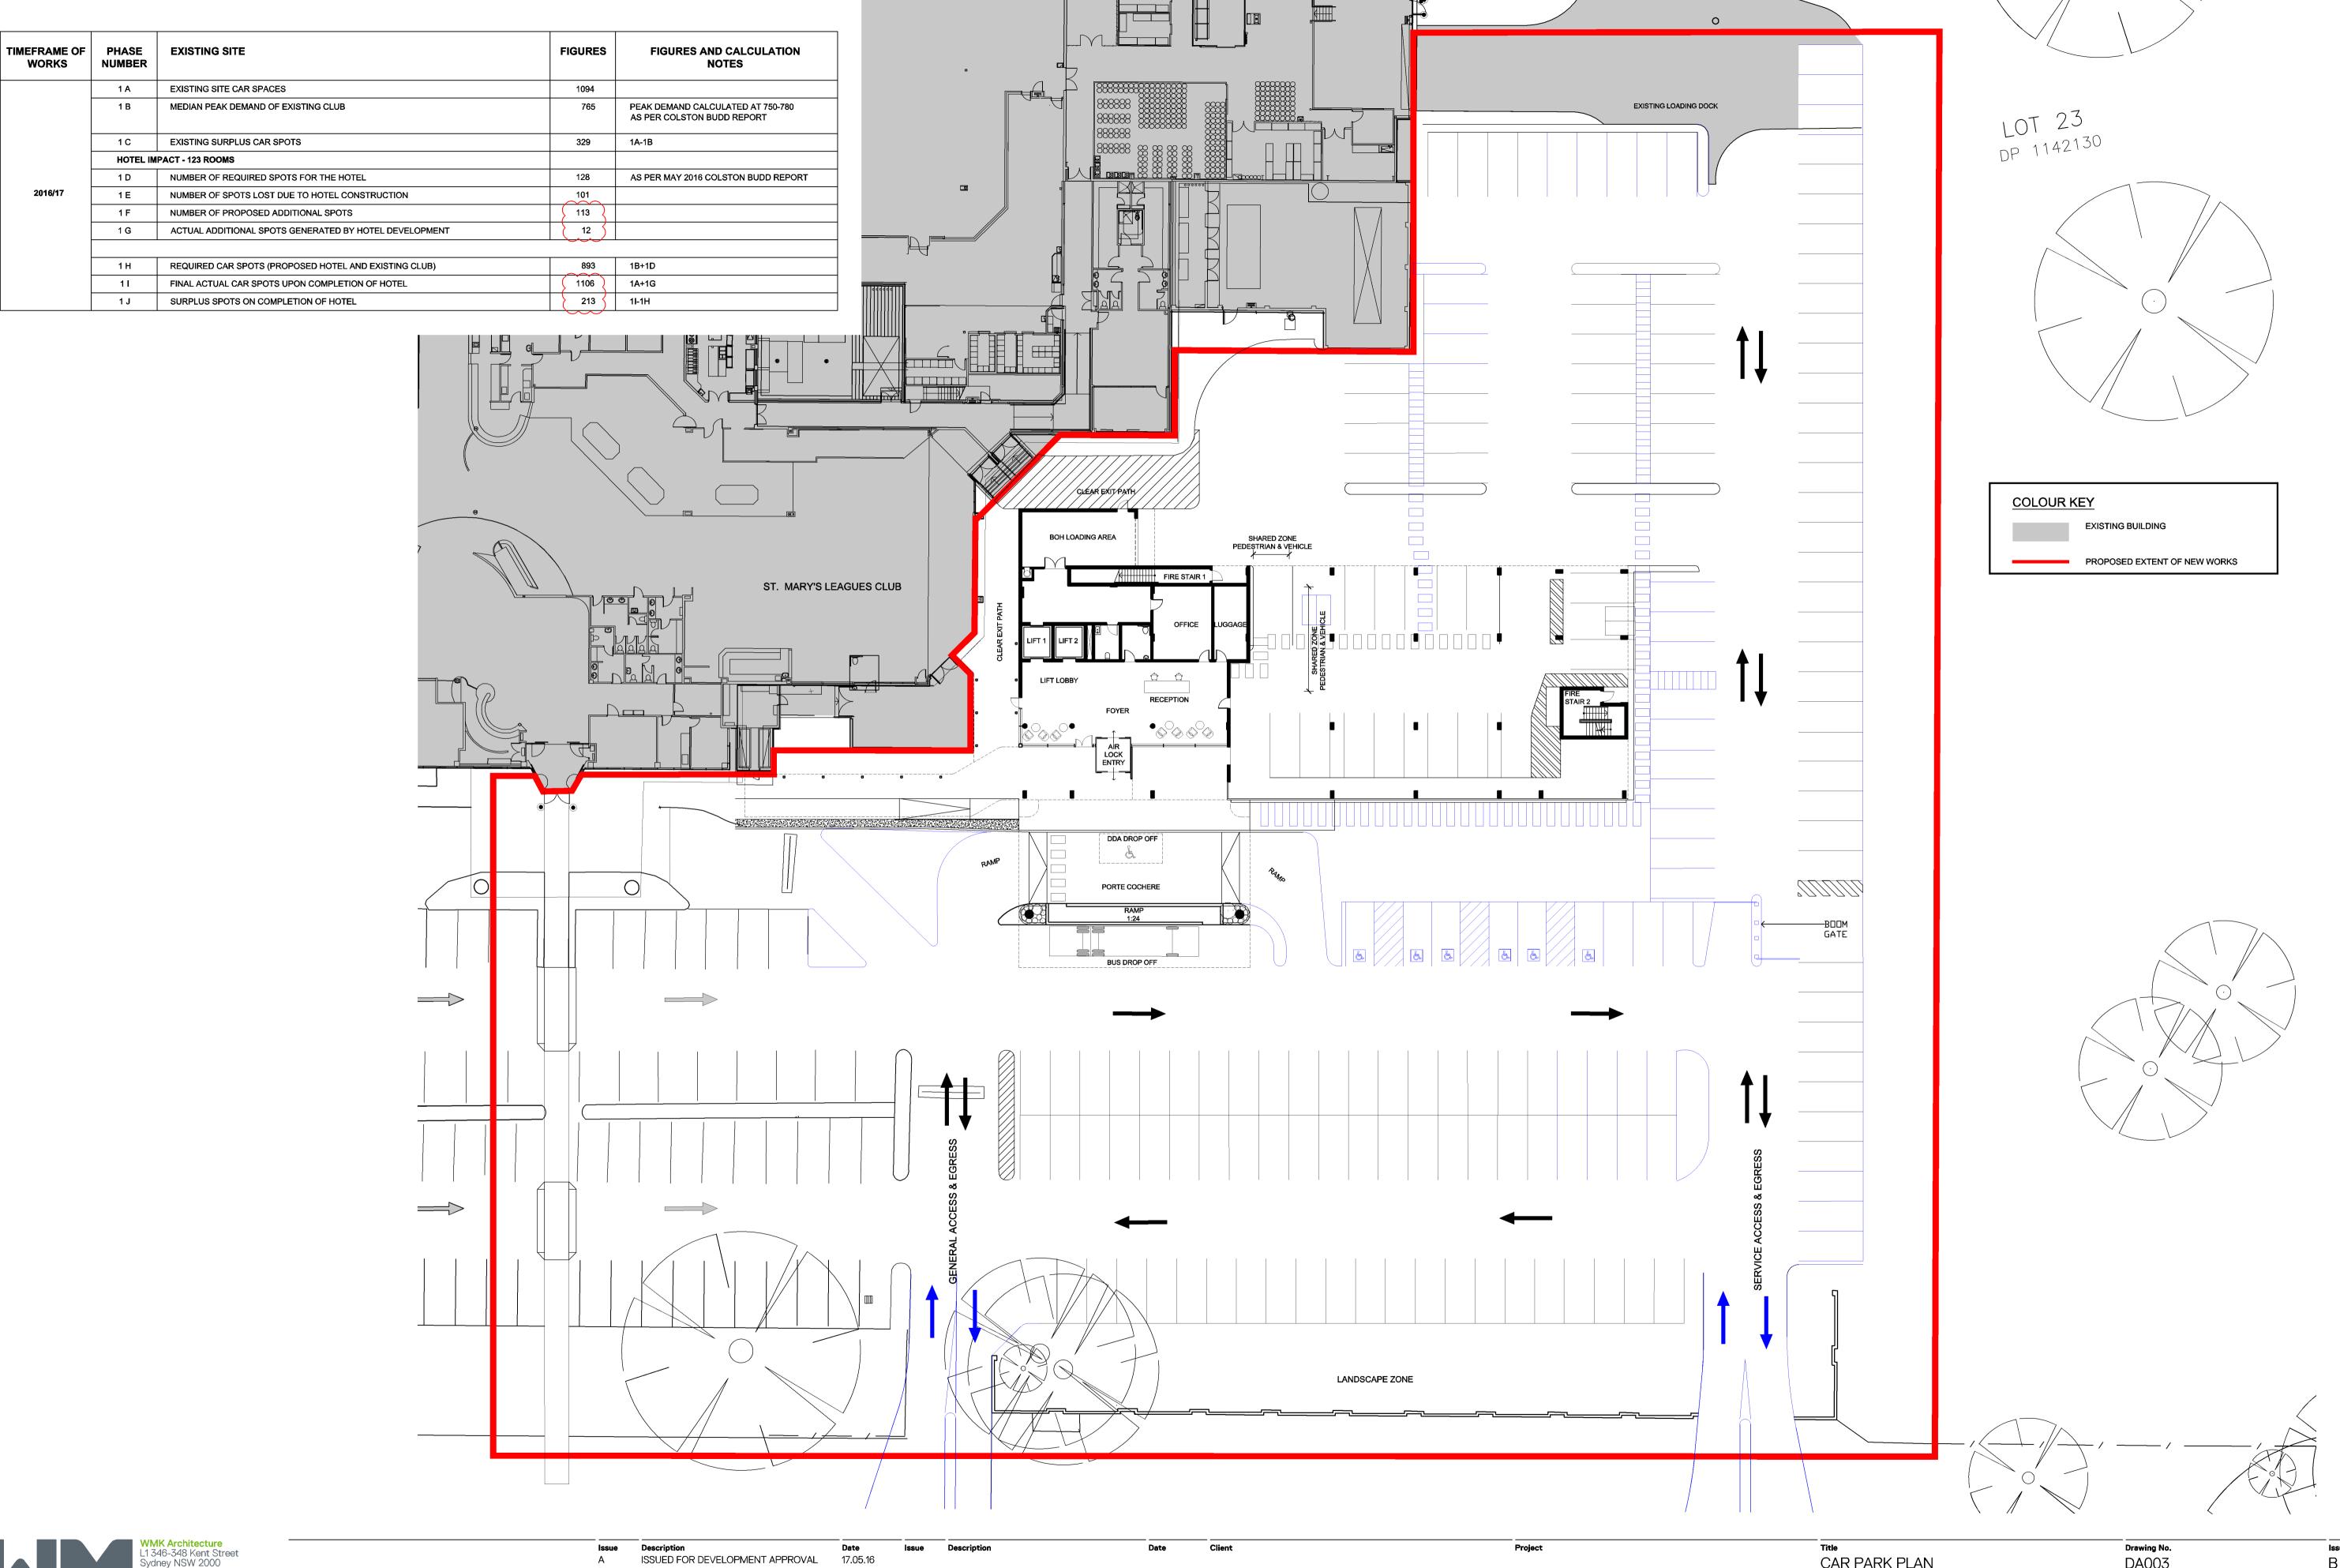

17.05.16

13.02.17


ISSUED FOR SECTION 96




Version: 1, Version Date: 07/03/2017

CAR PARK PLAN

Drawing No. DA003 Scale **Drawing Size** 1:250 APRIL 2016 BL

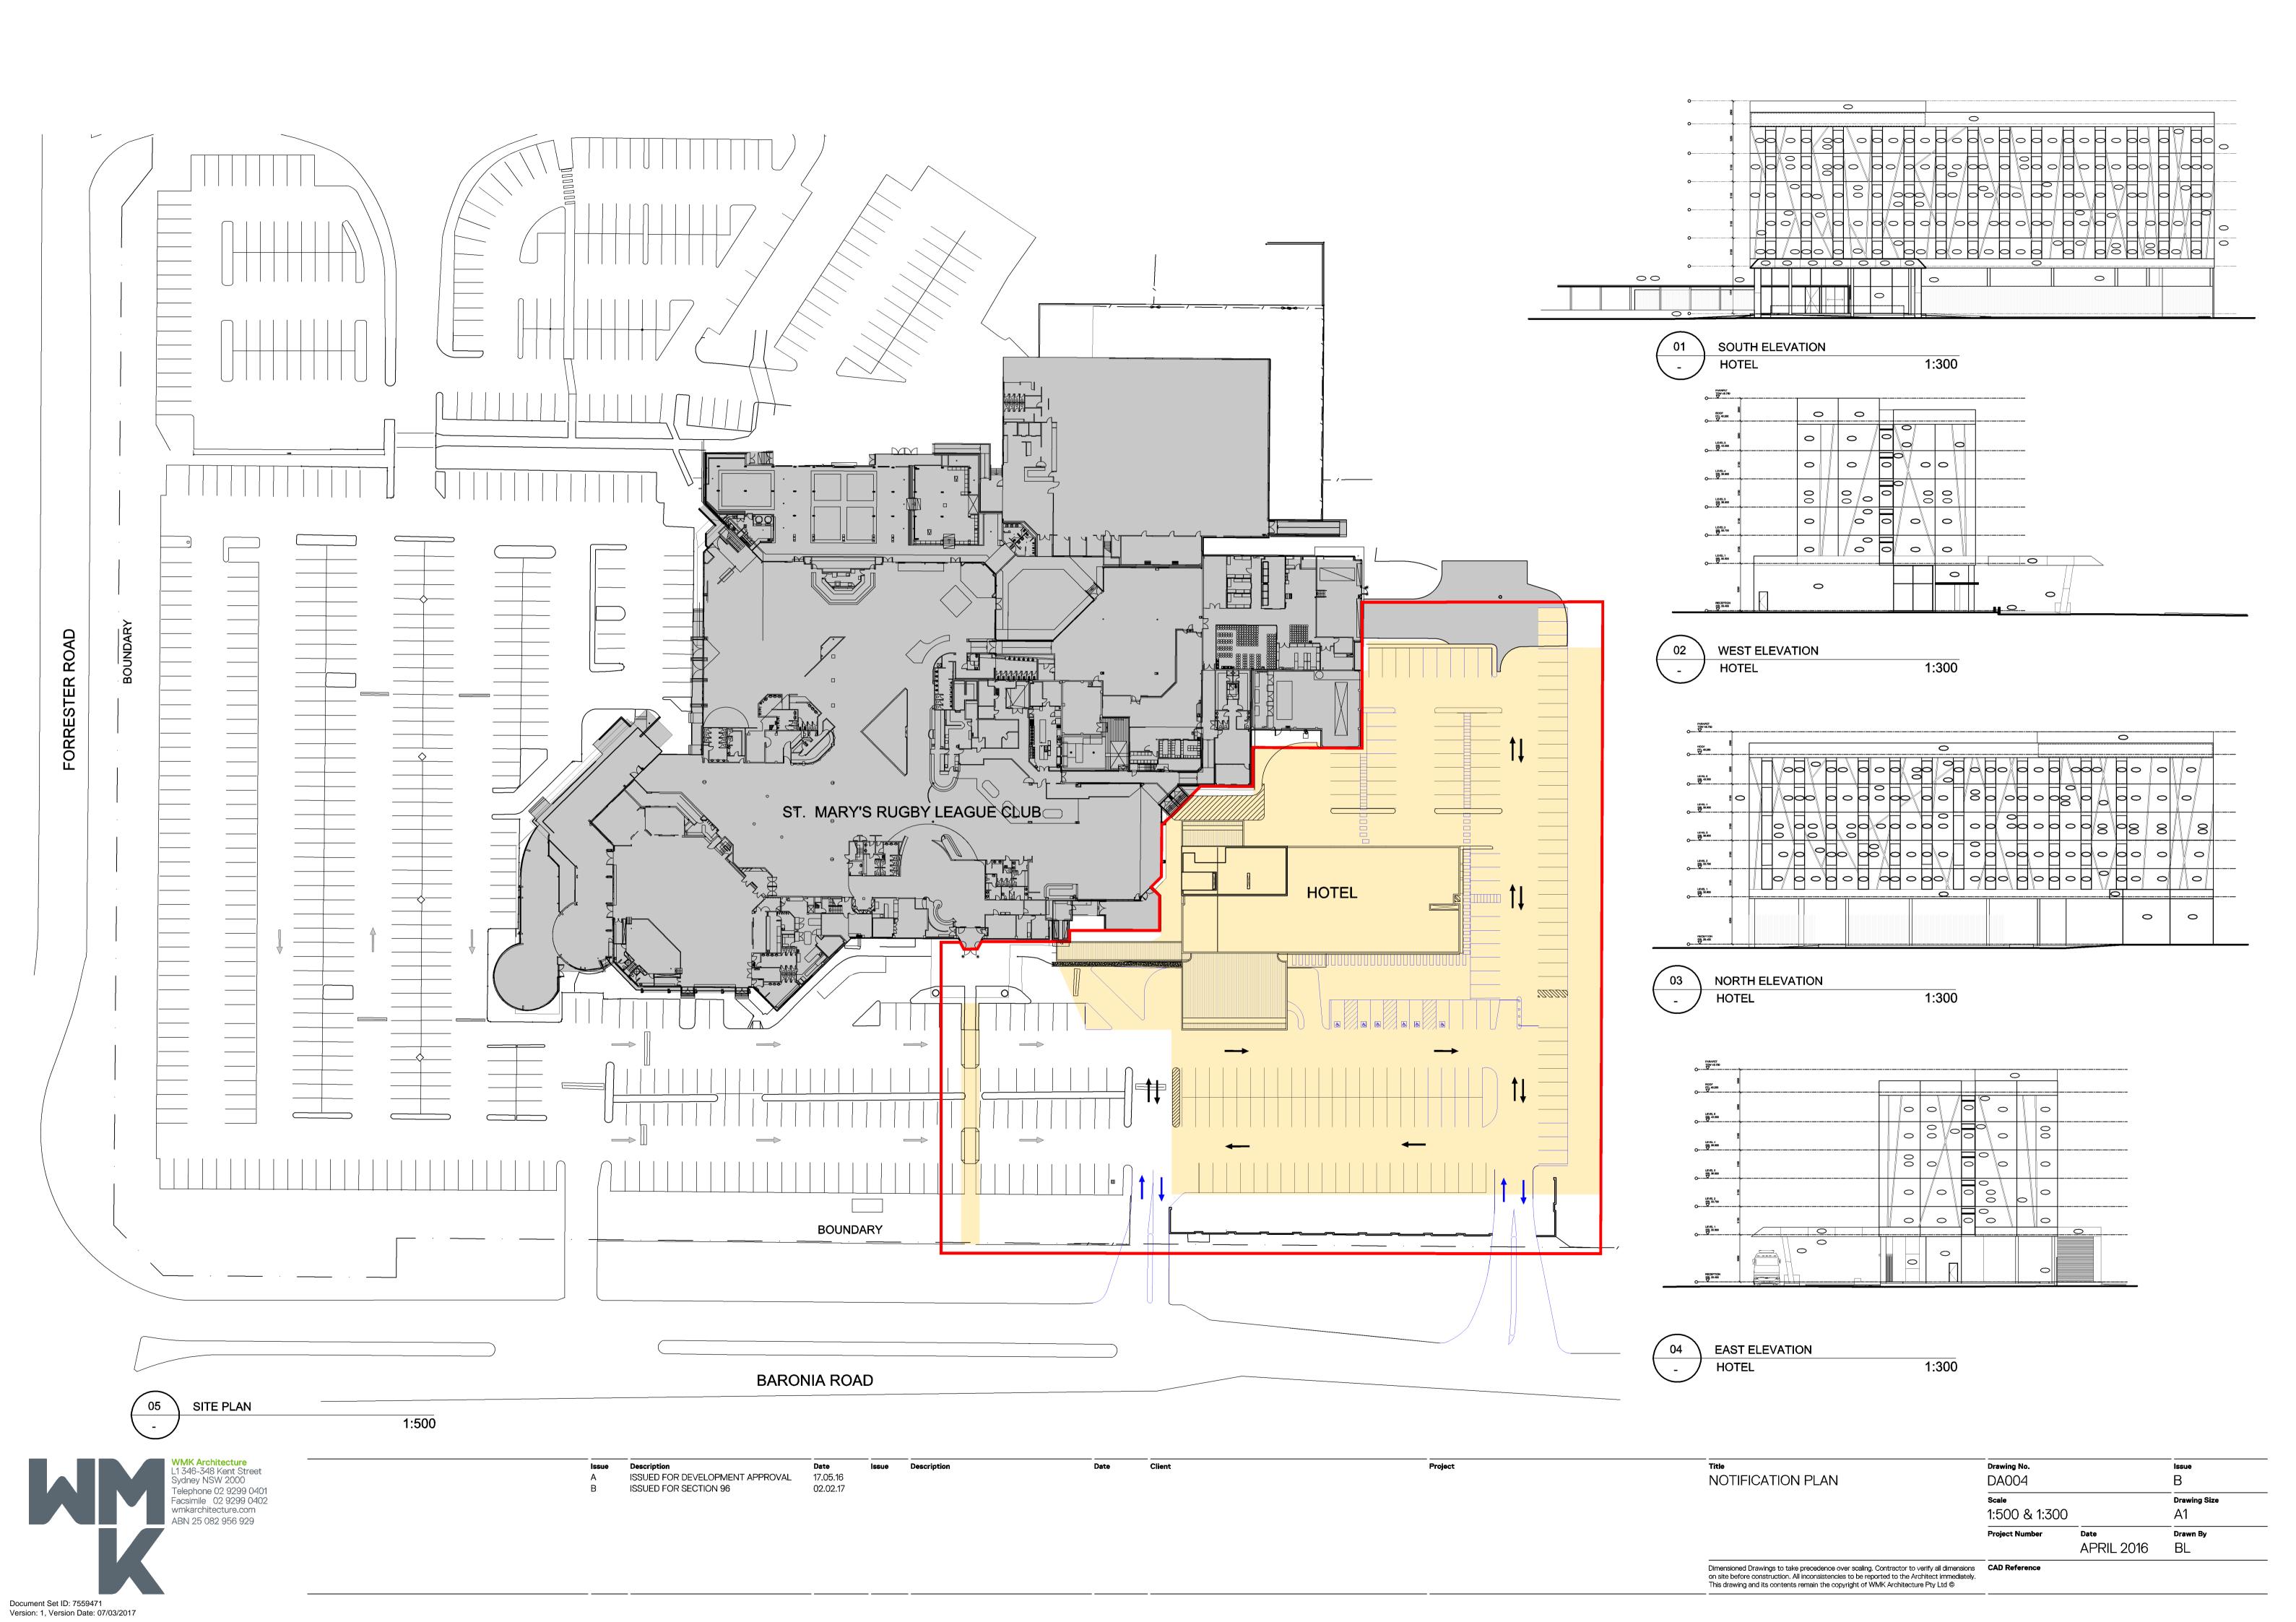

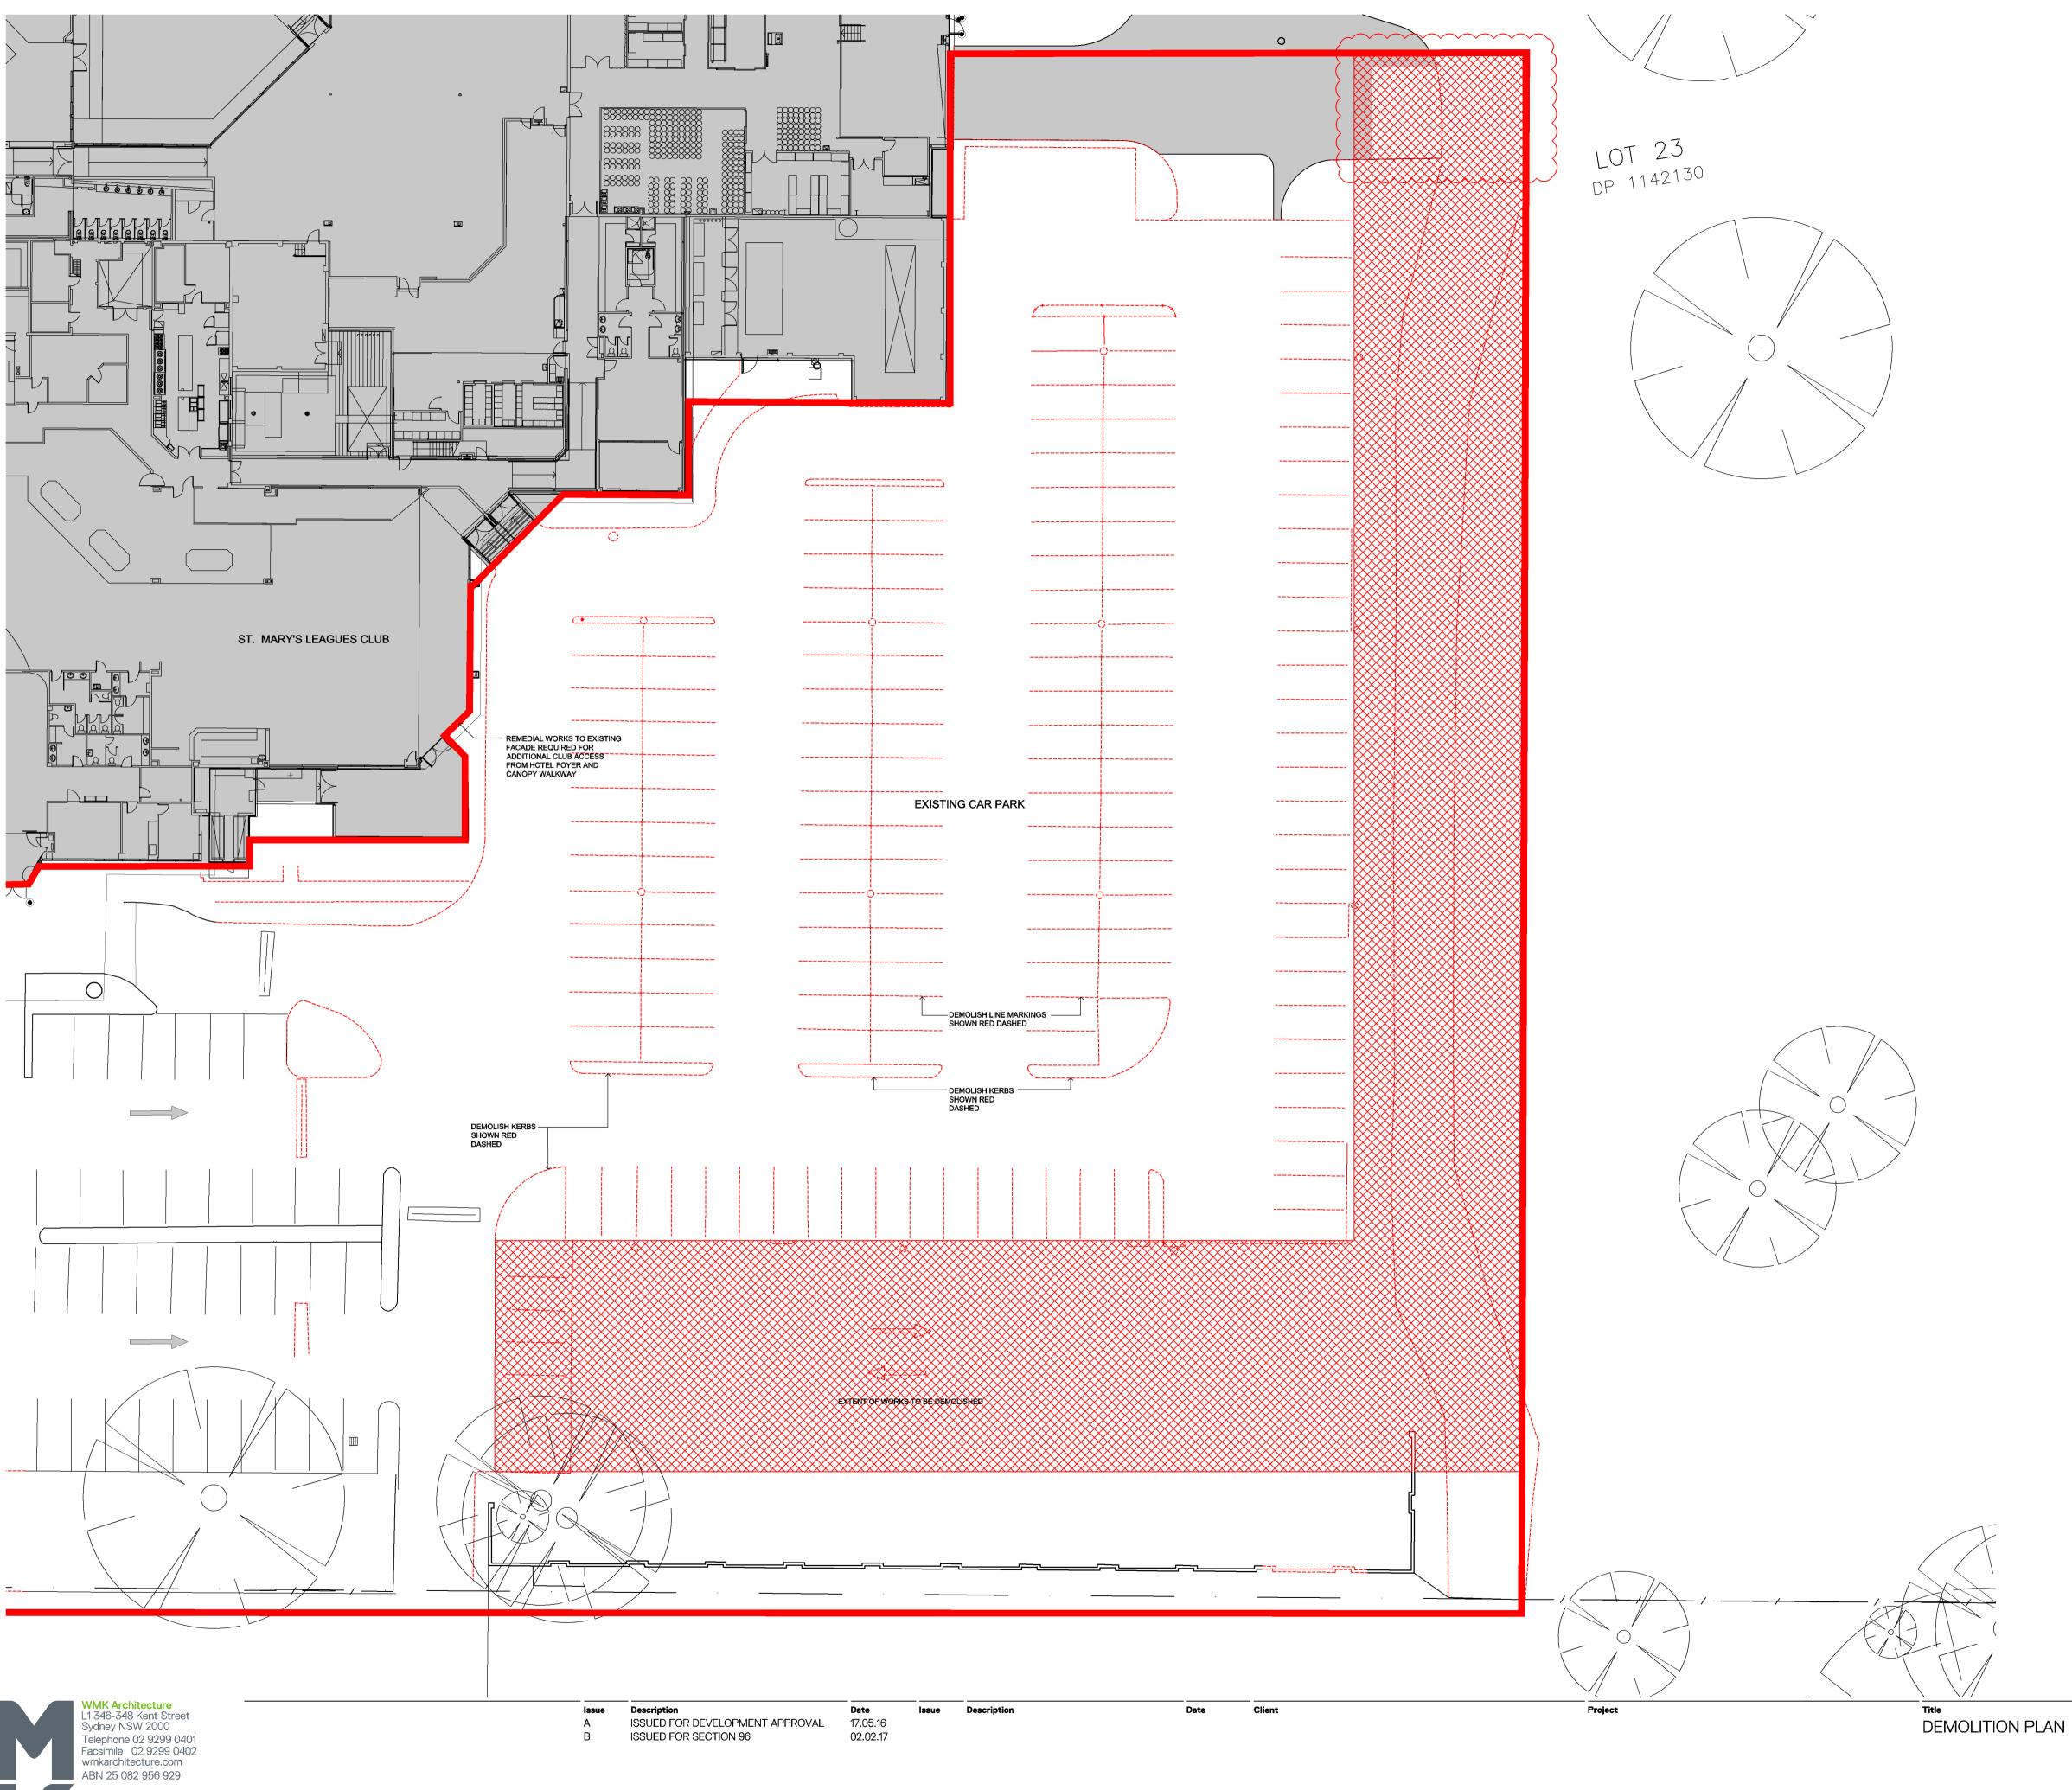


Document Set ID: 7559471 Version: 1, Version Date: 07/03/2017

DEMOLITION LEGEND: EXTENT OF WORKS IN SCOPE ---- EXISTING LINE MARKING AND KERBS TO BE DEMOLISHED EXTENT OF EXISTING AREA TO BE DEMOLISHED

Drawing No. DA010 **Drawing Size** 1:250 APRIL 2016 BL

Dimensioned Drawings to take precedence over scaling. Contractor to verify all dimensions on site before construction. All inconsistencies to be reported to the Architect immediately. This drawing and its contents remain the copyright of WMK Architecture Pty Ltd ©

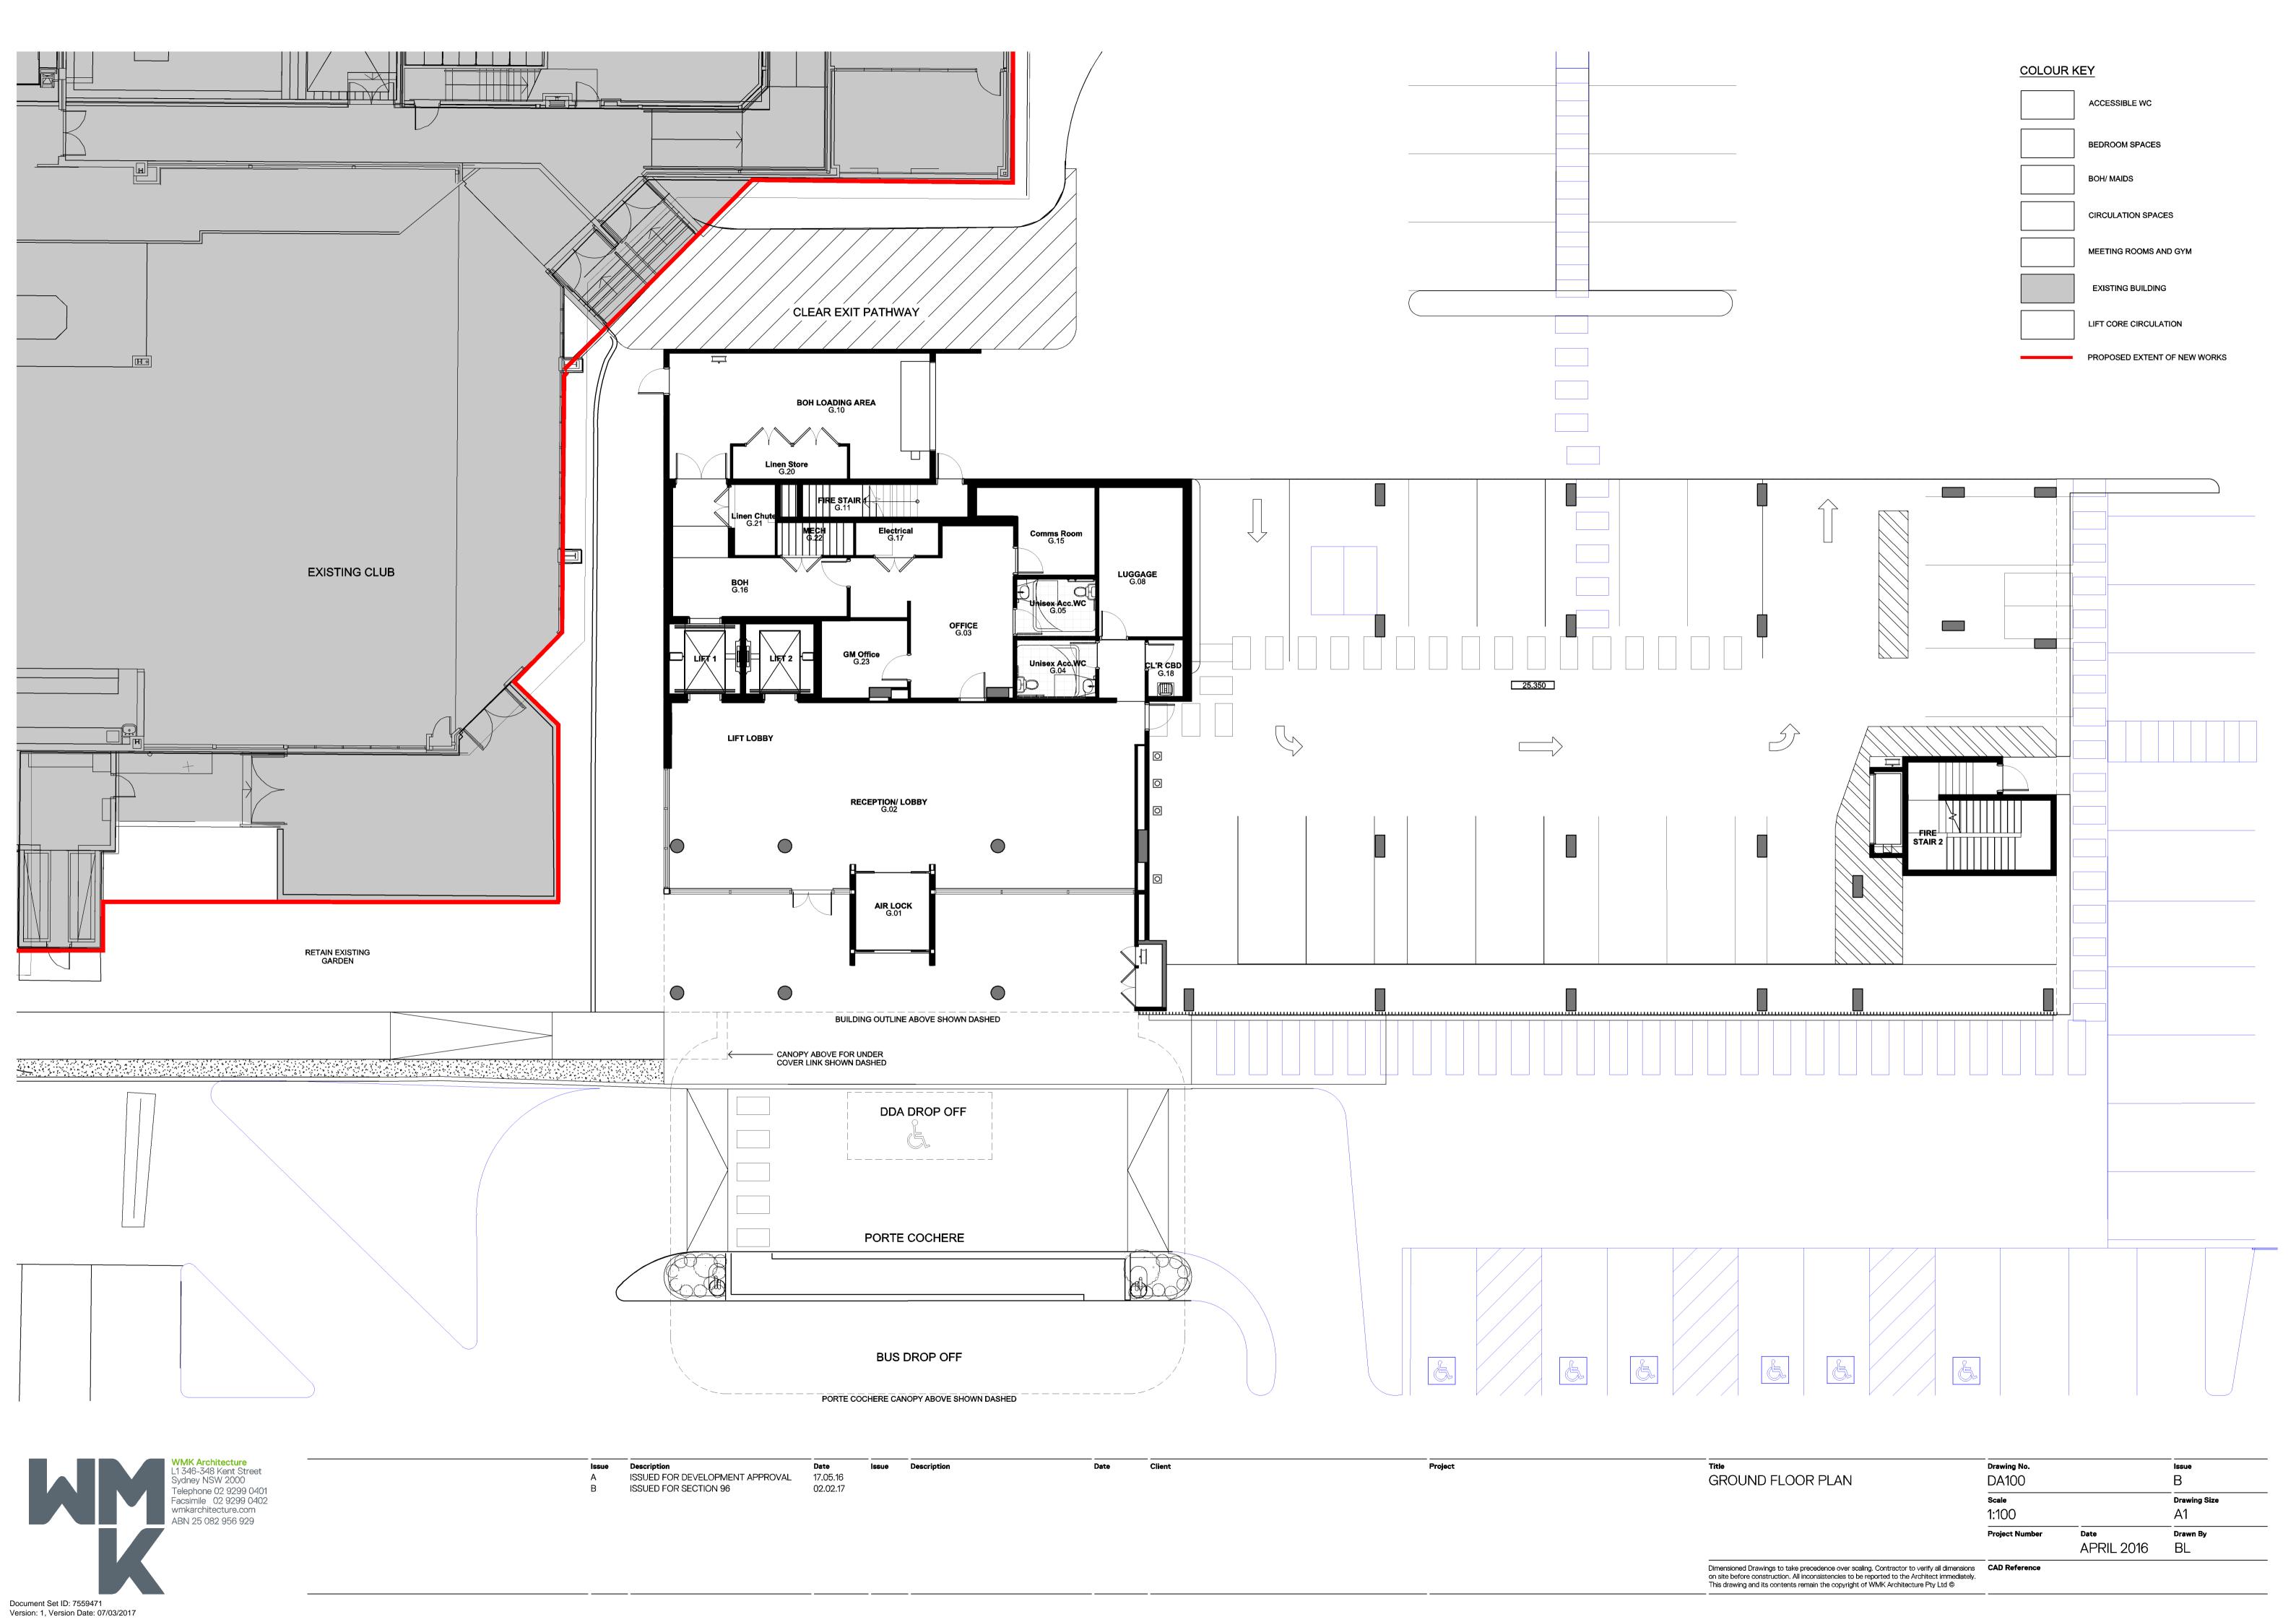

FINISHES LEGEND


- PRECAST CONCRETE PANELS WITH CHARCOAL COLOUR FINISH
- COLOUR BACK GLASS INFILL SPANDREL PANEL (SP) TO MATCH VISION GLAZING
- POWDER COATED ALUMINIUM WINDOW FRAME BLACK COLOUR FINISH
- COMPOSITE METAL PANEL CLADDING WITH EXPRESSED JOINTS BRONZE COLOUR FINISH
- COMPOSITE ALUMINIUM PANEL CLADDING WITH
- EXPRESSED JOINTS CHARCOAL FINISH COLOUR

 SHOP FRONT GLAZING SYSTEM WITH POWDER COATED ALUMINIUM FRAMES REFER TO EF03
- POWDER COATED ALUMINIUM BLADES WITH SUPPORT POST FIXINGS COLOUR CHARCOAL FINISH
- COMPOSITE METAL PANEL CLADDING WITH EXPRESS JOINTS BRONZE COLOUR FINISH
- POWDER COATED ALUMINIUM LOUVRES TO MATCH WINDOW FRAMES REFER TO EF03
- ANODISED EXTRUDED ALUMINIUM BATTENS (NOM. 150MM X 100MM) WITH CONCEALED FIXING TO PRECAST SUBSTRATE -
- BRONZE COLOUR FINISH

 TEXTURED CEMENT RENDERED BRICK WALL LIGHT GRAY
 COLOUR FINISH
 - COLOUR FINISH

<u>LEGEND</u>

FG FIXED GLASS SP SPANDREL PANEL

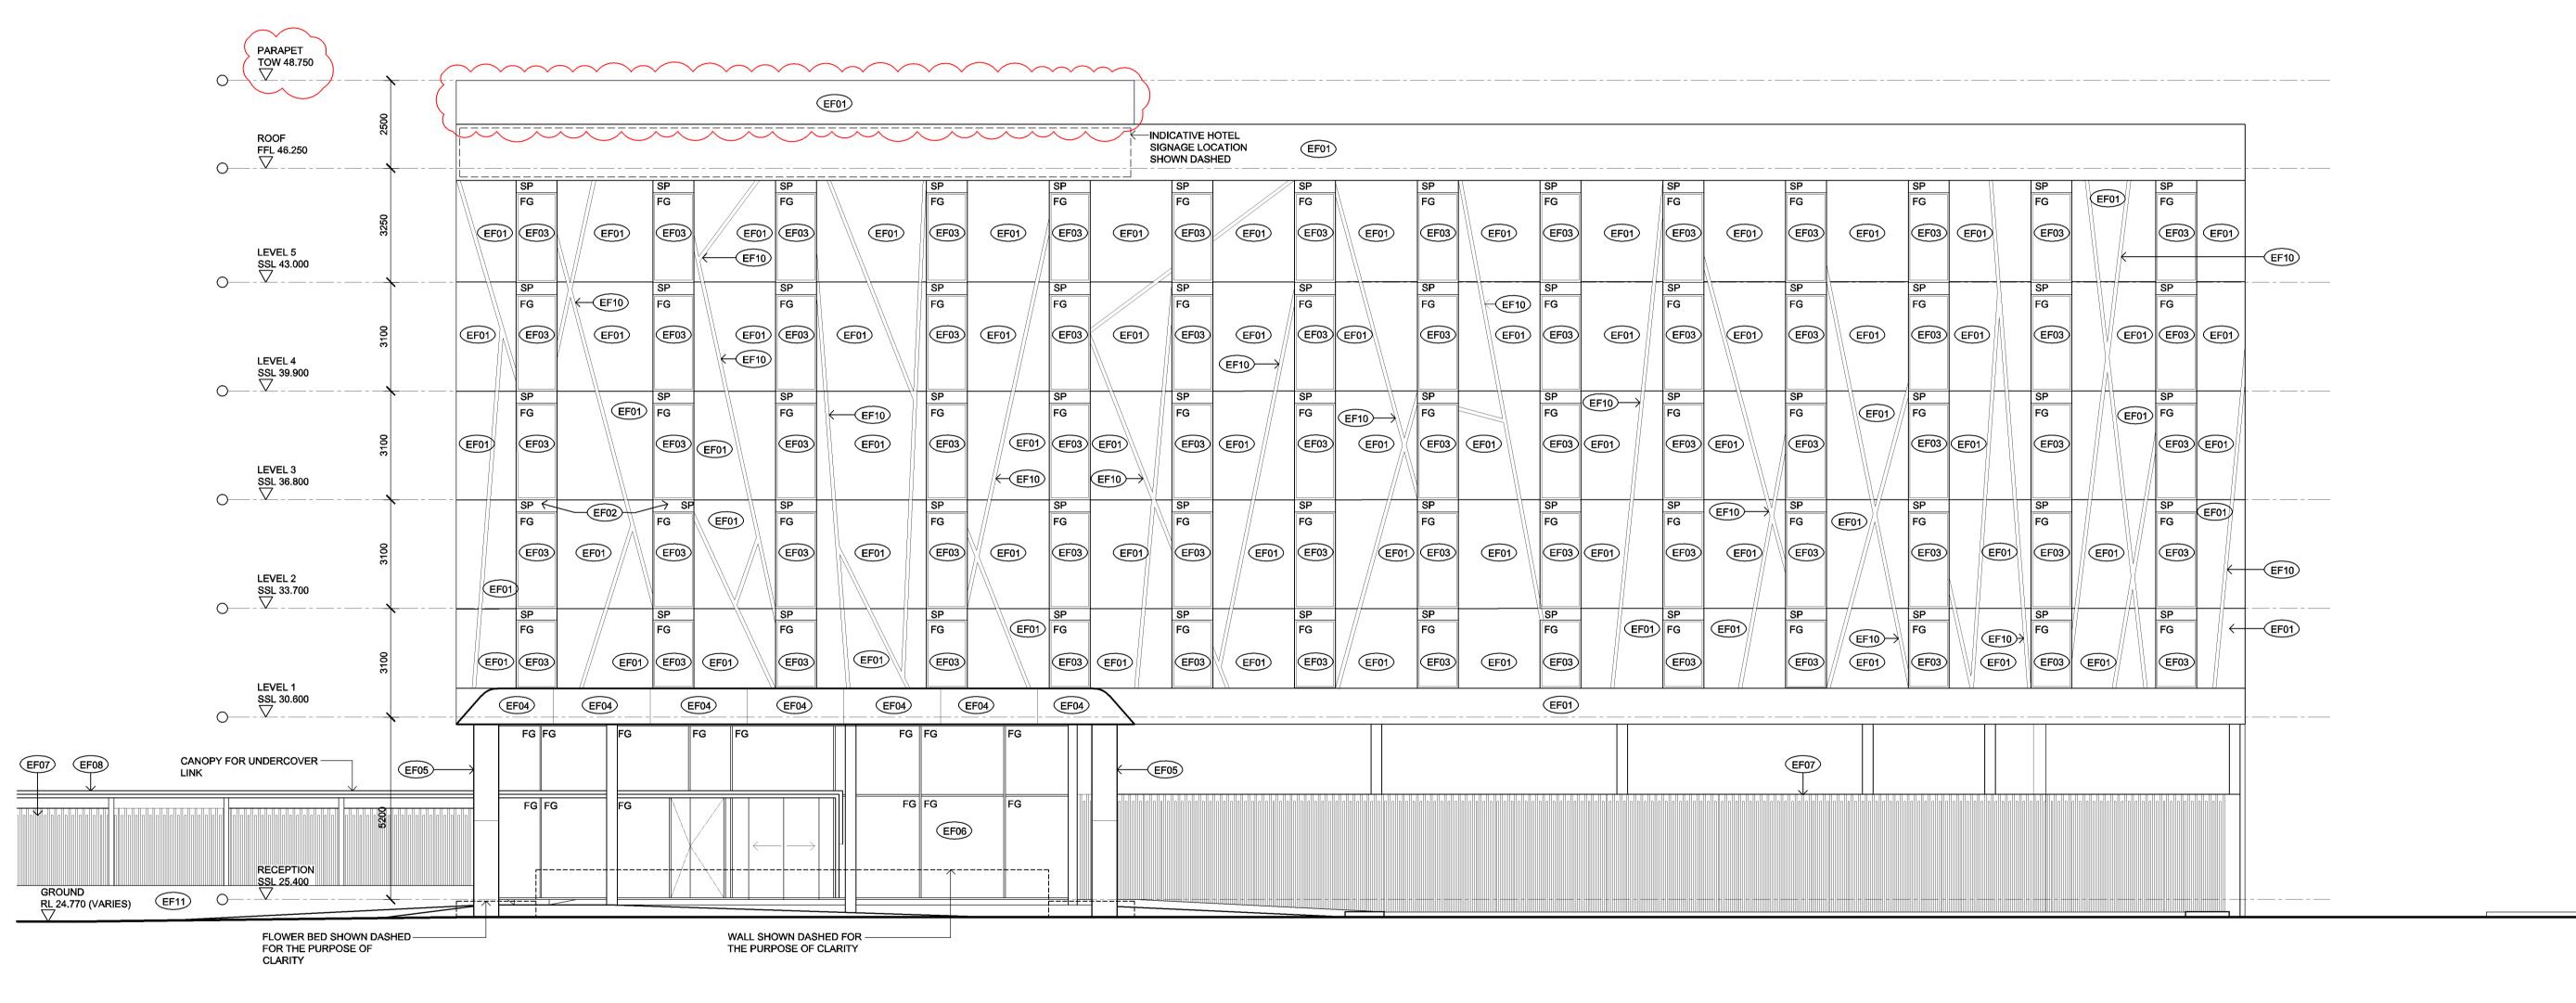

01

ELEVATION - 01


SOUTH ELEVATION

		WMK Architecture L1 346-348 Kent Street Sydney NSW 2000 Telephone 02 9299 0401 Facsimile 02 9299 0402 wmkarchitecture.com ABN 25 082 956 929
	K	
ocument Set ID: 7559471		

Version: 1, Version Date: 07/03/2017

Issue	Description	Date	Issue	Description	Date	Client	Project
Α	ISSUED FOR DEVELOPMENT APPROVAL	17.05.16					
В	ISSUED FOR SECTION 96	25.01.17					

SOUTH ELEVATION

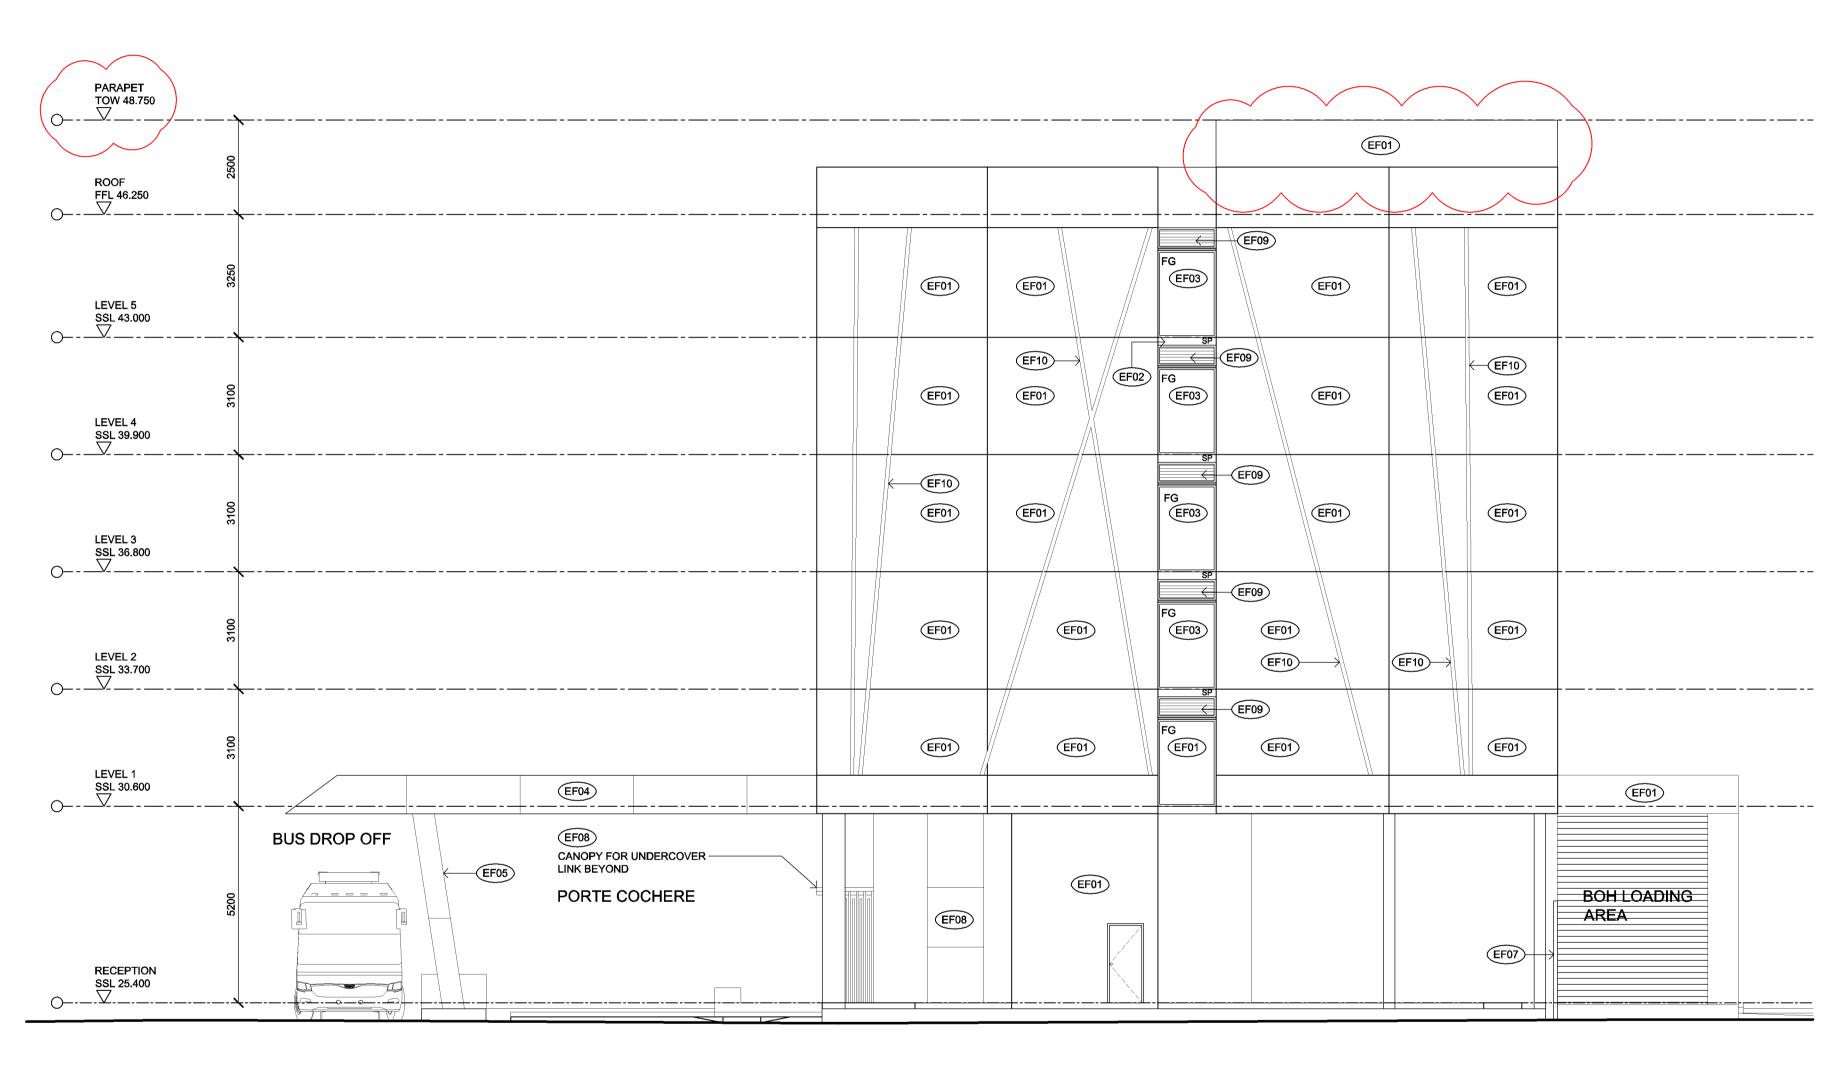

ELEVATION - 02 EAST ELEVATION



ISSUED FOR DEVELOPMENT APPROVAL 17.05.16 ISSUED FOR SECTION 96 25.01.17

EAST ELEVATION

Drawing No. DA501 **Drawing Size** 1:100 APRIL 2016 BL

Dimensioned Drawings to take precedence over scaling. Contractor to verify all dimensions on site before construction. All inconsistencies to be reported to the Architect immediately. This drawing and its contents remain the copyright of WMK Architecture Pty Ltd ©

COLOUR BACK GLASS INFILL SPANDREL PANEL (SP) TO

EXPRESSED JOINTS - BRONZE COLOUR FINISH

COATED ALUMINIUM FRAMES - REFER TO EF03

PRECAST CONCRETE PANELS WITH CHARCOAL COLOUR FINISH

EF02 MATCH VISION GLAZING POWDER COATED ALUMINIUM WINDOW FRAME -

BLACK COLOUR FINISH COMPOSITE METAL PANEL CLADDING WITH

COMPOSITE ALUMINIUM PANEL CLADDING WITH EF05

EXPRESSED JOINTS - CHARCOAL FINISH COLOUR SHOP FRONT GLAZING SYSTEM WITH POWDER

POWDER COATED ALUMINIUM BLADES WITH SUPPORT POST FIXINGS - COLOUR CHARCOAL FINISH

COMPOSITE METAL PANEL CLADDING WITH EXPRESS JOINTS - BRONZE COLOUR FINISH

POWDER COATED ALUMINIUM LOUVRES TO MATCH WINDOW EF09 FRAMES - REFER TO EF03

ANODISED EXTRUDED ALUMINIUM BATTENS (NOM. 150MM X 100MM) WITH CONCEALED FIXING TO PRECAST SUBSTRATE -BRONZE COLOUR FINISH

TEXTURED CEMENT RENDERED BRICK WALL - LIGHT GRAY EF11 COLOUR FINISH

FIXED GLASS SPANDREL PANEL

FINISHES LEGEND

EF01

FINISHES LEGEND

PRECAST CONCRETE PANELS WITH CHARCOAL COLOUR FINISH

COLOUR BACK GLASS INFILL SPANDREL PANEL (SP) TO EF02 MATCH VISION GLAZING

POWDER COATED ALUMINIUM WINDOW FRAME -EF03 BLACK COLOUR FINISH

EF04 COMPOSITE METAL PANEL CLADDING WITH

EXPRESSED JOINTS - BRONZE COLOUR FINISH

COMPOSITE ALUMINIUM PANEL CLADDING WITH EXPRESSED JOINTS - CHARCOAL FINISH COLOUR

COATED ALUMINIUM FRAMES - REFER TO EF03 POWDER COATED ALUMINIUM BLADES WITH SUPPORT POST

EF07 FIXINGS - COLOUR CHARCOAL FINISH COMPOSITE METAL PANEL CLADDING WITH EXPRESS JOINTS -

SHOP FRONT GLAZING SYSTEM WITH POWDER

EF08 BRONZE COLOUR FINISH


POWDER COATED ALUMINIUM LOUVRES TO MATCH WINDOW EF09 FRAMES - REFER TO EF03

ANODISED EXTRUDED ALUMINIUM BATTENS (NOM. 150MM X 100MM) WITH CONCEALED FIXING TO PRECAST SUBSTRATE -BRONZE COLOUR FINISH

TEXTURED CEMENT RENDERED BRICK WALL - LIGHT GRAY EF11 COLOUR FINISH

<u>LEGEND</u>

FIXED GLASS SPANDREL PANEL

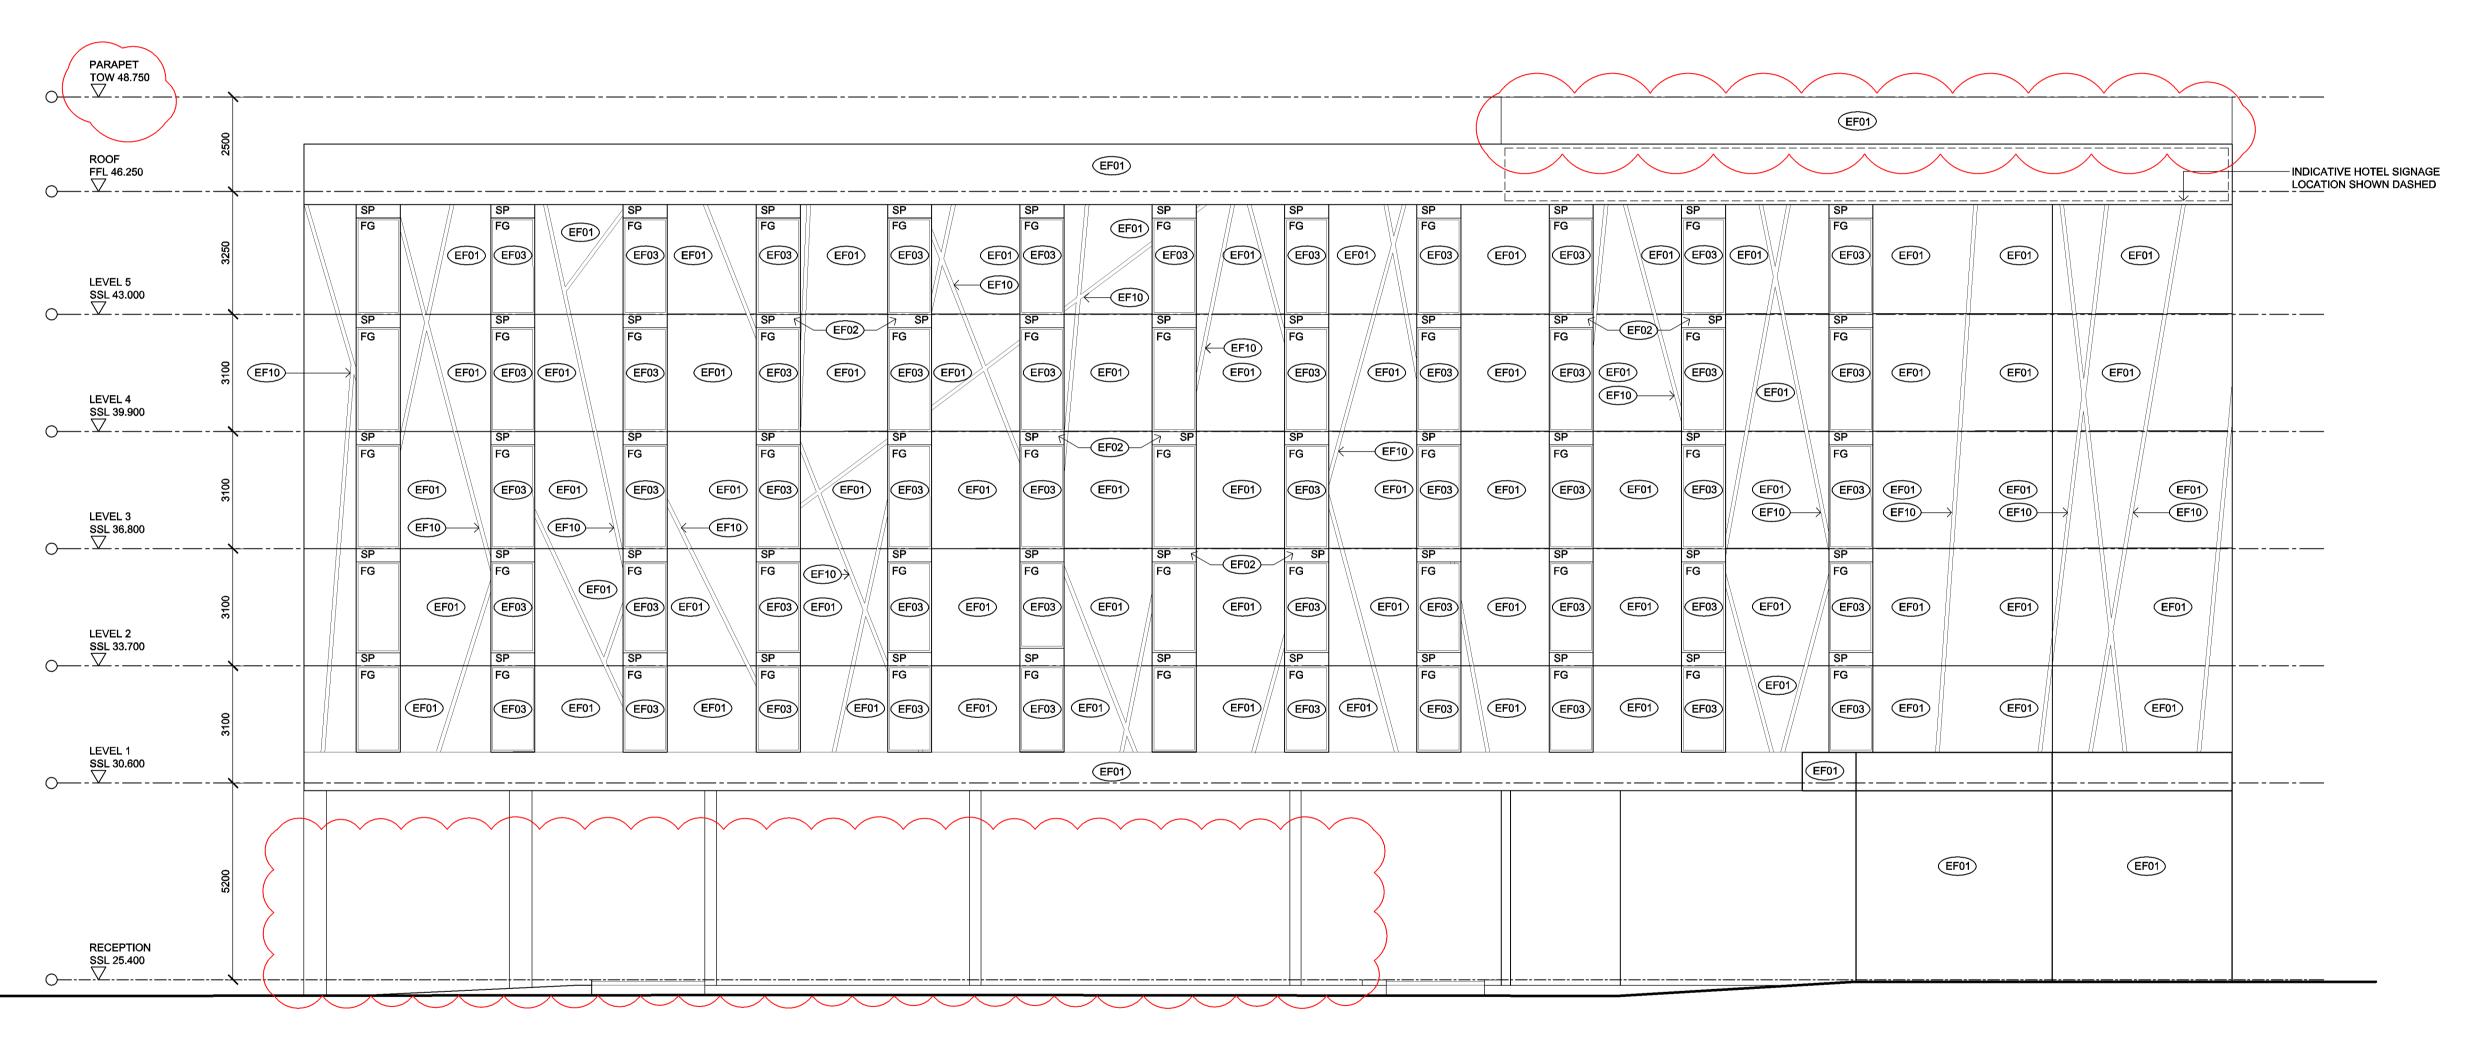



ELEVATION - 03


NORTH ELEVATION

	WMK Architecture L1 346-348 Kent Street Sydney NSW 2000 Telephone 02 9299 0401 Facsimile 02 9299 0402 wmkarchitecture.com ABN 25 082 956 929
Document Set ID: 7559471 Version: 1, Version Date: 07/03/2017	

Issue	Description	Date	issue	Description	Date	Client	Project
Α	ISSUED FOR DEVELOPMENT APPROVAL	17.05.16					
В	ISSUED FOR SECTION 96	25.01.17					

NORTH ELEVATION

Drawing No. DA502 **Drawing Size** 1:100 APRIL 2016

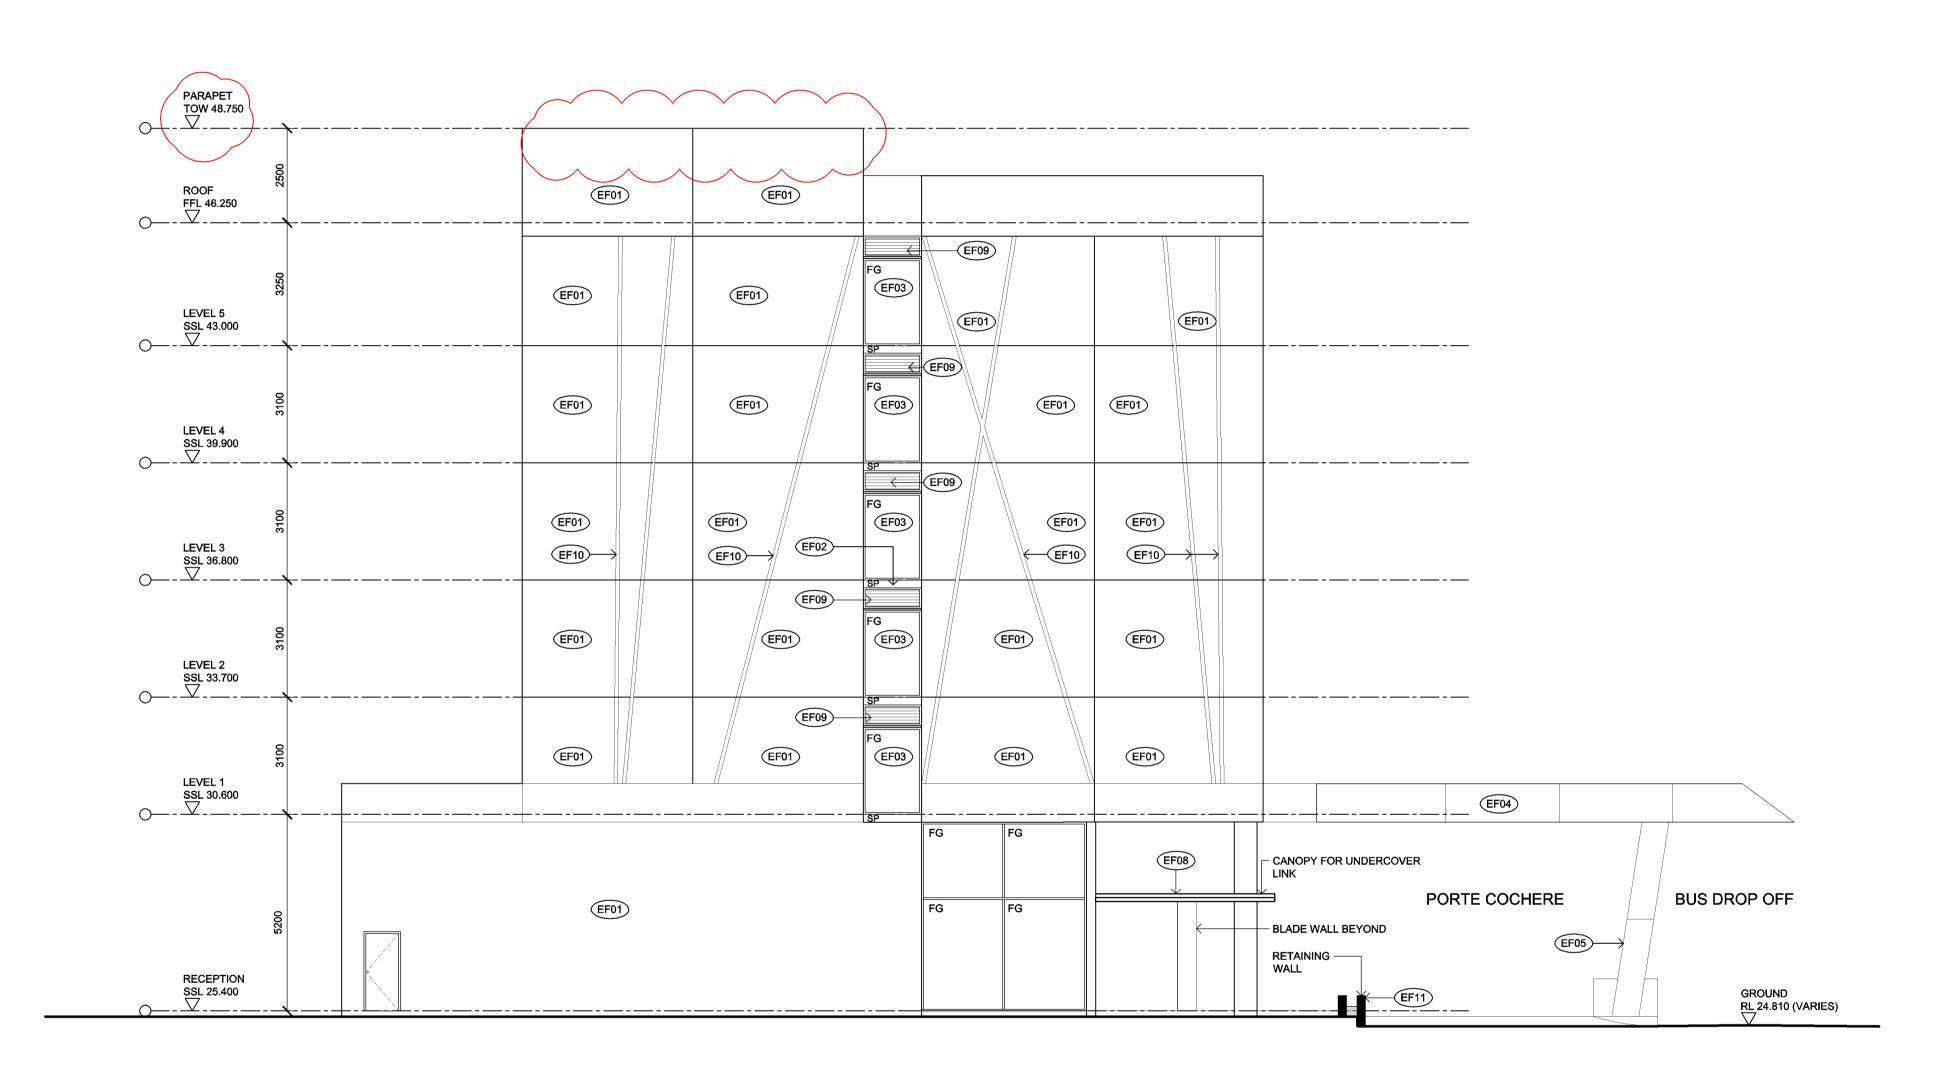

01	ELEVATION - 04	
<u>-</u>	WEST ELEVATION	



ISSUED FOR DEVELOPMENT APPROVAL 17.05.16 ISSUED FOR SECTION 96 25.01.17

WEST ELEVATION

Drawing No. **Drawing Size** Α1 APRIL 2016

Dimensioned Drawings to take precedence over scaling. Contractor to verify all dimensions on site before construction. All inconsistencies to be reported to the Architect immediately. This drawing and its contents remain the copyright of WMK Architecture Pty Ltd ©

FINISHES LEGEND

EF03

EF04

EF07

EF08

EF09

EF11

<u>LEGEND</u>

PRECAST CONCRETE PANELS WITH CHARCOAL COLOUR FINISH

COLOUR BACK GLASS INFILL SPANDREL PANEL (SP) TO

POWDER COATED ALUMINIUM BLADES WITH SUPPORT POST

COMPOSITE METAL PANEL CLADDING WITH EXPRESS JOINTS -

POWDER COATED ALUMINIUM LOUVRES TO MATCH WINDOW

ANODISED EXTRUDED ALUMINIUM BATTENS (NOM. 150MM X 100MM) WITH CONCEALED FIXING TO PRECAST SUBSTRATE -

TEXTURED CEMENT RENDERED BRICK WALL - LIGHT GRAY

POWDER COATED ALUMINIUM WINDOW FRAME -

COMPOSITE METAL PANEL CLADDING WITH EXPRESSED JOINTS - BRONZE COLOUR FINISH COMPOSITE ALUMINIUM PANEL CLADDING WITH EXPRESSED JOINTS - CHARCOAL FINISH COLOUR SHOP FRONT GLAZING SYSTEM WITH POWDER COATED ALUMINIUM FRAMES - REFER TO EF03

FIXINGS - COLOUR CHARCOAL FINISH

BRONZE COLOUR FINISH

FRAMES - REFER TO EF03

BRONZE COLOUR FINISH


COLOUR FINISH

FIXED GLASS SPANDREL PANEL

MATCH VISION GLAZING


BLACK COLOUR FINISH

DA503 Scale 1:100

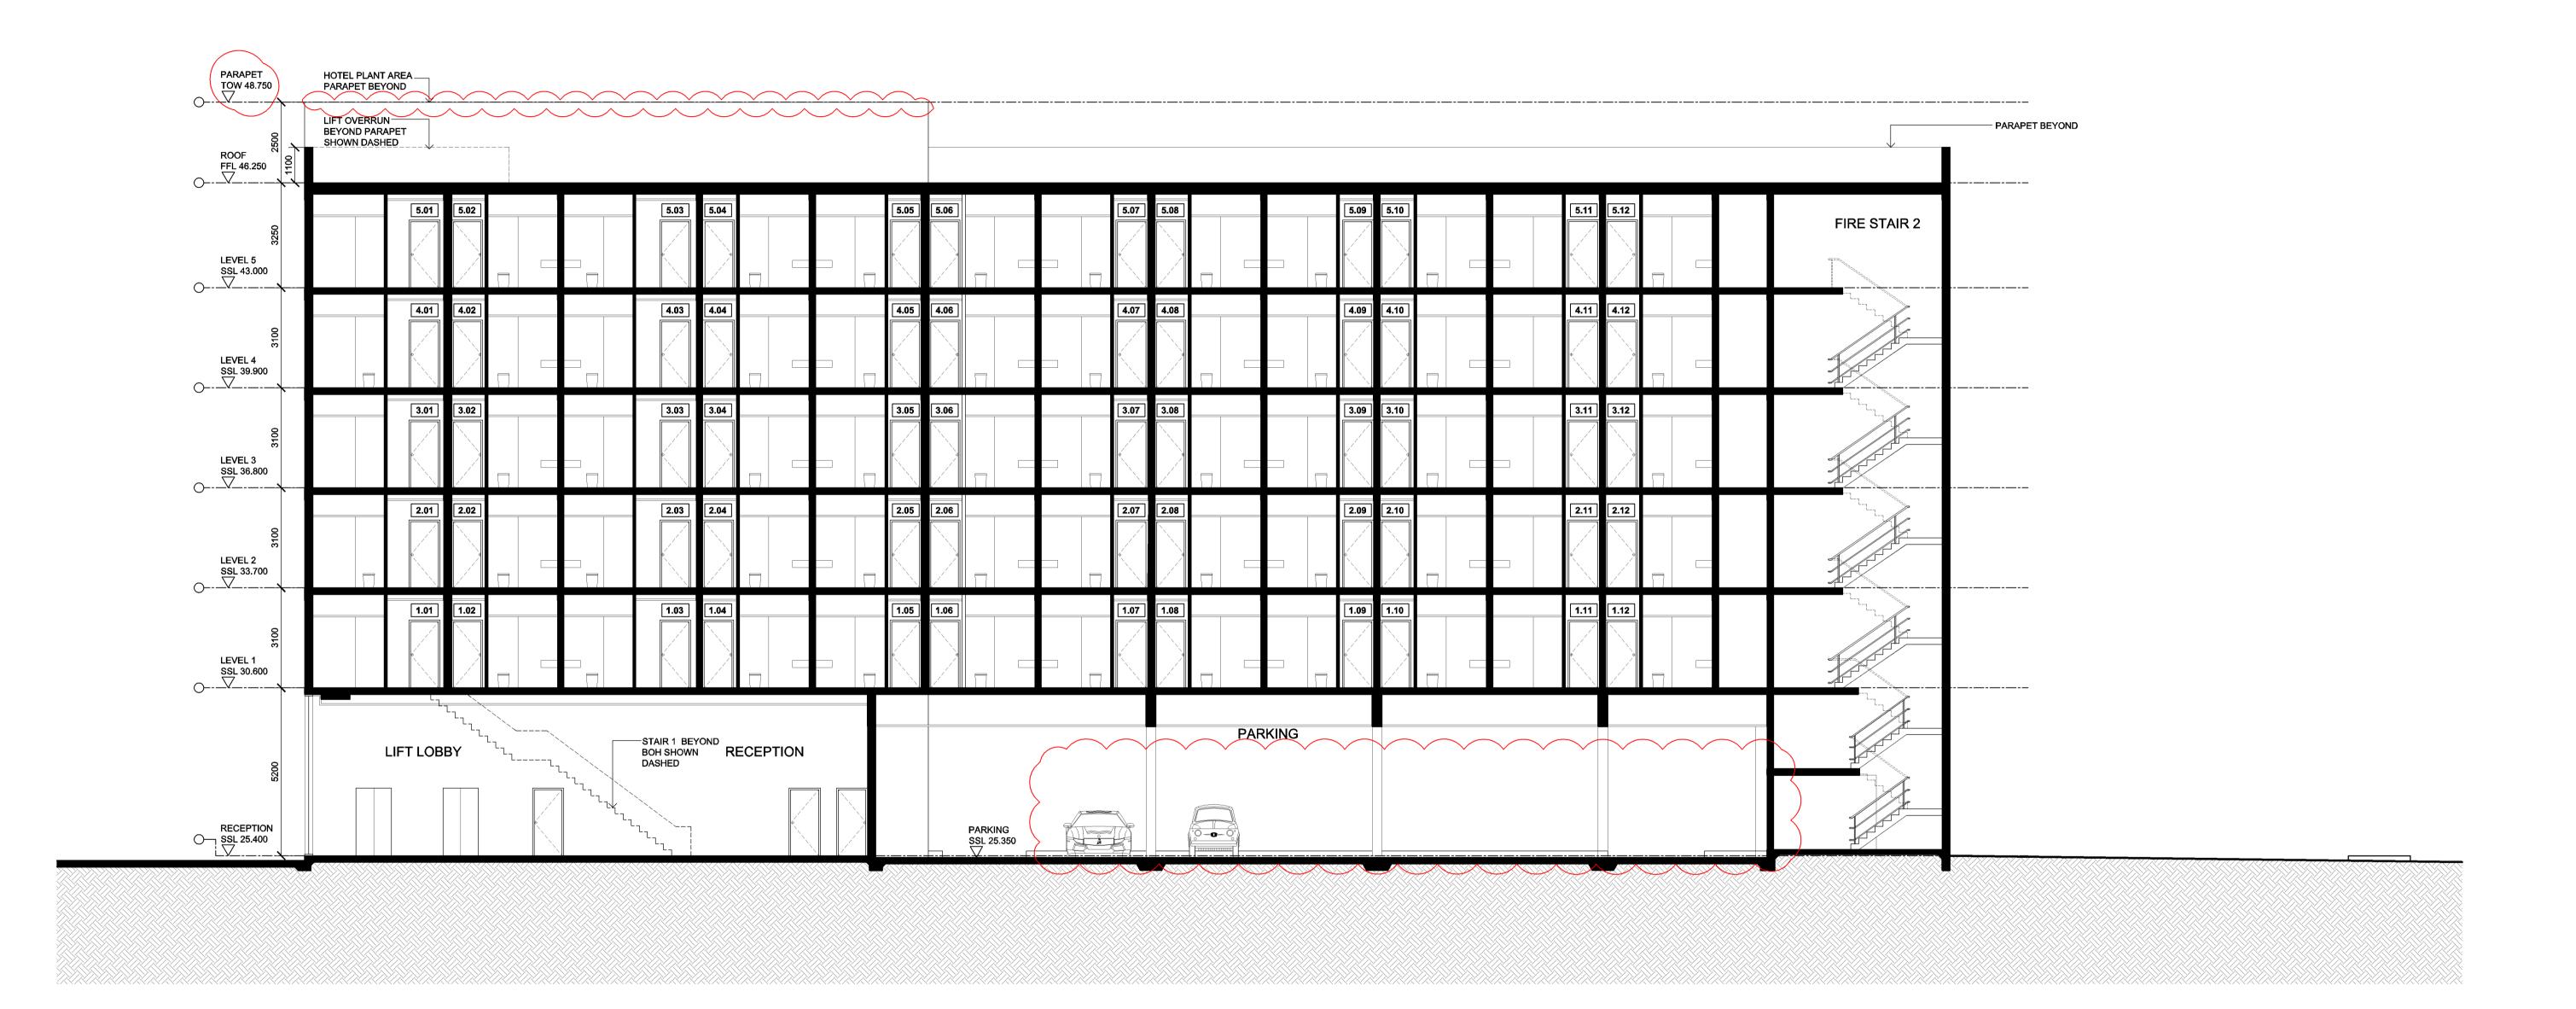



·			
Dimensioned Drawings to take precedence over scaling. Contractor to verify all dimensions on site before construction. All inconsistencies to be reported to the Architect immediately. Scale 1:100 Project Number Dat All CAD Reference			Issue B
Dimensioned Drawings to take precedence over scaling. Contractor to verify all dimensions on site before construction. All inconsistencies to be reported to the Architect immediately. CAD Reference	J		Drawing Size A1
on site before construction. All inconsistencies to be reported to the Architect immediately.			Drawn By BL
		CAD Reference	

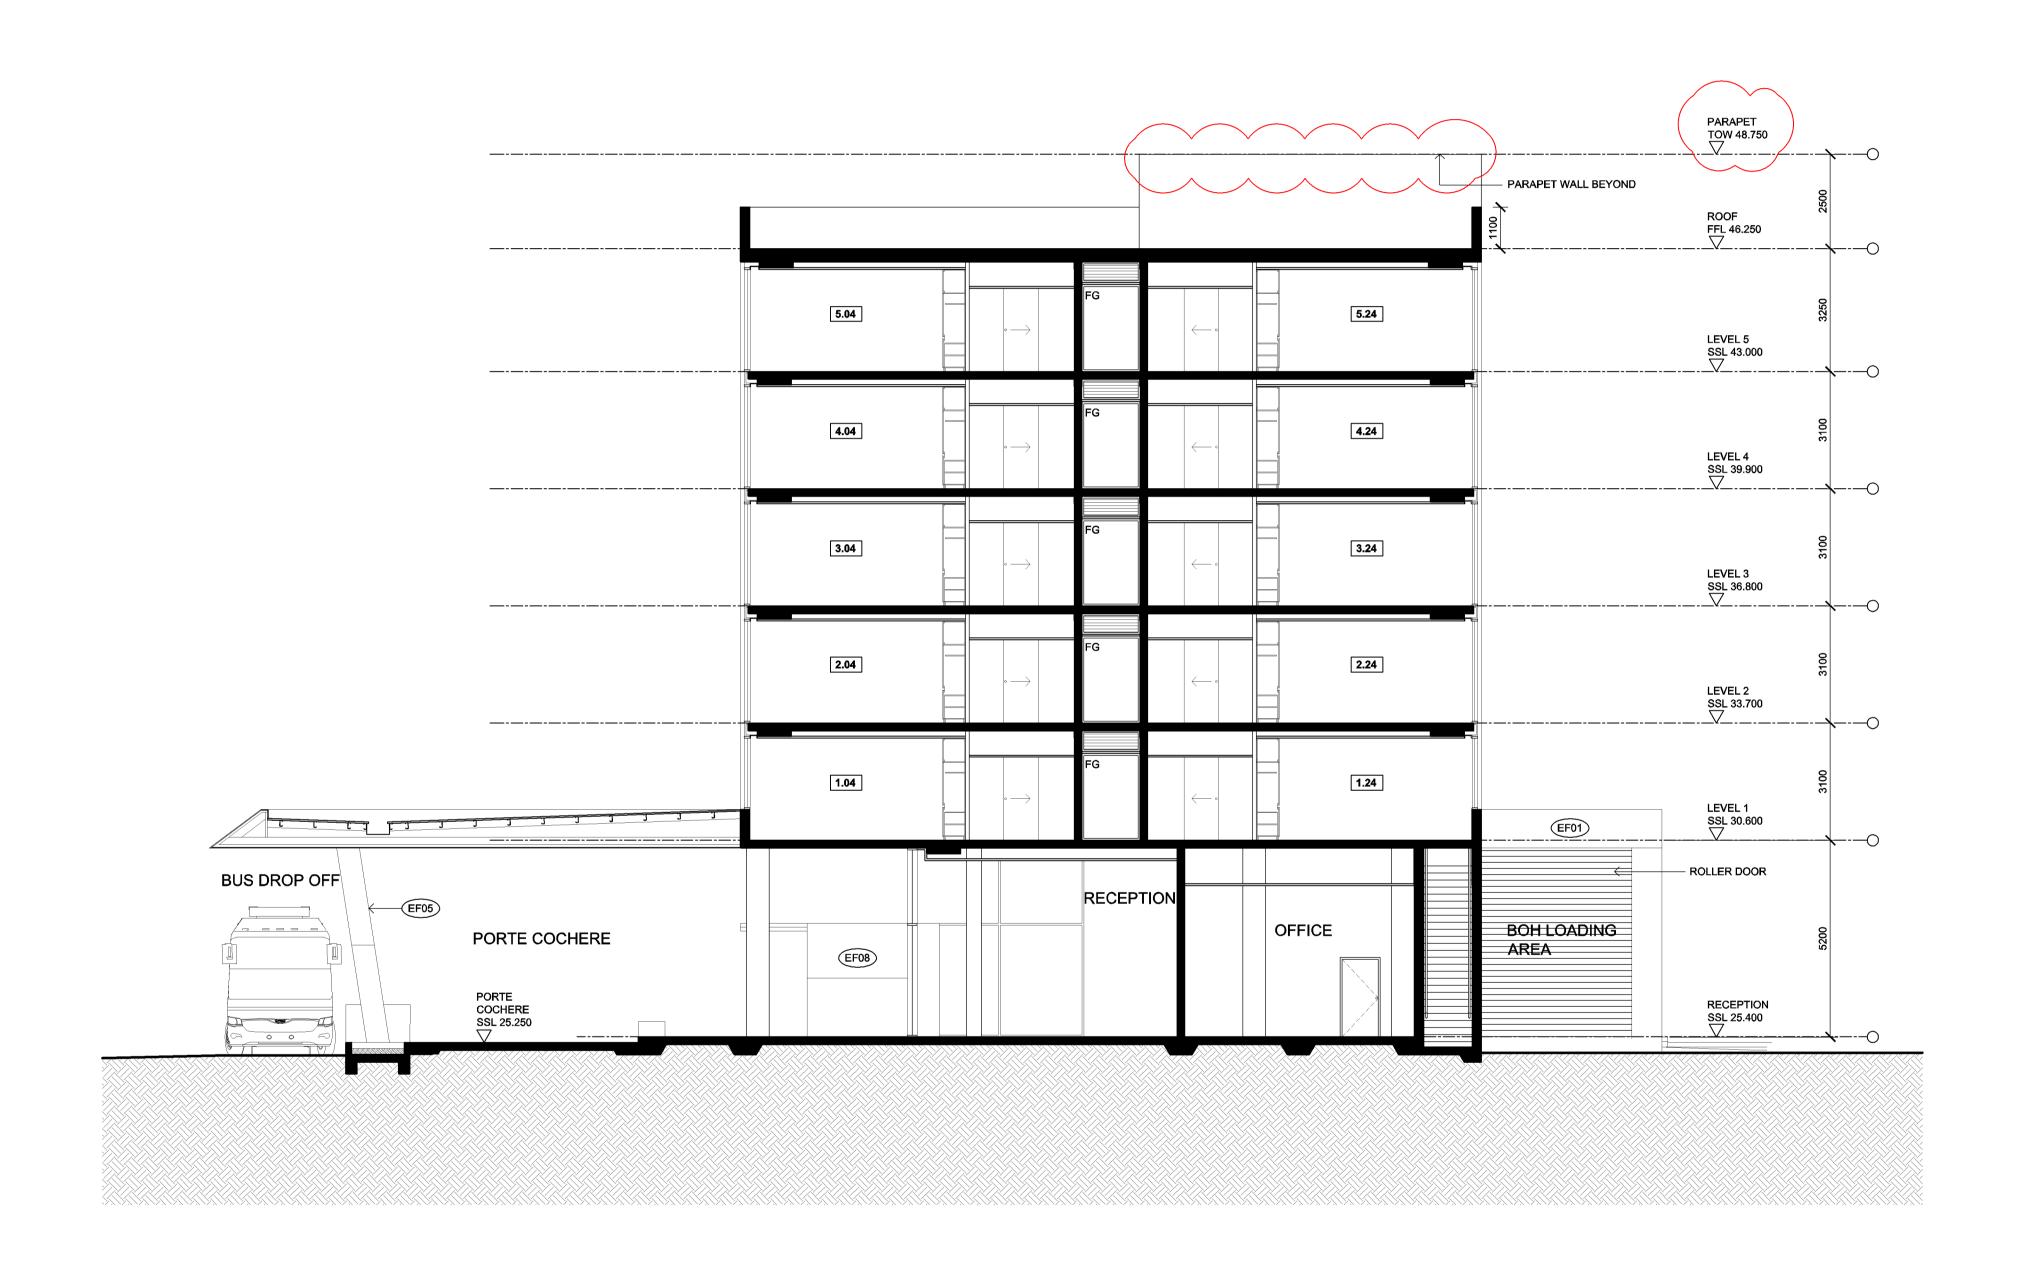




DescriptionDateISSUED FOR DEVELOPMENT APPROVAL17.05.16 SECTION B ISSUED FOR SECTION 96 25.01.17

Drawing No. DA601 Scale **Drawing Size** 1:100 Α1 APRIL 2016 BL



Attachment 2 – Car Park Turning Paths and Compliance Review

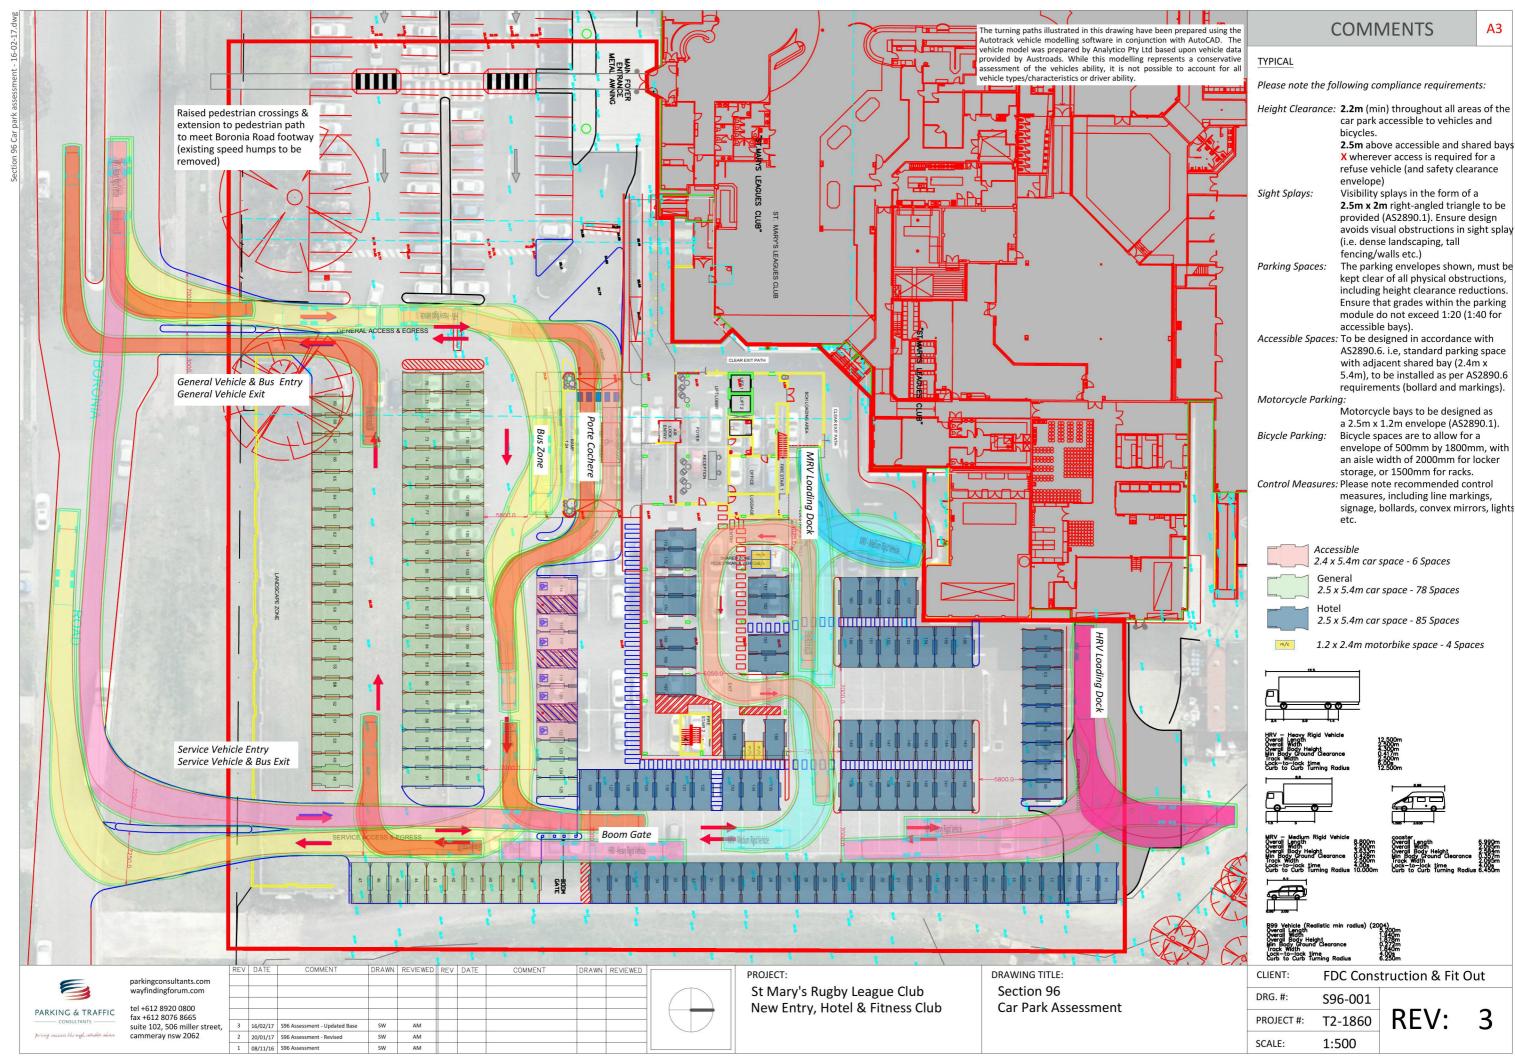

Document Set ID: 7559471 Version: 1, Version Date: 07/03/2017