
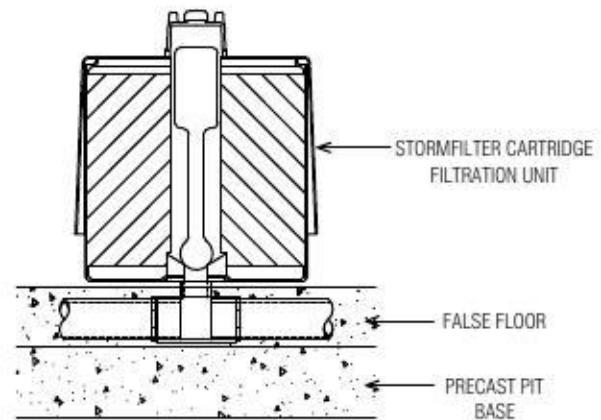
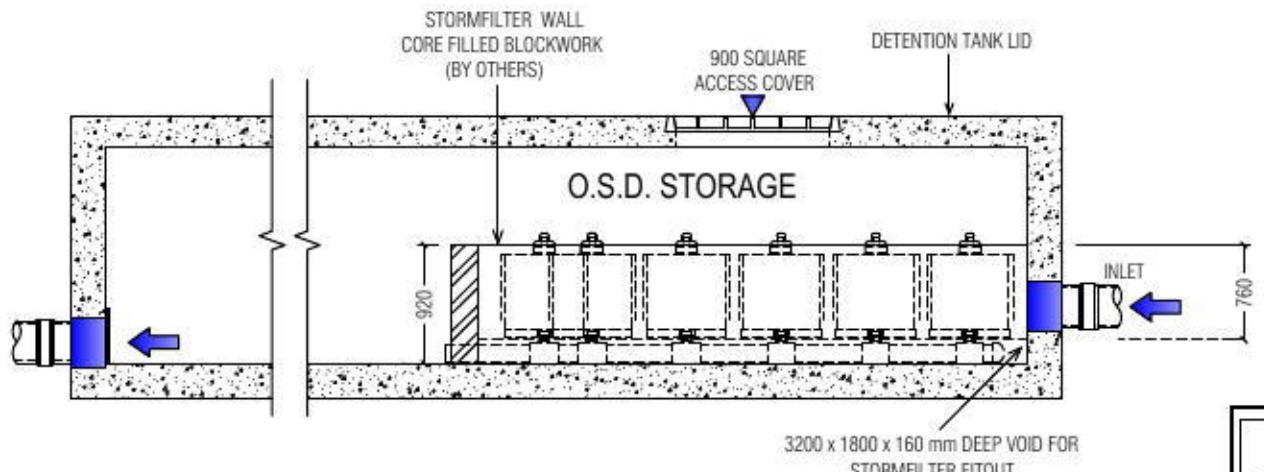


STORMFILTER DESIGN TABLE

- THE SIZE 3.2 x 1.8m STORMFILTER TREATMENT CAPACITY VARIES BY NUMBER OF FILTER CARTRIDGES INSTALLED AND BY REGION SPECIFIC INTERNAL FLOW CONTROLS.
- THE STANDARD CONFIGURATION IS SHOWN. ACTUAL CONFIGURATION OF THE SPECIFIED STRUCTURE(S) PER CIVIL ENGINEER WILL BE SHOWN ON SUBMITTAL DRAWING(S).
- ALL PARTS PROVIDED AND INTERNAL ASSEMBLY BY STORMWATER360 UNLESS OTHERWISE NOTED.

CARTRIDGE HEIGHT	690	460	310
SYSTEM HYDRAULIC DROP (H - REQ'D. MIN.)	930	700	550
TREATMENT BY MEDIA SURFACE AREA L/S/m ²	1.4	0.7	1.4
CARTRIDGE FLOW RATE (L/s)	1.42	0.71	0.95

GENERAL NOTES										
1. INLET AND OUTLET PIPING SHALL BE SPECIFIED BY SITE CIVIL ENGINEER (SEE PLANS) AND PROVIDED BY CONTRACTOR. STORMFILTER IS PROVIDED WITH OPENINGS AT INLET AND OUTLET LOCATIONS.										
2. IF THE PEAK FLOW RATE, AS DETERMINED BY THE SITE CIVIL ENGINEER, EXCEEDS THE PEAK HYDRAULIC CAPACITY OF THE PRODUCT, AN UPSTREAM BYPASS STRUCTURE IS REQUIRED. PLEASE CONTACT STORMWATER360 FOR OPTIONS.										
3. THE FILTER CARTRIDGE(S) ARE SIPHON-ACTUATED AND SELF-CLEANING. THE STANDARD DETAIL DRAWING SHOWS THE MAXIMUM NUMBER OF CARTRIDGES. THE ACTUAL NUMBER SHALL BE SPECIFIED BY THE SITE CIVIL ENGINEER ON SITE PLANS OR IN DATA TABLE BELOW. CONCRETE STRUCTURE TO BE PROVIDED BY OTHERS.										
4. SEE STORMFILTER DESIGN TABLE FOR REQUIRED HYDRAULIC DROP. FOR SHALLOW, LOW DROP OR SPECIAL DESIGN CONSTRAINTS, CONTACT STORMWATER360 FOR DESIGN OPTIONS.										
5. ALL WATER QUALITY PRODUCTS REQUIRE PERIODIC MAINTENANCE AS OUTLINED IN THE O&M GUIDELINES. PROVIDE MINIMUM CLEARANCE FOR MAINTENANCE ACCESS.										
6. STRUCTURE AND ACCESS COVERS DESIGNED BY OTHERS. ACCESS COVERS TO BE A MINIMUM 900X900 ABOVE CARTRIDGES.										
7. THE STRUCTURE THICKNESSES SHOWN ARE FOR REPRESENTATIONAL PURPOSES AND VARY REGIONALLY.										
8. ANY BACKFILL DEPTH, SUB-BASE, AND OR ANTI-FLOTATION PROVISIONS ARE SITE-SPECIFIC DESIGN CONSIDERATIONS AND SHALL BE SPECIFIED BY SITE CIVIL ENGINEER.										
9. CARTRIDGE HEIGHT AND ASSOCIATED DESIGN PARAMETERS PER STORMFILTER DESIGN TABLE.										
10. STORMFILTER BY STORMWATER360: SYDNEY (AU) PHONE: 1300 354 722 www.stormwater360.com.au										

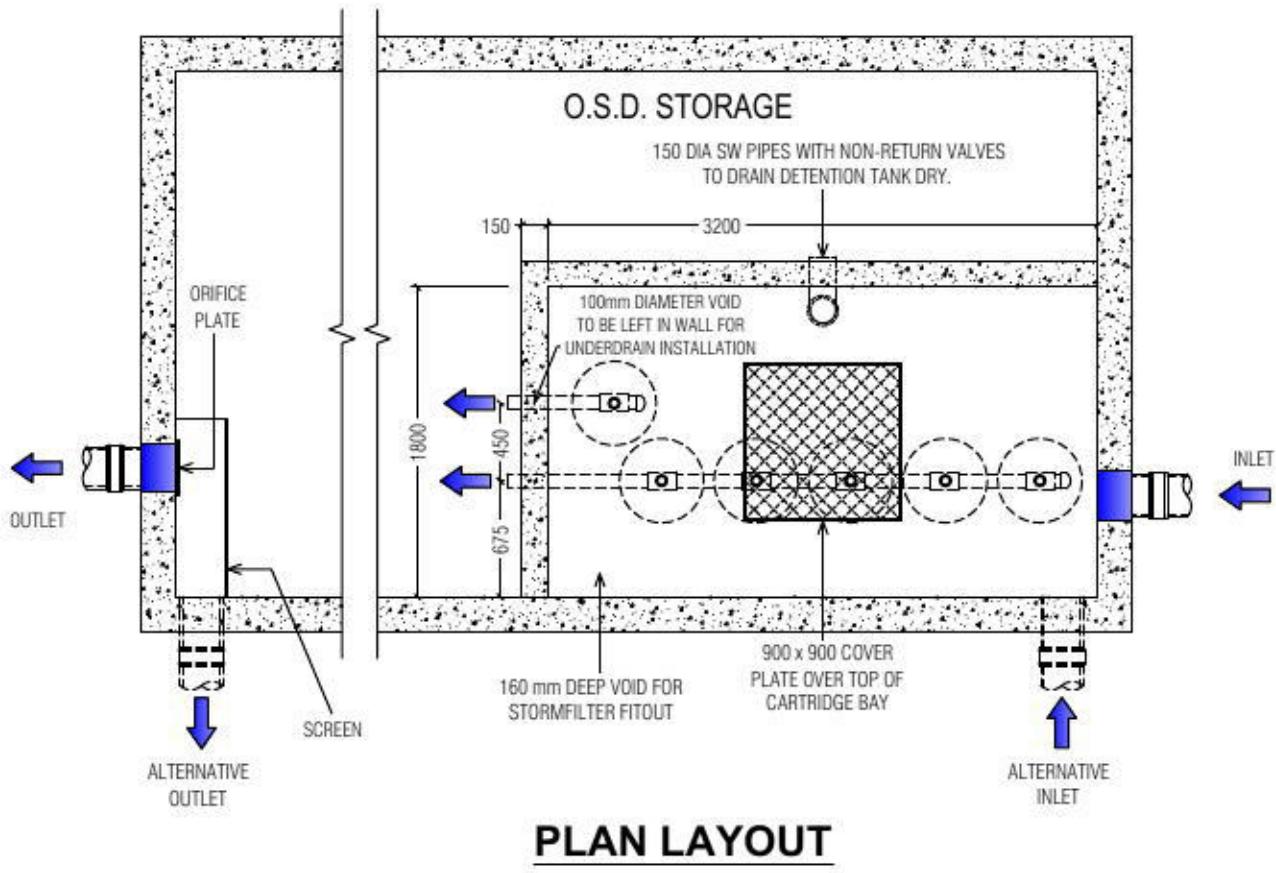


SITE SPECIFIC DATA REQUIREMENTS										
STRUCTURE ID	XXX									
WATER QUALITY FLOW RATE (L/S)	XXX									
PEAK FLOW RATE (L/S)	XXX									
RETURN PERIOD OF PEAK FLOW (yrs)	XXX									
# OF CARTRIDGES REQUIRED	XXX									
CARTRIDGE HEIGHT (310, 460 or 690mm)	690									
MEDIA TYPE (PERLITE, PERLITE/ZEOLITE OR ZPG)	XXX									
PRECAST VAULT WEIGHT	- kg									
PRECAST LID WEIGHT	- kg									
PIPE DATA:	I.L.	MATERIAL	DIAMETER							
INLET PIPE #1	XXX	MATERIAL	XXX							
INLET PIPE #2	XXX	MATERIAL	XXX							
OUTLET PIPE	XXX	MATERIAL	XXX							
RIM RLs										
UPSTREAM	XXX									
DOWNSTREAM										
FLOW	→	→								
LADDER	YES/NO									
ANTI-FLOTATION BALLAST	XXX	XXX								
	XXX	XXX								
NOTES/SPECIAL REQUIREMENTS:										



STORMWATER360
STORMFILTER DETENTION TANK
6 CARTRIDGE STORMFILTER SYSTEM
FIRST FLUSH GENERAL ARRANGEMENT


DRAWING
1
A

DATE: 15.03.12 FILE NAME: 6C-DET-TANK-STD-690 DRN: R.P. CHK: A.M.

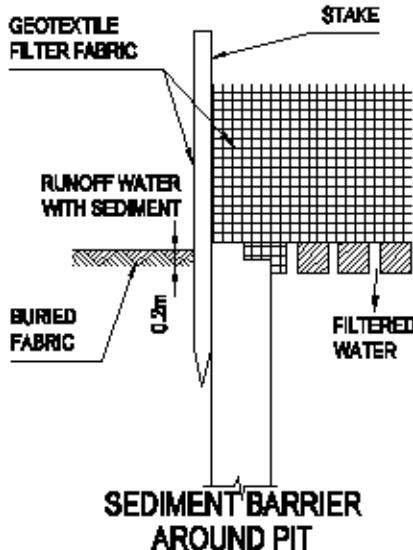

CONSTRUCTION NOTES

1. FABRICATE A SEDIMENT BARRIER MADE FROM GEOTEXTILE
2. SUPPORT GEOTEXTILE WITH MESH TIED TO POSTS AT 1000mm CENTRES.
3. DO NOT COVER INLET WITH GEOTEXTILE.
4. INSTALL & SUPPORT GEOTEXTILE AS PER SITE FENCE BARRIER DETAIL.


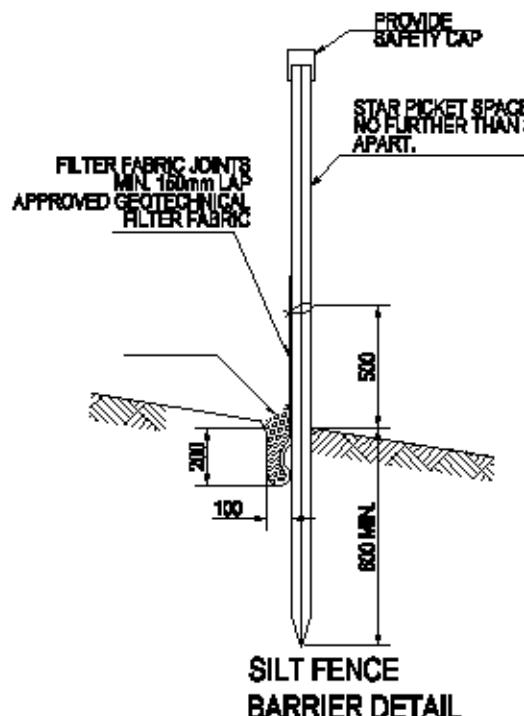


PROVIDE SILT FENCE AT BOUNDARY
OF SITE AS SHOWN ON PLAN

EROSION & SEDIMENT CONTROL

1. Sediment control devices are to be in place prior to any demolition or contraction.
2. Construct a silt barrier fence where shown on plan and to details above.
3. Sediment control devices are to be maintained, in good working order, until completion of all site works or to the satisfaction of Council's supervising officer.
4. Provide HAY BALE BARRIERS around all existing surface inlet pits during concreting.
5. Install stabilised site access as per detail over.

AREA CALCULATIONS	
SITE AREA	2090.32 Sqm
EXISTING SITE	
BUILDING	:1016.50 Sqm
SHEDS	:73.20 Sqm
CARPORT/DRIVeway	:224.50 Sqm
TOTAL IMPERVIOUS AREA	:1313.20 Sqm
PERCENTAGE	:62.42%
PROPOSED SITE	
BUILDING	:1434.50 Sqm
DRIVeway	:41.90 Sqm
PAVED AREA	:74.95 Sqm
TOTAL IMPERVIOUS AREA	:1551.35 Sqm
PERCENTAGE	:74.22%
AS PER COUNCIL STORMWATER DCP STORMWATER MANAGEMENT PLAN	
1. INSTALLATION OF PIPE SYSTEM	
2. O&G	
3. PUMP OUT SYSTEM-BASEMENT	

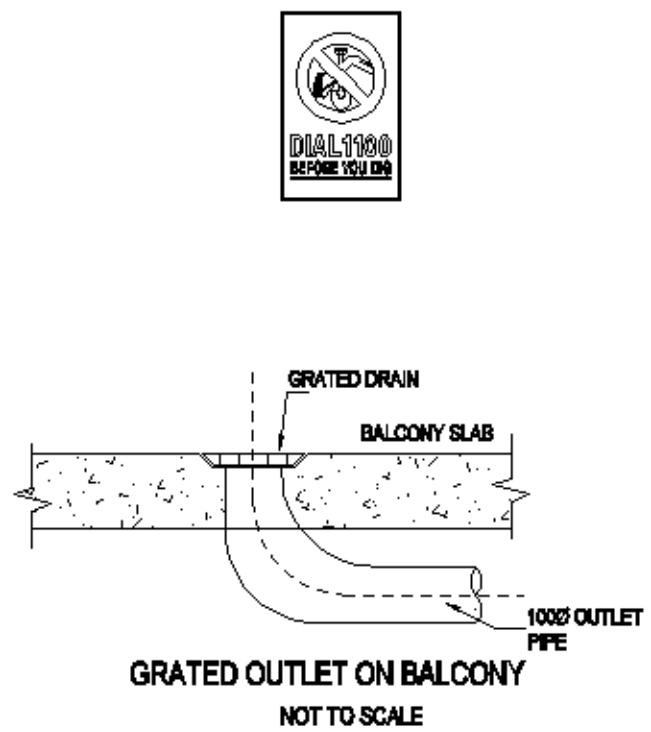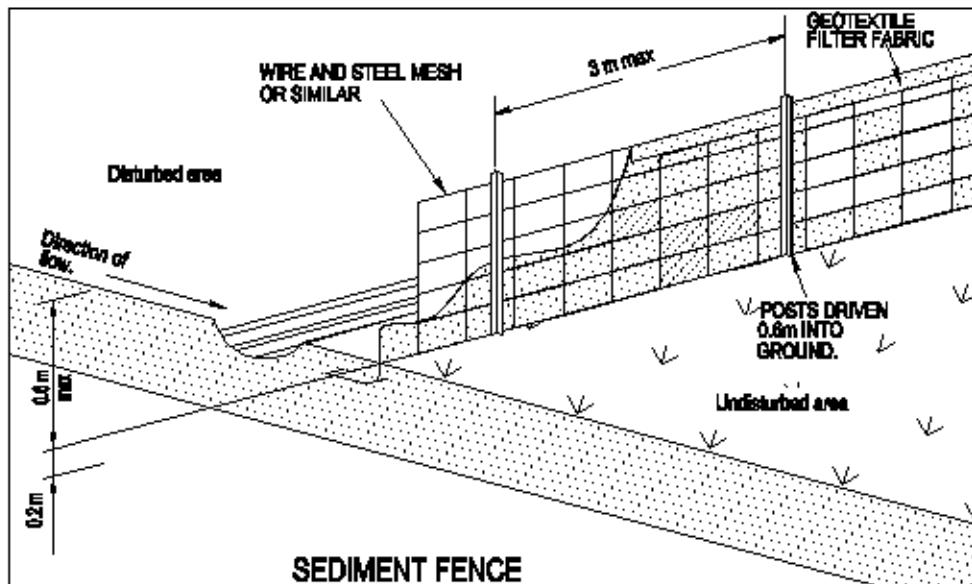


IMPORTANT

All existing services shown on this plan are approximate location only. The contractor is to verify the exact location and level of all existing services prior to commencement of excavation work for pipe laying. The contractor is to meet the full cost to relocate or adjust Telstra, Energy Australia, Sydney water or Natural gas services as required.

SYMBOLS & NOTATIONS

— — — — —	STORMWATER DRAINAGE LINE
□	GRATED INLET PIT
G.	DESIGNED GRATE LEVEL
I.	INVERT LEVEL OF PIPE
DP	DOWN PIPE 200mm OR 100x75mm
RL	REDUCED LEVEL (DESIGNED)
— — — — —	SILT BARRIER FENCE
←	SURFACE RUNOFF DIRECTION
VD	VERTICAL DROP @100mm

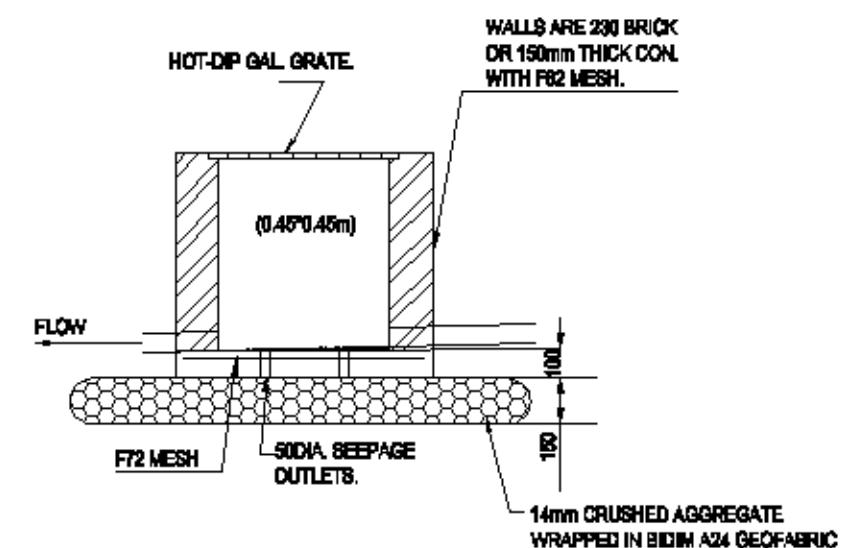

TYPICAL INLET PIT DETAIL
(NOT TO SCALE)

ABBREVIATED ROOF WATER RUNOFF CALCULATIONS

ARI = 1:100 yr.

I = 206.10mm/hr.

T₀ = 6 mm.

C = 1

Q = CIA3600 l/s

RUNOFF RATE FOR EACH CATCHMENT
AREAS ARE MARKED ON THE PLAN.

IMPORTANT

All existing services shown on this plan are approximate location only. The contractor is to verify the exact location and level of all existing services prior to commencement of excavation work for pipe laying. The contractor is to meet the full cost to relocate or adjust Telstra, Energy Australia, Sydney water or Natural gas services as required.

A	06/12/15	ISSUED FOR DA	REVISIONS
ISSUE:	DATE:		
			ISSUED FOR CONSTRUCTION
			DRAWN: MM
			DATE: 06/12/15
			SCALE: AS NOTED
	JOB No: 7604		JOB No: 7604
			SHEET No: 02 OF 07



NASTASI & ASSOCIATES
CONSULTING CIVIL & STRUCTURAL ENGINEERS

B.E., M.I.E. AUST. CPENG NPER-3

ABN 45 003 221 004


Pt (02) 8807 2864 OR (02) 8796 6617 FAX: (02) 8731 2081

Mob: 0419 041 401

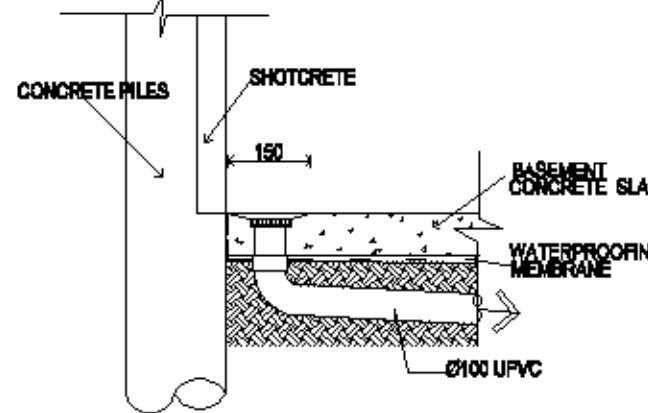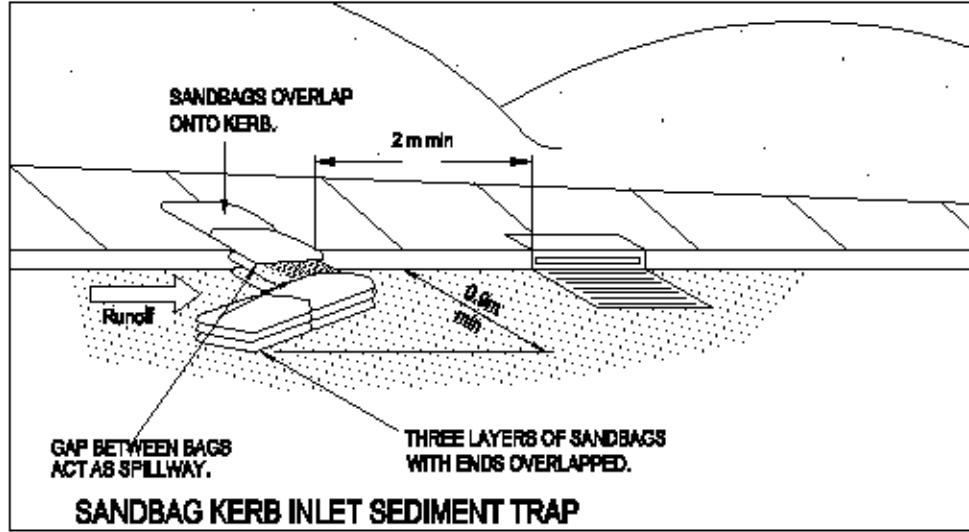

**SPOON DRAIN OUTLET
FOR CONTIGUOUS PILING WALLS
OR PILES WITH SHOTCRETE**

NOT TO SCALE

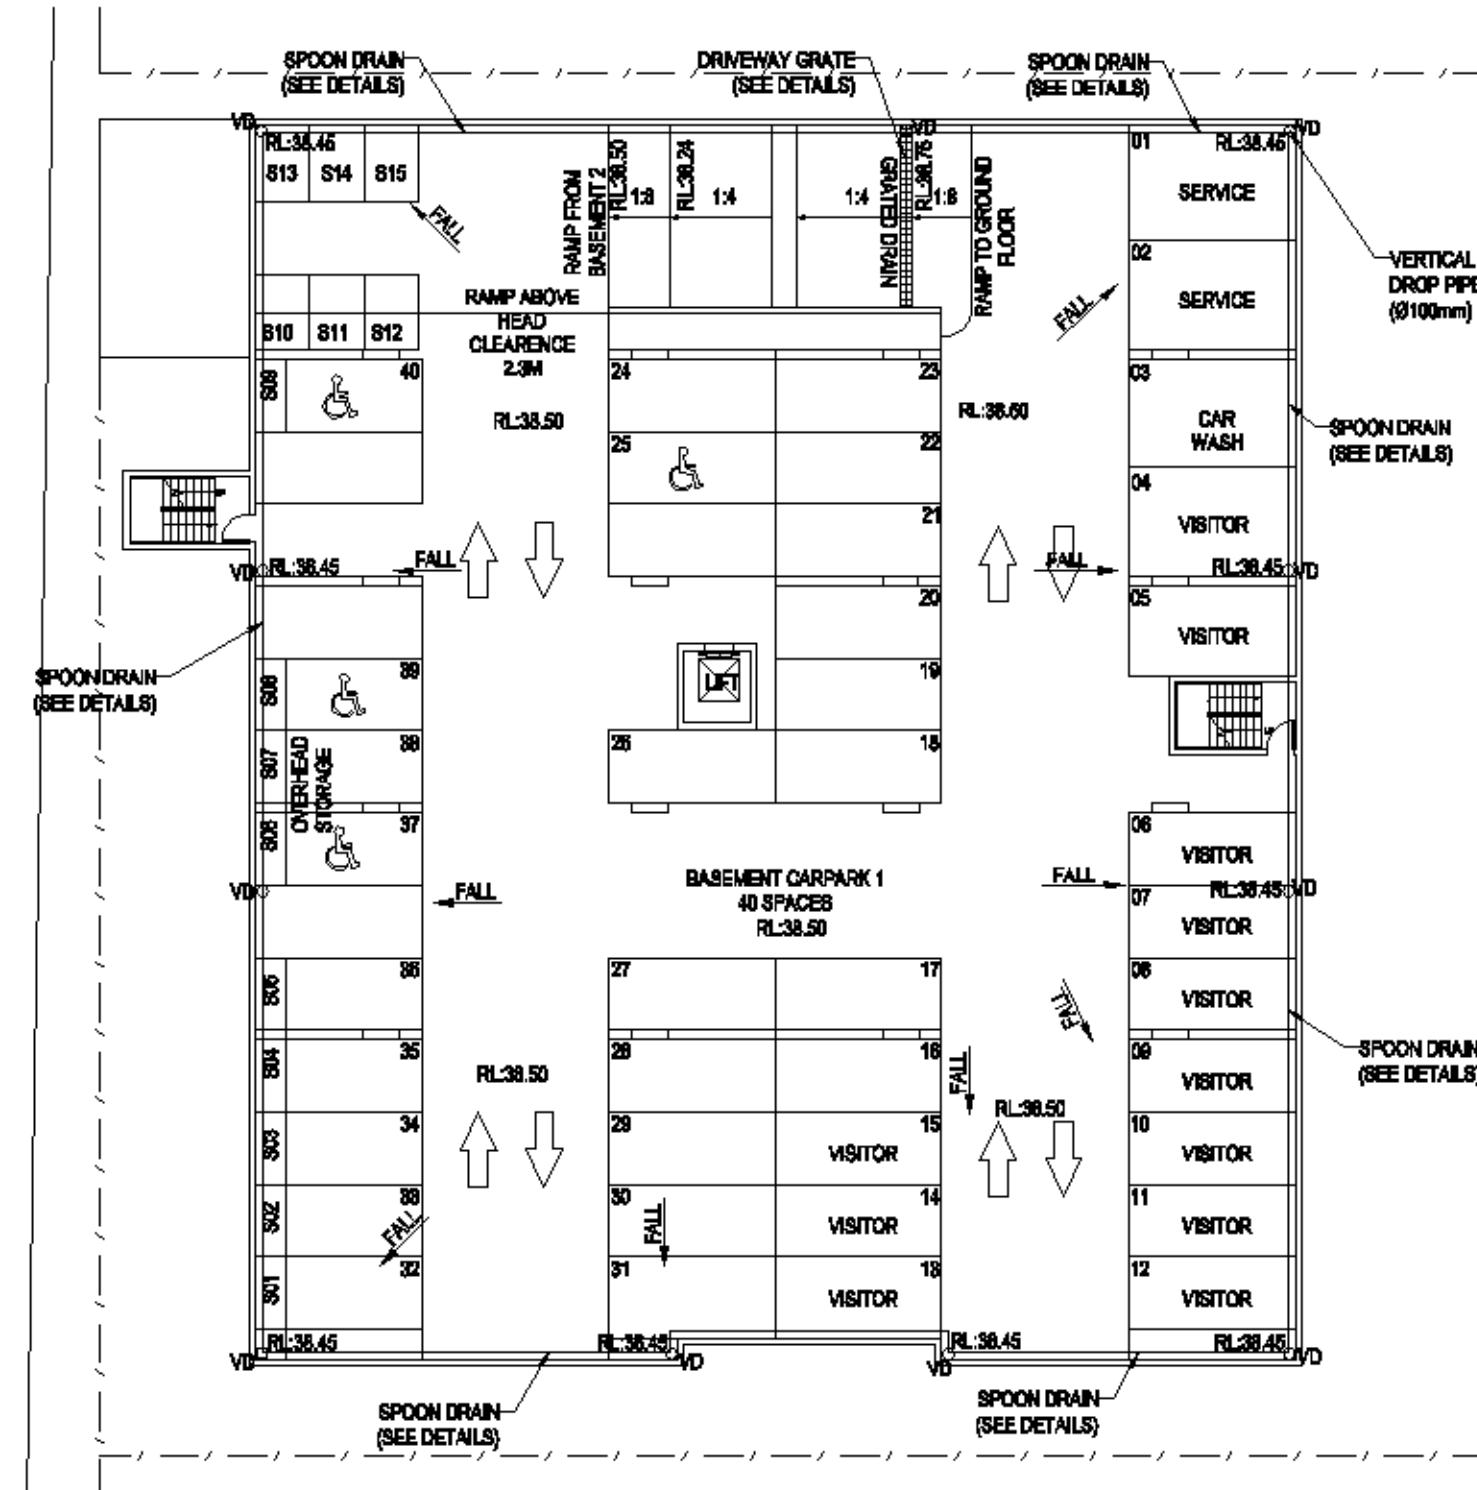

PROPOSED STORMWATER SYSTEM AT BASEMENT-1 CARPARK

SCALE 1:250 IN A.D.

A	08/12/16	ISSUED FOR DA	
ISSUE:	DATE:	REVISIONS	
TITLE: STORMWATER AND SEDIMENT MANAGEMENT PLAN		ISSUED FOR CONSTRUCTION	
		DRAWN: MM	
		DATE: 08/12/15	
		SCALE:	AS NOTED
		JOB No: 7804	SHEET No: 08 OF 07





NASTASI & ASSOCIATES
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B.E., M.I.E. AUST. CPENG NPER-3

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PH (02) 8707 2884 OR (02) 8700 6617 FAX: (02) 8731 2081
MOB: 0419 041 401

ANSWER

CONCEPT PLAN

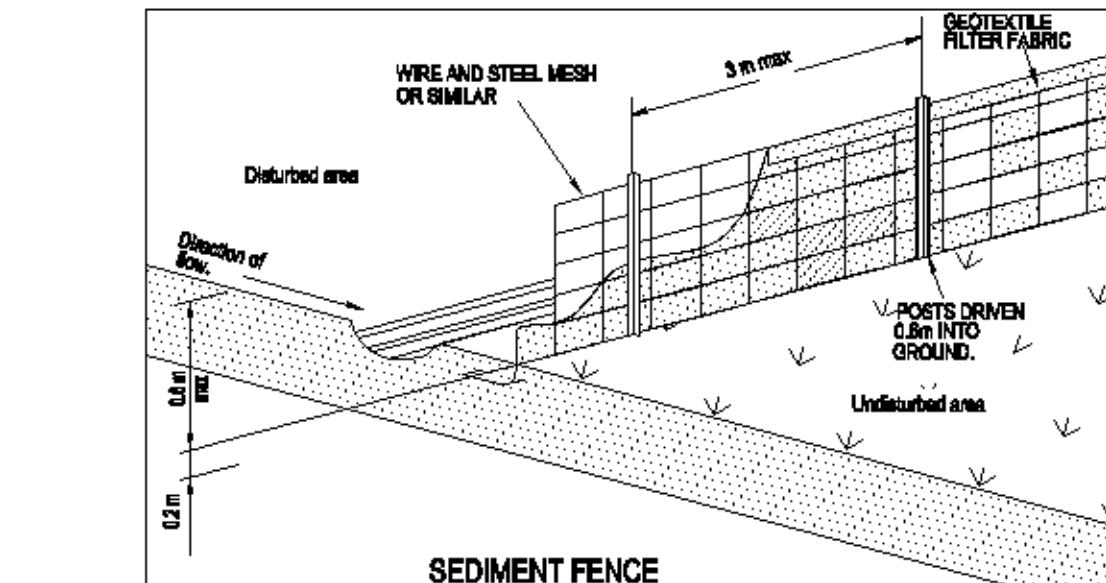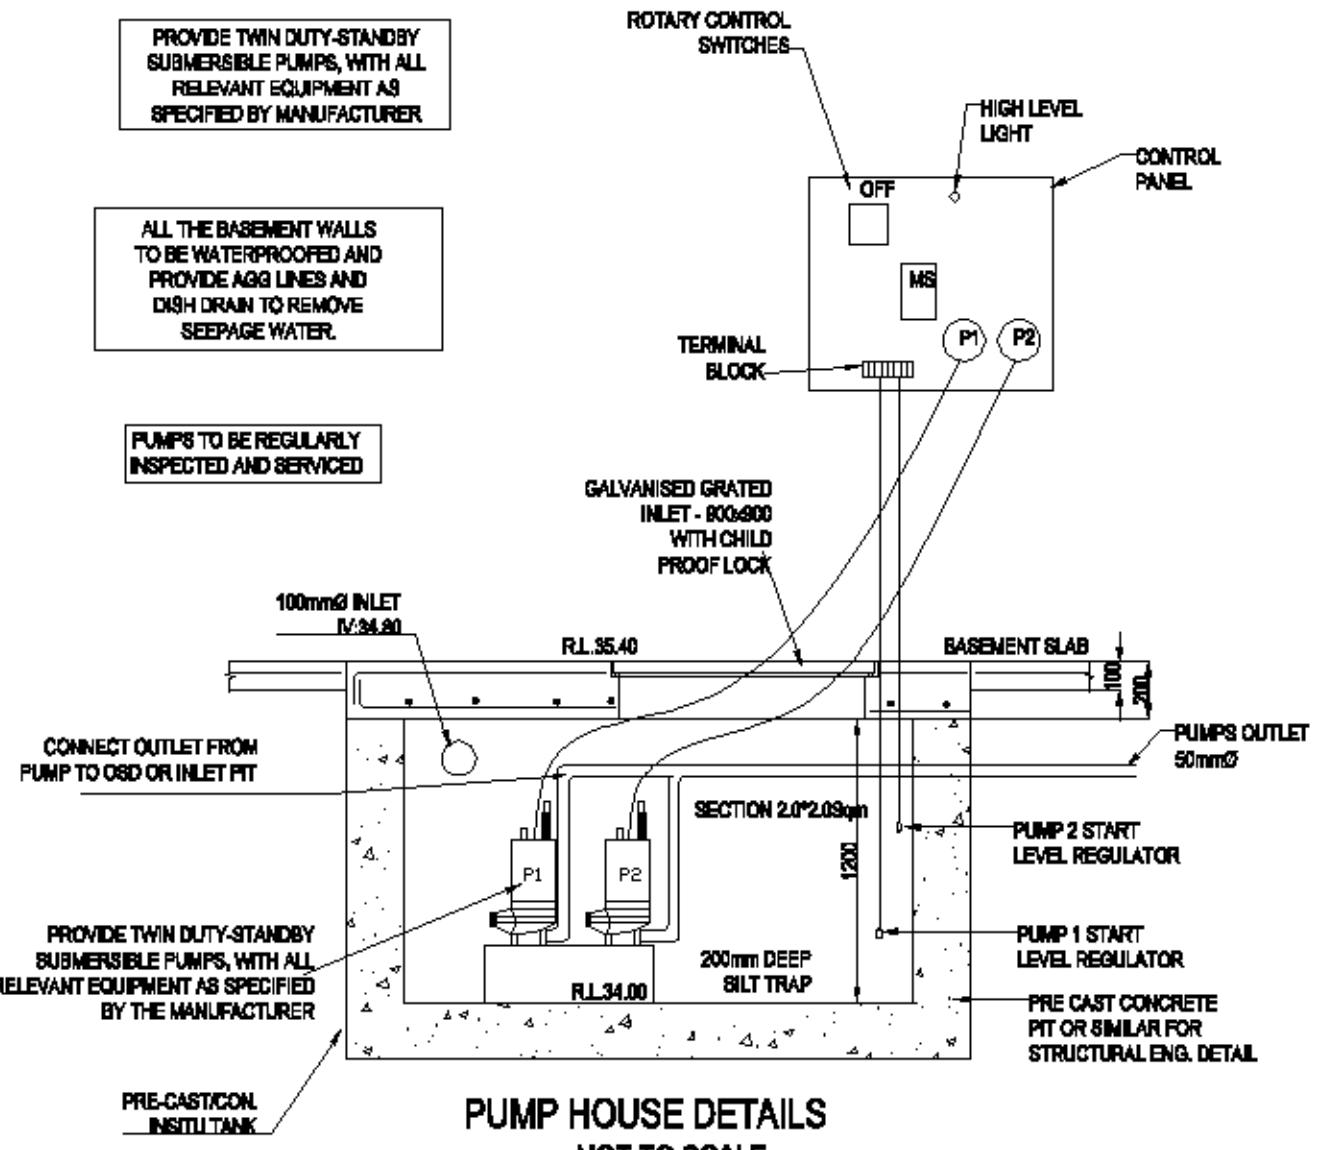

PUMP SPECIFICATIONS

STANDARD PUMP-OUT NOTES

THE PUMP-OUT SYSTEM IS DESIGNED TO WORK IN THE FOLLOWING MANNER:-

1. THE PUMPS SHALL BE PROGRAMMED TO WORK ALTERNATELY SO AS TO ALLOW BOTH PUMPS TO HAVE EQUAL OPERATION LOAD & PUMP LIFE.
 2. A LOW LEVEL FLOAT SHALL BE PROVIDED TO ENSURE THAT THE MINIMUM REQUIRED WATER LEVEL IS MAINTAINED WITHIN THE SUMP AREA OF THE BELOW GROUND TANK. IN THIS REGARD THIS FLOAT WILL FUNCTION AS AN OFF SWITCH FOR THE PUMPS.
 3. A SECOND FLOAT SHALL BE PROVIDED AT A HIGHER LEVEL, APPROXIMATELY 300mm ABOVE THE MINIMUM WATER LEVEL, WHEREBY ONE OF THE PUMPS WILL OPERATE & DRAIN THE TANK TO THE LEVEL OF THE LOW LEVEL FLOAT.
 4. A THIRD FLOAT SHALL BE PROVIDED AT A HIGH LEVEL, WHICH IS APPROXIMATELY THE ROOF LEVEL OF THE BELOW GROUND TANK. THIS FLOAT SHOULD START THE OTHER PUMP THAT IS NOT OPERATING & ACTIVATE THE ALARM.
 5. AN ALARM SYSTEM SHALL BE PROVIDED WITH A FLASHING STROBE LIGHT & A PUMP FAILURE WARNING SIGN WHICH ARE TO BE LOCATED AT THE DRIVEWAY ENTRANCE TO THE BASEMENT LEVEL. THE ALARM SYSTEM SHALL BE PROVIDED WITH A BATTERY BACK-UP IN CASE OF POWER FAILURE.

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	SCALE:	AS NOTED
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UNIT 5, 13 WHYALLA PLACE, PRESTONS NSW 2170
PH: (02) 8007 2884 OR (02) 8700 6817 FAX: (02) 9731 2081
MOB: 0418 041 401

APPROVED:

CLIENT: CHRIS KHOURY

CLIENT No: 7804

**PROJECT: 115-119 DERBY STREET
PENRITH**

**TITLE: STORMWATER AND SEDIMENT
MANAGEMENT PLAN**

ISSUED FOR CONSTRUCTION

DRAWN: MM

DATE: 09/09/15

10 of 10



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ANSWER




DESIGN AND CONSTRUCTION
OF SUBSOIL DRAINAGE
AS PER AS3500.3-1990

ALL THE BASEMENT WALLS
TO BE WATERPROOFED AND
PROVIDE AGG LINES AND
SPOON DRAIN TO REMOVE
SEEPAGE WATER.

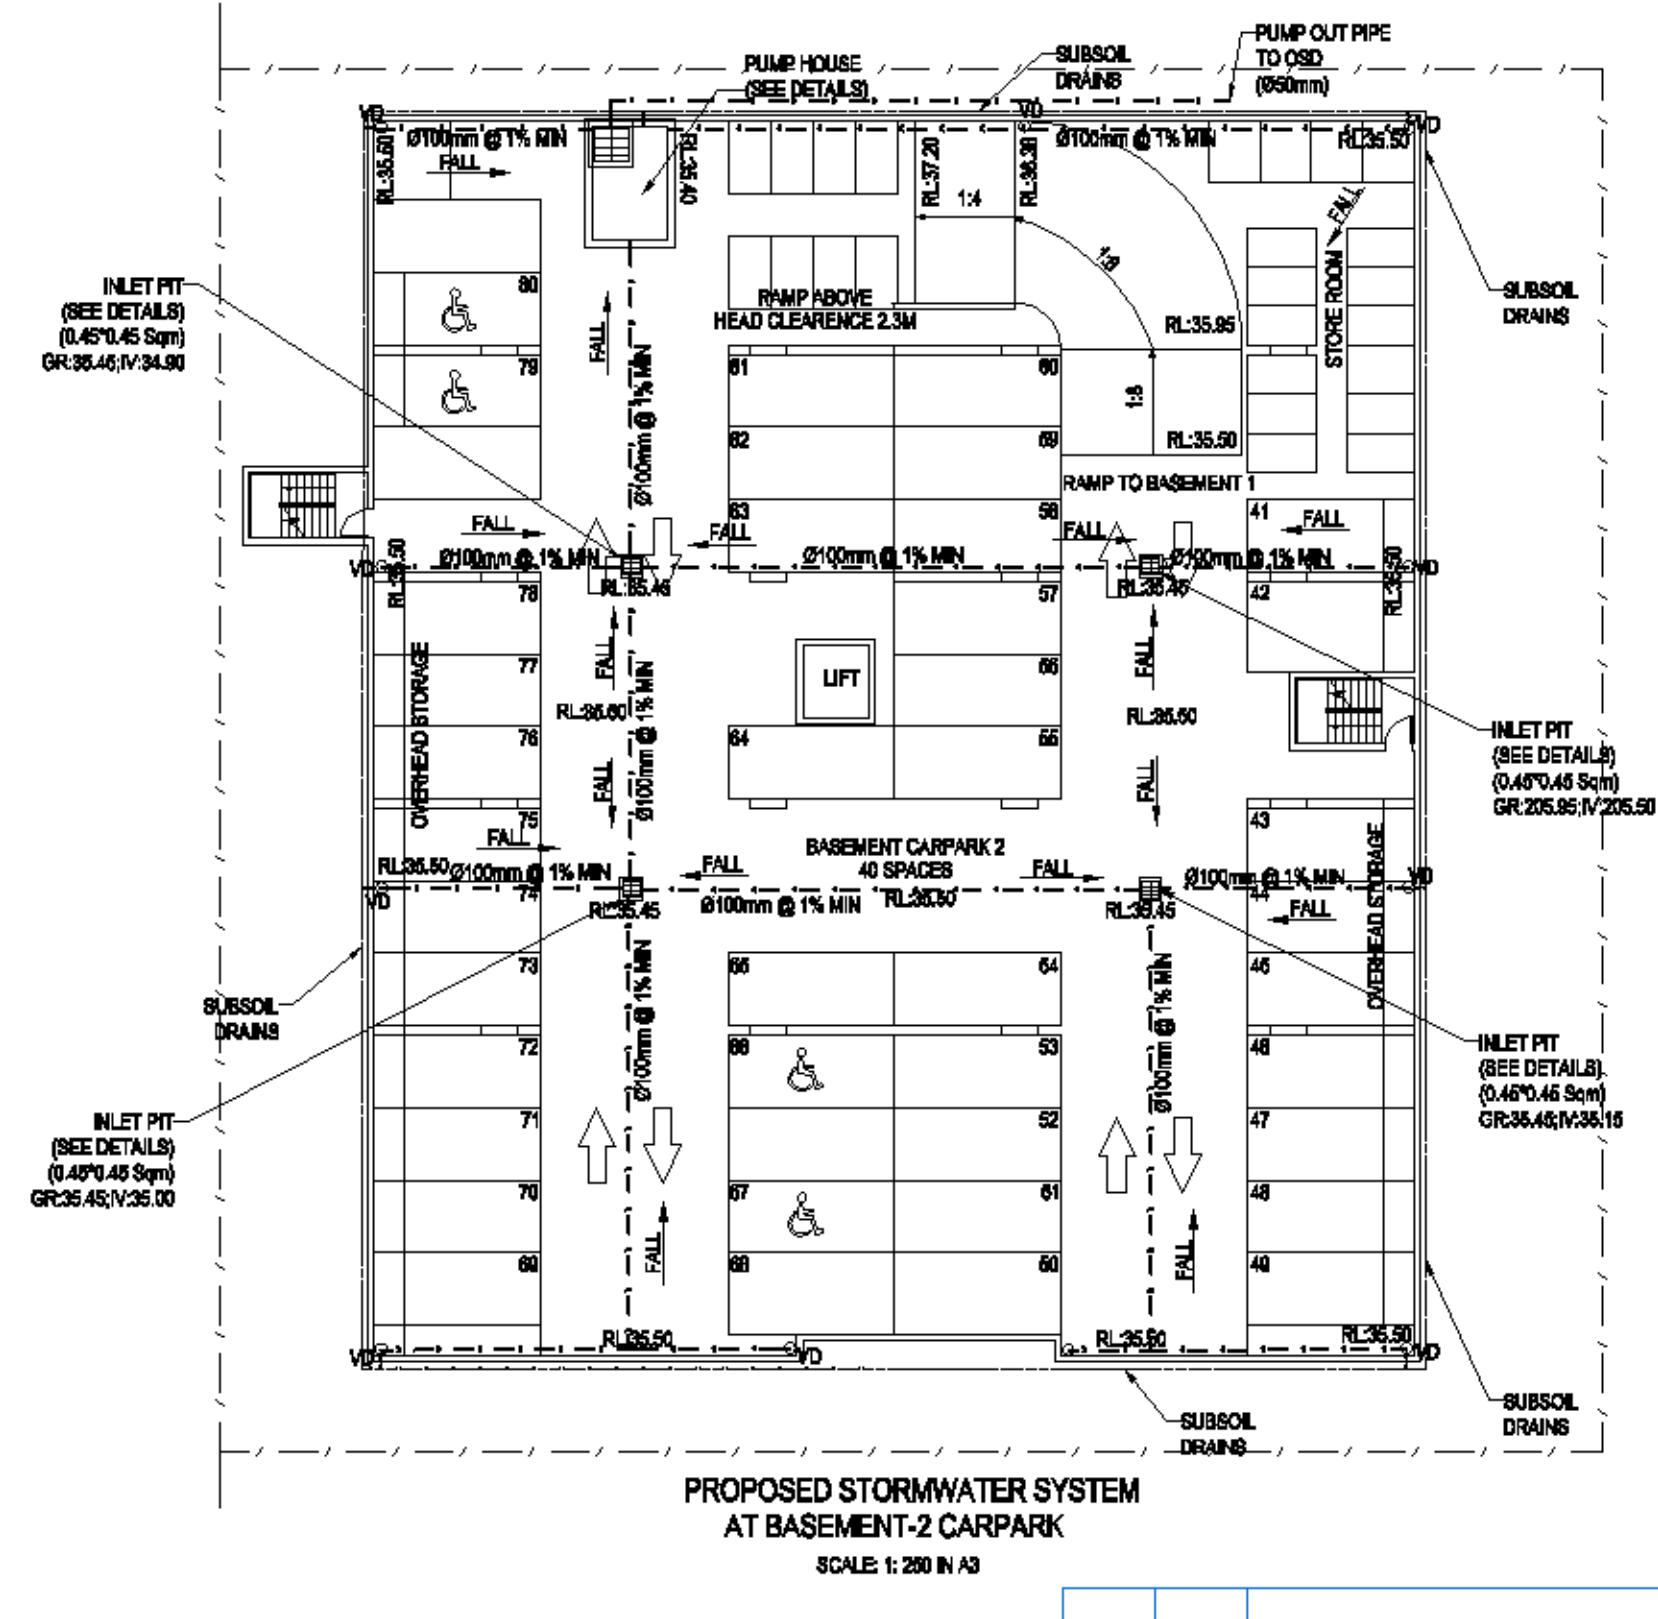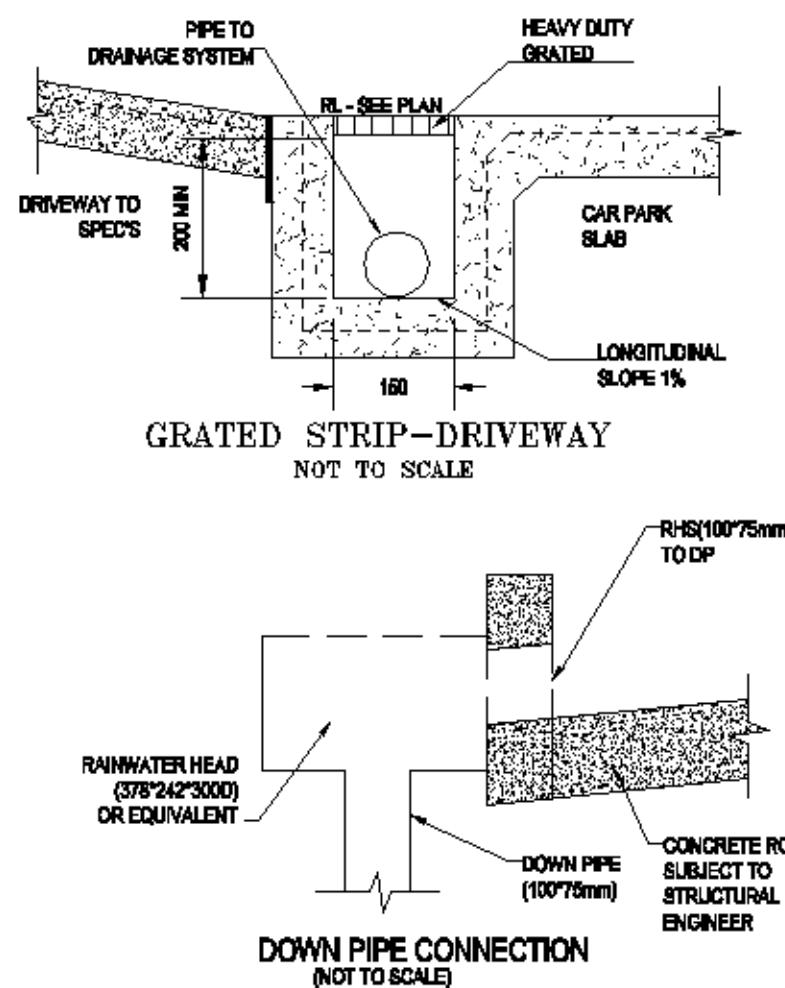

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		JOB No: 7604		SHEET No: 05 OF 07

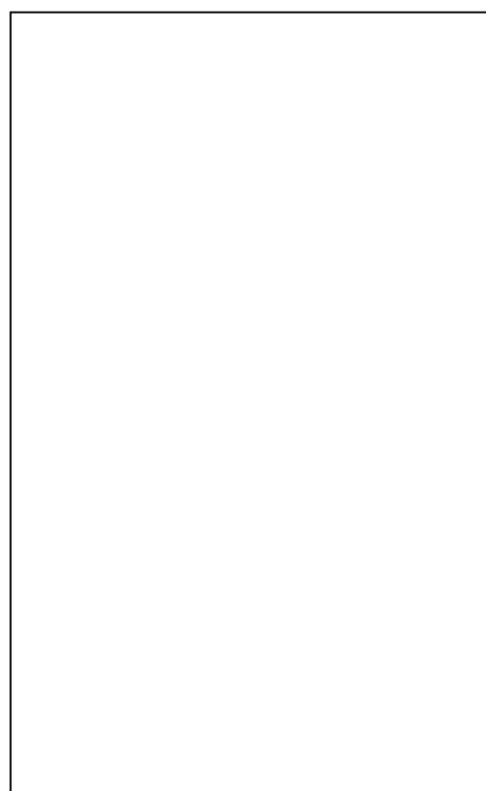


PLEASE VISIT
www.stormwater360.com.au
 OR
 CALL 1800 364 722
 FOR INSTALLATION OF STORMWATER
 FILTER AND MAINTENANCE






SEE SHEET 4 FOR
 STORMWATER FILTER
 AND INTERNAL SECTION
 DETAILS AND FOR MORE DETAILS
 PLEASE VISIT
www.stormwater360.com.au
 OR
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 FOR INSTALLATION OF STORMWATER
 FILTER AND MAINTENANCE

STORMFILTER DESIGN TABLE					
<ul style="list-style-type: none"> THE SIZE 3.2 x 1.8m STORMFILTER TREATMENT CAPACITY VARIES BY NUMBER OF FILTER CARTRIDGES INSTALLED AND BY REGION SPECIFIC INTERNAL FLOW CONTROLS. THE STANDARD CONFIGURATION IS SHOWN. ACTUAL CONFIGURATION OF THE SPECIFIED STRUCTURE(S) PER CIVIL ENGINEER WILL BE SHOWN ON SUBMITTAL DRAWING(S). ALL PARTS PROVIDED AND INTERNAL ASSEMBLY BY STORMWATER360 UNLESS OTHERWISE NOTED. 					
CARTRIDGE HEIGHT	680	480	310		
SYSTEM HYDRAULIC DROP (H - REQ'D. MIN.)	630	700	660		
TREATMENT BY MEDIA SURFACE AREA L/S/m ²	1.4	0.7	1.4	0.7	1.4
CARTRIDGE FLOW RATE (L/s)	1.42	0.71	0.95	0.47	0.63
					0.32

PLAN LAYOUT (NOT TO SCALE)

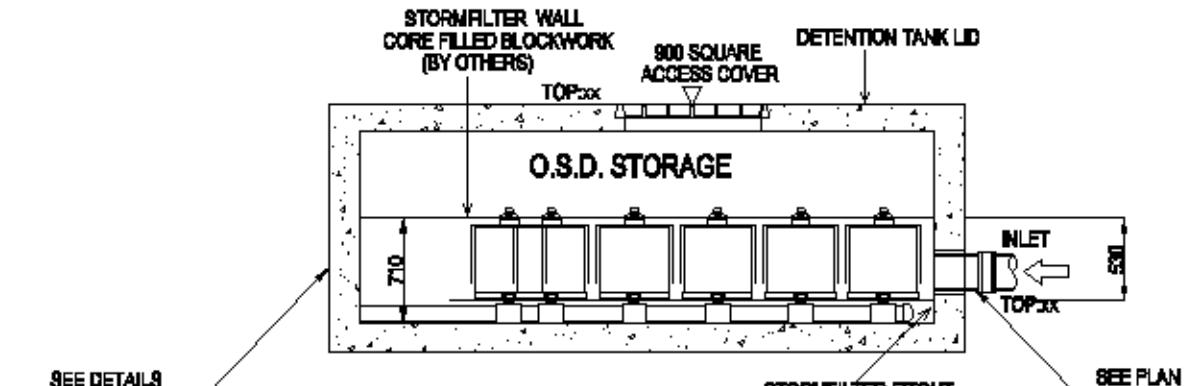

SECTION ON B-B

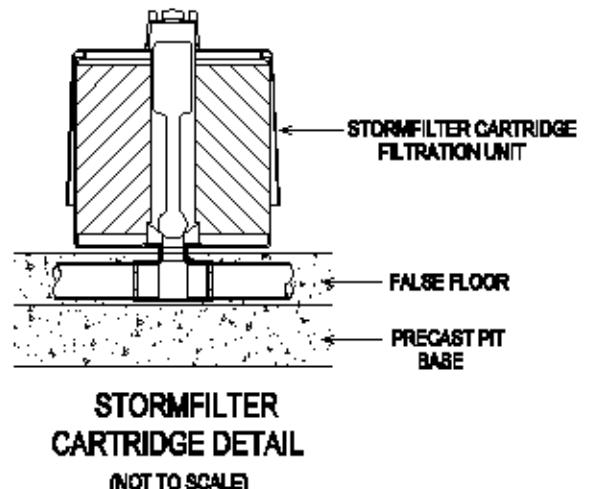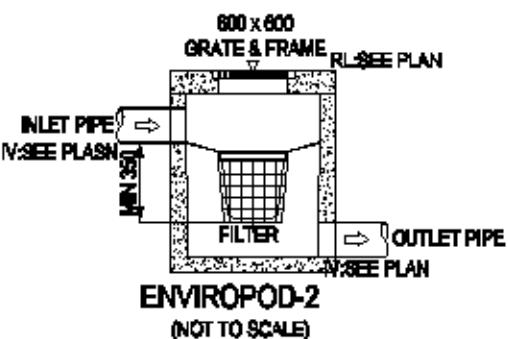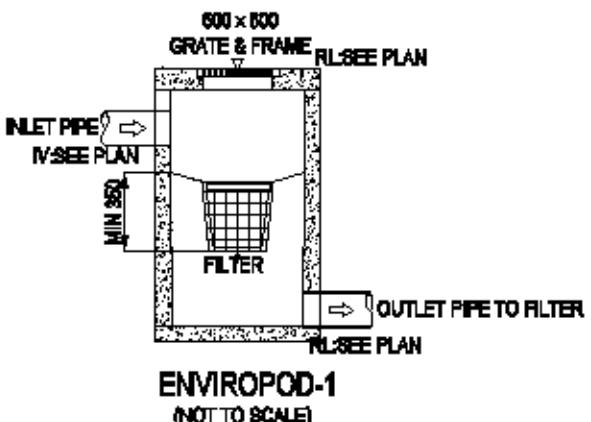

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			DATE: 08/12/15
			SCALE: AS NOTED
	JOB No: 7604		SHEET No: 00 OF 07



NASTASI & ASSOCIATES
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B.E., M.I.E. AUST. CPENG NPER-3

ABN 45 053 229 004

Pt (02) 8807 2884 OR (02) 8706 6617 FAX: (02) 8731 2081

MOb: 0419 041 401

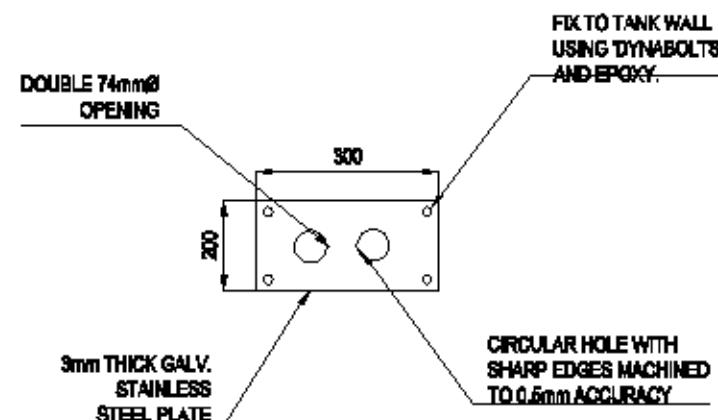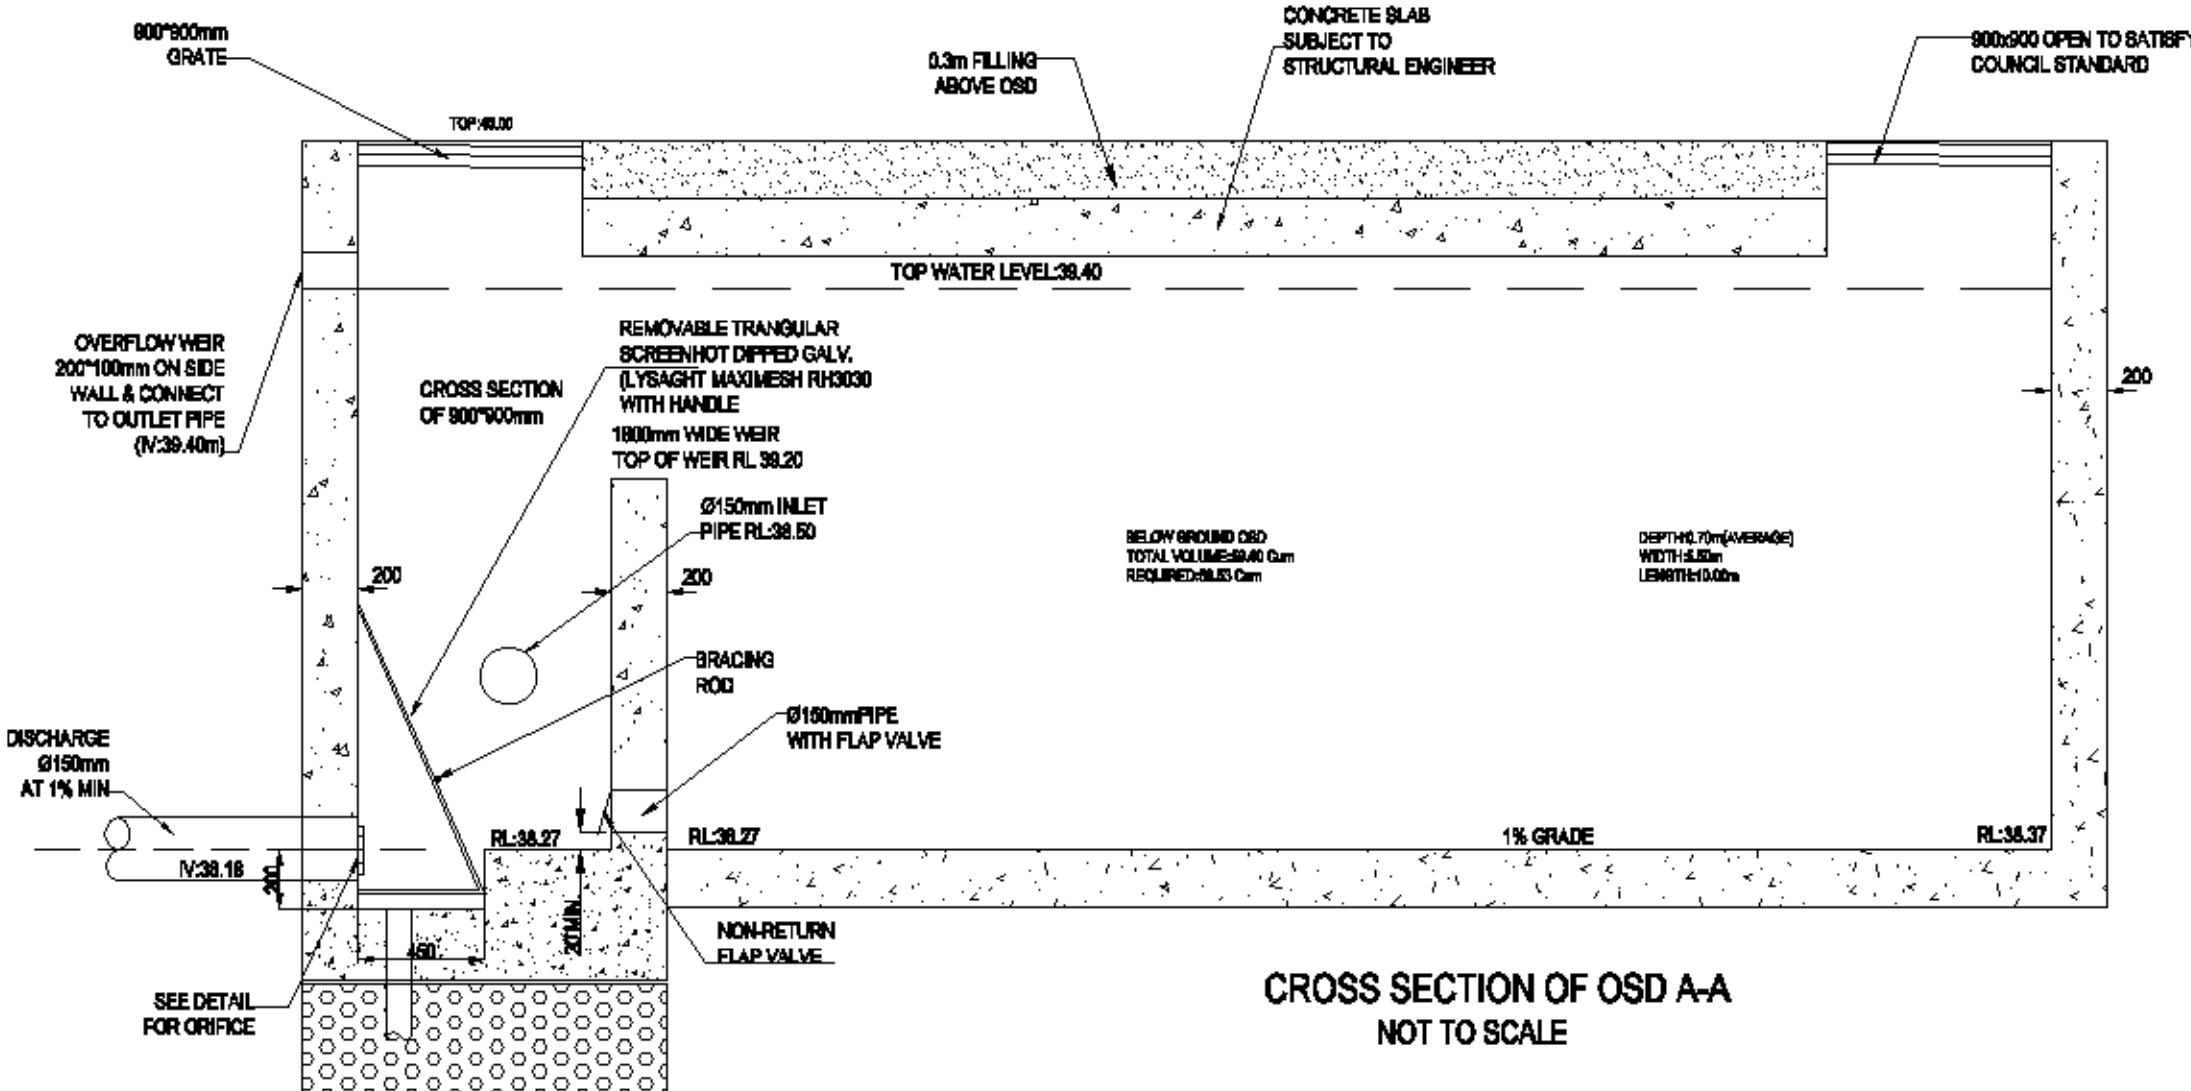

SEE SHEET 4 FOR
STORMWATER FILTER
AND INTERNAL SECTION
DETAILS AND FOR MORE DETAILS
PLEASE VISIT
www.stormwater360.com.au
OR
CALL 1300 354 722
FOR INSTALLATION OF STORMWATER
FILTER AND MAINTENANCE

OSD CALCULATIONS	
SITE AREA	=2090.32 Sq.m
AREA TO OSD	:2090.32 Sq.m
AS PER COUNCIL STORMWATER MANUAL	
PSD	:120 lit/sec/hac
SSR	:280 m³/sec
PSD	:25.08 lit/sec
SSR	:58.53 m³/sec
AS DETAILED IN PLAN	
OSD AREA	:55.00 Sq.m
TOTAL VOLUME PROVIDED	:59.40 m³
TOP WATER LEVEL	:39.40 m
ORIFICE CENTRELINE	:38.27 m
ORIFICE(DOUBLE)	:74 mm


**THIS IS AN
ON SITE STORMWATER
DETENTION SYSTEM
REQUIRED BY COUNCIL**

IT IS AN OFFENSE TO REDUCE THE VOLUME OF THE
TANK/BASIN OR TO INTERFERE WITH THE
ORIFICE PLATE THAT CONTROL THE FLOW


THE BASIN OF THE OUTLET CONTROL PIT AND
THE DEBRIS SCREEN MUST BE CLEANED OF DEBRIS
AND SEDIMENT ON A REGULAR BASIC BY THE OWNER

THIS PLATE MUST NOT BE REMOVED

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JOB No: 7604	SHEET No: 07 OF 07		

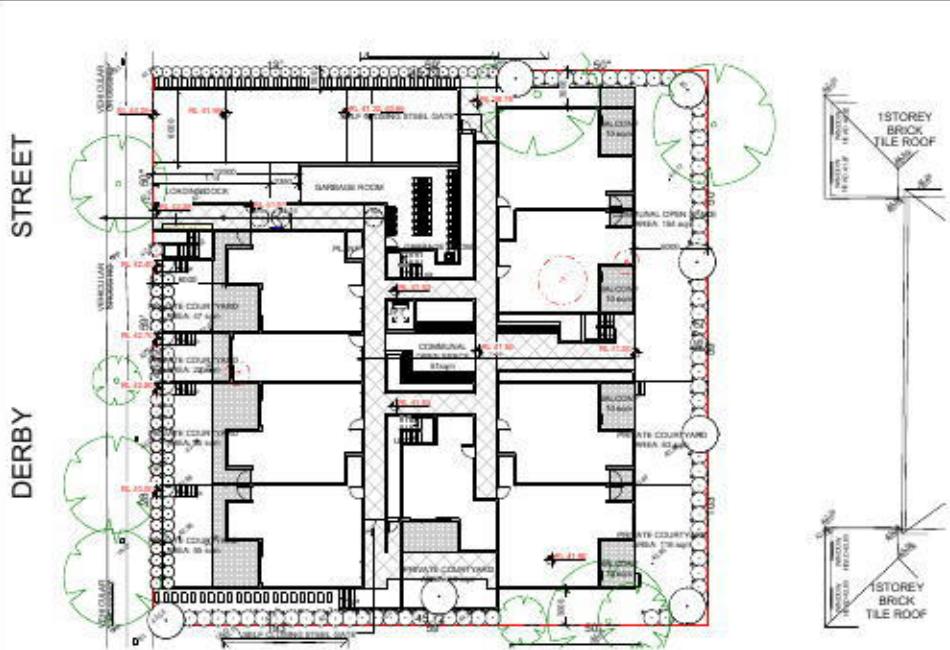

1 NP - SITE PLAN
N.T.S.

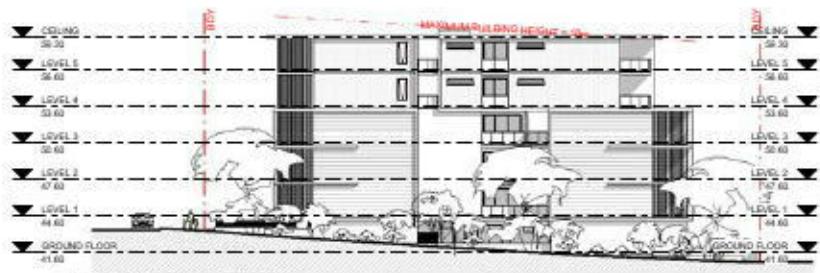

2 NP - EAST ELEVATION
N.T.S.



3 NP - NORTH ELEVATION
N.T.S.



4 NP - SOUTH ELEVATION
N.T.S.




5 NP - WEST ELEVATION
N.T.S.



No.	Description	Date
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NOTIFICATION PLAN

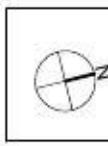

DEVELOPMENT APPLICATION
PROPOSED UNIT DEVELOPMENT

CLIENT: ELCON PTY LTD	Scale N.T.S.
Address: 115-119 DERBY ST, PENRITH	Drawn by TA Date OCT 2015
	Checked by CK Sheet number A126
	Project number 15035-01

Sheet List	
Sheet Number	Sheet Name
A101	COVER PAGE
A102	SURVEY PLAN
A103	BASIX COMMITMENTS
A104	SITE ANALYSIS
A105	SITE PLAN
A106	BASEMENT 2
A107	BASEMENT 1
A108	GROUND FLOOR
A109	LEVEL 1
A110	LEVEL 2
A111	LEVEL 3
A112	LEVEL 4
A113	LEVEL 5
A114	ROOF PLAN
A115	NORTH ELEVATION
A116	SOUTH ELEVATION
A117	EAST ELEVATION
A118	WEST ELEVATION
A119	SECTION
A120	SITE CALCULATIONS
A121	3D PERSPECTIVE
A122	SHADOW DIAGRAMS
A123	SHADOW DIAGRAMS
A124	SHADOW DIAGRAMS
A125	SOLAR ANALYSIS



Design


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IMPLIED AGREEMENT BETWEEN CK DES
AND THE INSTRUCTING PARTY. -
DISCLAIMER:
ALL WORKS ARE TO BE IN ACCORDANCE
WITH THE RELEVANT AUSTRALIAN
STANDARDS AND FOLLOW THE GUIDEL
OF THE BUILDING CODE OF AUSTRALIA.**

DEVELOPMENT APPLICATION

PROPOSED UNIT DEVELOPMENT

ADDRESS:
115-119 DERBY ST, PENRITH

CLIENT:
EL CON PTY LTD

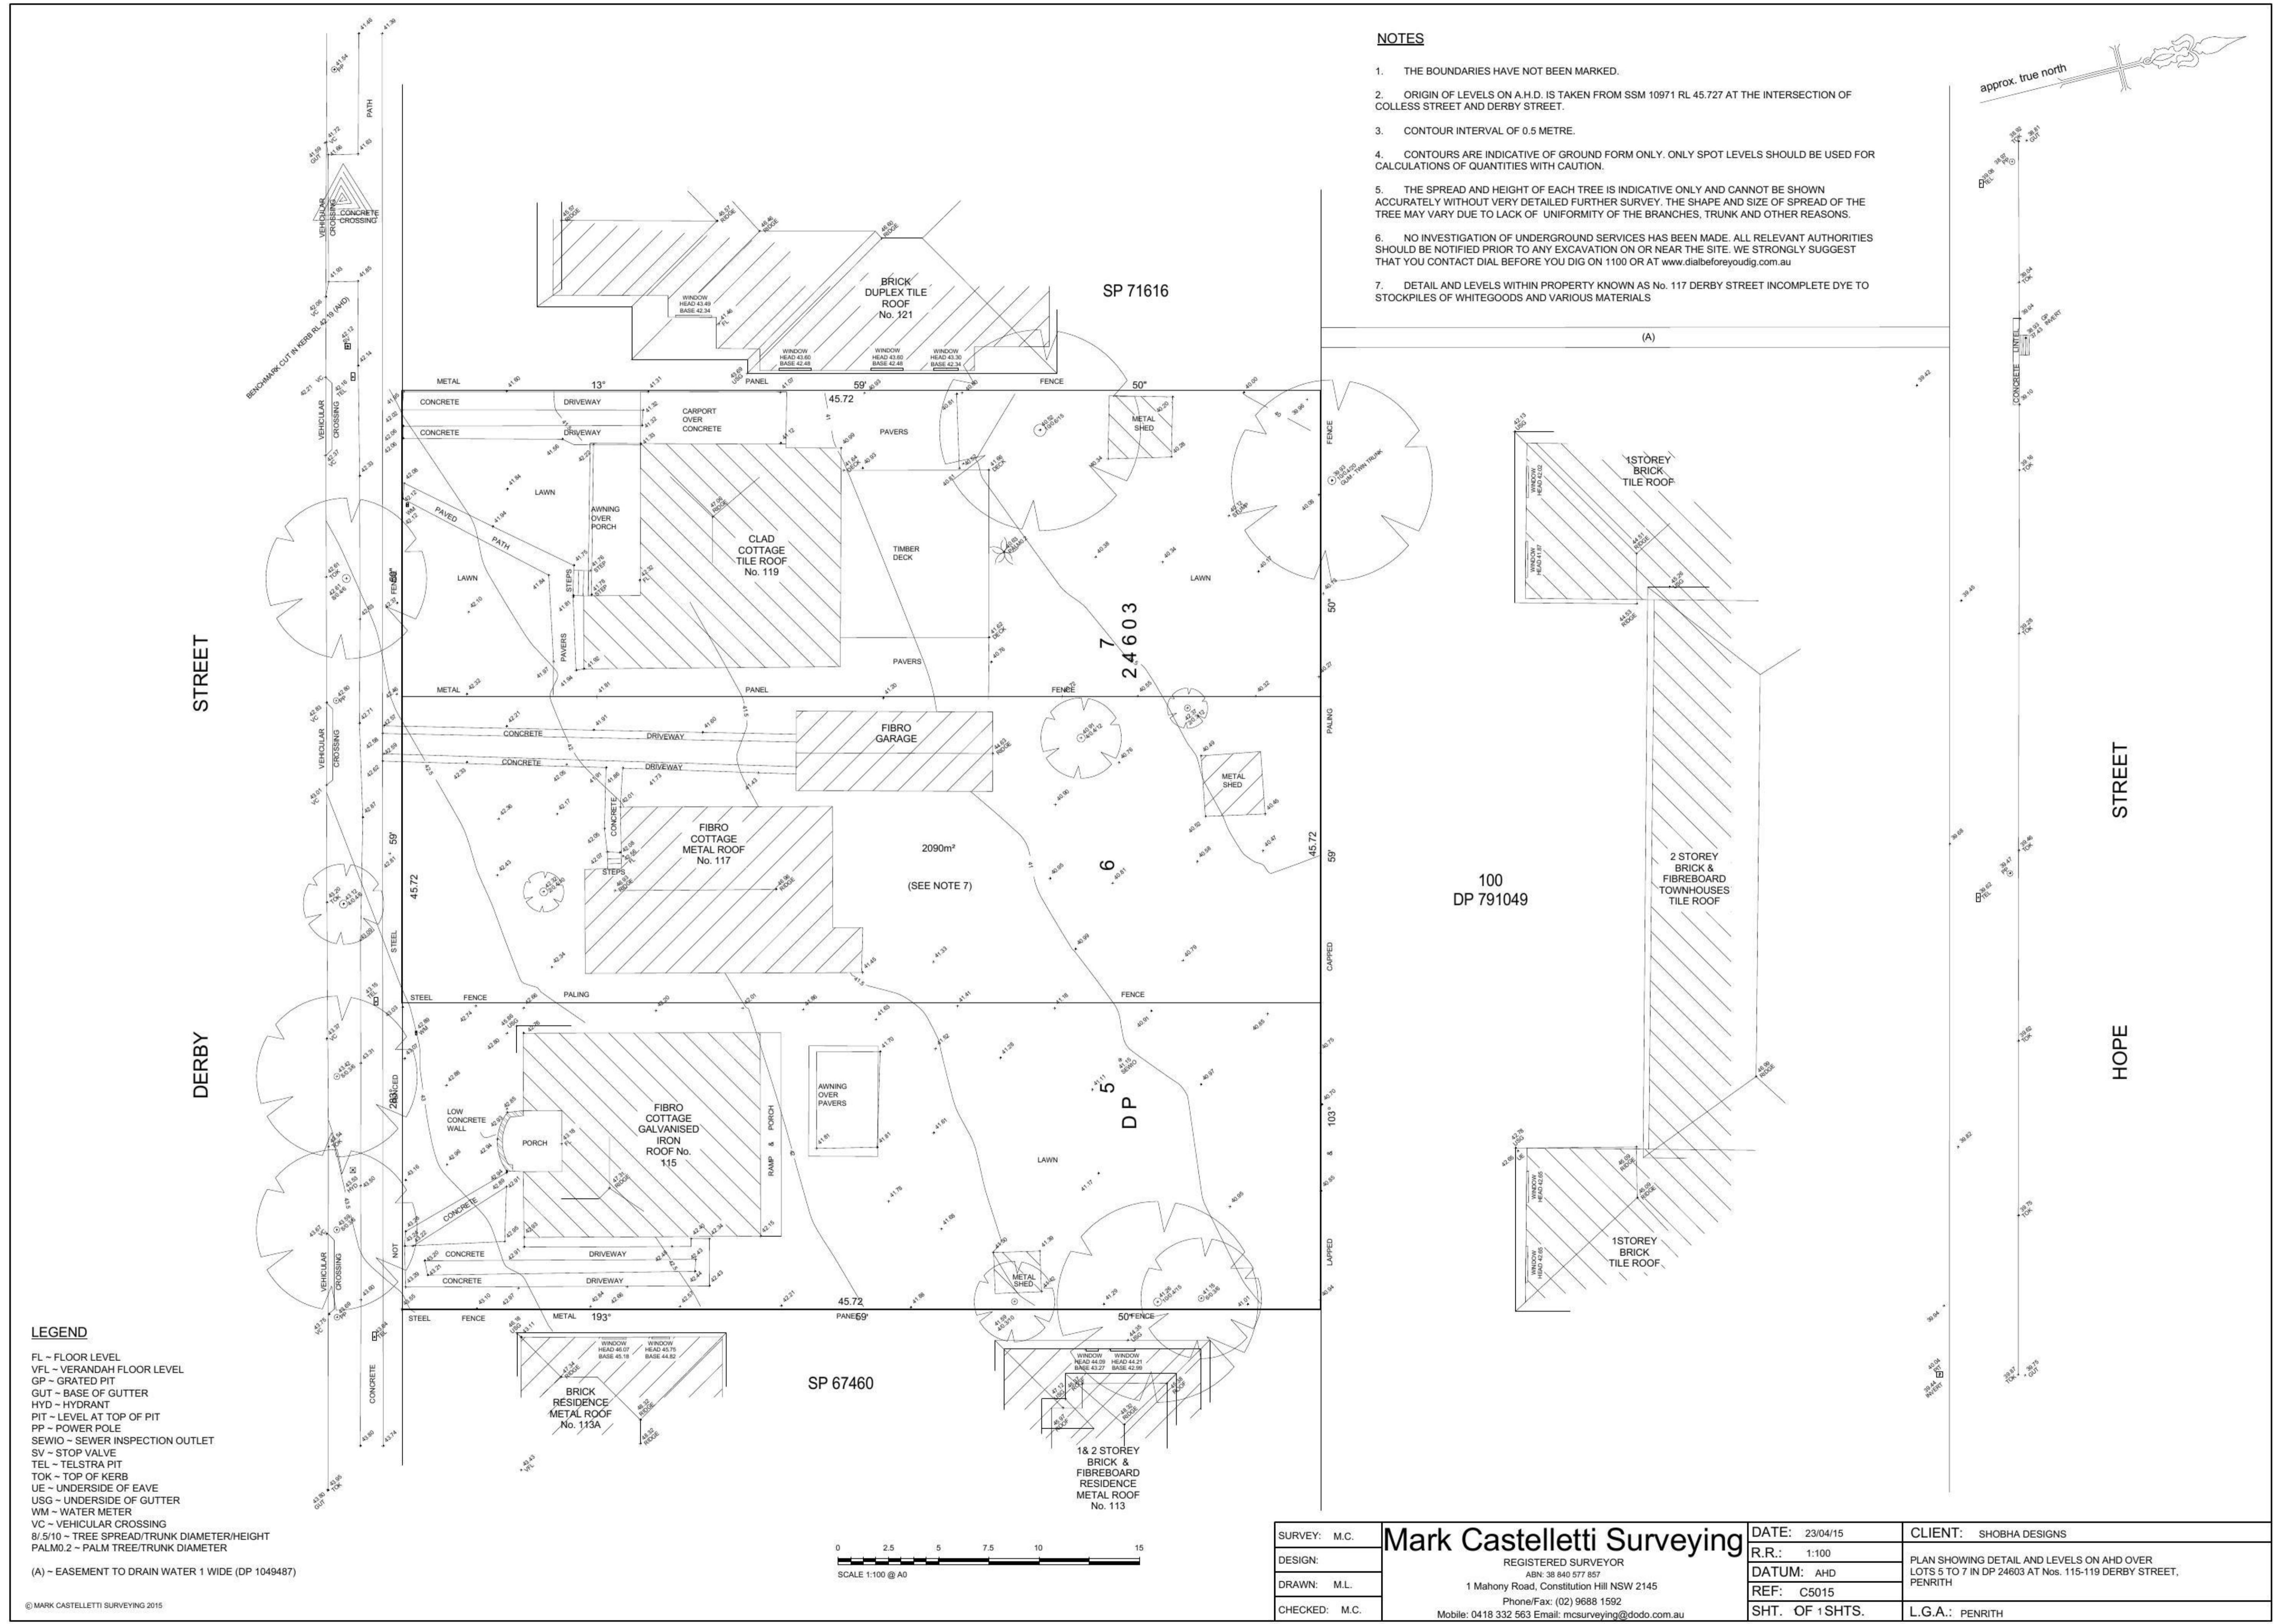

BASIX Certificate

Building Sustainability Index www.basix.nsw.gov.au

Multi Dwelling

Certificate number: 601478M

This certificate confirms that the proposed development will meet the NSW government's requirements for sustainability, if it is built in accordance with the applicable laws and codes and the relevant parts of the BASIX commitments, have the meaning given by the document entitled "BASIX Definitions" dated 18/09/2014 published by Planning & Infrastructure. This document is available at www.basix.nsw.gov.au

Director-General
Date of issue: Tuesday, 22 December 2015
To be valid, this certificate must be lodged within 3 months of the date of issue.



Project summary	
Project name	Development @ 115-119 DERBY ST, PENRITH
Street address	115-119 DERBY Street PENRITH 2750
Local Government Area	Penrith City Council
Plan type and plan number	deposited 24603
Lot no.	4,5,6
Section no.	-
No. of residential flat buildings	1
No. of units in residential flat buildings	61
No. of multi-dwelling houses	0
No. of single dwelling houses	0
Project score	
Water	✓ 40 Target 40
Thermal Comfort	✓ Pass Target Pass
Energy	✓ 30 Target 30

Certificate Prepared by	
Name / Company Name: Outsource Ideas P/L	ABN (if applicable): 12 130 002 981

Description of project

Project address	
Project name	Development @ 115-119 DERBY ST, PENRITH
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No. of units in residential flat buildings	61
No. of multi-dwelling houses	0
No. of single dwelling houses	0
Site details	
Site area (m²)	2090
Roof area (m²)	1685
Non-residential floor area (m²)	0
Residential car spaces	80
Non-residential car spaces	0

Description of project

The tables below describe the dwellings and common areas within the project.

Residential flat buildings - Building 1, 61 dwellings, 5 stores above ground

Dwelling no.	Number of bedrooms	Conditioned floor area (m²)	Unconditioned floor area (m²)	Area of garden & lawns (m²)	Indigenous species (m²)	Dwelling no.	Number of bedrooms	Conditioned floor area (m²)	Unconditioned floor area (m²)	Area of garden & lawns (m²)	Indigenous species (m²)	Dwelling no.	Number of bedrooms	Conditioned floor area (m²)	Unconditioned floor area (m²)	Area of garden & lawns (m²)	Indigenous species (m²)
1	2	73.0	0.0	0	0	2	1	41.0	0.0	0	0	3	2	73.0	0.0	0	0
5	1	53.0	0.0	0	0	6	2	80.0	0.0	0	0	7	2	73.0	0.0	0	0
9	2	60.0	0.0	0	0	10	2	80.0	0.0	0	0	11	2	73.0	0.0	0	0
13	2	73.0	0.0	0	0	14	2	80.0	0.0	0	0	15	1	64.0	0.0	0	0
17	2	73.0	0.0	0	0	18	1	50.0	0.0	0	0	19	2	73.0	0.0	0	0
21	1	50.0	0.0	0	0	22	2	80.0	0.0	0	0	23	2	73.0	0.0	0	0
25	2	73.0	0.0	0	0	26	2	80.0	0.0	0	0	27	1	64.0	0.0	0	0
29	2	73.0	0.0	0	0	30	1	50.0	0.0	0	0	31	2	73.0	0.0	0	0
33	1	50.0	0.0	0	0	34	2	80.0	0.0	0	0	35	2	73.0	0.0	0	0
37	2	73.0	0.0	0	0	38	2	80.0	0.0	0	0	39	1	64.0	0.0	0	0
41	2	73.0	0.0	0	0	42	1	50.0	0.0	0	0	43	2	73.0	0.0	0	0
45	1	50.0	0.0	0	0	46	2	77.0	0.0	0	0	47	2	77.0	0.0	0	0
49	2	77.0	0.0	0	0	50	3	116.0	0.0	0	0	51	2	76.0	0.0	0	0
53	2	118.0	0.0	0	0	54	2	77.0	0.0	0	0	55	2	77.0	0.0	0	0
57	2	77.0	0.0	0	0	58	3	118.0	0.0	0	0	59	2	76.0	0.0	0	0
61	3	118.0	0.0	0	0							60	2	68.0	0.0	0	0

Description of project

The tables below describe the dwellings and common areas within the project.

Common areas of unit building - Building 1

Common area	Floor area (m²)	Common area	Floor area (m²)	Common area	Floor area (m²)
Basement Car park-1	1400	Basement Car park-2	1403	Lift car (No. 1)	-
Lift motor room	5	Garage room	63	Garage room (Level-1)	6
Garage room (Level-2)	6	Garage room (Level-3)	6	Garage room (Level-4)	6
Garage room (Level-5)	6	Ground floor lobby	190	Lobby (Level-1)	123
Lobby (Level-2)	123	Lobby (Level-3)	123	Lobby (Level-4)	123
Lobby (Level-5)	123				

Description of project

The tables below describe the dwellings and common areas within the project.

Schedule of BASIX commitments

The commitments set out below regulate how the proposed development is to be carried out. It is a condition of any development consent granted, or complying development certificate issued, for the proposed development, that BASIX commitments be complied with.

1. Commitments for Residential flat buildings - Building 1

(a) Dwellings

(i) Water		Show on DA plans	Show on CCC/DC plans	Certifier check
(a) The applicant must comply with the commitments listed below in carrying out the development of a dwelling listed in a table below.		✓	✓	
(b) The applicant must plan for rainwater harvesting or no water use species of vegetation throughout the time of least required for the dwelling in the "Rainwater harvesting" column of the table below, or prevent leachages for fire dwellings in the "Area of garden and lawn" for the dwelling specified in the "Description of Project" table.		✓	✓	
(c) If a rating is specified in the table below for a fixture or appliance to be installed in the dwelling, the applicant must ensure that each such fixture or appliance meets the rating specified for it.		✓	✓	
(d) The applicant must install a demand hot water reduction system which regulates all hot water use throughout the dwelling, where indicated in the "HWH reduction or diversion" column of the table below.		✓	✓	
(e) The applicant must install:				
(aa) a hot water diversion system to all showers, kitchen sinks and all basins in the dwelling, where indicated for a dwelling in the "HWH reduction or diversion" column of the table below;				
(bb) a separate diversion tank (or tanks) connected to the hot water diversion systems of at least 100 litres. The applicant must connect the tank(s) to all toilets in the dwelling.				
(f) If specified in the table, the applicant must not install a private swimming pool or spa for the dwelling, with a volume exceeding that specified for it in the table below.		✓	✓	
(g) The pool or spa must be located as specified in the table.		✓	✓	
(h) The applicant must install for the dwelling, each alternative water supply system, with the specified size, listed for that dwelling in the table below. Each system must be configured to collect run-off from the areas specified (excluding any area which supplies any other alternative water supply system), and to divert overflow as specified. Each system must be connected as specified.		✓	✓	

(b) Common areas and central systems/facilities

(i) Water		Show on DA plans	Show on CCC/DC plans	Certifier check
(a) If, in carrying out the development, the applicant installs a showerhead, toilet, tap or clothes washer into a common area, then that specification must meet the specifications listed for it in the table.		✓	✓	
(b) The applicant must install (or ensure that the development is serviced by) the alternative water supply system(s) specified in the "Central systems" column of the table below. In each case, the system must be sized, be configured, and be connected, as specified in the table.		✓	✓	
(c) A swimming pool or spa listed in the table must not have a volume (in kLs) greater than that specified for the pool or spa in the table.		✓	✓	
(d) A pool or spa listed in the table must have a cover or shading if specified for the pool or spa in the table.		✓	✓	

(c) Fixtures

(d) Appliances


(e) Individual pool



(f) Individual spa

(g) Appliances & other efficiency measures

(h) Individual pool

(i) Individual spa

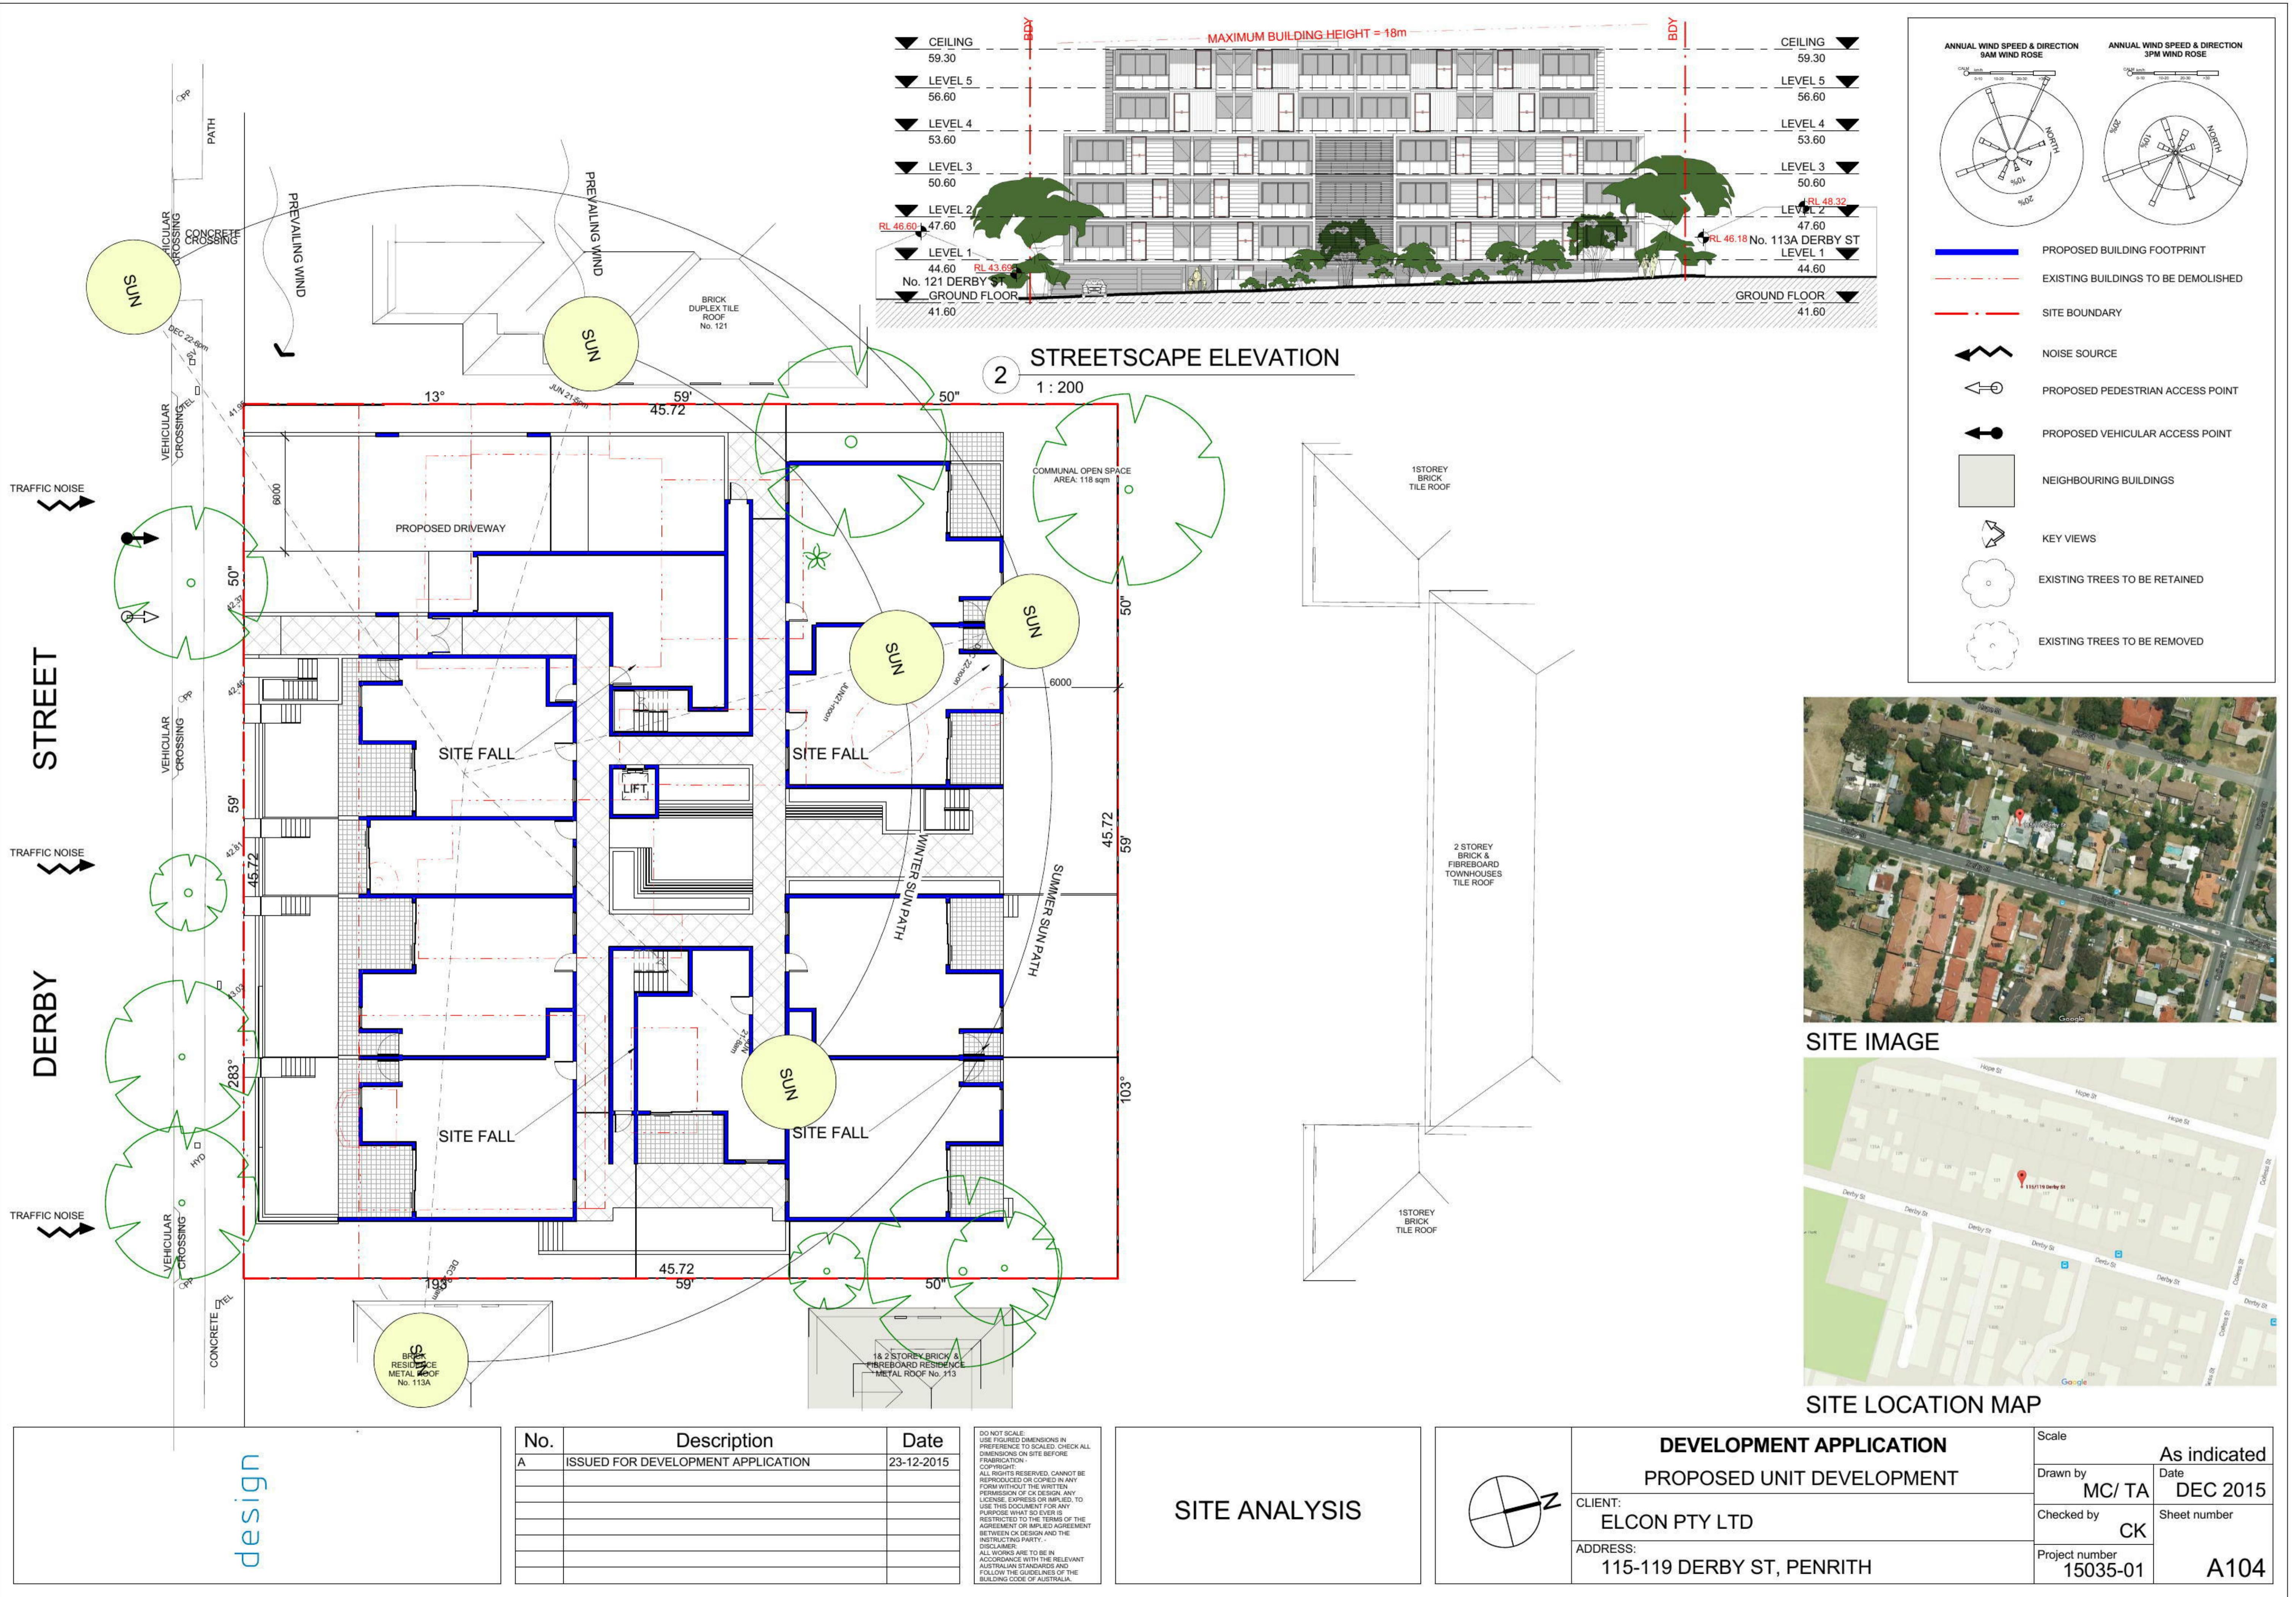

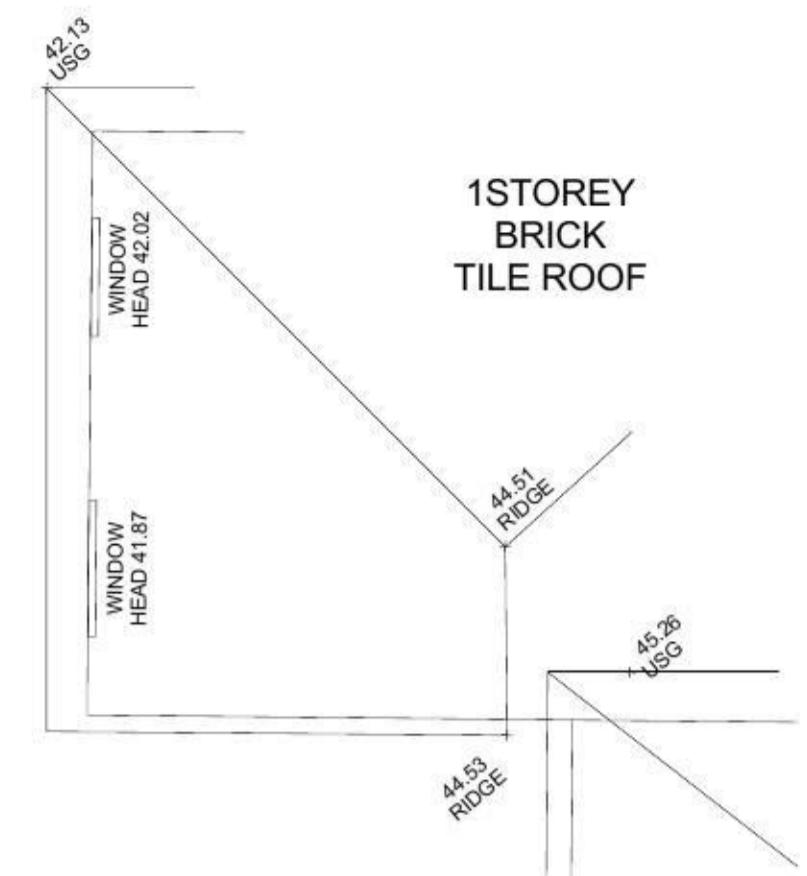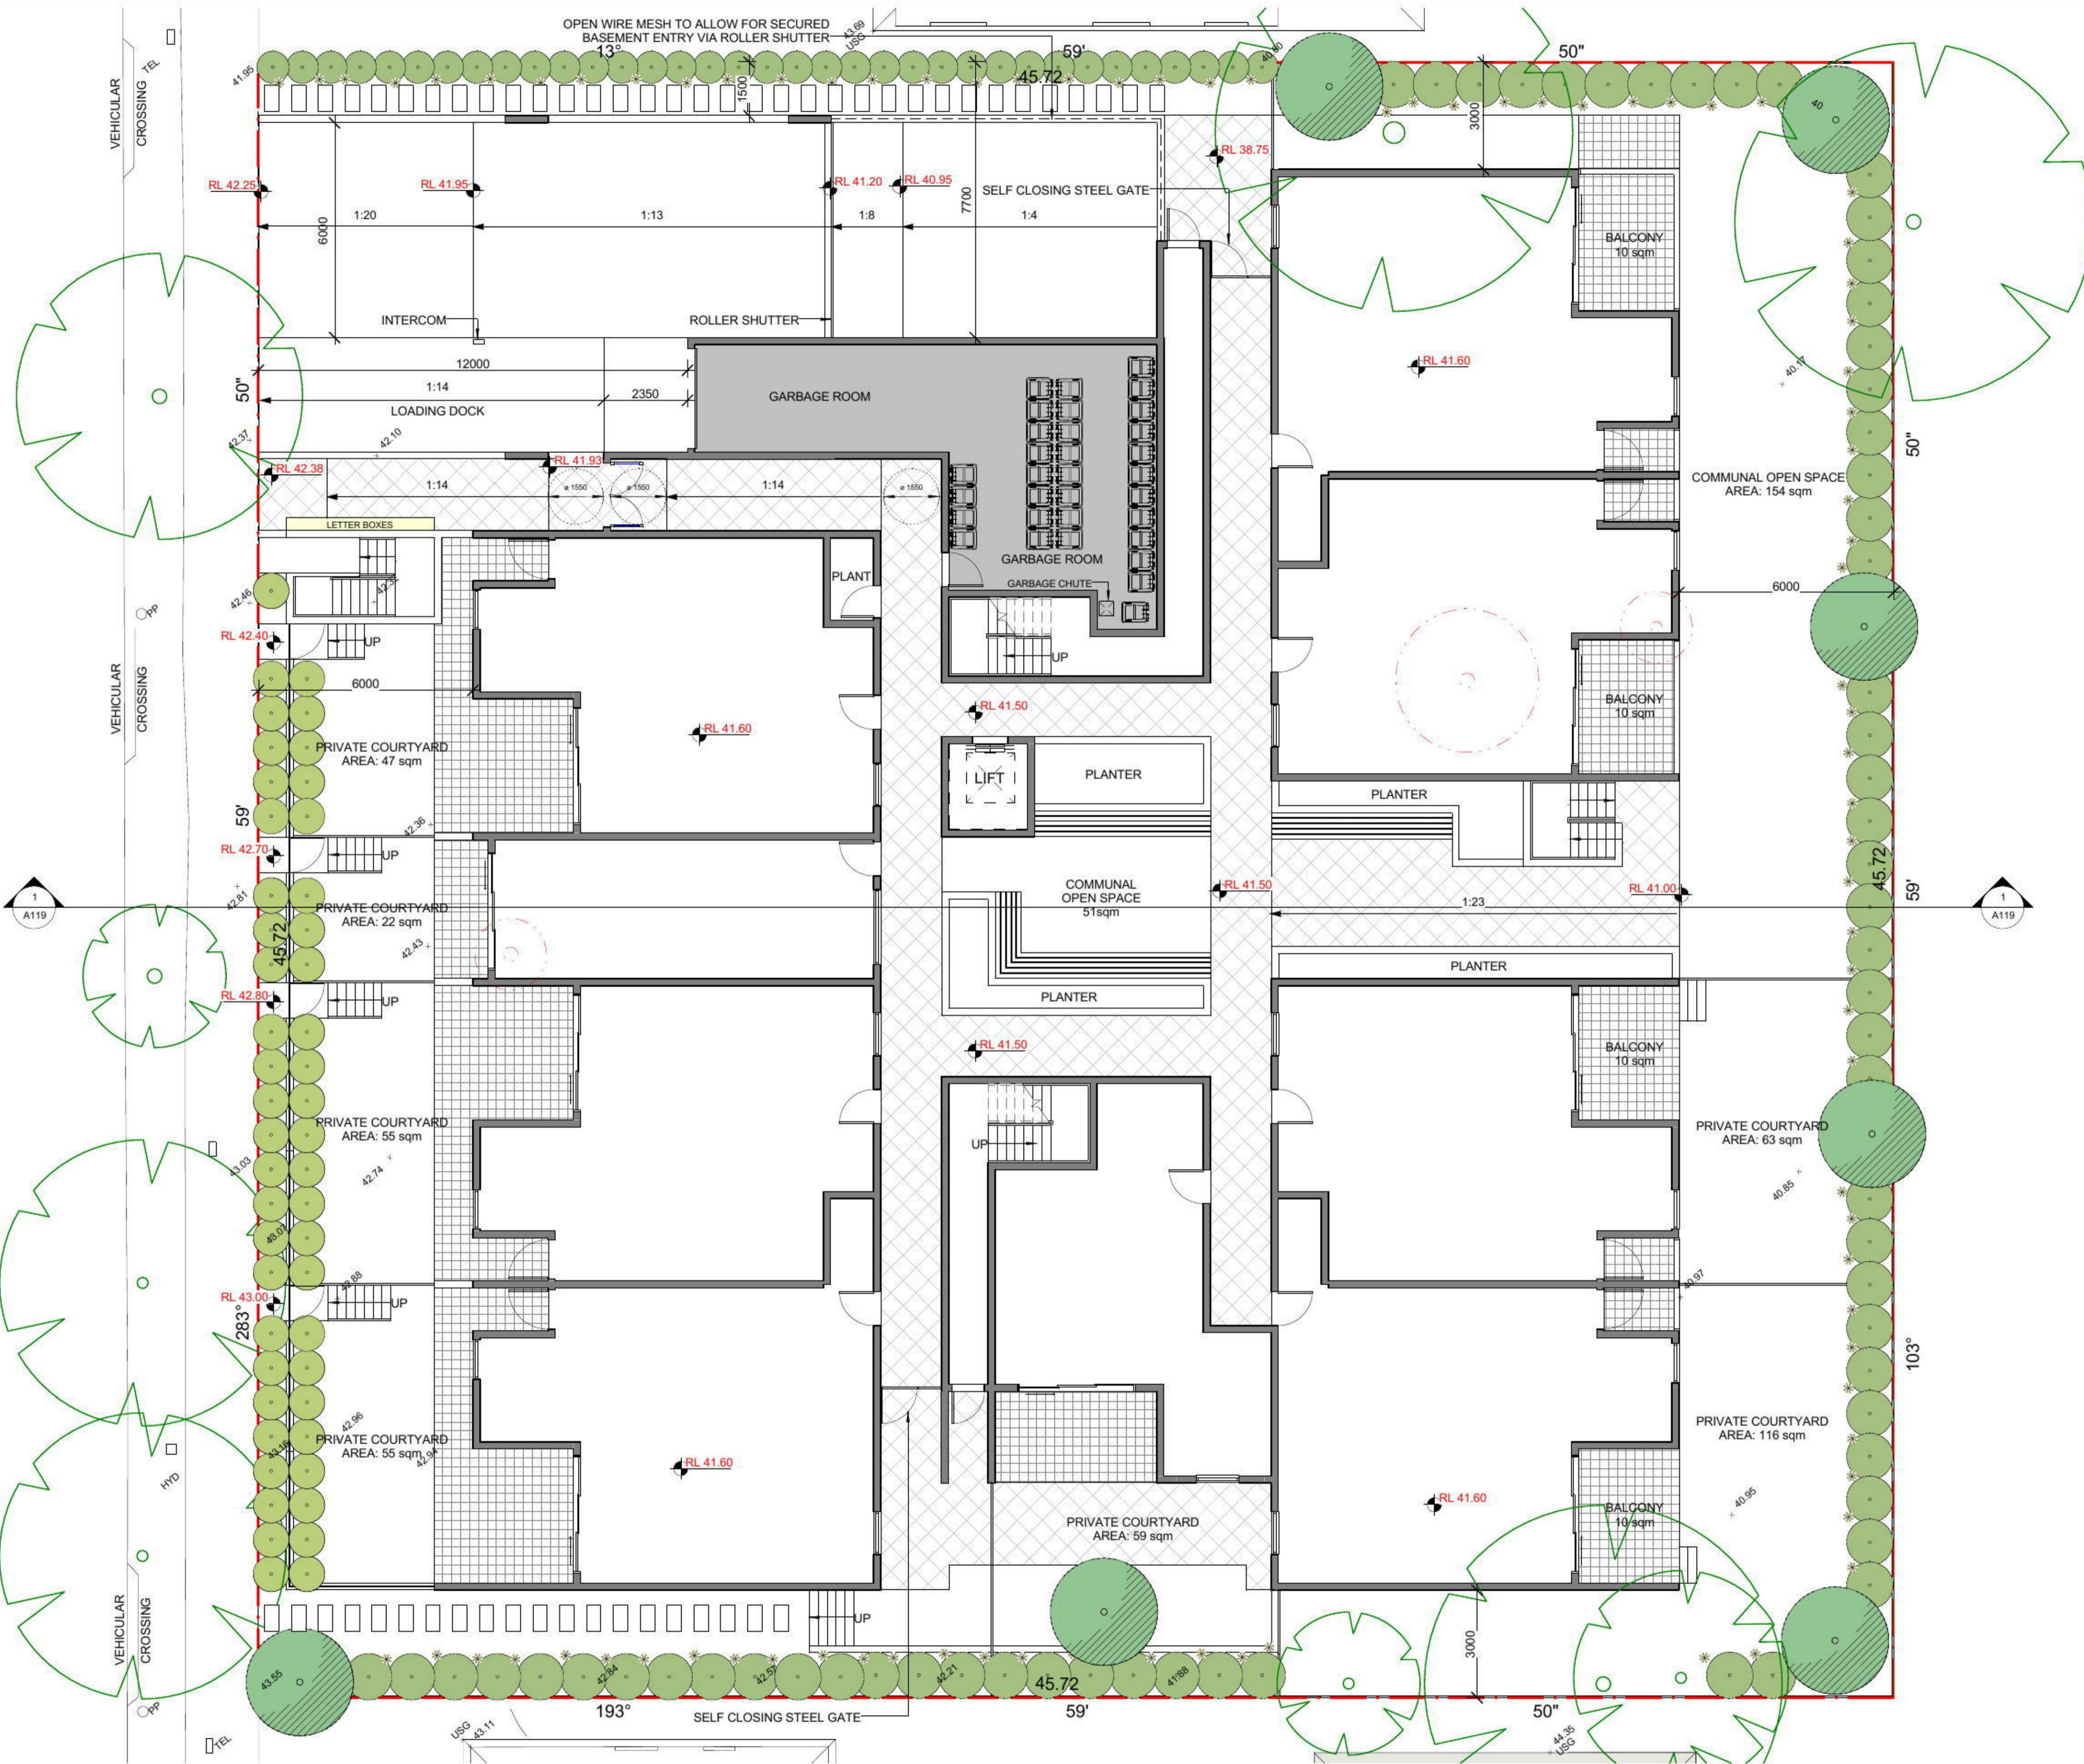


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SITE PLAN



DEVELOPMENT APPLICATION

PROPOSED UNIT DEVELOPMENT


T:
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ESS:
15-119 DERBY ST, PENRITH
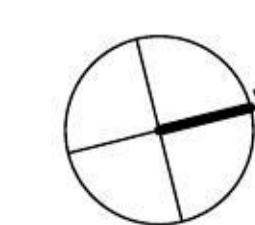
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Drawn by	TA	Date DEC 2015
Checked by	CK	Sheet number
Project number	15035-01	A105

DERBY STREET

design

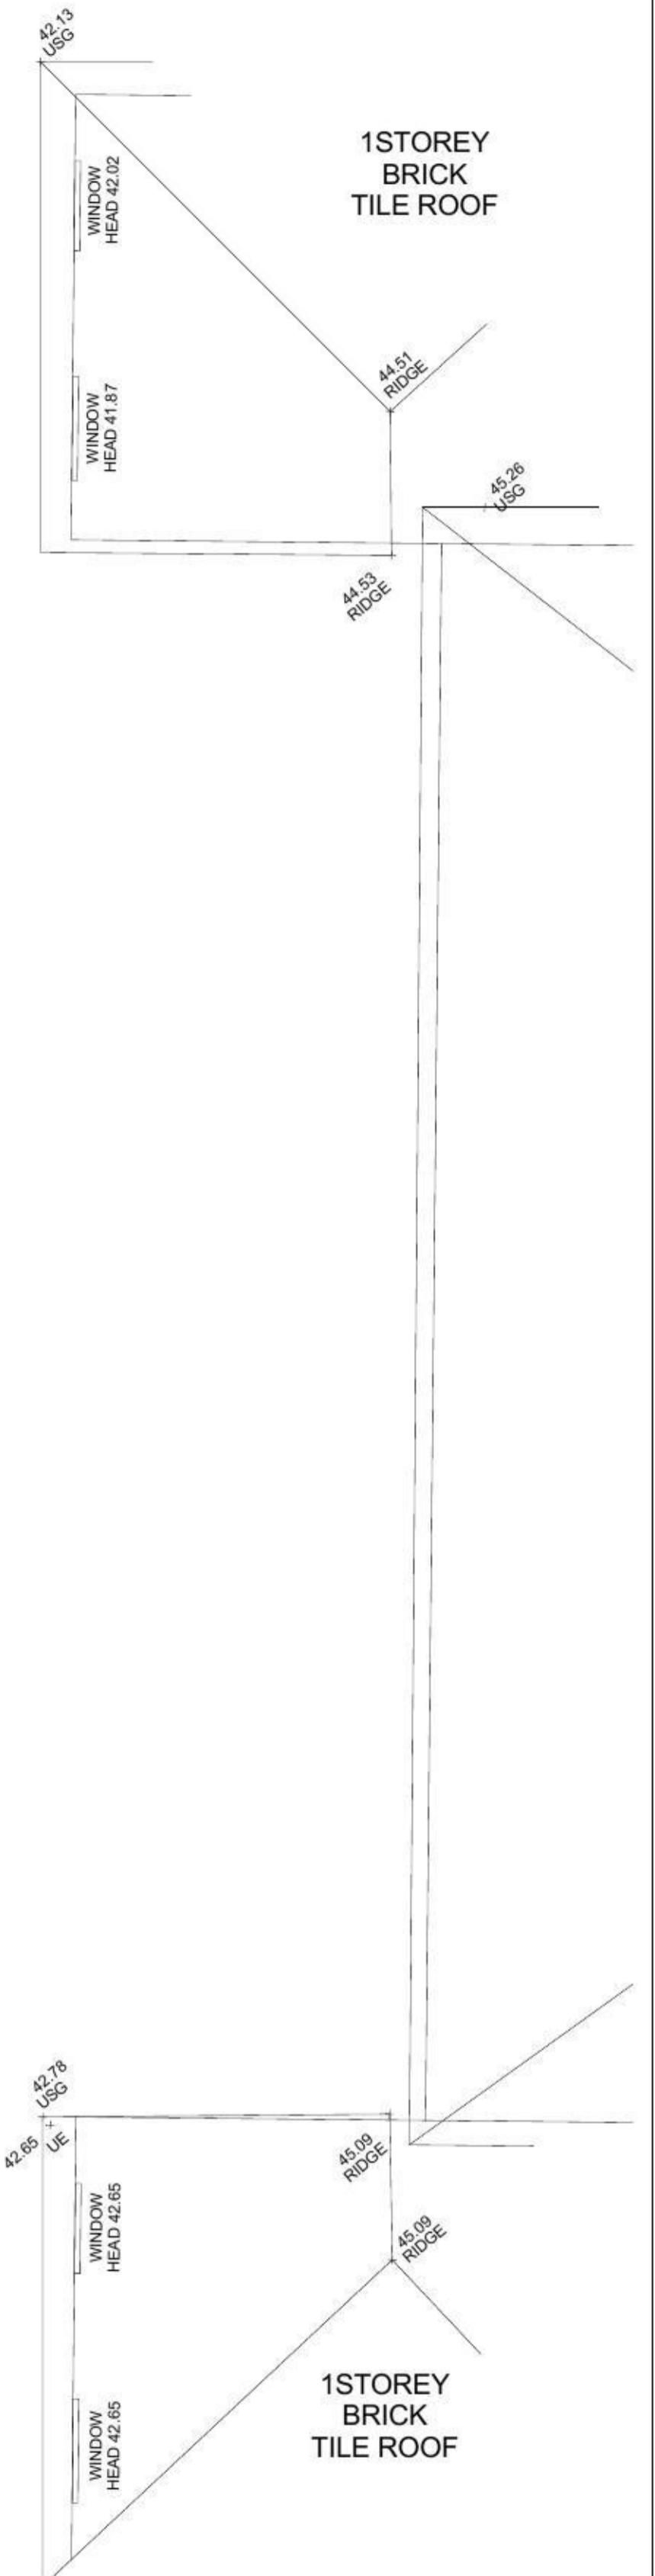


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BASEMENT 2




DEVELOPMENT APPLICATION

PROPOSED UNIT DEVELOPMENT
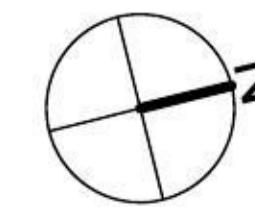
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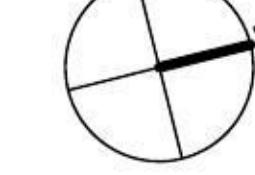
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Project number 15035-01		A106



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BASEMENT 1

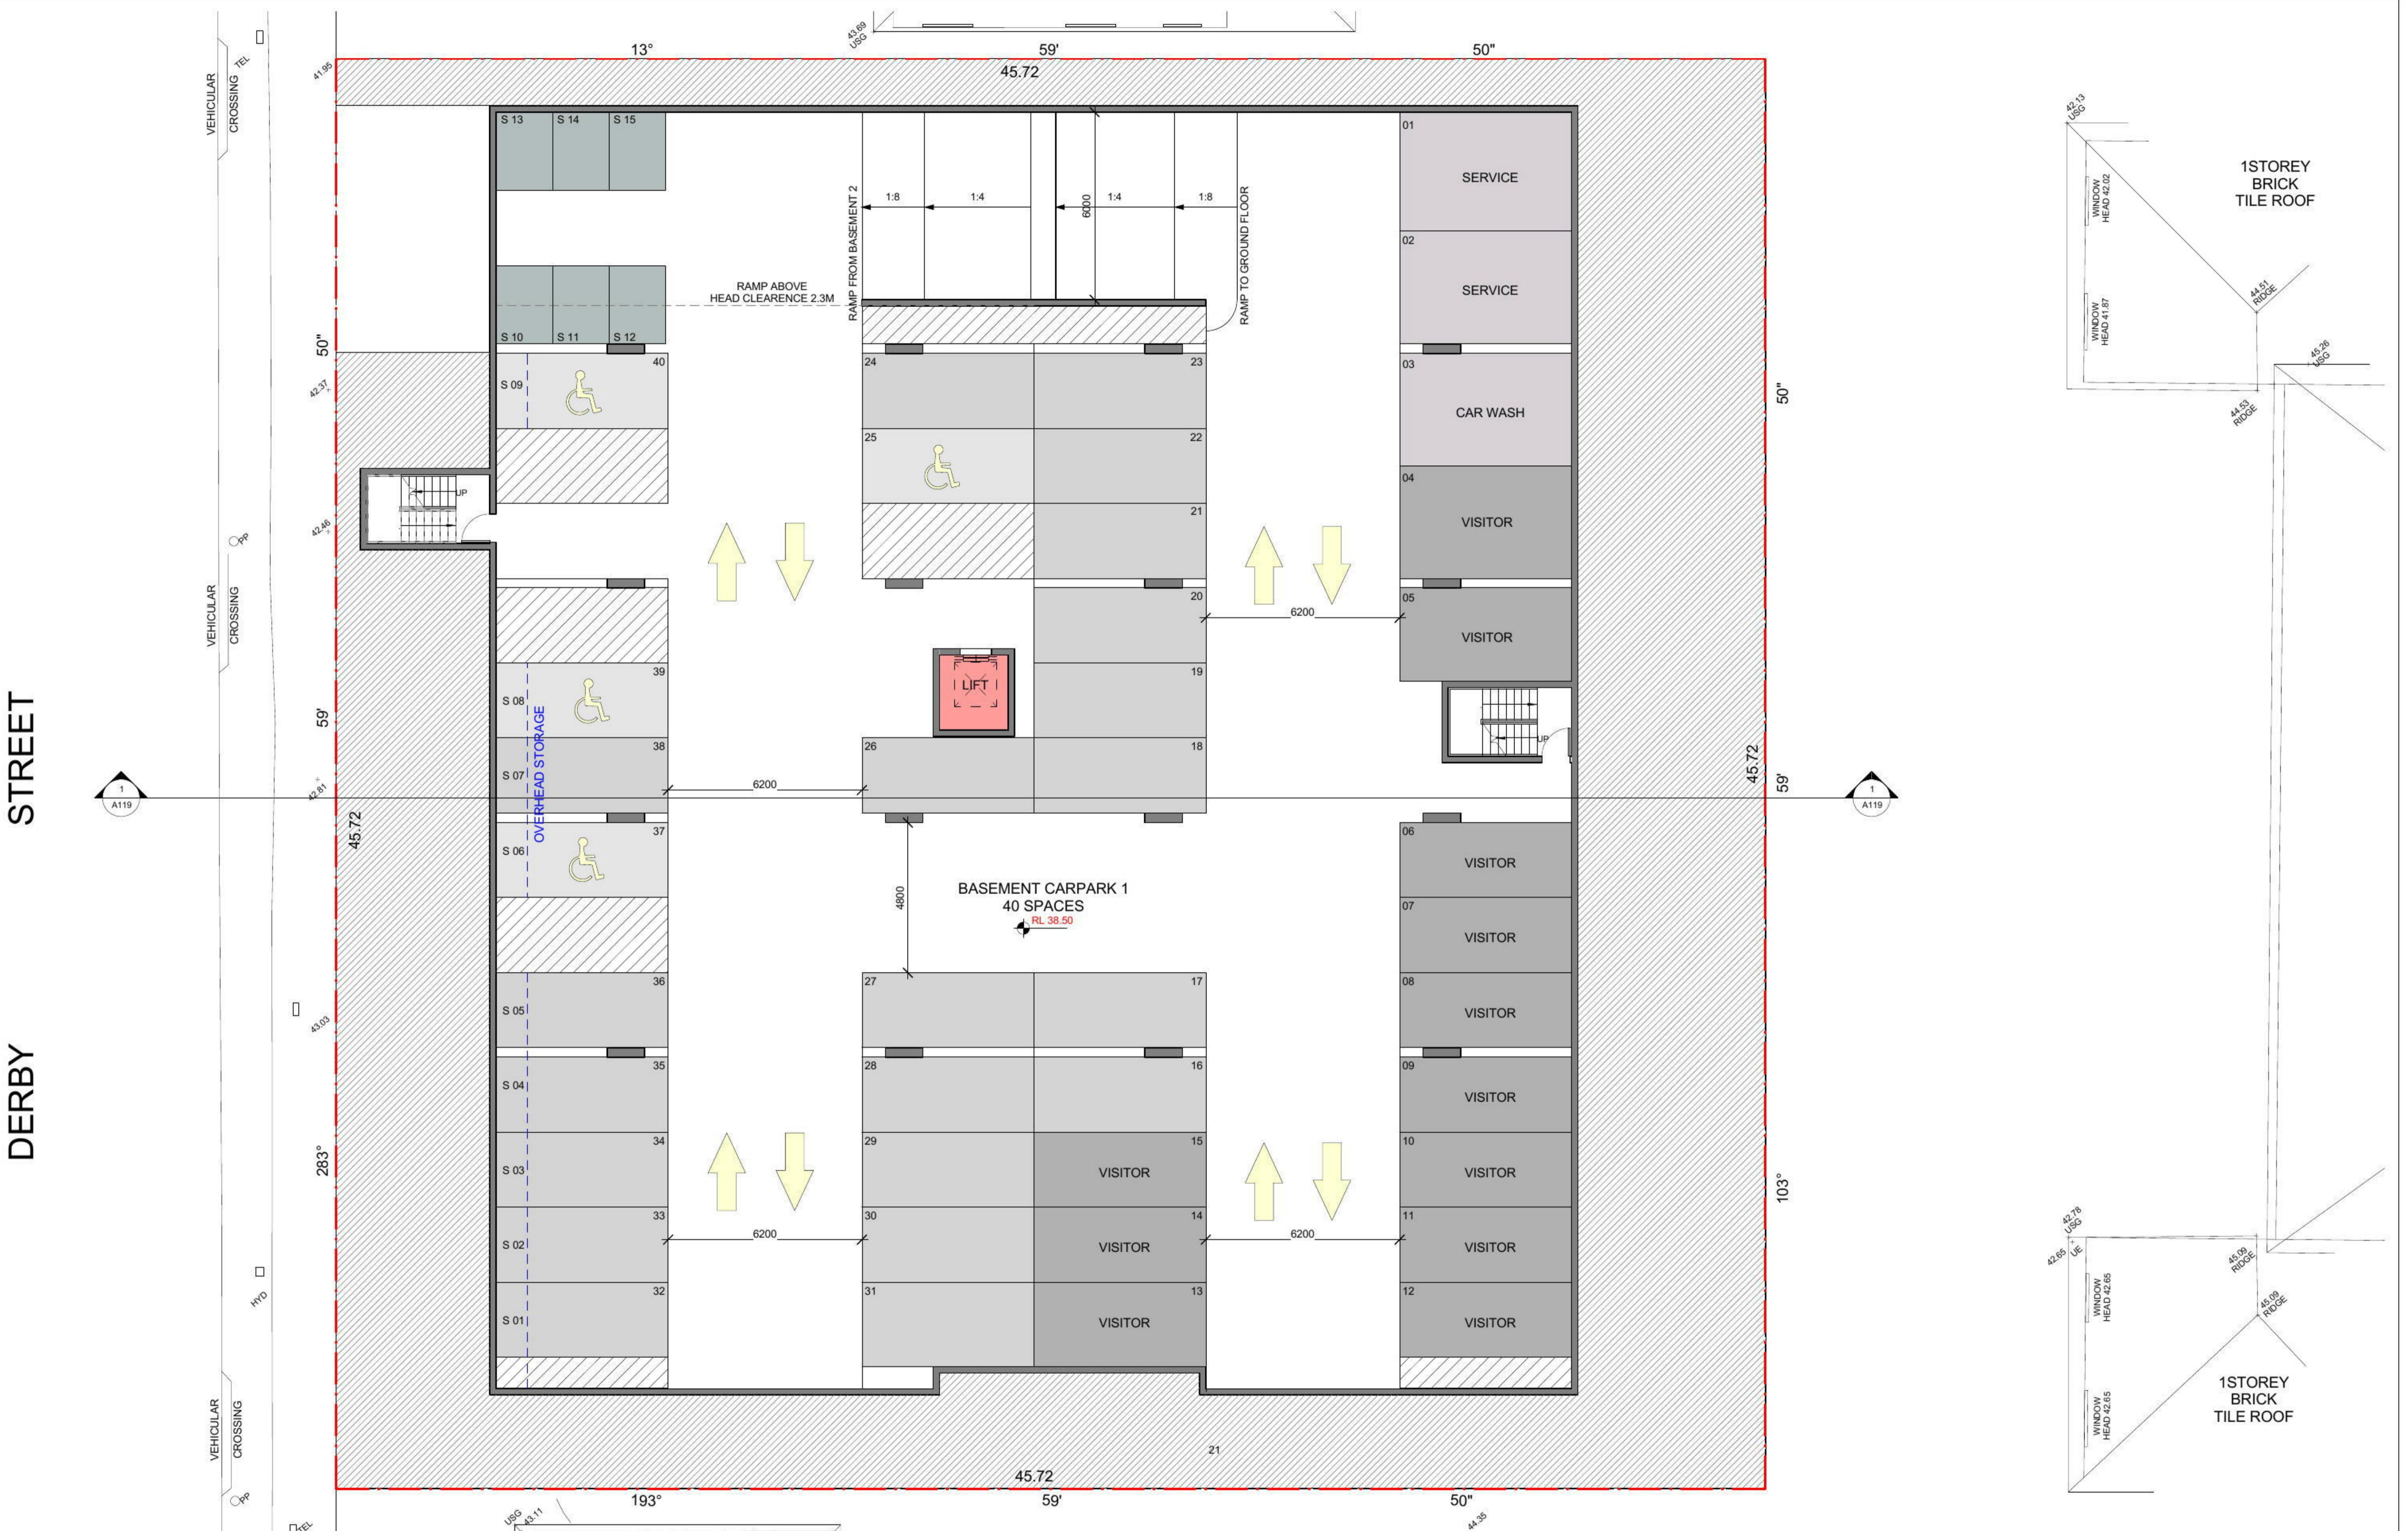

DEVELOPMENT APPLICATION



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	Checked by CK	Sheet number
	Project number 15035-01	A107

DERBY STREET



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DEVELOPMENT APPLICATION			Scale
PROPOSED UNIT DEVELOPMENT			1 : 100
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ADDRESS: 115-119 DERBY ST, PENRITH			Date DEC 2015
			Checked by CK
			Sheet number A114
			Project number 15035-01

NOTE:
1. ALL WINDOWS 2.0m ABOVE GROUND LEVEL ARE REQUIRED TO HAVE A BARRIER DEVICE TO LIMIT THE WINDOW OPENING TO NO MORE THAN 125mm IN ACCORDANCE WITH CLAUSE 3.9.2.5 OF BCA.
2. ALL WINDOWS AND DOOR SIZES TO BE CONFIRMED ON SITE PRIOR TO MANUFACTURING AND INSTALLATION.
3. REFER TO BASIX FOR ALL WINDOW AND DOOR SPECIFICATION AND RATINGS.
4. ALL STAIR TREADS AND NOSING STRIP TO COMPLY WITH AS 4586-2013 AND TABLE 3.9.1.1 OF BCA.
5. ALL SMOKE ALARMS ARE TO BE INTERCONNECTED.

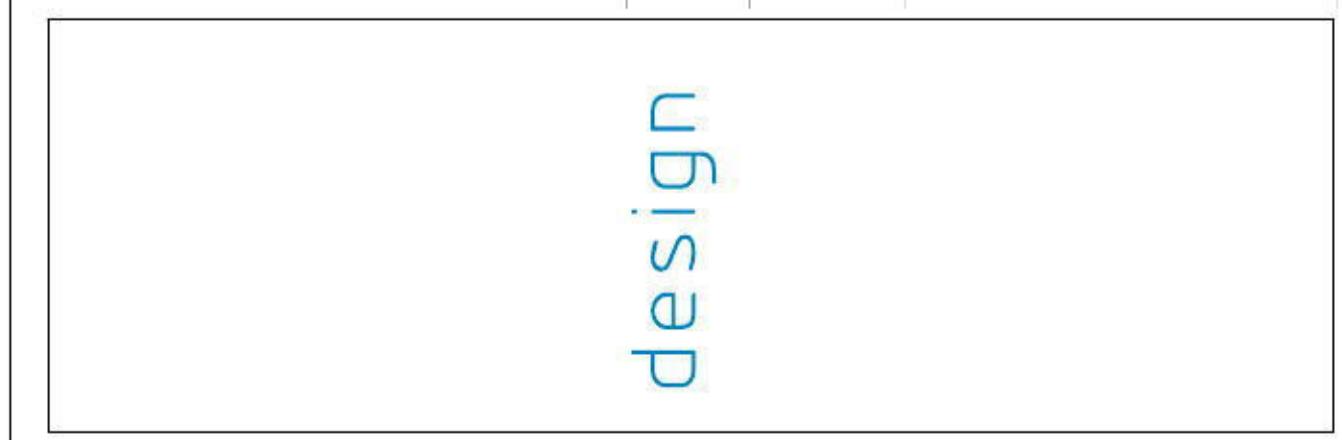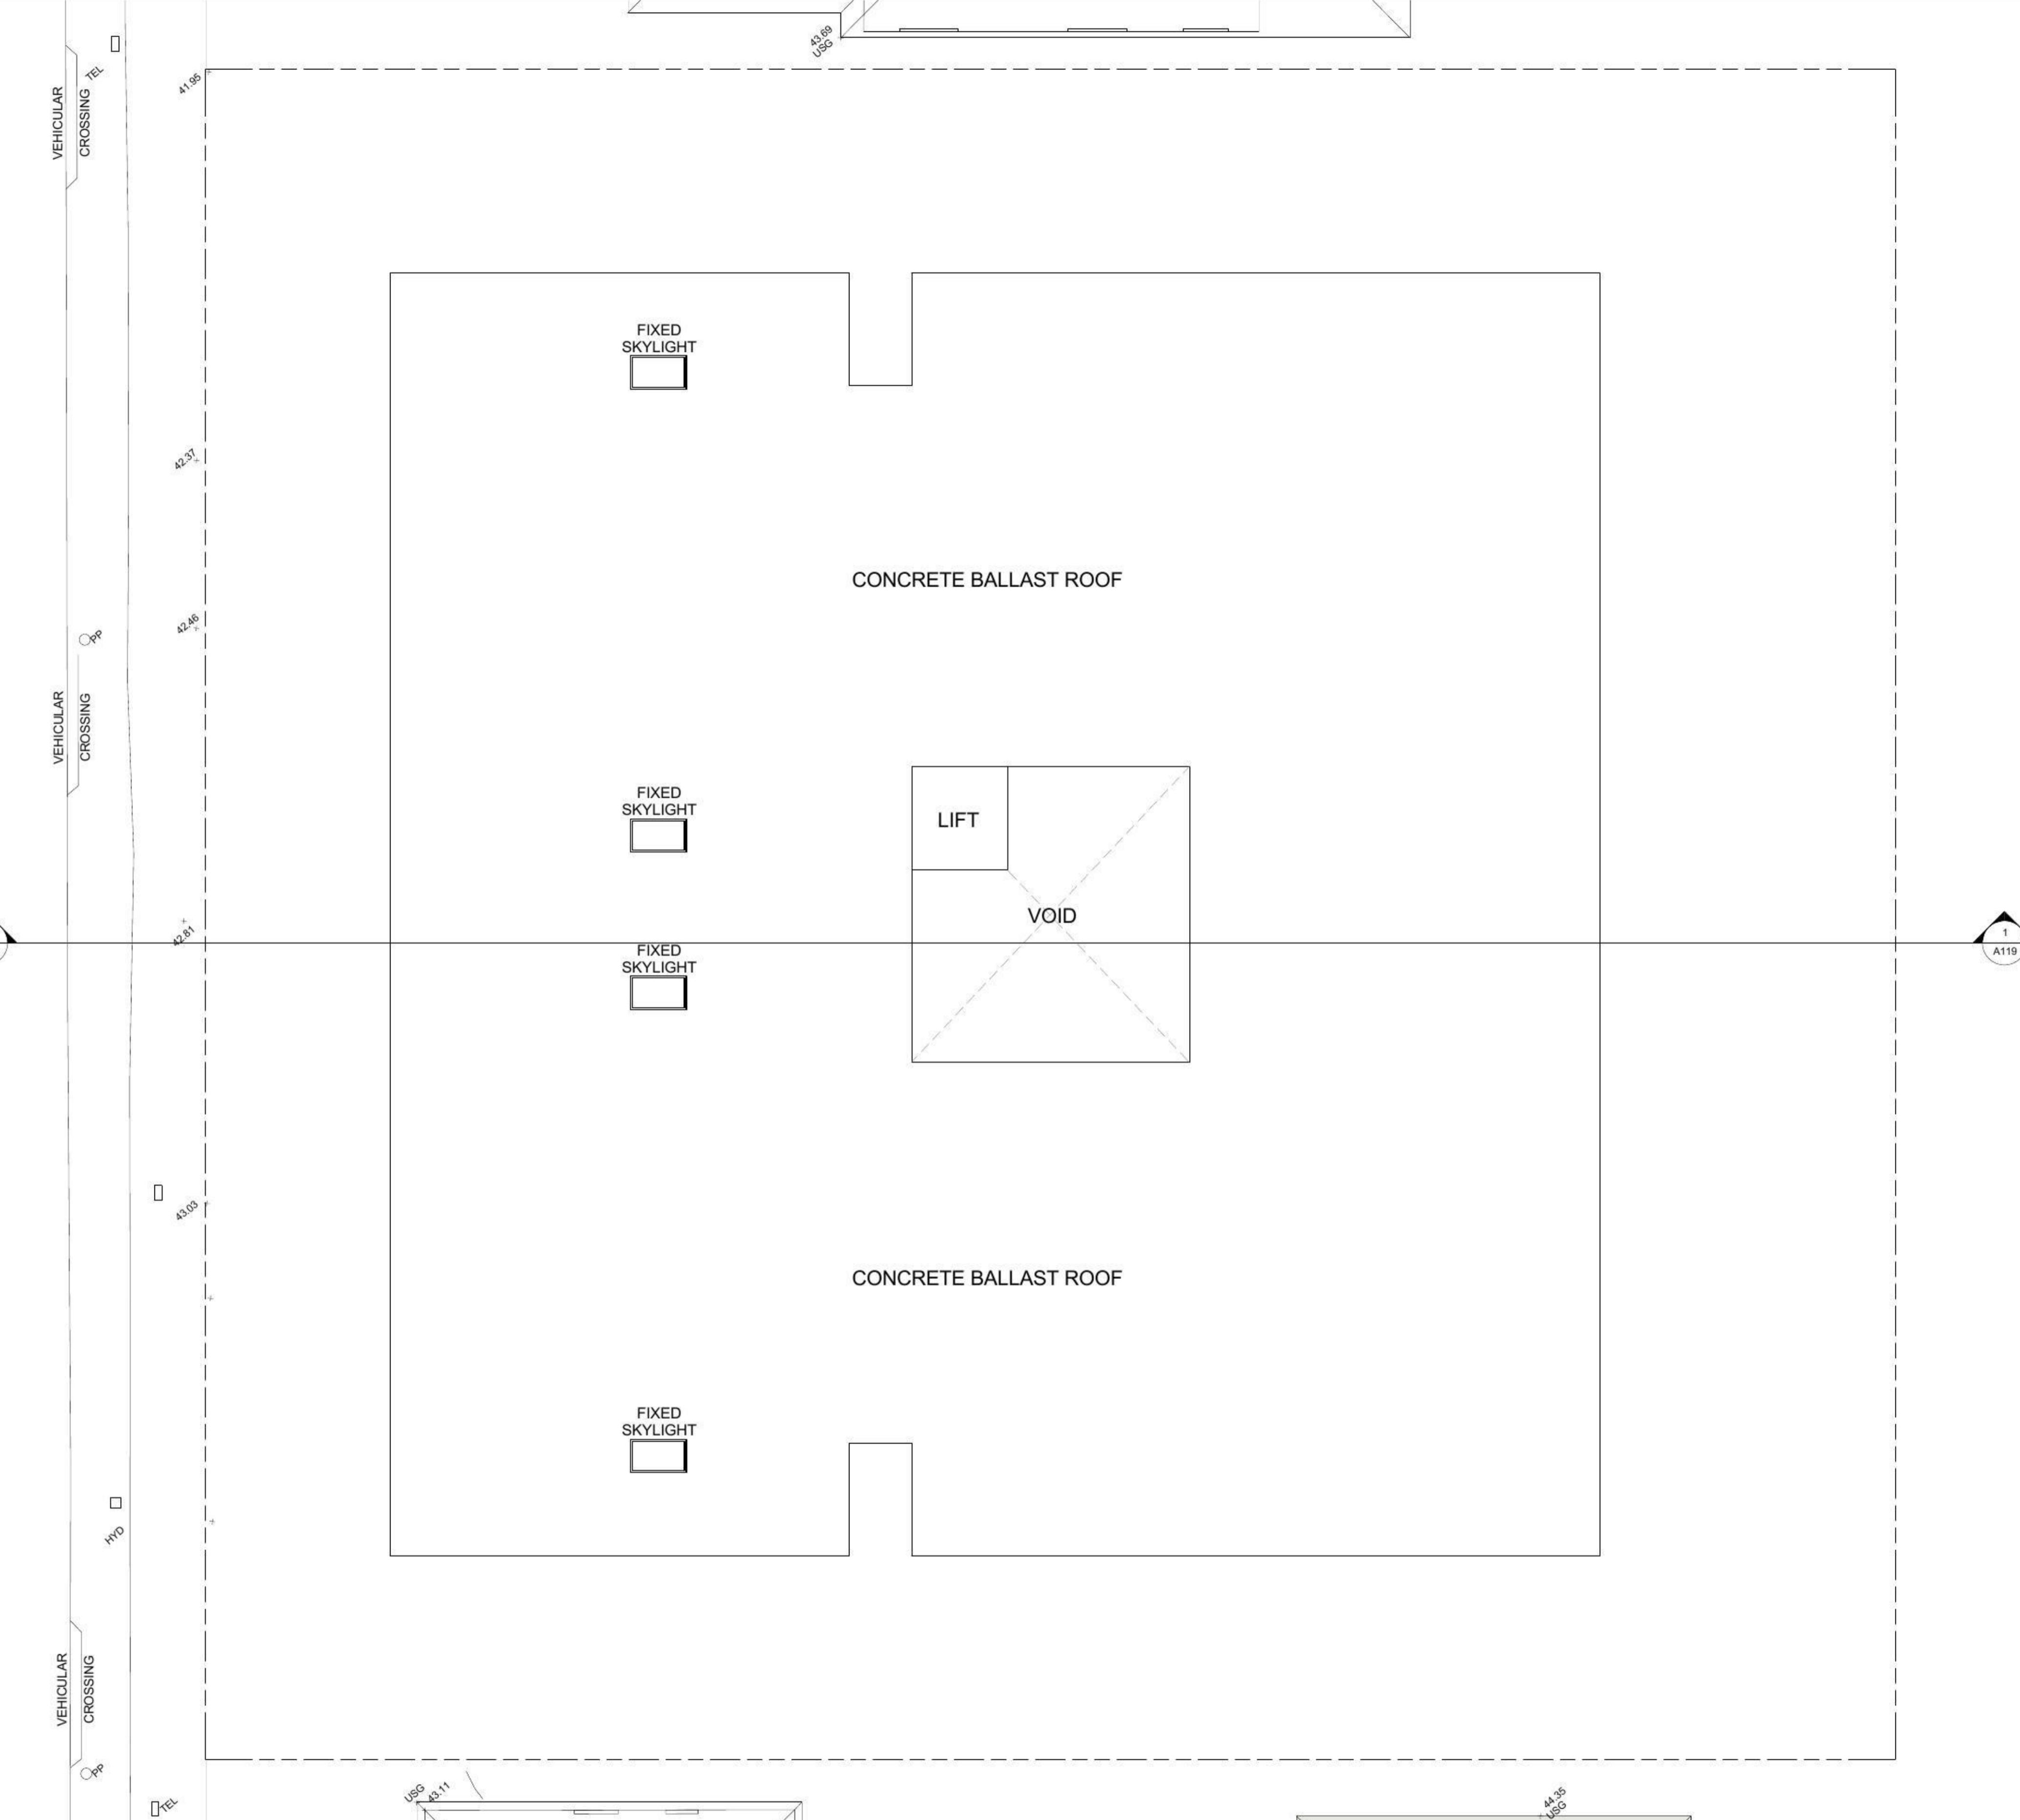Door Schedule				
Mark	Width	Height	Function	Count
1	3200	2400	Exterior	51
2	1100	2400	Exterior	39
3	4200	2400	Exterior	10
4	2100	2400	Exterior	15
5	1800	2400	Exterior	1
6	950	2100	Exterior	73
GD1	2800	2400	Exterior	1
GD2	6000	2400	Exterior	1

Grand total: 191


Window Schedule			
Mark	Width	Height	Count
1	1100	2700	48
2	1200	600	44
3	2100	600	13
4	750	1800	12

Grand total: 117

Mechanical/Natural Ventilation to Comply with the Building Code of Australia Protection of the Environment Operations Act 1992 and Australian Standards		
Access for people with disabilities must be provided in accordance with the requirements of the Building Code of Australia, relevant Australian standards and with regard to the Disability Discrimination Act 1992.		



SHADOWCLAD PAINTED
DULUX - DOMINO

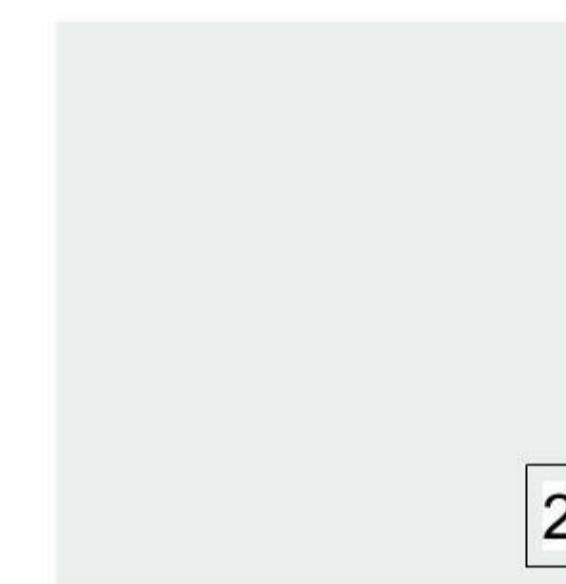

PAINTED RENDER
DULUX - LEXICON



PAINTED RENDER
DULUX - TIMELESS GREY



PAINTED RENDER
DULUX - DOMINO



TIMBA - STEEL CLADDING
TIMBER FINISH




WINDOW & DOOR FRAME
POWDERCOATED CHARCOAL

No.	Description	Date
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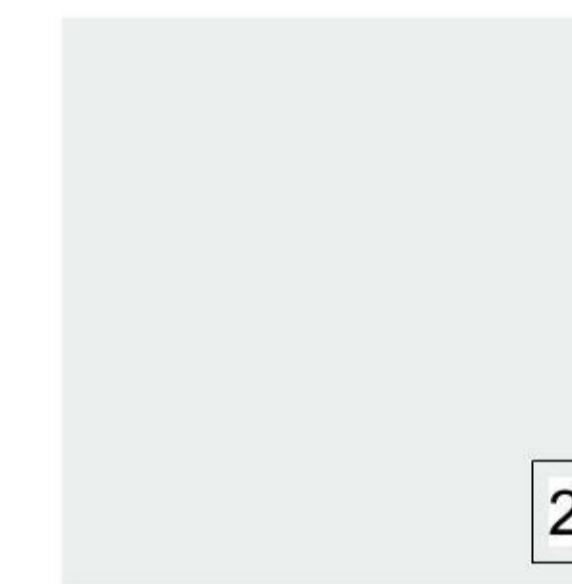
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NORTH ELEVATION	

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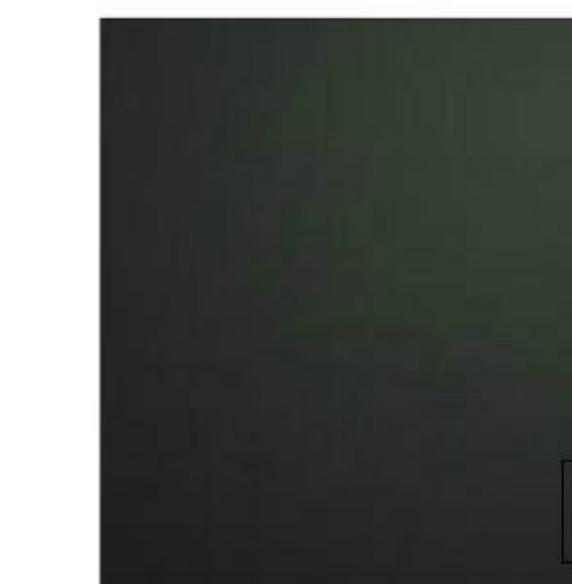
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DULUX - LEXICON



PAINTED RENDER
DULUX - TIMELESS GREY

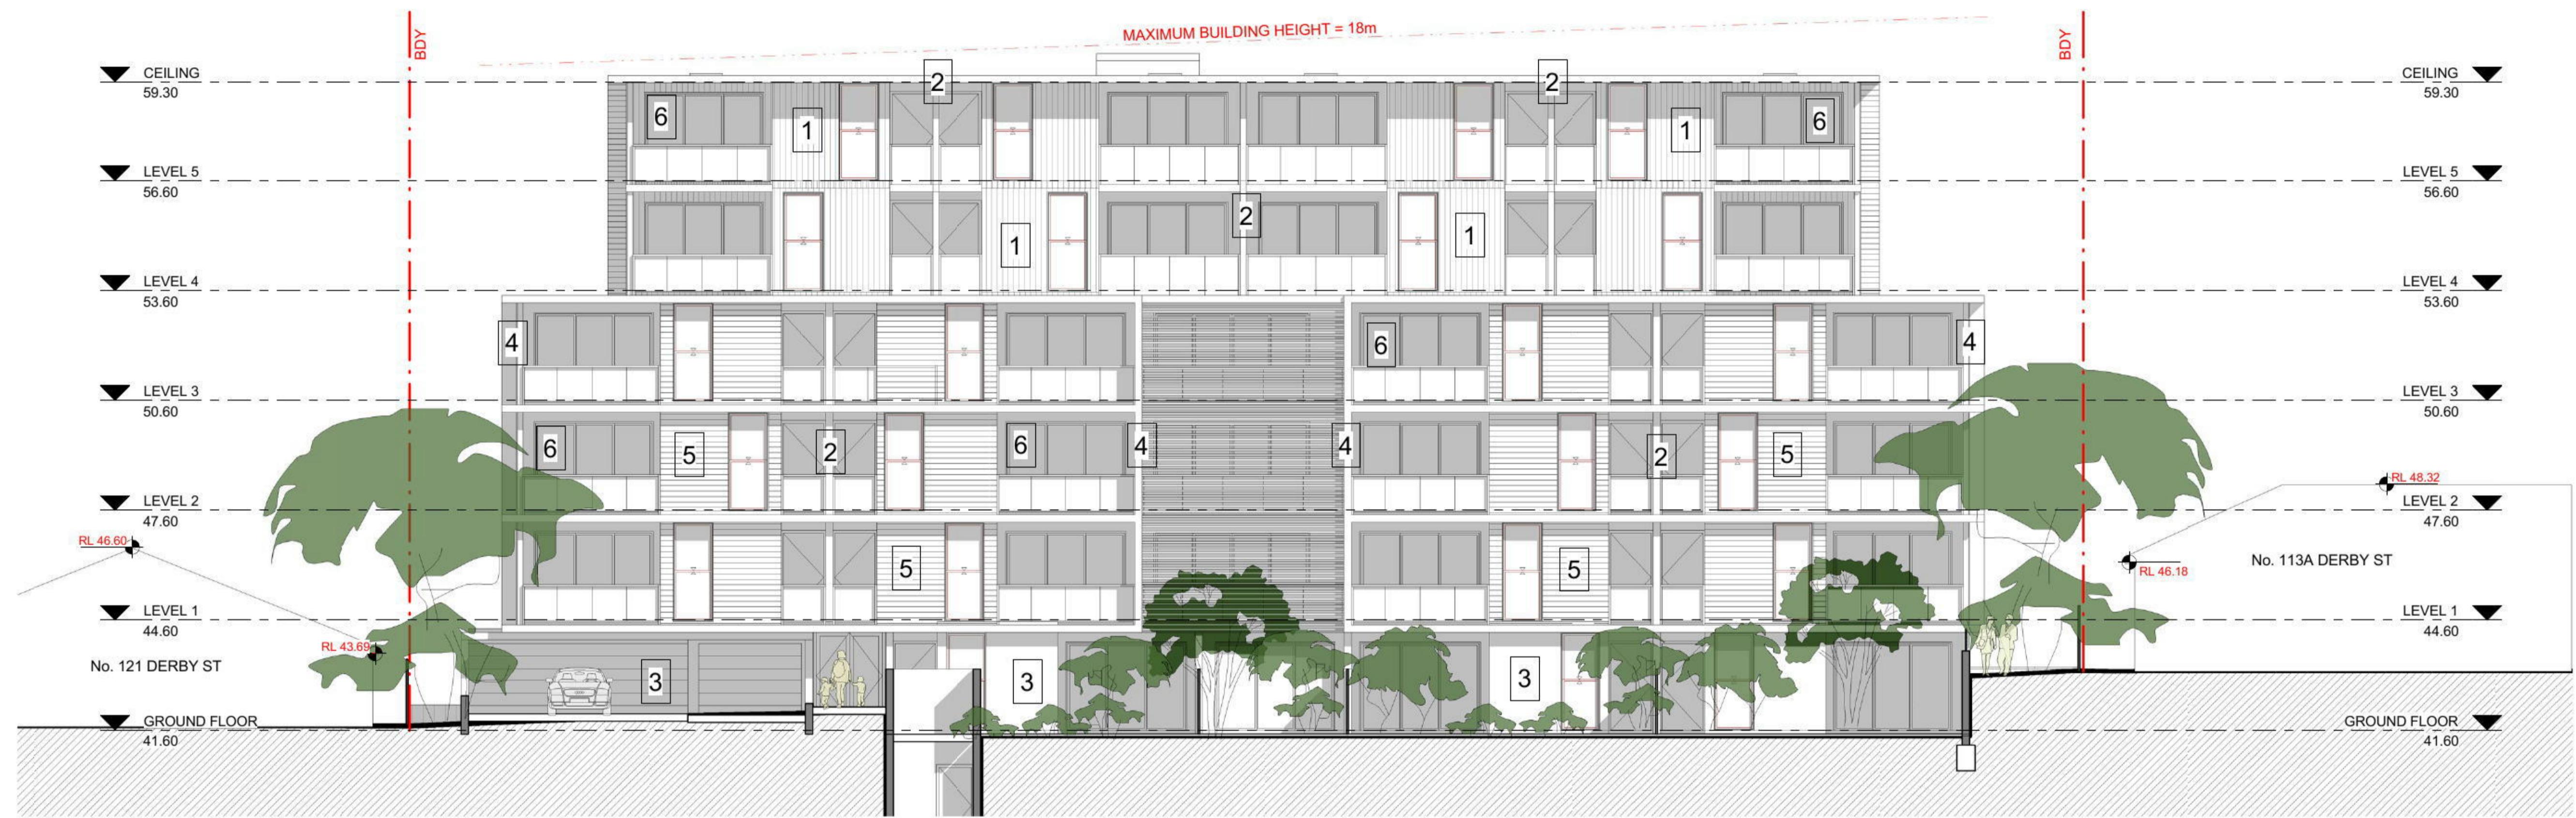

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DULUX - DOMINO



TIMBA - STEEL CLADDING
TIMBER FINISH



WINDOW & DOOR FRAME
POWDERCOATED CHARCOAL

design

No.	Description	Date
A	ISSUED FOR DEVELOPMENT APPLICATION	23-12-2015

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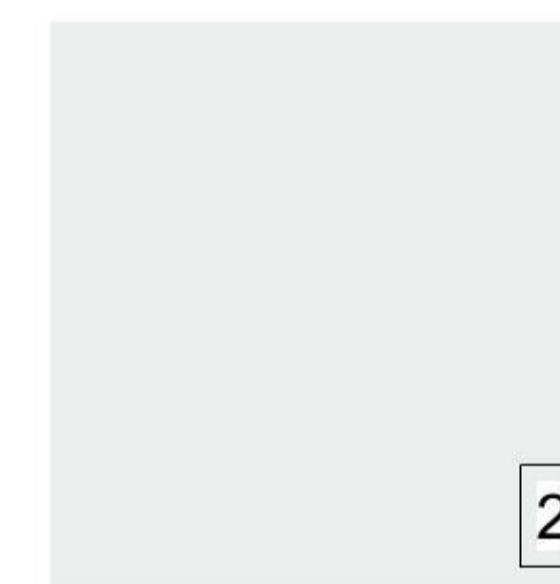
SOUTH ELEVATION

DEVELOPMENT APPLICATION PROPOSED UNIT DEVELOPMENT		Scale 1 : 100
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ADDRESS: 115-119 DERBY ST, PENRITH	Checked by CK	Sheet number
		Project number 15035-01

A116




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DULUX - DOMINO



PAINTED RENDER
DULUX - LEXICON



PAINTED RENDER
DULUX - TIMELESS GREY

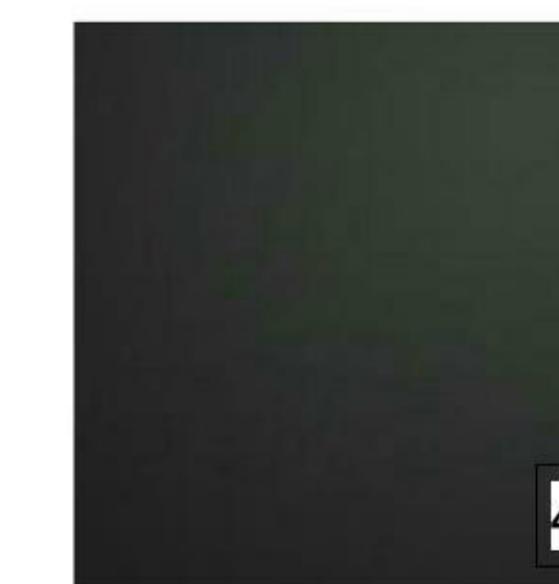

PAINTED RENDER
DULUX - DOMINO



TIMBA - STEEL CLADDING
TIMBER FINISH



WINDOW & DOOR FRAME
POWDERCOATED CHARCOAL

design

No.	Description	Date
A	ISSUED FOR DEVELOPMENT APPLICATION	23-12-2015

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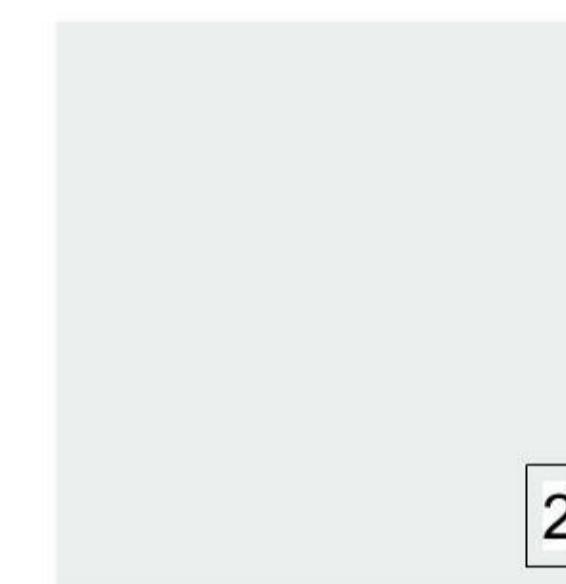
EAST ELEVATION

DEVELOPMENT APPLICATION PROPOSED UNIT DEVELOPMENT		Scale 1 : 100
CLIENT: ELCON PTY LTD	Drawn by MC / TA	Date DEC 2015
ADDRESS: 115-119 DERBY ST, PENRITH	Checked by TA	Sheet number
		Project number 15035-01


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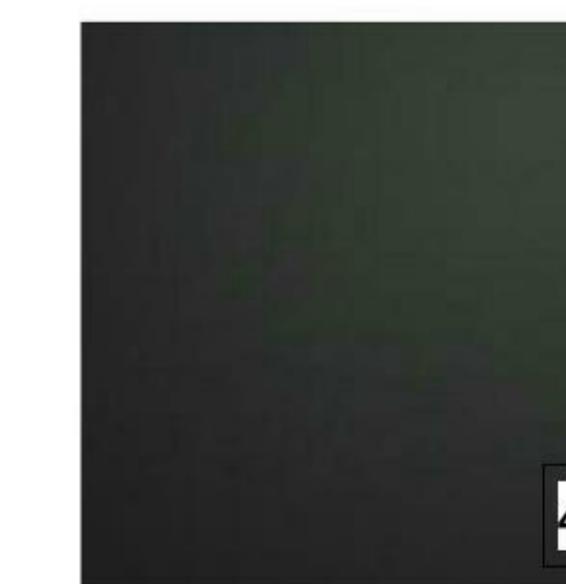
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DULUX - DOMINO



PAINTED RENDER
DULUX - LEXICON



PAINTED RENDER
DULUX - TIMELESS GREY

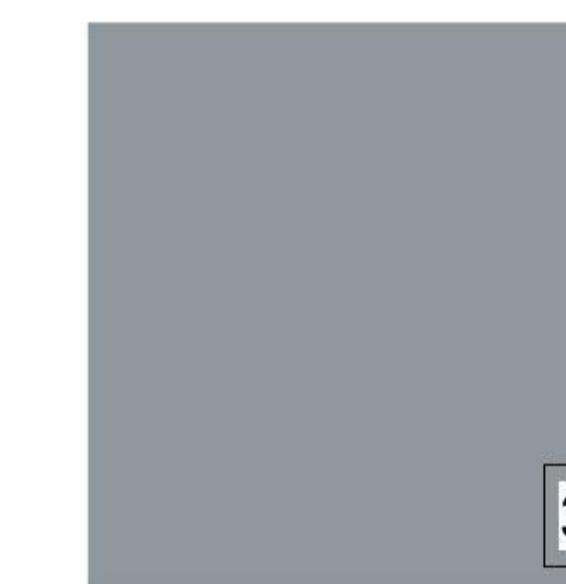

PAINTED RENDER
DULUX - DOMINO



TIMBA - STEEL CLADDING
TIMBER FINISH



WINDOW & DOOR FRAME
POWDERCOATED CHARCOAL

design


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WEST ELEVATION

DEVELOPMENT APPLICATION PROPOSED UNIT DEVELOPMENT		Scale 1 : 100
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ADDRESS: 115-119 DERBY ST, PENRITH	Checked by CK	Sheet number
		Project number 15035-01


A118



SITE AREA= 2090.0sqm	
TOTAL UNIT MIX	
3 BED UNIT:	4 UNITS
2 BED UNIT:	43 UNITS
1 BED + STUDY UNIT:	6 UNITS
1 BED UNIT:	8 UNITS
TOTAL UNITS:	61 UNITS
F.S.R PROPOSED	N/A
LANDSCAPED AREA (deep soil) REQUIRED	731.0sqm 35%
PROPOSED	813.0sqm 38.89%
SOLAR ANALYSIS REQUIRED PROPOSED 44/62	2HRS=70% 2HRS=70%
CROSS VENTILATION REQUIRED PROPOSED	50% 89%
CAR PARKING RESIDENTIAL VISITOR SERVICE CARWASH	65 SPACES 12 SPACES 2 SPACES 1 SPACE

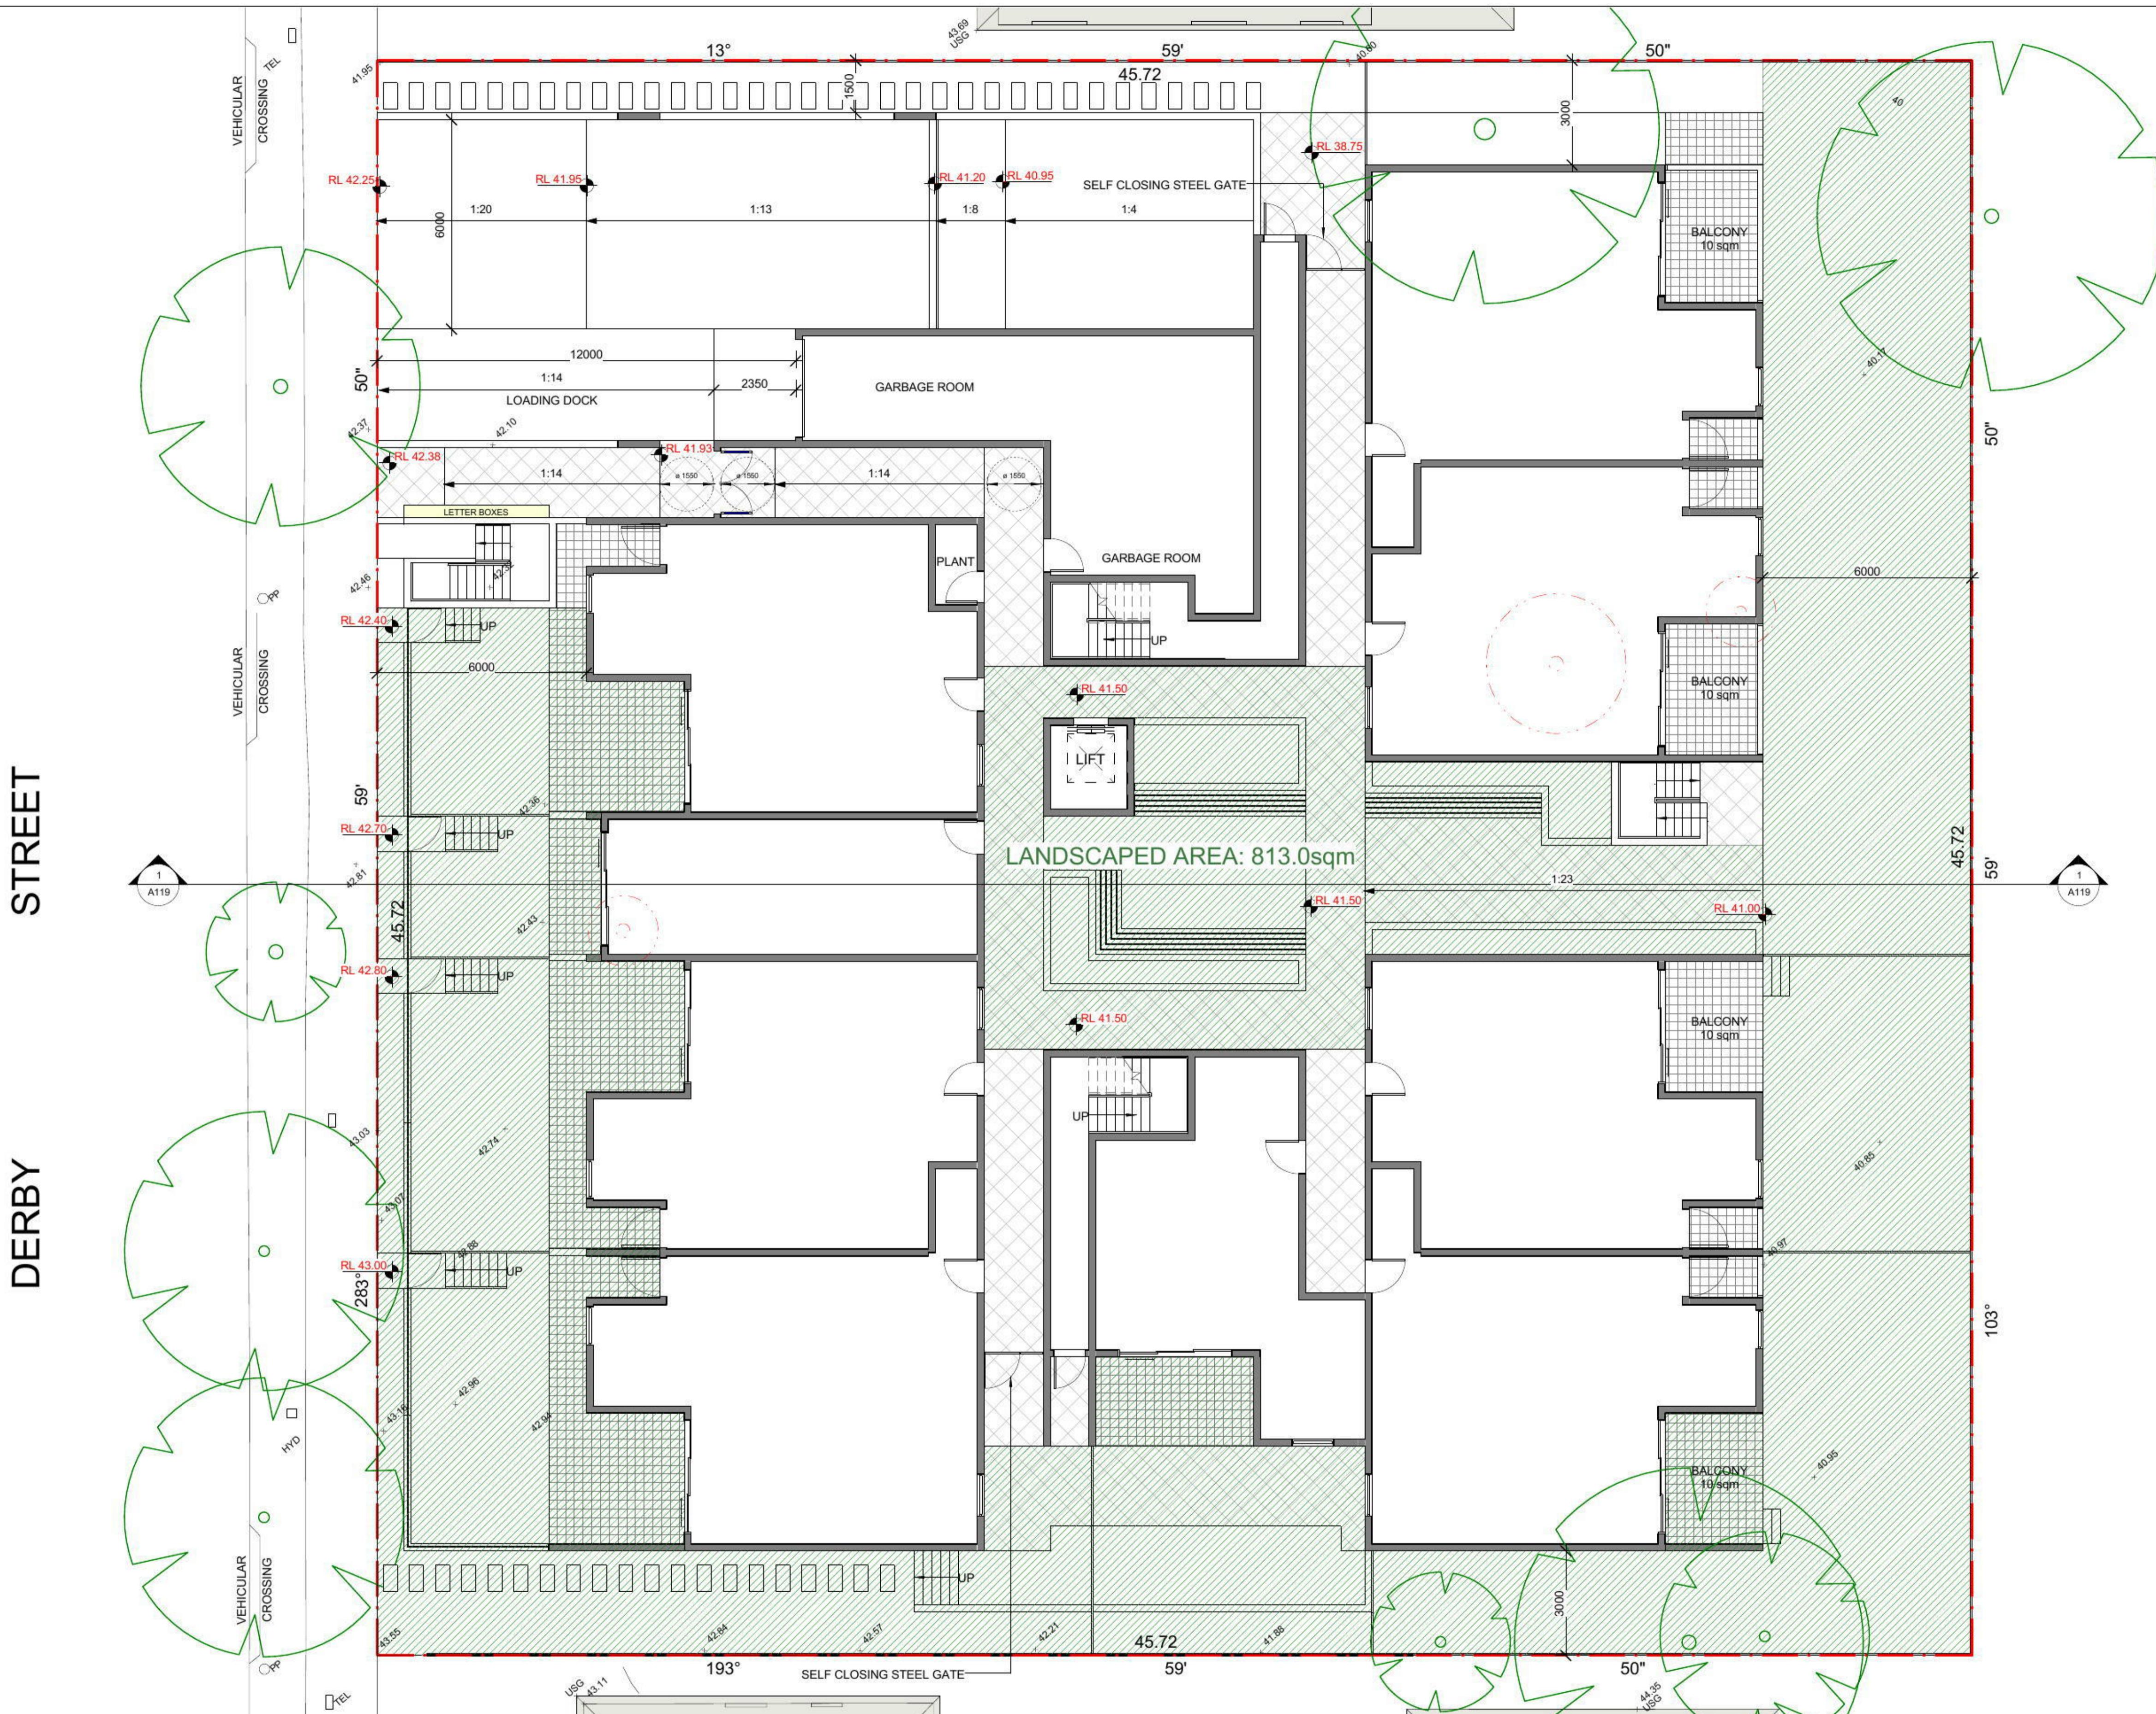Design

SITE CALCULATIONS

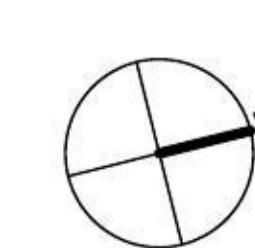

DEVELOPMENT APPLICATION

PROPOSED UNIT DEVELOPMENT

CLIENT: EICON PTY LTD

ADDRESS:
115-119 DERBY ST, PENRITH

Scale	1 : 100	
Drawn by	TA	Date DEC 2015
Checked by	CK	Sheet number
Project number	15035-01	A120