PROPOSED PENRITH PUB RE-DEVELOPMENT

CONCEPT CIVIL DESIGN

LOTS 21 & 22 DP1236215 MEMORIAL AVE, PENRITH NSW 2750



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N.T.S.

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Issue	Date	Amendment	Int.	App.	CO-ORDINA	FED REFERENCE DRAWINGS			Client / Architect:
Α	31.03.20	ISSUED FOR DA SUBMISSION	RM	MW	SERVICE	DRAWING NUMBER	ISSUE	DATE	
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						BUT ARE NOT SHOWN TO SCALE			



PENRITH PUB
REDEVELOPMENT

MEMORIAL AVENUE PENRITH
NSW 2750

CIVIL SERVICES COVER SHEET

North Point:	Design: CV
	Design Validated:
	Amendment Approved: LDG
	Drawn:
Date: JAN 2020	Scale: N/A
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GENERAL NOTES:

- 1. THE NOTES CONTAINED ON THIS DRAWING ARE TYPICAL STANDARDS ONLY. ANY SPECIFIC DETAILS PROVIDED ELSEWHERE ARE TO TAKE PRECEDENCE.
- 2. THESE DRAWINGS ARE TO BE READ IN CONJUNCTION WITH THE RELATED SOIL EROSION CONTROL NOTES, RELATED ROAD AND DRAINAGE PLANS, SPECIFICATION AND STANDARD DRAWINGS AS APPLICABLE.
- ALL WORK IS SUBJECT TO STATUTORY REQUIREMENTS, INCLUDING BUT NOT LIMITED TO WORK HEALTH AND SAFETY REQUIREMENTS, & APPROPRIATE TRAFFIC CONTROL REQUIREMENTS.
- THE CONTRACTOR IS TO PROVIDE ALL NECESSARY LABOUR, PLANT, MATERIALS AND ANYTHING ELSE REQUIRED TO COMPLETE THE INTENT OF THE DESIGN.
- 5. IT IS THE RESPONSIBILITY OF THE CONTRACTOR TO SET OUT IN BOTH LINE AND LEVEL FOR THE WORKS IN ACCORDANCE WITH THE DESIGN.
- 6. THE CONTRACTOR IS TO ALLOW FOR THE COST OF TESTING. ALL TESTING IS TO BE DONE BY A NATA REGISTERED LABORATORY, TEST RESULTS ARE TO BE SUBMITTED TO THE PRINCIPAL FOR APPROVAL PRIOR TO WORK PROCEEDING
- THE CONTRACTOR SHALL ENSURE THAT THE ADJOINING PROPERTY OWNERS ARE NOT DEPRIVED OF ALL WEATHER ACCESS NOR ARE SUBJECTED TO ADDITIONAL
- STORMWATER RUNOFF. 8. THE CONTRACTOR SHALL ENSURE THAT ALL EROSION AND SEDIMENTATION

CONTROL STRUCTURES ARE IN PLACE PRIOR TO COMMENCING.

- 9. THE CONTRACTOR SHALL NOT ENTER UPON ADJOINING PROPERTY WITHOUT THE PERMISSION OF THE OWNER/OCCUPIER.
- 10. THE SITE IS TO BE LEFT CLEAN AND TIDY, AND TO THE SATISFACTION OF THE PRINCIPAL.
- 11. WHERE MIENGINEERS RELIES ON THE INFORMATION SUPPLIED BY OTHERS TO PRODUCE THE DESIGNS. WE ACCEPT NO LIABILITY FOR ERRORS, TO THE EXTENT THAT THE DESIGN HAS MADE RELIANCE ON THIS INFORMATION

CLEARING AND GRUBBING

- THE CONTRACTOR SHALL GIVE COUNCIL & THE PRINCIPAL AT LEAST THREE FULL WORKING DAYS NOTICE OF INTENTION TO COMMENCE CLEARING OPERATIONS.
- 2. THE CONTRACTOR SHALL AVOID UNWARRANTED DAMAGE TO ALL NATURAL FLORA ON SITE AND ON THE ADJACENT LAND.
- 3. ONLY TREES IDENTIFIED TO BE REMOVED ON THE DRAWINGS ARE TO BE FELLED OR DAMAGED IN ANY WAY. SURPLUS SOIL IS TO BE KEPT WELL CLEAR OF EXISTING TREE TRUNKS. CARE MUST BE TAKEN TO PROTECT THE ROOTS OF TREES TO BE RETAINED.
- 4. NO TREES SHALL BE CLEARED WITHOUT OBTAINING THE WRITTEN APPROVAL OF THE COUNCIL.
- ALL MATERIAL CLEARED OR GRUBBED SHALL BE DISPOSED OF BY THE CONTRACTOR TO AN APPROVED SITE. THE CONTRACTOR SHALL PAY ALL FEES. BURNING IS NOT PERMITTED.
- 6. ANY HOLES OR DEPRESSION CAUSED BY THE CLEARING OR GRUBBING WORK SHALL BE INSPECTED BY THE PRINCIPAL. HOLES ARE TO BE BACKFILLED WITH APPROVED MATERIAL, AND COMPACTED TO AT LEAST 98% OF STANDARD MAXIMUM DRY DENSITY

- 1. TOPSOIL INCLUDING ALL GRASS COVER SHALL BE STRIPPED FROM THE WHOLE OF THE AFFECTED AREA TO THE DEPTH SPECIFIED IN THE DRAWINGS OR AS REQUIRED OR, WHERE NO DEPTH IS SPECIFIED, TO A MINIMUM DEPTH OF 100mm.
- 2. STRIPPED SURFACES WILL NEED TO BE INSPECTED BY THE PRINCIPAL OR A SUITABLY QUALIFIED GEOTECHNICAL ENGINEER PRIOR TO THE COMMENCEMENT OF EARTHWORKS TO ENSURE THE AREAS HAVE BEEN ADEQUATELY STRIPPED.
- 3. THE STRIPPED TOPSOIL IS TO BE STOCKPILED IN THE LOCATIONS SHOWN ON THE SOIL AND WATER MANAGEMENT PLAN. IF STOCKPILE LOCATIONS ARE NOT INDICATED THEY ARE TO BE PLACED GENERALLY IN ACCORDANCE WITH MUS AND TO THE SATISFACTION OF THE PRINCIPAL. THE SURFACE OF STOCKPILES IS TO BE COVERED WITH GEOFABRIC TO PREVENT SEDIMENT LOSS.
- THE STOCKPILED TOPSOIL IS TO BE RE-SPREAD OVER THE FINISHED SURFACE (IN THE LOCATIONS INSTRUCTED BY THE PRINCIPAL) IMMEDIATELY FOLLOWING COMPLETION OF EARTHWORKS. DEPTHS OF TOPSOIL SHALL BE A MINIMUM OF 75mm BUT SHALL NOT EXCEED 250mm.
- 5. SURPLUS TOPSOIL SHALL NOT BE SPREAD OVER THE SITE WITHOUT THE WRITTEN PERMISSION OF THE PRINCIPAL.
- 6. NEWLY TOPSOILED AREAS ARE TO BE IMMEDIATELY REVEGETATED IN ACCORDANCE WITH THE APPROVED SOIL AND WATER MANAGEMENT PLAN & MUS.

FILL AND COMPACTION:

- 1. FILL IS TO BE PLACED IN HORIZONTAL LAYERS NOT EXCEEDING 150mm COMPACTED THICKNESS.
- 2. FILL IS TO BE COMPACTED TO AT LEAST 100% OF STANDARD MAXIMUM DRY DENSITY AS DETERMINED BY AS1289-5.1.1.
- COMPACTION TESTING SHALL OCCUR AT THE RATE OF AT LEAST ONE TEST PER 500mm THICKNESS, 300m2 AREA OR 150m3 VOLUME, WHICHEVER GIVES MAXIMUM NUMBER OF TESTS.
- 4. ALL COMPACTION TESTING IS TO BE PERFORMED BY A NATA REGISTERED LABORATORY UNDER THE CONTROL OF A SUITABLY QUALIFIED GEOTECHNICAL ENGINEER WHO SHALL SUPERVISE THE WORKS TO AT LEAST LEVEL 2 CONTROL AS DEFINED BY AS3798.
- ALL COMPACTION TEST RESULTS SHALL BE SUBMITTED TO THE PRINCIPAL AS THEY BECOME AVAILABLE, BUT NO LATER THAN 48hrs AFTER TESTING.

SOIL/WATER MANAGEMENT AND PROTECTION OF THE ENVIRONMENT

- 1. ALL SOIL EROSION AND SEDIMENT CONTROL MEASURES AND STRUCTURES SHALL BE LOCATED, CONSTRUCTED & MAINTAINED IN ACCORDANCE WITH THE GUIDELINES AND PRINCIPLES AS OUTLINED IN LANDCOM'S "SOILS AND CONSTRUCTION" VOLUME 1 (MANAGING URBAN STORMWATER 4TH EDITION, MARCH 2004).(MUS).
- 2. THE CONTRACTOR IS RESPONSIBLE FOR CARRYING OUT ALL EARTHWORKS, ROAD AND DRAINAGE CONSTRUCTION GENERALLY IN ACCORDANCE WITH MUS AND TO THE SATISFACTION OF COUNCIL, THE SOIL CONSERVATION SERVICE AND THE PRINCIPAL.
- 3. CONSTRUCTION SEQUENCE SHALL BE PLANNED SO THAT LAND DISTURBANCE IS CONFINED TO AREAS OF MANAGEABLE SIZE. STABILISATION MEASURES SHALL BE APPLIED TO THE FIRST DISTURBED SECTION PRIOR TO COMMENCING ON THE NEXT SECTION.
- BEFORE STRIPPING TOPSOIL ALL AREAS TO BE EXPOSED SHALL BE CLEARED AND GRUBBED OF ALL EXCESSIVE VEGETATION.
- 5. ALL WORK SHALL BE CARRIED OUT IN SUCH A MANNER AS TO AVOID NUISANCE AND/OR DAMAGE TO THE ENVIRONMENT. THE CONTRACTOR SHALL COMPLY WITH THE REQUIREMENTS OF THE CONDITIONS OF APPROVAL IMPOSED BY THE COUNCIL, THE ENVIRONMENTAL PROTECTION AUTHORITY, THE CLEAN WATERS ACT, THE CLEAN AIR ACT AND THE NOISE CONTROL ACT. THE CONTRACTOR IS TO ALLOW FOR THIS IN THEIR TENDER.
- 6. HERBICIDES AND OTHER TOXIC CHEMICALS SHALL NOT BE USED ON THE SITE WITHOUT THE PRIOR WRITTEN APPROVAL OF THE PRINCIPAL
- 7. NO NOISE, SMOKE, OR OTHER NUISANCE WHICH IN THE OPINION OF THE PRINCIPAL IS UNNECESSARY OR EXCESSIVE SHALL BE PERMITTED BY THE CONTRACTOR IN THE PERFORMANCE OF THE WORKS UNDER THIS CONTRACT. SHOULD WORK OUTSIDE CUSTOMARY WORKING HOURS BE APPROVED, THE CONTRACTOR SHALL NOT USE, DURING SUCH PERIOD, ANY PLANT, MACHINERY OR EQUIPMENT WHICH IN THE OPINION OF THE PRINCIPAL IS CAUSING OR LIKELY TO CAUSE A NUISANCE TO THE PUBLIC. NO NOISY WORKS AND/OR WORKS LIKELY TO DISTURB NEARBY RESIDENTS SHALL BE UNDERTAKEN DURING THE HOURS PRECLUDING SUCH ACTIVITY AS SPECIFIED BY COUNCIL IN ACCORDANCE WITH THE REQUIREMENTS FOR DEVELOPMENT CONSENT AND BUILDING APPROVAL MADE UNDER THE LOCAL GOVERNMENT ACT AND THE NOISE CONTROL ACT.
- 8. THE CONTRACTOR SHALL ENSURE THAT FUGITIVE DUST FROM DISTURBED AREAS IS MINIMISED BY A METHOD APPROVED BY THE PRINCIPAL
- 9. TOPSOIL REQUIRED TO BE RESPREAD ON SITE SHALL BE STOCKPILED CLEAR OF HAZARDS SUCH AS DRAINAGE AREAS, REMAINING TOPSOIL SHALL BE REMOVED AND STOCKPILED WHERE AGREED. STOCKPILED TOPSOIL IS TO BE RE-SPREAD LATER ON AREAS TO BE REVEGETATED AND STABILISED ONLY (ie. ALL FOOTPATHS, BATTERS, DRAINAGE RESERVE AND CHANNELS). TOPSOIL SHALL NOT BE SPREAD ON ANY OTHER AREAS UNLESS SPECIFICALLY APPROAVED BY THE PRINCIPAL. STOCKPILES REMAINING LONGER THAN THREE MONTHS SHALL BE PROTECTED FROM EROSION BY COVERING WITH A MULCH AND HYDROSEEDING AND, IF NECESSARY, BY LOCATING BANKS OR DRAINS UPSLOPE TO DIVERT RUNOFF
- 10. THE CONTRACTOR SHALL REGULARLY MAINTAIN ALL SEDIMENT AND EROSION CONTROL DEVICES AND REMOVE ACCUMULATED SILT ETC BEFORE NO MORE THAN 60% OF THEIR CAPACITY IS LOST. ALL SILT REMOVED SHALL BE DISPOSED OF AS DIRECTED BY THE PRINCIPAL. CONTROL DEVICES SHALL BE MAINTAINED. UNTIL ALL DISTURBED AREAS ARE REVEGETATED OR FURTHER AS MAY BE DIRECTED BY THE PRINCIPAL IN ACCORDANCE WITH THE CONTRACT.
- 11. CUT AND FILL BATTERS SHALL BE:
- FORMED AT MAXIMUMS OF 2:1 IN CUT AND 3:1 IN FILL U.N.O.
- TOPSOILED AS SOON AS PRACTICABLE AFTER FORMATION WITH A: MINIMUM DEPTH OF 75mm AND MAXIMUM OF 250mm.
- ii. SCARIFIED BEFORE TOPSOILING.
- SEEDED WITHIN 7 DAYS OF TOPSOILING WITH AN APPROVED MIX. c. WHERE LENGTH OF CUT BATTER SLOPES EXCEED 3m THE BATTER SHALL BE PROTECTED BY EITHER A CUT-OFF DRAIN 150mm DEEP OR A SOIL CUT-OFF BANK 150mm HIGH LEADING TO A SEDIMENT TRAP SO AS TO CONTROL RUNOFF OVER BATTERS PRIOR TO THEIR REVEGETATION.

12. OUTLETS:

- a. ALL WATER SHALL BE RELEASED IN A NON-SEDIMENT MANNER, GENERALLY IN
- ACCORDANCE WITH MUS. b. ENERGY DISSIPATERS SHALL BE PROVIDED AS APPROVED BY THE PRINCIPAL WHEN DISCHARGE FLOW VELOCITIES ARE NOT IN ACCORDANCE WITH MUS.
- c. SHALL HAVE CAPACITY TO DISCHARGE THE 5 YEAR CRITICAL STORM EVENT WITHOUT CAUSING FAILURE OF THE STRUCTURE. d. AGGREGATE FOR OUTLETS SHALL BE CRUSHED BASALT OR EQUIVALENT
- APPROVED BY THE PRINCIPAL
- 13. EARTH OR HAY BALE BANKS:
- a. SHALL BE PROVIDED WHERE REQUIRED. i. TO DIVERT SEDIMENT LADEN RUNOFF TO A SEDIMENT TRAP OR BASIN, OR ii. INCORPORATED AS PART OF A BARRIER OR DAM USED TO INTERCEPT AND
- RETARD SEDIMENT LADEN RUNOFF. b. FREEBOARD: BANKS SHALL HAVE FIXED 300mm FREEBOARD WHEN USED AS A DIVERSION BANK.
- 14. SLOPES LONGER THAN 80m ARE TO HAVE CHECK DAMS INSTALLED. REFER TO STANDARD DRAWING 5-4 (MUS) FOR DETAILS.
- 15. WHERE PRACTICAL, MAINTAIN OR IMPROVE EXISTING CLEAN WATER DRAINS TO DIVERT WATER AROUND THE SITE.
- 16. PERMANENT DRAINAGE FEATURES ARE TO BE INSTALLED AS EARLY AS POSSIBLE DURING THE CONSTRUCTION PERIOD.
- 17. DRAINAGE CHANNELS AND CATCH DRAINS ARE TO BE STABILISED WITH MATERIAL SUCH AS JUTE MESH, GEOFABRIC, MEDIUM / HIGH PERFORMANCE TURF REINFORCEMENT MATS (TRMS).

SMOOTH JUNCTIONS:

CONSTRUCTION WORK CARRIED OUT UNDER THIS CONTRACT ADJACENT TO ADJOINING WORKS, SHALL MAKE SMOOTH JUNCTIONS WITH EXISTING WORK, AS APPROPRIATE.

SUBGRADE:

- 1. PAVEMENT SUBGRADES SHALL BE PREPARED TO A WIDTH EXTENDING AT LEAST 150mm BEHIND THE REAR EDGE OF KERBING OR IF THERE IS NO KERBING THE OUTER EDGE OF THE ROAD SHOULDER OR AS SHOWN ON THE DRAWINGS.
- THE SUBGRADE SURFACE SHALL BE TRIMMED TO A TOLERANCE OF +14mm TO -30mm OF THE DESIGN LEVEL.
- THE TOP 150mm OF THE SUBGRADE MATERIAL IS TO BE COMPACTED TO A MINIMUM OF 100% OF STANDARD MAXIMUM DRY DENSITY (AS1289-5.1.1).
- 4. WHERE ROCK IS ENCOUNTERED IN THE SUBGRADE, IT SHALL BE RIPPED TO A MINIMUM DEPTH OF 150mm AND RECONSOLIDATED ABOVE.
- THE SUBGRADE SHALL BE PROOF ROLLED IN THE PRESENCE OF THE PRINCIPAL TO ENSURE UNIFORM PREPARATION. SUCH PROOF ROLLING SHOULD BE PERFORMED USING A 3 POINT ROLLER OF NOT LESS THAT 9 TONNES MASS, OR APPROVED ALTERNATIVE. BENKELMAN BEAM TESTING MAY BE CARRIED OUT IN A REGULAR PATTERN OVER THE SUBGRADE AS AN ALTERNATIVE TO PROOF ROLLING.
- 6.SUBGRADE COMPACTION TESTING IS TO BE CARRIED OUT BY A NATA REGISTERED LABORATORY AT THE RATE OF ONE DENSITY TEST PER 500m² OF NEW PAVEMENT (OR PART THEREOF). PROOF ROLLING SHALL TAKE PLACE OVER THE ENTIRE SUBGRADE SURFACE.
- 7. COPIES OF COMPACT TEST RESULTS MUST BE SUBMITTED TO THE PRINCIPAL UPON RECEIPT FROM THE TESTING LABORATORY.
- 8. ALL SUBGRADE PREPARATION MUST BE INSPECTED AND APPROVED BY THE PRINCIPAL PRIOR TO PAVEMENT WORKS PROCEEDING.

- ALL SUBBASE MATERIALS SHALL COMPLY WITH COUNCIL SPECIFICATION C242B FOR 2A TRAFFIC LOADING.
- 2. THE SUBBASE SHOULD BE SPREAD AND COMPACTED IN LAYERS NOT EXCEEDING 150mm COMPACTED THICKNESS.
- 3. THE WHOLE OF THE SUBBASE SHALL BE COMPACTED TO A MINIMUM COMPACTION OF 98% MODIFIED (AS1289 - 5.2.1).

ANY DIRECTION, BY MORE THAN 25mm.

- 4. FINISHED LEVELS SHOULD BE WITHIN + 20mm OF DESIGN LEVELS. THE SUBBASE SURFACE SHOULD NOT DEVIATE FROM A 3m STRAIGHT EDGE, LAID IN
- 5. THE WHOLE OF SUBBASE SURFACE SHOULD BE PROOF ROLLED USING A 3 POINT ROLLER OF MINIMUM 9 TONNES MASS (OR APPROVED ALTERNATIVE) TO ENSURE UNIFORMITY. THERE SHALL BE NO VISIBLE DEFLECTION UNDER PROOF ROLLING.
- BENKELMAN BEAM DEFLECTION TESTING MAY ALSO BE REQUIRED BY THE PRINCIPAL IN SOME CIRCUMSTANCES FOLLOWING THE COMPACTION OF THE SUBBASE. IF REQUIRED, THIS SHOULD BE PERFORMED AT 20m INTERVALS ALTERNATIVELY ALONG THE WHEEL PATHS. THE CO-EFFICIENT OF VARIATION IN RECORDED DEFLECTION READINGS SHOULD NOT EXCEED 50%.
- ALL COMPACTION TESTING (AND BENKELMAN BEAM TESTING IF REQUIRED) SHALL BE PERFORMED BY A NATA REGISTERED LABORATORY UNDER THE CONTROL OF A SUITABLY QUALIFIED GEOTECHNICAL ENGINEER. DENSITY TESTS SHOULD BE PERFORMED AT LEAST AT THE RATE OF 1 TEST PER 500m² OF NEW PAVEMENT OR PART THEREOF.
- 8. ALL TEST RESULTS MUST BE SUBMITTED TO THE PRINCIPAL UPON RECEIPT FROM THE TESTING LABORATORY.
- ALL SUBBASE PREPARATION MUST BE INSPECTED AND APPROVED BY THE PRINCIPAL PRIOR TO BASE COURSE OR KERB AND GUTTER WORKS.

BASE COURSE:

- 1. ALL BASE COURSE MATERIALS SHALL COMPLY WITH COUNCIL SPECIFICATION C242B FOR 2A TRAFFIC LOADING.
- 2. THE BASE COURSE SHALL BE SPREAD AND COMPACTED IN LAYERS NOT EXCEEDING 150mm COMPACTED THICKNESS.
- 3. THE WHOLE OF THE BASE COURSE SHALL BE COMPACTED TO A MINIMUM COMPACTION OF 98% MODIFIED (AS1289 - 5.2.1).
- 4. FINISHED LEVELS SHOULD BE WITHIN + 10mm OF DESIGN LEVELS. THE BASE COURSE SURFACE SHOULD NOT DEVIATE FROM A 3m STRAIGHT EDGE, LAID IN ANY DIRECTION, BY MORE THAN 15mm.
- THE WHOLE OF THE BASE COURSE SHOULD BE PROOF ROLLED USING A 3 POINT ROLLER OF MINIMUM 9 TONNES MASS (OR APPROVED ALTERNATIVE) TO ENSURE UNIFORMITY.
- BENKELMAN BEAM TESTING MAY ALSO BE REQUIRED BY THE PRINCIPAL IN SOME CIRCUMSTANCES FOLLOWING THE COMPACTION OF THE BASE COURSE. IF REQUIRED, THIS SHOULD BE PERFORMED AT 20m INTERVALS ALTERNATIVELY ALONG THE WHEEL PATHS. THE CO-EFFICIENT OF VARIATION IN RECORDED DEFLECTION READINGS SHOULD NOT EXCEED 30%.
- ALL COMPACTION TESTING (AND BENKELMAN BEAM TESTING IF REQUIRED) SHALL BE PERFORMED BY A NATA REGISTERED LABORATORY UNDER THE CONTROL OF A SUITABLY QUALIFIED GEOTECHNICAL ENGINEER. DENSITY TESTS SHOULD BE PERFORMED AT THE RATE OF 1 TEST PER 500m² OF PAVEMENT OR PART THEREOF.
- ALL TEST RESULTS MUST BE SUBMITTED TO THE PRINCIPAL UPON RECEIPT FROM THE TESTING LABORATORY.
- 9. ALL BASE COURSE PREPARATION MUST BE INSPECTED BY THE PRINCIPAL PRIOR TO SEALING OR KERB AND GUTTER WORKS.

lient / Architect

MATERIALS:

MATERIALS AND WORKMANSHIP SHALL BE THE BEST OF THEIR KIND AND UNLESS OTHERWISE SPECIFIED, SHALL CONFORM TO RELEVANT AUSTRALIAN STANDARDS.

WEARING COURSE:

- 1. SEALING OF ROADS WILL BE PERFORMED IN TWO STAGES. THE FIRST SEAL WILL PROTECT THE ROAD PAVEMENT AND PRODUCE A WEARING SURFACE DURING THE INSTALLATION OF SERVICES IN THE FOOTPATHS. ONCE ALL SERVICES ARE INSTALLED THE FINAL WEARING SURFACE MAY THEN BE LAID.
- THE FOLLOWING PAVEMENT SEALS WILL BE ACCEPTABLE, UNLESS NOMINATED OTHERWISE ON THE DESIGN DRAWINGS:
- a. 30mm AC10 FINAL WEARING SURFACE.
- b. 5mm SINGLE COAT SPRAYED SEAL AS FIRST COAT, FOLLOWED BY ARRB GAP GRADED ASPHALT MIX MINIMUM 25mm CONSOLIDATED THICKNESS. c. 15mm AC5 AS FIRST COAT, FOLLOWED BY ARRB GAP GRADED ASPHALT MIX MINIMUM 25mm CONSOLIDATED THICKNESS.
- 3. FINISHED LEVELS SHOULD BE WITHIN + 10mm OF THE DESIGN LEVELS AND THE FINISHED PROFILE SHOULD NOT DEVIATE FROM THE BOTTOM OF A 3m STRAIGHT EDGE LAID IN ANY DIRECTION BY MORE THAN 7mm.
- ROUGHNESS AS MEASURED BY NAASRA ROUGHNESS METER SHOULD NOT EXCEED 12 COUNTS/100m.
- 5. THE PRINCIPAL MAY REQUIRE THE ASPHALT TO BE TESTED TO ENSURE COMPLIANCE WITH THE ARRB SPECIFICATION.

SUBSURFACE DRAINAGE:

- SUBSURFACE DRAINAGE IS TO BE INSTALLED ALONG THE EDGE OF ALL PAVEMENT AS DETAILED. OR AS DIRECTED BY THE PRINCIPAL.
- SUBSURFACE LINE PIPES AND FITTINGS SHALL BE PERFORATED PLASTIC TO AS2439 PART 1. LAY PIPES ON 100mm OF FILTER MATERIAL GRADED AT MINIMUM 1% AND OVERLAY WITH FILTER MATERIAL EXTENDING TO UNDERSIDE OF PAVEMENT SUB-BASE. PROVIDE FILTER FABRIC AROUND TRENCH AS DETAILED.
- TRENCHES SHALL BE MINIMUM 300mm IN WIDTH AND EXCAVATED TO AT LEAST 500mm BELOW SUBGRADE LEVEL.
- 4. BACKFILL FILTER MATERIAL SHALL MEET THE GRADING REQUIREMENTS AS SET OUT IN MR538. HOWEVER COARSER MATERIAL WILL BE PERMISSIBLE IF THE ENTIRE BACKFILL IS WRAPPED IN A GEOTEXTILE FABRIC (BIDIM A14 OR TERRAM 1000, OR EQUIVALENT).
- 5. "NYLEX STRIP DRAIN" OR EQUIVALENT MAY BE CONSIDERED AN ALTERNATIVE TO CONVENTIONAL SUBSURFACE DRAINS BUT WILL REQUIRE THE SPECIFIC PERMISSION OF THE PRINCIPAL IN EACH CASE.
- 6. ALL SUBSURFACE DRAINAGE IS TO DISCHARGE DIRECTLY TO A DESIGNATED STORMWATER SYSTEM.

EXISTING SERVICES:

- 1. THE CONTRACTOR IS TO INFORM THEMSELVES OF ALL EXISTING SERVICES. ATTEND TO EXISTING SERVICES AS FOLLOWS (a) IF THE SERVICE(S) IS/ARE TO BE CONTINUED, PROTECT, REPAIR, DIRECT OR RELOCATE AS REQUIRED. IF SUCH A SERVICE(S) CROSSES THE LINE OF A
- TRENCH, OR WILL LOSE SUPPORT WHEN THE TRENCH IS EXCAVATED, PROVIDE PERMANENT SUPPORT FOR THE EXISTING SERVICES. (b) IF THE SERVICE IS TO BE ABANDONED, CUT AND SEAL OR DISCONNECT, AND MAKE SAFE.
- 2. THE CONTRACTOR'S PRICE IS TO ALLOW FOR HAND EXCAVATION AND BACKFILL NEAR ALL EXISTING SERVICES OR IN AREAS WHERE THERE MAY BE EXISTING SERVICES.
- THE COST OF DEALING WITH ALL EXISTING SERVICES AS ABOVE, AND THE TIME ASSOCIATED WITH THE WORK, IS TO BE INCLUDED IN THE TENDER.
- 4. THE PRINCIPAL AND THE DESIGN CONSULTANT WILL NOT BE RESPONSIBLE FOR DAMAGES TO EXISTING SERVICES. THE CONTRACTOR IS TO TAKE ALL ACTION NECESSARY TO AVOID DAMAGE TO EXISTING SERVICES.

STANDARDS AND TEST METHODS:

- UNLESS OTHERWISE SPECIFIED IN THE CONTRACT, AND WHERE APPLICABLE, MATERIALS AND WORKMANSHIP SHALL BE IN ACCORDANCE WITH THE RELEVANT STANDARD OF THE STANDARDS ASSOCIATION OF AUSTRALIA.
- 2. A STANDARD APPLICABLE TO THE WORKS SHALL BE THE EDITION LAST PUBLISHED 14 DAYS PRIOR TO THE CLOSING DATE FOR TENDERS UNLESS OTHERWISE SPECIFIED.
- SPECIFICATION SHALL BE APPLICABLE IN THE SAME MANNER AS AUSTRALIAN STANDARDS TO RELEVANT MATERIALS AND WORKMANSHIP.

OVERSEAS STANDARDS AND OTHER STANDARD DOCUMENTS NAMED IN THE

- 4. COPIES OF ANY STANDARDS QUOTED OR REFERRED TO IN THE SPECIFICATION SHALL BE KEPT ON THE SITE IF SO SPECIFIED.
- 5. WHERE NO SUITABLE TEST METHODS ARE AVAILABLE, THOSE OF THE RMS OR PWD (AS APPROPRIATE) SHALL BE USED.

PROVISION FOR TRAFFIC

- 1. THE CONTRACTOR SHALL ENSURE THE SAFE PASSAGE OF VEHICLES AND/OR PEDESTRIANS AROUND THE WORK SITE AT ALL TIMES TO STATUTORY REQUIREMENTS.
- 2. THE CONTROLS FOR VEHICULAR TRAFFIC MUST CONFORM TO THE RMS "TRAFFIC CONTROL AT WORK SITES MANUAL".
- 3. SIGNS OR BARRIERS USED FOR TRAFFIC CONTROL SHALL COMPLY WITH AS1742 "MANUAL OF UNIFORM TRAFFIC CONTROL DEVICES" AND WITH RMS "GUIDELINES TO SIGNS AND MARKINGS MANUAL".
- 4. THE CONTRACTOR IS TO PROVIDE PROPER PROVISION FOR TRAFFIC ON ADJACENT ROADS, AND MAINTAIN EXISTING VEHICULAR ACCESS TO PROPERTIES IN ACCORDANCE WITH THE RELEVANT AUSTRALIAN STANDARD AND STATUTORY REQUIREMENTS.

CONCRETE NOTES

- 1. ALL WORKMANSHIP AND MATERIALS SHALL COMPLY WITH THE CURRENT EDITION OF AS3600.
- CONCRETE STRENGTH SHALL BE AS FOLLOWS U.N.O.

ELEMENT	KERB	CAST-IN-SITU STORMWATER PITS	OTHER
STRENGTH	25MPa	32MPa	32MPa
SLUMP	100mm	100mm	100mm
MAX. AGG. SIZE	20mm	20mm	20mm

CLEAR CONCRETE COVER TO REINFORCEMENT SHALL BE AS FOLLOWS U.N.O.:

ELEMENT	TOP	BOTTOM	SIDE
KERB	N/A	N/A	N/A
CAST IN-SITU STORMWATER PITS	50	60	60
OTHER	50	60	60

- 4. THE SIZES OF THE CONCRETE ELEMENTS DO NOT INCLUDE THICKNESSES OF ANY APPLIED FINISHES.
- 5. ALL CONCRETE SHALL BE COMPACTED ADEQUATELY IN ACCORDANCE WITH AS3600 BY THE USE OF A MECHANICAL VIBRATOR.
- 6. ALL CONCRETE SHALL BE CURED IN ACCORDANCE WITH AS3600.
- REINFORCEMENT SYMBOLS: N - DENOTES GRADE 500 DEFORMED BARS TO AS4671 R - DENOTES GRADE 250 N PLAIN BARS TO AS4671 SL - DENOTES WELDED GRADE 500 REINFORCING FABRIC TO AS4671
- REINFORCEMENT IS REPRESENTED DIAGRAMMATICALLY AND NOT NECESSARILY IN TRUE PROJECTION.
- SPLICES IN REINFORCEMENT SHALL BE MADE ONLY IN POSITIONS SHOWN OR OTHERWISE APPROVED IN WRITING BY THE ENGINEER. LAPS SHALL BE IN ACCORDANCE WITH AS3600 AND NOT LESS THAN THE DEVELOPMENT LENGTH FOR EACH BAR.
- 10. NO ADMIXTURES SHALL BE USED IN CONCRETE UNLESS APPROVED IN WRITING BY THE PRINCIPAL.
- 11. CONSTRUCTION JOINTS WHERE NOT SHOWN SHALL BE LOCATED TO THE APPROVAL OF THE PRINCIPAL.
- 12. THE FINISHED CONCRETE SHALL BE MECHANICALLY VIBRATED TO ACHIEVE A DENSE HOMOGENEOUS MASS, COMPLETELY FILLING THE FORMWORK THOROUGHLY EMBEDDING THE REINFORCEMENT AND FREE OF STONE POCKETS. CONCRETE SHALL BE COMPACTED WITH MECHANICAL VIBRATORS.
- 13. CURING OF ALL CONCRETE IS TO BE ACHIEVED BY KEEPING SURFACES CONTINUOUSLY WET FOR A PERIOD OF THREE DAYS, AND THE PREVENTION OF LOSS OF MOISTURE FOR A TOTAL OF 7 DAYS FOLLOWED BY A GRADUAL DRYING OUT
- REPAIRS TO CONCRETE SHALL NOT BE ATTEMPTED WITHOUT THE PERMISSION OF THE PRINCIPAL.

STORMWATER DRAINAGE NOTES

- STORMWATER DRAINAGE SHALL BE GENERALLY IN ACCORDANCE WITH
- PIPES OF 225mm DIA. AND UNDER SHALL BE uPVC TO AS1254.
- PIPES OF 300mm DIA. AND LARGER SHALL BE CONCRETE CLASS 4 TO AS4058, RUBBER RING JOINTED UNO. 4. PIPES UP TO 150mm DIA. SHALL BE LAID AT A MINIMUM GRADE OF 1.0 %. PIPES
- BEDDING MATERIAL TO AS2032 OR AS3725 AS APPROPRIATE. MINIMUM COVER TO PIPES 300mm DIA. AND OVER GENERALLY SHALL BE 450mm

225mm DIA. AND OVER TO BE LAID AT A MINIMUM GRADE OF 0.5% U.N.O.

- IN CARPARK & ROADWAY AREAS UNO. BACKFILL TRENCHES WITH APPROVED FILL, SUCH AS SANDY LOAM.
- COMPACTED IN 200mm LAYERS TO 98% OF STANDARD DENSITY TO AS1289.5.1.1. 7. ANY PIPES OVER 15% GRADE SHALL HAVE CONCRETE BULKHEADS AT ALL
- 8. PITS SHALL BE OF REINFORCED CONCRETE CONSTRUCTION AS DETAILED U.N.O. METAL GRATES AT LEVELS INDICATED. ALL PITS DEEPER THAN 1200mm
- BUILD INTO UPSTREAM FACE OF ALL PITS A 3.0m SUBSURFACE LINE FALLING TO
- 10. DRAINAGE PITS MAY ONLY BE SUBSTITUTED WITH ALTERNATIVE PRECAST PITS WITH THE PRIOR APPROVAL OF THE PRINCIPAL OR AS INDICATED ON THE

HAULAGE:

DRAWINGS.

TO HAVE CLIMB IRONS.

PITS TO MATCH PIT INVERT.

- ROUTES FOR HAULAGE ROADS SHOULD BE CHOSEN TO MINIMISE THE IMPACT OF CONSTRUCTION WORKS ON EXISTING RESIDENTIAL AREAS.
- 2. THE CONTRACTOR SHALL ENSURE THAT NO SITE MATERIAL IS TRACKED ONTO ANY ADJOINING PUBLIC ROADS. ALL PUBLIC ROADS ARE TO BE KEPT CLEAN AT ALL TIMES.

Drawing Title:

WORK-AS-EXECUTED DRAWINGS:

- 1. THE CONTRACTOR SHALL SUPPLY THE PRINCIPAL WITH FULL MARKED-UP AND CERTIFIED WORK-AS-EXECUTED DRAWINGS FOR THE WHOLE OF THE CONTRACT PRIOR TO THE FINAL CERTIFICATE. PRINTS OR REPRODUCIBLES OF THE CONTRACT DRAWINGS WILL BE SUPPLIED BY THE PRINCIPAL FREE OF CHARGE FOR THIS PURPOSE.
- WORK-AS-EXECUTED DRAWINGS FOR ROADWORKS OR CARPARKS SHALL SHOW IN RED INK, ALL CHANGES TO THE CONTRACT DRAWINGS AND ACTUAL VALUES OF ALL LEVELS SHOWN ON THE DRAWINGS. THE DRAWINGS SHALL BE SIGNED BY A REGISTERED SURVEYOR AND CERTIFIED BY THE CONTRACTOR.
- WORK-AS-EXECUTED DRAWINGS FOR DRAINAGE AND SEWER WORKS WHERE APPLICABLE SHALL SHOW IN RED INK ALL CHANGES TO THE CONTRACT DRAWINGS INCLUDING VARIATIONS TO LEVELS, DIMENSIONS, CONCRETE, REINFORCEMENT AND OTHER MATERIALS. THE DRAWINGS SHALL BE CERTIFIED BY THE CONTRACTOR.

WORKING AREA

- THE PRINCIPAL WILL NOT BE RESPONSIBLE FOR THE SAFE KEEPING OF ANY OF THE CONTRACTOR'S PLANT, EQUIPMENT, TOOLS, MATERIALS OR OTHER PROPERTY. THE CONTRACTOR MAY PROVIDE, AT THEIR OWN COST, ANY SECURITY FENCING CONSIDERED NECESSARY AROUND THE SITE OFFICE, WORKSHOPS OR STORAGE AREAS, SUBJECT TO THE PRINCIPAL'S PRIOR APPROVAL.
- 2. IF EXISTING FENCING IS CUT OR ALTERED BY THE CONTRACTOR, THE CONTRACTOR SHALL PROVIDE AND MAINTAIN TEMPORARY FENCING TO THE SATISFACTION OF THE PRINCIPAL DURING THE CONTRACT TO PREVENT UNAUTHORISED ENTRY INTO THE PROPERTY. AND SHALL REINSTATE THE FENCING AND REMOVE TEMPORARY FENCING ON COMPLETION OF THE WORK.

SYMBOL		DESCRIPTION
<u>—s—</u>	s	EXISTING SEWER LINE
<u>— т —</u>	—т—	EXISTING TELSTRA LINE
— G —	— G—	EXISTING GAS LINE
<u>—</u> Е —	— E —	EXISTING ELECTRICITY LINE
w	w	EXISTING WATER MAIN
<u> </u>	c	EXISTING COMMUNICATIONS LINE
		BOUNDARY LINE
	-SW	EXISTING STORMWATER LINE
		— EASEMENT
	P P	EXISTING POWER POLE
	EX. WM	EXISTING WATER METER
	EX. HYD	EXISTING HYDRANT
	EX. SV	EXISTING STOP VALVE
	Ex.SMH	EXISTING SEWER MANHOLE
		EXISTING SEALED ROAD

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CO-ORDINATED REFERENCE DRAWINGS Issue Date Amendment 31.03.20 ISSUED FOR DA SUBMISSION SERVICE DRAWING NUMBER ISSUE DATE 23.04.2020 REISSUED FOR DA SUBMISSION CV LDG ARCH MECH STRUCT ELEC CIVIL NOTE: SYMBOLS ARE DRAWN IN THE CORRECT POSITION BUT ARE NOT SHOWN TO SCALE

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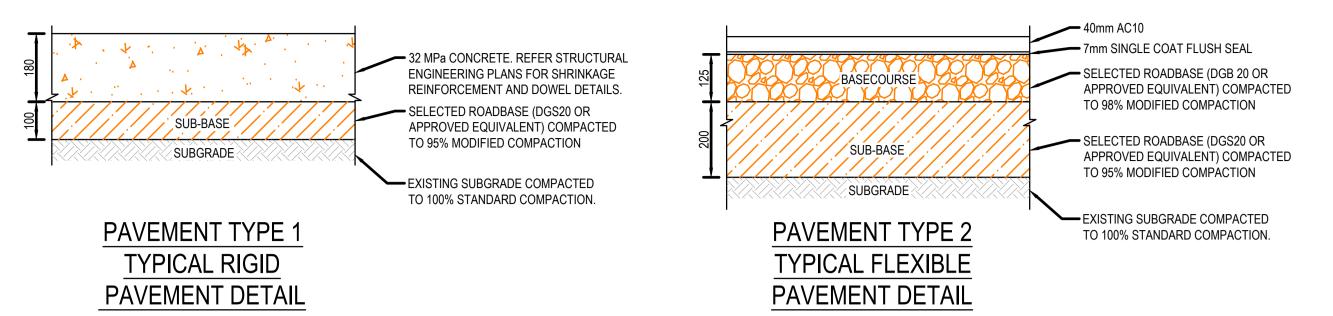
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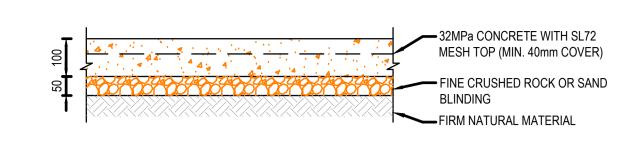
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CIVIL SERVICES NOTES SHEET

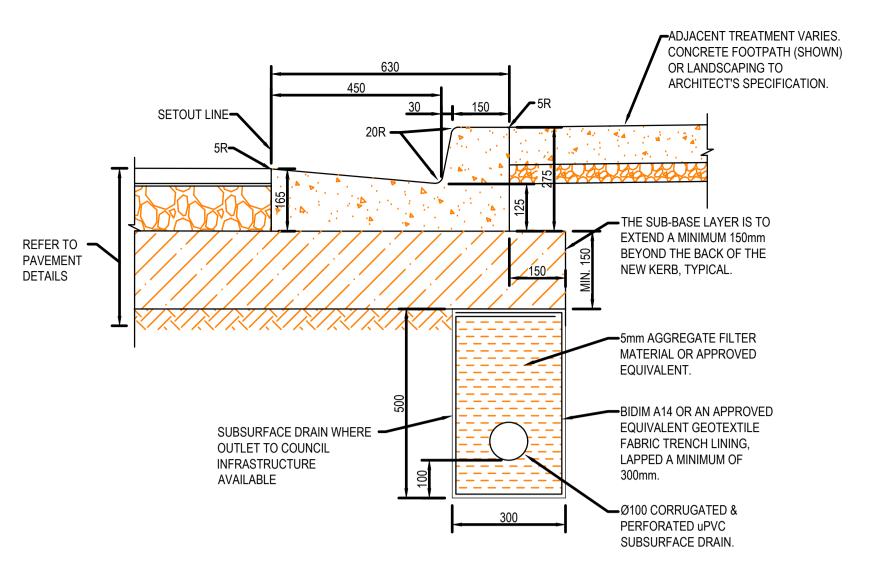
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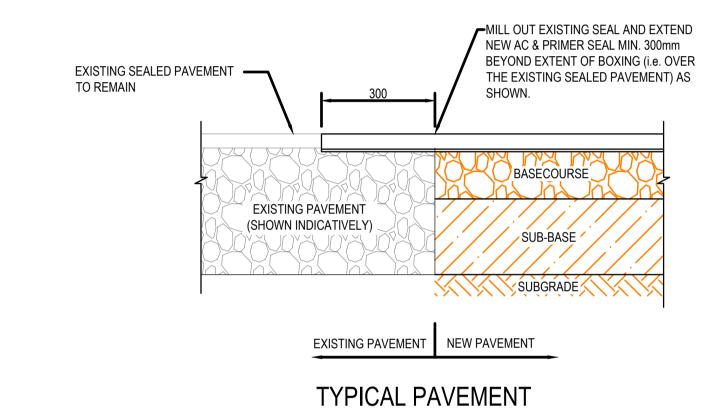




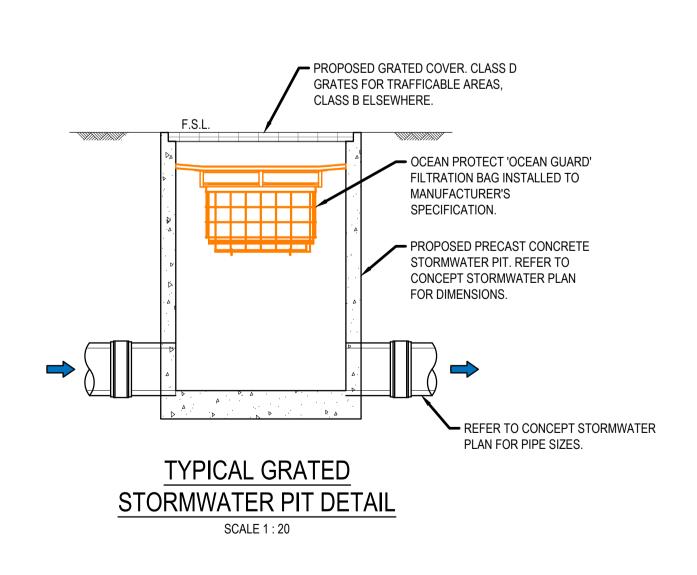
PAVEMENT TYPE 3 TYPICAL CONCRETE FOOTPATH DETAIL SCALE 1:10



TYPICAL KERB AND GUTTER (KG) DETAIL



INTERFACE DETAIL



PAVEMENT DESIGN NOTES:

- FLEXIBLE PAVEMENT DESIGN HAS BEEN BASED ON A CBR OF 3.0% FOR A TRAFFIC LOADING OF 8X10⁴ ESAs
- RIGID PAVEMENT DESIGN HAS BEEN BASED ON A CBR OF 3% FOR A TRAFFIC LOADING OF 1.3X10⁵ HVAG
- FOR RIGID PAVEMENT SHRINKAGE REINFORCEMENT AND DOWEL SPECIFICATIONS, REFER STRUCTURAL ENGINEERS DETAILS. SUBGRADE PREPARATION AND PLACEMENT OF CONTROLLED FILL.
- THE FOLLOWING PROCEDURES ARE TO BE FOLLOWED FOR SUBGRADE PREPARATION AND PLACEMENT OF CONTROLLED FILL: STRIP EXISTING TOPSOIL (IF PRESENT) AND STOCKPILE FOR POSSIBLE FUTURE USE IN LANDSCAPING.
- IN AREAS WHERE GRADE RAISE FILL WILL BE PROVIDED THE EXPOSED MATERIAL AFTER REMOVAL OF TOPSOIL SHALL BE PROOF ROLLED (USING AN 8 TO 10 TONNES ROLLER) TO DETECT POTENTIALLY WEAK SPOTS (GROUND HEAVE). EXCAVATE AREAS OF LOCALISED HEAVING TO DEPTH OF ABOUT 300MM AND REPLACE WITH GRANULAR MATERIAL OR LOW PLASTICITY CLAY AND COMPACT AS RECOMMENDED BELOW.
- REPEAT PROOF ROLLING OF SOFT SPOTS BACKFILLED WITH GRANULAR MATERIAL OR LOW PLASTICITY CLAY. IF THE BACKFILLED AREA SHOWS MOVEMENT DURING PROOF ROLLING, THIS OFFICE SHOULD BE CONTACTED FOR FURTHER RECOMMENDATIONS.
- PLACE SUITABLE FILL MATERIALS ON PROOF ROLLED SURFACE IN HORIZONTAL LAYERS OF 250MM TO 300MM LOOSE THICKNESS (DEPENDING ON THE SIZE OF EQUIPMENT) AND COMPACT TO ACHIEVE A MINIMUM DENSITY RATIO OF AT LEAST 98% STANDARD, AT MOISTURE CONTENT WITHIN 2% OF OPTIMUM MOISTURE CONTENT (OMC). SUITABLE FILL MATERIALS MAY COMPRISE GRANULAR OR LOW PLASTICITY CLAY. THE TOP 300MM OF THE FILL FORMING PAVEMENT SUBGRADE SHALL BE COMPACTED TO A MINIMUM DENSITY RATIO OF AT LEAST 100%STANDARD, AT MOISTURE CONTENT WITHIN 2% OF OPTIMUM MOISTURE CONTENT (OMC).
- IN CUT AREAS THE TOP 300MM OF THE PAVEMENT SUBGRADE SHALL BE SCARIFIED AND COMPACTED TO A MINIMUM DENSITY RATIO OF AT LEAST 100% STANDARD, AT MOISTURE CONTENT WITHIN 2% OF OPTIMUM MOISTURE CONTENT (OMC).
- FILL PLACEMENT SHOULD BE SUPERVISED TO ENSURE THAT MATERIAL QUALITY, LAYER THICKNESS, TESTING FREQUENCY AND COMPACTION CRITERIA CONFORM TO THE SPECIFICATIONS. WE RECOMMEND "LEVEL 1" SUPERVISION, IN ACCORDANCE WITH AS3798-2007.

PENRITH PUB PAVEMENT DESIGN

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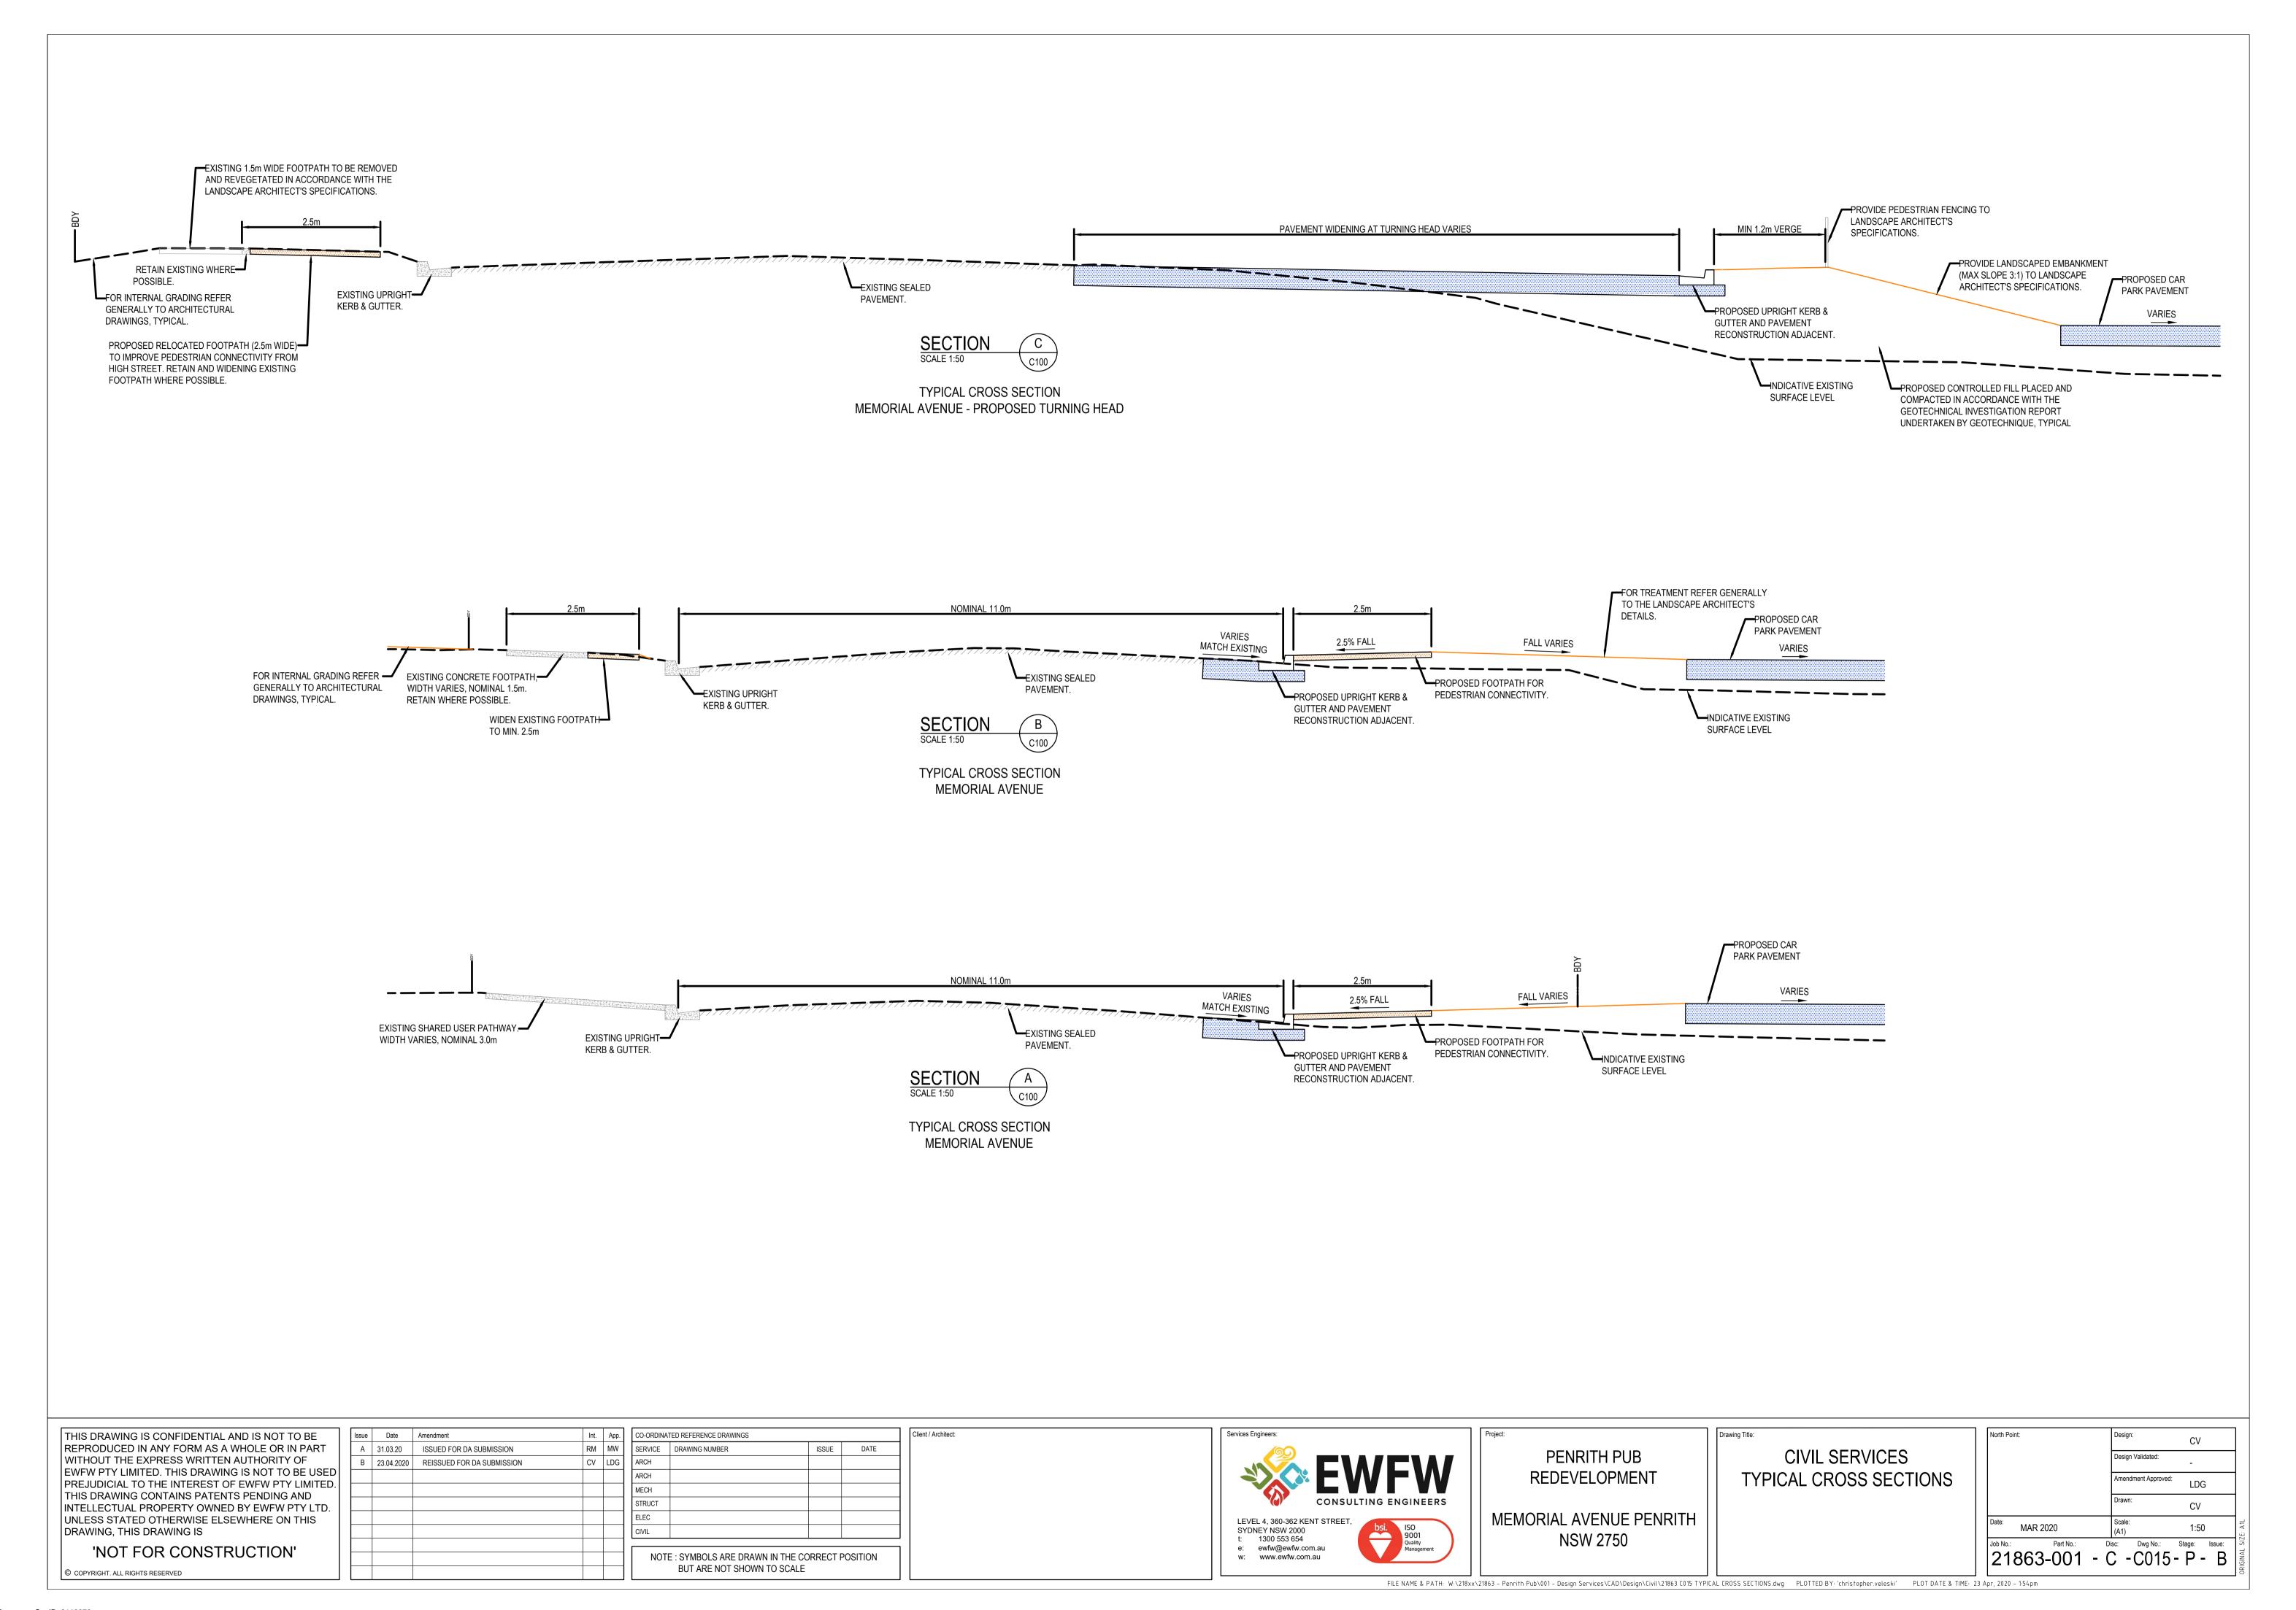
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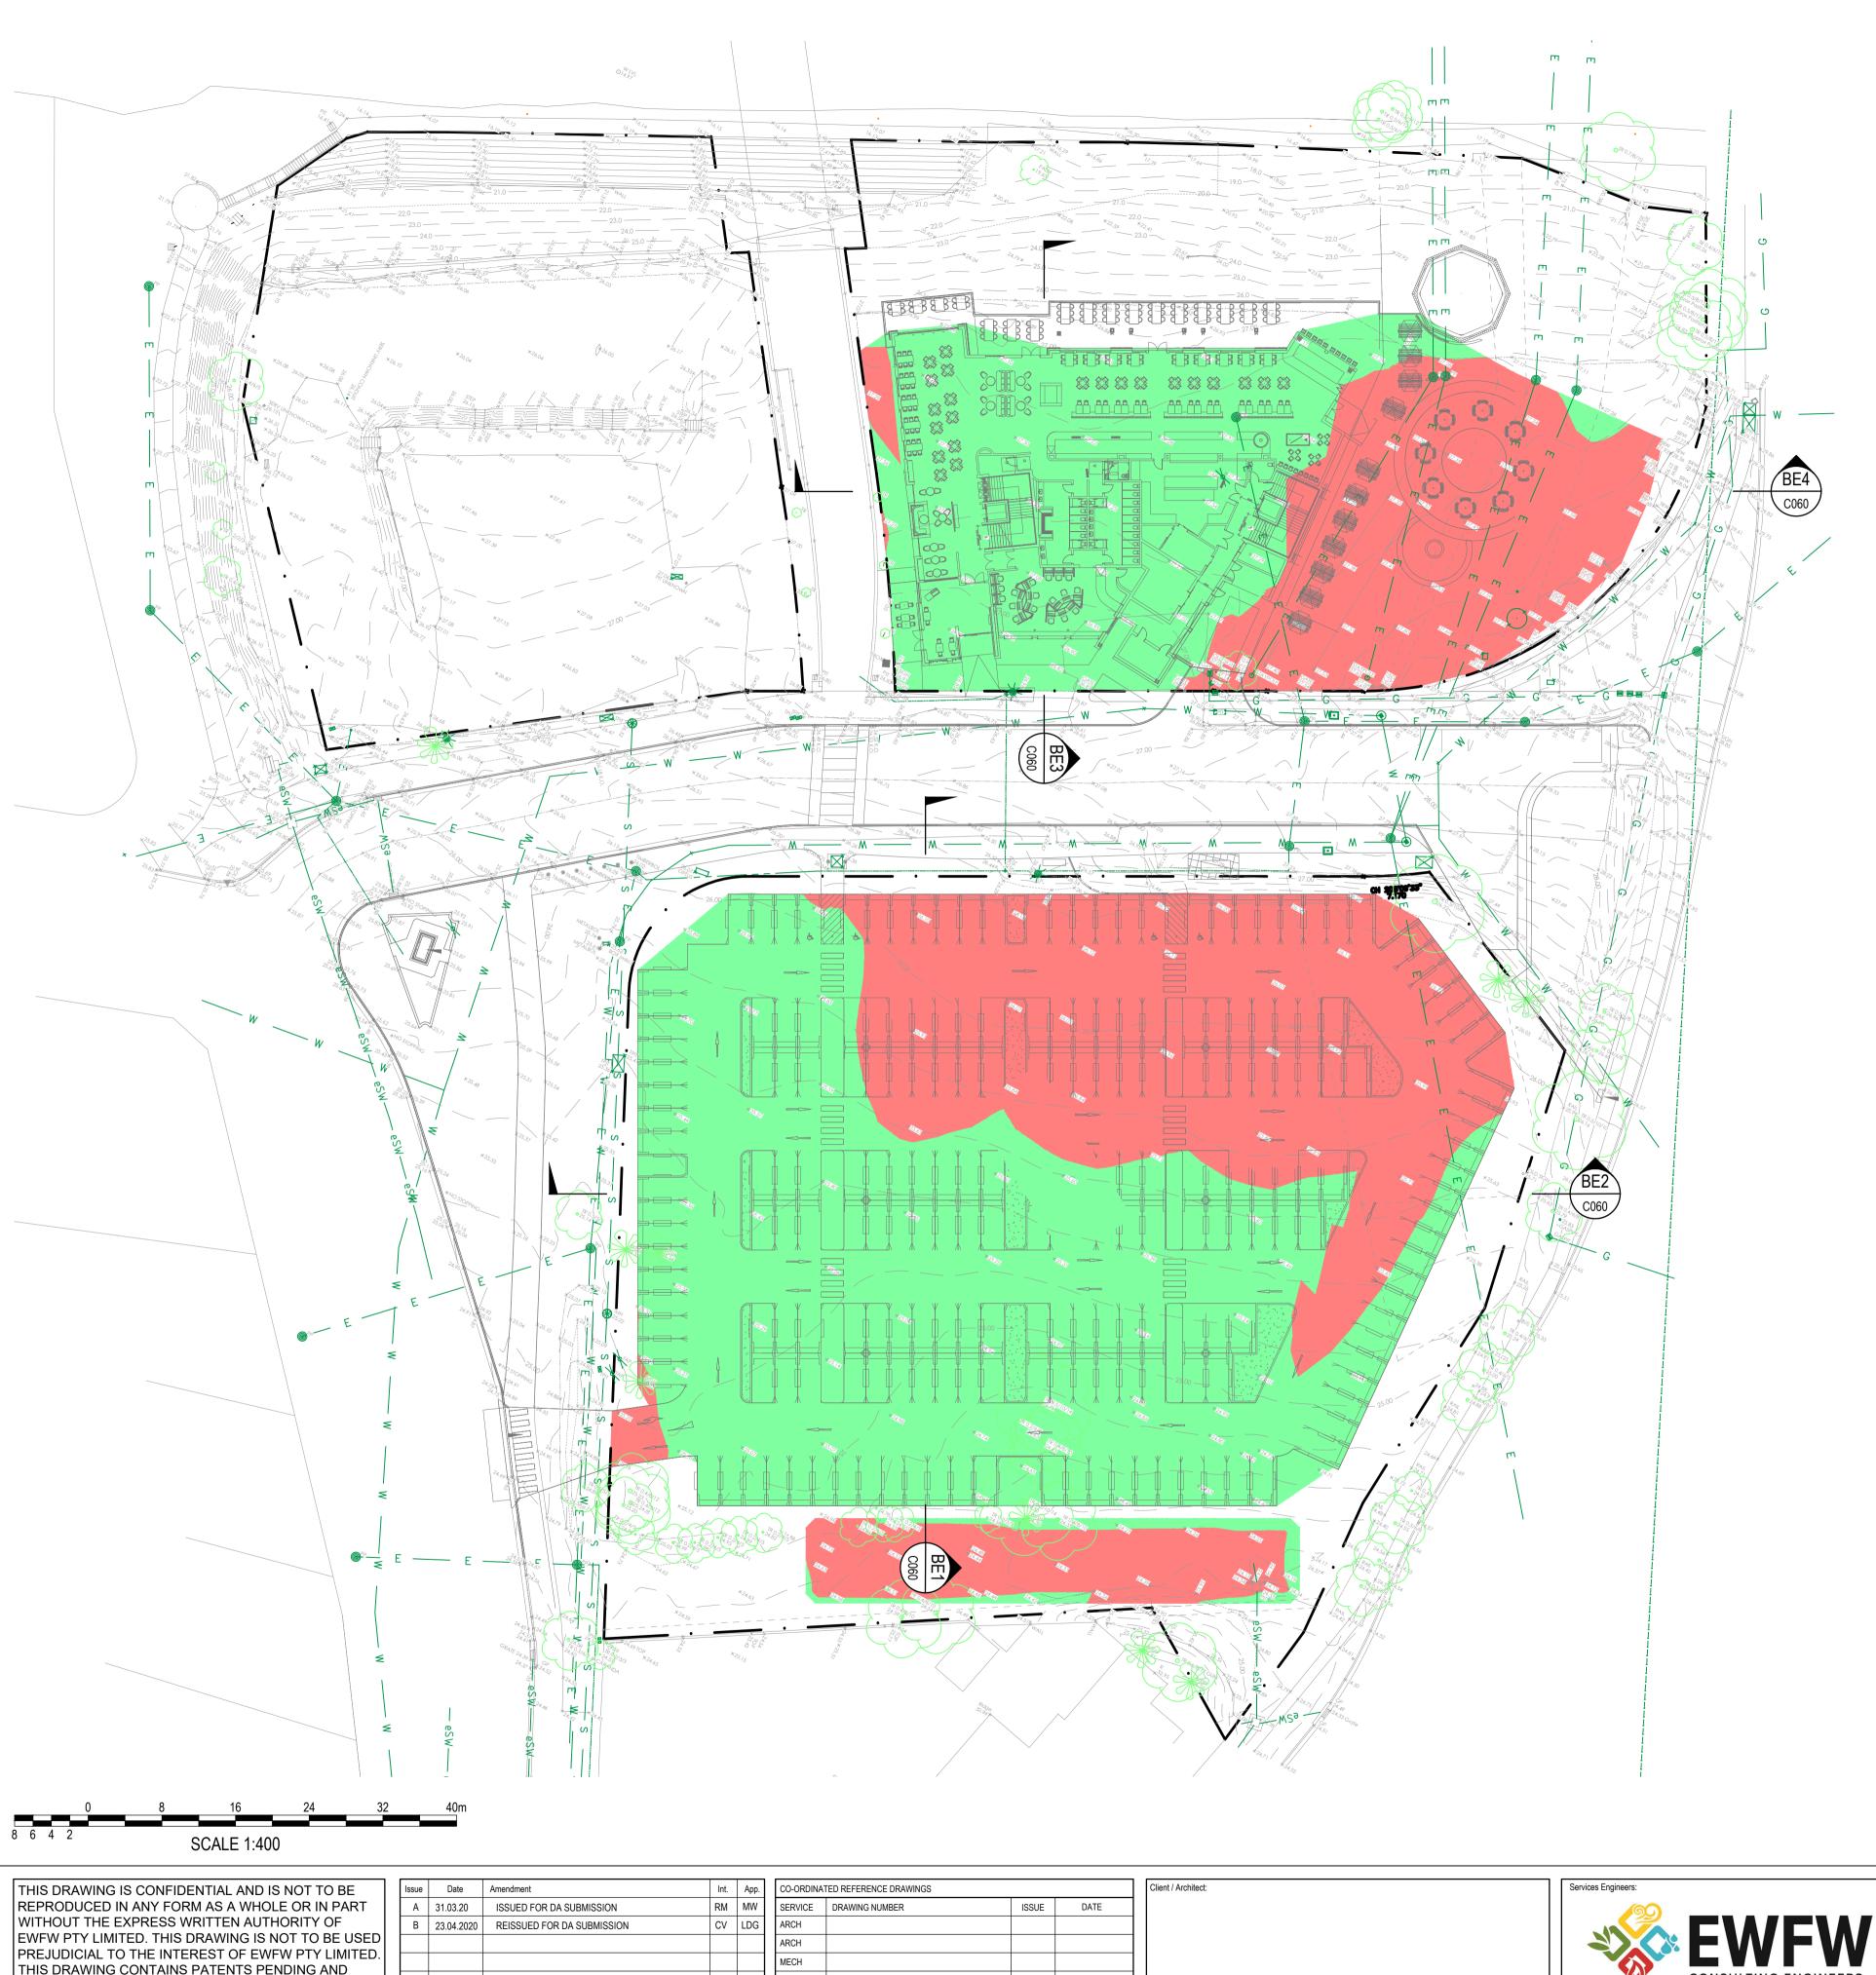
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CIVIL SERVICES TYPICAL DETAILS SHEET	

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North Point:	Design:	CV	
	Design Validated:	-	
	Amendment Approved:	LDG	
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Job No.: Part No.: Di 21863-001 - C			eiginal siz

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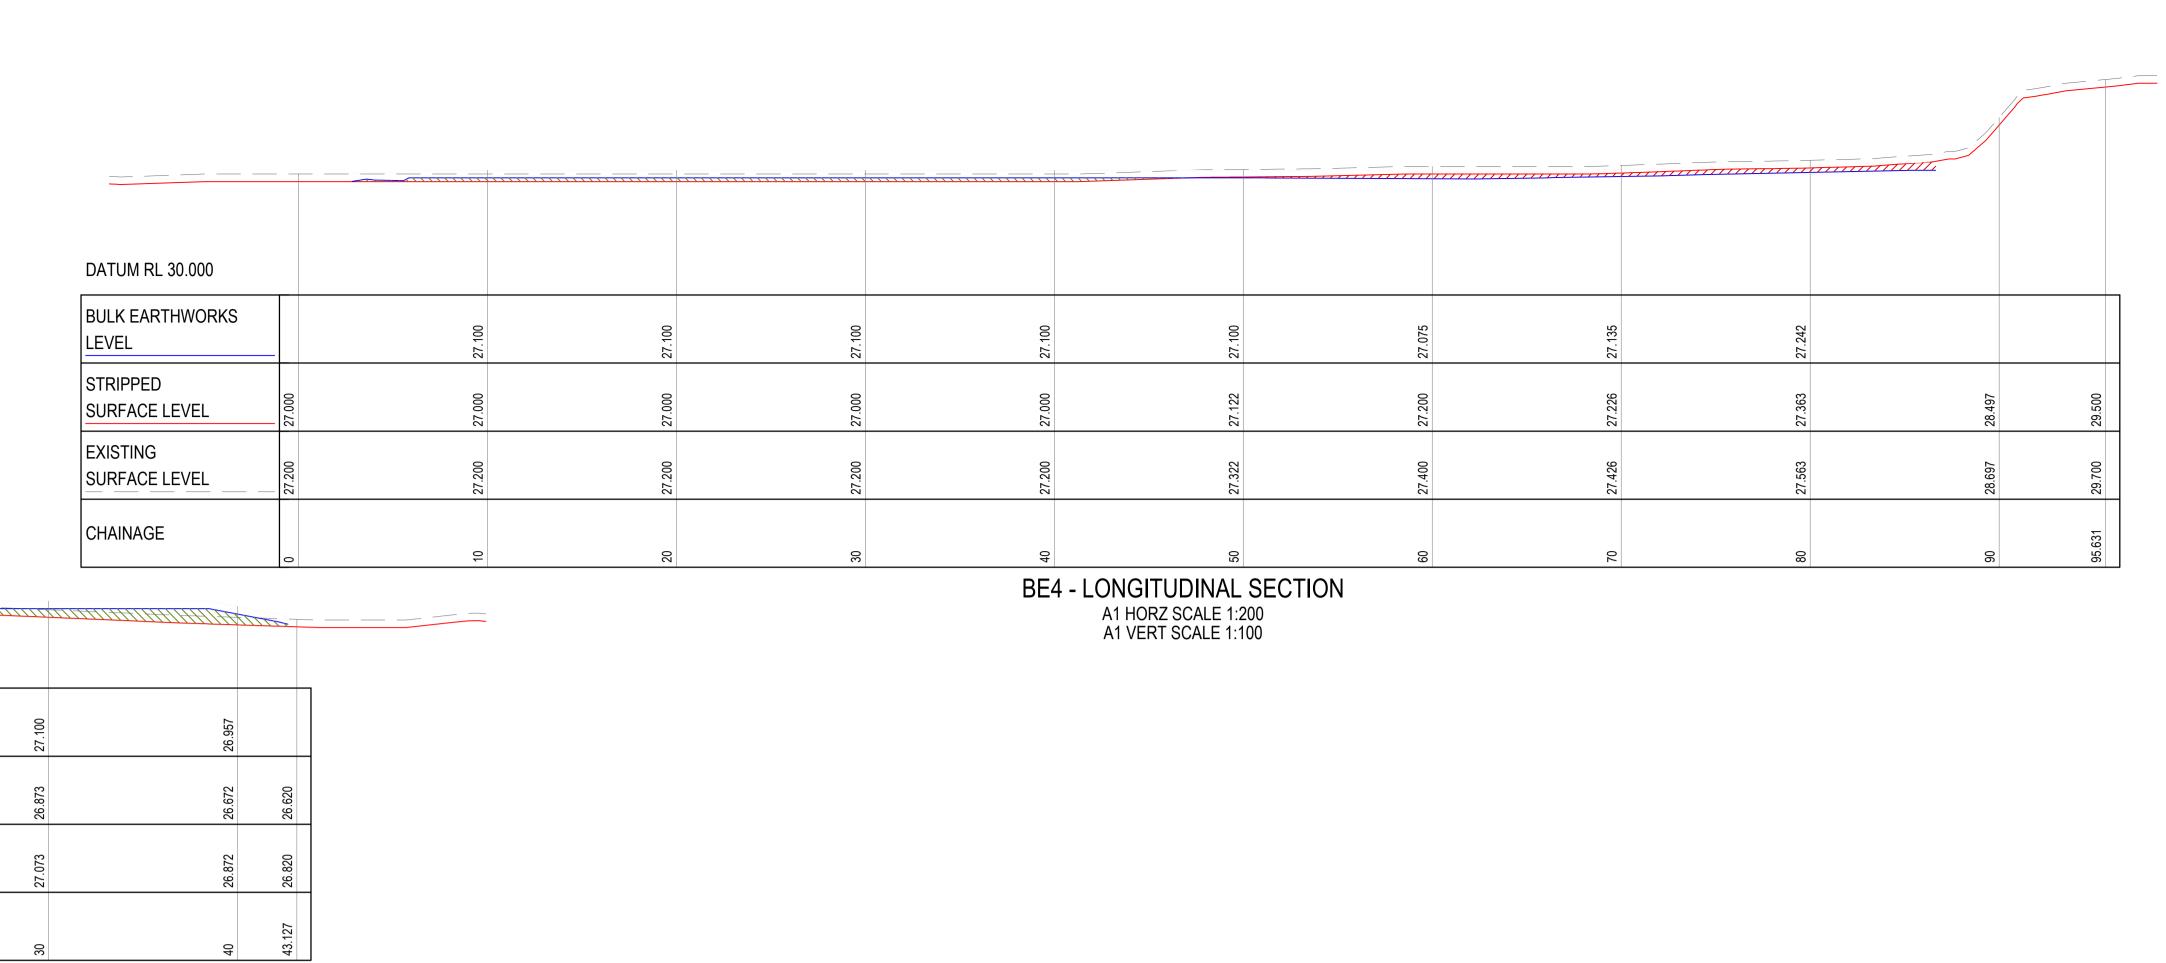
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CIVIL SERVICES BULK EARTHWORKS PLAN

Drawing Title:

FILE NAME & PATH: W:\218xx\21863 - Penrith Pub\001 - Design Services\CAD\Design\Civil\21863 C050 BULK EARTHWORKS PLAN.dwg PLOTTED BY: 'christopher.veleski' PLOT DATE & TIME: 23 Apr., 2020 - 6:28pm

North Point:	Design:	CV
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BE3 - LONGITUDINAL SECTION
A1 HORZ SCALE 1:200
A1 VERT SCALE 1:100

DATUM RL 20.000 BULK EARTHWORKS 25 25 25 25 25 STRIPPED 25.450 25.462 SURFACE LEVEL EXISTING 25.650 25.662 SURFACE LEVEL 100 100.508 CHAINAGE BE2 - LONGITUDINAL SECTION

A1 HORZ SCALE 1:200 A1 VERT SCALE 1:100

BE1 - LONGITUDINAL SECTION
A1 HORZ SCALE 1:200
A1 VERT SCALE 1:100

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DATUM RL 25.000

LEVEL

STRIPPED

EXISTING

CHAINAGE

SURFACE LEVEL

SURFACE LEVEL

BULK EARTHWORKS

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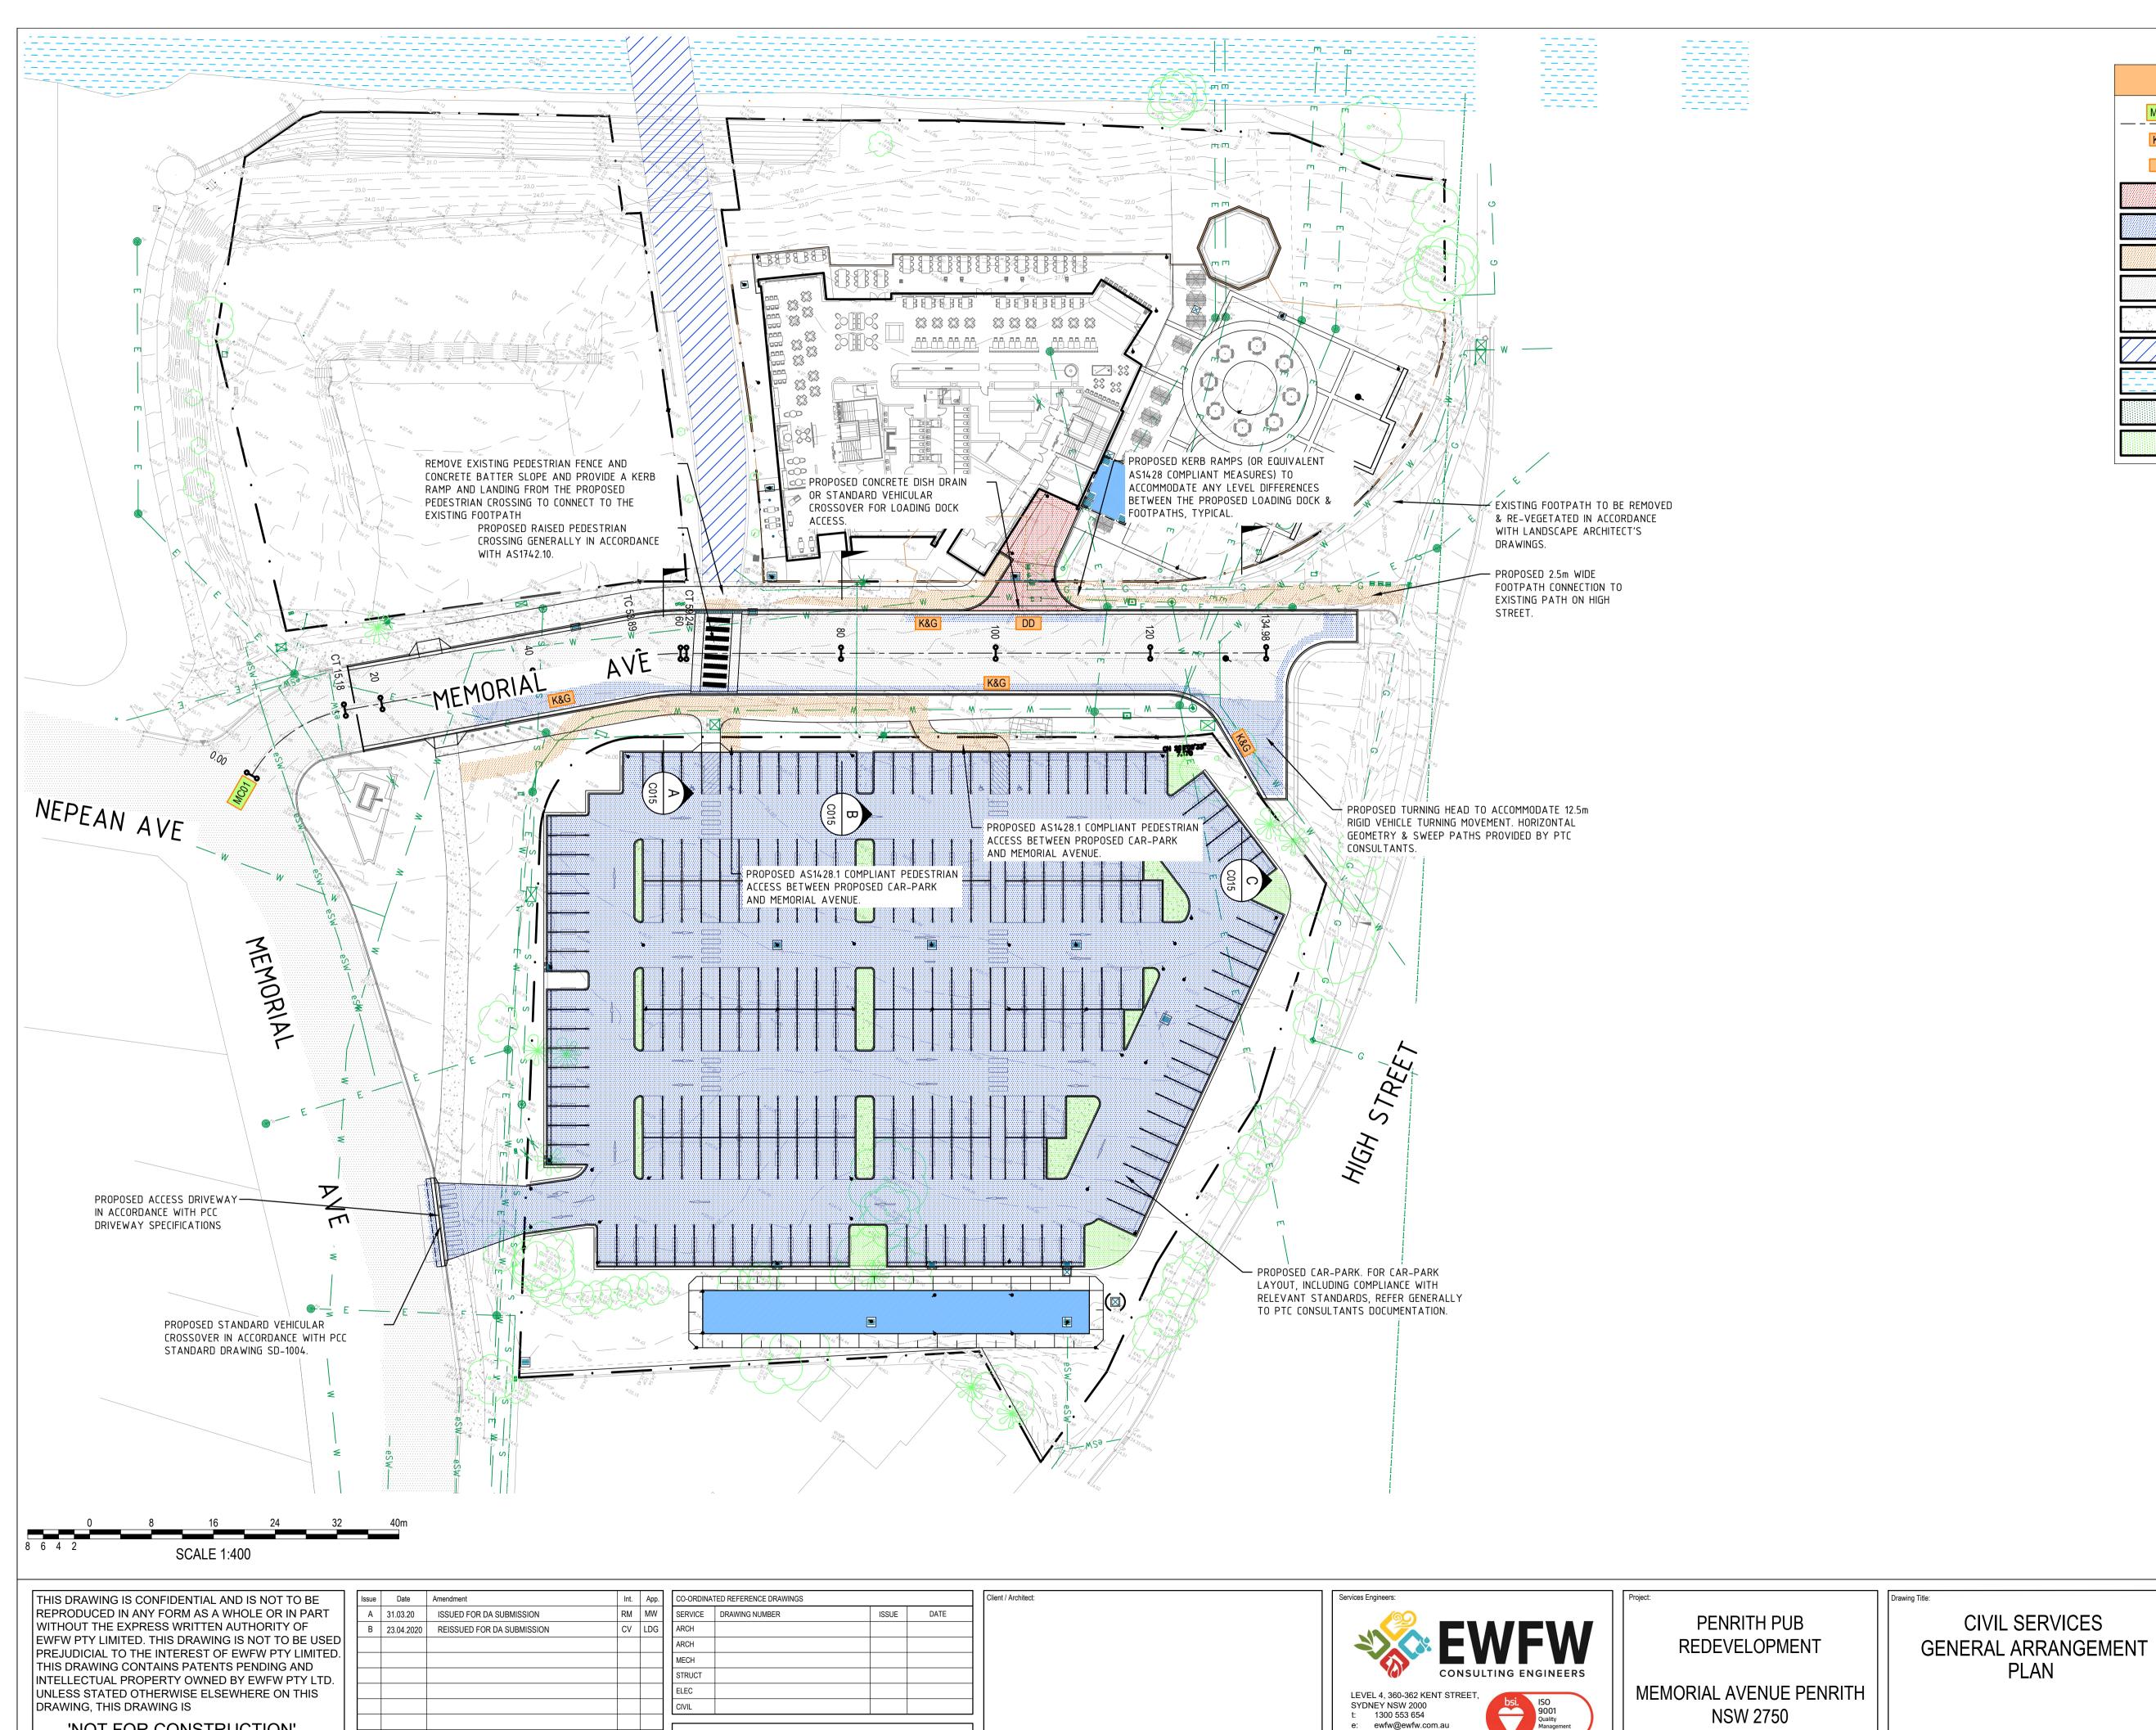


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MEMORIAL AVENUE PENRITH NSW 2750 CIVIL SERVICES
BULK EARTHWORKS
TYPICAL CROSS SECTIONS

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GENERAL LEGEND

PROPOSED KERB AND GUTTER

PROPOSED DISH DRAIN

PAVEMENT TYPE 3 -

EXISTING SEALED ROAD

EXISTING CONCRETE

EXISTING FOOTBRIDGE

PROPOSED DEVELOPMENT

PROPOSED LANDSCAPING (BY OTHERS)

NEPEAN RIVER

F00TPATH

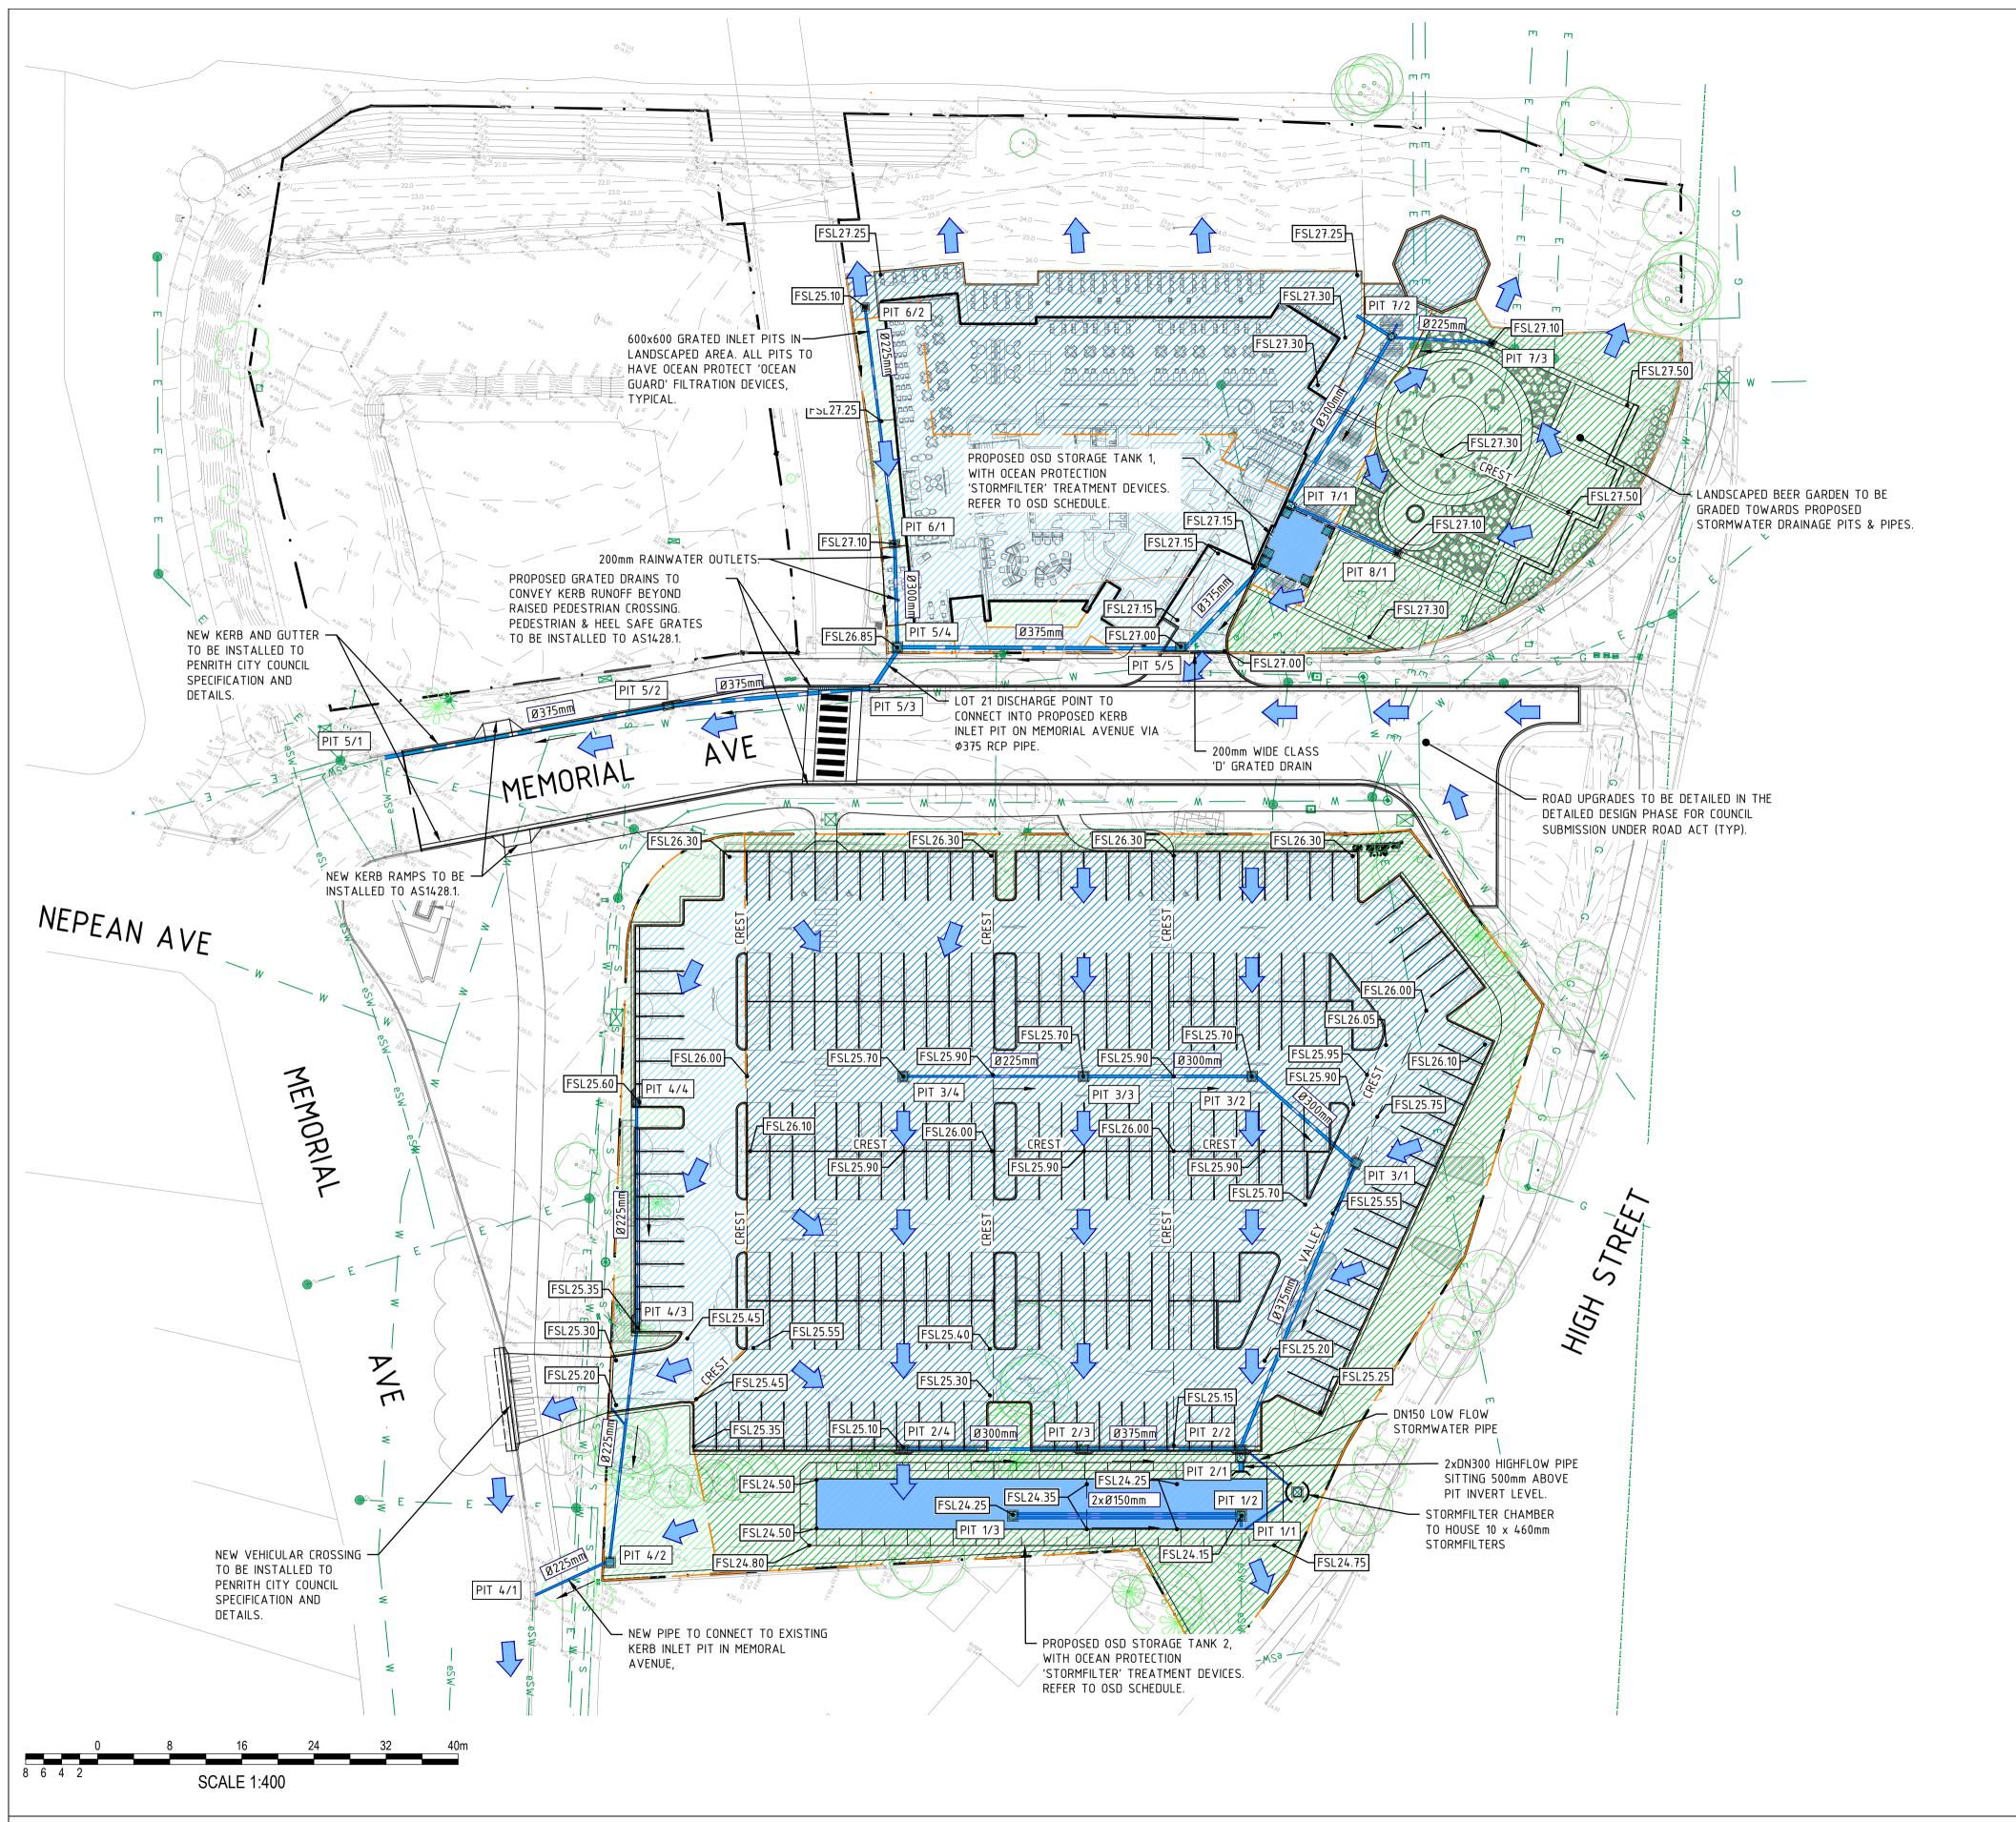
PAVEMENT TYPE 1 - RIGID

PAVEMENT TYPE 2 - FLEXIBLE

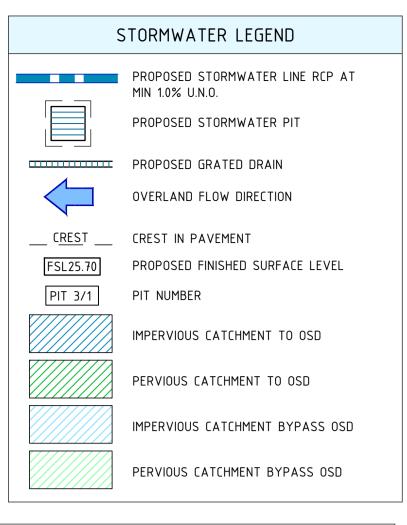
CONTROL LINE

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Client / Architect:



	OSD SCHEDULE										
OSD LABEL	CATCHMENT AREA (ha)	STORAGE (m³)	DETAILS	ORIFICE DETAILS	OVERFLOW WEIR						
OSD1	0.2307	27	6.8m x 5.8m CAST-IN-SITU H.E.D WEIR 26.25	Ø136mm CL25.85 ORIFICE ON Ø300mm OUTLET PIPE	VIA INTERNAL OVERFLOW WEIR RL 26.65						
OSD2	0.6457	144	50m x 5.6m BASIN TWL24.75	Ø151mm CL23.85 ORIFICE ON Ø225 OUTLET PIPE	VIA LANSCAPE AREA ON HIGH STREET						

	CATCHMENT AREA SUMMARY							
CAT	TOTAL CATCHMENT AREA (ha)	IMPERVIOUS %	PERVIOUS %					
LOT 21 TO OSD	0.2307	53	47					
LOT 21 BYPASS	0.1102	88	12					
LOT 22 TO OSD	0.6457	75	25					
LOT 22 BYPASS	0.1036	65	35					

5.7		CHEDULE		
PIT NO.	TYPE	SIZE	GRATE RL	
1/1	EXISTING INLET PIT	-	e24.20	e23.70
1/2	DISCHARGE CONTROL PIT	900x900	24.15	23.70
1/3	GRATED INLET PIT	900×900	24.25	23.85
2/1	HEADWALL W/ SCOUR	TO SUIT 2x Φ300	-	24.20
2/2	KERB INLET/DIVERSION PIT	1.8m LINTEL	25.00	23.95
2/3	KERB INLET PIT	1.8m LINTEL	25.05	24.10
2/4	KERB INLET PIT	1.8m LINTEL	25.10	24.30
3/1	GRATED INLET PIT	900×900	25.65	24.30
3/2	GRATED INLET PIT	900x900	25.70	24.45
3/3	GRATED INLET PIT	900x900	25.70	24.60
3/4	GRATED INLET PIT	900x900	25.70	24.80
4/1	EXISTING INLET PIT	-	e24.20	e23.50
4/2	GRATED INLET PIT	600x900	24.50	23.80
4/3	KERB INLET PIT	1.8m LINTEL	25.35	24.30
4/4	KERB INLET PIT	1.8m LINTEL	25.60	25.60
5/1	EXISTING KERB INLET PIT	-	25.69	24.48
5/2	KERB INLET PIT	1.8m LINTEL	26.35	24.80
5/3	KERB INLET PIT	1.8m LINTEL	26.55	25.05
5/4	GRATED INLET PIT	600x900	26.85	25.15
5/5	GRATED INLET PIT	900x900	27.00	25.50
6/1	GRATED INLET PIT	600x600	27.10	26.40
6/2	GRATED INLET PIT	600x900	27.10	26.10
7/1	JUNCTION PIT	600×900	27.25	26.05
7/2	GRATED INLET PIT	600x600	27.25	26.35
7/3	GRATED INLET PIT	600×600	27.10	26.45
8/1	GRATED INLET PIT	600×600	27.10	26.35

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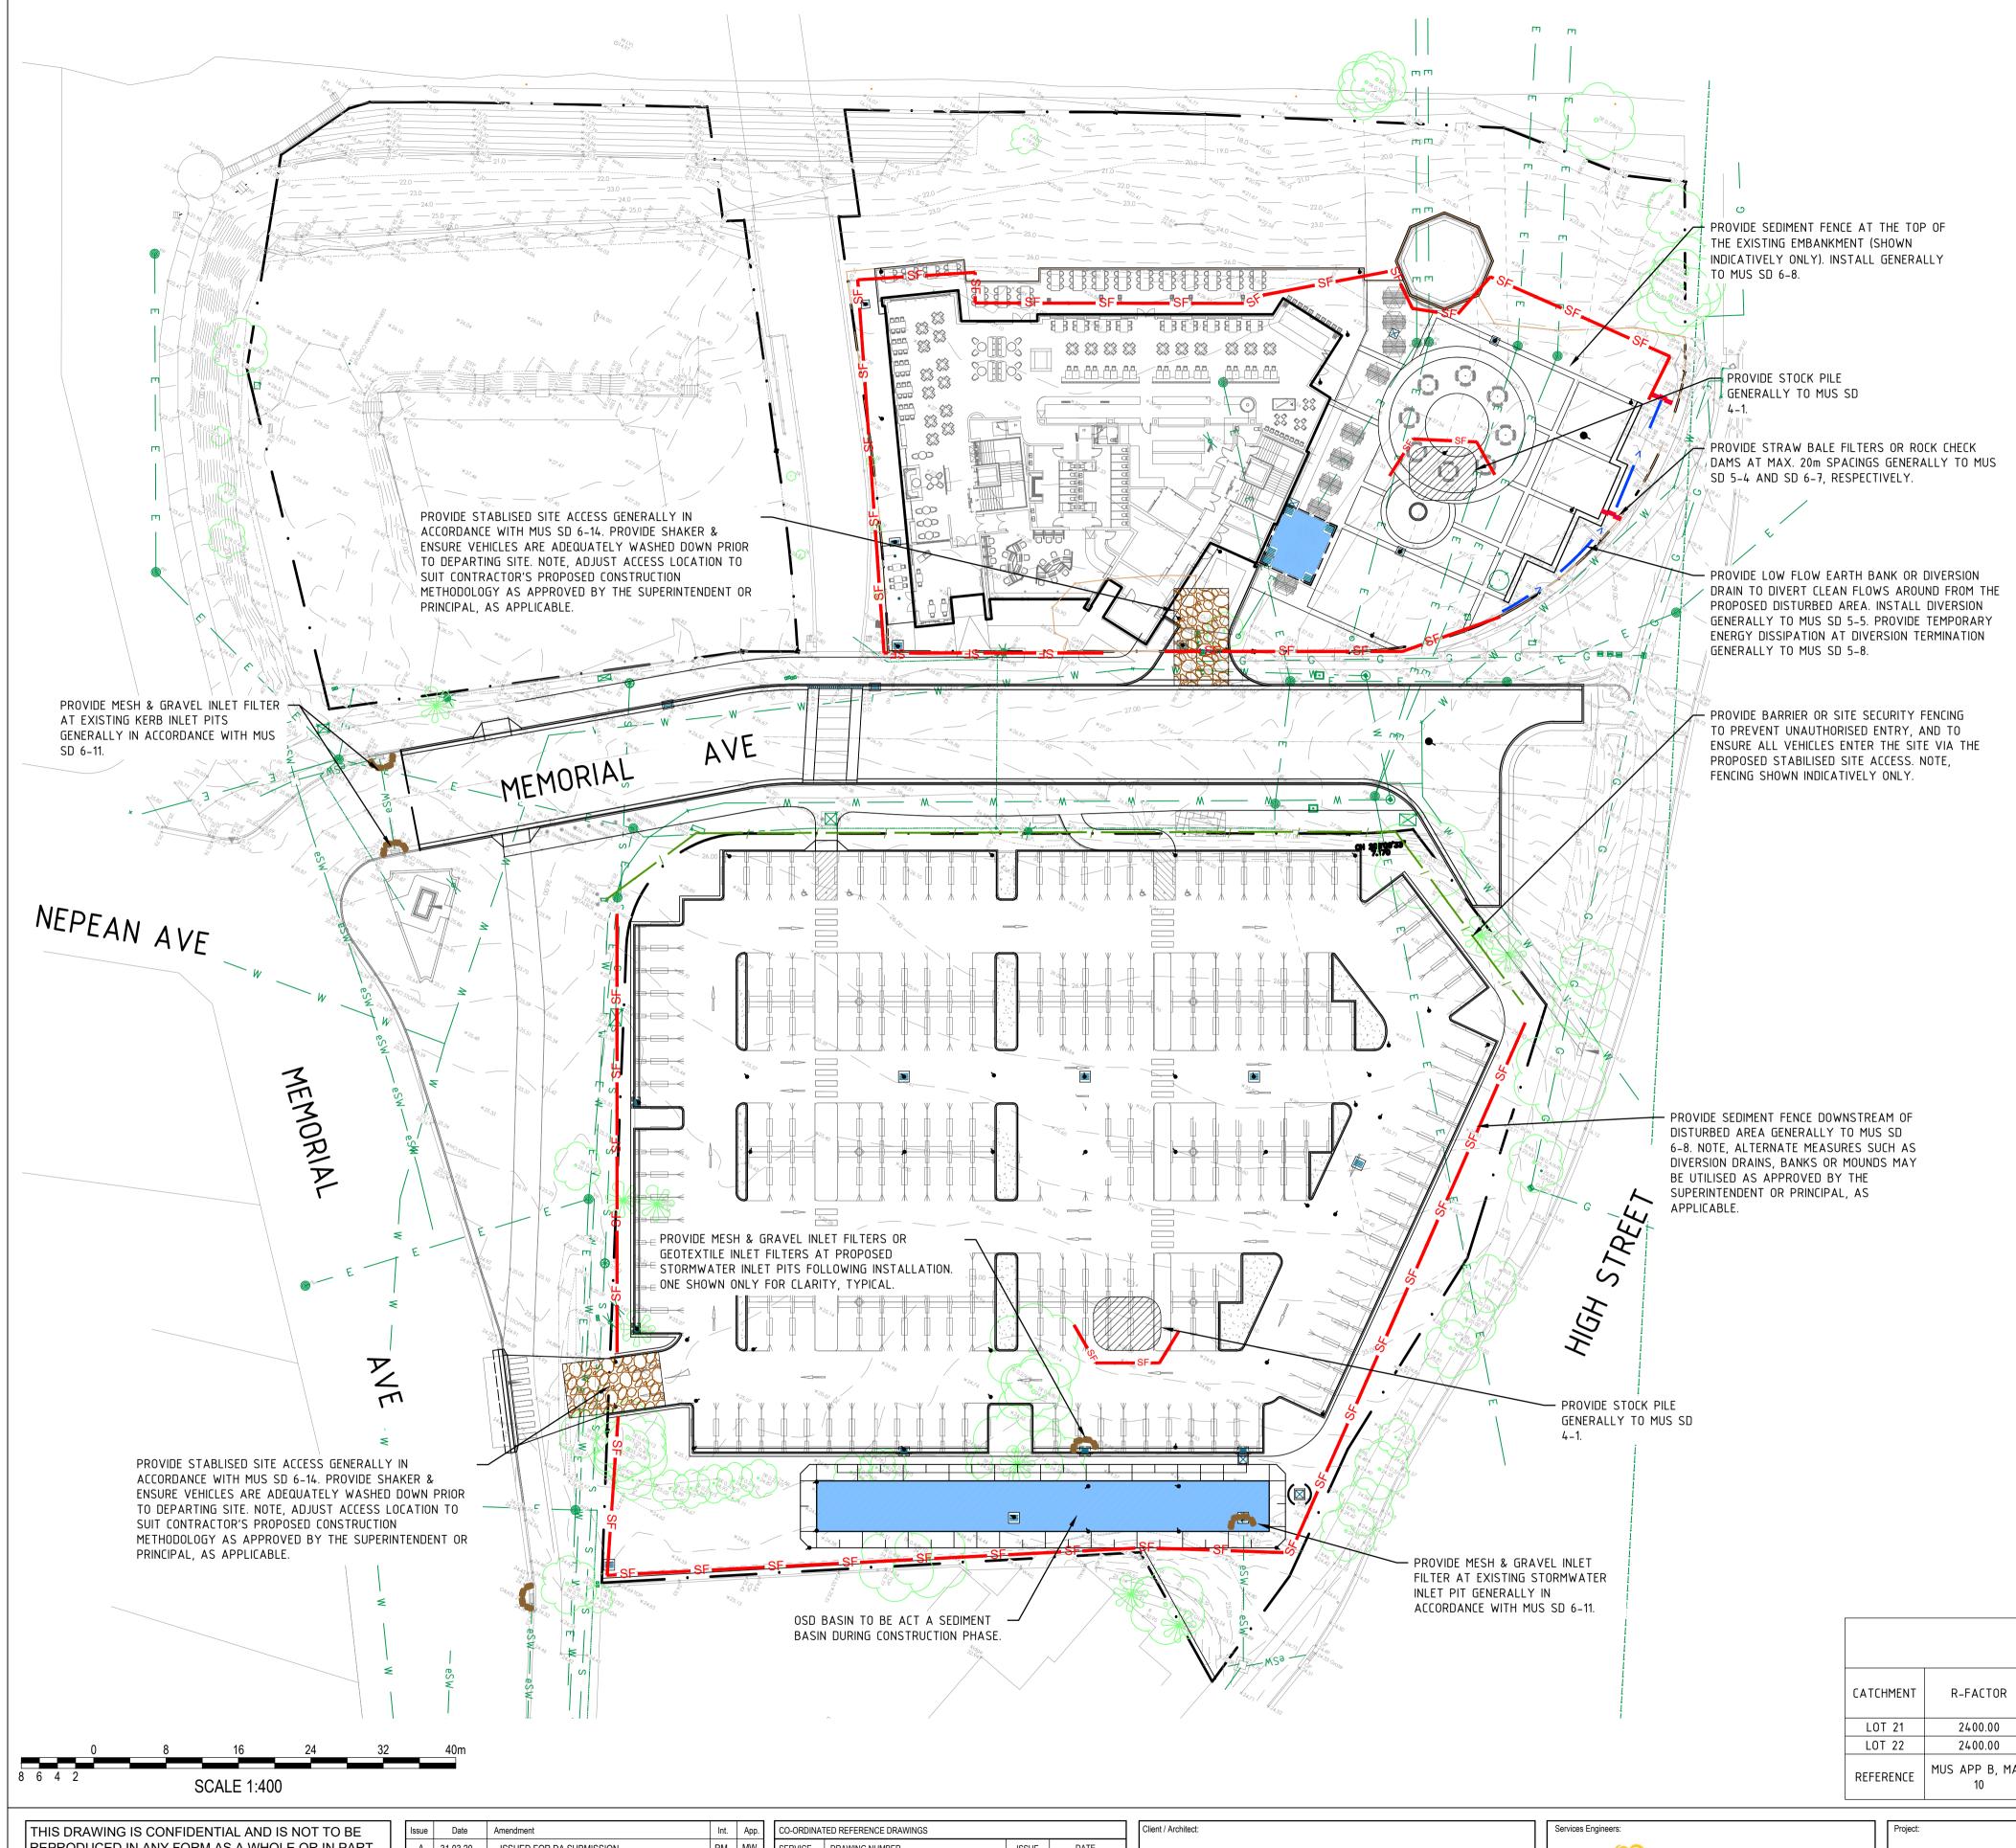
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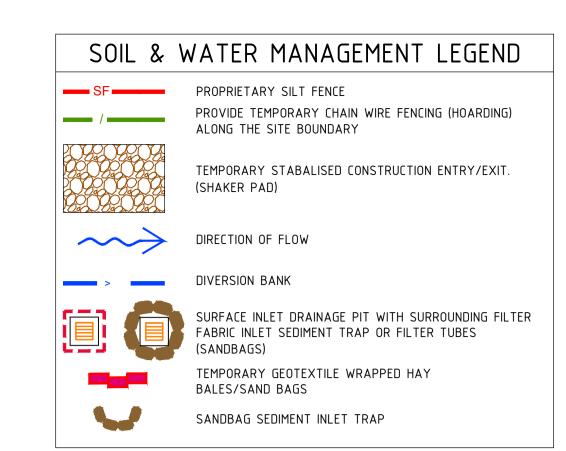
MEMORIAL AVENUE PENRITH NSW 2750 CIVIL SERVICES STORMWATER LAYOUT PLAN

North Point:	Design:	CV
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Job No.: Part N	: Disc: Dwg No.:	Stage: Issue:

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SOIL& WATER MANAGEMENT NOTES

- 1. RUSLE: A = SOIL LOSS (tonne/ha/yr) = R.K.Ls.P.C
- THE AVERAGE ANNUAL SOIL LOSS CALCULATIONS WERE UNDERTAKEN
 USING MUS MANAGING URBAN STORMWATER VOL. 1 (LANDCOM, 2004).
 MUS REQUIRES THE CONSTRUCTION OF A SEDIMENT BASIN IF THE ANNUAL

SOIL LOSS IS GREATER THAN 150m³. AS THIS IS NOT THE CASE FOR EACH

THE PRINCIPAL FOR REVIEW AND APPROVAL PRIOR TO COMMENCING WORK.

CONSIDERED UNNECESSARY.

4. THE DISTURBED AREA SHALL BE REHABILITATED & STABILISED PRIOR TO DISTURBING THE NEXT SUB-CATCHMENT AREA. THE CONTRACTOR SHALL SUBMIT THE PROPOSED EARTHWORKS CONSTRUCTION METHODOLOGY TO

ASSUMED CATCHMENT, THE CONSTRUCTION OF A SEDIMENT BASIN IS

RUSLE CALCULATIONS SOIL LOSS PER SOIL LOSS, A K-FACTOR | SLOPE (%) | DISTANCE (m' SLOPE CATCHMENT SOIL LOSS, A Ls FACTOR | P-FACTOR | C-FACTOR CATCHMENT (m³/ha/yr) AREA (ha) (tonne/ha/yr) (m³/yr) 0.06 3.00 40.00 0.47 1.30 1.00 0.35 30.28 23.29 8.15 0.06 3.00 80.00 0.66 1.30 1.00 0.65 78.97 60.75 39.49 MUS APP C MUS APP B, MAP MUS, APP MUS, APP | MUS, APP CONVERSION T19 RICHMOND | SURVEY SURVEY RUSLE EQUATION SURVEY 1.3t/m³

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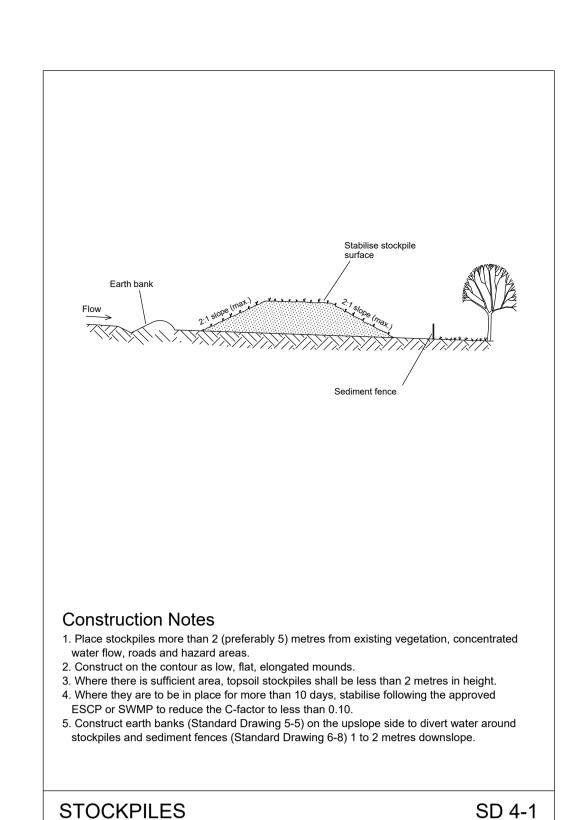
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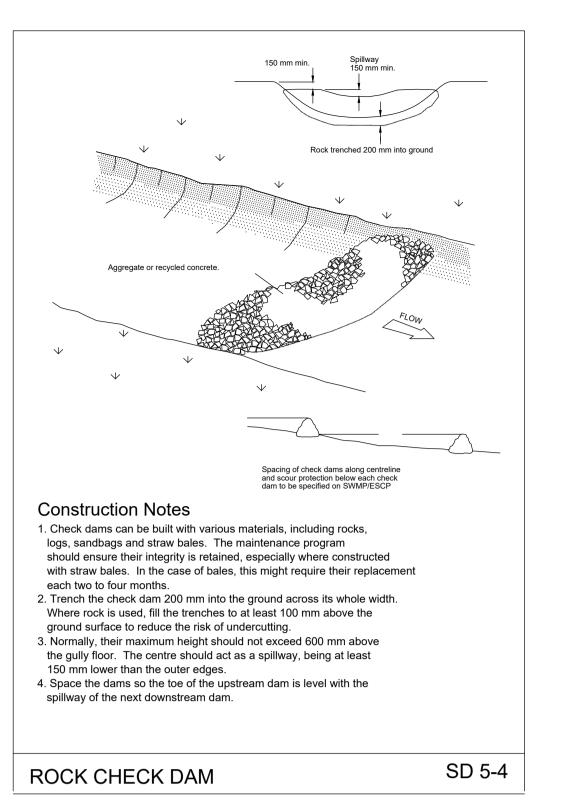
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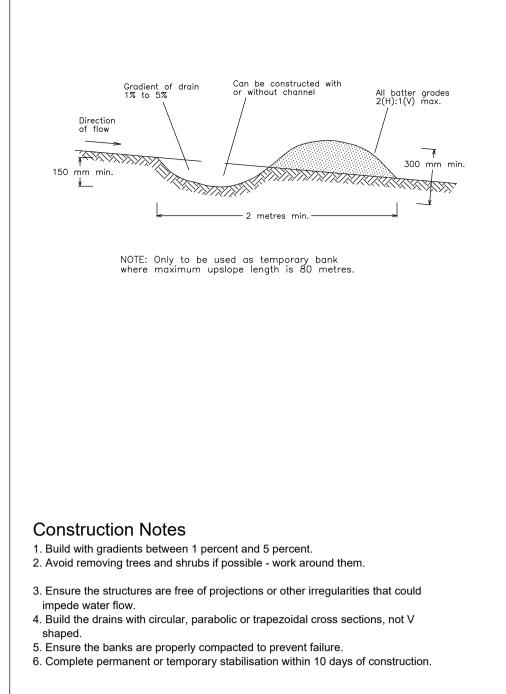
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	Amendment Approved	: LDG	
	Drawn:	CV	
Date: MAR 2020	Scale: (A1)	1.400	
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FILE NAME & PATH: W:\218xx\21863 - Penrith Pub\001 - Design Services\CAD\Design\Civil\21863 CE01 SOIL & WATER MANAGEMENT PLAN.dwg PLOTTED BY: 'christopher.veleski' PLOT DATE & TIME: 23 Apr., 2020 - 2:36pm

Drawing Title:

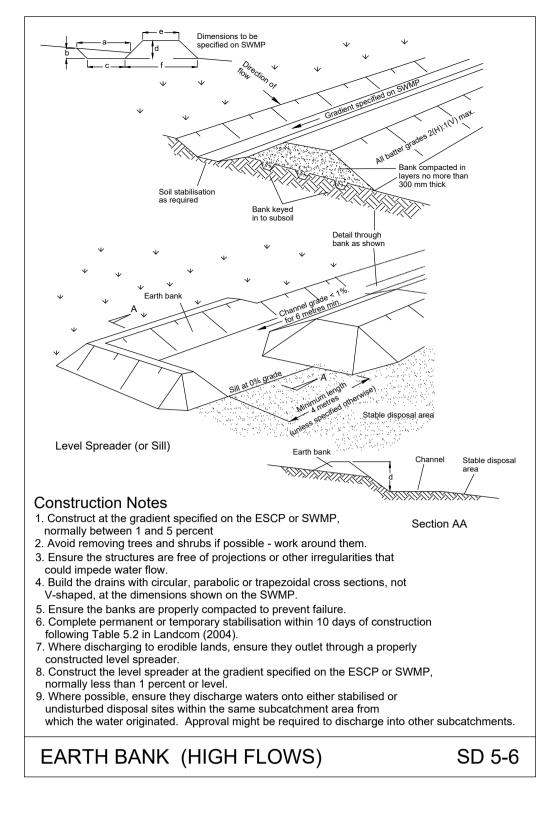


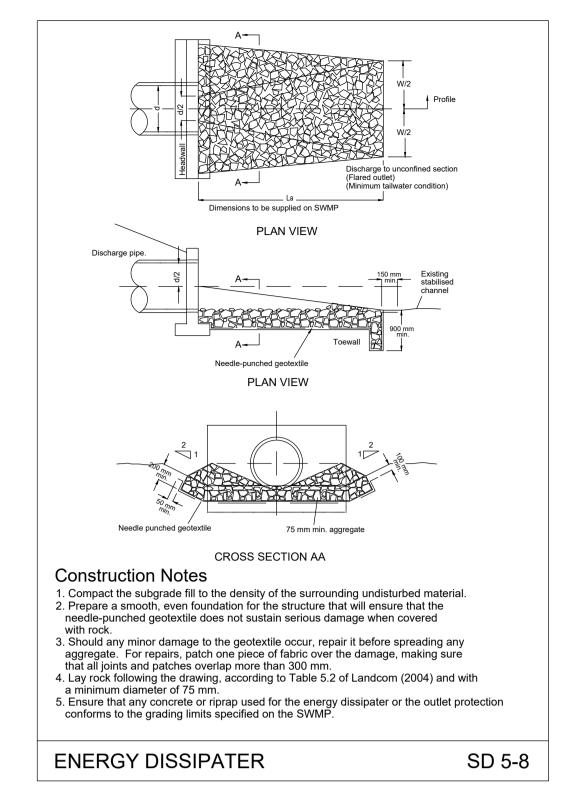


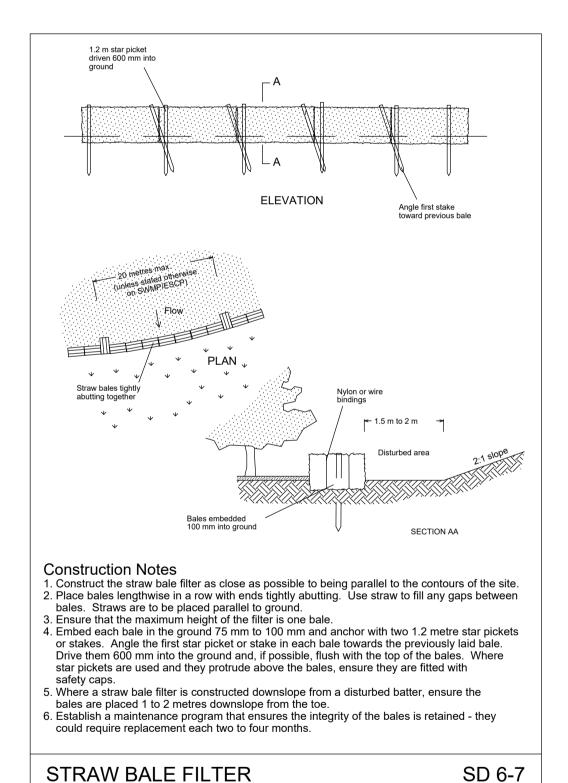


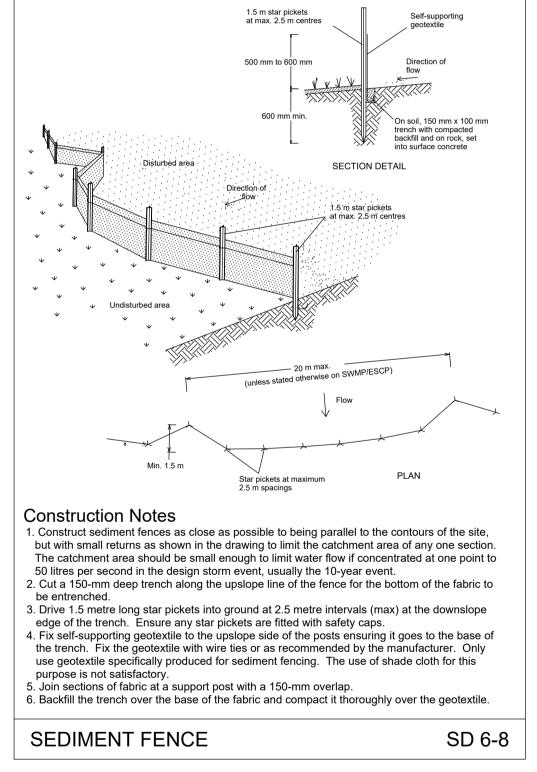
EARTH BANK (LOW FLOW)

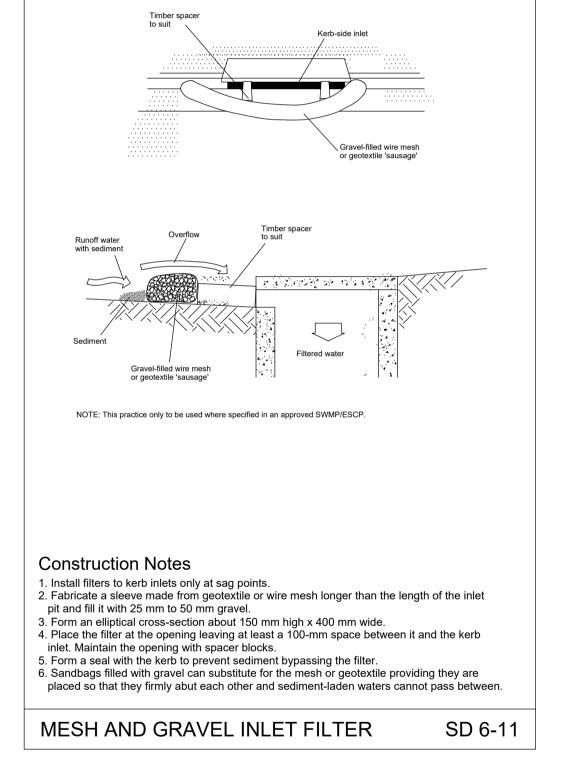
SD 5-5

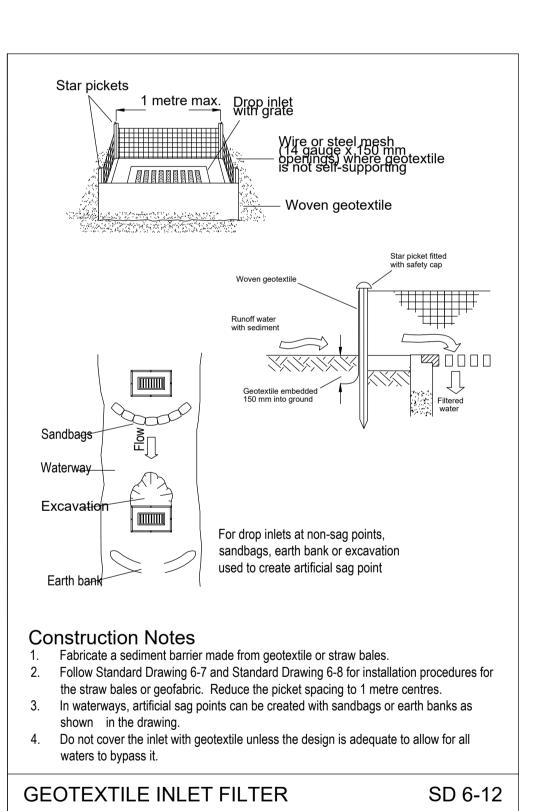


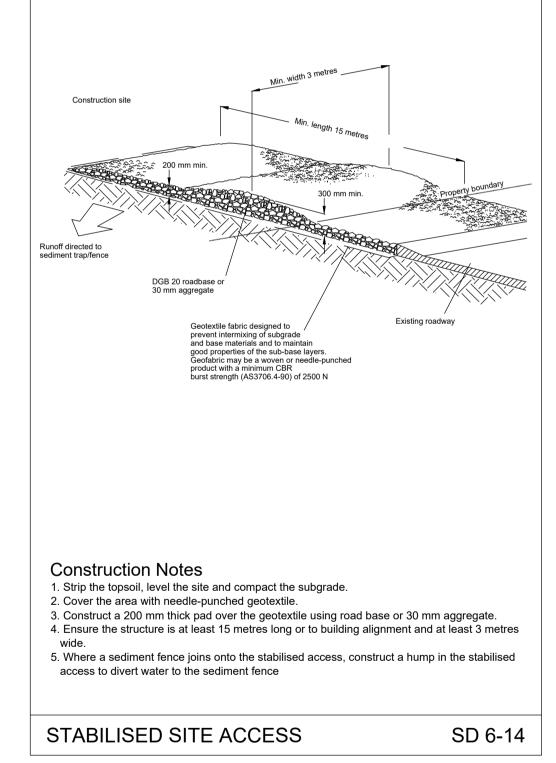








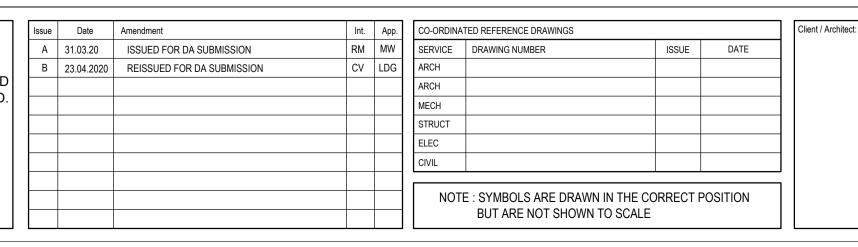




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Drawing Title:
CIVIL SERVICES
SOIL & WATER
MANAGEMENT DETAILS SHEET

FILE NAME & PATH: W:\218xx\21863 - Penrith Pub\001 - Design Services\CAD\Design\Civil\21863 CE02 SOIL & WATER MANAGEMENT DETAILS SHEET.dwg PLOTTED BY: 'christopher.veleski' PLOT DATE & TIME: 23 Apr., 2020 - 2:37pm

North Point:	Design:	CV
	Design Validated:	-
	Amendment Approved:	LDG
	Drawn:	CV
Date: MAR 2020	Scale: (A1)	NTS
Job No.: Part No.: 21863-001 -	Disc: Dwg No.:	Stage: Issue: