

Cardno (NSW/ACT) Pty Ltd | ABN 95 001 145 035 Level 9, The Forum, 203 Pacific Highway St. Leonards, NSW 2065 Tel: 02 9496 7700 Fax: 02 9439 5170

Web: www.cardno.com.au

LENDLEASE JORDAN SPRINGS EAST STAGE 3B2 - CIVIL WORKS DEVELOPMENT APPLICATION





SCHEDULE OF DRAWINGS

DESCRIPTION DRAWING No. COVER SHEET & DRAWING SCHEDULE CV-CARDNO-ST03B2-1001 GENERAL NOTES & LEGENDS CV-CARDNO-ST03B2-1011 CV-CARDNO-ST03B2-1021 CONTEXT PLAN GENERAL ARRANGEMENT PLAN CV-CARDNO-ST03B2-1031 DEVELOPMENT APPLICATION STAGING PLAN AND ROAD HIERARCHY PLAN CV-CARDNO-ST03B2-1041 CV-CARDNO-ST03B2-1051 EXISTING SERVICES AND SURVEY PLAN CV-CARDNO-ST03B2-1101 EROSION AND SEDIMENTATION CONTROL PLAN EROSION AND SEDIMENTATION CONTROL DETAILS CV-CARDNO-ST03B2-1131 CV-CARDNO-ST03B2-1251 TYPICAL ROAD CROSS SECTIONS CV-CARDNO-ST03B2-1301 ROADS & STORMWATER PLAN ROAD LONGITUDINAL SECTIONS SHEET 1 ROAD 001 CV-CARDNO-ST03B2-1351

CV-CARDNO-ST03B2-1352 ROAD LONGITUDINAL SECTIONS SHEET 2 ROAD 013 & 021 CV-CARDNO-ST03B2-1353 ROAD LONGITUDINAL SECTIONS SHEET 3 ROAD 022 & 023 CV-CARDNO-ST03B2-1354 ROAD LONGITUDINAL SECTIONS SHEET 4 LANE 001 & 002 CV-CARDNO-ST03B2-1601 SITEWORKS DETAILS SHEET 1 SITEWORKS DETAILS SHEET 2 CV-CARDNO-ST03B2-1602 CV-CARDNO-ST03B2-1701 PAVEMENT, SIGNAGE & LINEMARKING PLAN CV-CARDNO-ST03B2-2201 CV-CARDNO-ST03B2-2202 CV-CARDNO-ST03B2-2301 CV-CARDNO-ST03B2-3001 LANEWAY GARBAGE COLLECTION TURNING PATH

ISSUED FOR DEVELOPMENT APPLICATION APPROVAL BJD DRAFT - ISSUED FOR INFORMATION

Des. Verif. Appd.

© Cardno Limited All Rights Reserved. This document is produced by Cardno Limited solely for the benefit of and use by the client in accordance with the terms of the retainer. Cardno Limited does not and shall not assume any responsibility or liability whatsoever to any third party arising out of any use or reliance by third party on the content of this document.

	Drawn	Date	Status		
	MCD	15.09.17		E05.45	
	Checked	Date		FOR AP	ŀ
	DAC	15.09.17	NOT TO BE I	JSED FOR CO	١
	Designed	Date	INOT TO BE (JOLD I OIL OC	•
	BJĎ	15.09.17			
L	Verified	Date	Datum		
			AHD		ĺ
	Approved		Drawing Number		_
	ADM	15 00 17	CV-CAI	RDNO-ST	(

GENERAL

- 1. ALL WORKS TO BE CONSTRUCTED IN ACCORDANCE WITH PENRITH CITY COUNCIL ENGINEERING CONSTRUCTION SPECIFICATION FOR CIVIL WORKS.
- PENRITH CITY COUNCIL STANDARD DETAILS TO BE USED AT ALL

SITEWORKS NOTES

- . ORIGIN OF LEVELS:- REFER SURVEY NOTES.
- . CONTRACTOR MUST VERIFY ALL DIMENSIONS AND EXISTING LEVELS ON SITE PRIOR TO COMMENCEMENT OF WORK. ANY DISCREPANCIES TO BE REPORTED TO CARDNO.
- MAKE SMOOTH CONNECTION WITH EXISTING WORKS AND SURFACES.
- . ALL TRENCH BACKFILL MATERIAL SHALL BE COMPACTED TO THE SAME DENSITY AS THE ADJACENT MATERIAL.
- . ALL SERVICE TRENCHES UNDER VEHICULAR PAVEMENTS SHALL BE BACKFILLED WITH SAND TO 300mm ABOVE PIPE. WHERE PIPE IS UNDER PAVEMENTS BACKFILL REMAINDER OF TRENCH TO UNDERSIDE OF PAVEMENT WITH SAND OR APPROVED GRANULAR MATERIAL COMPACTED IN 150mm LAYERS TO MINIMUM 98% MODIFIED MAXIMUM DRY DENSITY IN ACCORDANCE WITH AS 1289 5.2.1. (OR A DENSITY INDEX OF NOT LESS THAN 75)
- . PROVIDE 10mm WIDE EXPANSION JOINTS BETWEEN BUILDINGS AND ALL CONCRETE OR UNIT PAVEMENTS.
- 7. ASPHALTIC CONCRETE SHALL CONFORM TO R.M.S. SPECIFICATION R116.
- B. ALL BASECOURSE MATERIAL SHALL BE IGNEOUS ROCK QUARRIED MATERIAL TO COMPLY WITH R.M.S. FORM 3051, COMPACTED TO MINIMUM 98% MODIFIED DENSITY IN ACCORDANCE WITH AS 1289 5.2.1 FREQUENCY OF COMPACTION TESTING SHALL NOT BE LESS THAN 1 TEST PER 50m³ OF BASECOURSE MATERIAL PLACED.
- 9. ALL SUB-BASE COURSE MATERIAL SHALL BE IGNEOUS ROCK QUARRIED MATERIAL TO COMPLY WITH R.M.S. FORM 3051, AND COMPACTED TO MINIMUM 95% MODIFIED DENSITY IN ACCORDANCE WITH A.S 1289 5.2.1 FREQUENCY OF COMPACTION TESTING SHALL NOT BE LESS THAN 1 TEST PER 100m³ OF SUB-BASE COURSE MATERIAL PLACED.
- 10. AS AN ALTERNATIVE TO THE USE OF IGNEOUS ROCK AS A SUB-BASE MATERIAL IN (9) A CERTIFIED RECYCLED CONCRETE MATERIAL COMPLYING WITH R.M.S. FORM 3051 WILL BE CONSIDERED. SUBJECT TO MATERIAL SAMPLES AND APPROPRIATE CERTIFICATIONS BEING PROVIDED TO THE SATISFACTION OF PENRITH CITY COUNCIL AND THE SUPERINTENDENT.
- 11. A HANDRAIL OR SAFETY BARRIER IS TO BE PROVIDED AT THE TOP OF ALL HEADWALLS AND RETAINING WALLS GREATER THAN 1m HIGH IN ACCORDANCE WITH THE LENDLEASE GMR'S.

BULK EARTHWORKS NOTES

- 1. ORIGIN OF LEVELS: REFER SURVEY NOTES
- STRIP ALL TOPSOIL/ORGANIC MATERIAL FROM CONSTRUCTION AREA AND STOCK PILE AS DIRECTED BY SUPERINTENDENT FOR FUTURE REUSE.
- EXCAVATED MATERIAL TO BE USED AS STRUCTURAL FILL PROVIDED THE PLACEMENT MOISTURE CONTENT OF THE MATERIAL IS +/- 2% OF THE OPTIMUM MOISTURE CONTENT.
- 4. COMPACT FILL AREAS AND SUBGRADE TO NOT LESS THAN:

LOCATION	STANDARD DRY DENSITY (AS 1289 E 5.1.1.)
UNDED DUIL DING OF A DC	

UNDER BUILDING SLABS ON GROUND 98% UNDER ROADS AND CARPARKS LANDSCAPED AREAS UNLESS NOTED OTHERWISE 98%

- . FOR NON COHESIVE MATERIAL, COMPACT TO 75% DENSITY INDEX.
- BEFORE PLACING FILL, PROOF ROLL EXPOSED SUBGRADE WITH AN 8 TONNE (MIN) DEADWEIGHT SMOOTH DRUM VIBRATORY ROLLER TO DETECT THEN REMOVE SOFT SPOTS (AREAS WITH MORE THAN 2mm MOVEMENT UNDER ROLLER).
- FREQUENCY OF COMPACTION TESTING SHALL BE NOT LESS THAN:-(A) 1 TEST PER 1,000m³ OF FILL PLACED PER LAYER OF FILL.

(B) 3 TESTS PER VISIT

- (C) 1 TEST PER 1000m² OF EXPOSED SUBGRADE "LEVEL 1" TESTING SHALL BE TESTING IN ACCORDANCE WITH AS 3798 (1996).
- B. FILLING TO BE PLACED IN MAXIMUM 300mm LOOSE LAYERS AND COMPACTED AS SPECIFIED
- P. NO FILLING SHALL TAKE PLACE TO EXPOSED SUBGRADE UNTIL THE AREA HAS BEEN PROOF ROLLED IN THE PRESENCE OF A SUITABLY QUALIFIED GEOTECHNICAL ENGINEER AND APPROVAL GIVEN IN WRITING THAT FILLING CAN PROCEED.

EROSION AND SEDIMENT CONTROL

NOTES

GENERAL INSTRUCTIONS THE CONTRACTOR SHALL BE SOLELY RESPONSIBLE FOR THE CONTROL O EROSION AND SEDIMENTATION TO THE SATISFACTION OF COUNCIL, NSW OFFICE OF WATER, SYDNEY WATER, THE OFFICE OF ENVIRONMENT AND

HERITAGE, AND LENDLEASE'S REPRESENTATIVE. TO THIS END, THE EROSION AND SEDIMENTATION CONTROLS SHOWN ON THE DRAWINGS SHALL ONLY BE USED AS A GUIDE BY THE CONTRACTOR, AND REPRESEN THE MINIMUM REQUIREMENT ONLY.

- THE CONTRACTOR SHALL ENSURE THAT ALL SOIL AND WATER MANAGEMENT WORKS ARE LOCATED AS DOCUMENTED OR AS OTHERWISE DIRECTED BY THE SUPERINTENDENT.
- ALL WORK SHALL BE GENERALLY CARRIED OUT IN ACCORDANCE WITH a. LOCAL AUTHORITY REQUIREMENTS
- ь. EPA REQUIREMENTS c. NSW DEPARTMENT OF HOUSING MANUAL "MANAGING URBAN
- STORMWATER, SOILS AND CONSTRUCTION", 4th EDITION, MARCH 2004.
- MAINTAIN THE EROSION CONTROL DEVICES TO THE SATISFACTION OF THE SUPERINTENDENT AND THE LOCAL AUTHORITY.
- ENTERING UNLESS SEDIMENT FENCES ARE ERECTED AROUND PITS. CONTRACTOR IS TO ENSURE ALL EROSION & SEDIMENT CONTROL DEVICES ARE MAINTAINED IN GOOD WORKING ORDER AND OPERATE

WHEN STORMWATER PITS ARE CONSTRUCTED, PREVENT SITE RUNOFF

EFFECTIVELY. REPAIRS AND OR MAINTENANCE SHALL BE UNDERTAKEN

.AND DISTURBANCE

WHERE PRACTICAL THE SOIL EROSION HAZARD ON THE SITE WILL BE KEPT AS LOW AS POSSIBLE. TO THIS END, WORKS SHOULD BE UNDERTAKEN IN THE FOLLOWING SEQUENCE

AS REQUIRED, PARTICULARLY FOLLOWING STORM EVENTS.

- a. INSTALL A SEDIMENT FENCE ALONG THE BOUNDARIES AS SHOWN ON PLAN. REFER DETAIL. b. CONSTRUCT STABILISED CONSTRUCTION ENTRANCE TO LOCATION AS
- DETERMINED BY SUPERINTENDENT/ENGINEER. REFER DETAIL. c. INSTALL SEDIMENT BASIN AS SHOWN ON PLAN (D) INSTALL SEDIMENT
- TRAPS AS SHOWN ON PLAN. d. UNDERTAKE SITE DEVELOPMENT WORKS IN ACCORDANCE WITH THE ENGINEERING PLANS. WHERE POSSIBLE, PHASE DEVELOPMENT SO THAT LAND DISTURBANCE IS CONFINED TO AREAS OF WORKABLE SIZE

EROSION CONTROL

- DURING WINDY WEATHER, LARGE, UNPROTECTED AREAS WILL BE KEPT MOIST (NOT WET) BY SPRINKLING WITH WATER TO KEEP DUST UNDER CONTROL.
- FINAL SITE LANDSCAPING WILL BE UNDERTAKEN AS SOON AS IS PRACTICABLE AFTER THE COMPLETION OF CONSTRUCTION ACTIVITIES.

SEDIMENT CONTROL

- STOCKPILES WILL NOT BE LOCATED WITHIN 2 METRES OF HAZARD AREAS INCLUDING LIKELY AREAS OF CONCENTRATED OR HIGH VELOCITY FLOWS SUCH AS WATERWAYS. WHERE THEY ARE BETWEEN 2 AND 5 METRES FROM SUCH AREAS. SPECIAL SEDIMENT CONTROL MEASURES SHOULD BE TAKEN TO MINIMISE POSSIBLE POLLUTION TO DOWNSLOPE WATERS, E.G. THROUGH INSTALLATION OF SEDIMENT FENCING.
- 10. ANY SAND USED IN THE CONCRETE CURING PROCESS (SPREAD OVER THE SURFACE) WILL BE REMOVED AS SOON AS POSSIBLE AND WITHIN 10 WORKING DAYS FROM PLACEMENT
- 1. WATER WILL BE PREVENTED FROM ENTERING THE PERMANENT DRAINAGE SYSTEM UNLESS IT IS RELATIVELY SEDIMENT FREE, I.E. THE CATCHMENT AREA HAS BEEN PERMANENTLY LANDSCAPED AND/OR ANY LIKELY SEDIMENT HAS BEEN FILTERED THROUGH AN APPROVED STRUCTURE.
- ?. TEMPORARY SOIL AND WATER MANAGEMENT STRUCTURES WILL BE REMOVED ONLY AFTER THE LANDS THEY ARE PROTECTING ARE REHABILITATED.
- B. ACCEPTABLE RECEPTORS WILL BE PROVIDED FOR CONCRETE AND MORTAI SLURRIES, PAINTS, ACID WASHINGS, LIGHT-WEIGHT WASTE MATERIALS AND LITTER.
- 14. ANY EXISTING TREES WHICH FORM PART OF THE FINAL LANDSCAPING PLAN WILL BE PROTECTED FROM CONSTRUCTION ACTIVITIES BY: a. PROTECTING THEM WITH BARRIER FENCING OR SIMILAR MATERIALS
- INSTALLED OUTSIDE THE DRIP LINE b. ENSURING THAT NOTHING IS NAILED TO THEM

COMPACT THE SOIL AROUND THEM.

- c. PROHIBITING PAVING, GRADING, SEDIMENT WASH OR PLACING OF STOCKPILES WITHIN THE DRIP LINE EXCEPT UNDER THE FOLLOWING CONDITIONS.
- (I) ENCROACHMENT ONLY OCCURS ON ONE SIDE AND NO CLOSER TO THE TRUNK THAN EITHER 1.5 METRES OR HALF THE DISTANCE BETWEEN THE OUTER EDGE OF THE DRIP LINE AND THE TRUNK, WHICH EVER IS THE GREATER
- (II) A DRAINAGE SYSTEM THAT ALLOWS AIR AND WATER TO CIRCULATE THROUGH THE ROOT ZONE (E.G. A GRAVEL BED) IS PLACED UNDER ALI FILL LAYERS OF MORE THAN 300 MILLIMETRES DEPTH (III) CARE IS TAKEN NOT TO CUT ROOTS UNNECESSARILY NOR TO

EPA AND COUNCIL REQUIREMENTS MUST BE ADHERED TO REGARDING LEVEL OF NOISE AND WORKING HOURS TO ENSURE THAT RESIDENTS AND OTHER APPLICABLE NEIGHBORS TO THE SITE ARE NOT DISTURBED UNREASONABLY THE GENERATION OF NOISE MUST BE MINIMISED.

Des. Verif. Appd.

DUST MUST BE MINIMISED TO ENSURE THERE IS NO HEALTH RISK OR LOSS OF AMENITY.

STAGING OF WORKS

STRIPPING WORKS ARE TO BE STAGED TO MINIMISE EXTENT OF EXPOSED AREA. WEATHER CONDITIONS TO BE ASSESSED PRIOR TO UNDERTAKING

STOCKPILE PROTECTION

SEDIMENT RETENTION STRUCTURES TO BE PLACED DOWNSLOPE OF ANY STOCKPILES. STOCKPILE IN PLACE > 28 DAYS TO BE TEMPORARILY

VEHICLE AND ROAD MANAGEMENT

SITE ACCESS TO BE RESTRICTED TO ALLOCATED TRUCK ROUTES. EXTERNAL ROADS TO BE SWEPT REGULARLY FOR DURATION OF WORKS.

EXISTING UNDERGROUND SERVICES

THE LOCATIONS OF UNDERGROUND SERVICES SHOWN IN THIS SET OF DRAWINGS HAVE BEEN PLOTTED FROM SURVEY INFORMATION AND SERVICE AUTHORITY INFORMATION. THE SERVICE INFORMATION HAS BEEN PREPARED ONLY TO SHOW THE APPROXIMATE POSITIONS OF ANY KNOWN SERVICES AND MAY NOT BE AS CONSTRUCTED OR ACCURATE. CARDNO CAN NOT GUARANTEE THAT THE SERVICES INFORMATION SHOWN ON THESE DRAWINGS ACCURATELY INDICATES THE PRESENCE OR ABSENCE OF SERVICES OR THEIR LOCATION AND WILL ACCEPT NO LIABILITY FOR INACCURACIES IN THE SERVICES INFORMATION SHOWN FROM ANY CAUSE WHATSOEVER.

CONTRACTORS SHALL TAKE DUE CARE WHEN EXCAVATING ONSITE INCLUDING HAND EXCAVATION WHERE NECESSARY. CONTRACTORS ARE TO CONTACT THE RELEVANT SERVICE AUTHORITY PRIOR TO COMMENCEMENT OF EXCAVATION WORKS. CONTRACTORS ARE TO UNDERTAKE A SERVICES SEARCH, PRIOR TO COMMENCEMENT OF WORKS ON SITE. SEARCH RESULTS ARE TO BE KEPT ON SITE AT ALL TIMES.

STORMWATER DRAINAGE NOTES

- STORMWATER DESIGN CRITERIA: (A) AVERAGE RECURRENCE INTERVAL:
- 5 YEAR ARI PIPED DRAINAGE
- 100 YEAR ARI OVERLAND FLOW (B) RAINFALL INTENSITIES: TIME OF CONCENTRATION:

TO PRIOR APPROVAL BY PENRITH CITY COUNCIL.

- 5 MINUTES 5 YEAR ARI= 126mm/hr
- 100 YEAR ARI= 219mm/hr PIPES 375 DIA. AND LARGER TO BE REINFORCED CONCRETE CLASS '2'
- APPROVED SPIGOT AND SOCKET WITH RUBBER RING JOINTS. U.N.O. PIPES 300 DIA AND LESS SHALL BE DWV GRADE (CLASS SN8) uPVC
- WITH SOLVENT WELDED JOINTS. . EQUIVALENT STRENGTH FRC PIPES MIN CLASS 3 MAY BE USED SUBJECT
- ALL PIPES ARE TO BE UNIFORMLY SUPPORTED ALONG THE LENGTH OF THE BARREL BY SUITABLE FILL MATERIAL. REFER TO BEDDING SUPPORT TYPE.
- PIPES WITH SOCKETS SHALL BE LAID IN BEDDING WHERE SUITABLE RECESSES HAVE BEEN PROVIDED TO ENSURE PIPES DO NOT BEAR ON THEIR SOCKETS.
- PIPES TO BE INSTALLED TO TYPE HS1 SUPPORT IN ACCORDANCE WITH AS 3725 (2007) IN ALL CASES BACKFILL TRENCH WITH SAND TO 300mm ABOVE PIPE. WHERE PIPE IS UNDER PAVEMENTS BACKFILL REMAINDER OF TRENCH TO UNDERSIDE OF PAVEMENT WITH SAND OR APPROVED GRANULAR MATERIAL COMPACTED IN 150mm LAYERS TO MINIMUM 98% STANDARD MAXIMUM DRY DENSITY IN ACCORDANCE WITH AS 1289 5.2.1 (OR A DENSITY INDEX OF NOT LESS THAN 75).
- REFER TO AS/NZS 3725:2007 TABLE B1 FOR REQUIRED FILL DEPTHS ABOVE PIPE BARREL PRIOR TO USE OF COMPACTION MACHINERY OR TRAVERSING OF PIPES BY GENERAL SITE EQUIPMENT.
- WHERE WORKING METHODS REQUIRE HIGHER CLASS PIPE, THE CONTRACTOR SHALL REFER TO AS 3725 (2007) TO DETERMINE THE APPROPRIATE PIPE CLASS. PROPOSED PIPE CLASS SHALL BE REVIEWED BY CARDNO PRIOR TO INSTALLATION.
- 10. ALL INTERNAL WORKS WITHIN PROPERTY BOUNDARIES ARE TO COMPLY WITH THE REQUIREMENTS OF AS 3500.3 (2015).
- . THE USE OF PRECAST PITS IS ONLY PERMITTED WITH THE PRIOR APPROVAL OF PENRITH CITY COUNCIL.
- 12. ENLARGERS, CONNECTIONS AND JUNCTIONS TO BE PREFABRICATED FITTINGS WHERE PIPES ARE LESS THAN 300 DIA.
- 13. WHERE SUBSOIL DRAINS PASS UNDER FLOOR SLABS AND VEHICULAR PAVEMENTS, UNSLOTTED uPVC DWV SEWER GRADE PIPE IS TO BE
- 14. CARE IS TO BE TAKEN WITH LEVELS OF STORMWATER LINES. GRADES SHOWN ARE NOT TO BE REDUCED WITHOUT APPROVAL.
- 15. GRATES AND COVERS SHALL CONFORM TO AS 3996. MINIMUM CLASS C. UNLESS NOTED OTHERWISE.
- 16. ALL BOX CULVERTS SHALL BE STRUCTURALLY DESIGNED BY THE MANUFACTURER AND DELIVERED TO SITE AS FIT FOR PURPOSE.
- 17. AT ALL TIMES DURING CONSTRUCTION OF STORMWATER PITS, ADEQUATE SAFETY PROCEDURES SHALL BE TAKEN TO ENSURE AGAINST THE POSSIBILITY OF PERSONNEL FALLING DOWN PITS.

STORMWATER DRAINAGE NOTES CONTINUED

18. ALL EXISTING STORMWATER DRAINAGE LINES AND PITS THAT ARE TO REMAIN ARE TO BE INSPECTED AND CLEANED. DURING THIS PROCESS ANY PART OF THE STORMWATER DRAINAGE SYSTEM THAT WARRANTS REPAIR SHALL BE REPORTED TO THE SUPERINTENDENT/ENGINEER FOR FURTHER DIRECTIONS.

TELSTRA - DUTY OF CARE NOTE

TELSTRA'S PLANS SHOW ONLY THE PRESENCE OF CABLES AND PLANT THEY ONLY SHOW THEIR POSITION RELATIVE TO ROAD BOUNDARIES, PROPERTY FENCES ETC. AT THE TIME OF INSTALLATION AND TELSTRA DOES NOT WARRANT OR HOLD OUT THAT SUCH PLANS ARE ACCURATE THEREAFTER DUE TO CHANGES THAT MAY OCCUR OVER TIME. DO NOT ASSUME DEPTH OR ALIGNMENT OF CABLES OR PLANT AS THESE VARY SIGNIFICANTLY. THE CONTRACTOR HAS A DUTY OF CARE WHEN EXCAVATING NEAR TELSTRA CABLES AND PLANT. BEFORE USING MACHINE EXCAVATORS TELSTRA PLANT MUST FIRST BE PHYSICALLY EXPOSED BY SOFT DIG POTHOLING TO IDENTIFY IT'S LOCATION TELSTRA WILL SEEK COMPENSATION FOR DAMAGES CAUSED TO IT'S PROPERTY AND LOSSES CAUSED TO TELSTRA AND IT'S CUSTOMERS.

SURVEY NOTES

THE EXISTING SITE CONDITIONS SHOWN ON THE FOLLOWING DRAWINGS HAVE BEEN INVESTIGATED BY RPS GROUP PLC (FORMERLY WHELANS INSITES), BEING REGISTERED SURVEYORS, THE INFORMATION IS SHOWN TO PROVIDE A BASIS FOR DESIGN. CARDNO DOES NOT GUARANTEE THE ACCURACY OR COMPLETENESS OF THE SURVEY BASE OR ITS SUITABILITY AS A BASIS FOR CONSTRUCTION DRAWINGS. SHOULD DISCREPANCIES BE ENCOUNTERED DURING CONSTRUCTION BETWEEN THE SURVEY DATA AND ACTUAL FIELD DATA, CONTACT CARDNO.

ROOF WATER KERB OUTLETS

- KERB OUTLETS TO BE PROVIDED IN ACCORDANCE WITH PENRITH CITY COUNCILS CIVIL WORKS SPECIFICATION AT EACH LOT WHERE INTERALLOTMENT DRAINAGE IS NOT PROVIDED
- KERB OUTLETS ARE TO BE CONSTRUCTED AT THE SAME TIME KERBS ARE POURED.
- ALIGNMENT OF KERB OUTLET PIPE TO BE ADJUSTED ON SITE TO AVOID SERVICE CLASHES.

STREET FURNITURE

- ALL LIGHT POLES, STREET NAMES AND BUS SHELTERS IN THIS SUBDIVISION WILL BE GALVANISED BLACK POWDER COATED TO THE SATISFACTION OF PENRITH CITY COUNCIL. FURTHER THAT THESE LIGHT POLES WILL COMPLY WITH COUNCIL'S SPECIFICATIONS.
- ALL LIGHT POLES ARE TO BE TYPE 'MACARTHUR'. REFER ELECTRICAL DESIGN DRAWINGS.

CONCRETE NOTES

- 1. ALL WORKMANSHIP AND MATERIALS SHALL BE IN ACCORDANCE WITH AS 3600 CURRENT EDITION WITH AMENDMENTS, EXCEPT WHERE VARIED BY THE CONTRACT DOCUMENTS.
- 2. CONCRETE QUALITY ALL REQUIREMENTS OF THE CURRENT ACSE CONCRETE SPECIFICATION DOCUMENT 1 SHALL APPLY TO THE FORMWORK, REINFORCEMENT AND CONCRETE LINEESS NOTED OTHERWISE

ONCKLIE ONLESS NOTED OTHER WISE.								
ELEMENT	AS 3600 F'c MPa	SPECIFIED	NOMINAL					
	AT 28 DAYS	SLUMP	AGG. SIZE					
VEHICULAR BASE	32	60	20					
KERBS AND PATHS	25	80	20					
PITS, FOUNDATIONS &	40	80	20					
CULVERT BASE SLABS								

- CEMENT TYPE SHALL BE (ACSE SPECIFICATION) TYPE SL - PROJECT CONTROL TESTING SHALL BE CARRIED OUT IN ACCORDANCE WITH
- 3. NO ADMIXTURES SHALL BE USED IN CONCRETE UNLESS APPROVED IN
- WRITING BY CARDNO . CLEAR CONCRETE COVER TO ALL REINFORCEMENT FOR DURABILITY SHALL BE 40mm TOP AND 70mm FOR EXTERNAL EDGES UNLESS NOTED
- OTHERWISE. ALL REINFORCEMENT SHALL BE FIRMLY SUPPORTED ON MILD STEEL PLASTIC TIPPED CHAIRS, PLASTIC CHAIRS OR CONCRETE CHAIRS AT NOT GREATER THAN 1m CENTRES BOTH WAYS. BARS SHALL BE TIED AT
- ALTERNATE INTERSECTIONS THE FINISHED CONCRETE SHALL BE A DENSE HOMOGENEOUS MASS, COMPLETELY FILLING THE FORMWORK, THOROUGHLY EMBEDDING THE REINFORCEMENT AND FREE OF STONE POCKETS. ALL CONCRETE INCLUDING SLABS ON GROUND AND FOOTINGS SHALL BE COMPACTED AND CURED IN ACCORDANCE WITH R.T.A. SPECIFICATION R83.

PROPOSED WORKS LEGEND

EXISTING CONTOURS

SITE BOUNDARY

PROPOSED SEWER

BATTER SLOPE

EXTENT OF WORKS

TREES TO BE REMOVED AS PART OF

BULK EARTHWORKS PACKAGE.

TREES TO BE RETAINED

BATTERS

LOT NUMBERS

KERB & GUTTER

STANDARD DETAIL

VEHICULAR CROSSING

STANDARD DETAIL.

STORMWATER PIPELINE

CONCRETE HEADWALL

DRAINAGE LINE No.

DRAINAGE PIT No.

DRAINAGE CAP

STORMWATER DRAINAGE PITS

EXISTING WATER COURSES AS

PER 1:10000 TOPOGRAPHIC MAPS

SCOUR PROTECTION

PRAM RAMP

DETAIL.

REFER PENRITH CITY COUNCIL

REFER PENRITH CITY COUNCIL FOR

MEDIAN KERB

REFER PENRITH CITY COUNCIL

REFER DRAWING 1601 FOR DETAILS

—··−100.0·—··— PROPOSED CONTOURS


PROPOSED

—··—100.0·—··—

K&G

MDK

4\2

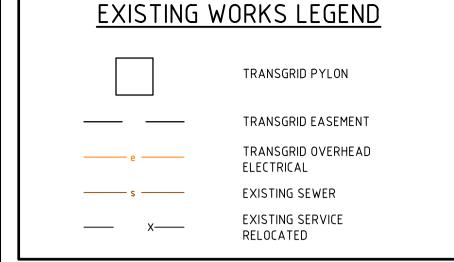


REINFORCEMENT NOTES

- REINFORCEMENT IS REPRESENTED DIAGRAMMATICALLY. IT IS NOT NECESSARILY SHOWN IN TRUE PROJECTION.
- SPLICES IN THE REINFORCEMENT SHALL BE MADE ONLY IN THE POSITIONS SHOWN. THE WRITTEN APPROVAL OF THE ENGINEER SHALL BE OBTAINED FOR ANY OTHER SPLICES. WHERE THE LAP LENGTH IS NOT SHOWN IT SHALL BE SUFFICIENT TO DEVELOP THE FULL STRENGTH OF
- WELDING OF REINFORCEMENT WILL NOT BE PERMITTED UNLESS SHOWN ON THE STRUCTURAL DRAWINGS OR APPROVED IN WRITING BY THE
- ENGINEER. REINFORCEMENT SYMBOLS -

THE REINFORCEMENT.

- N DENOTES GRADE 400N TEMPCORE DEFORMED BARS TO AS 1302 R - DENOTES GRADE 250R HOT ROLLED PLAIN BARS TO AS 1302 SL - DENOTES HARD-DRAWN WIRE REINFORCING FABRIC TO AS 1304
- W DENOTES HARD-DRAWN PLAIN WIRE TO AS 1303 REINFORCEMENT COGS AND EXTENSIONS TO BE IN ACCORDANCE WITH

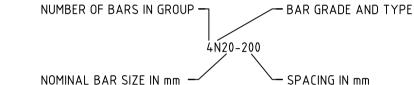

THE FIGURES FOLLOWING THE FABRICS SYMBOL 'SL' IS THE REFERENCE NUMBER FOR FABRIC TO AS 1304. ALL REINFORCEMENT FABRIC SHALL COMPLY WITH AS1303 AND AS1304 AND SHALL BE SUPPLIED AS FLAT SHEETS.



FABRIC SHALL BE LAPPED 2 TRANSVERSE WIRES PLUS 50mm.

- BUNDLED BARS SHALL BE TIED TOGETHER AT 30 BAR DIAMETER CENTRES WITH 3 WRAPS OF WIRE. PLACE SUFFICIENT BAR CHAIRS UNDER BOTTOM REINFORCING RODS AND TOP CROSSRODS IN SLABS TO ALLOW THEM TO BE SUPPORTED IN THEIR CORRECT POSITIONS DURING CONCRETING (NOT GREATER
- THAN 900mm CENTRES BOTH WAYS) REINFORCEMENT LAYERS DENOTED THUS UNO TT - DENOTES TOP BARS LAID LAST IN TOP T - DENOTES TOP BARS LAID FIRST IN TOP B - DENOTES BOTTOM BARS LAID SECOND IN BOTTOM
- SPLICED WHERE NECESSARY AND LAP WITH MAIN BARS 450mm UNLESS NOTED OTHERWISE. MINIMUM LAP LENGTHS UNLESS NOTED OTHERWISE SHALL BE -

BB - DENOTES BOTTOM BARS LAID FIRST IN BOTTOM

WHERE TRANSVERSE TIE BARS ARE NOT SHOWN PROVIDE N12-300

- 500 FOR N12 BARS 600 FOR N16 BARS 900 FOR N20 BARS
- 1000 FOR N24 BARS 1200 FOR N28 BARS

1500 FOR N32 BARS 1800 FOR N36 BARS

ISSUED FOR DEVELOPMENT APPLICATION APPROVAL BJD 15.09.17 BJD DRAFT - ISSUED FOR INFORMATION ARM 08.09.17

Description

lendlease

© Cardno Limited All Rights Reserved. This document is produced by Cardno Limited solely for the benefit of and use by the client in accordance with the terms of the retainer. Cardno Limited does not and shall not ssume any responsibility or liability whatsoever to any third party arising out of any use or reliance by third party on the content of this document.





Cardno (NSW/ACT) Pty Ltd | ABN 95 001 145 035 Level 9, The Forum, 203 Pacific Highway St. Leonards, NSW 2065 Tel: 02 9496 7700 Fax: 02 9439 5170 Web: www.cardno.com.au


LENDLEASE 15.09.17 DJect JORDAN SPRINGS EAST 15.09.17 FOR APPROVAL STAGE 3B2 - CIVIL WORKS NOT TO BE USED FOR CONSTRUCTION PURPOSES BJĎ 15.09.17 DEVELOPMENT APPLICATION Date Verified AHD Approved GENERAL NOTES & LEGENDS CV-CARDNO-ST03B2-1011 15.09.17


Document Set ID: 7854152 Version: 1, Version Date: 26/09/2017


Date

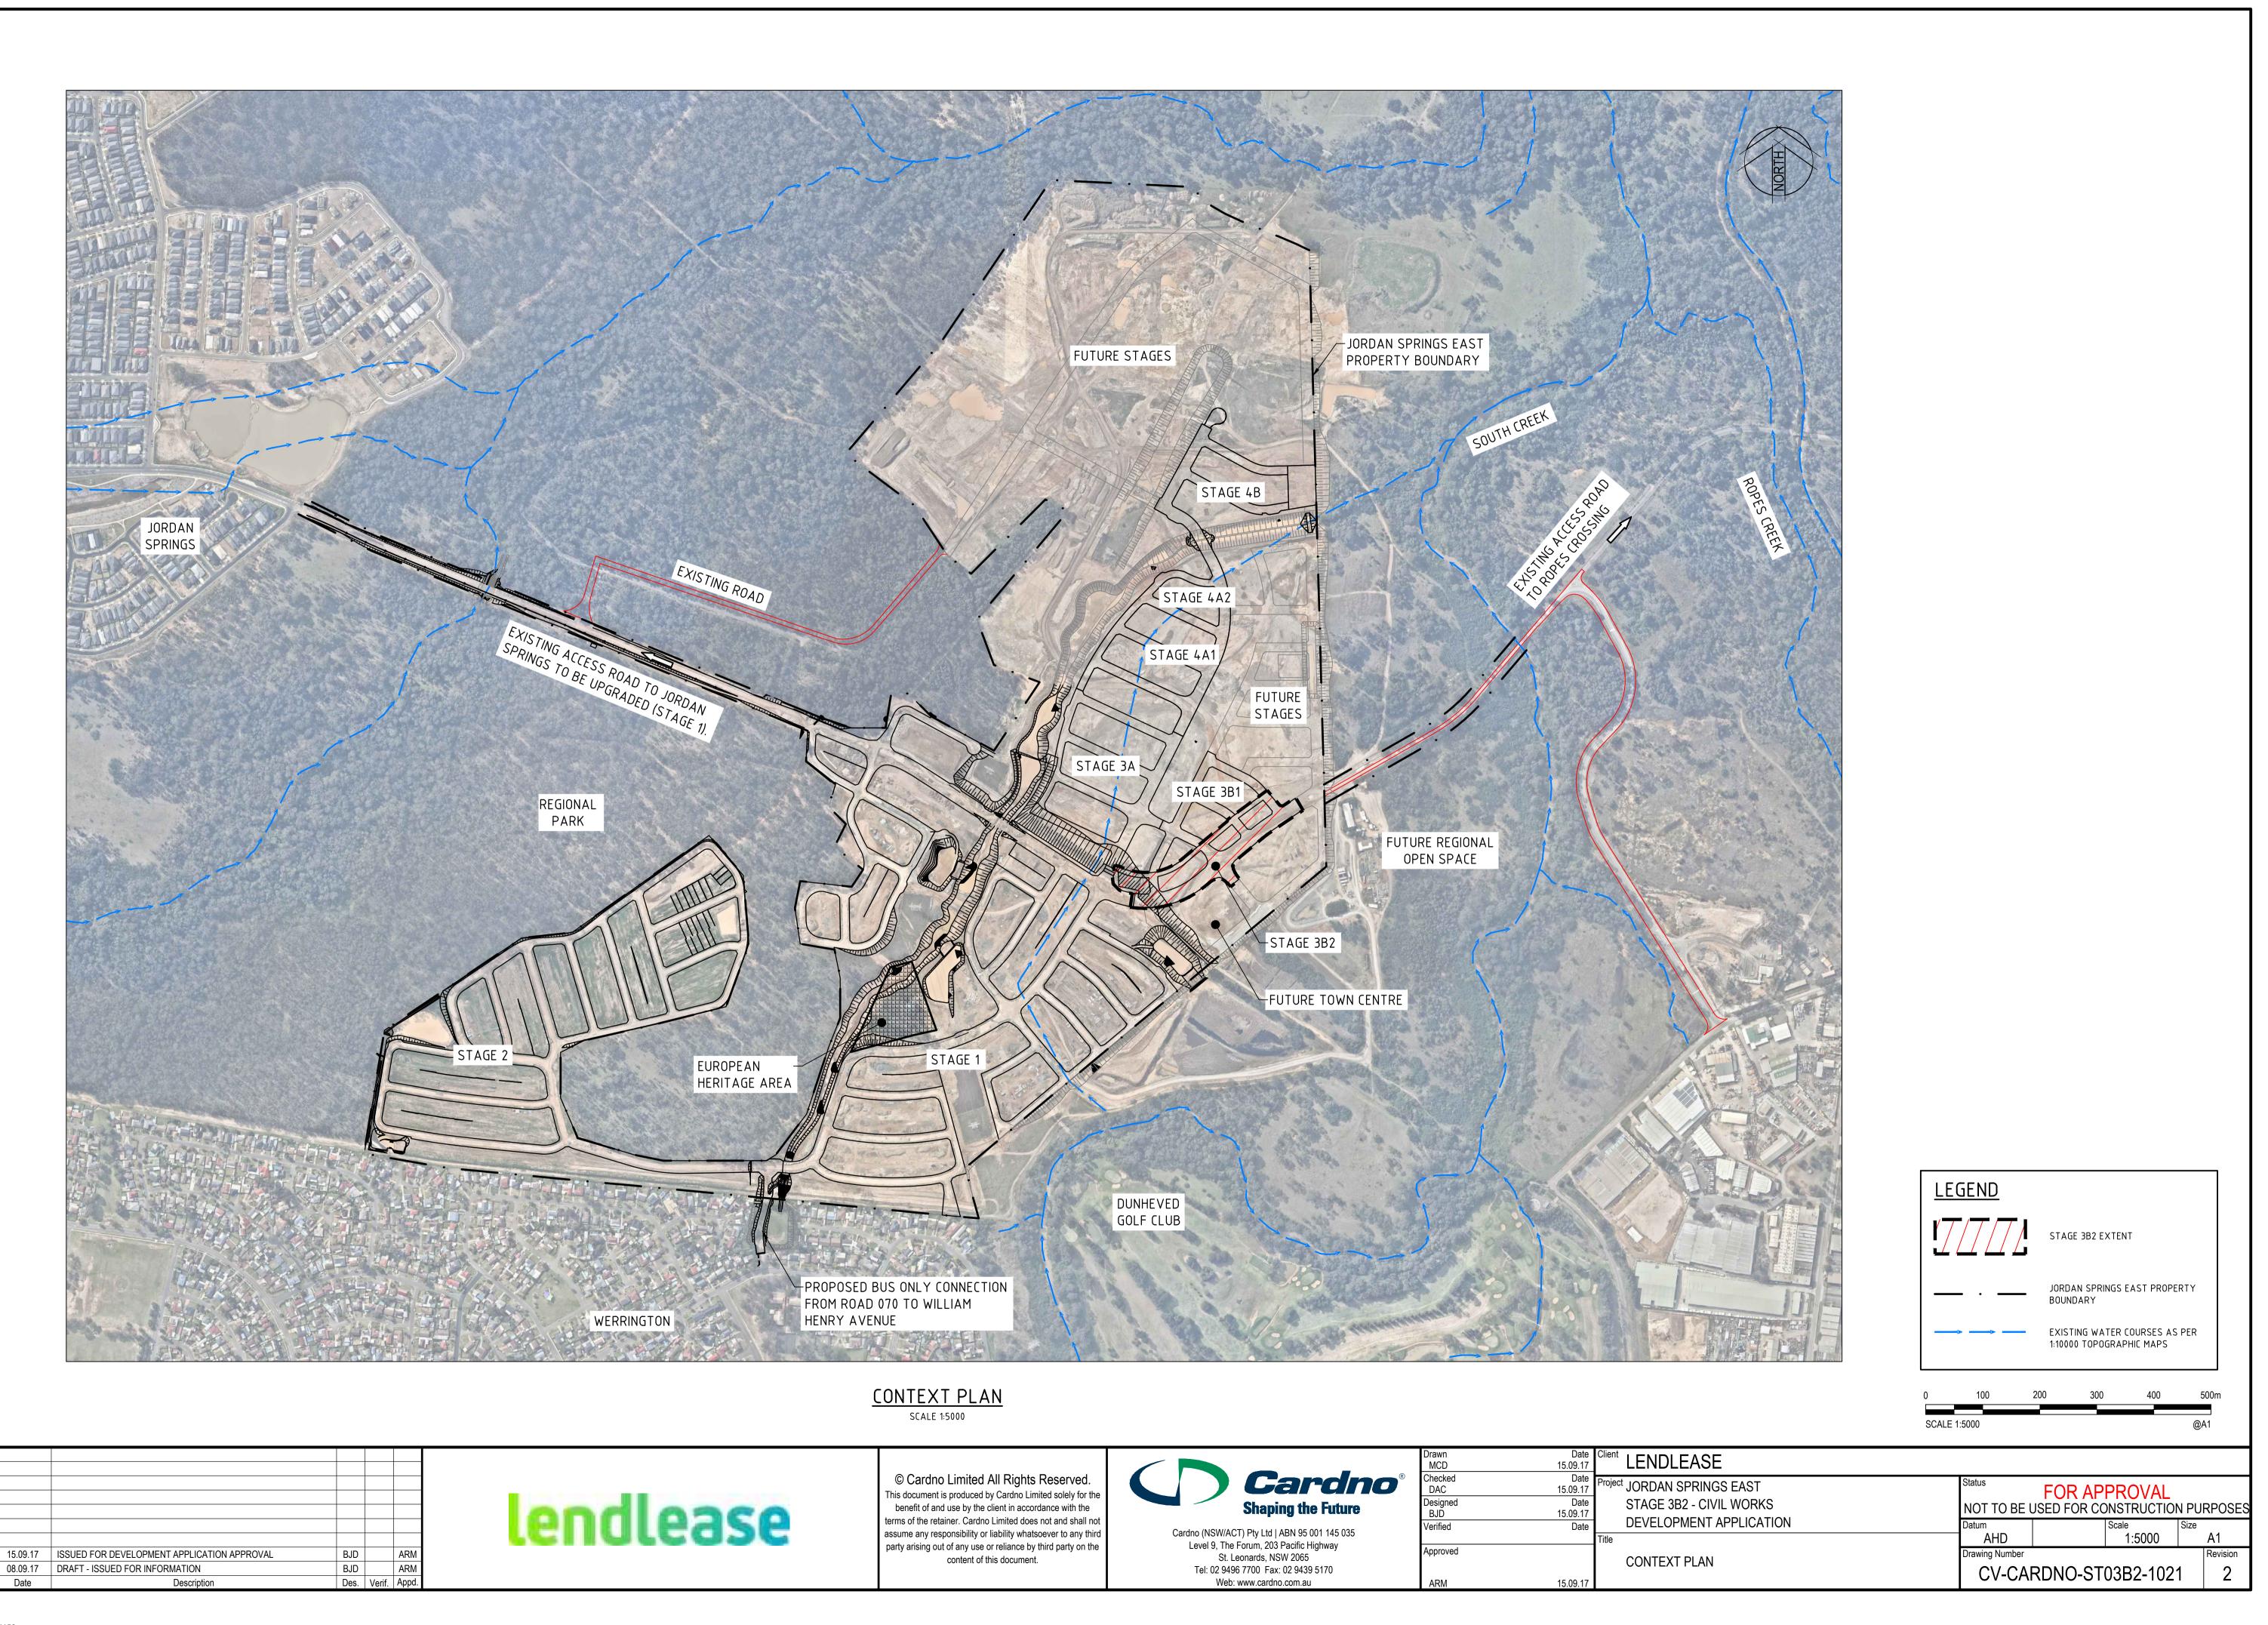


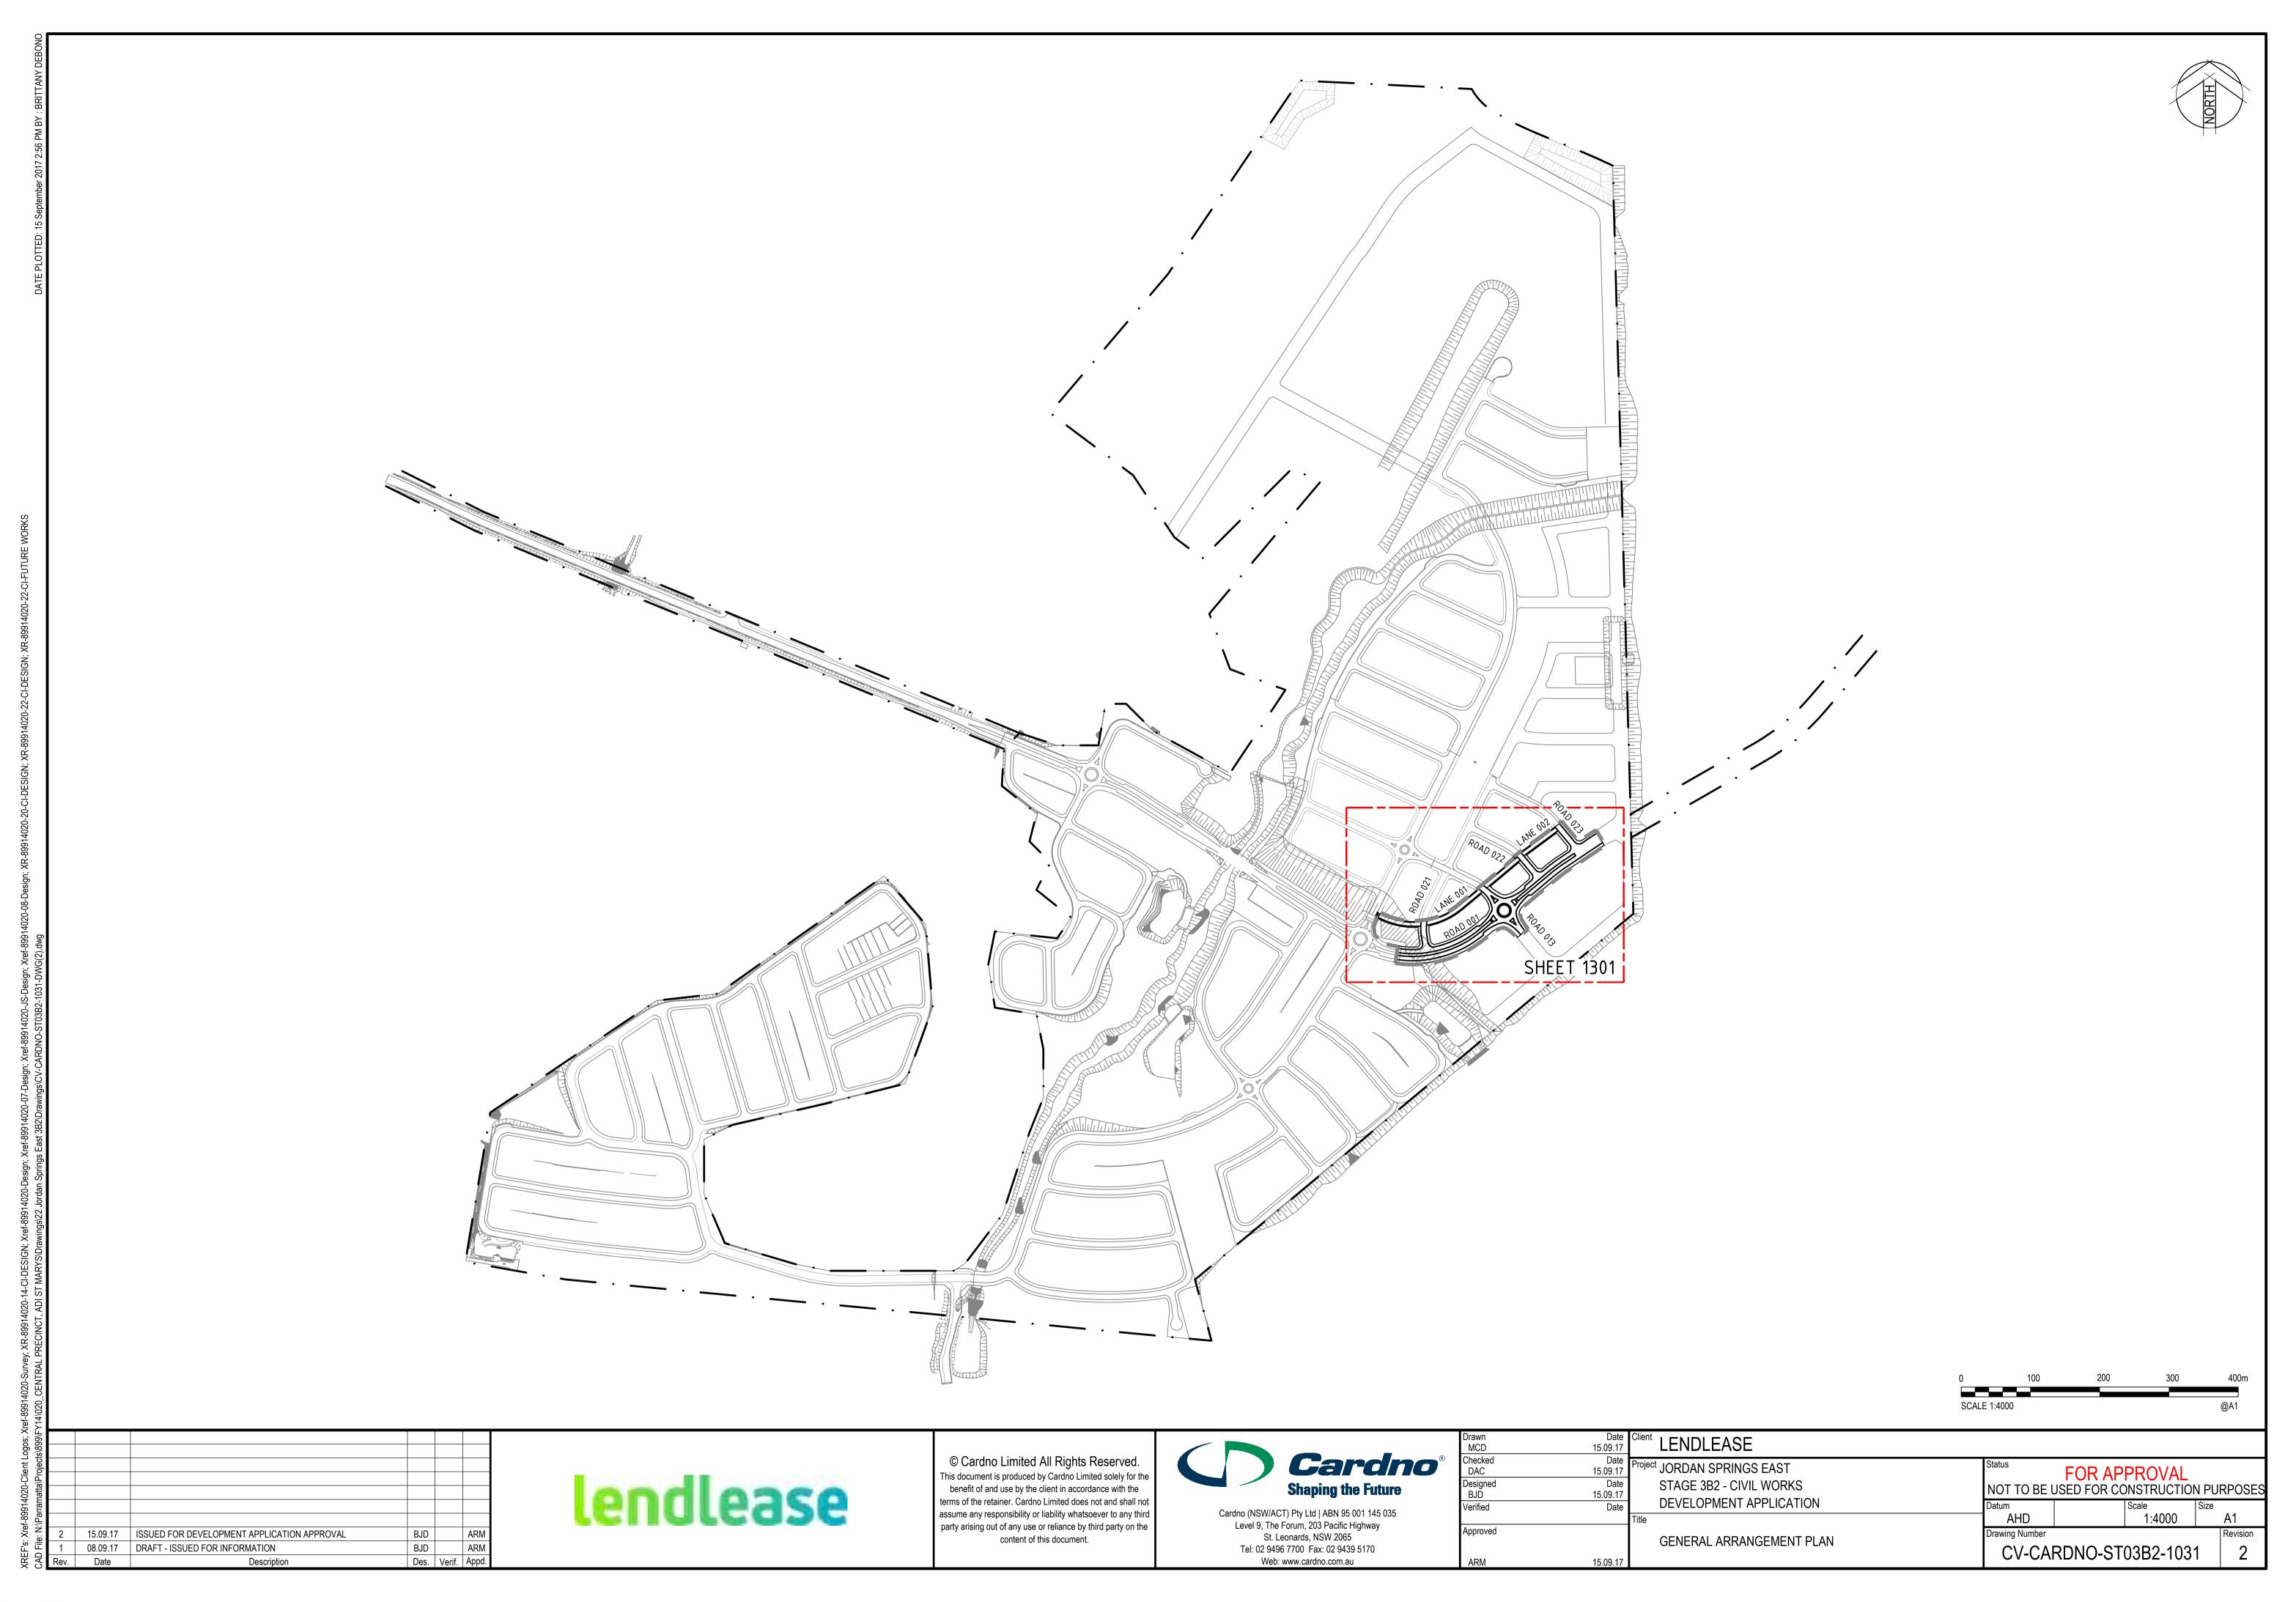

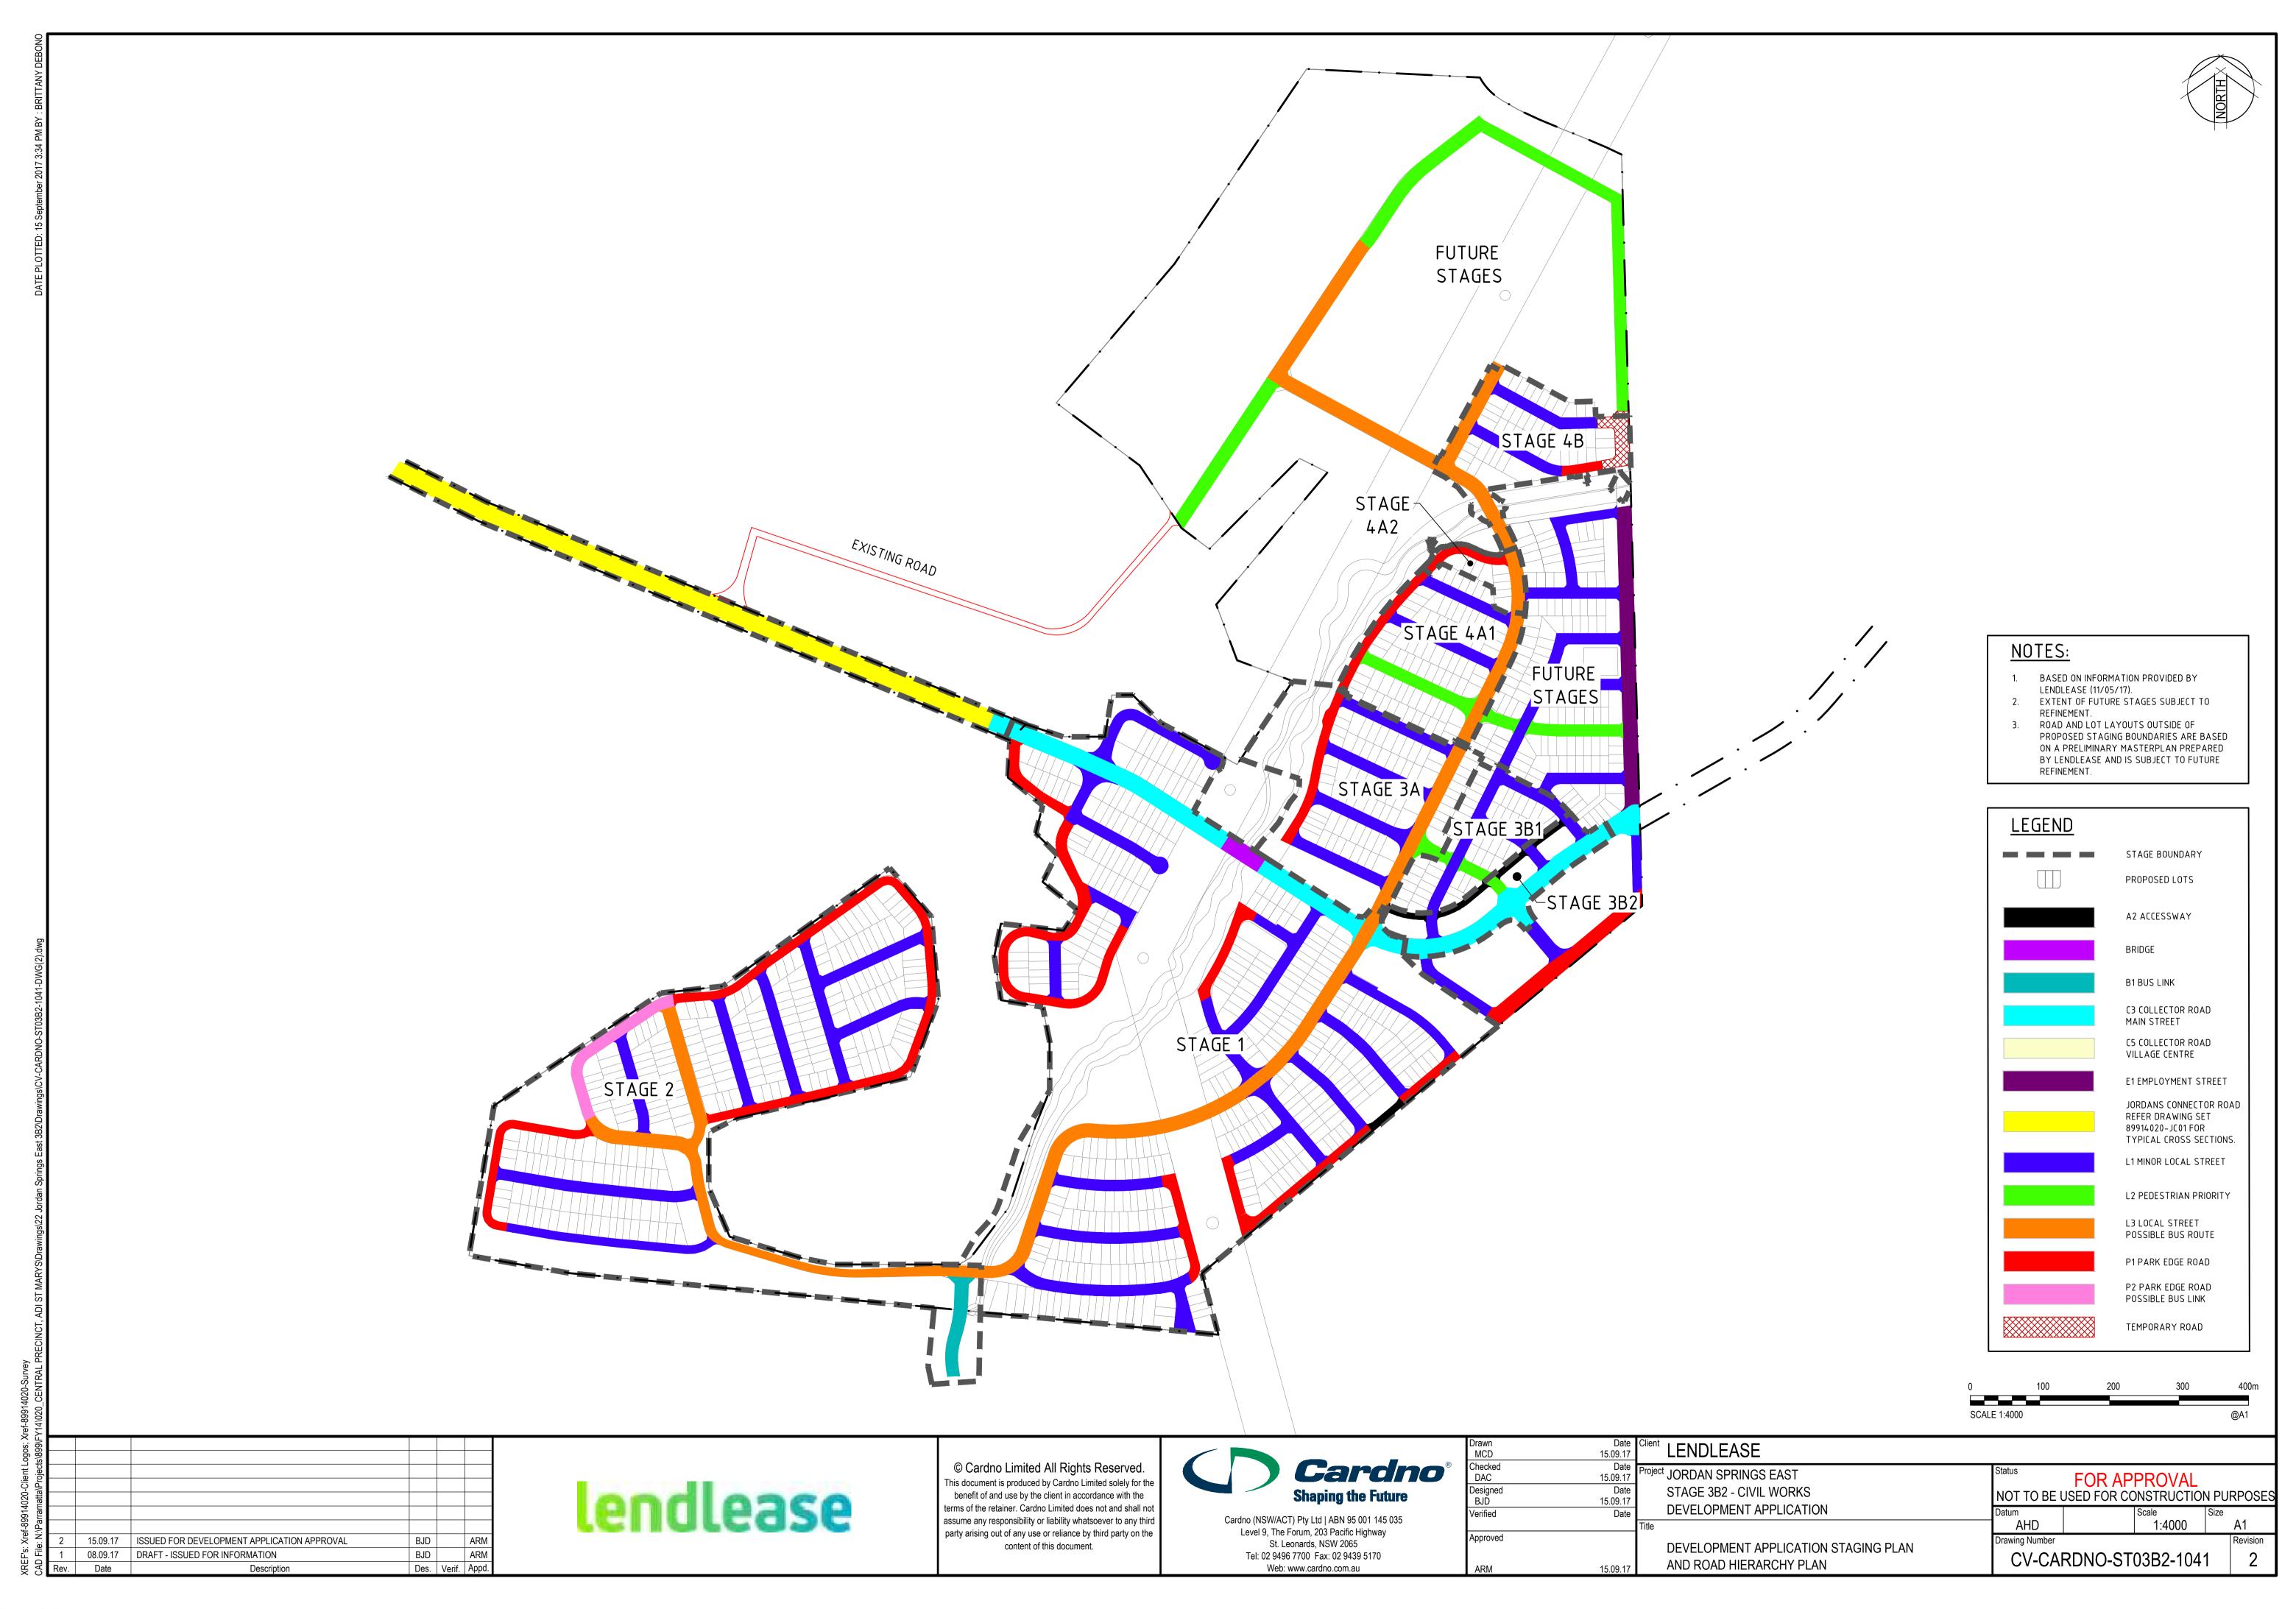

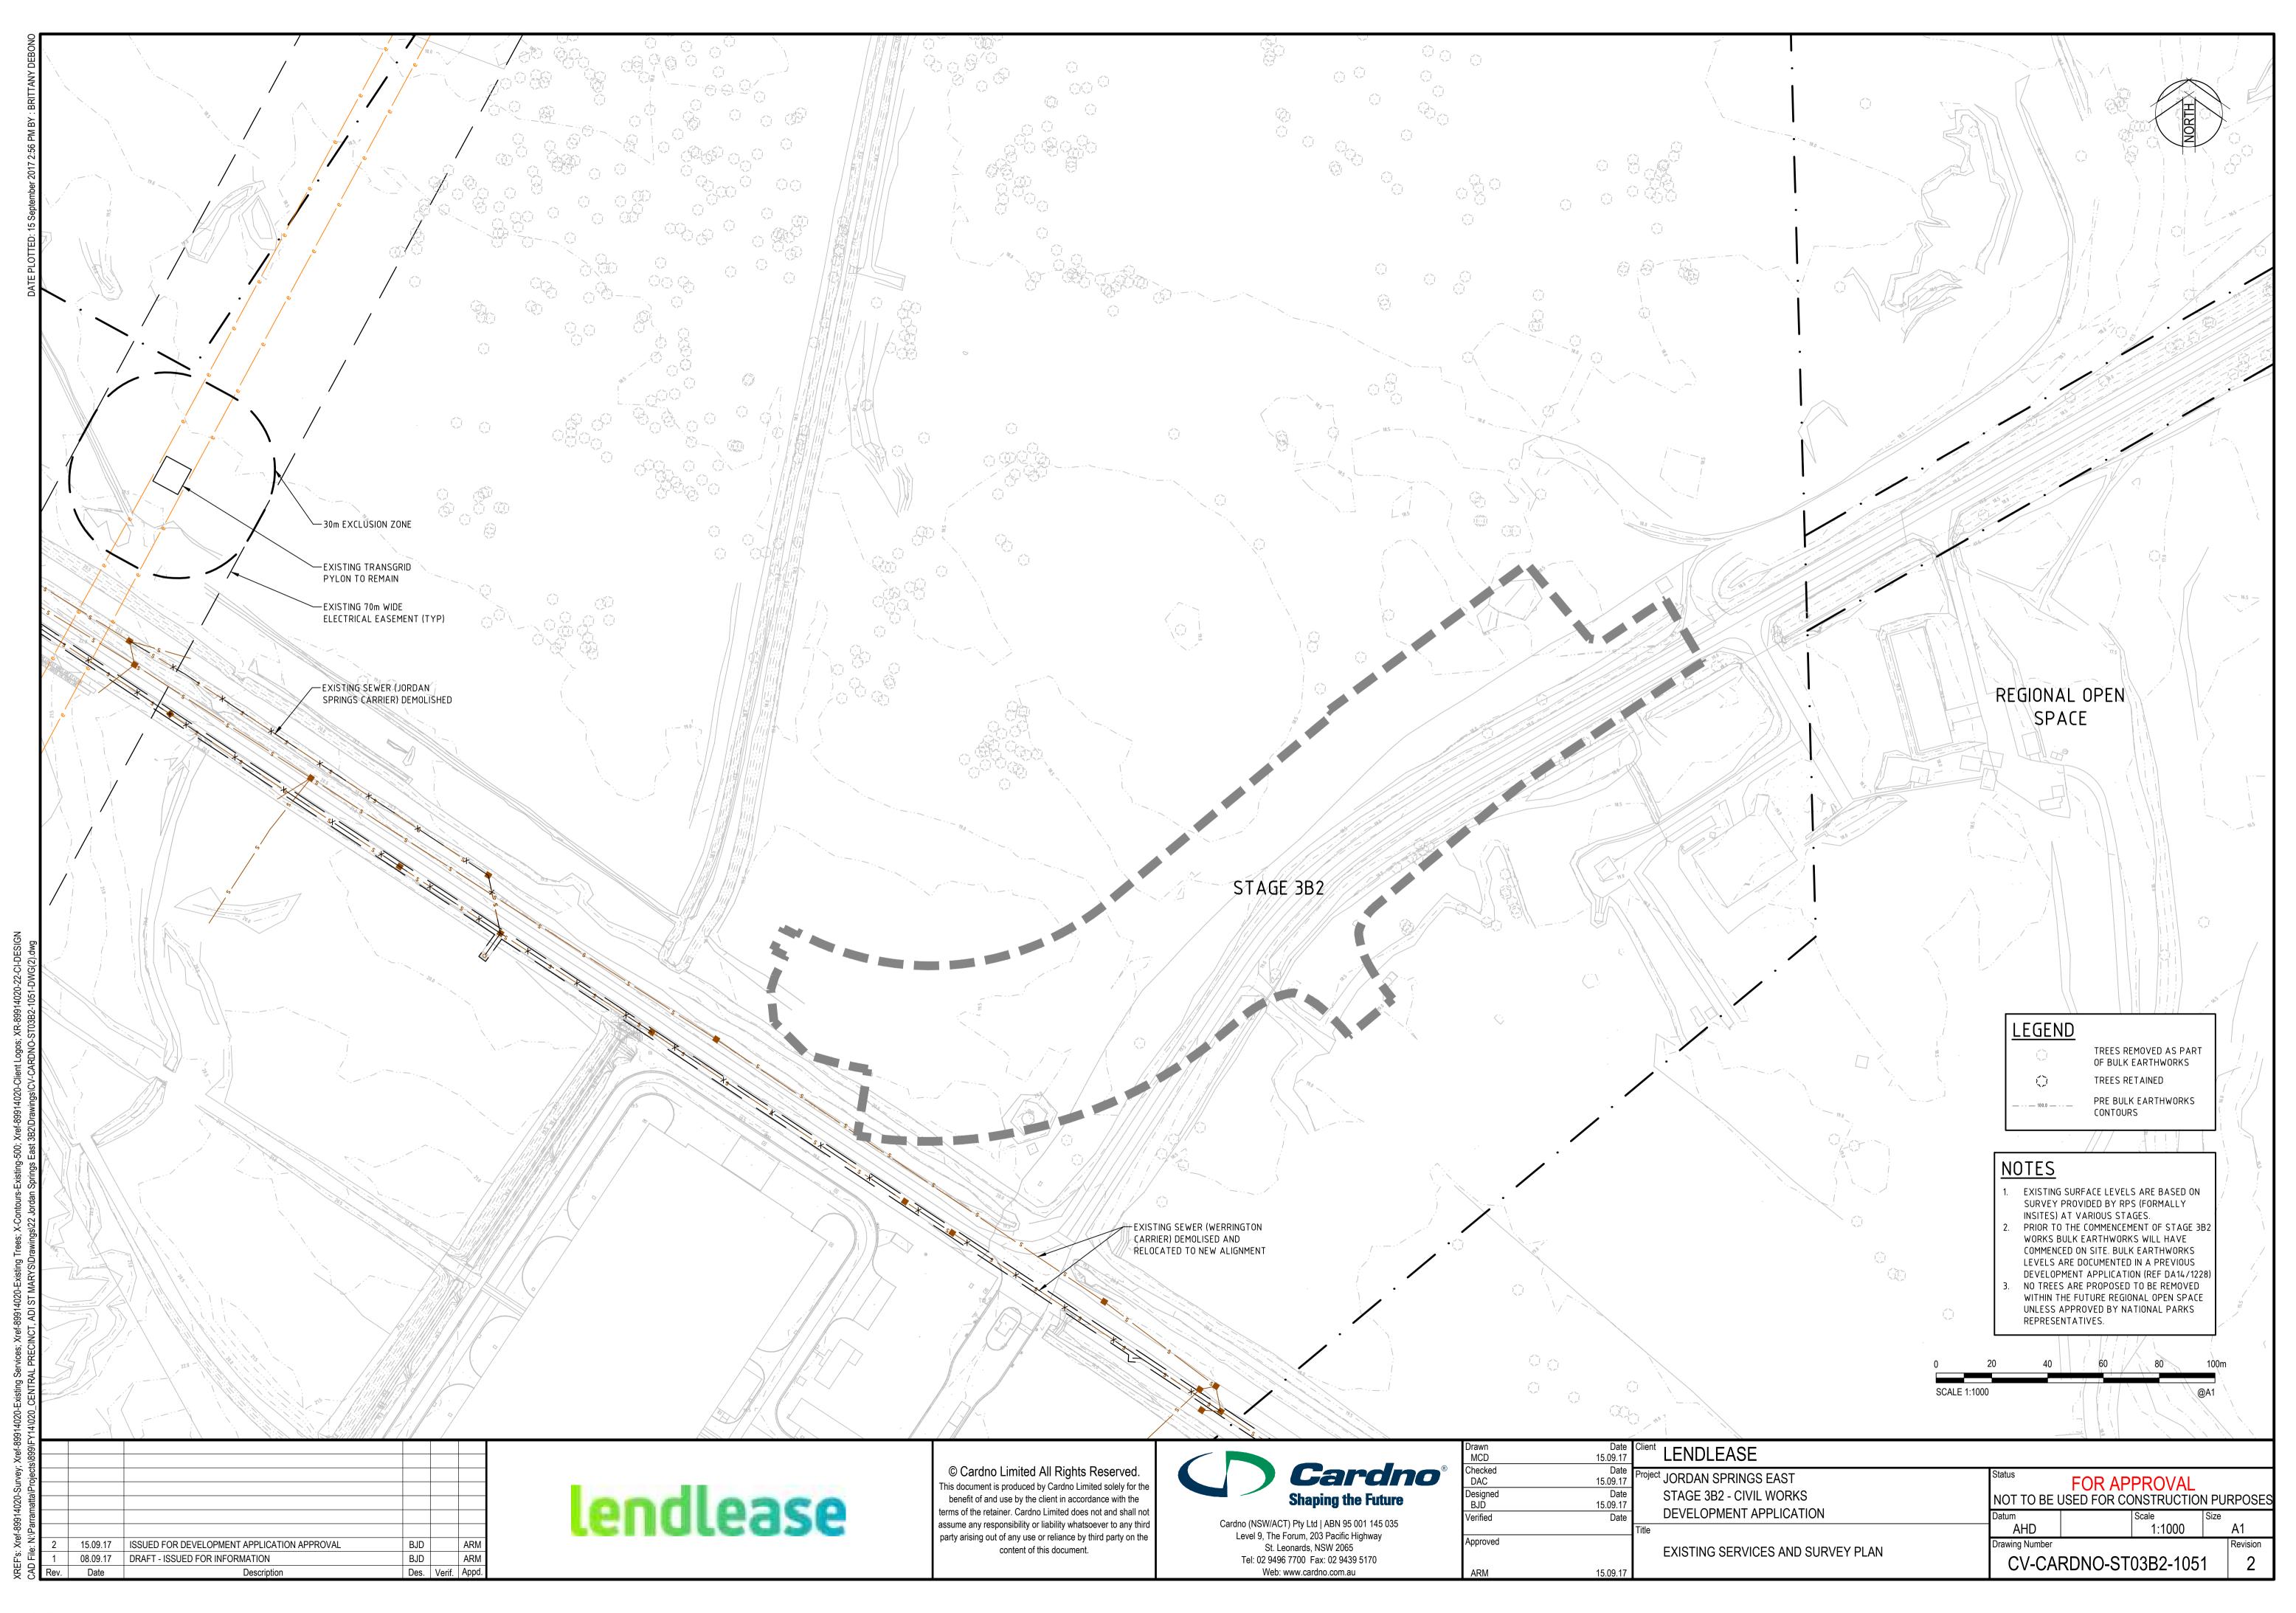

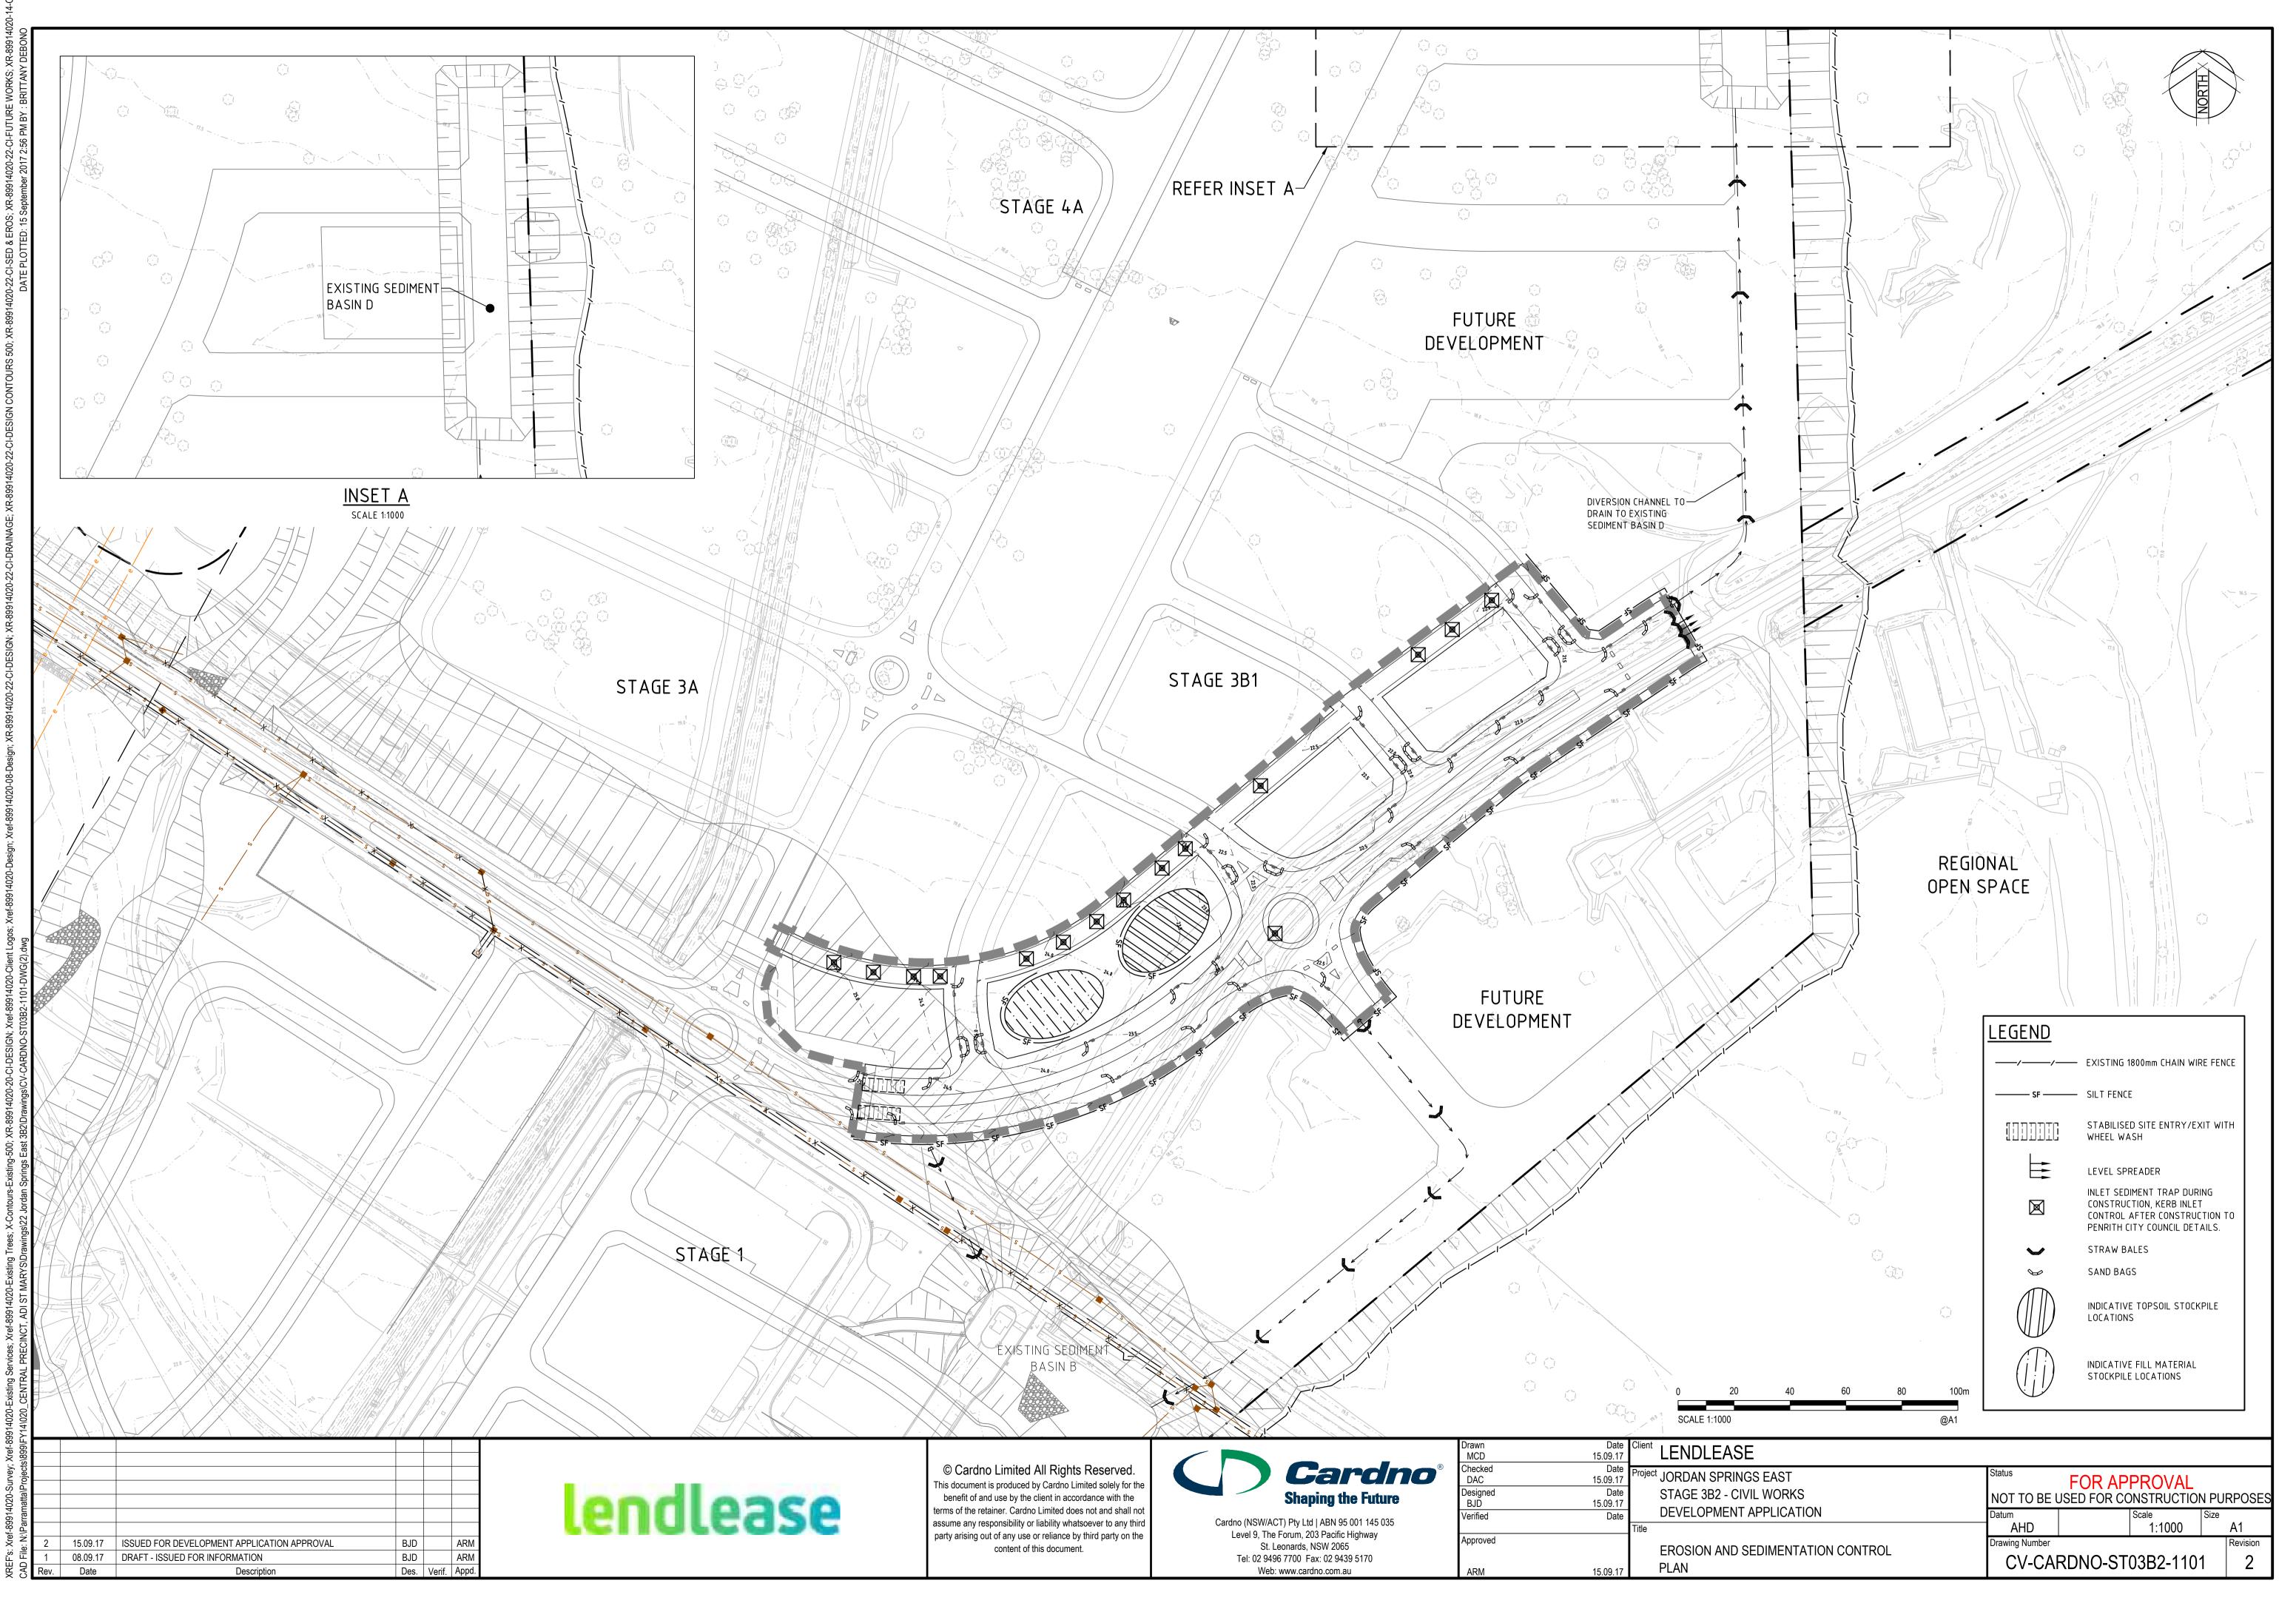

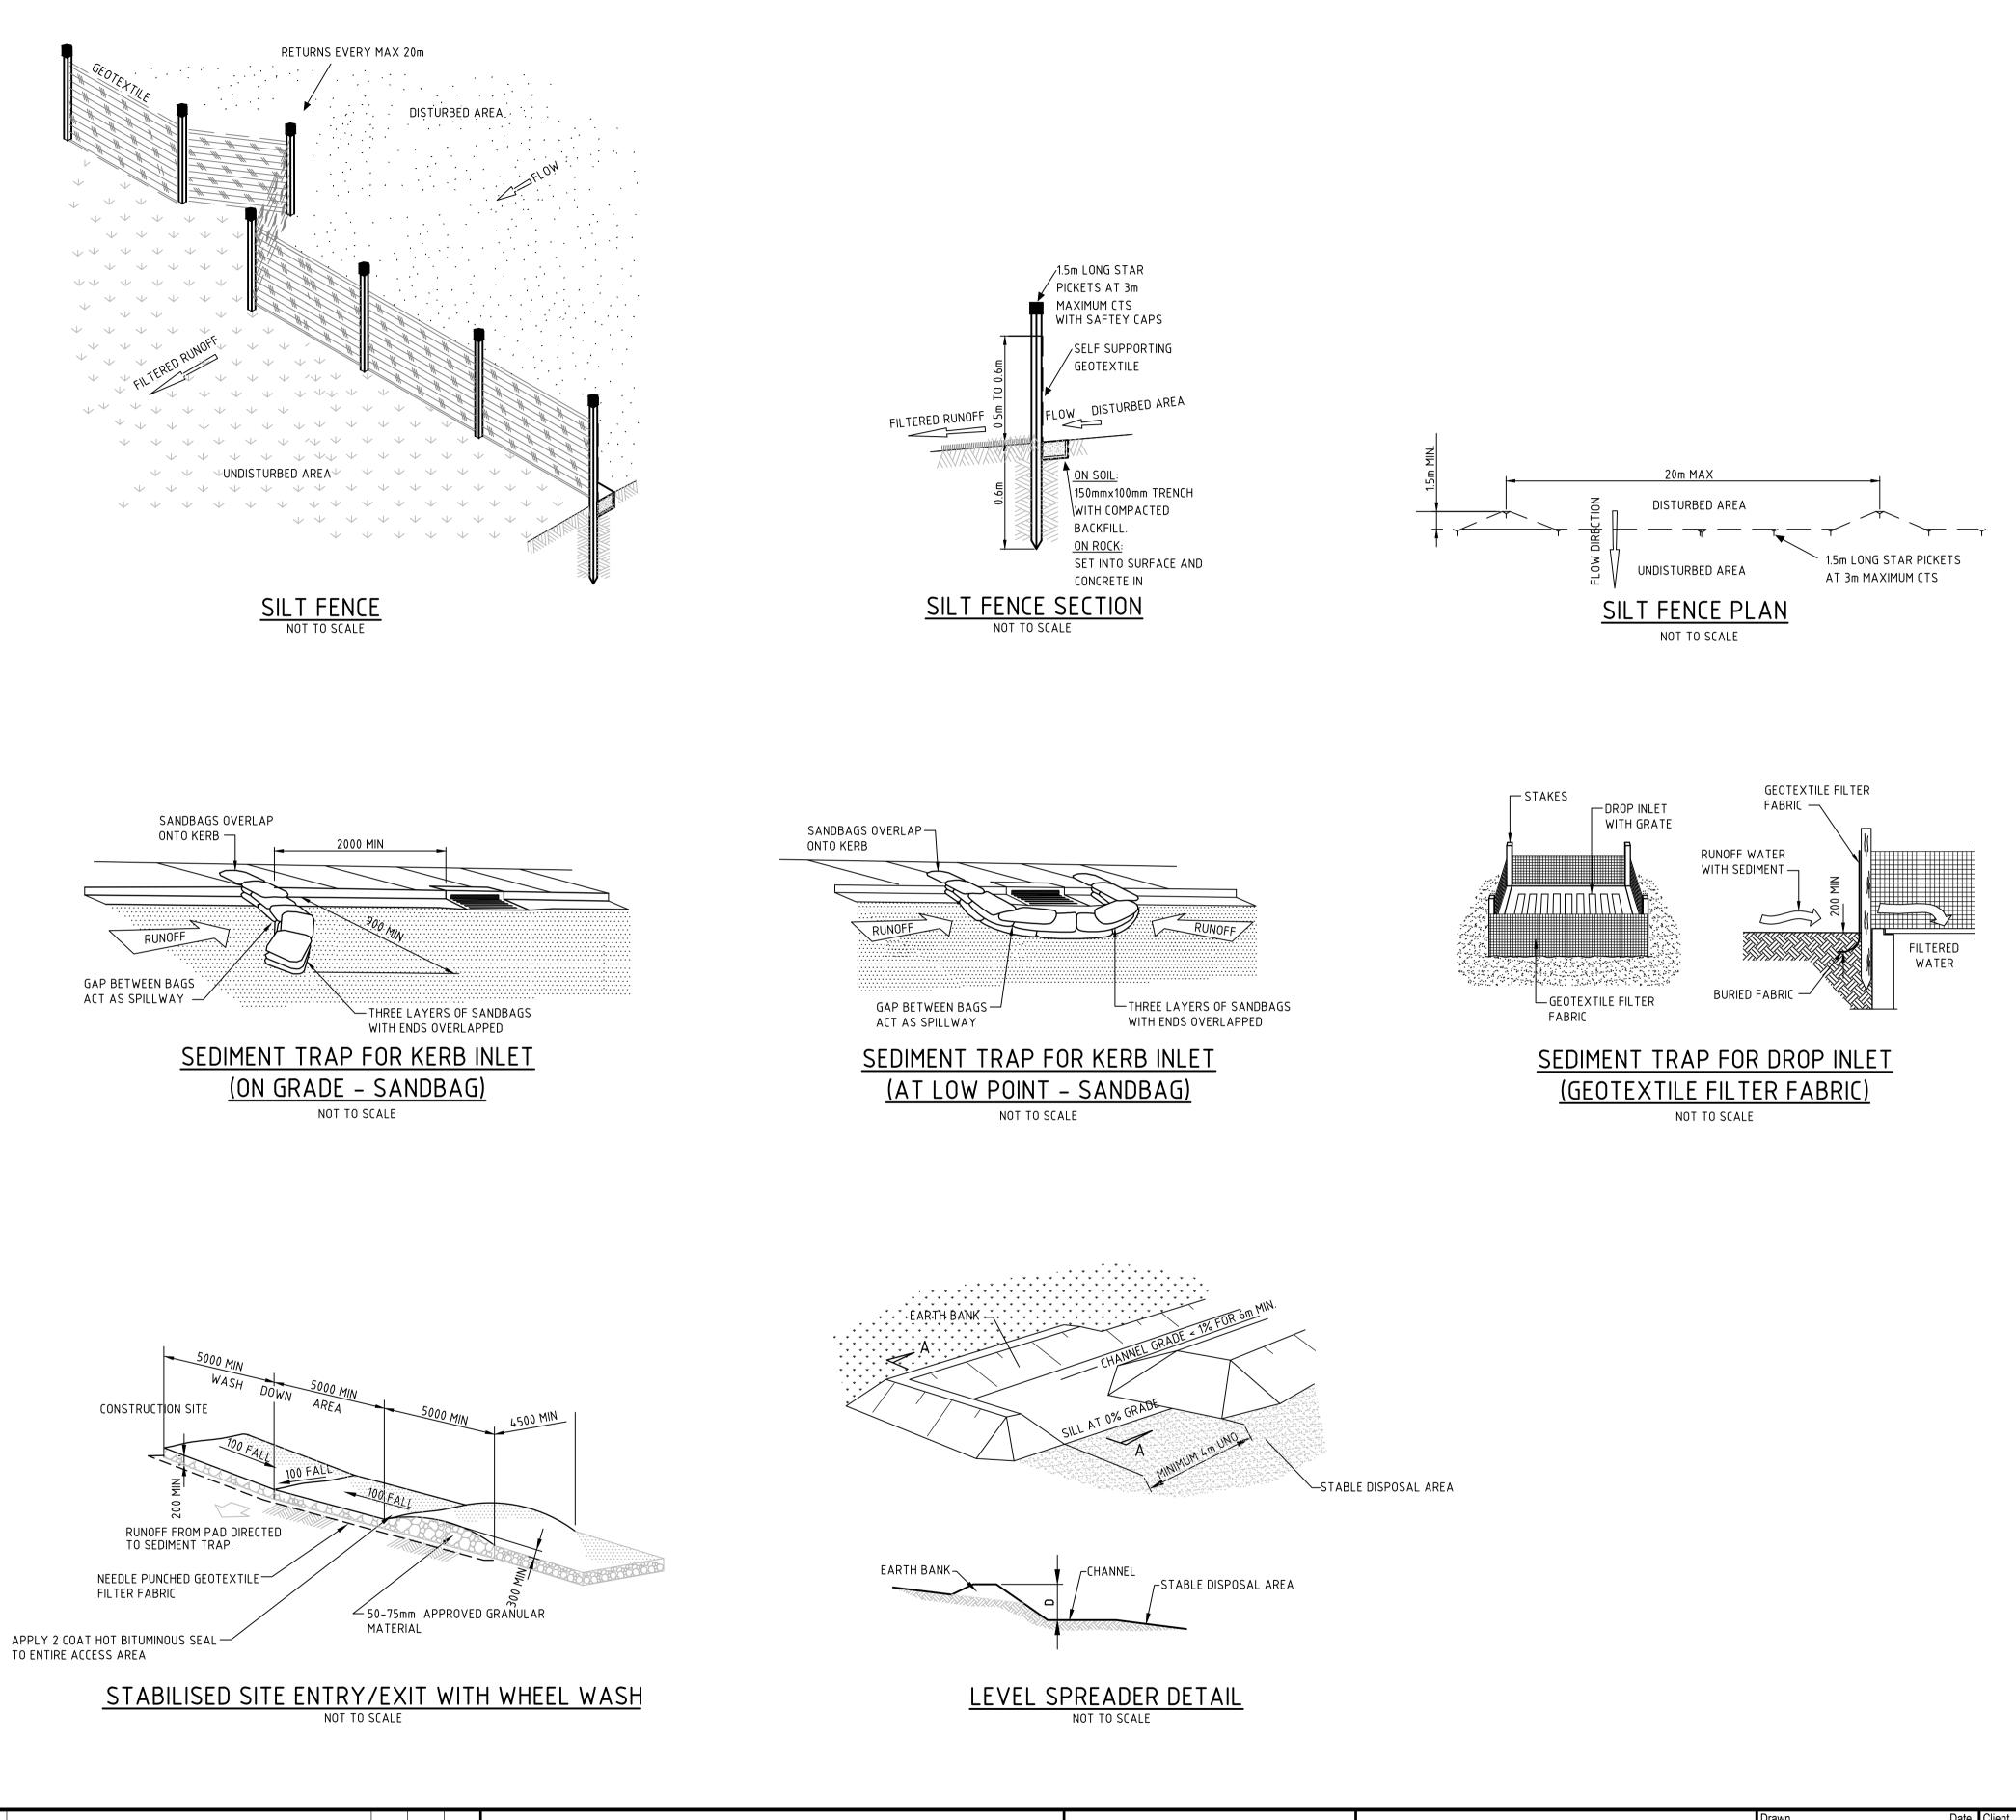

Date 15.09.17 Client LENDLEASE **Cardno**® roject JORDAN SPRINGS EAST FOR APPROVAL

NOT TO BE USED FOR CONSTRUCTION PURPOSES 15.09.17 Date 15.09.17 STAGE 3B2 - CIVIL WORKS DEVELOPMENT APPLICATION Verified Date AHD AS SHOWN A1 Approved Drawing Number EROSION AND SEDIMENTATION CONTROL CV-CARDNO-ST03B2-1131 **DETAILS** 15.09.17

STAPLES ON TOP EDGE —

SEDIMENT FENCE

(GEOTEXTILE FILTER FABRIC & STRAW BALE)

NOT TO SCALE

ALLOW SUFFICIENT

SPILLWAY CAPACITY

TO HOLD CLOTH

1.2m STAR PICKET DRIVEN — 0.6m INTO THE GROUND

☐GRAVEL (OPTIONAL)

DRAINAGE AREA 0.8ha MAX

SPILLWAY AT LEAST 0.15m BELOW SIDES

<u>CHECK DAM – STRAW BALE</u>

HEIGHT 0.6M MAX

DISTURBED

AREA


ANGLE FIRST STAKE TOWARDS

NYLON OR WIRE BINDINGS

UNDISTURBED

AREA

PREVIOUSLY LAID STRAW BALE

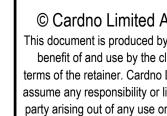

© Cardno Limited All Rights Reserved. This document is produced by Cardno Limited solely for the benefit of and use by the client in accordance with the terms of the retainer. Cardno Limited does not and shall not assume any responsibility or liability whatsoever to any third party arising out of any use or reliance by third party on the content of this document.

Shaping the Future

Cardno (NSW/ACT) Pty Ltd | ABN 95 001 145 035

Level 9, The Forum, 203 Pacific Highway

St. Leonards, NSW 2065

Tel: 02 9496 7700 Fax: 02 9439 5170

Web: www.cardno.com.au

15.09.17

08.09.17

Date


ISSUED FOR DEVELOPMENT APPLICATION APPROVAL

Description

DRAFT - ISSUED FOR INFORMATION


BJD

Des. Verif. Appd.

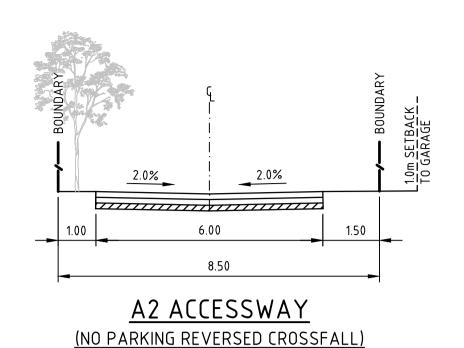


PAVEMENT TYPE 9

SCALE 1:100

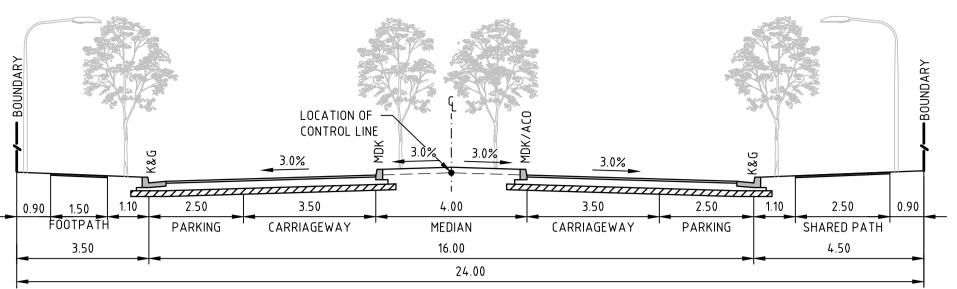



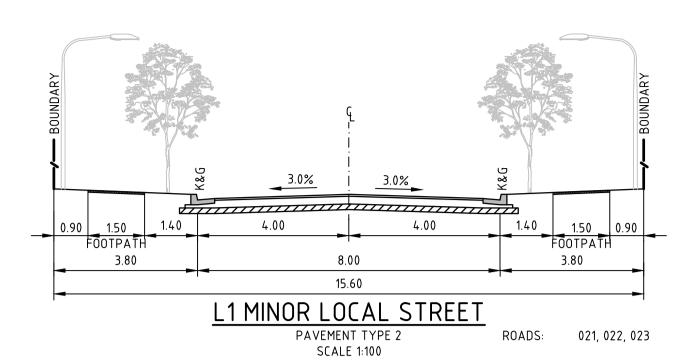


0.90 1.50 2.50 1.40 4.00 4.00 3.80 8.00 4.80 16.60 L2 PEDESTRIAN PRIORITY PAVEMENT TYPE 2 ROADS: 013

SCALE 1:100

Des. Verif. Appd.


LANE:

001, 002

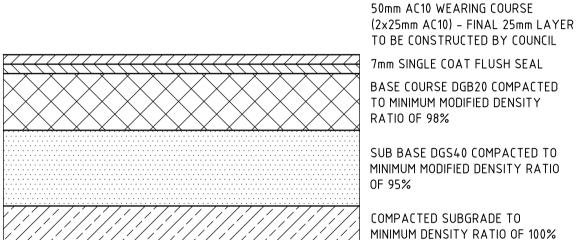

PAVEMENT TYPE 1



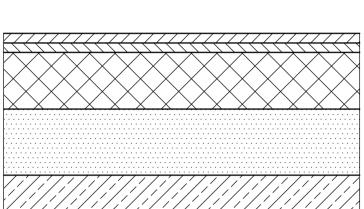

BASE COURSE DGB20 COMPACTED TO MINIMUM MODIFIED DENSITY RATIO OF 98% SUB BASE DGS40 COMPACTED TO MINIMUM MODIFIED DENSITY RATIO OF 95% COMPACTED SUBGRADE TO

50mm AC10 WEARING COURSE

7mm SINGLE COAT FLUSH SEAL


(2x25mm AC10) - FINAL 25mm LAYER TO BE CONSTRUCTED BY COUNCIL


MINIMUM DENSITY RATIO OF 100%

ASSUMED	CBR:	REFER	TABLE	BELOW
ASSUMED	ESA:	5×10 ⁴		

PAVEMENT 2 DESIGN							
DESIGN SUBGRADE CBR 3% CBR 5%							
WEARING SURFACE	50mm AC10	50mm AC10					
SINGLE COAT FLUSH SEAL	7mm	7mm					
BASECOURSE	150mm	150mm					
SUBBASE	275mm	175mm					
TOTAL THICKNESS	475mm	375mm					

PAVEMENT TYPE 2

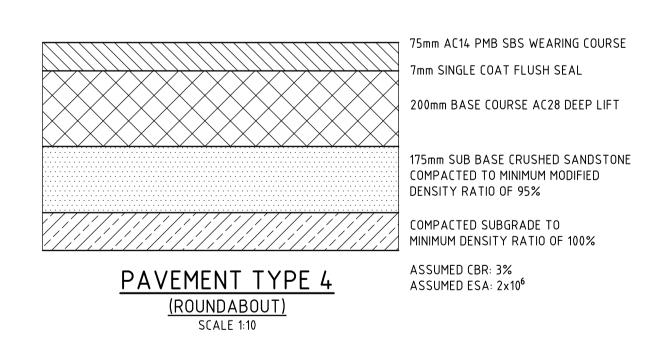

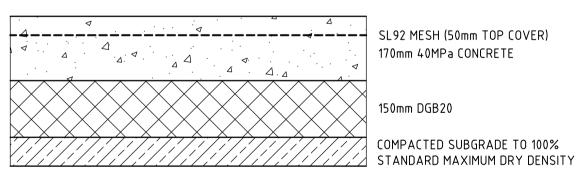

PAVEMENT TYPE 9

(LANEWAY)

SCALE 1:10


ASSUMED CBR: 3%

NOTES

1. SAWCUT PATH OR TROWELLED DUMMY JOINT AT 4m SPACING. EVERY THIRD JOINT TO BE FULL DEPTH

REFER DRAWING 1601 FOR JOINT DETAILS

DOWELLED EXPANSION JOINT.

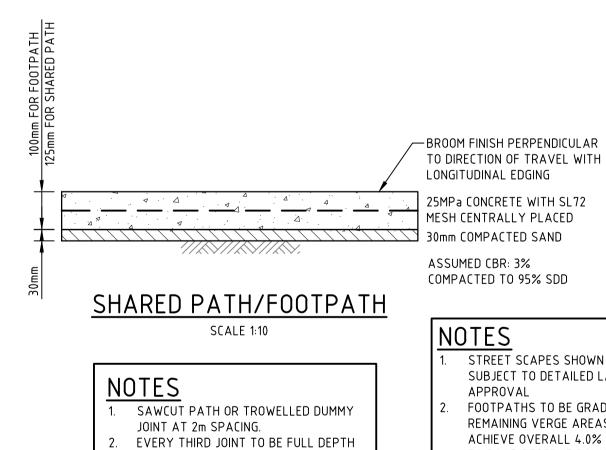


DOWELLED EXPANSION JOINT.

3. REFER DRAWING 1601 FOR JOINT DETAILS.

STREET SCAPES SHOWN ARE INDICATIVE ONLY AND SUBJECT TO DETAILED LANDSCAPING DESIGN AND APPROVAL FOOTPATHS TO BE GRADED AT MAXIMUM 2.5%. REMAINING VERGE AREAS TO BE GRADED TO

ACHIEVE OVERALL 4.0% GRADE FROM TOP OF KERB TO ROAD RESERVE BOUNDARY. CONSTRUCTION OF FOOTPATH AND SHARED PATH TO BE DEFERRED UNTIL DIRECTED BY THE SITE

SUPERINTENDENT. REFER DRAWING 1701 FOR PAVEMENT PLAN.

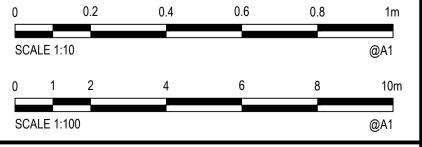

ISSUED FOR DEVELOPMENT APPLICATION APPROVAL BJD 15.09.17 BJD ARM DRAFT - ISSUED FOR INFORMATION 08.09.17

Description



© Cardno Limited All Rights Reserved. This document is produced by Cardno Limited solely for the benefit of and use by the client in accordance with the terms of the retainer. Cardno Limited does not and shall not assume any responsibility or liability whatsoever to any third party arising out of any use or reliance by third party on the content of this document.




Cardno (NSW/ACT) Pty Ltd | ABN 95 001 145 035 Level 9, The Forum, 203 Pacific Highway St. Leonards, NSW 2065 Tel: 02 9496 7700 Fax: 02 9439 5170 Web: www.cardno.com.au


Drawn	Date	Cli
MCD	15.09.17	
Checked	Date	Pro
DAC	15.09.17	' '
Designed	Date	
BJD	15.09.17	
Verified	Date	
		Titl
Approved		
ARM	15.09.17	


LENDLEASE Project JORDAN SPRINGS EAST STAGE 3B2 - CIVIL WORKS DEVELOPMENT APPLICATION TYPICAL ROAD CROSS SECTIONS


FOR APPROVAL NOT TO BE USED FOR CONSTRUCTION PURPOSES AHD AS SHOWN Drawing Number CV-CARDNO-ST03B2-1251

Date

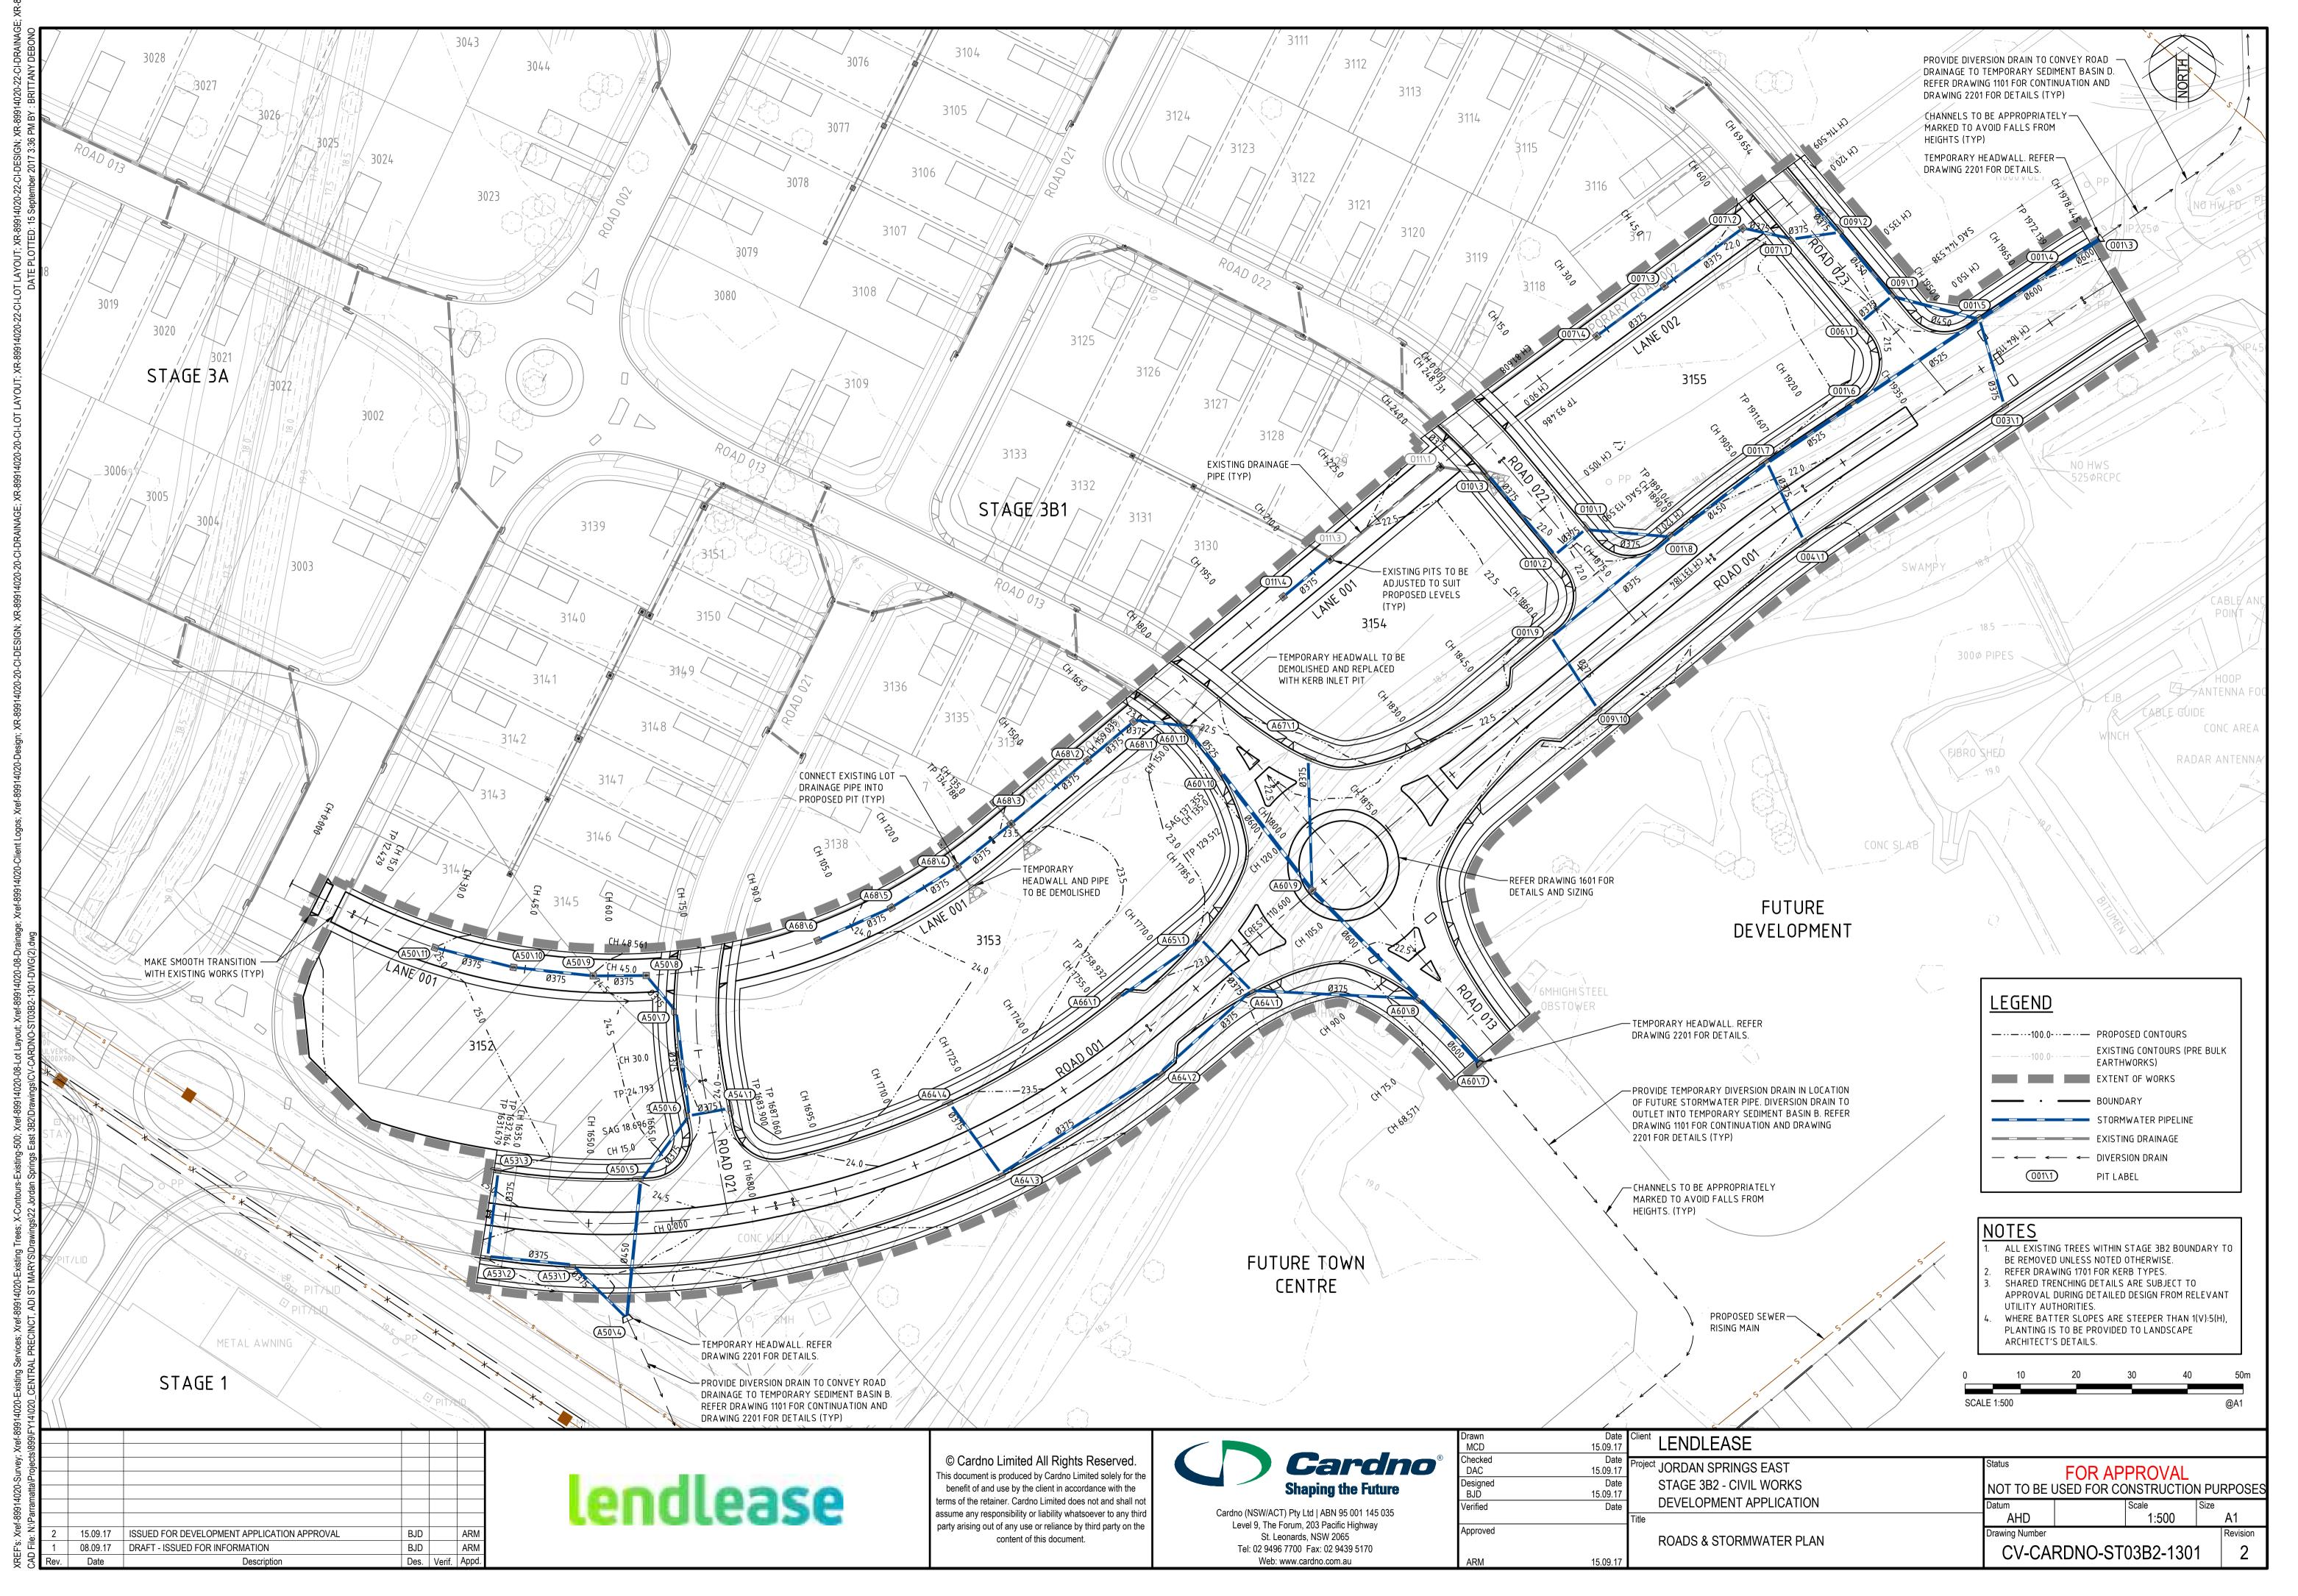

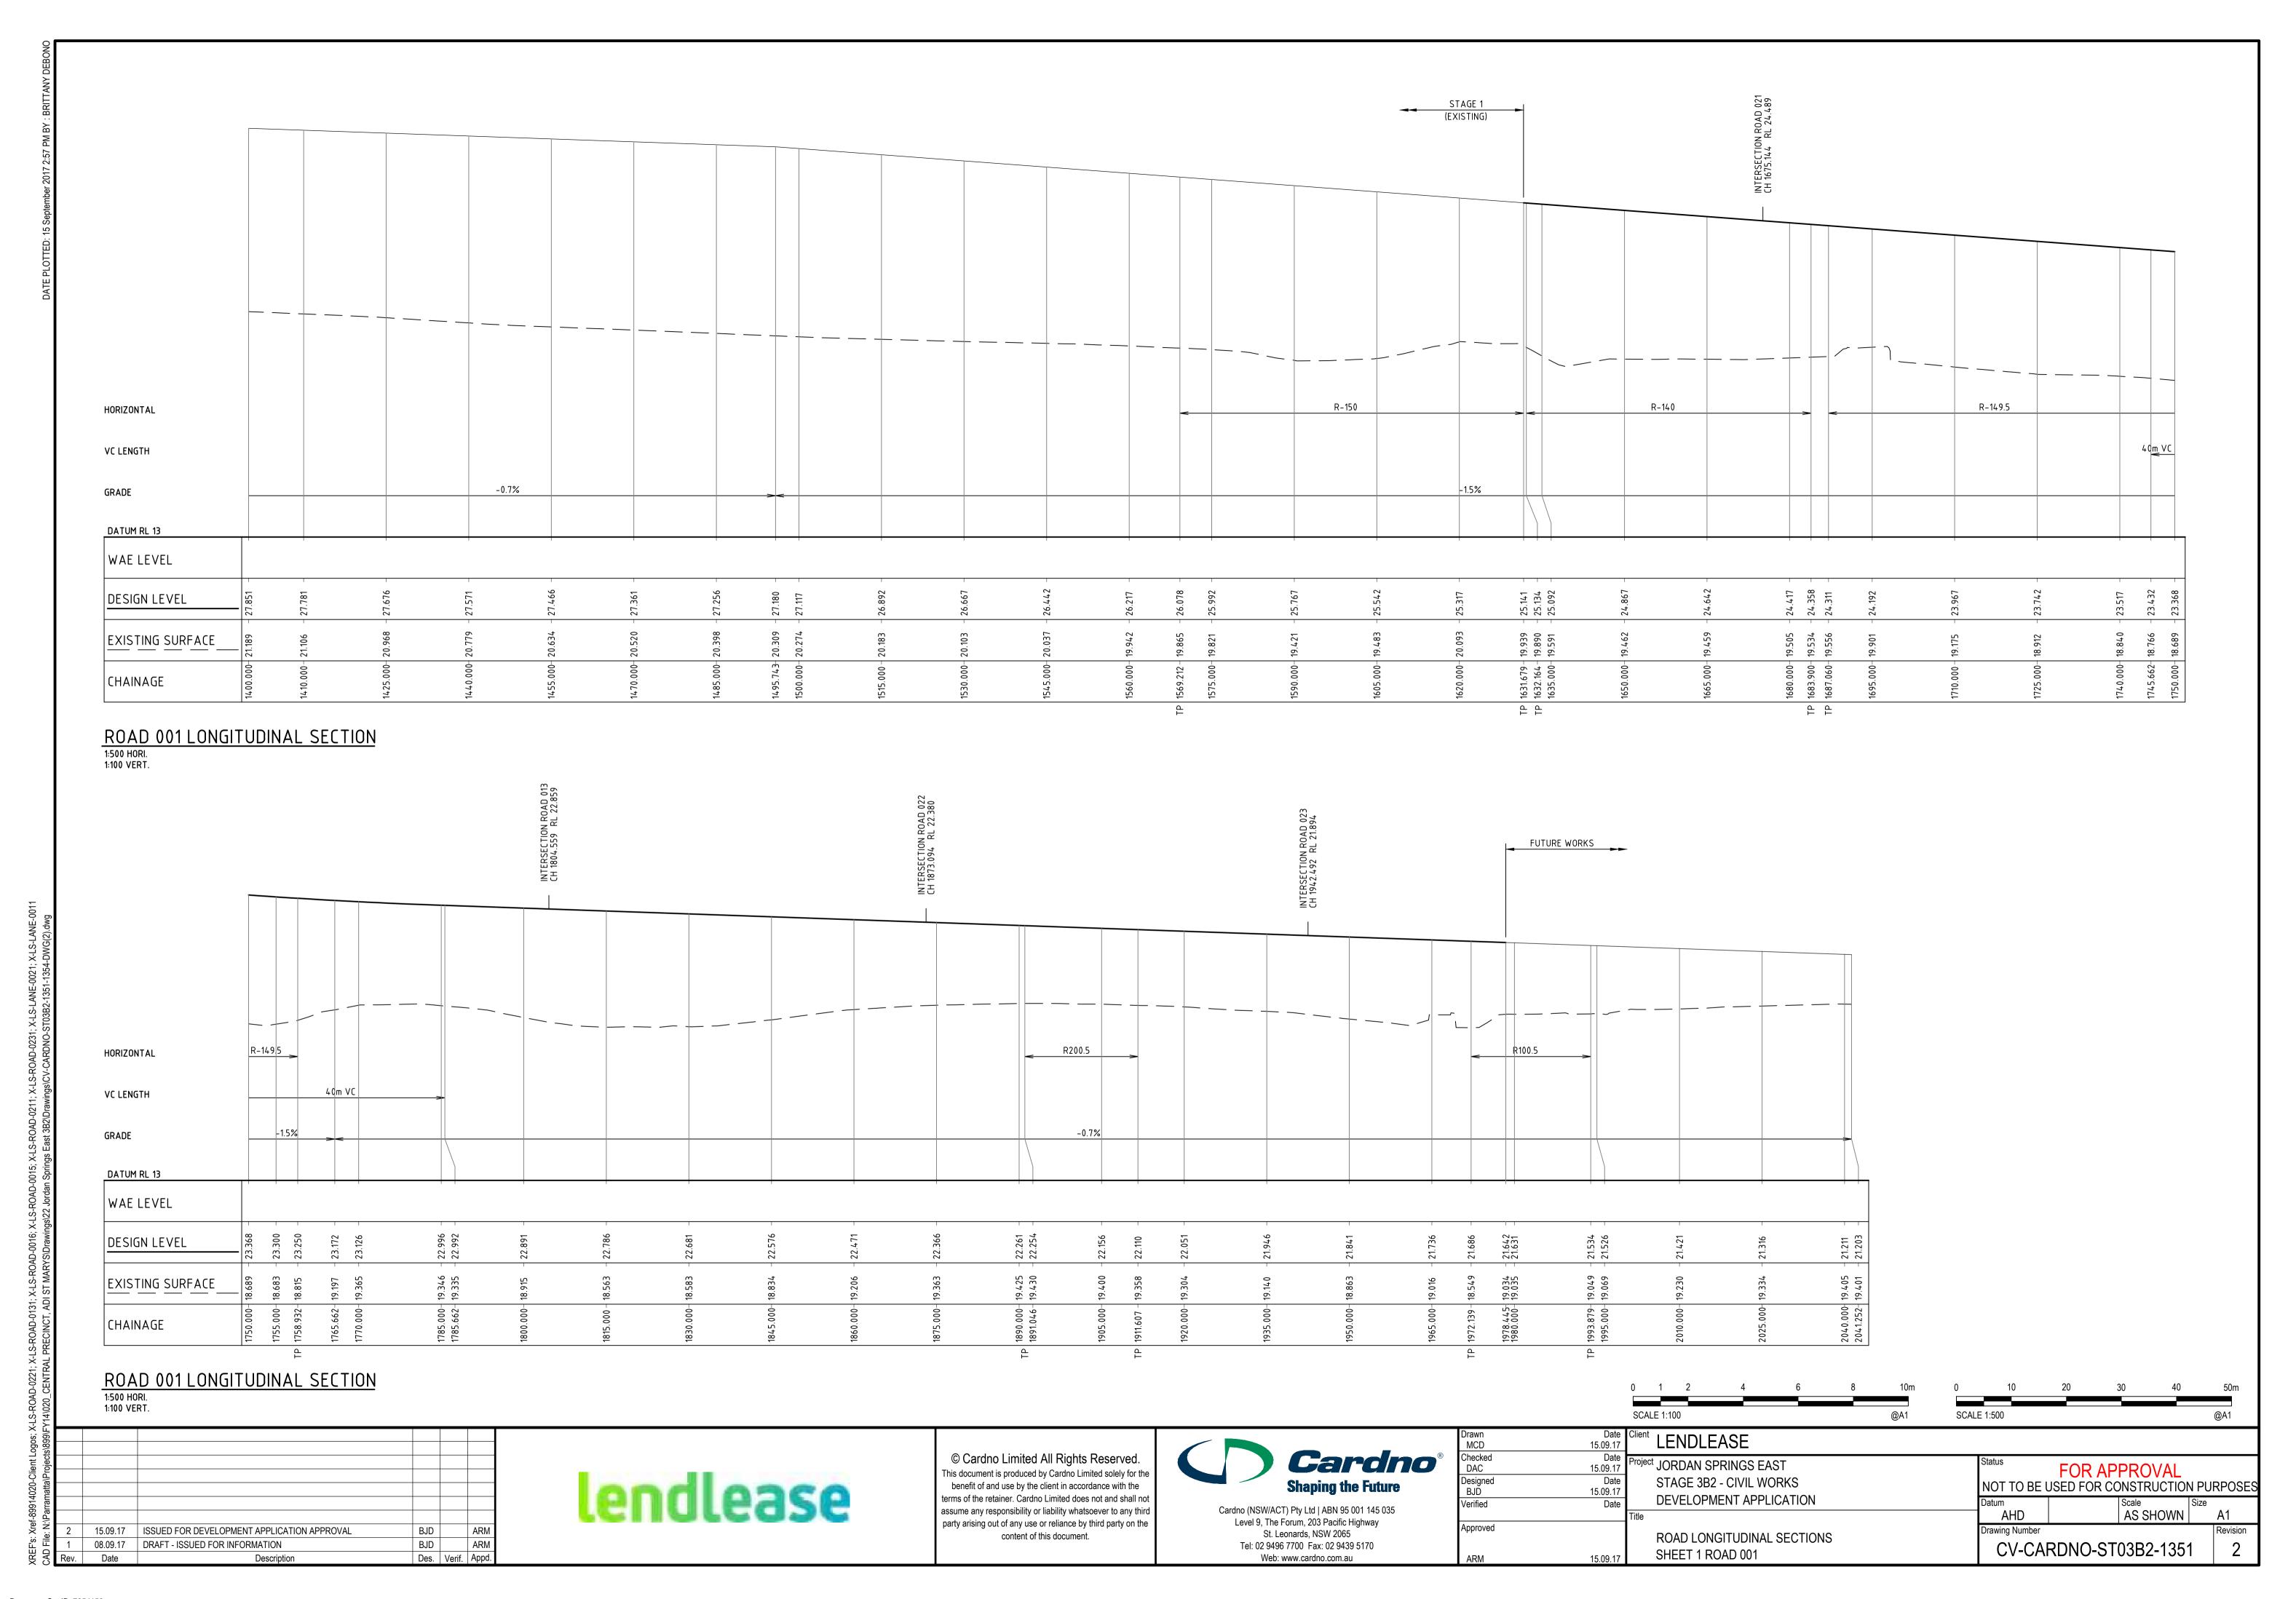


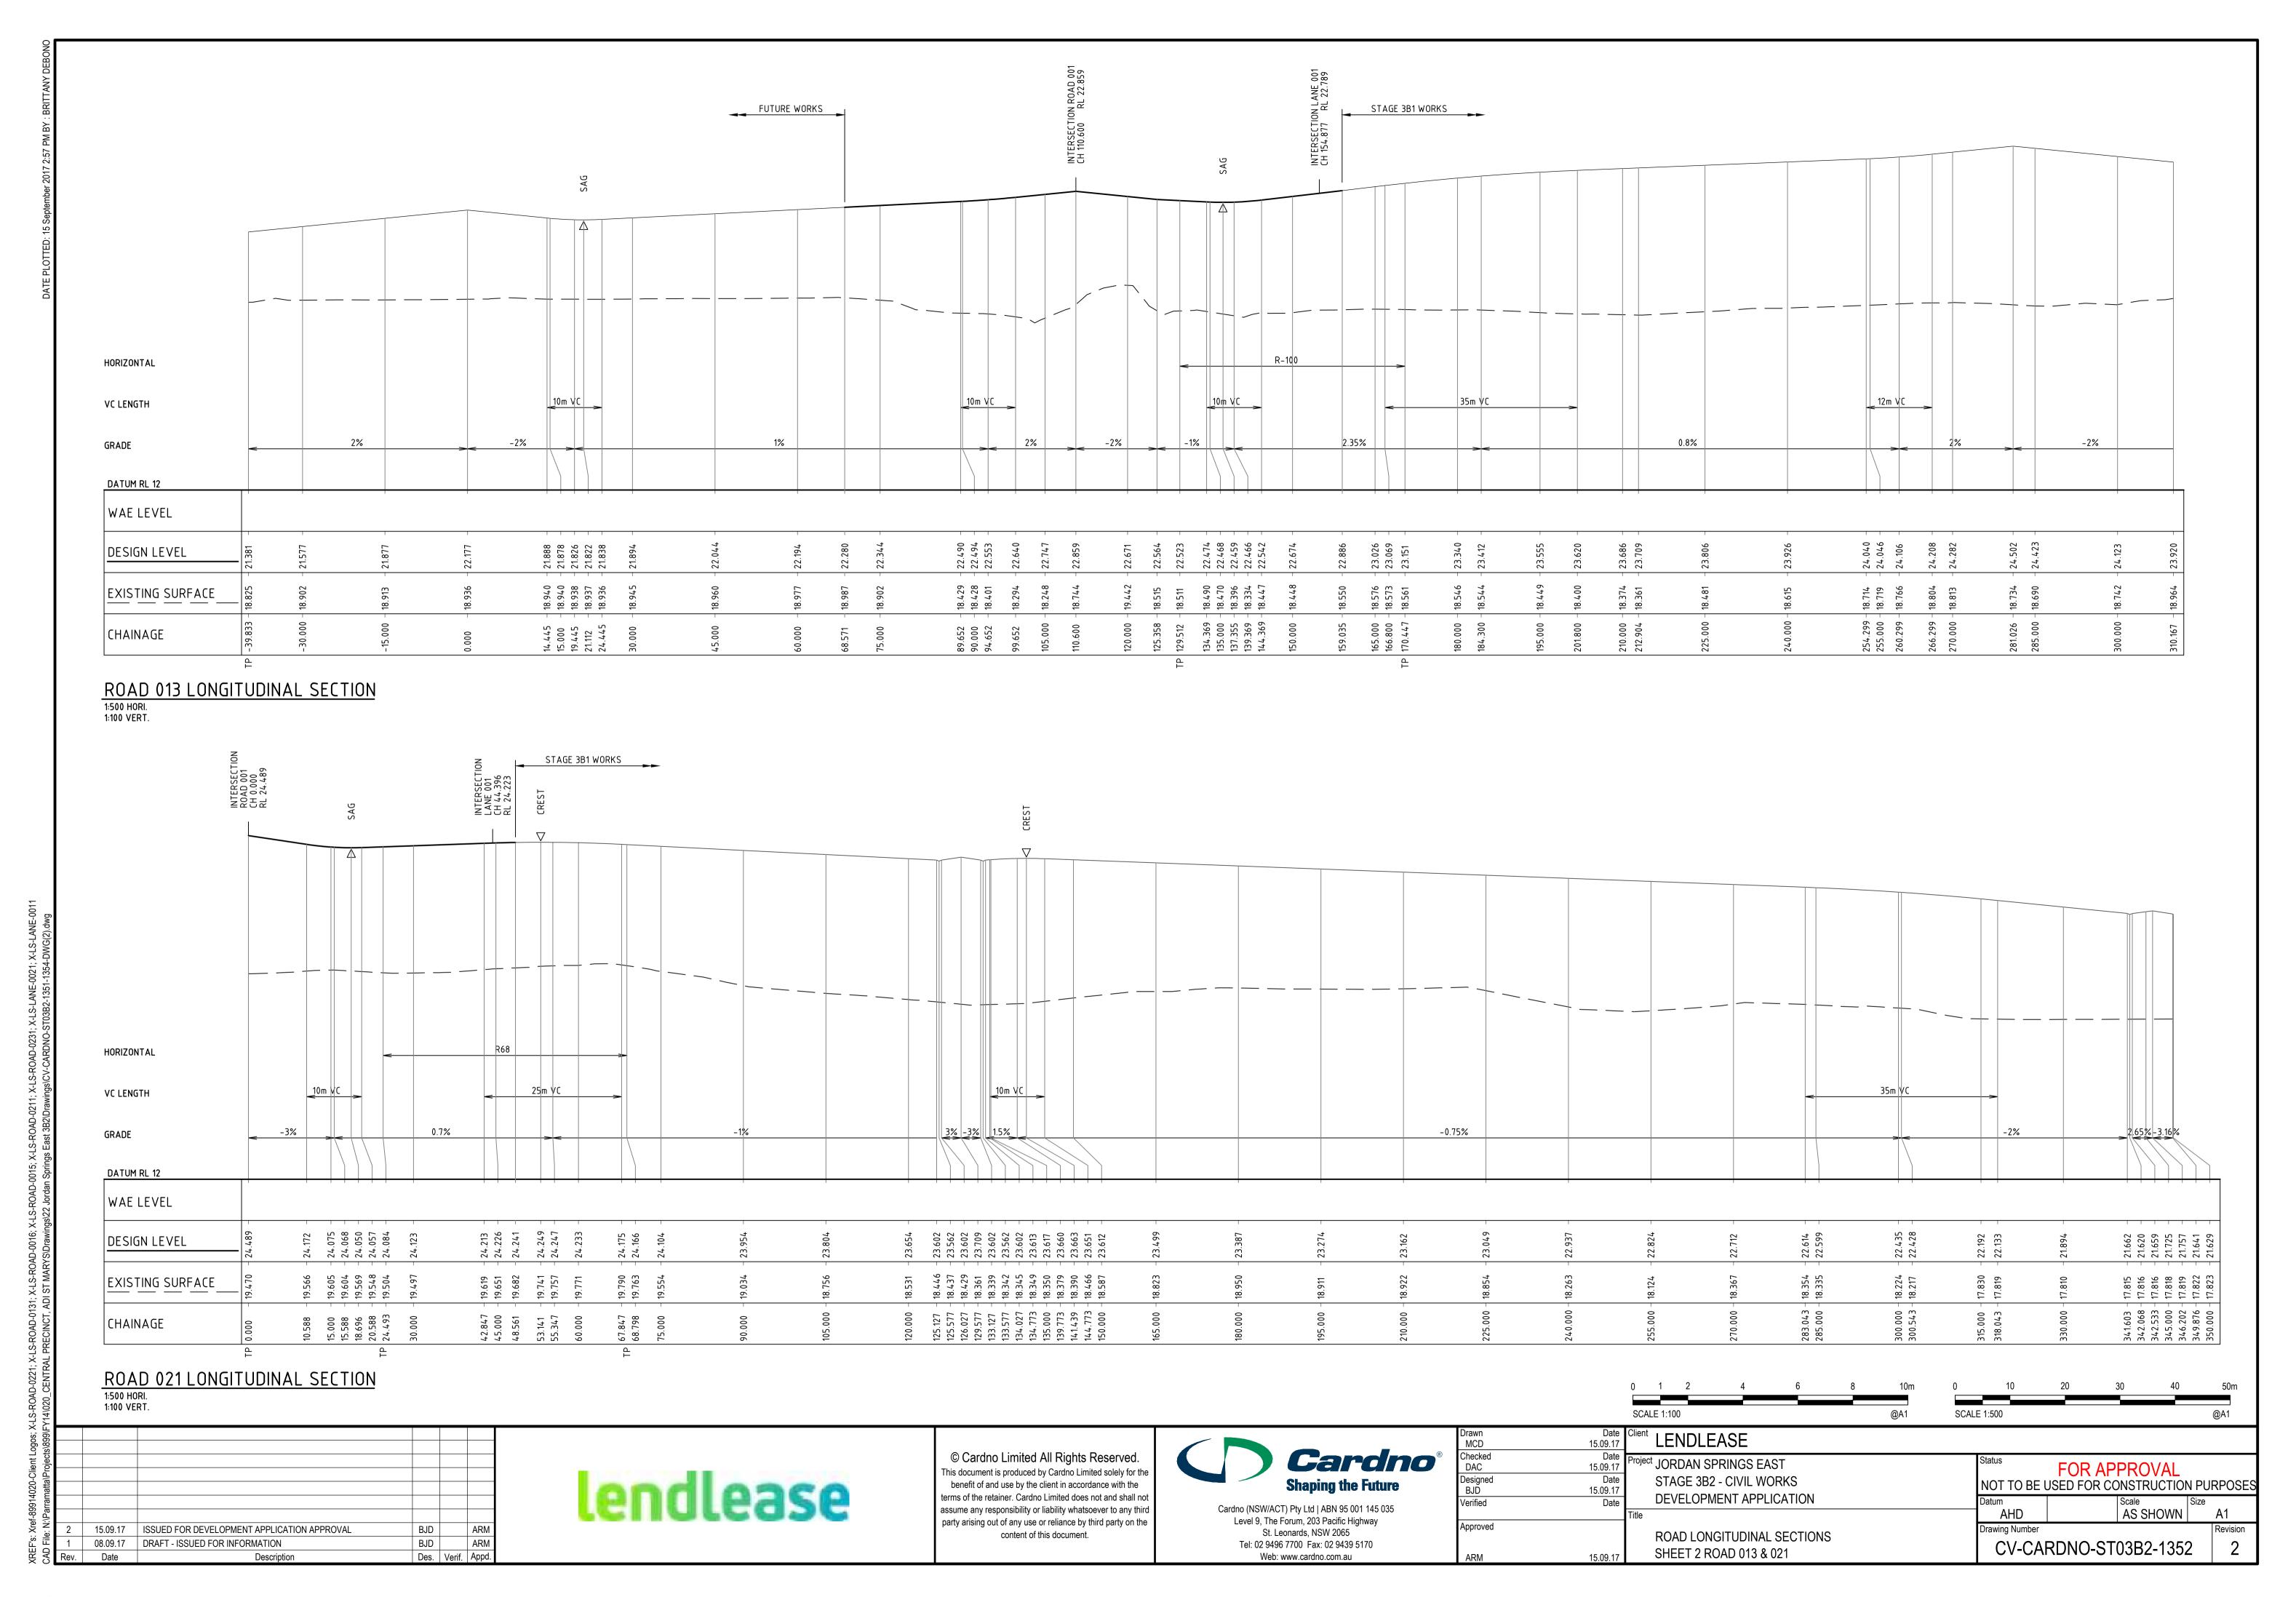

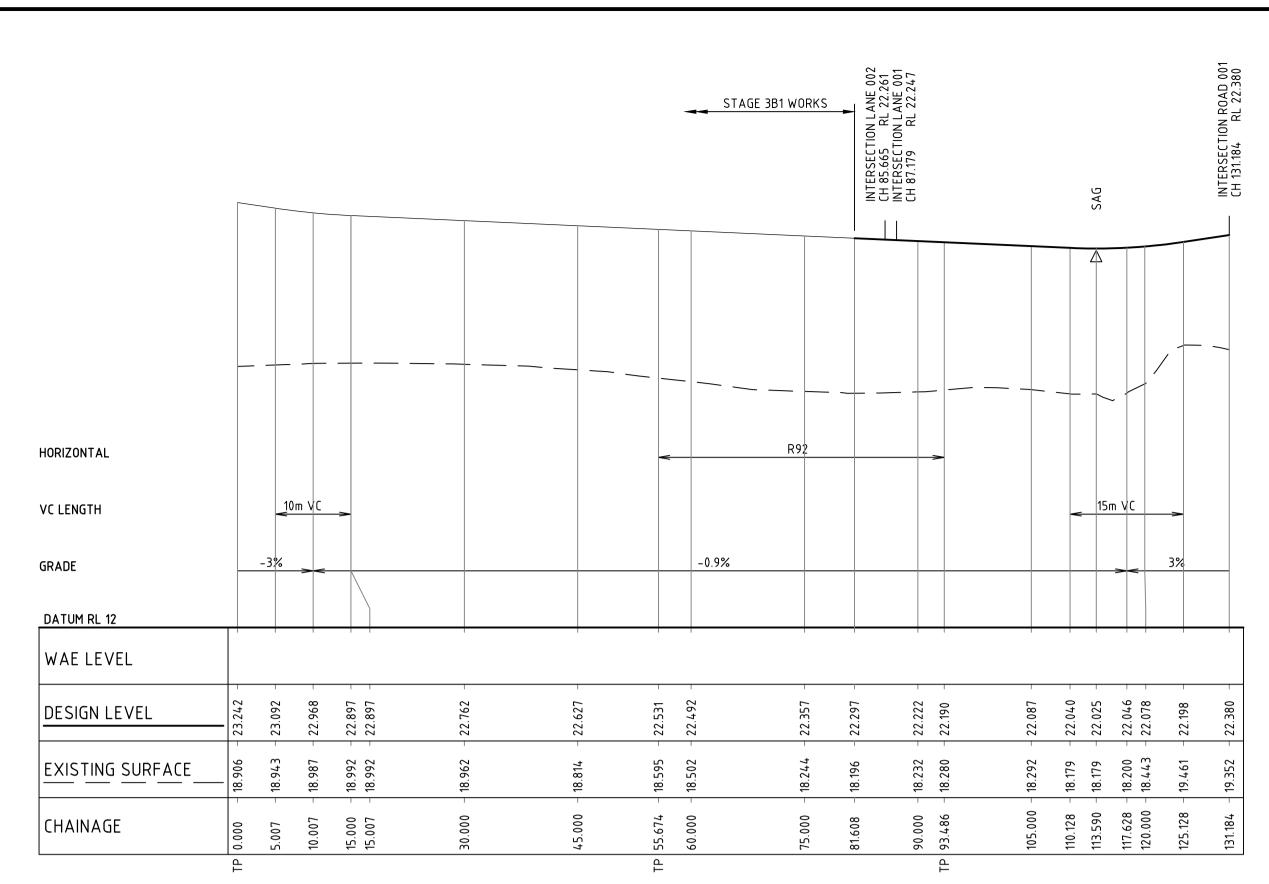

ROAD 022 LONGITUDINAL SECTION

1:500 HORI. 1:100 VERT.

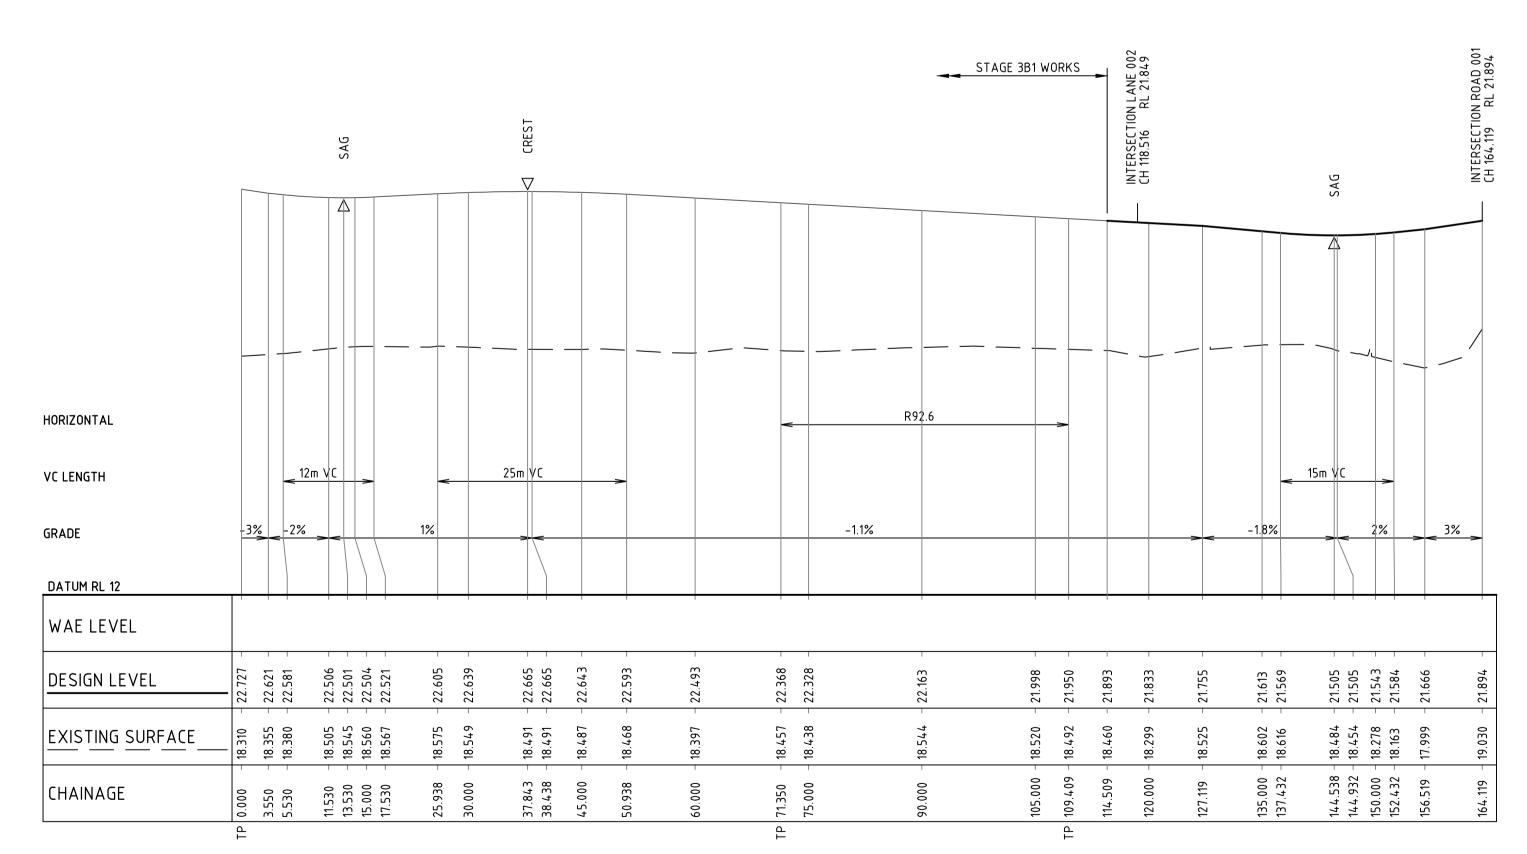

ROAD 023 LONGITUDINAL SECTION

4-DWG(2).dwg								
AKDNO-S103B2-1351-135	HORIZON	ITAL					_	_
rawings\CV-C	VC LENG	тн	12r	π VC	<		25m VC	
gs East 3B2\D	GRADE		-3% -2%	>	1%			\
Sprin.	DATUM	RL 12						
s\22 Jordar	WAE	LEVEL						
YS\Drawing:	DESIG	IN LEVEL	22.727 – 22.621 – 22.581 –	22.506 - 22.501 - 22.504 - 22.521 -	- 22.605 -	- 22.639 -	22.665	22.665
ADI ST MAR	EXIS	TING SURFACE	- 18.310 - - 18.355 - - 18.380 -	18.505 - 18.545 - 18.560 - 18.567 -	- 18.575 -	- 18.549	- 18.491	18.491
RECINCT, A	CHAII	NAGE	0.000 - 3.550 - 5.530 -	11.530 - 13.530 - 15.000 - 17.530 -	25.938 -	- 000.08	ω.	38.438
CAD File: N:\Parramatta\Projects\899\FY14\020_CENTRAL PRECINCT, ADI ST MARYS\Drawings\22 Jordan Springs East 3B2\Drawings\CV-CARDNO-ST03B2-1351-1354-DWG(2).dwg	ROA 1:500 HC 1:100 VE		[≞] TUDINAI	_ SECTIO	<u>N</u>			
s/899/F								
CAD File: N:\Parramatta\Projects\899\FY14\020_CENTRAL PRECINCT, ADI ST MARYS\Drawings\22 Jordan Springs East 3B2\Drawings\CV-CARDNO-ST03B2-1351-1354-DWG(2).dwg 을 느 ਨ								
mati	 		_	_			1 7	ı
I:\Parramat								
File: N:\Parramat	15.09.17 08.09.17	ISSUED FOR DEVELOPM DRAFT - ISSUED FOR INI		ON APPROVAL		BJD BJD		AR

lendlease

© Cardno Limited All Rights Reserved. This document is produced by Cardno Limited solely for the benefit of and use by the client in accordance with the terms of the retainer. Cardno Limited does not and shall not assume any responsibility or liability whatsoever to any third party arising out of any use or reliance by third party on the content of this document.



Cardno (NSW/ACT) Pty Ltd | ABN 95 001 145 035 Level 9, The Forum, 203 Pacific Highway St. Leonards, NSW 2065 Tel: 02 9496 7700 Fax: 02 9439 5170 Web: www.cardno.com.au


Designed BJD

Verified

Approved


	SCALE 1:100	@A1	SCALE 1:500		@A1
15.09.17	Client LENDLEASE				
Date 15.09.17 Date 15.09.17	Project JORDAN SPRINGS EAST STAGE 3B2 - CIVIL WORKS			OR APPROVAL FOR CONSTRUCTION PU	IRPOSES
Date	DEVELOPMENT APPLICATION Title		Datum AHD	Scale Size AS SHOWN	A1
15.09.17	ROAD LONGITUDINAL SECTIONS SHEET 3 ROAD 022 & 023		Drawing Number CV-CARDN	IO-ST03B2-1353	Revision 2

Document Set ID: 7854152 Version: 1, Version Date: 26/09/2017

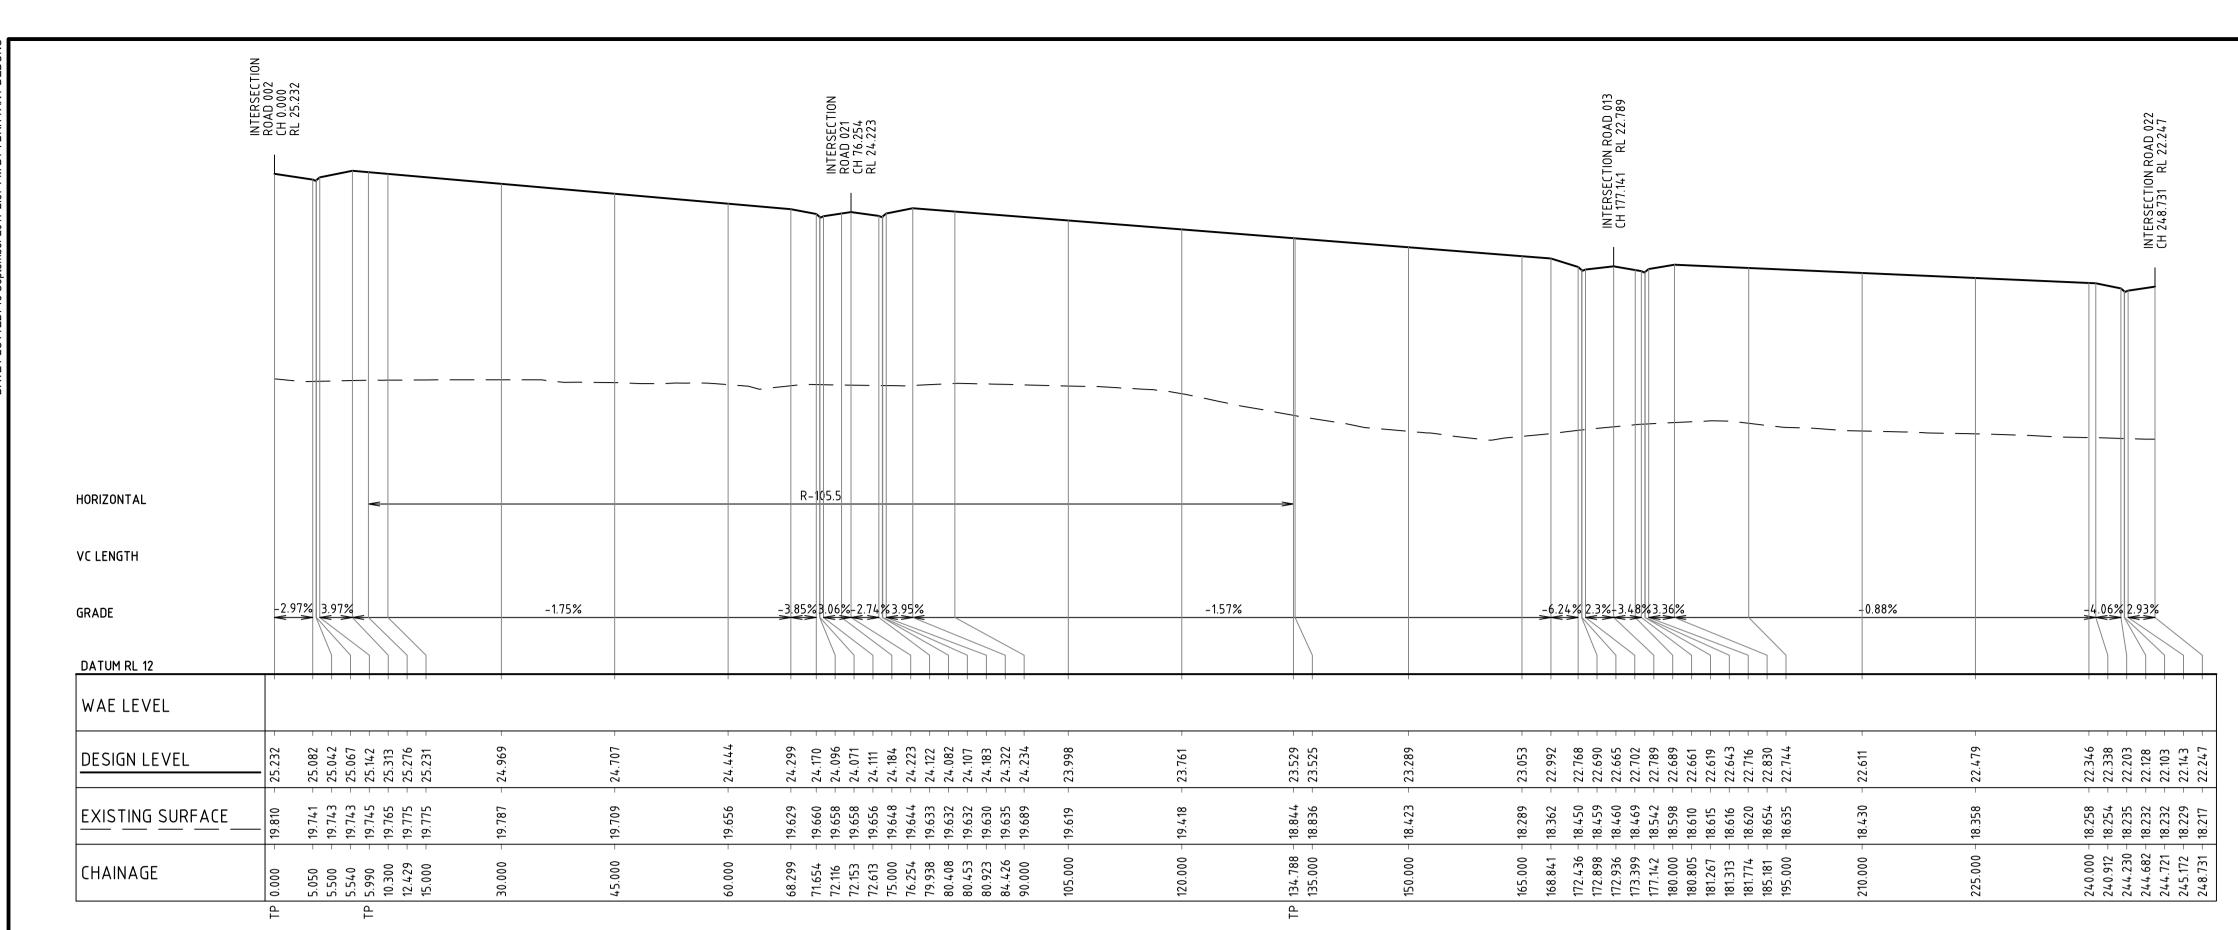

LANE 001 LONGITUDINAL SECTION 1:500 HORI.

1:100 VERT.

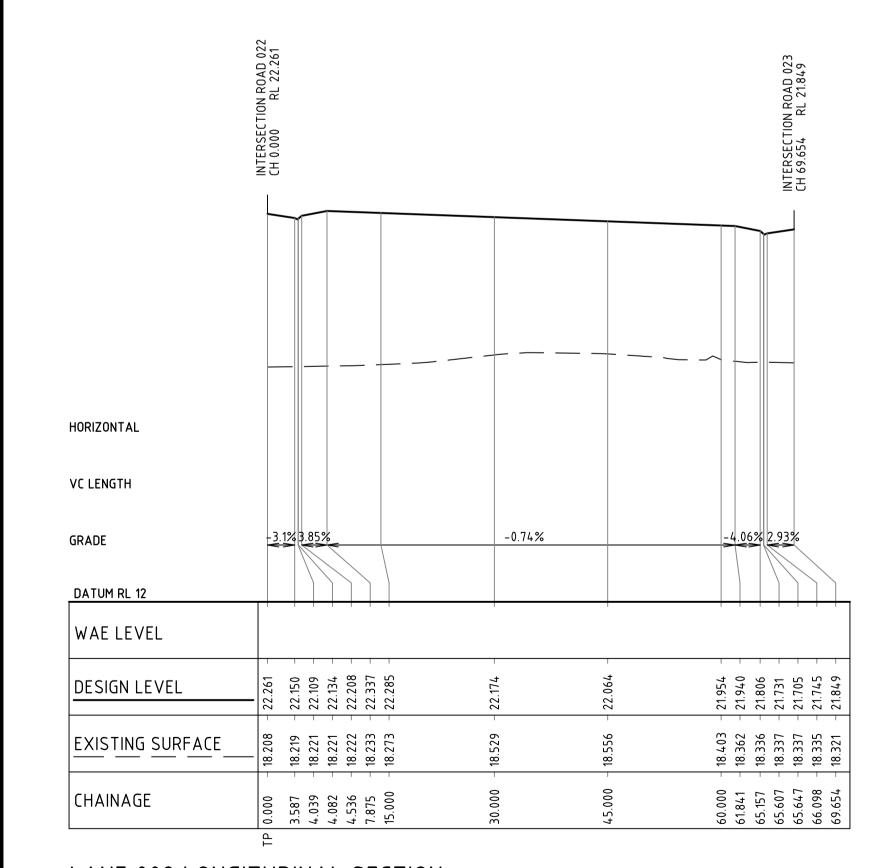

LANE 002 LONGITUDINAL SECTION

1:500 HORI. 1:100 VERT.

2	15.09.17	ISSUED FOR DEVELOPMENT APPLICATION APPROVAL	BJD		ARM	
1	08.09.17	DRAFT - ISSUED FOR INFORMATION	BJD		ARM	
lev.	Date	Description	Des.	Verif.	Appd.	

lendlease

© Cardno Limited All Rights Reserved.


This document is produced by Cardno Limited solely for the benefit of and use by the client in accordance with the terms of the retainer. Cardno Limited does not and shall not assume any responsibility or liability whatsoever to any third party arising out of any use or reliance by third party on the content of this document.



Cardno (NSW/ACT) Pty Ltd | ABN 95 001 145 035 Level 9, The Forum, 203 Pacific Highway St. Leonards, NSW 2065 Tel: 02 9496 7700 Fax: 02 9439 5170 Web: www.cardno.com.au


			SCALE 1:500	@A1
Drawn MCD	15.09.17	Client LENDLEASE		
Checked DAC		Project JORDAN SPRINGS EAST	Status FOR APPF	ROVAL
Designed BJD	Date 15.09.17	STAGE 3B2 - CIVIL WORKS DEVELOPMENT APPLICATION	NOT TO BE USED FOR CONS	
Verified	Date	Title	Datum Sca AHD AS	S SHOWN Size A1
Approved		ROAD LONGITUDINAL SECTIONS	Drawing Number	Revision
ARM	15.09.17	SHEET 4 LANE 001 & 002	CV-CARDNO-ST03	B2-1354 2

Document Set ID: 7854152 Version: 1, Version Date: 26/09/2017

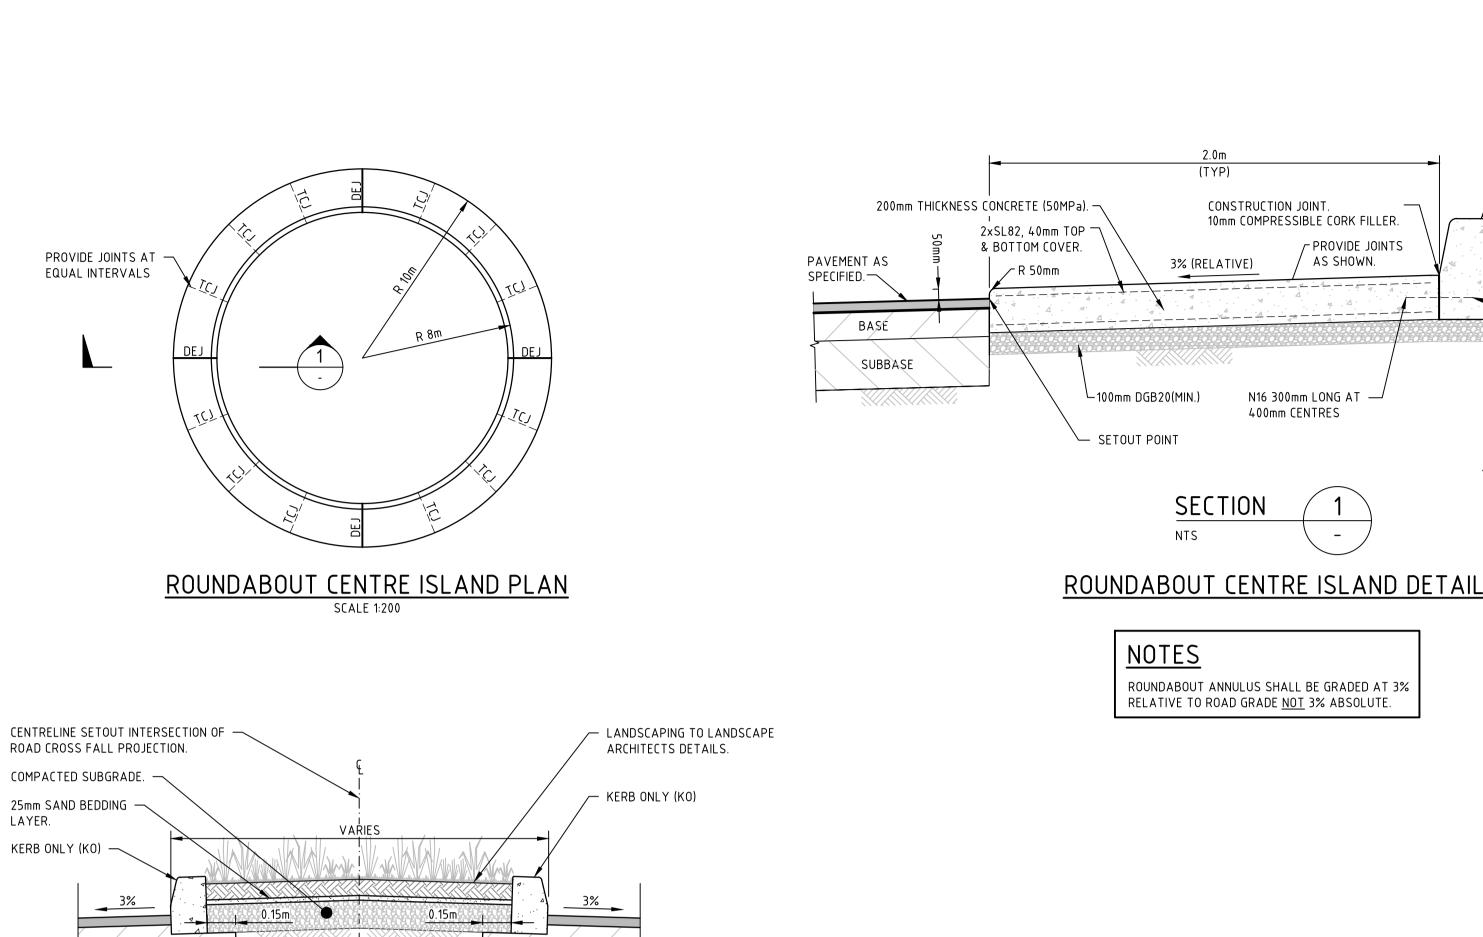

SUBSOIL DRAINAGE DISCHARGE LOCATION CONFIRMED AT

DETAILED DESIGN

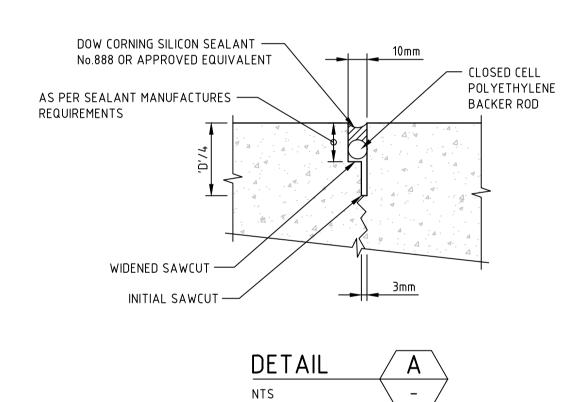

KERB ONLY. REFER PENRITH CITY COUNCIL STANDARD DETAIL SD1003/2.

- LANDSCAPING TO LANDSCAPE ARCHITECTS DETAILS.


DOWEL CAP WITH

EXPANSION SPACE.

DEBOND THIS END

- SUBSOIL DRAINAGE DISCHARGE

LOCATION CONFIRMED AT DETAILED DESIGN

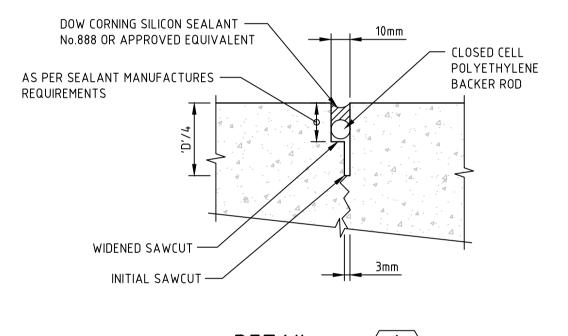


150mm THICKNESS CONCRETE 32MPa.

SL82, 40mm TOP COVER.

BAŞE

SUBBASE

PAVEMENT AS SPECIFIED —

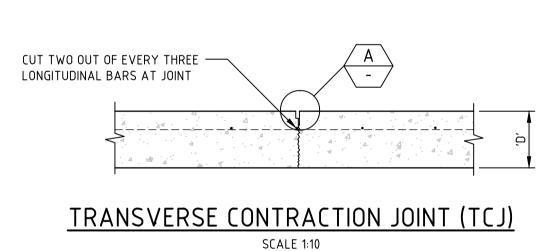

CONSTRUCTION JOINT.

3% (RELATIVE)


10mm COMPRESSIBLE CORK FILLER.

N16 300mm LONG AT —

400mm CENTRES

PROVIDE JOINTS

AS SHOWN.

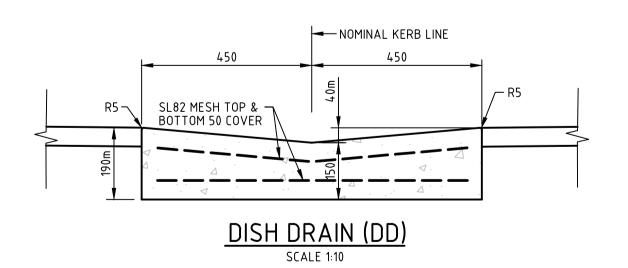

BJD


BJD


Des. Verif. Appd.

ARM

TYPICAL CENTRAL MEDIAN DETAIL

SCALE 1:20

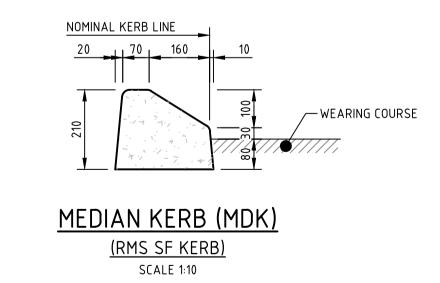

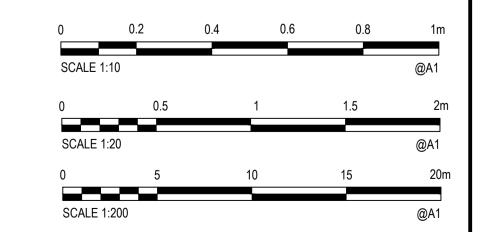

FOR APPROVAL

NOT TO BE USED FOR CONSTRUCTION PURPOSES

CV-CARDNO-ST03B2-1601

AHD

Drawing Number

AS SHOWN A1

— APPROVED SILICON SEALANT

DOWEL CAP WITH EXPANSION SPACE. DEBOND THIS END

__10mm COMPRESSIBLE CORK FILLER (TYP.)

– MEDIAN KERB (TYP.)

BASE

SUBBASE

DOWELED EXPANSION JOINT (DEJ)

SCALE 1:10

└ 60mm DGB20.

10mm PREFORMED JOINT FILLER —

GALVANISED R20 600mm —

LONG AT 300mm CENTRES

TYPICAL ROUNDABOUT SPLITTER ISLAND DETAIL

le	n	d	Į	e	8	S	6

© Cardno Limited All Rights Reserved.
This document is produced by Cardno Limited solely for the
benefit of and use by the client in accordance with the
terms of the retainer. Cardno Limited does not and shall not
assume any responsibility or liability whatsoever to any third
party arising out of any use or reliance by third party on the
content of this document.



) Garan
Shaping the Future
Cardno (NSW/ACT) Pty Ltd ABN 95 001 145 035
Level 9, The Forum, 203 Pacific Highway
St. Leonards, NSW 2065
Tel: 02 9496 7700 Fax: 02 9439 5170

	Cardno Shaping the Future
Car	dno (NSW/ACT) Pty Ltd ABN 95 001 145 035 Level 9, The Forum, 203 Pacific Highway

ture	
5 035	١
y	A
	ı

ire	De B
)35	Vei
	Ар
	l A

oproved

Date 15.09.17 MCD 15.09.17 Date 15.09.17 Date 15.09.17

Client LENDLEASE

SHEET 1

Project JORDAN SPRINGS EAST

SITEWORKS DETAILS

STAGE 3B2 - CIVIL WORKS


DEVELOPMENT APPLICATION

Checked DAC

Web: www.cardno.com.au

ISSUED FOR DEVELOPMENT APPLICATION APPROVAL 15.09.17 DRAFT - ISSUED FOR INFORMATION 08.09.17 Date


Description

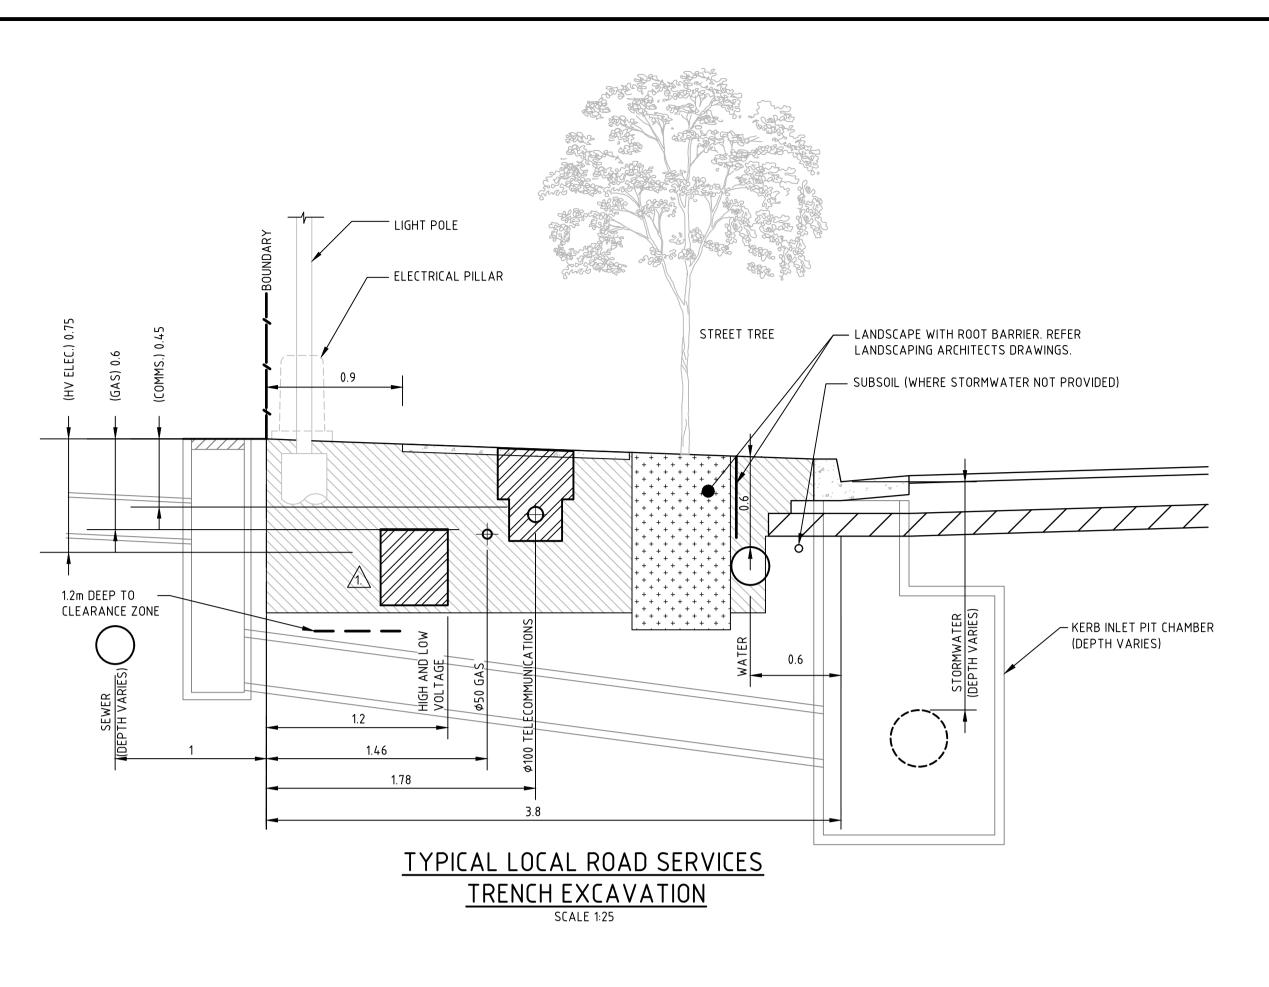


INTERALLOTMENT — LANDSCAPE WITH ROOT BARRIER. REFER STREET TREE LANDSCAPING ARCHITECTS DRAWINGS. - SUBSOIL (WHERE STORMWATER NOT PROVIDED) FINISHED GROUND LEVEL 1.2m DEEP TO CLEARANCE ZONE – KERB INLET PIT CHAMBER (DEPTH VARIES) -INTERALLOTMENT RETURN PIPE 3.8-4.8 TYPICAL COLLECTOR ROAD SERVICES TRENCH EXCAVATION

KERB (LIP) KERB (BACK) COMMUNICATIONS PIT TO BE LOCATED CENTRAL TO — LOT BOUNDARY. IN ADDITION, ALL COMMUNICATION PITS TO BE LOCATED WHOLLY WITHIN OR OUTSIDE THE PROPOSED FOOTPATH. ENDEAVOUR ENERGY PILLAR — TO BE LOCATED CENTRAL TO LOT BOUNDARY. BOUNDARY LOT A LOT B 0.90 0.80 LIGHT COLUMN TO BE— (MIN) LOCATED 1.0m FROM 1.00 LOT BOUNDARY

> TYPICAL SURFACE UTILITY LAYOUT (LIGHT COLUMN <u>AND</u> ELECTRICAL PILLAR)

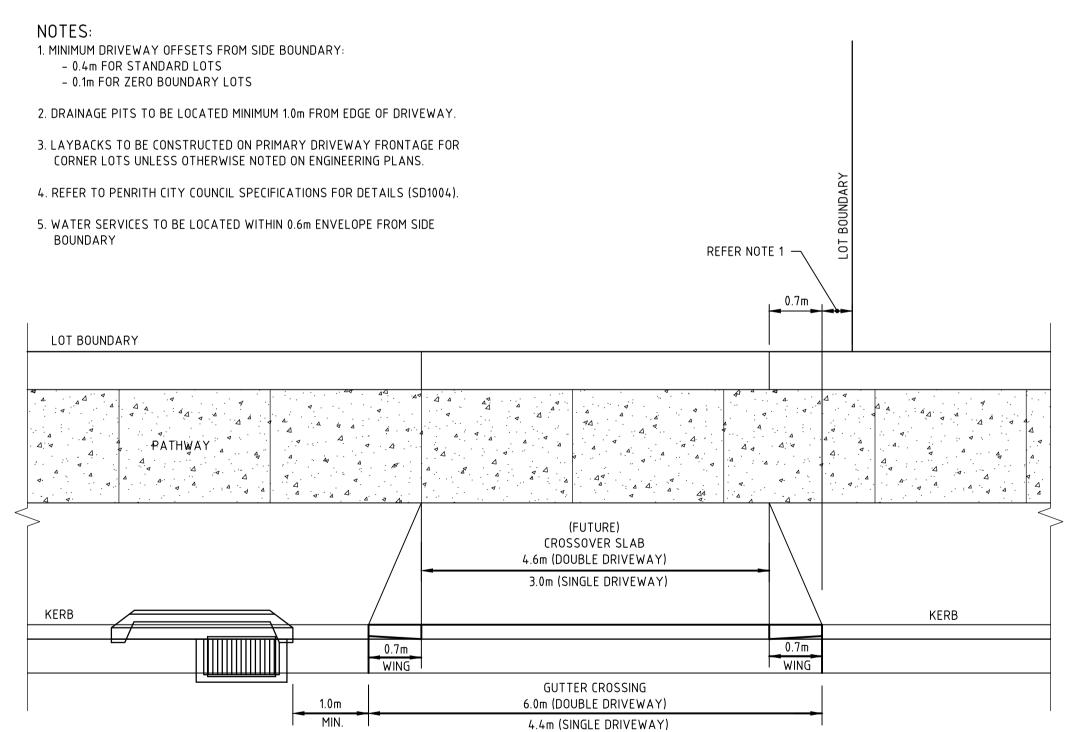

TYPICAL VEHICULAR CROSSING LOCATION DETAIL (VC)

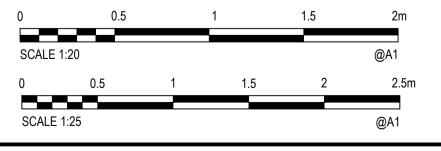

ISSUED FOR DEVELOPMENT APPLICATION APPROVAL BJD 15.09.17 DRAFT - ISSUED FOR INFORMATION BJD ARM 08.09.17 Date Description Des. Verif. Appd.

lendlease

© Cardno Limited All Rights Reserved. This document is produced by Cardno Limited solely for the benefit of and use by the client in accordance with the terms of the retainer. Cardno Limited does not and shall not assume any responsibility or liability whatsoever to any third party arising out of any use or reliance by third party on the content of this document.

<u>NOTE</u>

WHERE STORMWATER ENLIQUED INTO LELECTION CLEARANCE ZONE, COVER MAY BE REDUCED FROM WHERE STORMWATER ENCROACHES INTO ELECTRICAL

SUPERINTENDENT IS TO APPROVE CONCRETE

SPECIFIED ON CERTIFIED ELECTRICAL DRAWINGS.


750mm TO 500mm AND CONDUITS CONCRETE ENCASED.


ENCASEMENT PRIOR TO WORKS COMMENCING UNLESS





Cardno (NSW/ACT) Pty Ltd | ABN 95 001 145 035 Level 9, The Forum, 203 Pacific Highway St. Leonards, NSW 2065 Tel: 02 9496 7700 Fax: 02 9439 5170 Web: www.cardno.com.au


			SCALE 1:25	@A1
Drawn MCD	Date 15.09.17	Client LENDLEASE		
Checked DAC	Date 15.09.17	Project JORDAN SPRINGS EAST	Status FOR APP	ROVAL
Designed BJD	Date 15.09.17	STAGE 3B2 - CIVIL WORKS	NOT TO BE USED FOR CON	
Verified	Date	DEVELOPMENT APPLICATION Title	=	cale Size AS SHOWN A1
Approved		SITEWORKS DETAILS	Drawing Number	Revision
ARM	15.09.17	SHEET 2	CV-CARDNO-ST0	3B2-1602 2

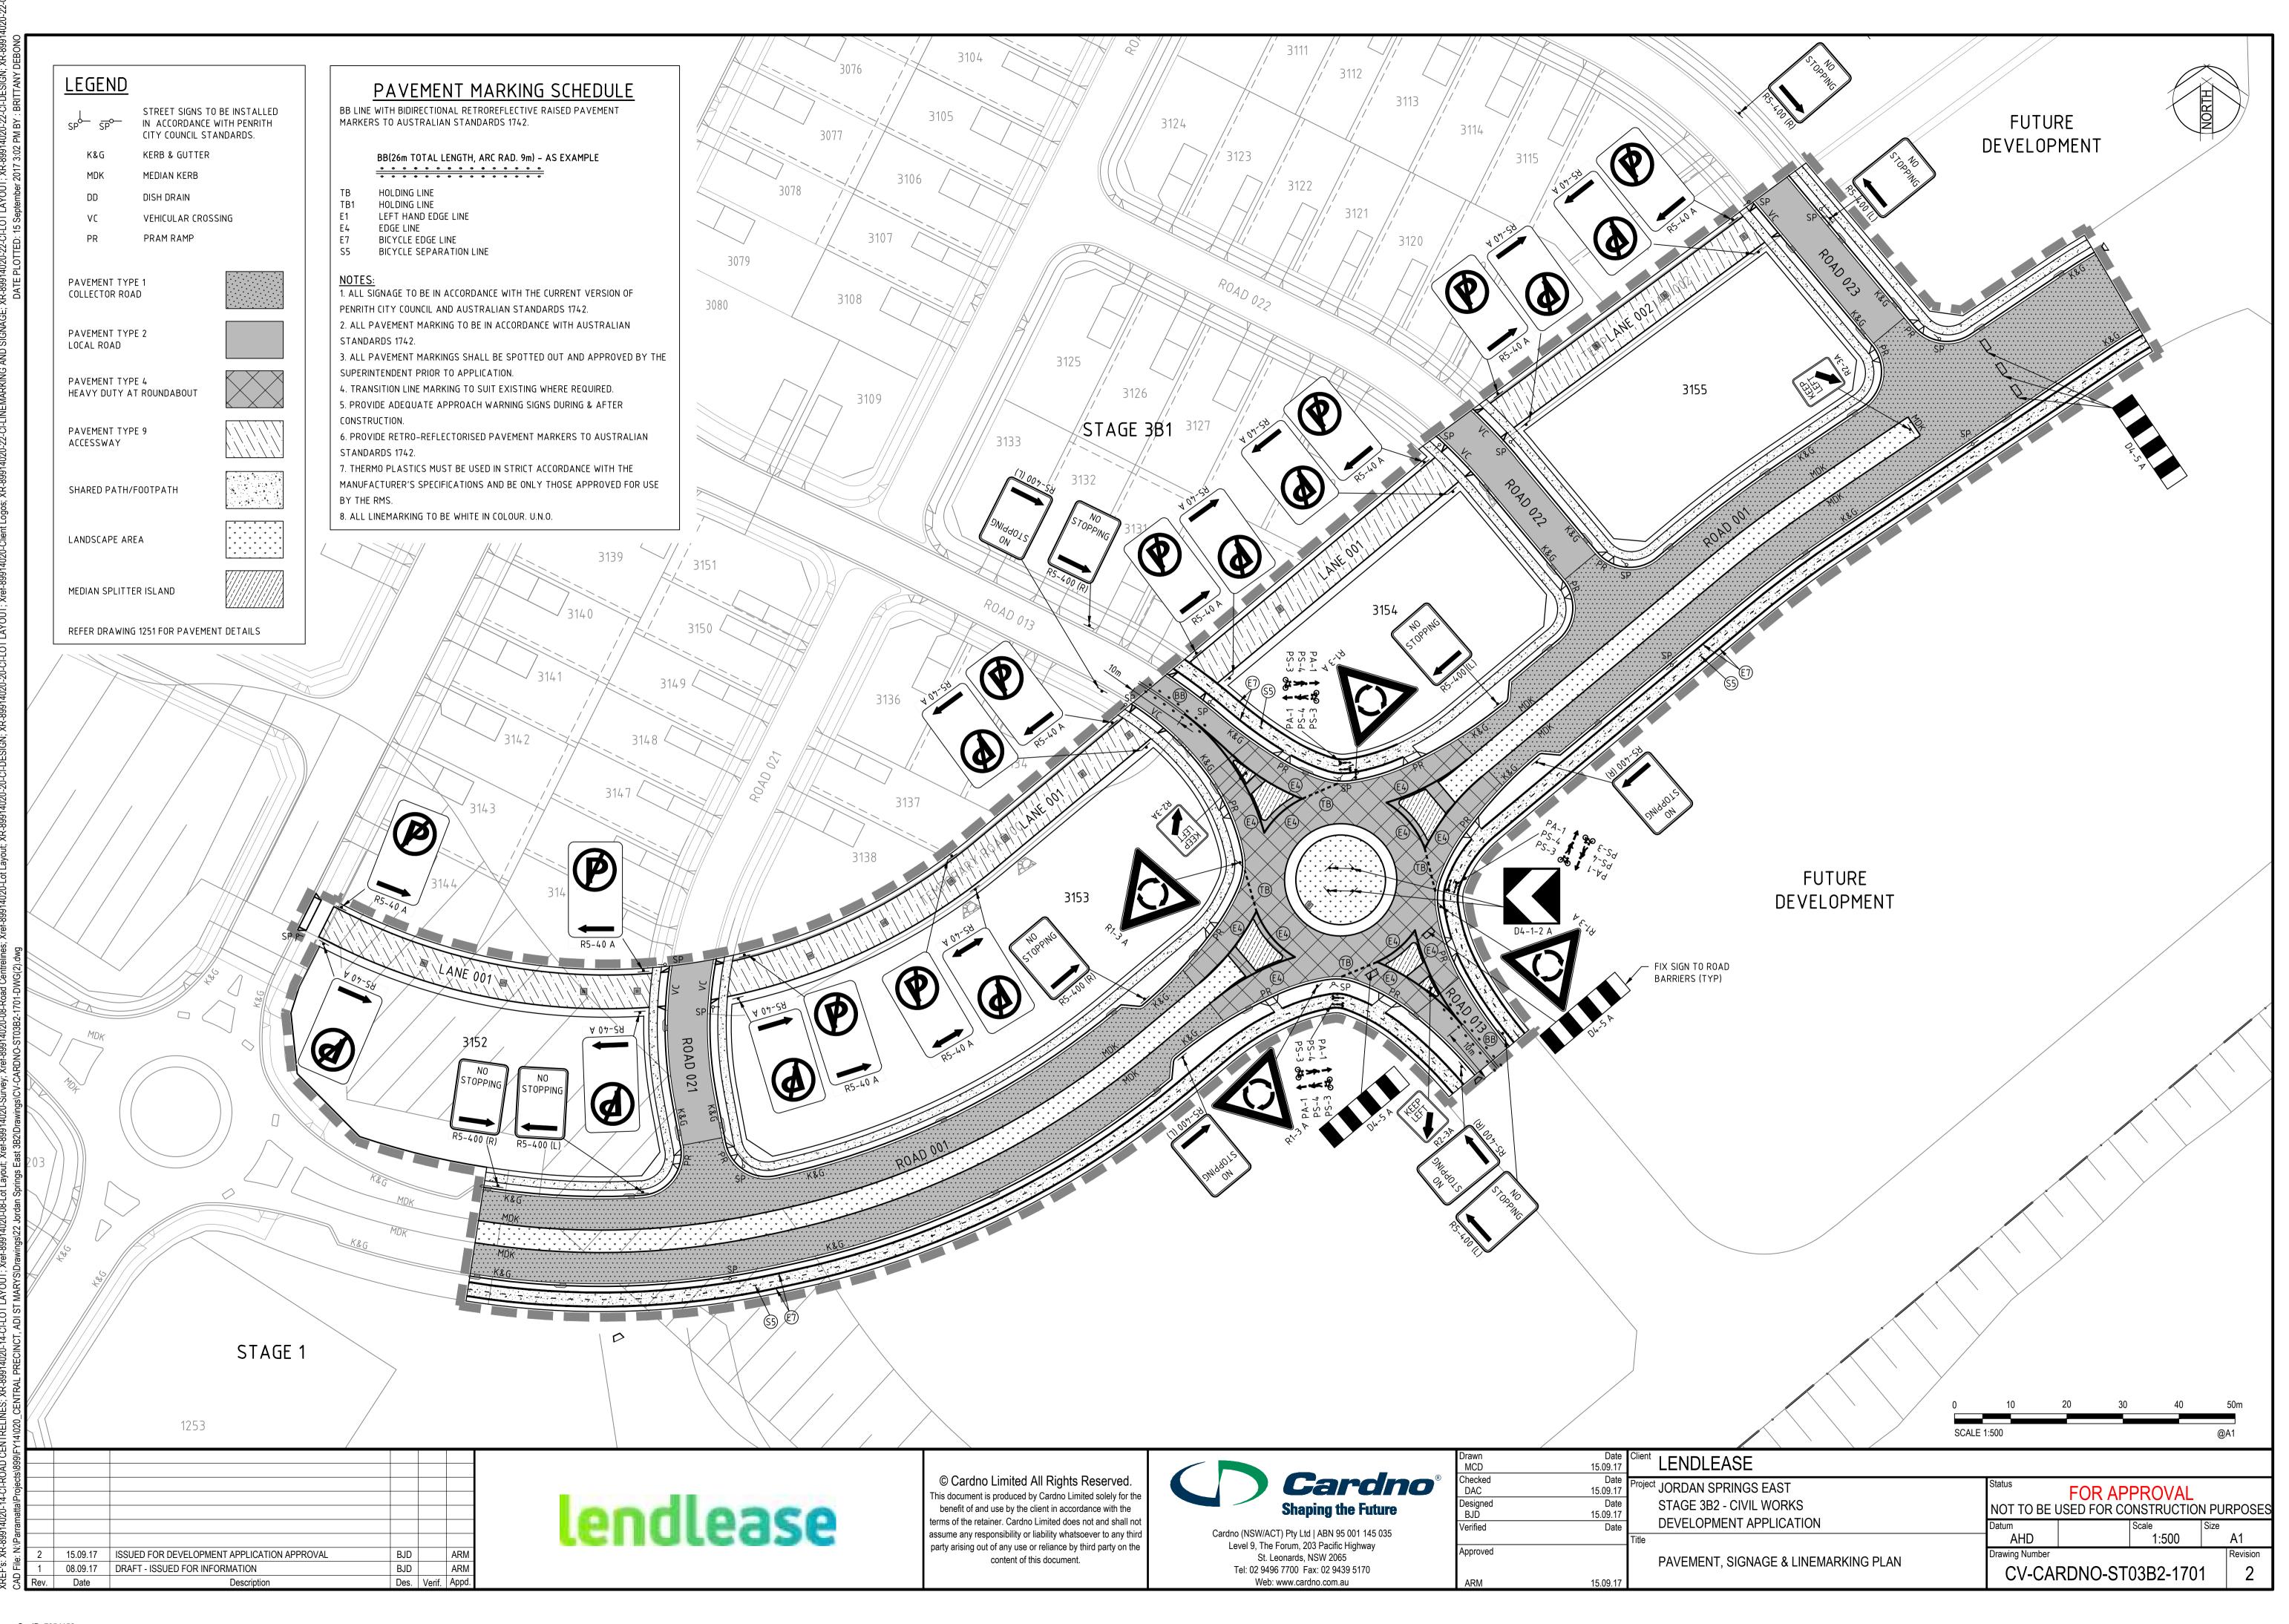


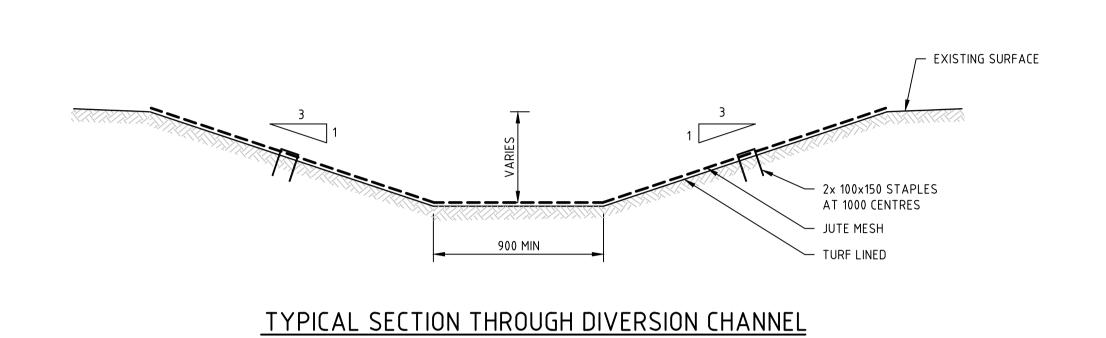


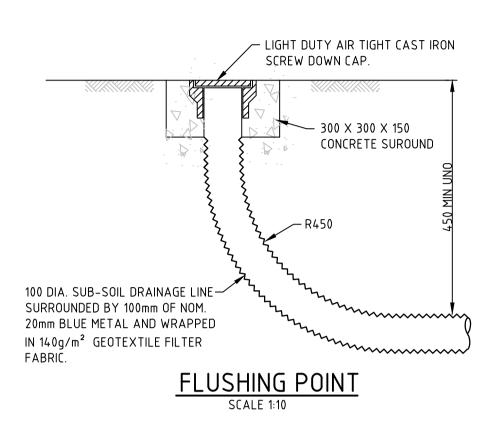

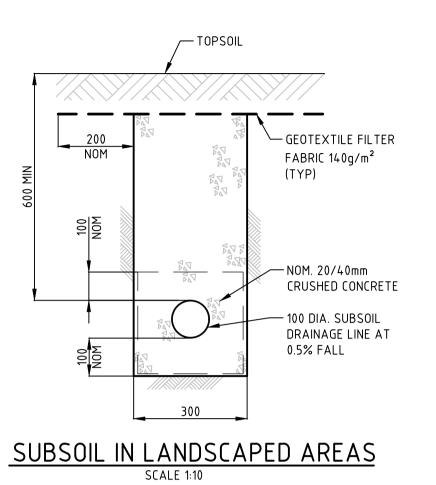

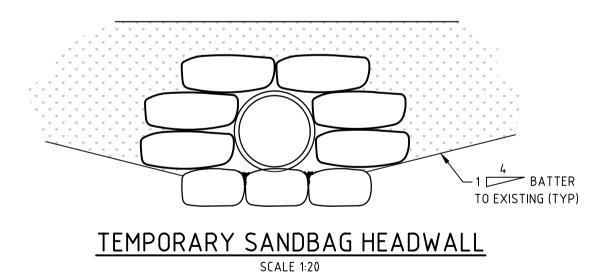

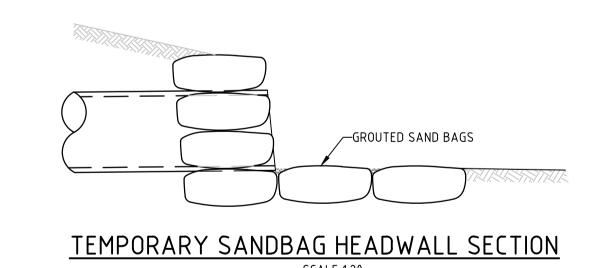

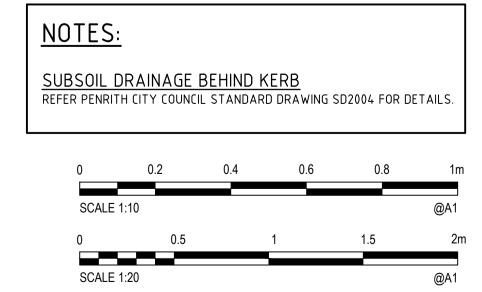

⋝						
N:\Parramatta\Projects\899\FY1						
ts/86						
oject						
\Pro						
natte						
rran						
:\Pa						
e: 	2	15.09.17	ISSUED FOR DEVELOPMENT APPLICATION APPROVAL	BJD		ARM
) File:	1	08.09.17	DRAFT - ISSUED FOR INFORMATION	BJD		ARM
SAD	Rev.	Date	Description	Des.	Verif.	Appd.





© Cardno Limited All Rights Reserved. This document is produced by Cardno Limited solely for the benefit of and use by the client in accordance with the terms of the retainer. Cardno Limited does not and shall not assume any responsibility or liability whatsoever to any third party arising out of any use or reliance by third party on the content of this document.




Cardno (NSW/ACT) Pty Ltd | ABN 95 001 145 035 Level 9, The Forum, 203 Pacific Highway St. Leonards, NSW 2065 Tel: 02 9496 7700 Fax: 02 9439 5170 Web: www.cardno.com.au

Drawn MCD	Date 15.09.17	Client LENDLEASE			
Checked DAC		Project JORDAN SPRINGS EAST	Status	APPROVAL	
Designed BJD	Date 15.09.17	STAGE 3B2 - CIVIL WORKS	NOT TO BE USED FO		URPOSES
Verified	Date	DEVELOPMENT APPLICATION Title	Datum AHD	Scale Size	• A1
Approved		STORMWATER DRAINAGE DETAILS	Drawing Number		Revision
ARM	15.09.17	SHEET 1	CV-CARDNO	-ST03B2-2201	2

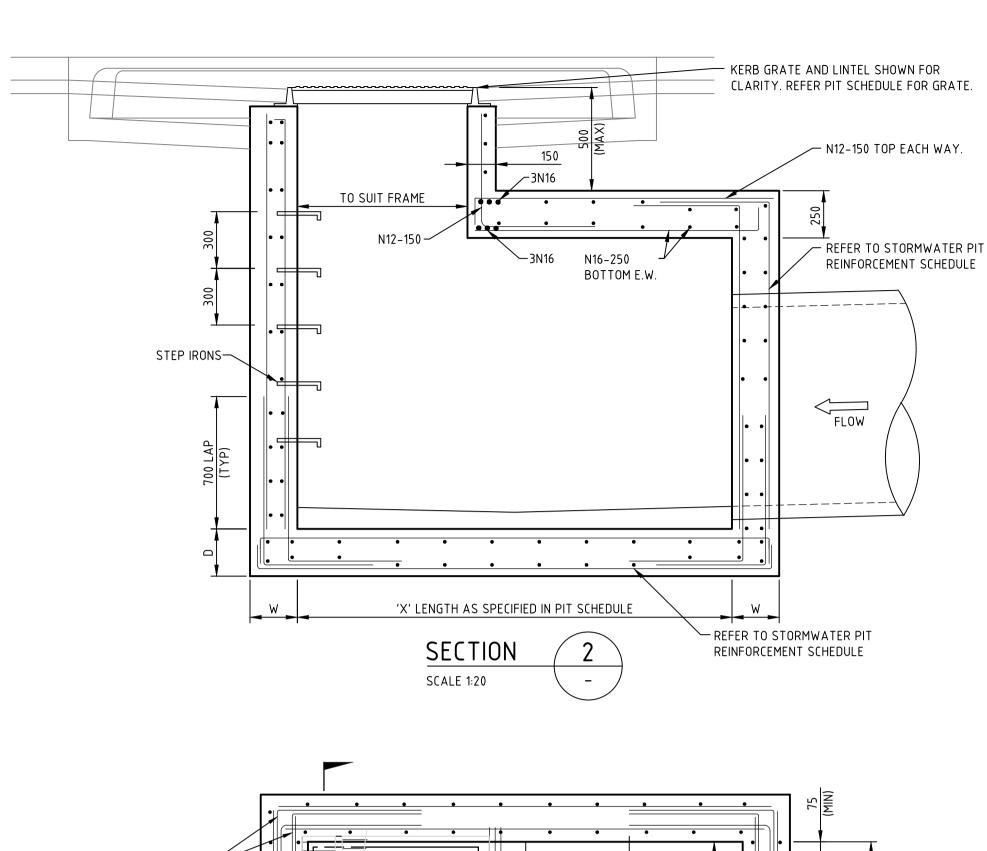

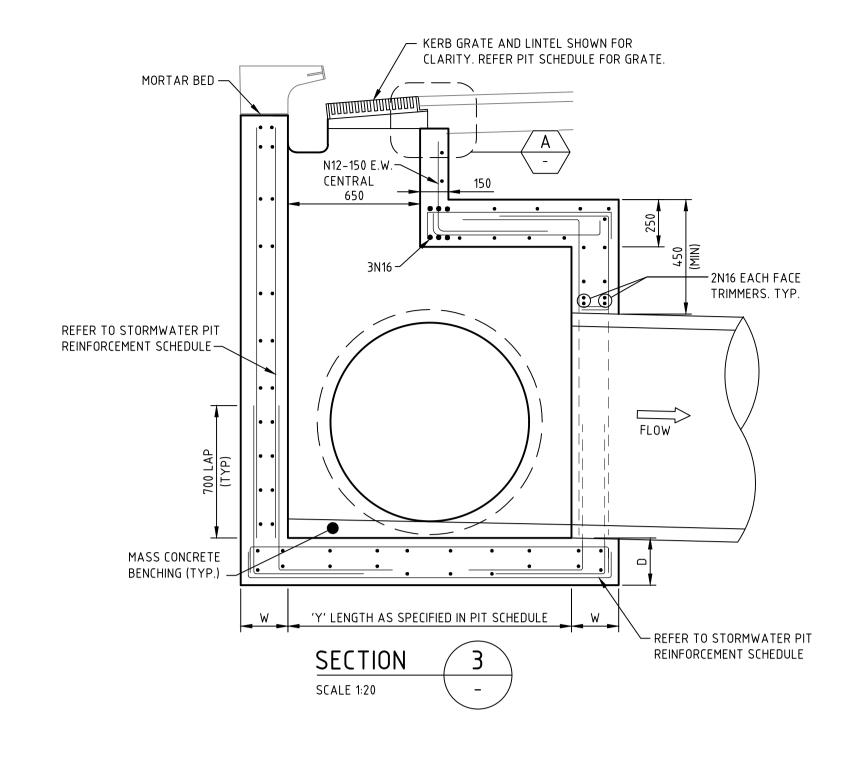

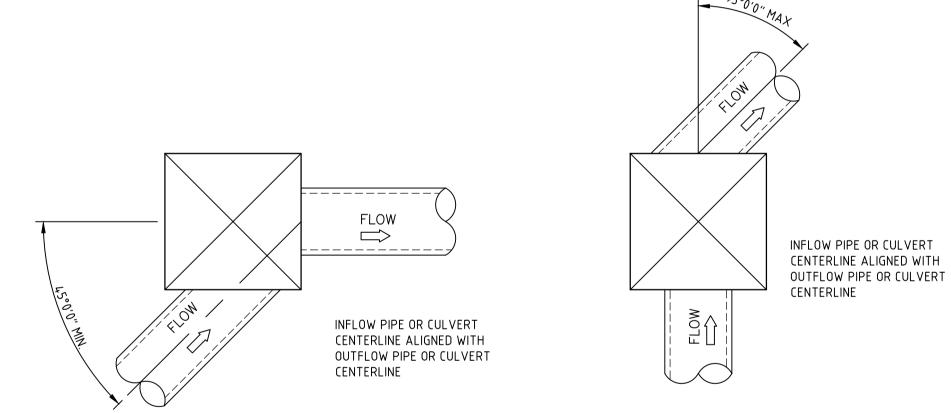

WELDLOK GG51D —

 $\Pi\Pi\Pi\Pi\Pi\Pi\Pi\Pi\Pi$


DETAIL

OR APPROVED


EQUIVALENT

ROAD PAVEMENT TO

ABUT GRATE FRAME

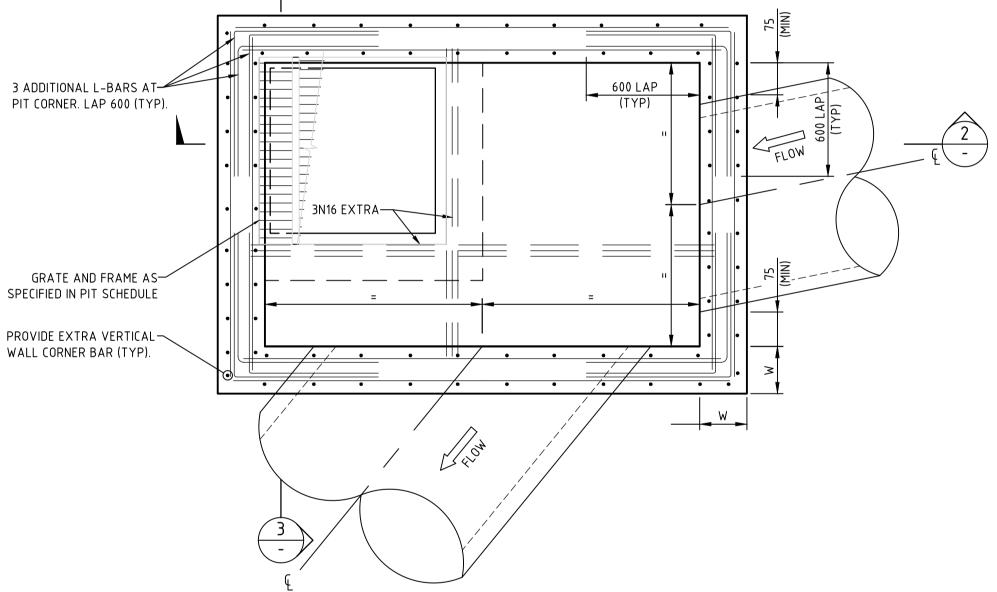

NON PENRITH CITY COUNCIL STANDARD STORMWATER PIT

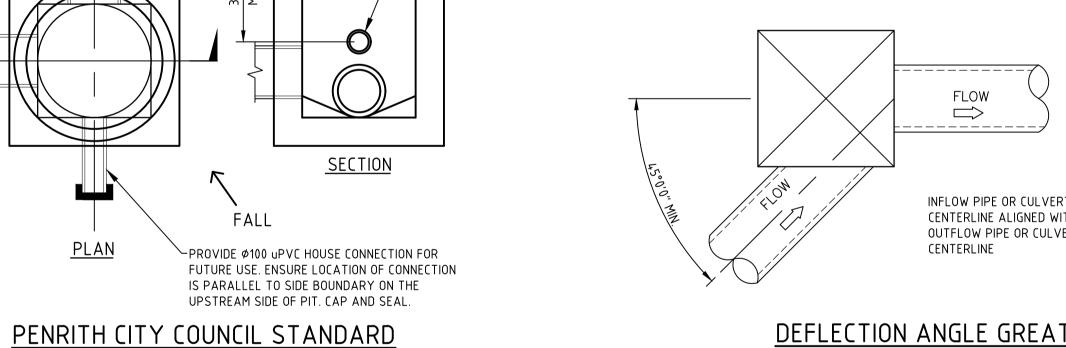

HOUSE CONNECTION.

DEFLECTION ANGLE GREATER THAN 45° (SIDE OF PIT)

PIT ALIGNMENT REQUIREMENTS

TYPICAL DETAILS OF STORMWATER PIPE OR CULVERT ALIGNMENTS THROUGH STORMWATER PITS. STORMWATER PIPE OR CULVERT ALIGNMENTS NOT SHOWN SHOULD BE CONSTRUCTED SIMILARLY IN ORDER TO STREAMLINE FLOWS FROM UPSTREAM TO DOWNSTREAM AND MINIMISE HEADLOSS.

IMPORTANT NOTE: PIT STANDARD DETAILS

PENRITH COUNCIL STANDARD GRATED GULLY PITS DETAIL, SD2001 TO BE USED FOR PIT DETAILS WHERE:

A. PIT INTERNAL WIDTH IN ANY DIRECTION IS LESS THAN OR EQUAL TO 1200mm, AND B. PIT DEPTH FROM SETOUT POINT TO INVERT IS LESS THAN OR EQUAL TO 2000mm.

FOR PITS WIDER THAN 1200mm AND/OR DEEPER THAN 2000mm REFER TO THE BELOW TABLE AND DETAILS.

NON PCC STORMWATER PIT REINFORCEMENT SCHEDULE							
PIT DIMENSIONS(mm)		WALL DIMENSIONS(mm)		VERTICAL	HORIZONTAL	BASE	
LENGTH 'X','Y'	DEPTH 'H'	BASE THICKNESS 'D'	WALL THICKNESS 'W'		REINFORCEMENT		
1200 <x,y<3300< td=""><td>2000<h<3900< td=""><td>230</td><td>230</td><td>N12-200 E.F.</td><td>N12-200 E.F.</td><td>N12-200 E.F.</td></h<3900<></td></x,y<3300<>	2000 <h<3900< td=""><td>230</td><td>230</td><td>N12-200 E.F.</td><td>N12-200 E.F.</td><td>N12-200 E.F.</td></h<3900<>	230	230	N12-200 E.F.	N12-200 E.F.	N12-200 E.F.	
X,Y<1200	H<6000	230	230	N16-250 E.F.	N16-250 E.F.	N16-250 E.F.	

BJD

Des. Verif. Appd.

NOTE: PIT REINFORCEMENT TO BE SELECTED USING MAXIMUM PIT DIMENSION

ISSUED FOR DEVELOPMENT APPLICATION APPROVAL

Description

DRAFT - ISSUED FOR INFORMATION

NOTES:

1. PIT REINFORCEMENT TO BE SELECTED USING MAXIMUM PIT DIMENSION. MINIMUM COVER TO REINFORCING AND CONCRETE STRENGTH AS SPECIFIED ON SHEET 1011.

© Cardno Limited All Rights Reserved. This document is produced by Cardno Limited solely for the benefit of and use by the client in accordance with the terms of the retainer. Cardno Limited does not and shall not assume any responsibility or liability whatsoever to any third party arising out of any use or reliance by third party on the content of this document.

REAR BOUNDARY



FALL

INTERALLOTMENT DRAINAGE PIT

SCALE 1:20

Cardno (NSW/ACT) Pty Ltd | ABN 95 001 145 035 Level 9, The Forum, 203 Pacific Highway St. Leonards, NSW 2065 Tel: 02 9496 7700 Fax: 02 9439 5170 Web: www.cardno.com.au

						_
MCD 15.09.	_	LENDLEASE				
Checked Da DAC 15.09.	7	^{ct} JORDAN SPRINGS EAST	Status	FOR AP	PROVAL	
Designed Da BJD 15.09.		STAGE 3B2 - CIVIL WORKS		USED FOR CO	ONSTRUCTION	
Verified Da	Title	DEVELOPMENT APPLICATION	Datum AHD		Scale AS SHOWN	Size A1
Approved		STORMWATER DRAINAGE DETAILS	Drawing Number			Revision
ARM 15.09.	7	SHEET 2	CV-CA	RDNO-ST	03B2-2202	2 2

lendlease

15.09.17

08.09.17

Date

