# **DEVELOPMENT APPLICATION**

PROPOSED FAST LANE CAFE

AT 137 COREEN AVE PENRITH NSW 2750 LOT 301 IN D.P. 860777



## **DEVELOPMENT DATA**

LOT 301 IN D.P. 860777 TOTAL SITE AREA  $= 10.060 \text{m}^2$ **EXISTING AREA 1** = 613m<sup>2</sup> **EXISTING AREA 2** = 337m<sup>2</sup> EXISTING AREA 3 (INCL. MEZZANINE) = 1250m<sup>2</sup> + 170m<sup>2</sup>(MEZZ)

EXISTING AREA 4 = 1421m<sup>2</sup> **EXISTING AREA 5** = 670m<sup>2</sup>

PROPOSED FAST LANE CAFE  $= 33 \text{ m}^2$ **EXISTING TOTAL GFA**  $= 4494m^2$ 

EXISTING GROUND SITE = 4324m2(43%) - COMPLIES COVER (Ground Floor only) (MAX. ALLOW = 50%)



DRAWING LIST						
SHEET NUMBER	SHEET NAME	Drawn By	Checked By	Current Revision Date	Current Revision	
A0000	COVER SHEET	FRANZ	HC	10.08.18	Α	
A0001	CONSTRUCTION, SITE & WASTE MANAGEMENT PLAN	FRANZ	HC	10.08.18	Α	
A0002	BLOW UP SITE PLAN & LANDSCAPE PLAN	FRANZ	HC	10.08.18	Α	
A0003	PROPOSED ELEVATION, FINISH SCHEDULES AND SIGNAL DETAIL	FRANZ	HC	10.08.18	Α	
A0004	PROPOSED SECTIONS	FRANZ	HC	10.08.18	Α	
A0005	PROPOSED FLOOR PLAN	FRANZ	HC	10.08.18	Α	
A0006	PROPOSED ROOF PLAN	FRANZ	HC	10.08.18	Α	
A0007	PARASOL FRAME + SUB-ROOF PLAN	FRANZ	HC	10.08.18	Α	
8000A	OVERVIEW PERSPECTIVE	FRANZ	HC	10.08.18	Α	
A0009	CONCEPT STORMWATER PLAN	HC	HC	10.08.18	Α	



**LOCATION PLAN** NTS

copyright of rkExpress all rights reserved. this design and drawing shall not be copied nor reproduce

10.08.18 DA ISSUE without written permission. do not scale the drawings. 19.07.18 ISSUED FOR COORDINATION verified all dimensions on site before commencing work. all work to australian standards & the building code of 2 12.07.18 PRELIMINARY CLIENT ISSUE australia. report all discrepancies to the architect. 1 22.06.18 CLIENT AMENDMENT ISSUE DATE REVISION Document Set ID: 8342171 Version: 1, Version Date: 17/08/2018





client: Yaringa Enterprises drawing title: **COVER SHEET** PROPOSED FAST LANE CAFE

137 COREEN AVENUE, PENRITH NSW 2750

LOT 301 IN D.P. 860777

print date: 10.08.18 checked: HC scale: 1:20

**B** A0000 18258 doj

100mm

CDC ISSUE

## performance

there are to be four, six monthly reports prepared by the bush regenerator and forwarded to dlwc. each report is to measure the performance of the plant material in reference to the following criteria;

	native grasses ht.	trees ht.
6 months	500mm	500mm
12 months	750mm	1000mm
18 months	750mm	1500mm
24 months	750mm	2500mm

each report is to identify any problems with implementing and maintaining the rehabilitation works. the report is also to address proposed methods of rectifying these problems. all remedial works are to be implemented and reported upon in subsequent reports.

## planting

plant material is to be propogated from seeds and cuttings from locally occuring species as noted in the "plant schedule". sizes shall be 75mm dia pot for native grasses, 150mm pot for trees and shrubs. native grasses are to be planted at a density of four plants per square metre. trees are to be planted at the rate show on on the plan.

### maintenance

riparian zone planting works are to be maintained and monitored for a period of two years following final planting. to ensure successful native vegetation establishment. maintenance must include watering, weed control, replacement of plant losses, disease and insect control etc.. as required for successful plant establishment.


## irrigation system

all garden areas on the landscape plan are to be covered fully by automatic irrigation system. the system is to provide full coverage with no over spray onto paved areas., structures or buildings.


all garden beds are to contain a minimum of 75mm of selected mulch laid on 300mm of clean, free draining topsoil / compost mix. apply gypsum to the subgrade at a rate of 300 grams per square metre and cultivate to a depth of 150mm where subgrade is clay, turf is to be supplied from a recognised turf grower/farm and laid on 100mm clean free draining topsoil over a 100mm layer of cultivated subgrade. trees in lawn areas are to have a 75mm thick x 1 metre diameter layer of mulch around its base

# hardwood stakes 38x38x1800mm positioned outside rootball 50mm wide jute webbing tie in figure of eight form stapled to stake mulch and soil dished to base of steam 100mm deep mulch top soil mixture backfill incorporating fertiliser as specified

planting detail (advanced tree)

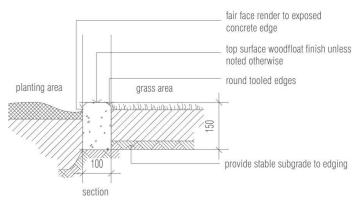

concrete garden edge detail. nts

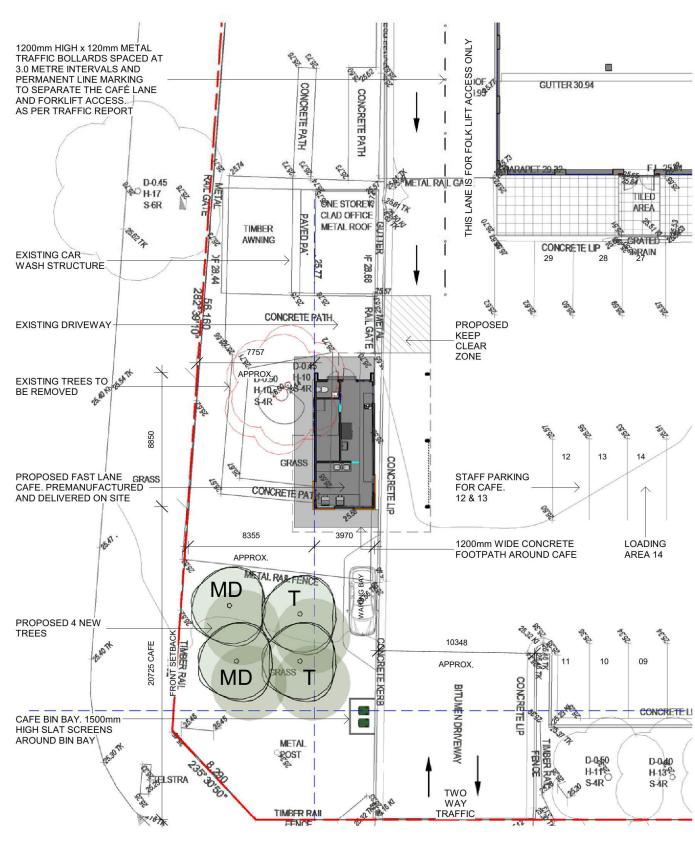

## PLANT SCHEDULE

### **TREES**

CODE	LATIN NAME	COMMON NAME	HEIGHT	SIZE	QTY	TYPE
MD	Melaleuca decora	Paperbark	11m	75L	2 2	NATIVE
T	Tristaniopsis laurina	Water Gum	6m	100L		NATIVE

## **BLOW UP SITE PLAN & LANDSCAPE PLAN** 1:250

10

0

10 20 30 50 100mm client: Yaringa Enterprises drawing title: print date: 10.08.18 FRANZ **BLOW UP SITE** checked: HC PLAN & PROPOSED FAST LANE scale: 18258 A0002 LANDSCAPE PLAN CAFE 137 COREEN AVENUE, PENRITH NSW 2750 doj DA ISSUE LOT 301 IN D.P. 860777

40


copyright of rkExpress all rights reserved. this design and drawing shall not be copied nor reproduce without written permission. do not scale the drawings. verified all dimensions on site before commencing work. all work to australian standards & the building code of australia. report all discrepancies to the architect.


10.08.18 DA ISSUE 07.08.18 DRAFT DA - CLIENT ISSUE FOR INFORMATION 19.07.18 ISSUED FOR COORDINATION 12.07.18 PRELIMINARY CLIENT ISSUE 22.06.18 CLIENT AMENDMENT ISSUE DATE REVISION





Document Set ID: 8342171 Version: 1, Version Date: 17/08/2018

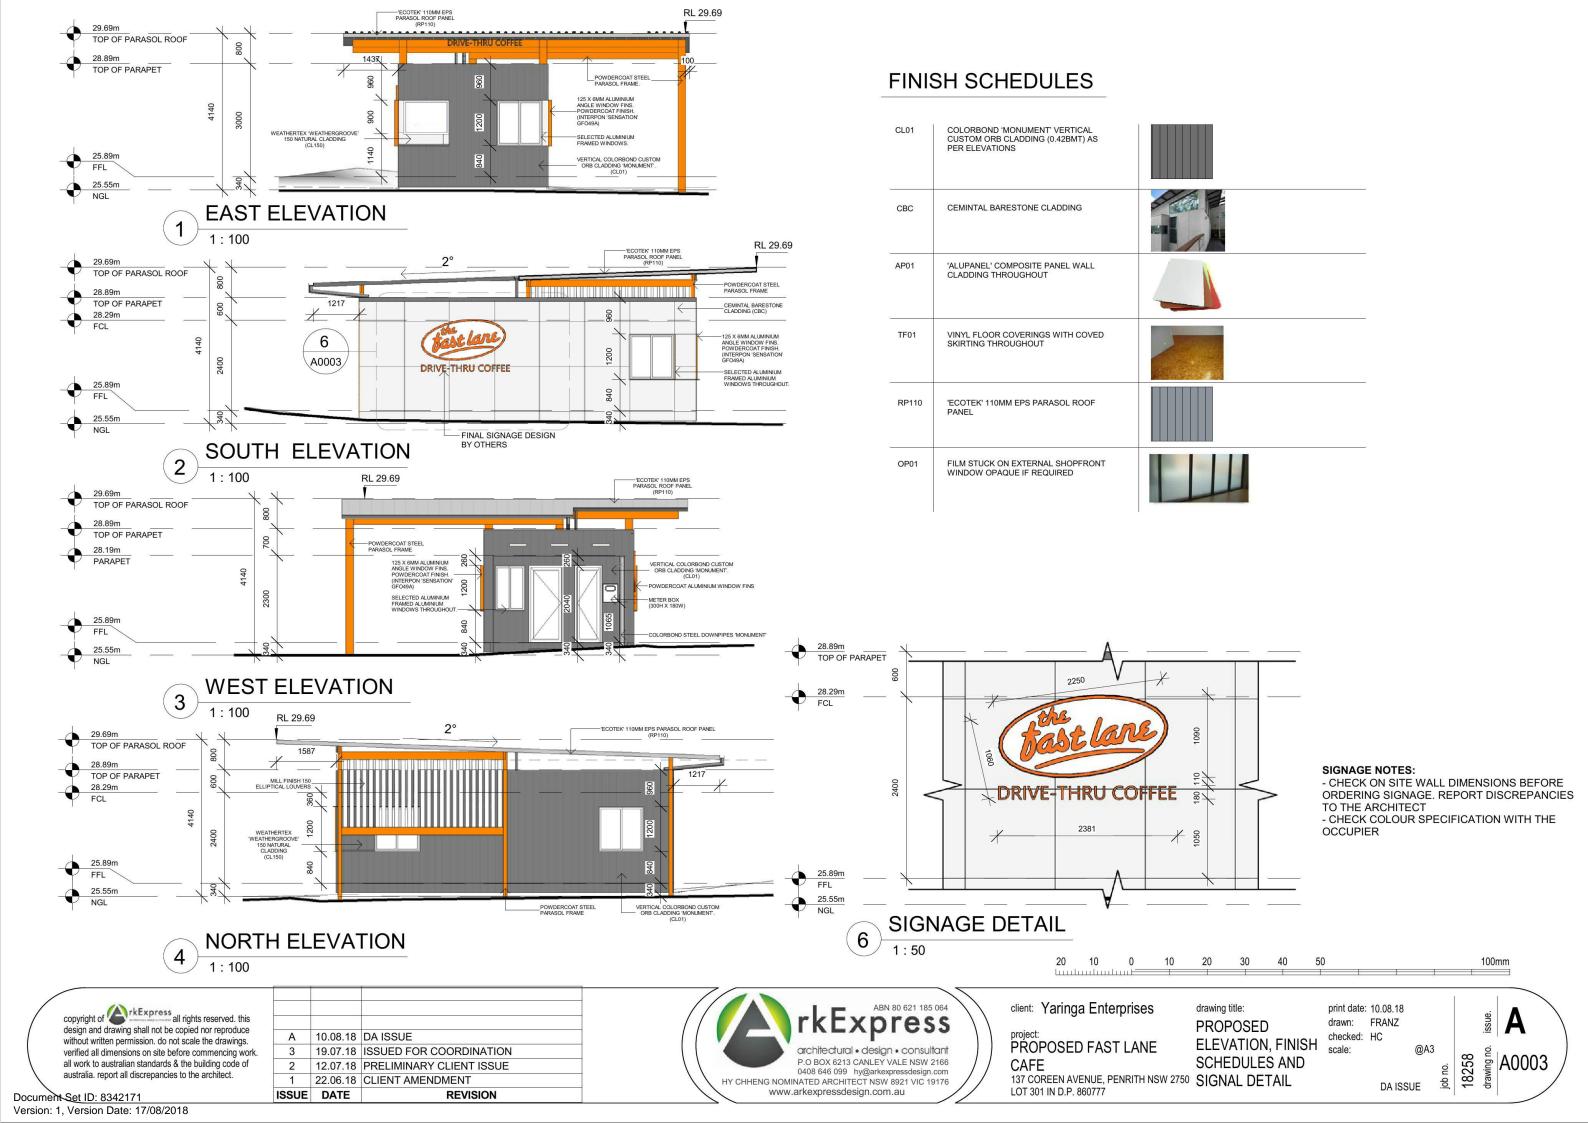

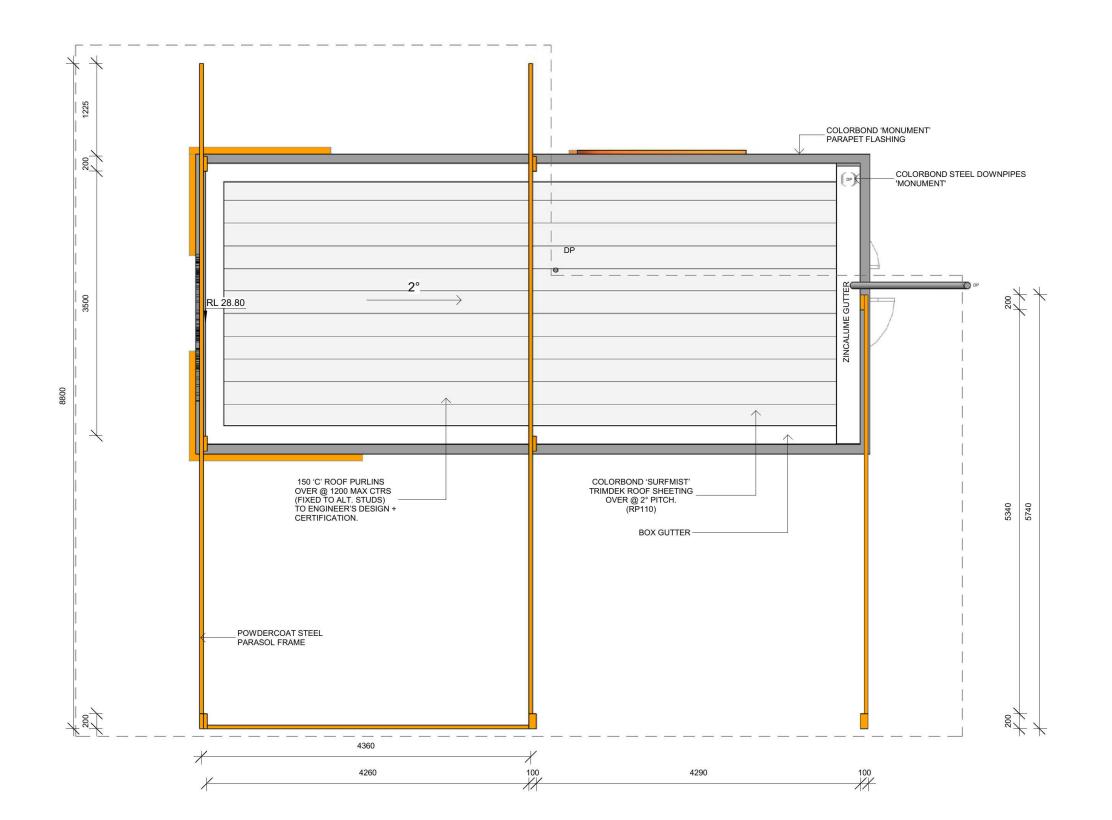

## **NOTES**

- 1. PARASOL RAFTERS 200 X 50 'BOXSPAN'. POWDERCOAT INTERPON 'SENSATION' GF049A
- 2. COLUMNS 200 X 100 SHS. POWDERCOAT INTERPON 'SENSATION' GFO49A
- 3. ALL STEEL WORK (INCLUDING ALL CONNECTION DETAILS TO BE DESIGNED & CERTIFIED BY A SUITABLY QUALIFIED STRUCTURAL ENGINEER.
- 4. PARASOL ROOF DESIGNED FOR A MAXIMUM WIND CATEGORY OF N3 (W41) & AN ULTIMATE LIMIT STATE DESIGN WIND PRESSURE OF 2.34 KPA AS PER THE ARCPANEL ECOTEK DESIGN GUIDE.
  ALL SPANS / CANTILEVERS & UPLIFT PRESSURES TO BE CONFIRMED WITH ARCPANEL PRIOR TO ANY CONSTRUCTION FOR THE PROPOSED SITE.
- 5. THE ROOF DRAINAGE SYSTEM HAS BEEN DESIGNED FOR A MAXIMUM RAINFALL INTENSITY OF 233MM/H @ 6.5L/S. LOCATION SHOULD BE CHECKED AND VERIFIED WITH AS3500.3 FOR COMPLIANCE PRIOR TO CONSTRUCTION.

# PARASOL FRAME + SUB-ROOF PLAN

copyright of rkExpress all rights reserved. this design and drawing shall not be copied nor reproduce without written permission. do not scale the drawings. verified all dimensions on site before commencing work. all work to australian standards & the building code of australia. report all discrepancies to the architect.

Document Set ID: 8342171

Version: 1, Version Date: 17/08/2018

10.08.18 DA ISSUE 19.07.18 ISSUED FOR COORDINATION 12.07.18 PRELIMINARY CLIENT ISSUE 1 22.06.18 CLIENT AMENDMENT ISSUE DATE REVISION





client: Yaringa Enterprises drawing title: print date: 10.08.18 PARASOL FRAME + checked: HC SUB-ROOF PLAN PROPOSED FAST LANE scale: As indicated@A3 137 COREEN AVENUE, PENRITH NSW 2750 <u>ह</u> DA ISSUE

30

40

50

100mm

§ A0007

18258

20

20 10 0 10

LOT 301 IN D.P. 860777









**OVERVIEW PERSPECTIVE 2** 

# **OVERVIEW PERSPECTIVE 3**


copyright of rkExpress all rights reserved. this


design and drawing shall not be copied nor reproduct without written permission. do not scale the drawings verified all dimensions on site before commencing we all work to australian standards & the building code o australia. report all discrepancies to the architect.

Document Set ID: 8342171 Version: 1, Version Date: 17/08/2018

A 10.08.18 DA ISSUE 3 19.07.18 ISSUED FOR COORDINATION 2 12.07.18 PRELIMINARY CLIENT ISSUE 1 22.06.18 CLIENT AMENDMENT	SSUE	DATE	REVISION
3 19.07.18 ISSUED FOR COORDINATION	1	22.06.18	CLIENT AMENDMENT
The state of the s	2	12.07.18	PRELIMINARY CLIENT ISSUE
A 10.08.18 DA ISSUE	3	19.07.18	ISSUED FOR COORDINATION
A 10.00.10 DA ICCLIE	Α	10.08.18	DA ISSUE



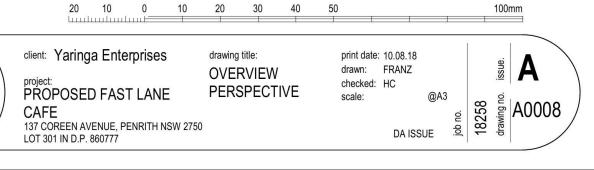

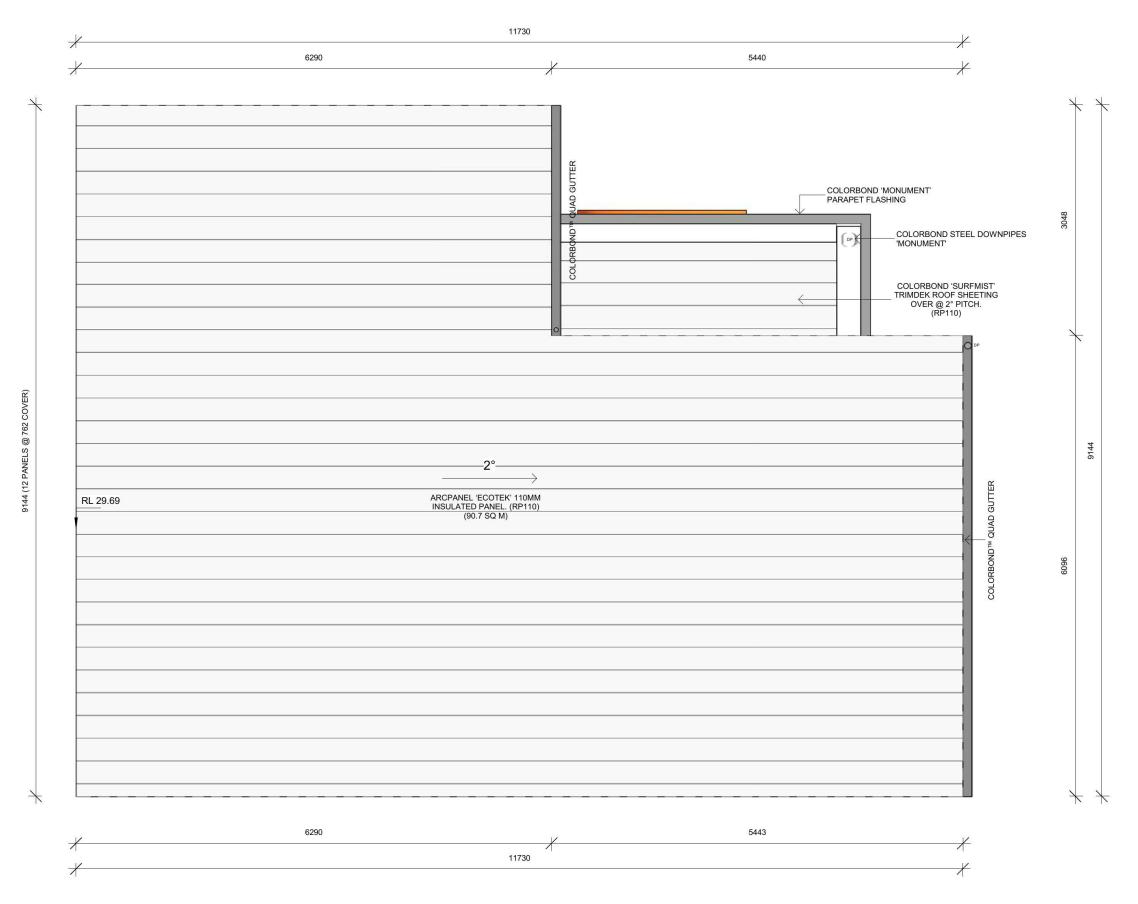



copyright of copyr

A 10.08.18 DA ISSUE
3 19.07.18 ISSUED FOR COORDINATION
2 12.07.18 PRELIMINARY CLIENT ISSUE
1 22.06.18 CLIENT AMENDMENT
ISSUE DATE REVISION



	rkExpress	
HY	architectural • design • consultant P.O BOX 6213 CANLEY VALE NSW 2166 0408 646 099 hy@arkexpressdesign.com CHHENG NOMINATED ARCHITECT NSW 8921 VIC 19176	),
	www.arkexpressdesign.com.au	_

project:
PROPOSED FAST LANE

137 COREEN AVENUE, PENRITH NSW 2750 LOT 301 IN D.P. 860777

drawing title: print
PROPOSED ROOF
PLAN draw
chec
scale

20 10 0 10 20 30 40 50

print date: 10.08.18 drawn: FRANZ checked: HC scale: 1:50

100mm

Document Set ID: 8342171 Version: 1, Version Date: 17/08/2018