

Cardno (NSW/ACT) Pty Ltd | ABN 95 001 145 035 Suite 3.01, Level 3, 3 Horwood Place Parramatta, NSW 2150 Tel: 02 9496 7700 Fax: 02 9439 5170 Web: www.cardno.com.au

# LENDLEASE JORDAN SPRINGS EAST STAGE 3C - CIVIL WORKS DEVELOPMENT APPLICATION





#### SCHEDULE OF DRAWINGS

**DESCRIPTION** DRAWING No.

CV-CARDNO-ST03C-1131 CV-CARDNO-ST03C-1251 CV-CARDNO-ST03C-1601

CV-CARDNO-ST03C-1602 CV-CARDNO-ST03C-2201 CV-CARDNO-ST03C-2301 INTERNAL STORMWATER CATCHMENT PLAN

4	25.07.19	ISSUED FOR DEVELOPMENT APPLICATION APPROVAL	DAC	ARM	ARM
3	26.06.19	ISSUED FOR DRAFT DA DOCUMENTATION	DAC		ARM
2	20.12.18	REISSUED FOR COORDINATION	DAC		ARM
1	06.08.18	DRAFT - ISSUED FOR COORDINATION	DAC		ARM
Rev.	Date	Description	Des.	Verif.	Appd.

© Cardno Limited All Rights Reserved This document is produced by Cardno Limited solely for the benefit of and use by the client in accordance with the terms of the retainer. Cardno Limited does not and shall not assume any responsibility or liability whatsoever to any third party arising out of any use or reliance by third party on the content of this document.

Drawn	Date	Status
MCD	25.07.19	
Checked	Date	
DAC	25.07.19	ГОИ
Designed	Date	1101
DAC	25.07.19	
Verified	Date	Datum
ARM	25.07.19	
Approved		Drawii
		1 (

FOR APPROVAL OT TO BE USED FOR CONSTRUCTION PURPOSES CV-CARDNO-ST03C-1001

#### **GENERAL**

- ALL WORKS TO BE CONSTRUCTED IN ACCORDANCE WITH PENRITH CITY COUNCIL ENGINEERING CONSTRUCTION SPECIFICATION FOR CIVIL WORKS.
- PENRITH CITY COUNCIL STANDARD DETAILS TO BE USED AT ALL

#### SITEWORKS NOTES

- ORIGIN OF LEVELS:- REFER SURVEY NOTES.
- CONTRACTOR MUST VERIFY ALL DIMENSIONS AND EXISTING LEVELS ON SITE PRIOR TO COMMENCEMENT OF WORK, ANY DISCREPANCIES TO BE REPORTED TO CARDNO.
- MAKE SMOOTH CONNECTION WITH EXISTING WORKS AND SURFACES.
- 4. ALL TRENCH BACKFILL MATERIAL SHALL BE COMPACTED TO THE SAME DENSITY AS THE ADJACENT MATERIAL.
- 5. ALL SERVICE TRENCHES UNDER VEHICULAR PAVEMENTS SHALL BE BACKFILLED WITH SAND TO 300mm ABOVE PIPE. WHERE PIPE IS UNDER PAVEMENTS BACKFILL REMAINDER OF TRENCH TO UNDERSIDE OF PAVEMENT WITH SAND OR APPROVED GRANULAR MATERIAL COMPACTED IN 150mm LAYERS TO MINIMUM 98% MODIFIED MAXIMUM DRY DENSITY IN ACCORDANCE WITH AS 1289 5.2.1. (OR A DENSITY INDEX OF NOT LESS
- 6. PROVIDE 10mm WIDE EXPANSION JOINTS BETWEEN BUILDINGS AND ALL CONCRETE OR UNIT PAVEMENTS.
- 7. ASPHALTIC CONCRETE SHALL CONFORM TO R.M.S. SPECIFICATION R116.
- B. ALL BASECOURSE MATERIAL SHALL BE IGNEOUS ROCK QUARRIED MATERIAL TO COMPLY WITH R.M.S. FORM 3051, COMPACTED TO MINIMUM 98% MODIFIED DENSITY IN ACCORDANCE WITH AS 1289 5.2.1 FREQUENCY OF COMPACTION TESTING SHALL NOT BE LESS THAN 1 TEST PER 50m³ OF BASECOURSE MATERIAL PLACED.
- ALL SUB-BASE COURSE MATERIAL SHALL BE IGNEOUS ROCK QUARRIED MATERIAL TO COMPLY WITH R.M.S. FORM 3051, AND COMPACTED TO MINIMUM 95% MODIFIED DENSITY IN ACCORDANCE WITH A.S 1289 5.2.1 FREQUENCY OF COMPACTION TESTING SHALL NOT BE LESS THAN 1 TEST PER 100m<sup>3</sup> OF SUB-BASE COURSE MATERIAL PLACED.
- 10. AS AN ALTERNATIVE TO THE USE OF IGNEOUS ROCK AS A SUB-BASE MATERIAL IN (9) A CERTIFIED RECYCLED CONCRETE MATERIAL COMPLYING WITH R.M.S. FORM 3051 WILL BE CONSIDERED. SUBJECT TO MATERIAL SAMPLES AND APPROPRIATE CERTIFICATIONS BEING PROVIDED TO THE SATISFACTION OF PENRITH CITY COUNCIL AND THE SUPERINTENDENT.
- 11. A HANDRAIL OR SAFETY BARRIER IS TO BE PROVIDED AT THE TOP OF ALL HEADWALLS AND RETAINING WALLS GREATER THAN 1m HIGH IN ACCORDANCE WITH THE LENDLEASE GMR'S.

### BULK EARTHWORKS NOTES

- 1. ORIGIN OF LEVELS: REFER SURVEY NOTES
- STRIP ALL TOPSOIL/ORGANIC MATERIAL FROM CONSTRUCTION AREA AND STOCK PILE AS DIRECTED BY SUPERINTENDENT FOR FUTURE REUSE.
- . EXCAVATED MATERIAL TO BE USED AS STRUCTURAL FILL PROVIDED THE PLACEMENT MOISTURE CONTENT OF THE MATERIAL IS +/- 2% OF THE OPTIMUM MOISTURE CONTENT.
- 4. COMPACT FILL AREAS AND SUBGRADE TO NOT LESS THAN:

STANDARD DRY DENSITY LOCATION (AS 1289 E 5.1.1.)

UNDER BUILDING SLABS ON GROUND UNDER ROADS AND CARPARKS

LANDSCAPED AREAS UNLESS NOTED OTHERWISE 98%

- 5. FOR NON COHESIVE MATERIAL, COMPACT TO 75% DENSITY INDEX.
- 6. BEFORE PLACING FILL, PROOF ROLL EXPOSED SUBGRADE WITH AN 8 TONNE (MIN) DEADWEIGHT SMOOTH DRUM VIBRATORY ROLLER TO DETECT THEN REMOVE SOFT SPOTS (AREAS WITH MORE THAN 2mm MOVEMENT UNDER ROLLER).
- FREQUENCY OF COMPACTION TESTING SHALL BE NOT LESS THAN:-(A) 1 TEST PER 1,000m³ OF FILL PLACED PER LAYER OF FILL.
- (B) 3 TESTS PER VISIT

COMPACTED AS SPECIFIED

- (C) 1 TEST PER 1000m<sup>2</sup> OF EXPOSED SUBGRADE "LEVEL 1" TESTING
- SHALL BE TESTING IN ACCORDANCE WITH AS 3798 (1996). 8. FILLING TO BE PLACED IN MAXIMUM 300mm - LOOSE LAYERS AND
- ). NO FILLING SHALL TAKE PLACE TO EXPOSED SUBGRADE UNTIL THE AREA HAS BEEN PROOF ROLLED IN THE PRESENCE OF A SUITABLY QUALIFIED GEOTECHNICAL ENGINEER AND APPROVAL GIVEN IN WRITING THAT FILLING CAN PROCEED.

ISSUED FOR DEVELOPMENT APPLICATION APPROVAL

Description

ISSUED FOR DRAFT DA DOCUMENTATION

REISSUED FOR COORDINATION

DRAFT - ISSUED FOR COORDINATION

#### **EROSION AND SEDIMENT CONTROL**

### **NOTES**

#### GENERAL INSTRUCTIONS

- THE CONTRACTOR SHALL BE SOLELY RESPONSIBLE FOR THE CONTROL OF EROSION AND SEDIMENTATION TO THE SATISFACTION OF COUNCIL, NSW OFFICE OF WATER, SYDNEY WATER, THE OFFICE OF ENVIRONMENT AND HERITAGE, AND LENDLEASE'S REPRESENTATIVE, TO THIS END. THE EROSION AND SEDIMENTATION CONTROLS SHOWN ON THE DRAWINGS SHALL ONLY BE USED AS A GUIDE BY THE CONTRACTOR, AND REPRESENT THE MINIMUM REQUIREMENT ONLY.
- THE CONTRACTOR SHALL ENSURE THAT ALL SOIL AND WATER MANAGEMENT WORKS ARE LOCATED AS DOCUMENTED OR AS OTHERWISE
- DIRECTED BY THE SUPERINTENDENT. ALL WORK SHALL BE GENERALLY CARRIED OUT IN ACCORDANCE WITH
- a. LOCAL AUTHORITY REQUIREMENTS b. EPA REQUIREMENTS
- c. NSW DEPARTMENT OF HOUSING MANUAL "MANAGING URBAN
- MAINTAIN THE EROSION CONTROL DEVICES TO THE SATISFACTION OF THE SUPERINTENDENT AND THE LOCAL AUTHORITY.

STORMWATER, SOILS AND CONSTRUCTION", 4th EDITION, MARCH 2004.

- WHEN STORMWATER PITS ARE CONSTRUCTED, PREVENT SITE RUNOFF ENTERING UNLESS SEDIMENT FENCES ARE ERECTED AROUND PITS.
- CONTRACTOR IS TO ENSURE ALL EROSION & SEDIMENT CONTROL DEVICE ARE MAINTAINED IN GOOD WORKING ORDER AND OPERATE EFFECTIVELY. REPAIRS AND OR MAINTENANCE SHALL BE UNDERTAKEN AS REQUIRED, PARTICULARLY FOLLOWING STORM EVENTS.

#### LAND DISTURBANCE

- WHERE PRACTICAL. THE SOIL EROSION HAZARD ON THE SITE WILL BE KEPT AS LOW AS POSSIBLE. TO THIS END, WORKS SHOULD BE UNDERTAKEN IN THE FOLLOWING SEQUENCE:
- a. INSTALL A SEDIMENT FENCE ALONG THE BOUNDARIES AS SHOWN ON PLAN. REFER DETAIL. b. CONSTRUCT STABILISED CONSTRUCTION ENTRANCE TO LOCATION AS
- DETERMINED BY SUPERINTENDENT/ENGINEER. REFER DETAIL. c. INSTALL SEDIMENT BASIN AS SHOWN ON PLAN (D) INSTALL SEDIMENT
- TRAPS AS SHOWN ON PLAN. d. UNDERTAKE SITE DEVELOPMENT WORKS IN ACCORDANCE WITH THE ENGINEERING PLANS. WHERE POSSIBLE, PHASE DEVELOPMENT SO THAT LAND DISTURBANCE IS CONFINED TO AREAS OF WORKABLE SIZE.

#### **EROSION CONTROL**

- DURING WINDY WEATHER, LARGE, UNPROTECTED AREAS WILL BE KEPT MOIST (NOT WET) BY SPRINKLING WITH WATER TO KEEP DUST UNDER CONTROL.
- FINAL SITE LANDSCAPING WILL BE UNDERTAKEN AS SOON AS IS PRACTICABLE AFTER THE COMPLETION OF CONSTRUCTION ACTIVITIES.

#### SEDIMENT CONTROL

- STOCKPILES WILL NOT BE LOCATED WITHIN 2 METRES OF HAZARD AREAS, INCLUDING LIKELY AREAS OF CONCENTRATED OR HIGH VELOCITY FLOWS SUCH AS WATERWAYS. WHERE THEY ARE BETWEEN 2 AND 5 METRES FROM SUCH AREAS, SPECIAL SEDIMENT CONTROL MEASURES SHOULD BE TAKEN TO MINIMISE POSSIBLE POLLUTION TO DOWNSLOPE WATERS, E.G. THROUGH INSTALLATION OF SEDIMENT FENCING.
- ). ANY SAND USED IN THE CONCRETE CURING PROCESS (SPREAD OVER THE SURFACE) WILL BE REMOVED AS SOON AS POSSIBLE AND WITHIN 10 WORKING DAYS FROM PLACEMENT
- . WATER WILL BE PREVENTED FROM ENTERING THE PERMANENT DRAINAGE SYSTEM UNLESS IT IS RELATIVELY SEDIMENT FREE, I.E. THE CATCHMENT AREA HAS BEEN PERMANENTLY LANDSCAPED AND/OR ANY LIKELY SEDIMENT HAS BEEN FILTERED THROUGH AN APPROVED STRUCTURE.
- 2. TEMPORARY SOIL AND WATER MANAGEMENT STRUCTURES WILL BE REMOVED ONLY AFTER THE LANDS THEY ARE PROTECTING ARE REHABILITATED.
- 3. ACCEPTABLE RECEPTORS WILL BE PROVIDED FOR CONCRETE AND MORTAR SLURRIES, PAINTS, ACID WASHINGS, LIGHT-WEIGHT WASTE MATERIALS AND LITTER.
- 4. ANY EXISTING TREES WHICH FORM PART OF THE FINAL LANDSCAPING PLAN WILL BE PROTECTED FROM CONSTRUCTION ACTIVITIES BY:
- a. PROTECTING THEM WITH BARRIER FENCING OR SIMILAR MATERIALS INSTALLED OUTSIDE THE DRIP LINE
- b. ENSURING THAT NOTHING IS NAILED TO THEM
- c. PROHIBITING PAVING, GRADING, SEDIMENT WASH OR PLACING OF STOCKPILES WITHIN THE DRIP LINE EXCEPT UNDER THE FOLLOWING CONDITIONS.
- (I) ENCROACHMENT ONLY OCCURS ON ONE SIDE AND NO CLOSER TO THE TRUNK THAN EITHER 1.5 METRES OR HALF THE DISTANCE BETWEEN TH OUTER EDGE OF THE DRIP LINE AND THE TRUNK, WHICH EVER IS THE **GREATER**
- (II) A DRAINAGE SYSTEM THAT ALLOWS AIR AND WATER TO CIRCULATE THROUGH THE ROOT ZONE (E.G. A GRAVEL BED) IS PLACED UNDER ALL FILL LAYERS OF MORE THAN 300 MILLIMETRES DEPTH
- (III) CARE IS TAKEN NOT TO CUT ROOTS UNNECESSARILY NOR TO COMPACT THE SOIL AROUND THEM.

EPA AND COUNCIL REQUIREMENTS MUST BE ADHERED TO REGARDING LEVEL OF NOISE AND WORKING HOURS TO ENSURE THAT RESIDENTS AND OTHER APPLICABLE NEIGHBORS TO THE SITE ARE NOT DISTURBED UNREASONABLY. THE GENERATION OF NOISE MUST BE MINIMISED.

DAC

DAC

DAC

DUST MUST BE MINIMISED TO ENSURE THERE IS NO HEALTH RISK OR LOSS OF AMENITY.

#### STAGING OF WORKS

STRIPPING WORKS ARE TO BE STAGED TO MINIMISE EXTENT OF EXPOSED AREA. WEATHER CONDITIONS TO BE ASSESSED PRIOR TO UNDERTAKING

#### STOCKPILE PROTECTION

SEDIMENT RETENTION STRUCTURES TO BE PLACED DOWNSLOPE OF ANY STOCKPILES. STOCKPILE IN PLACE > 28 DAYS TO BE TEMPORARILY GRASSED.

#### VEHICLE AND ROAD MANAGEMENT

SITE ACCESS TO BE RESTRICTED TO ALLOCATED TRUCK ROUTES. EXTERNAL ROADS TO BE SWEPT REGULARLY FOR DURATION OF WORKS.

# **EXISTING UNDERGROUND**

#### **SERVICES NOTES**

THE LOCATIONS OF UNDERGROUND SERVICES SHOWN IN THIS SET OF DRAWINGS HAVE BEEN PLOTTED FROM SURVEY INFORMATION AND SERVICE AUTHORITY INFORMATION. THE SERVICE INFORMATION HAS BEEN PREPARED ONLY TO SHOW THE APPROXIMATE POSITIONS OF ANY KNOWN SERVICES AND MAY NOT BE AS CONSTRUCTED OR ACCURATE. CARDNO CAN NOT GUARANTEE THAT THE SERVICES INFORMATION SHOWN ON THESE DRAWINGS ACCURATELY INDICATES THE PRESENCE OR ABSENCE OF SERVICES OR THEIR LOCATION AND WILL ACCEPT NO LIABILITY FOR INACCURACIES IN THE SERVICES INFORMATION SHOWN FROM ANY CAUSE WHATSOEVER.

CONTRACTORS SHALL TAKE DUE CARE WHEN EXCAVATING ONSITE INCLUDING HAND EXCAVATION WHERE NECESSARY. CONTRACTORS ARE TO CONTACT THE RELEVANT SERVICE AUTHORITY PRIOR TO COMMENCEMENT OF EXCAVATION WORKS. CONTRACTORS ARE TO UNDERTAKE A SERVICES SEARCH, PRIOR TO COMMENCEMENT OF WORKS ON SITE. SEARCH RESULTS ARE TO BE KEPT ON SITE AT ALL TIMES.

# STORMWATER DRAINAGE NOTES

- STORMWATER DESIGN CRITERIA:
- (A) AVERAGE RECURRENCE INTERVAL:
- 5 YEAR ARI PIPED DRAINAGE 100 YEAR ARI OVERLAND FLOW
- (B) RAINFALL INTENSITIES: TIME OF CONCENTRATION: 5 MINUTES
- 5 YEAR ARI= 126mm/hr 100 YEAR ARI= 219mm/hr
- PIPES 375 DIA. AND LARGER TO BE REINFORCED CONCRETE CLASS '2' APPROVED SPIGOT AND SOCKET WITH RUBBER RING JOINTS. U.N.O.
- PIPES 300 DIA AND LESS SHALL BE DWV GRADE (CLASS SN8) uPVC WITH SOLVENT WELDED JOINTS.
- 4. EQUIVALENT STRENGTH FRC PIPES MIN CLASS 3 MAY BE USED SUBJECT TO PRIOR APPROVAL BY PENRITH CITY COUNCIL.
- ALL PIPES ARE TO BE UNIFORMLY SUPPORTED ALONG THE LENGTH OF THE BARREL BY SUITABLE FILL MATERIAL. REFER TO BEDDING SUPPORT
- PIPES WITH SOCKETS SHALL BE LAID IN BEDDING WHERE SUITABLE RECESSES HAVE BEEN PROVIDED TO ENSURE PIPES DO NOT BEAR ON THEIR SOCKETS.
- PIPES TO BE INSTALLED TO TYPE HS1 SUPPORT IN ACCORDANCE WITH AS 3725 (2007) IN ALL CASES BACKFILL TRENCH WITH SAND TO 300mm ABOVE PIPE. WHERE PIPE IS UNDER PAVEMENTS BACKFILL REMAINDER OF TRENCH TO UNDERSIDE OF PAVEMENT WITH SAND OR APPROVED GRANULAR MATERIAL COMPACTED IN 150mm LAYERS TO MINIMUM 98% STANDARD MAXIMUM DRY DENSITY IN ACCORDANCE WITH AS 1289 5.2.1. (OR A DENSITY INDEX OF NOT LESS THAN 75).
- REFER TO AS/NZS 3725:2007 TABLE B1 FOR REQUIRED FILL DEPTHS ABOVE PIPE BARREL PRIOR TO USE OF COMPACTION MACHINERY OR TRAVERSING OF PIPES BY GENERAL SITE EQUIPMENT.
- WHERE WORKING METHODS REQUIRE HIGHER CLASS PIPE, THE CONTRACTOR SHALL REFER TO AS 3725 (2007) TO DETERMINE THE APPROPRIATE PIPE CLASS. PROPOSED PIPE CLASS SHALL BE REVIEWED BY CARDNO PRIOR TO INSTALLATION.
- 0. ALL INTERNAL WORKS WITHIN PROPERTY BOUNDARIES ARE TO COMPLY WITH THE REQUIREMENTS OF AS 3500.3 (2015).
- 1. THE USE OF PRECAST PITS IS ONLY PERMITTED WITH THE PRIOR APPROVAL OF PENRITH CITY COUNCIL.
- 12. ENLARGERS, CONNECTIONS AND JUNCTIONS TO BE PREFABRICATED FITTINGS WHERE PIPES ARE LESS THAN 300 DIA.
- 13. WHERE SUBSOIL DRAINS PASS UNDER FLOOR SLABS AND VEHICULAR PAVEMENTS, UNSLOTTED uPVC DWV SEWER GRADE PIPE IS TO BE USED.
- 14. CARE IS TO BE TAKEN WITH LEVELS OF STORMWATER LINES. GRADES SHOWN ARE NOT TO BE REDUCED WITHOUT APPROVAL. 15. GRATES AND COVERS SHALL CONFORM TO AS 3996. MINIMUM CLASS C.
- UNLESS NOTED OTHERWISE. 16. ALL BOX CULVERTS SHALL BE STRUCTURALLY DESIGNED BY THE

MANUFACTURER AND DELIVERED TO SITE AS FIT FOR PURPOSE.

17. AT ALL TIMES DURING CONSTRUCTION OF STORMWATER PITS, ADEQUATE SAFETY PROCEDURES SHALL BE TAKEN TO ENSURE AGAINST THE POSSIBILITY OF PERSONNEL FALLING DOWN PITS.

# STORMWATER DRAINAGE NOTES

### CONTINUED

18. ALL EXISTING STORMWATER DRAINAGE LINES AND PITS THAT ARE TO REMAIN ARE TO BE INSPECTED AND CLEANED. DURING THIS PROCESS ANY PART OF THE STORMWATER DRAINAGE SYSTEM THAT WARRANTS REPAIR SHALL BE REPORTED TO THE SUPERINTENDENT/ENGINEER FOR FURTHER DIRECTIONS.

#### TELSTRA - DUTY OF CARE NOTE

TELSTRA'S PLANS SHOW ONLY THE PRESENCE OF CABLES AND PLANT. THEY ONLY SHOW THEIR POSITION RELATIVE TO ROAD BOUNDARIES, PROPERTY FENCES ETC. AT THE TIME OF INSTALLATION AND TELSTRA DOES NOT WARRANT OR HOLD OUT THAT SUCH PLANS ARE ACCURATE THEREAFTER DUE TO CHANGES THAT MAY OCCUR OVER TIME. DO NOT ASSUME DEPTH OR ALIGNMENT OF CABLES OR PLANT AS THESE VARY SIGNIFICANTLY. THE CONTRACTOR HAS A DUTY OF CARE WHEN **EXCAVATING NEAR TELSTRA CABLES AND PLANT.** BEFORE USING MACHINE EXCAVATORS TELSTRA PLANT MUST FIRST BE PHYSICALLY EXPOSED BY SOFT DIG POTHOLING TO IDENTIFY IT'S LOCATION TELSTRA WILL SEEK COMPENSATION FOR DAMAGES CAUSED TO IT'S PROPERTY AND LOSSES CAUSED TO TELSTRA AND IT'S CUSTOMERS.

### **SURVEY NOTES**

THE EXISTING SITE CONDITIONS SHOWN ON THE FOLLOWING DRAWINGS HAVE BEEN INVESTIGATED BY RPS GROUP PLC (FORMERLY WHELANS INSITES), BEING REGISTERED SURVEYORS. THE INFORMATION IS SHOWN TO PROVIDE A BASIS FOR DESIGN, CARDNO DOES NOT GUARANTEE THE ACCURACY OR COMPLETENESS OF THE SURVEY BASE OR ITS SUITABILITY AS A BASIS FOR CONSTRUCTION DRAWINGS.

SHOULD DISCREPANCIES BE ENCOUNTERED DURING CONSTRUCTION BETWEEN THE SURVEY DATA AND ACTUAL FIELD DATA, CONTACT CARDNO.

THE FOLLOWING NOTES HAVE BEEN TAKEN DIRECTLY FROM THE ORIGINAL SURVEY DOCUMENTS.

- ORIGIN OF MGA BASED SITE CO-ORDINATES FROM PM 147113 AND PLANE DISTANCES HAVE BEEN USED.
- CO-ORDINATES FOR PM 147113 WERE DEDUCED BY WHELANS FROM SUROUNDING SSM & PM'S ON PUBLIC RECORD. CO-ORDINATES FOR PM 147113 HAVE BEEN ADOPTED AS 292202.160E 6266005.820N
- CONTOUR INTERVAL 0.25m
- LEVELS ARE BASED ON AUSTRALIAN HEIGHT DATUM (AHD) USING SSM 79753 WITH RL OF 19.758 (ACC 2) LOCATED ON LINKS ROAD.
- FEATURES SHOWN INCLUDING TREES AND LEVELS ARE TO BE USED ONLY FOR CONCEPT PLANNING DESIGN. DATA SHOWN SHOULD NOT BE USED FOR CONSTRUCTION PURPOSES. PRIOR TO CONSTRUCTION ANY FEATURE OR LEVEL SHOULD BE VERIFIED IF THE LOCATION OR HEIGHT
- 6. TREES SHOWN HAVE A TRUNK DIAMETER OF 300MM OR GREATER.

IS TO HAVE SIGNIFICANT IMPACT ON DESIGN OR CONSTRUCTION.

TREE CAPTURE CONFIDENCE INTERVAL OF 99%

#### ROOF WATER KERB OUTLETS

CITY COUNCILS CIVIL WORKS SPECIFICATION AT EACH LOT WHERE INTERALLOTMENT DRAINAGE IS NOT PROVIDED

KERB OUTLETS TO BE PROVIDED IN ACCORDANCE WITH PENRITH


- KERB OUTLETS ARE TO BE CONSTRUCTED AT THE SAME TIME KERBS ARE POURED.
- ALIGNMENT OF KERB OUTLET PIPE TO BE ADJUSTED ON SITE TO AVOID SERVICE CLASHES.

# STREET FURNITURE


- ALL LIGHT POLES, STREET NAMES AND BUS SHELTERS IN THIS SUBDIVISION WILL BE GALVANISED BLACK POWDER COATED TO THE SATISFACTION OF PENRITH CITY COUNCIL. FURTHER THAT THESE LIGHT POLES WILL COMPLY WITH COUNCIL'S SPECIFICATIONS.
- ALL LIGHT POLES ARE TO BE TYPE 'MACARTHUR'. REFER ELECTRICAL DESIGN DRAWINGS.

# REINFORCEMENT NOTES

- REINFORCEMENT IS REPRESENTED DIAGRAMMATICALLY. IT IS NOT NECESSARILY SHOWN IN TRUE PROJECTION.
- SPLICES IN THE REINFORCEMENT SHALL BE MADE ONLY IN THE POSITIONS SHOWN. THE WRITTEN APPROVAL OF THE ENGINEER SHALL BE OBTAINED FOR ANY OTHER SPLICES. WHERE THE LAP LENGTH IS NOT SHOWN IT SHALL BE SUFFICIENT TO DEVELOP THE FULL STRENGTH OF THE REINFORCEMENT.
- WELDING OF REINFORCEMENT WILL NOT BE PERMITTED UNLESS SHOWN ON THE STRUCTURAL DRAWINGS OR APPROVED IN WRITING BY THE ENGINEER.
- REINFORCEMENT SYMBOLS -N - DENOTES GRADE 400N TEMPCORE DEFORMED BARS TO AS 1302 R - DENOTES GRADE 250R HOT ROLLED PLAIN BARS TO AS 1302 SL - DENOTES HARD-DRAWN WIRE REINFORCING FABRIC TO AS 1304
- W DENOTES HARD-DRAWN PLAIN WIRE TO AS 1303 REINFORCEMENT COGS AND EXTENSIONS TO BE IN ACCORDANCE WITH

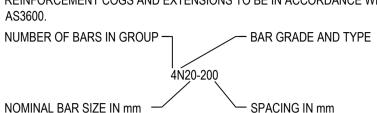

- THE FIGURES FOLLOWING THE FABRICS SYMBOL 'SL' IS THE REFERENCE NUMBER FOR FABRIC TO AS 1304. ALL REINFORCEMENT FABRIC SHALL COMPLY WITH AS1303 AND
- AS1304 AND SHALL BE SUPPLIED AS FLAT SHEETS.

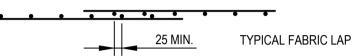

BUNDLED BARS SHALL BE TIED TOGETHER AT 30 BAR DIAMETER CENTRES WITH 3 WRAPS OF WIRE. PLACE SUFFICIENT BAR CHAIRS UNDER BOTTOM REINFORCING RODS AND TOP CROSSRODS IN SLABS TO ALLOW THEM TO BE SUPPORTED IN THEIR CORRECT POSITIONS DURING CONCRETING (NOT GREATER

FABRIC SHALL BE LAPPED 2 TRANSVERSE WIRES PLUS 50mm.

REINFORCEMENT LAYERS DENOTED THUS UNO -TT - DENOTES TOP BARS LAID LAST IN TOP T - DENOTES TOP BARS LAID FIRST IN TOP B - DENOTES BOTTOM BARS LAID SECOND IN BOTTOM BB - DENOTES BOTTOM BARS LAID FIRST IN BOTTOM WHERE TRANSVERSE TIE BARS ARE NOT SHOWN PROVIDE N12-300

THAN 900mm CENTRES BOTH WAYS)

- SPLICED WHERE NECESSARY AND LAP WITH MAIN BARS 450mm UNLESS NOTED OTHERWISE. MINIMUM LAP LENGTHS UNLESS NOTED OTHERWISE SHALL BE -
- 500 FOR N12 BARS 600 FOR N16 BARS
- 900 FOR N20 BARS 1000 FOR N24 BARS
- 1200 FOR N28 BARS 1500 FOR N32 BARS 1800 FOR N36 BARS

#### **CONCRETE NOTES** ALL WORKMANSHIP AND MATERIALS SHALL BE IN ACCORDANCE WITH AS

3600 CURRENT EDITION WITH AMENDMENTS, EXCEPT WHERE VARIED BY

THE CONTRACT DOCUMENTS. CONCRETE QUALITY ALL REQUIREMENTS OF THE CURRENT ACSE CONCRETE SPECIFICATION

OCUMENT 1 SHALL APPLY TO THE FORMWORK, REINFORCEMENT AND ONCRETE UNLESS NOTED OTHERWISE.							
ELEMENT AS 3600 F'c MPa SPECIFIED NOMINAL							
	AT 28 DAYS	SLUMP	AGG. SIZE				
VEHICULAR BASE	32	60	20				
KERBS AND PATHS	25	80	20				
PITS, FOUNDATIONS &	40	80	20				
CULVERT BASE SLABS	CULVERT BASE SLABS						

- CEMENT TYPE SHALL BE (ACSE SPECIFICATION) TYPE SL - PROJECT CONTROL TESTING SHALL BE CARRIED OUT IN ACCORDANCE WITH

- NO ADMIXTURES SHALL BE USED IN CONCRETE UNLESS APPROVED IN
- WRITING BY CARDNO. CLEAR CONCRETE COVER TO ALL REINFORCEMENT FOR DURABILITY SHALL BE 40mm TOP AND 70mm FOR EXTERNAL EDGES UNLESS NOTED OTHERWISE ALL REINFORCEMENT SHALL BE FIRMLY SUPPORTED ON MILD STEEL

PLASTIC TIPPED CHAIRS, PLASTIC CHAIRS OR CONCRETE CHAIRS AT NOT

GREATER THAN 1m CENTRES BOTH WAYS. BARS SHALL BE TIED AT ALTERNATE INTERSECTIONS. THE FINISHED CONCRETE SHALL BE A DENSE HOMOGENEOUS MASS, COMPLETELY FILLING THE FORMWORK, THOROUGHLY EMBEDDING THE REINFORCEMENT AND FREE OF STONE POCKETS. ALL CONCRETE INCLUDING SLABS ON GROUND AND FOOTINGS SHALL BE COMPACTED


AND CURED IN ACCORDANCE WITH R.T.A. SPECIFICATION R83.

#### SITE BOUNDARY **BATTER SLOPE** EXTENT OF WORKS EXISTING STAGING BOUNDARY TREES TO BE REMOVED AS PART OF BULK EARTHWORKS PACKAGE. TREES TO BE RETAINED **BATTERS** LOT NUMBERS **KERB & GUTTER** K&G REFER PENRITH CITY COUNCIL STANDARD DETAIL. **ROLL KERB & GUTTER** RK&G REFER PENRITH CITY COUNCIL STANDARD DETAIL. DISH DRAIN DD REFER PENRITH CITY COUNCIL STANDARD DETAIL KERB ONLY KO REFER PENRITH CITY COUNCIL STANDARD DETAIL. PRAM RAMP REFER PENRITH CITY COUNCIL FOR DETAIL. INDICATIVE GARAGE/DRIVEWAY LOCATION ONLY. REFER BUILDERS REQUIREMENTS FOR DETAILS. STORMWATER PIPELINE STORMWATER DRAINAGE PITS CONCRETE HEADWALI DRAINAGE LINE No. 4\2 DRAINAGE PIT No. EXISTING WATER COURSES AS PER 1:10000 TOPOGRAPHIC MAPS SCOUR PROTECTION

PROPOSED WORKS LEGEND

— · · − 100.0 · − · · — PROPOSED CONTOURS

# **EXISTING WORKS LEGEND** TRANSGRID PYLON EXISTING CONTOURS TRANSGRID EASEMENT TRANSGRID OVERHEAD ELECTRICAL EXISTING SEWER \_\_\_\_\_ s \_\_\_\_

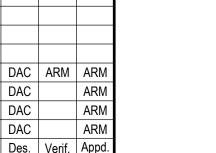



© Cardno Limited All Rights Reserved. his document is produced by Cardno Limited solely for the benefit of and use by the client in accordance with the erms of the retainer. Cardno Limited does not and shall no ssume any responsibility or liability whatsoever to any third party arising out of any use or reliance by third party on the content of this document.



Suite 3.01, Level 3, 3 Horwood Place

Parramatta, NSW 2150

Tel: 02 9496 7700 Fax: 02 9439 5170

Web: www.cardno.com.au

25.07.19 25.07.19 Date /erified ARM 25.07.19 Approved


**LENDLEASE** JORDAN SPRINGS EAST FOR APPROVAL STAGE 3C - CIVIL WORKS NOT TO BE USED FOR CONSTRUCTION PURPOSES DEVELOPMENT APPLICATION AHD GENERAL NOTES & LEGENDS CV-CARDNO-ST03C-1011 25.07.19

25.07.19


20.12.18


06.08.18


Date

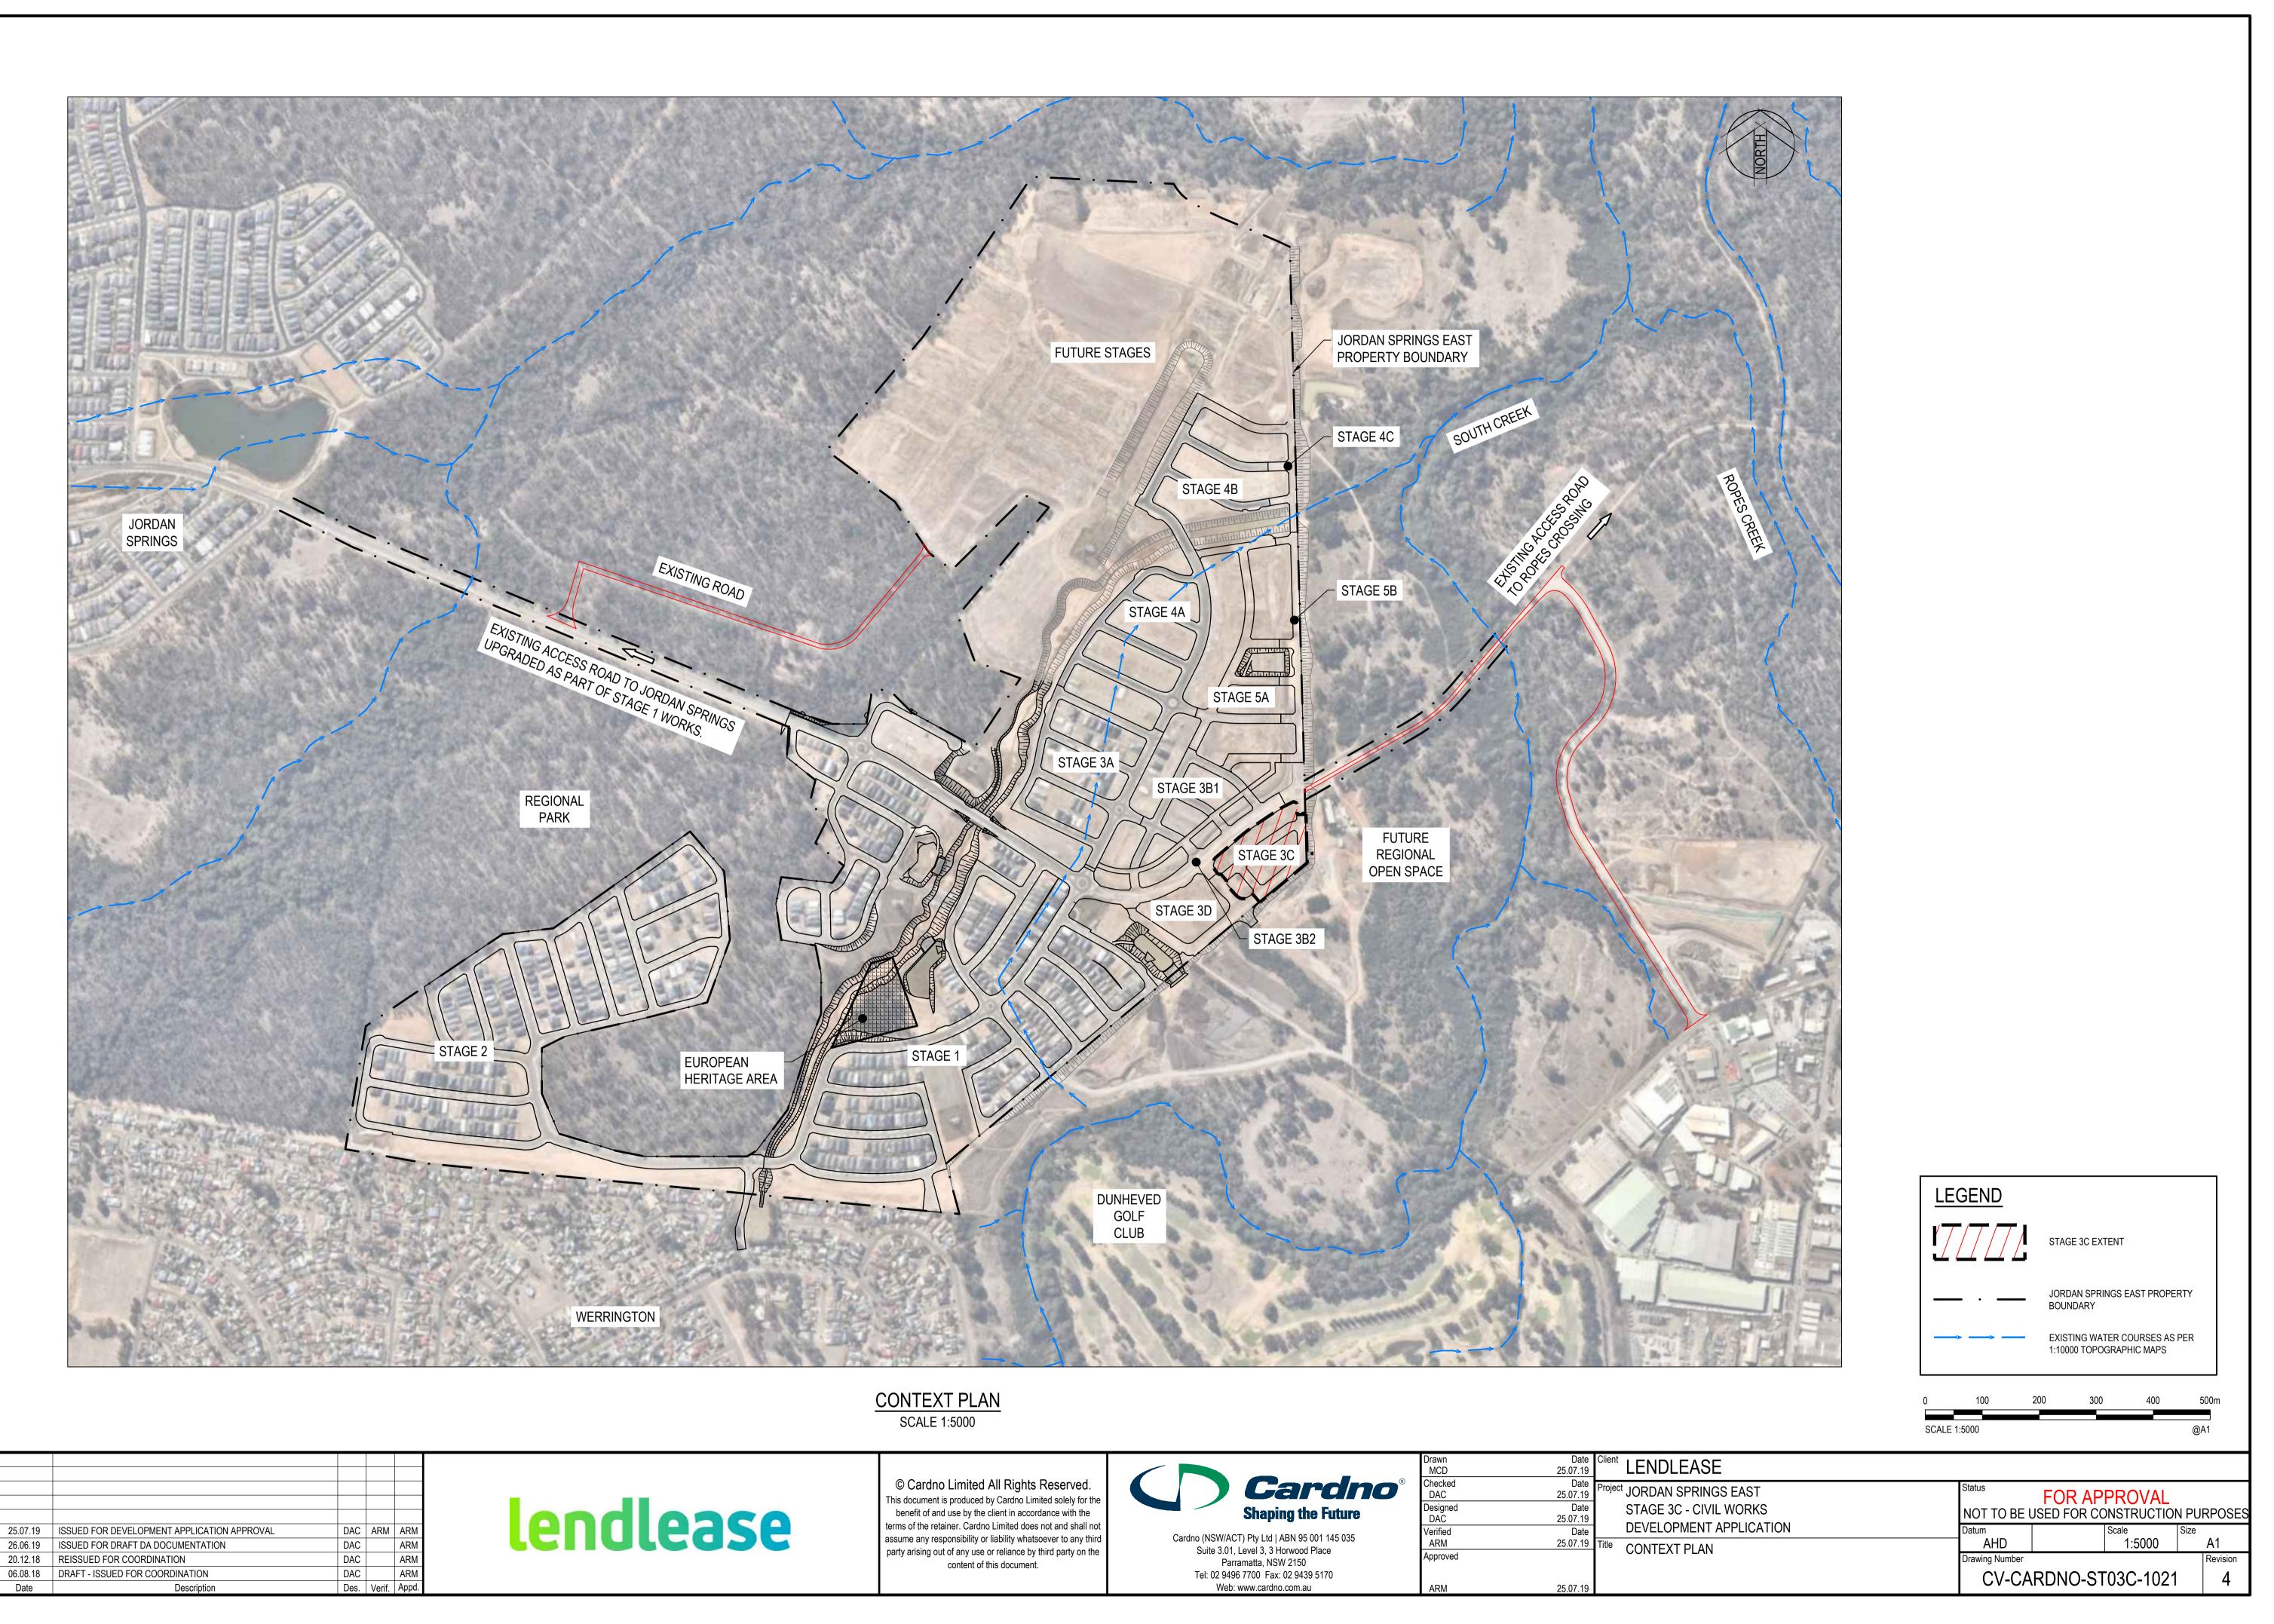


Document Set ID: 8836409 Version: 1, Version Date: 03/09/2019

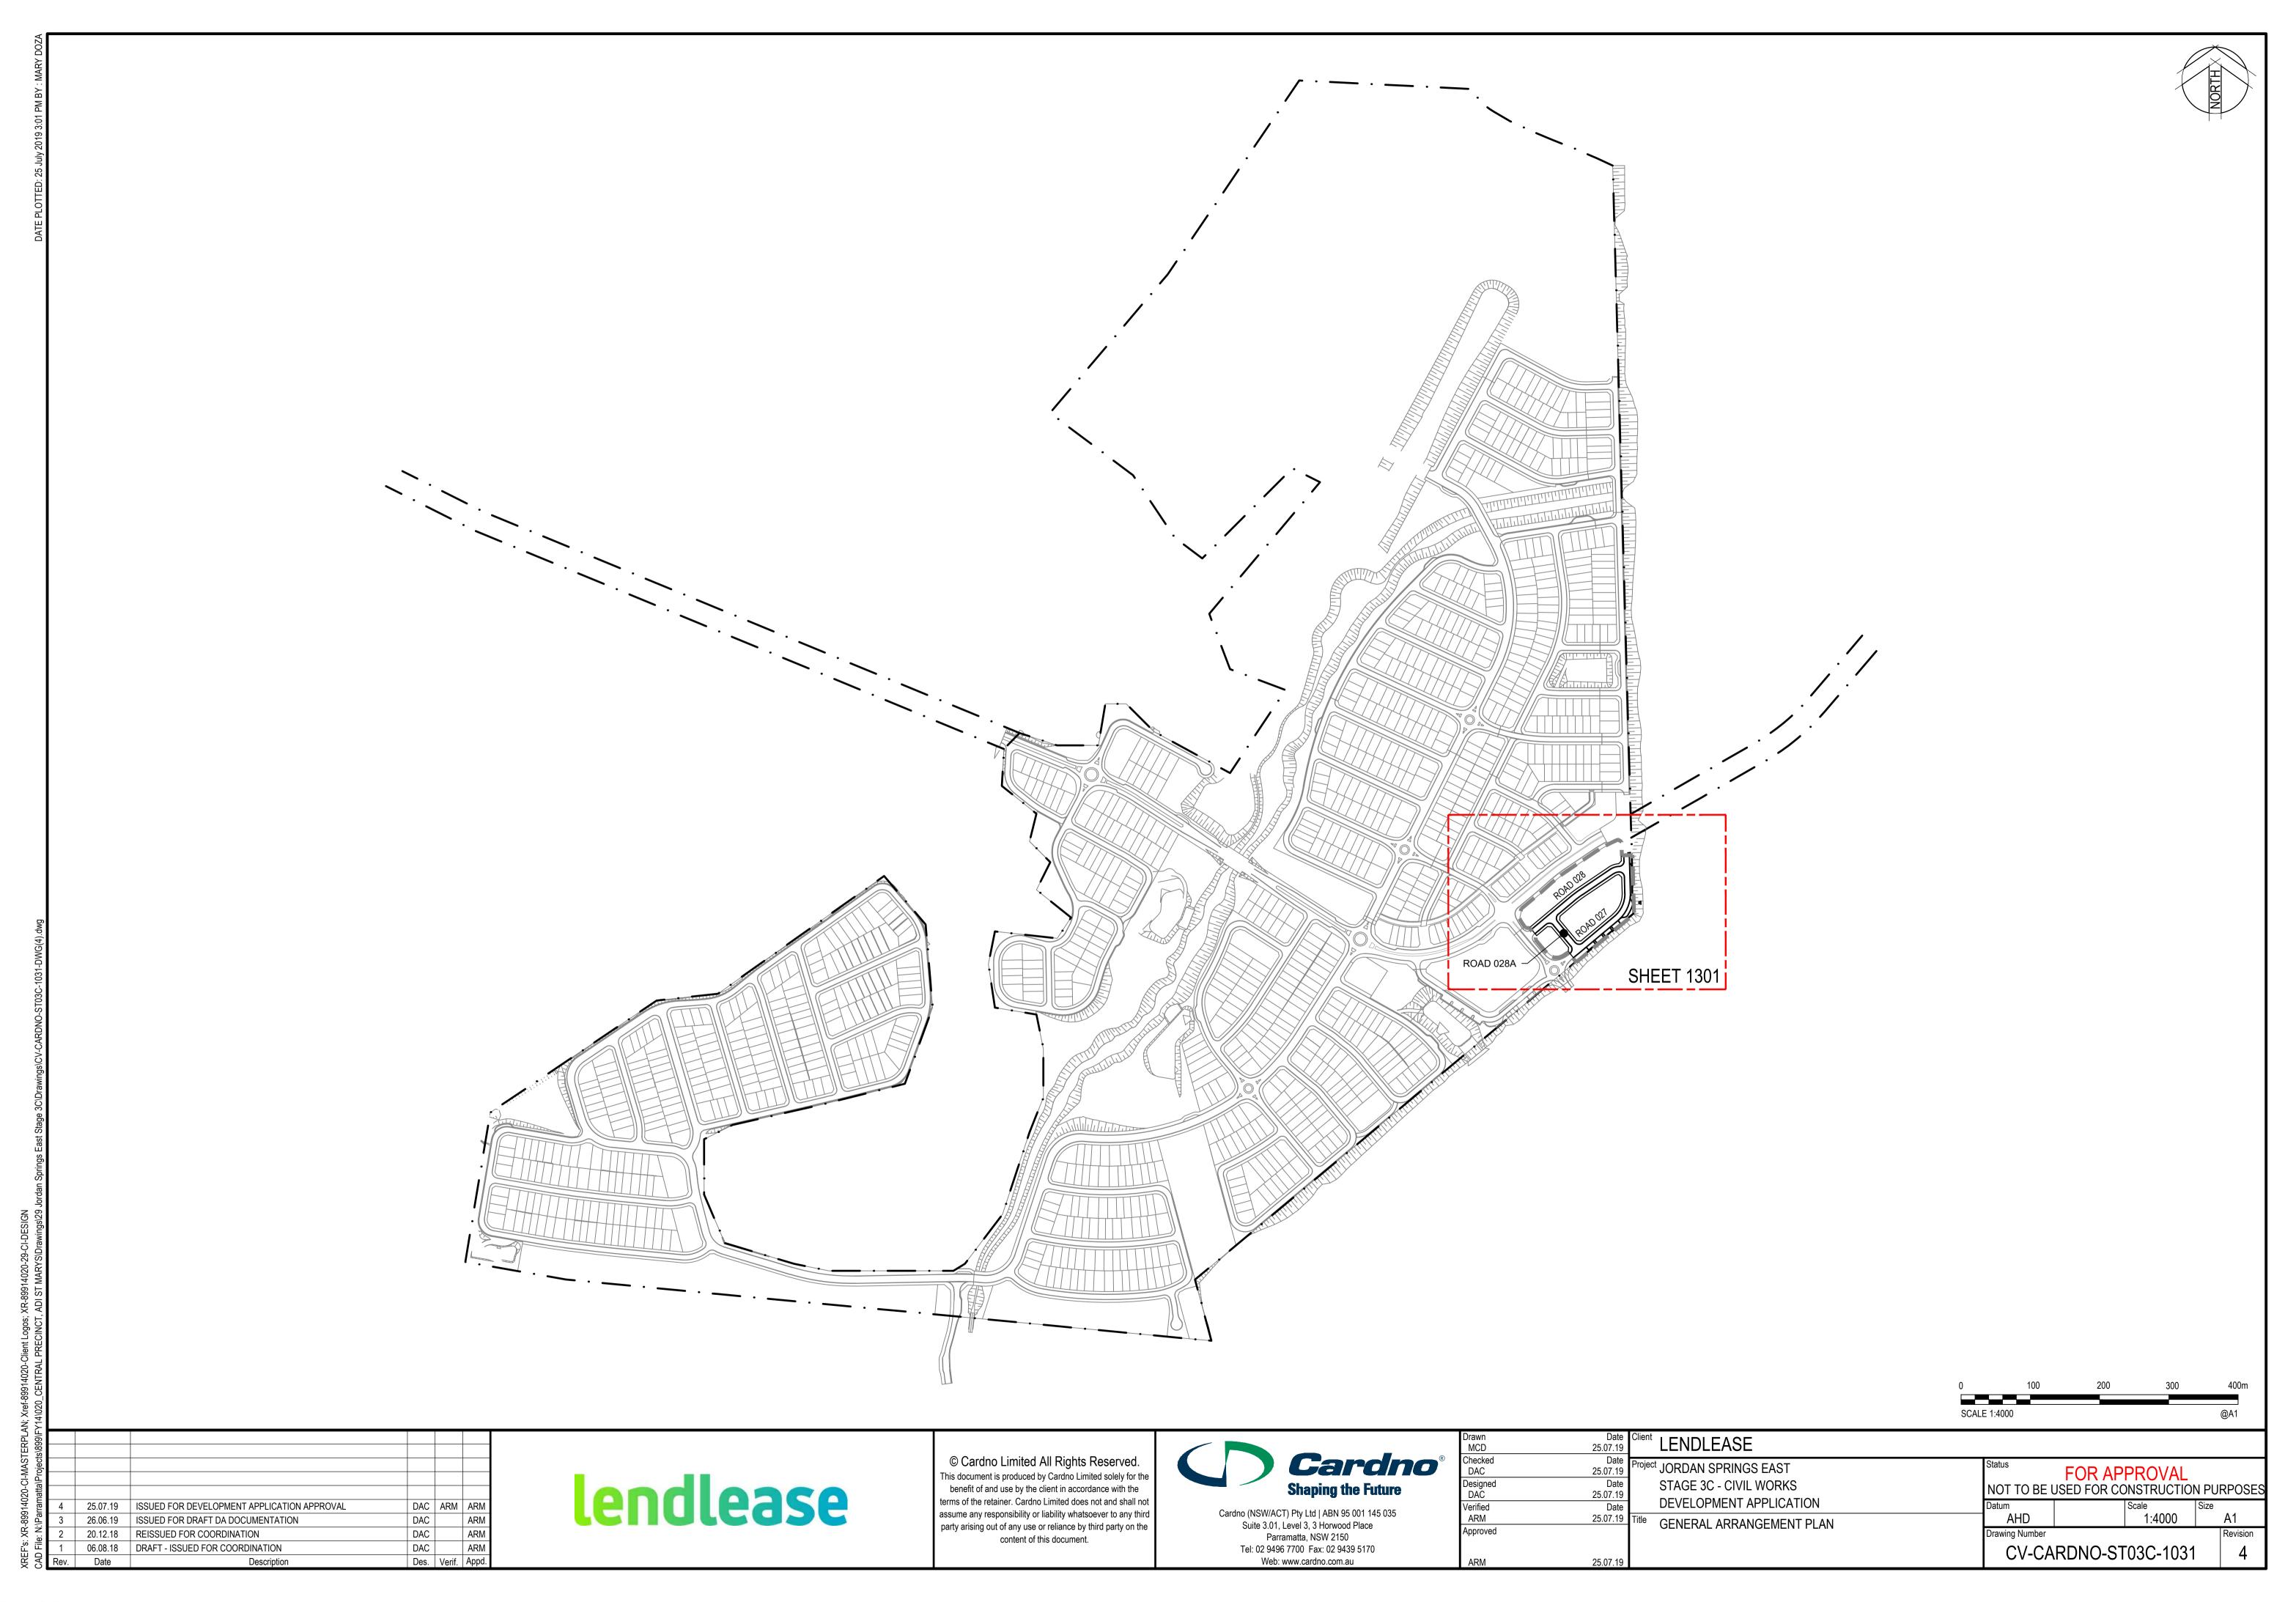

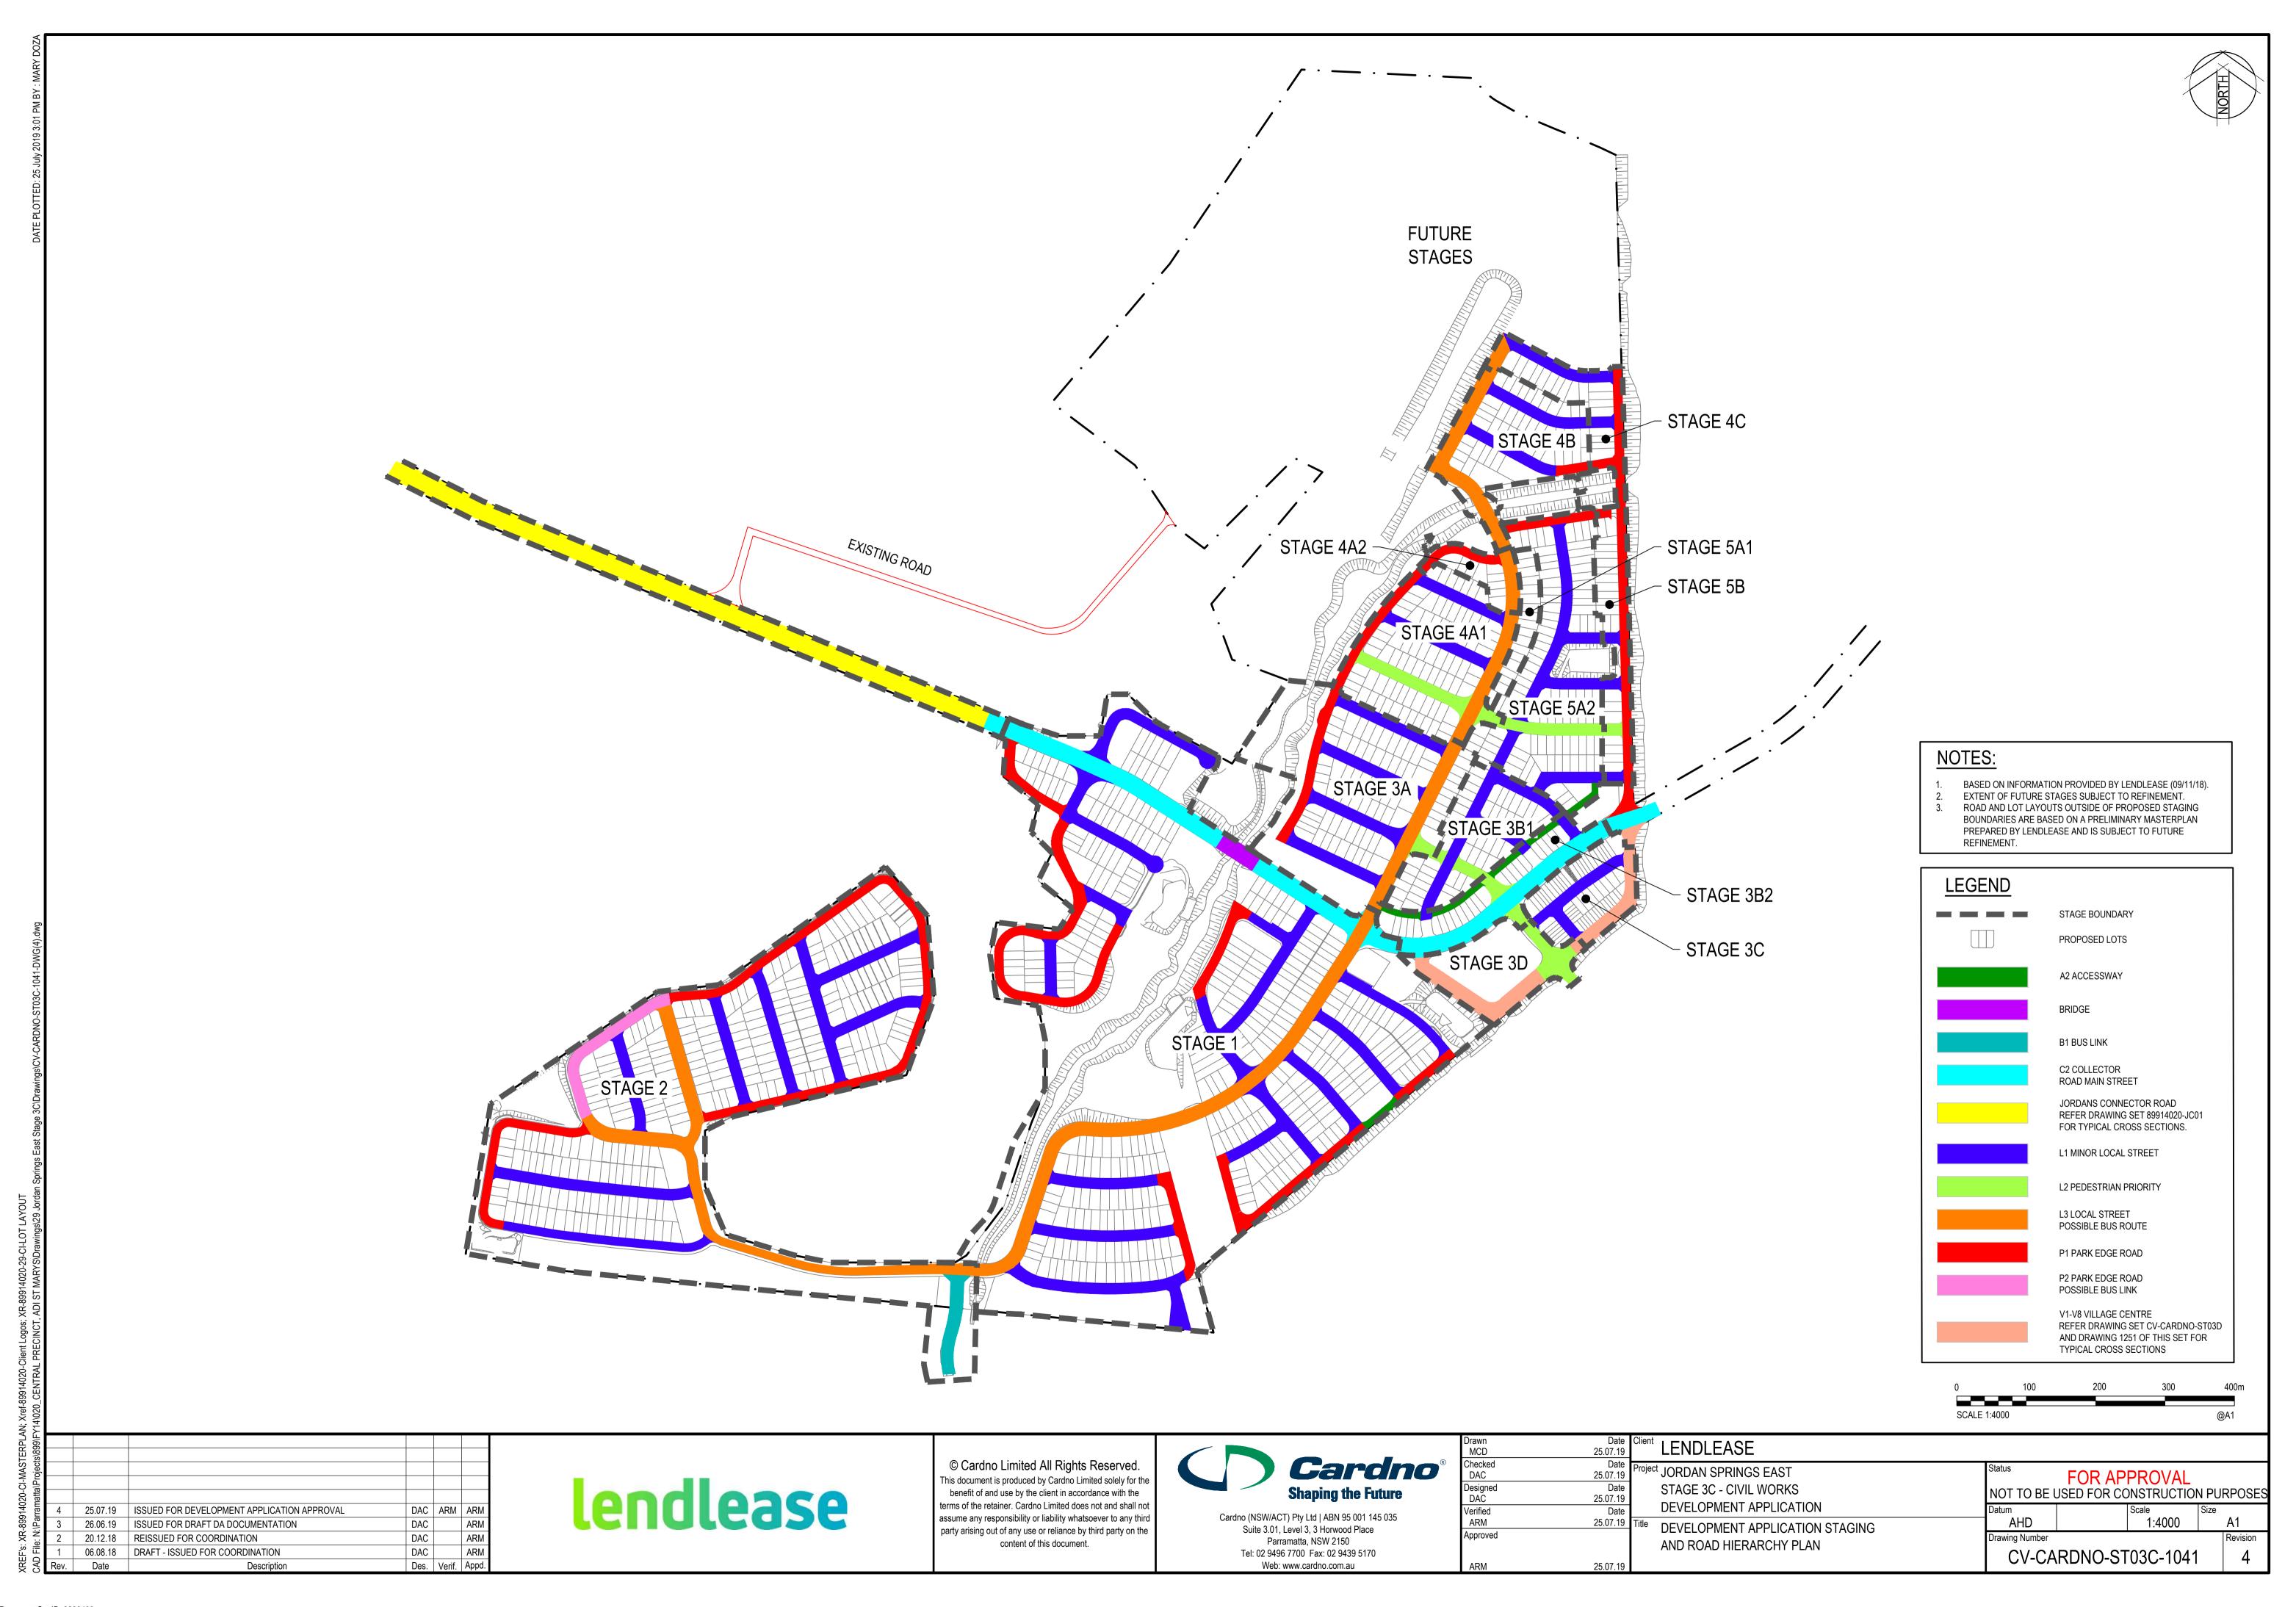

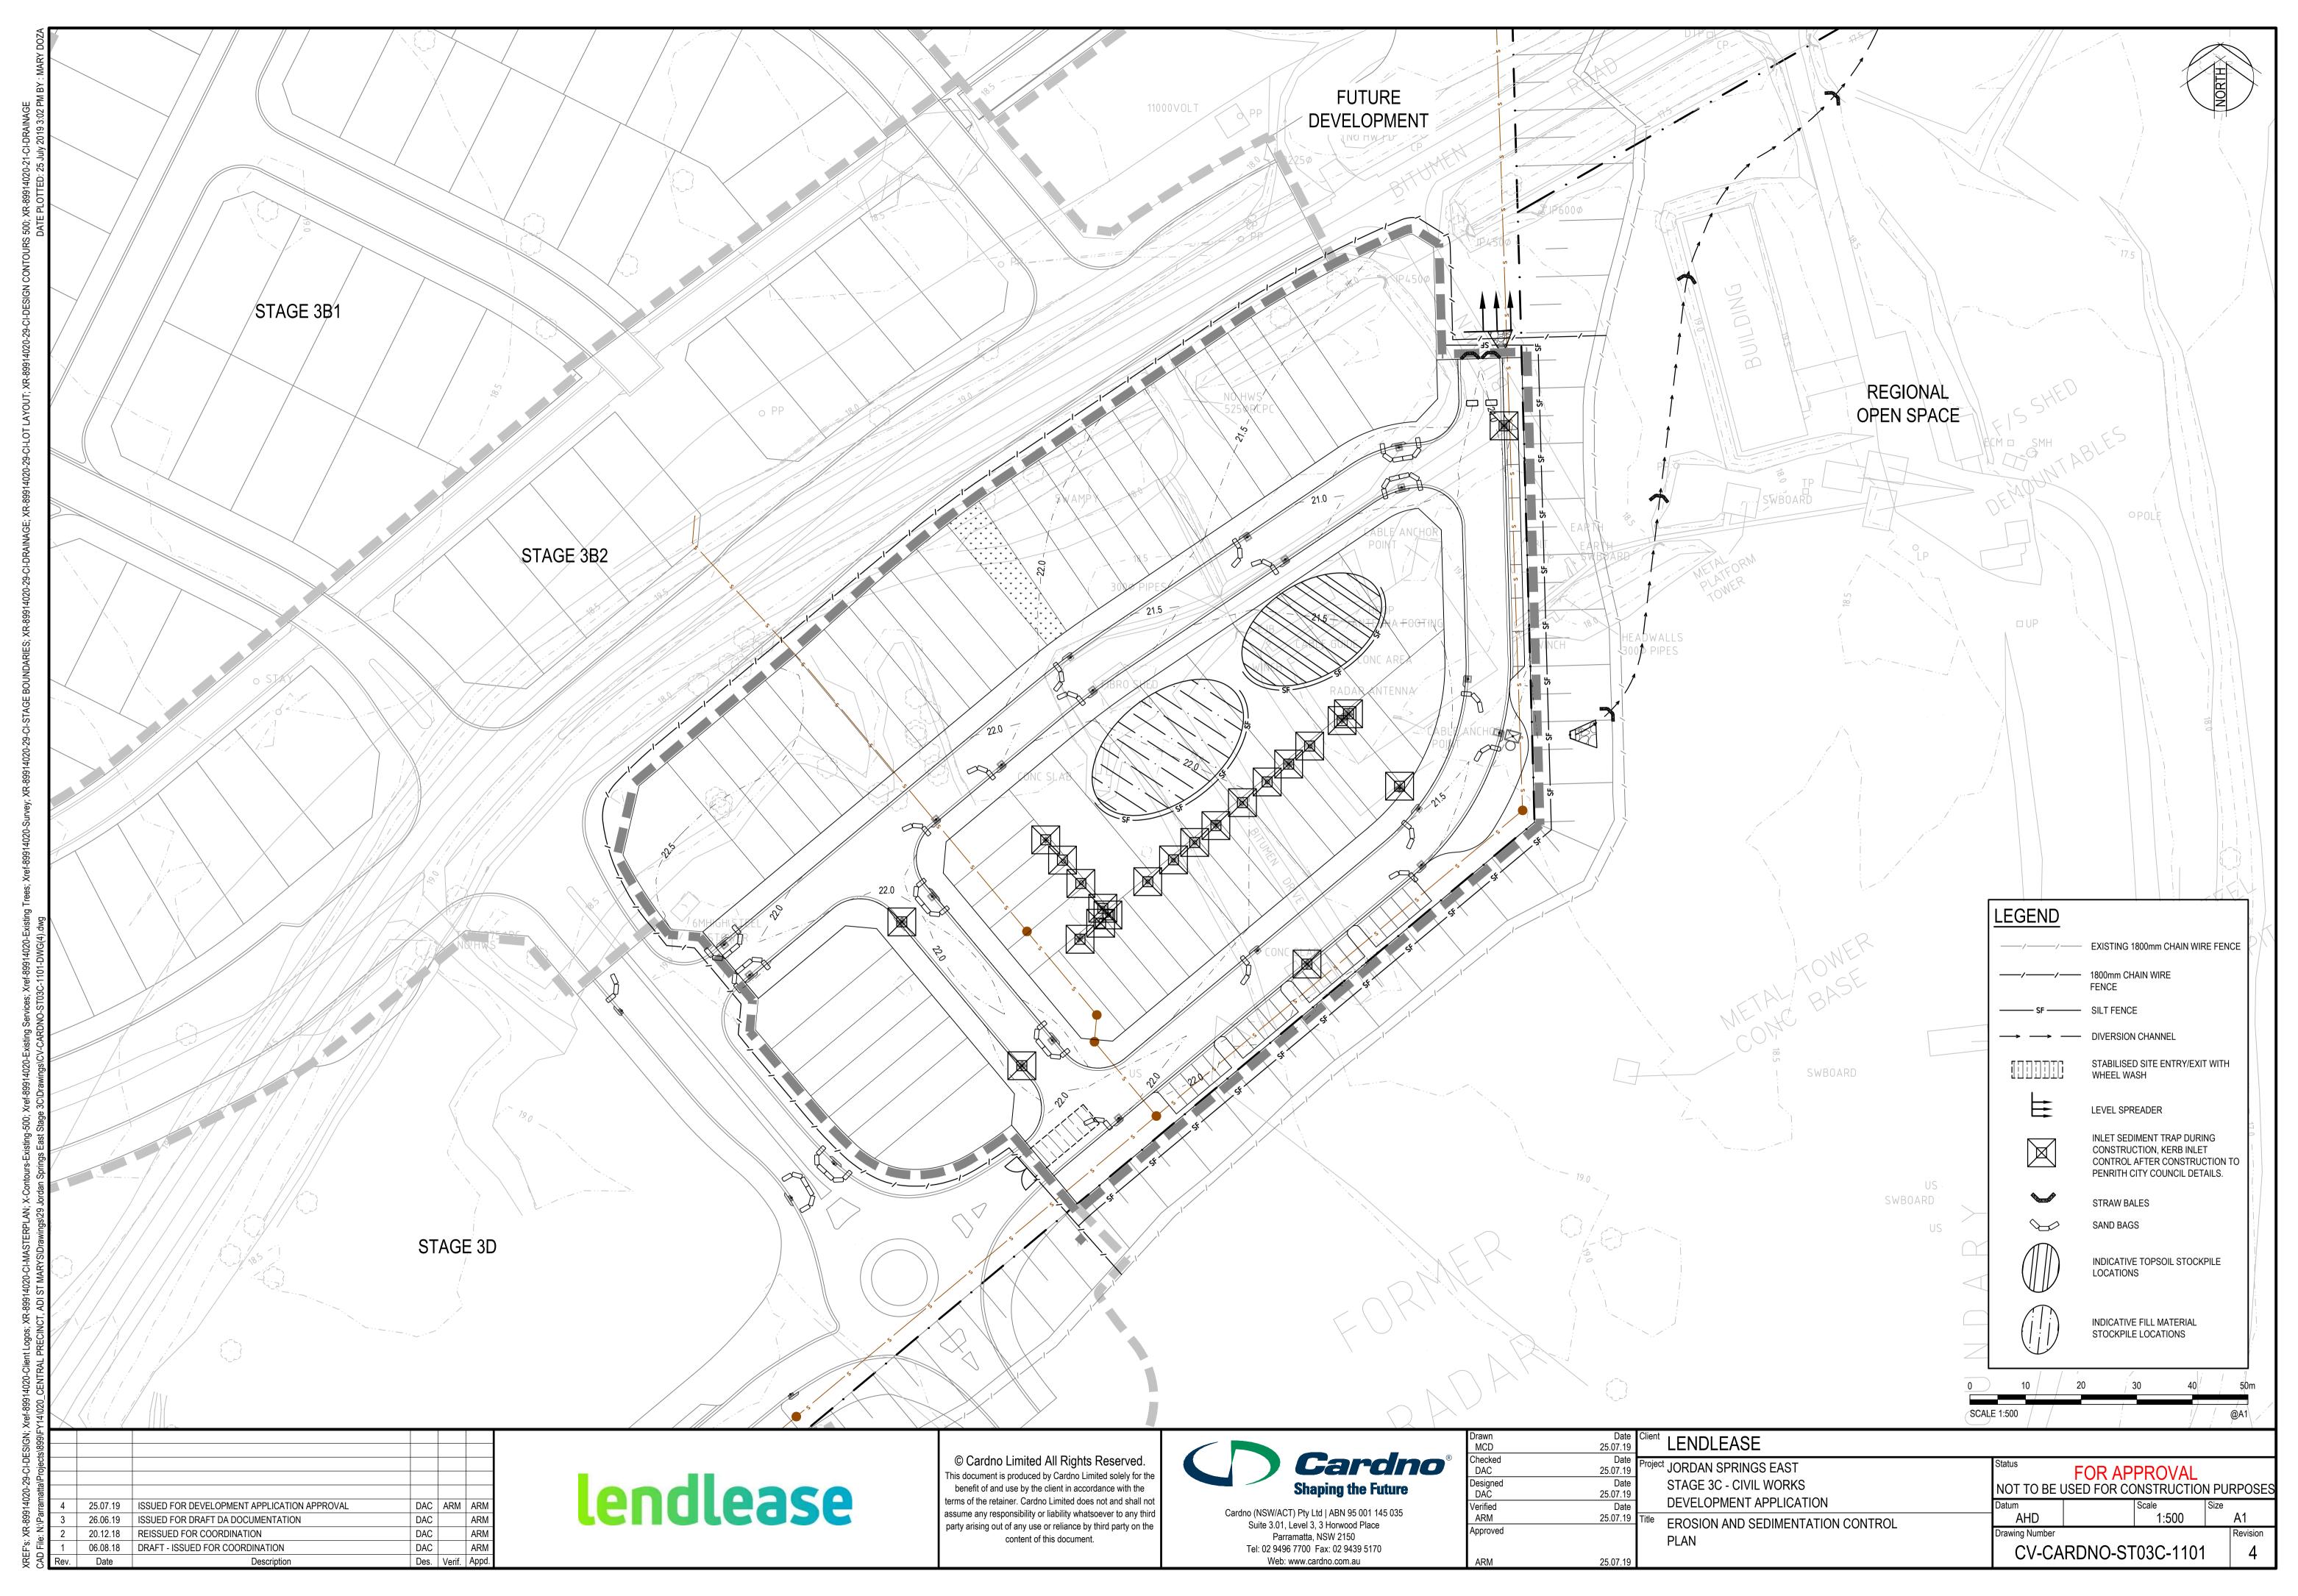

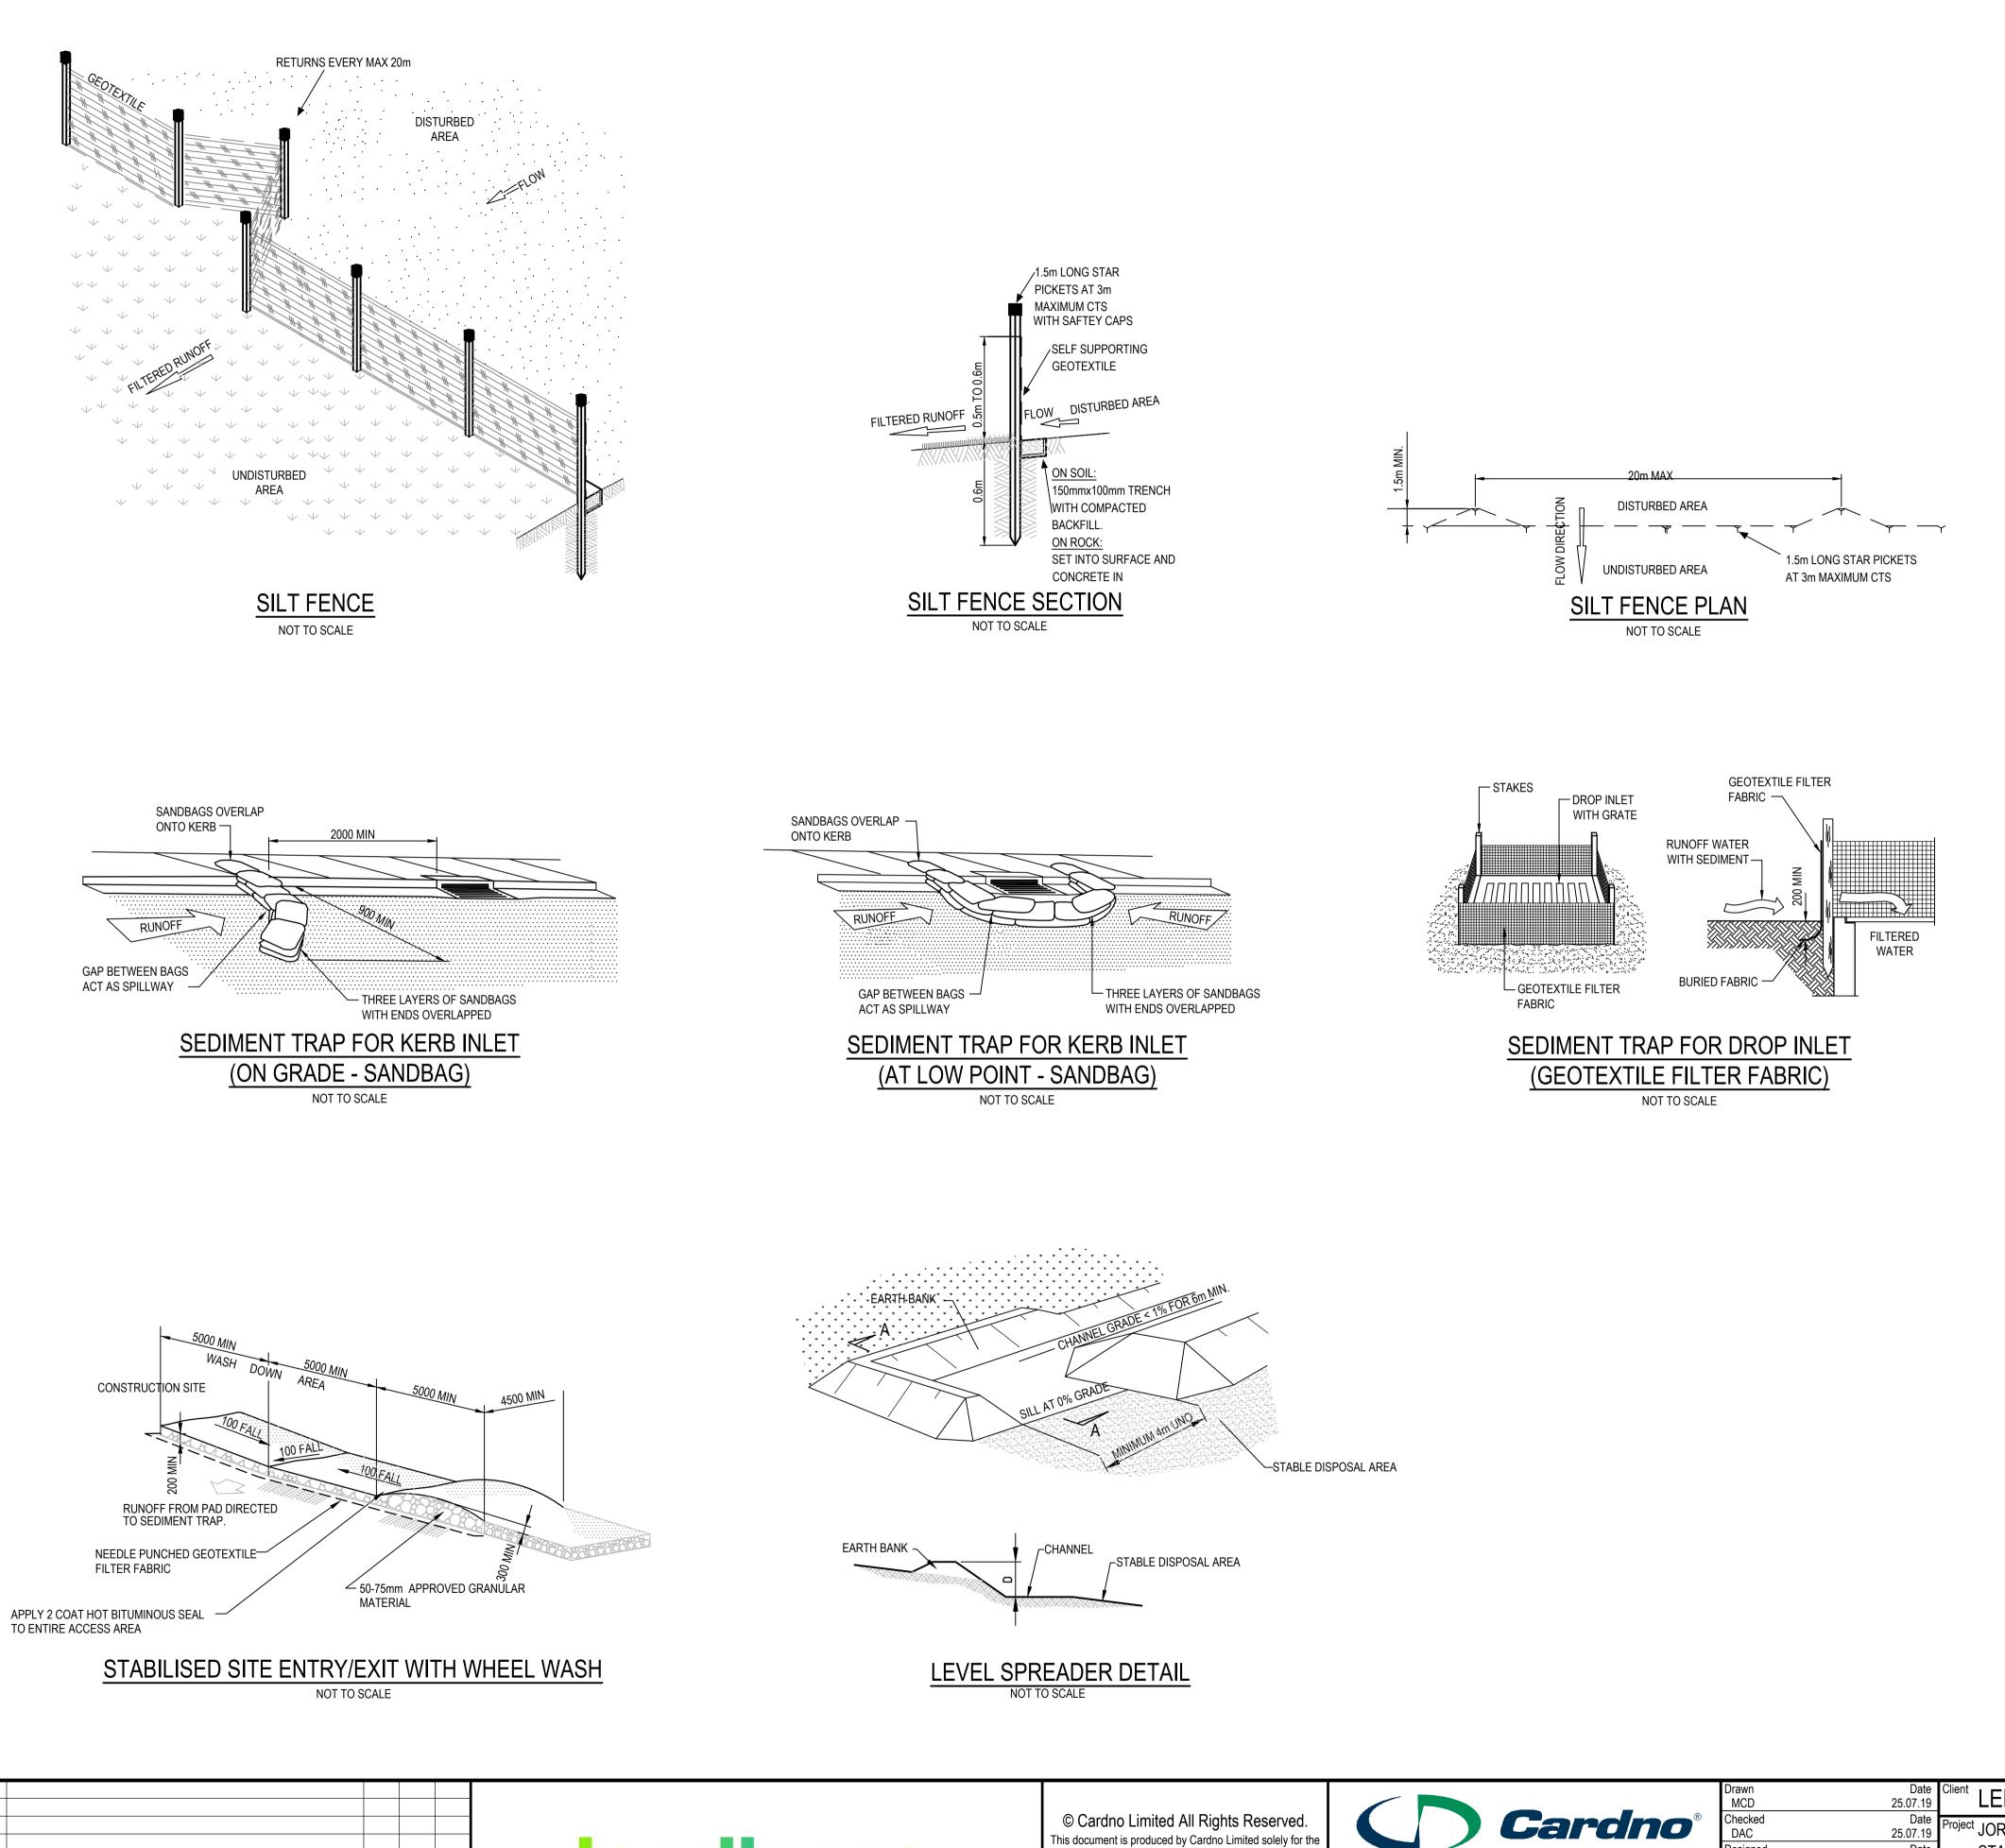

Client LENDLEASE roject JORDAN SPRINGS EAST FOR APPROVAL

NOT TO BE USED FOR CONSTRUCTION PURPOSES lendlease Date 25.07.19 STAGE 3C - CIVIL WORKS benefit of and use by the client in accordance with the DEVELOPMENT APPLICATION terms of the retainer. Cardno Limited does not and shall not Verified ARM Date assume any responsibility or liability whatsoever to any third Cardno (NSW/ACT) Pty Ltd | ABN 95 001 145 035 AHD AS SHOWN A1 25.07.19 **EROSION AND SEDIMENTATION CONTROL** Suite 3.01, Level 3, 3 Horwood Place party arising out of any use or reliance by third party on the Drawing Number Parramatta, NSW 2150 content of this document. **DETAILS** CV-CARDNO-ST03C-1131 Tel: 02 9496 7700 Fax: 02 9439 5170 Web: www.cardno.com.au 25.07.19

STAPLES ON TOP EDGE —

SEDIMENT FENCE

(GEOTEXTILE FILTER FABRIC & STRAW BALE)

NOT TO SCALE

CHECK DAM - STRAW BALE

SPILLWAY CAPACITY

TO HOLD CLOTH

GRAVEL (OPTIONAL)

DRAINAGE AREA 0.8ha MAX

SPILLWAY AT LEAST 0.15m BELOW SIDES

HEIGHT 0.6M MAX

1.2m STAR PICKET DRIVEN 0.6m INTO THE GROUND

DISTURBED

AREA

ANGLE FIRST STAKE TOWARDS

— NYLON OR WIRE BINDINĞS

UNDISTURBED

AREA

PREVIOUSLY LAID STRAW BALE

20.12.18

06.08.18

Date

ISSUED FOR DEVELOPMENT APPLICATION APPROVAL

Description

ISSUED FOR DRAFT DA DOCUMENTATION

REISSUED FOR COORDINATION

DRAFT - ISSUED FOR COORDINATION


DAC ARM ARM


Des. Verif. Appd.

DAC


DAC

DAC

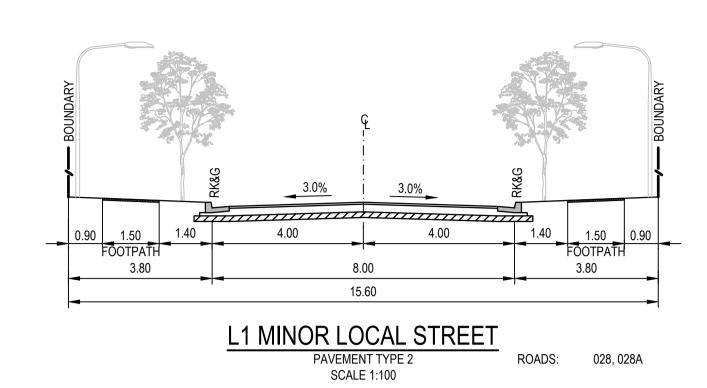

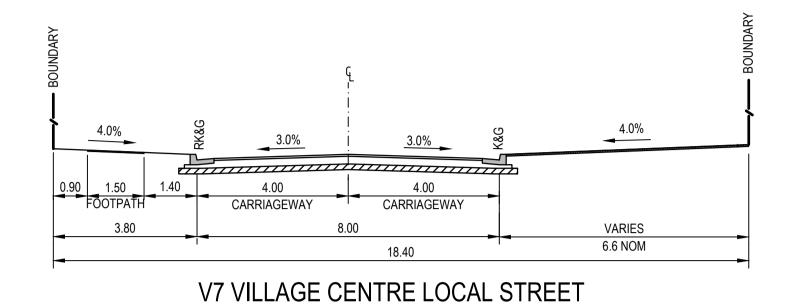


SCALE 1:100

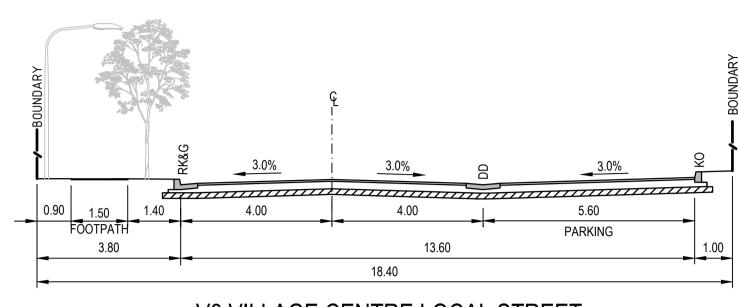



**V8 VILLAGE CENTRE LOCAL STREET** PAVEMENT TYPE 2 SCALE 1:100 ROADS: 027 (CH 325-385)

PAVEMENT TYPE 5

(CONCRETE MAINTENANCE AND HARDSTAND)

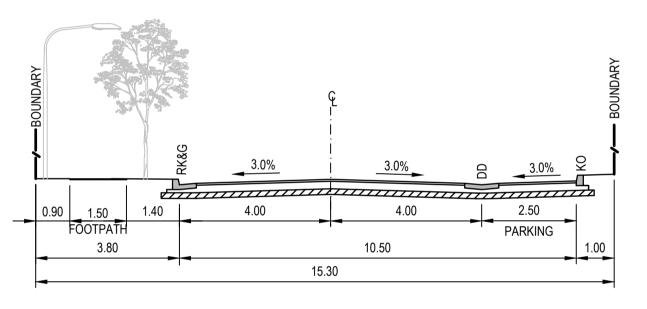

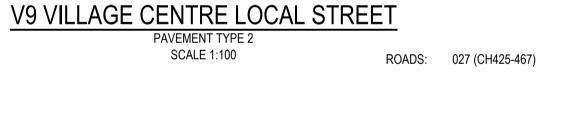


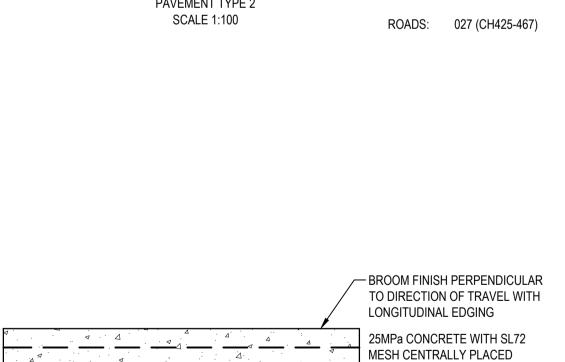

30mm COMPACTED SAND


ASSUMED CBR: 3%

COMPACTED TO 95% SDD

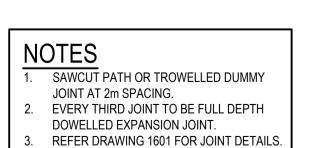

SHARED PATH/FOOTPATH

SCALE 1:10

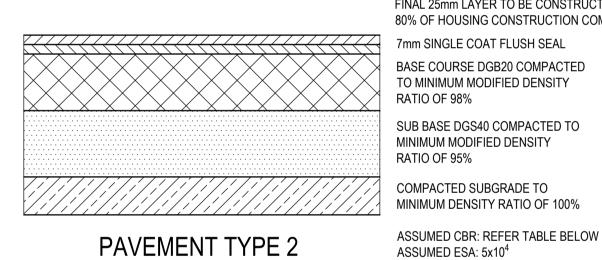

PAVEMENT 2 DESIGN CBR 3% DESIGN SUBGRADE CBR 5% WEARING SURFACE 50mm AC10 50mm AC10 SINGLE COAT FLUSH SEAL 7mm 7mm BASECOURSE 150mm 150mm SUBBASE 175mm 275mm


475mm

375mm

50mm AC10 WEARING COURSE (2x25mm AC10) FINAL 25mm LAYER TO BE CONSTRUCTED AFTER 80% OF HOUSING CONSTRUCTION COMPLETED 7mm SINGLE COAT FLUSH SEAL BASE COURSE DGB20 COMPACTED TO MINIMUM MODIFIED DENSITY RATIO OF 98% SUB BASE DGS40 COMPACTED TO MINIMUM MODIFIED DENSITY RATIO OF 95% COMPACTED SUBGRADE TO MINIMUM DENSITY RATIO OF 100%

ROADS: 027 (CH301-325, CH385-425, CH467-478)

NOTE PROVIDE TCJ AT 4m SPACING. EVERY THIRD JOINT TO BE DEJ. REFER DRAWING 1601 FOR JOINT DETAILS

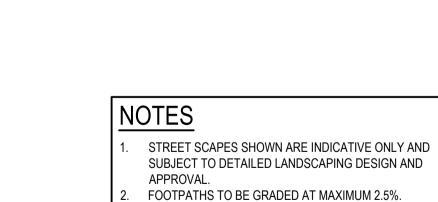

SL82 MESH (50mm TOP COVER)

COMPACTED SUBGRADE TO 100%

STANDARD MAXIMUM DRY DENSITY


170mm 32MPa CONCRETE

150mm DGB20

ASSUMED CBR: 3%

REMAINING VERGE AREAS TO BE GRADED TO ACHIEVE OVERALL 4.0% GRADE FROM TOP OF KERB TO ROAD RESERVE BOUNDARY. CONSTRUCTION OF FOOTPATH AND SHARED PATH TO BE DEFERRED UNTIL DIRECTED BY THE SITE SUPERINTENDENT.

REFER DRAWING 1701 FOR PAVEMENT PLAN.

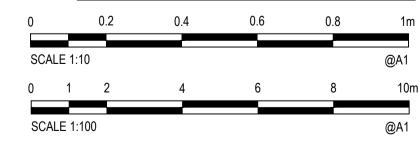

25.07.19 ISSUED FOR DEVELOPMENT APPLICATION APPROVAL DAC ARM ARM DAC ISSUED FOR DRAFT DA DOCUMENTATION DAC REISSUED FOR COORDINATION 20.12.18 06.08.18 DRAFT - ISSUED FOR COORDINATION DAC Date Description Des. Verif. Appd.

lendlease

© Cardno Limited All Rights Reserved. This document is produced by Cardno Limited solely for the benefit of and use by the client in accordance with the terms of the retainer. Cardno Limited does not and shall not assume any responsibility or liability whatsoever to any third party arising out of any use or reliance by third party on the content of this document.

TOTAL THICKNESS




Cardno (NSW/ACT) Pty Ltd | ABN 95 001 145 035 Suite 3.01, Level 3, 3 Horwood Place Parramatta, NSW 2150 Tel: 02 9496 7700 Fax: 02 9439 5170

Web: www.cardno.com.au


Drawn	Date
MCD	25.07.19
Checked	Date
DAC	25.07.19
Designed	Date
DAC	25.07.19
Verified	Date
ARM	25.07.19
Approved	
ARM	25.07.19

	S	CALE 1:100			(	@A1
Date 7.19	Client LENDLEASE					
Date 7.19 Date 7.19 Date	Project JORDAN SPRINGS EAST STAGE 3C - CIVIL WORKS DEVELOPMENT APPLICATION			PROVAL ONSTRUCTION		RPOSI
Date 7.19	Title TYPICAL ROAD CROSS SECTIONS	Datum AHD		Scale AS SHOWN		A1
	AND PAVEMENT DETAILS	Drawing Number	ZBDNO-SI	Г03C-1251		Revision 4
7.19		UV-07	יט-טווטיוו	1000-1201		

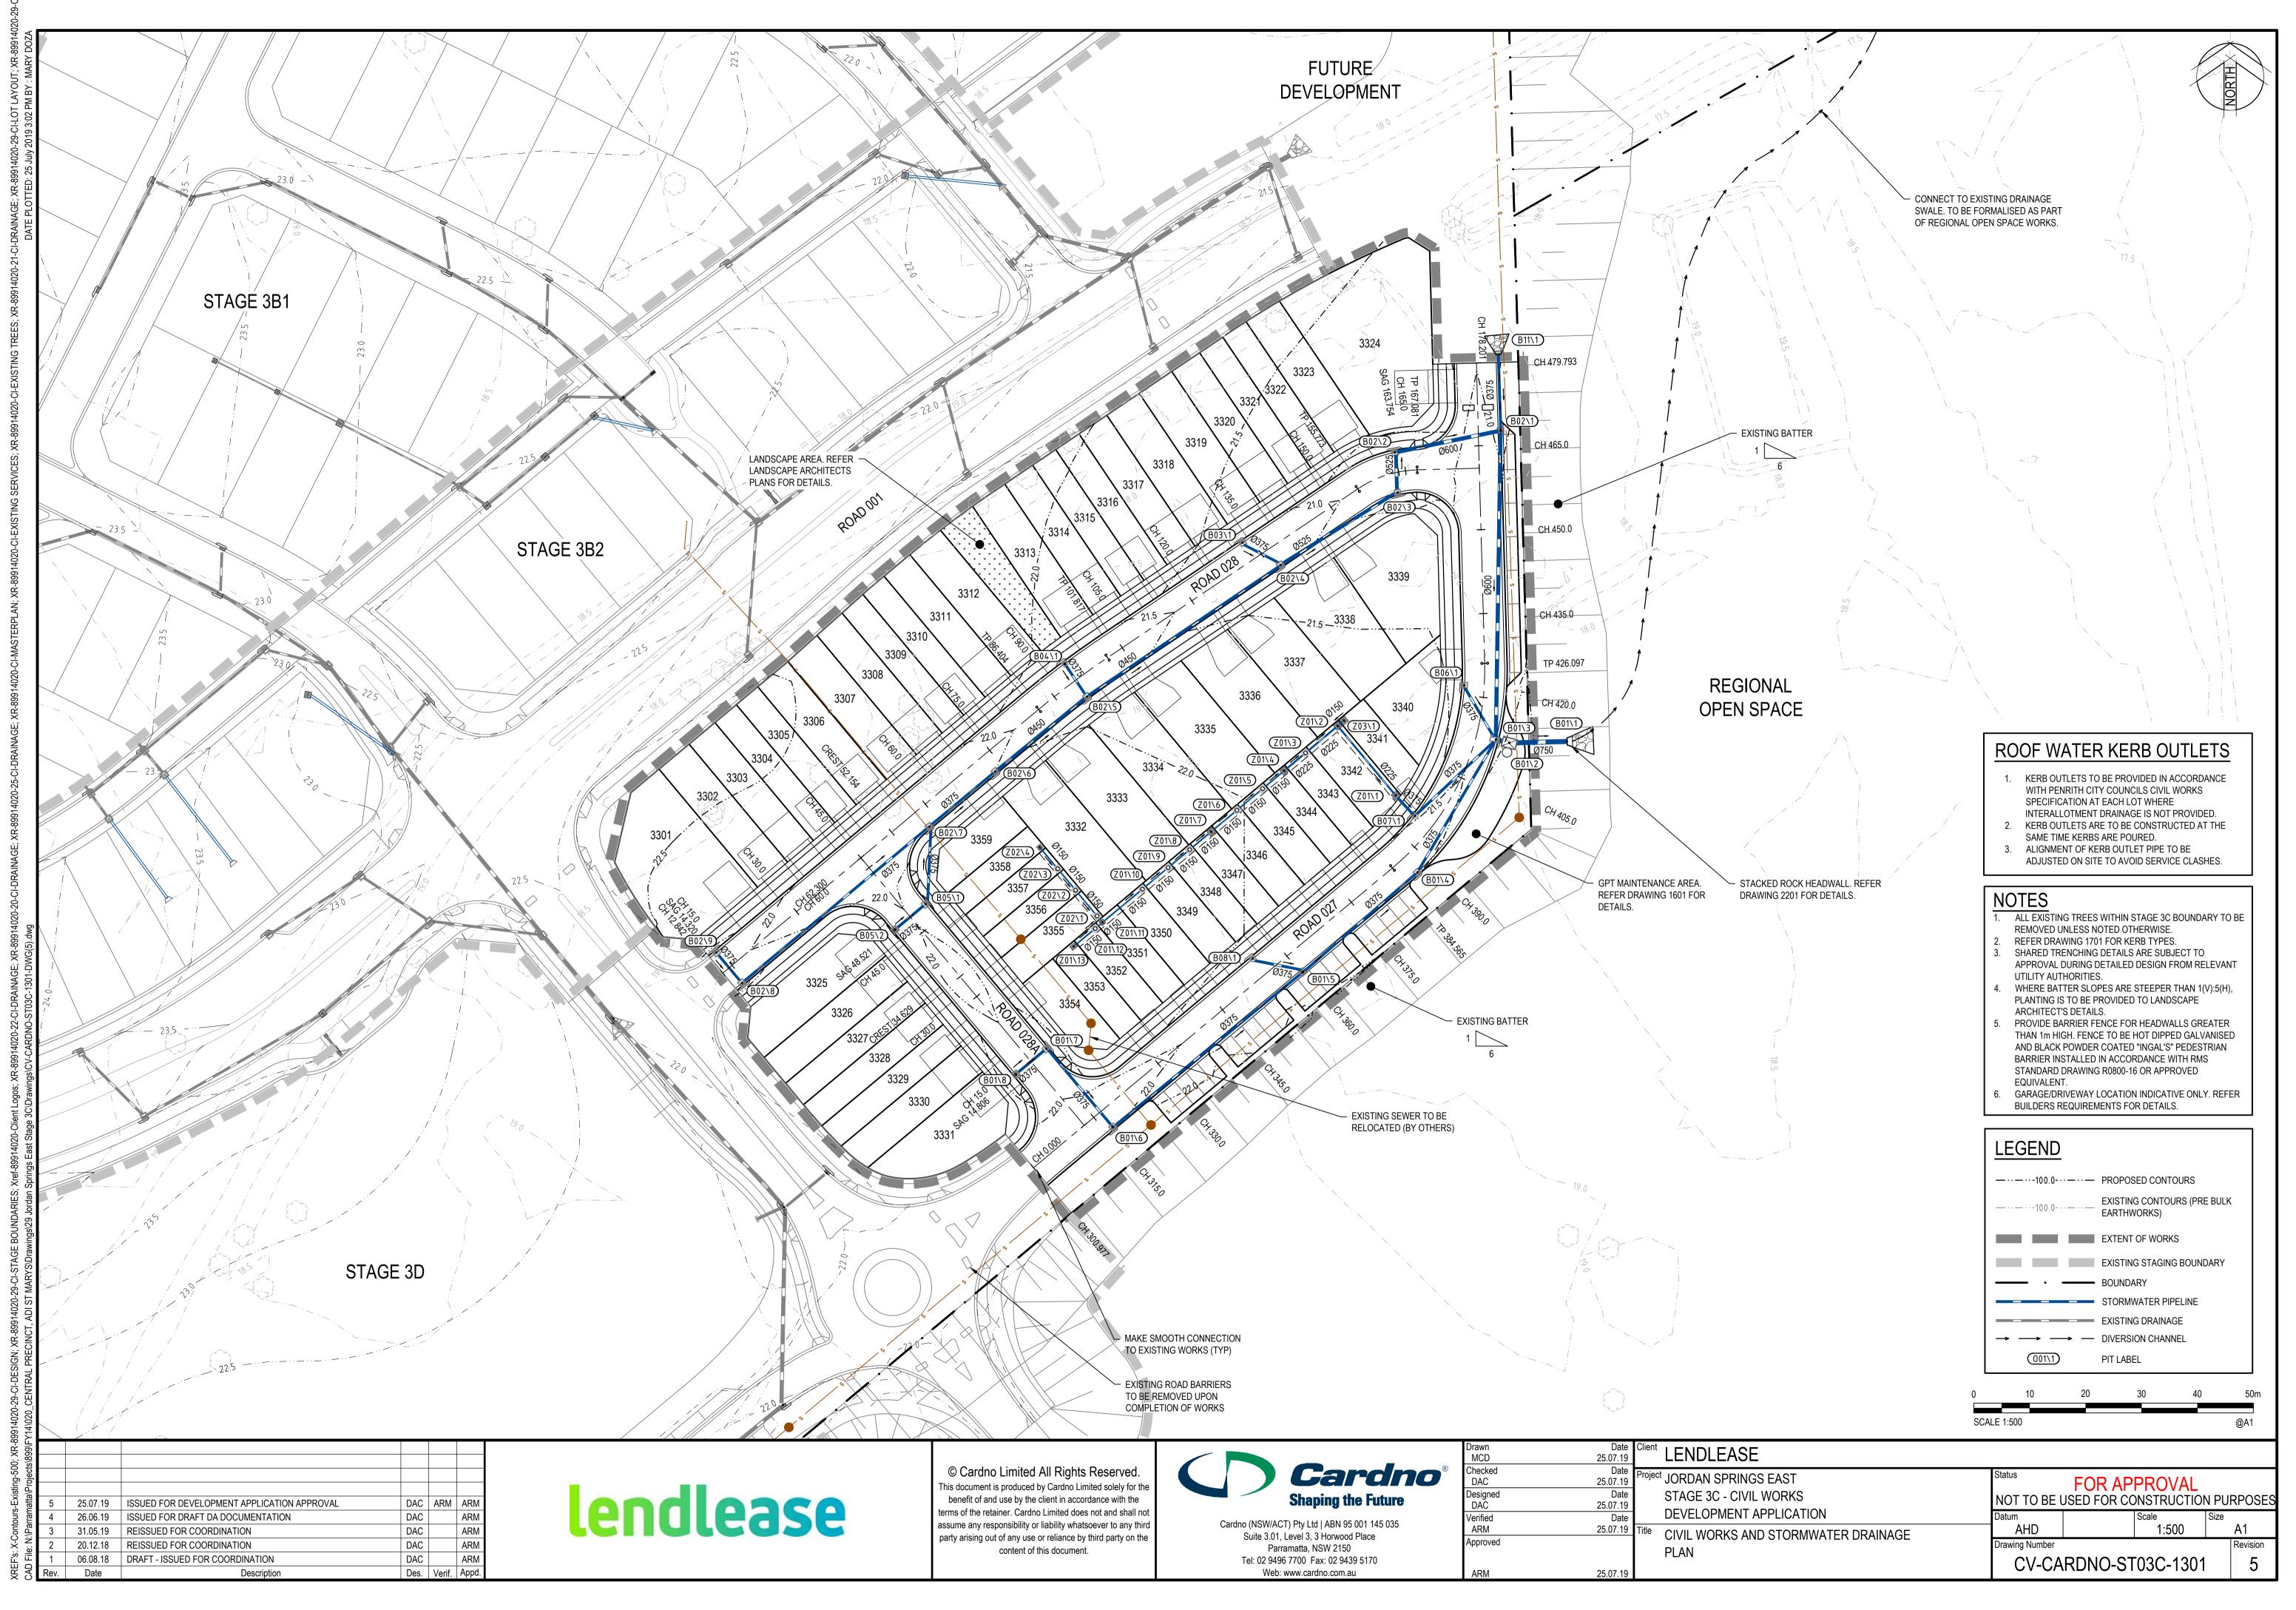

EXISTING LEVELS SHOWN ARE PRE BULK EARTHWORKS. PRIOR TO THE COMMENCEMENT OF CIVIL WORKS, THE BULK EARTHWORKS CONTRACTOR WILL COMPLETE BULK EARTHWORKS OPERATIONS, WHICH INCLUDES FINISHED SURFACE LEVELS EXCEPT FOR AREAS WITHIN THE ROAD THE RESERVE. IN AREAS OF FILL, THE CIVIL CONTRACTOR WILL RECEIVE SUB-GRADE LEVEL +100mm. IN AREAS OF CUT, THE STAGE 3D WORKS CIVIL CONTRACTOR WILL RECEIVE SUB-GRADE LEVELS. STAGE 5B WORKS R300 HORIZONTAL 35m VC 15m VC VC LENGTH -0.7% GRADE DATUM RL 13 WAE LEVEL 22.251 22.248 22.240 DESIGN LEVEL **EXISTING SURFACE** CHAINAGE 299. 300. 301. 281. 282. 285. ROAD 027 LONGITUDINAL SECTION 1:500 HORI. 1:100 VERT. 불충 R150.3 R20 HORIZONTAL HORIZONTAL VC LENGTH VC LENGTH -1.4% GRADE GRADE DATUM RL 12 DATUM RL 13 WAE LEVEL WAE LEVEL DESIGN LEVEL **DESIGN LEVEL EXISTING SURFACE** 18.999 18.990 18.988 18.981 18.991 18.964 **EXISTING SURFACE** .754 .000 .078 .078 .081 .201 .201 CHAINAGE CHAINAGE 11.820 14.320 15.000 19.320 163.7 165.0 167.0 172.4 174.3 ROAD 028A LONGITUDINAL SECTION **ROAD 028 LONGITUDINAL SECTION** 1:500 HORI. 1:500 HORI. 1:100 VERT. 1:100 VERT. SCALE 1:500 Client LENDLEASE **Cardno**® © Cardno Limited All Rights Reserved. roject JORDAN SPRINGS EAST FOR APPROVAL

NOT TO BE USED FOR CONSTRUCTION PURPOSES 25.07.19 lendlease This document is produced by Cardno Limited solely for the Date STAGE 3C - CIVIL WORKS benefit of and use by the client in accordance with the 25.07.19 DEVELOPMENT APPLICATION terms of the retainer. Cardno Limited does not and shall no ISSUED FOR DEVELOPMENT APPLICATION APPROVAL DAC ARM ARM Date Verified assume any responsibility or liability whatsoever to any third Cardno (NSW/ACT) Pty Ltd | ABN 95 001 145 035 AHD AS SHOWN A1 ARM 25.07.19 DAC SSUED FOR DRAFT DA DOCUMENTATION ROAD LONGITUDINAL SECTIONS Suite 3.01, Level 3, 3 Horwood Place party arising out of any use or reliance by third party on the DAC REISSUED FOR COORDINATION Parramatta, NSW 2150 content of this document. ROAD 027, 028 & 028A DAC 06.08.18 DRAFT - ISSUED FOR COORDINATION CV-CARDNO-ST03C-1351 Tel: 02 9496 7700 Fax: 02 9439 5170 Date Description Des. Verif. Appd. Web: www.cardno.com.au 25.07.19

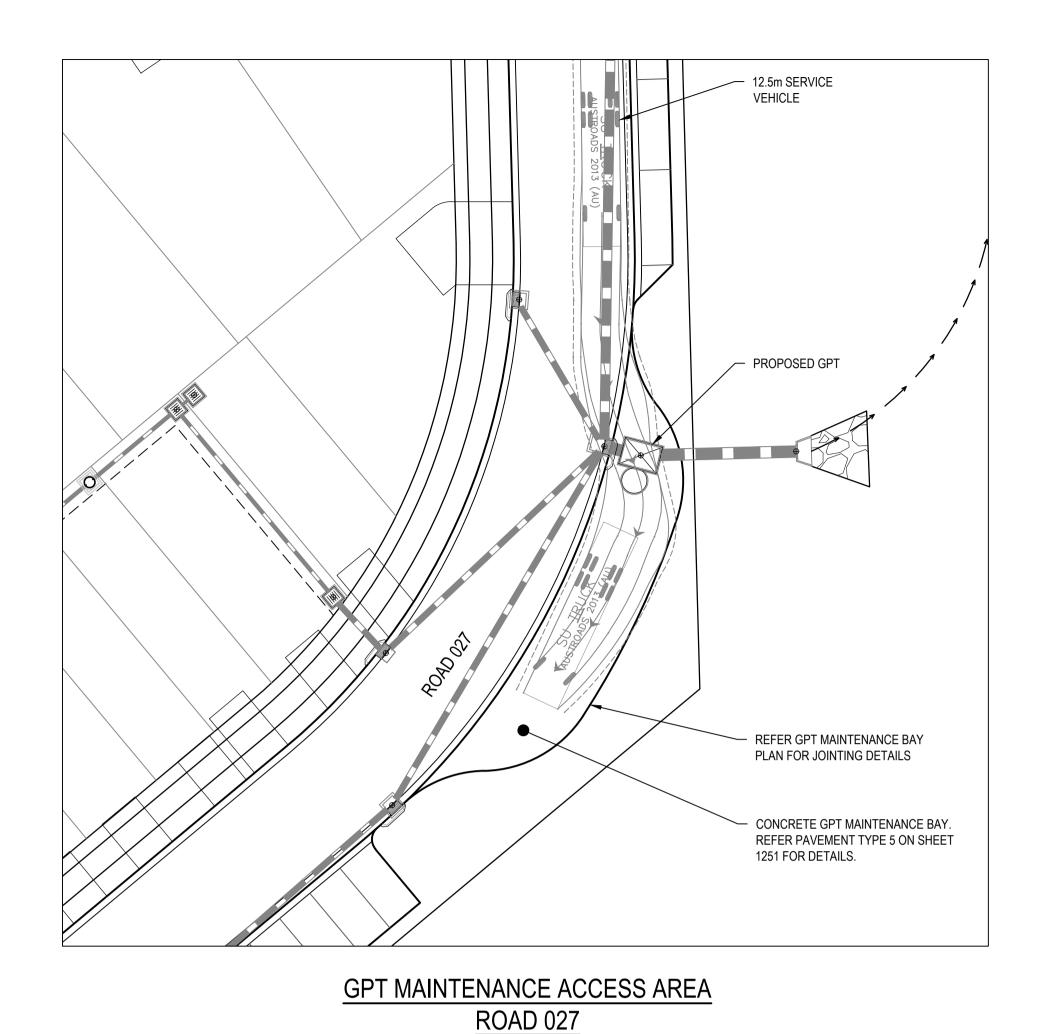


SCALE 1:250


CUT TWO OUT OF EVERY THREE -LONGITUDINAL BARS AT JOINT

TRANSVERSE CONTRACTION JOINT (TCJ)

DOW CORNING SILICON SEALANT —— No.888 OR APPROVED EQUIVALENT - CLOSED CELL POLYETHYLENE BACKER ROD AS PER SEALANT MANUFACTURES REQUIREMENTS WIDENED SAWCUT -INITIAL SAWCUT

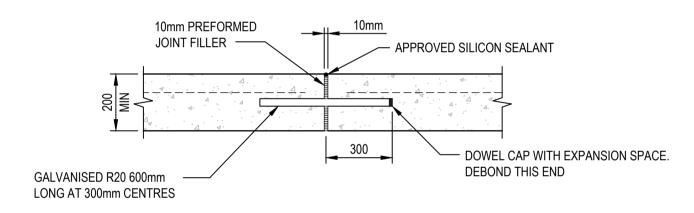

# DOWELED EXPANSION JOINT (DEJ) SCALE 1:10

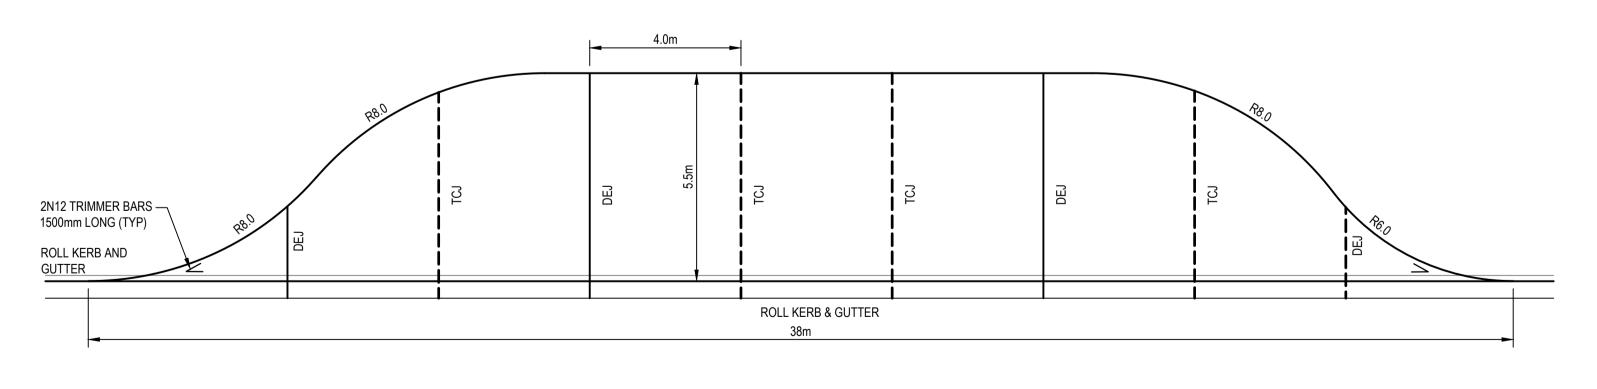

# CONCRETE GPT MAINTENANCE BAY PLAN SCALE 1:100

assume any responsibility or liability whatsoever to any third party arising out of any use or reliance by third party on the

content of this document.

© Cardno Limited All Rights Reserved.  This document is produced by Cardno Limited solely for the benefit of and use by the client in accordance with the	Sha
terms of the retainer. Cardno Limited does not and shall not	

Cardno® haping the Future

Cardno (NSW/ACT) Pty Ltd   ABN 95 001 145 035
Suite 3.01, Level 3, 3 Horwood Place
Parramatta, NSW 2150
Tel: 02 9496 7700 Fax: 02 9439 5170
Weh: www.cardno.com.au

awn	Date	Clie
MCD	25.07.19	
necked	Date	Pro
DAC	25.07.19	ו וט
esigned	Date	
DAČ	25.07.19	
erified	Date	
ARM	25.07.19	Title
proved		


		30ALE 1.230			<u> </u>	<i>y</i> A 1
te Client	LENDLEASE					
Project 19 ate 19	STAGE 3C - CIVIL WORKS	Status  NOT TO BE	FOR AP	PROVAL DNSTRUCTION	N PURF	<sup>2</sup> O:
ate 19 Title	DEVELOPMENT APPLICATION	Datum AHD		Scale AS SHOWN	Size A	.1
	CIVIL WORKS DETAILS SHEET 1	Drawing Number		7.0 01101111		evisi
10	OHLLI I	CV-CA	ARDNO-ST	<sup>-</sup> 03C-1601		4


DAC ARM ARM
DAC ARM
DAC ARM
DAC ARM
DAC ARM
DAC ARM
Des. Verif. Appd. 25.07.19 ISSUED FOR DEVELOPMENT APPLICATION APPROVAL ISSUED FOR DRAFT DA DOCUMENTATION REISSUED FOR COORDINATION 06.08.18 DRAFT - ISSUED FOR COORDINATION

Description


lendlease

Date

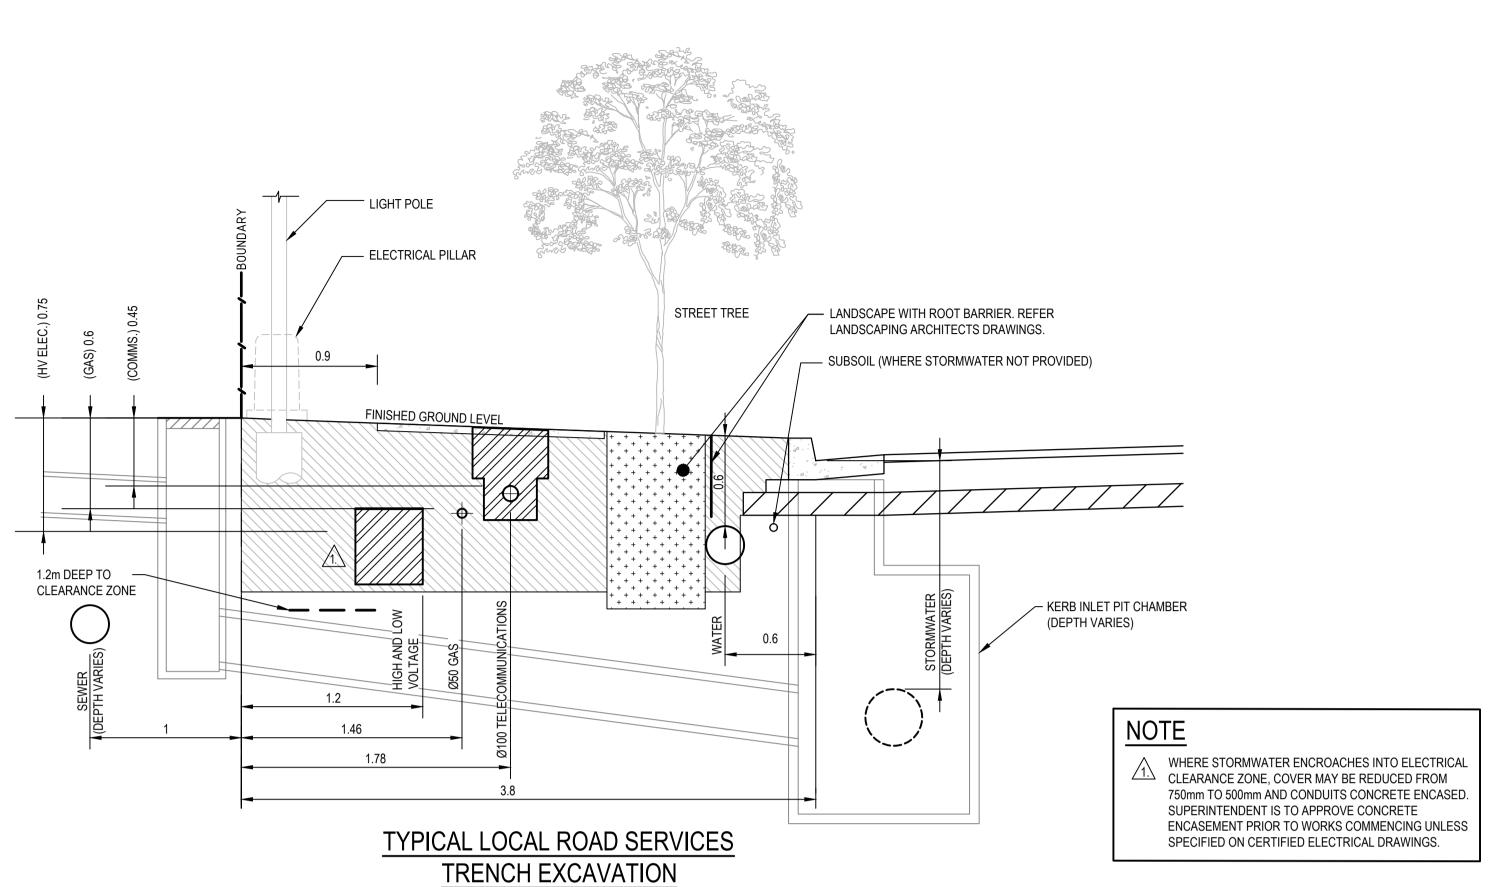

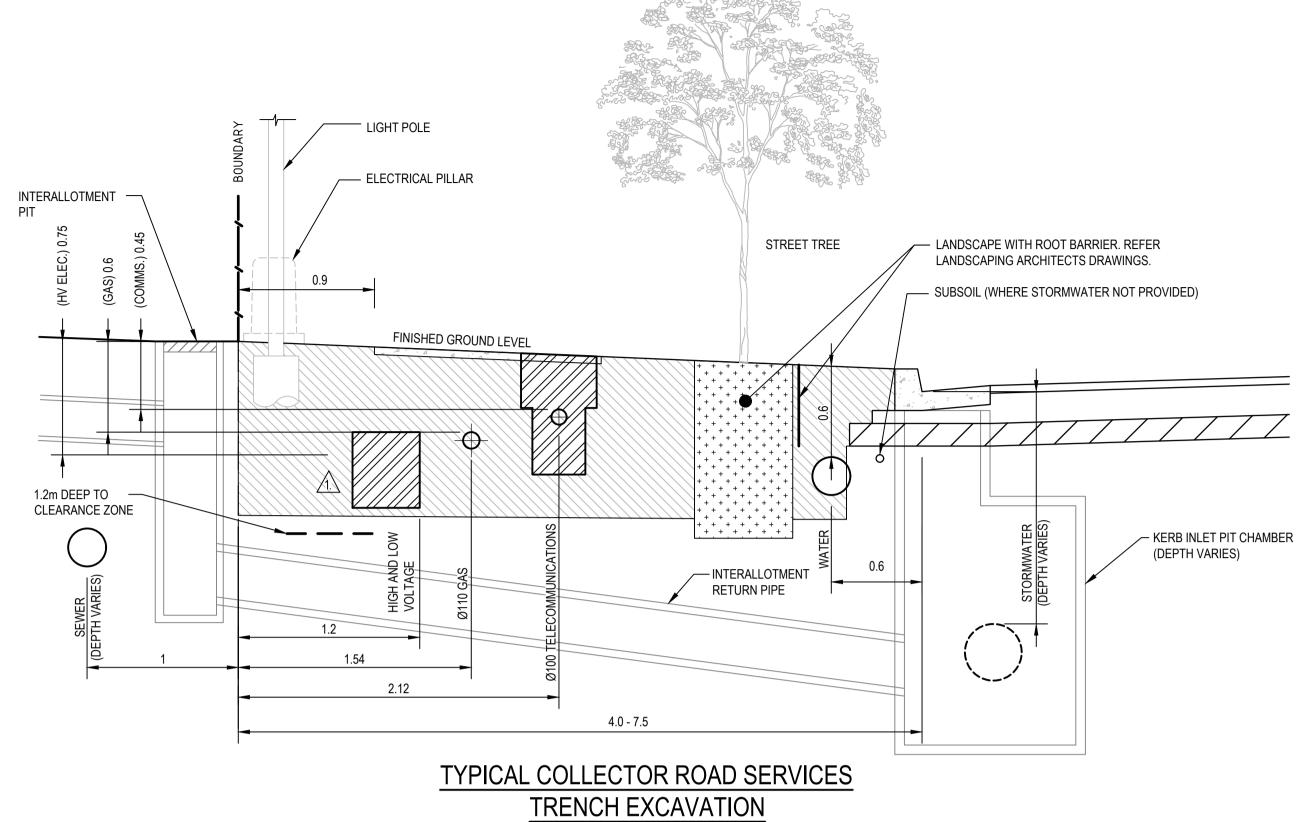

SCALE 1:25

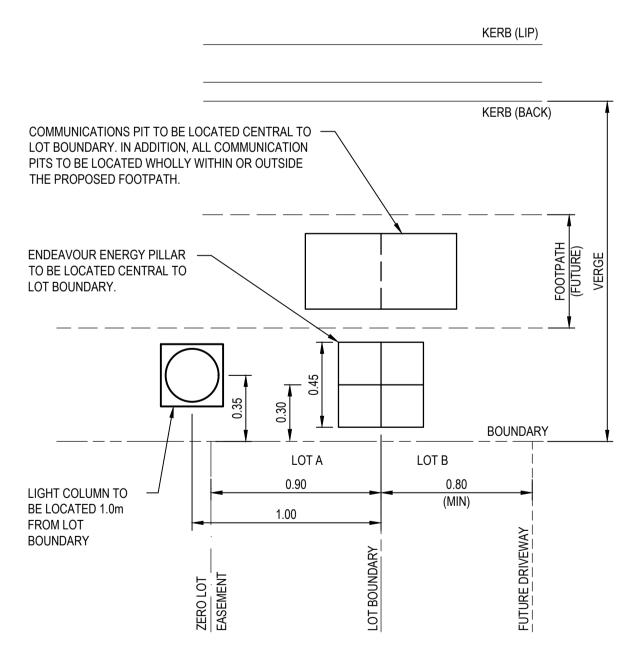

TYPICAL SURFACE UTILITY LAYOUT (LIGHT COLUMN AND ELECTRICAL PILLAR)



25.07.19	ISSUED FOR DEVELOPMENT APPLICATION APPROVAL	DAC	ARM	ARM
26.06.19	ISSUED FOR DRAFT DA DOCUMENTATION	DAC		ARM
20.12.18	REISSUED FOR COORDINATION	DAC		ARM
06.08.18	DRAFT - ISSUED FOR COORDINATION	DAC		ARM
Date	Description	Des.	Verif.	Appd.


ease


© Cardno Limited All Rights Reserved. This document is produced by Cardno Limited solely for the benefit of and use by the client in accordance with the terms of the retainer. Cardno Limited does not and shall not assume any responsibility or liability whatsoever to any third party arising out of any use or reliance by third party on the content of this document.





Cardno (NSW/ACT) Pty Ltd   ABN 95 001 145 035
Suite 3.01, Level 3, 3 Horwood Place
Parramatta, NSW 2150
Tel: 02 9496 7700 Fax: 02 9439 5170
Web: www.cardno.com.au


			<b>©</b>
25.07.19	Client LENDLEASE		
Date 25.07.19	Project JORDAN SPRINGS EAST	Status FOR APP	ROVAL
Date 25.07.19	STAGE 3C - CIVIL WORKS		
Date			cale Size
25.07.19	Title CIVIL WORKS DETAILS		AS SHOWN A1
		Drawing Number	Revision
25.07.19	STILLT Z	CV-CARDNO-ST0	3C-1602 4
	25.07.19  Date 25.07.19  Date 25.07.19  Date	Date 25.07.19 Date 25.07.19 Date 25.07.19 Date 25.07.19 Date 25.07.19 Title CIVIL WORKS DETAILS SHEET 2	Date   25.07.19   Title   CIVIL WORKS DETAILS   SHEET 2   CV-CARDNO-STO

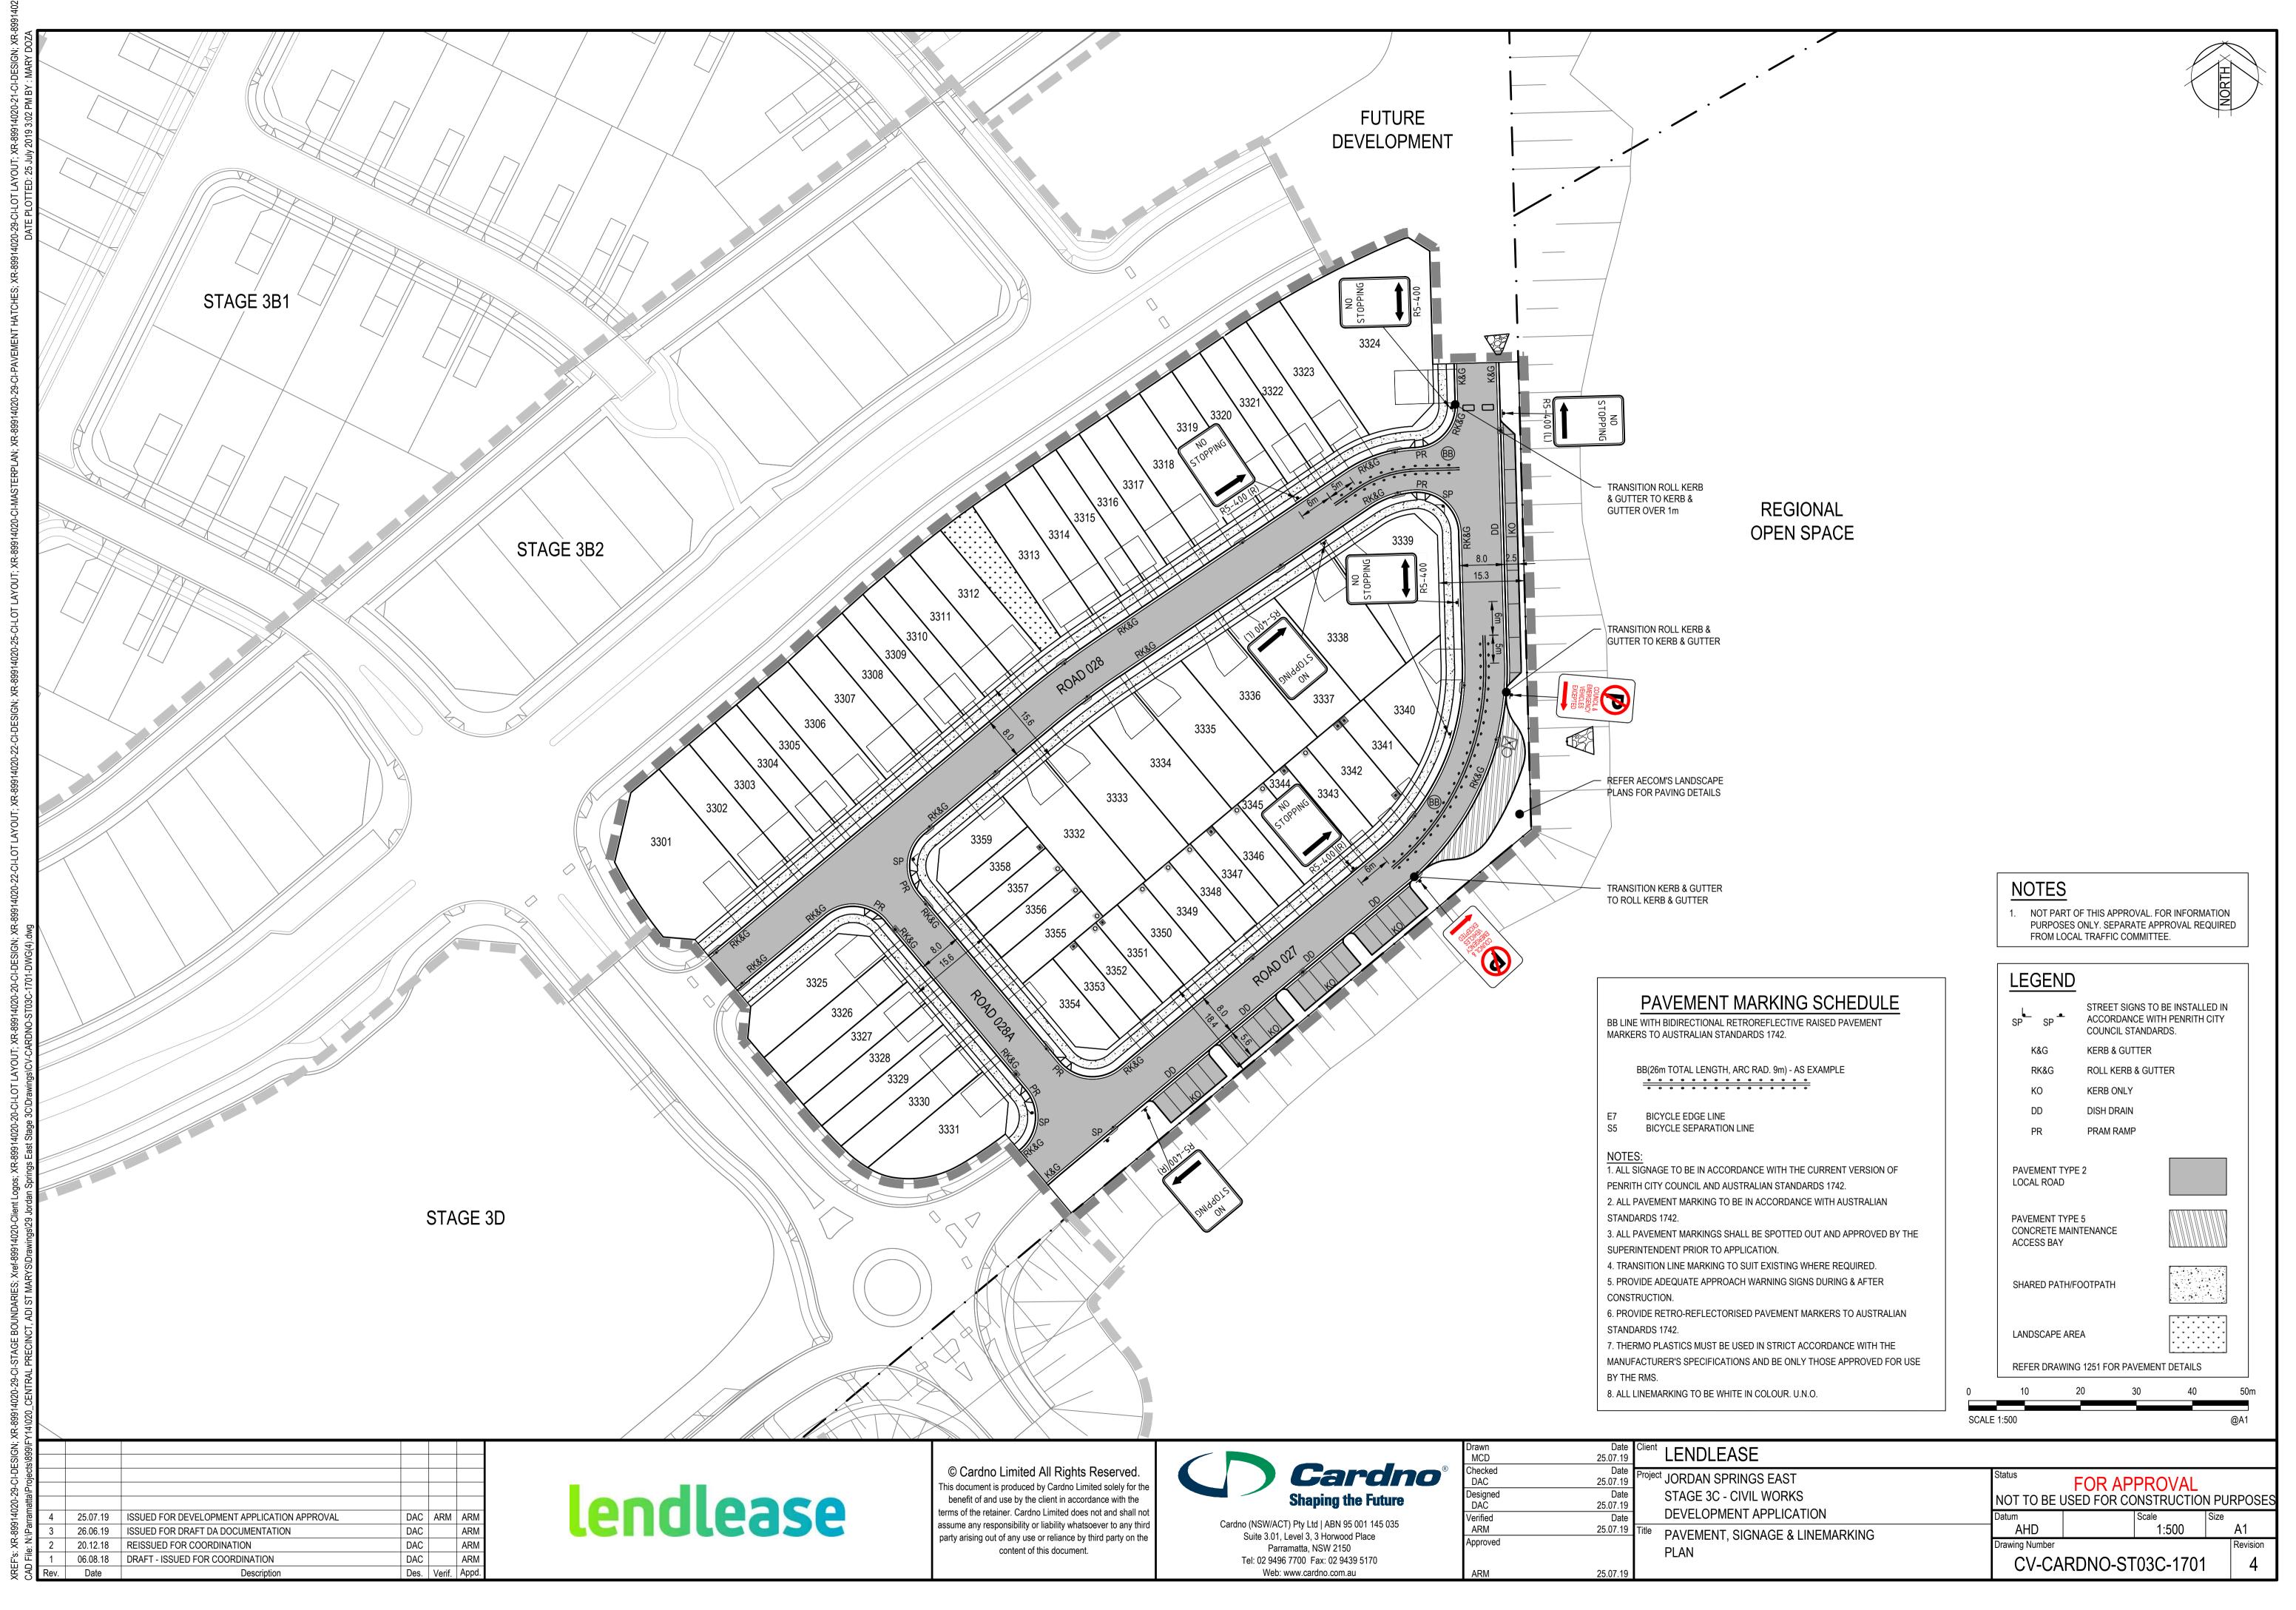


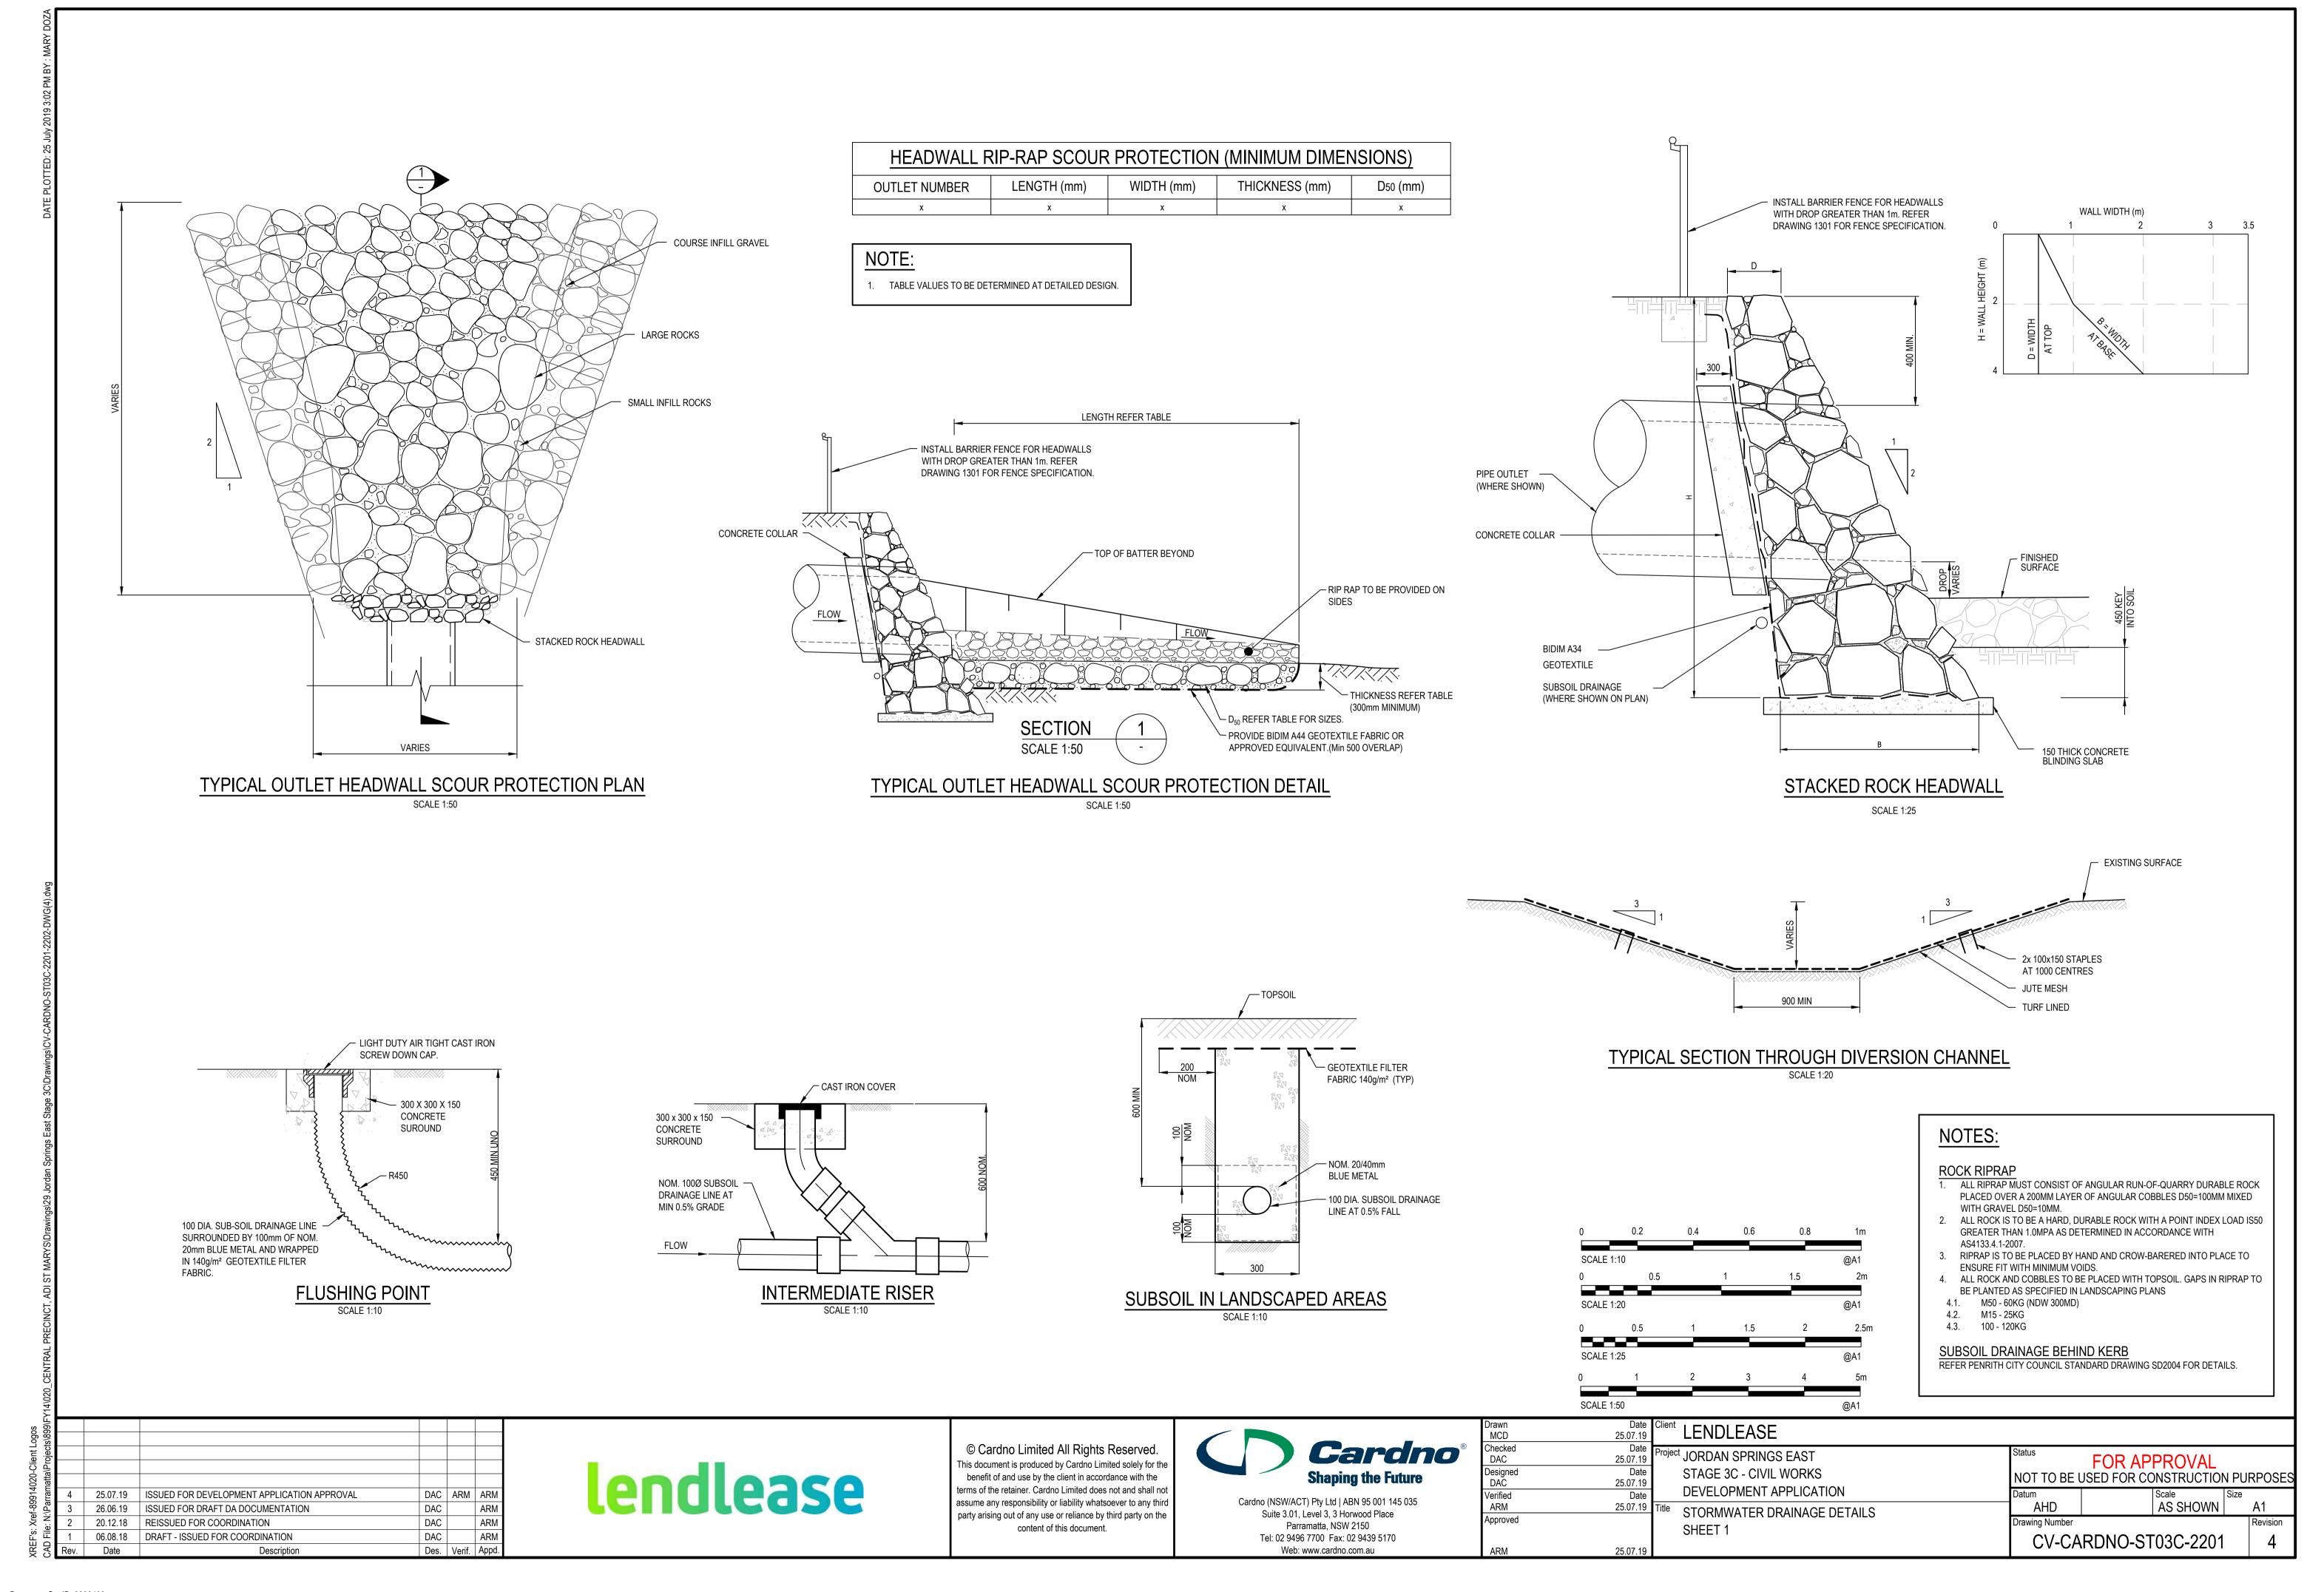

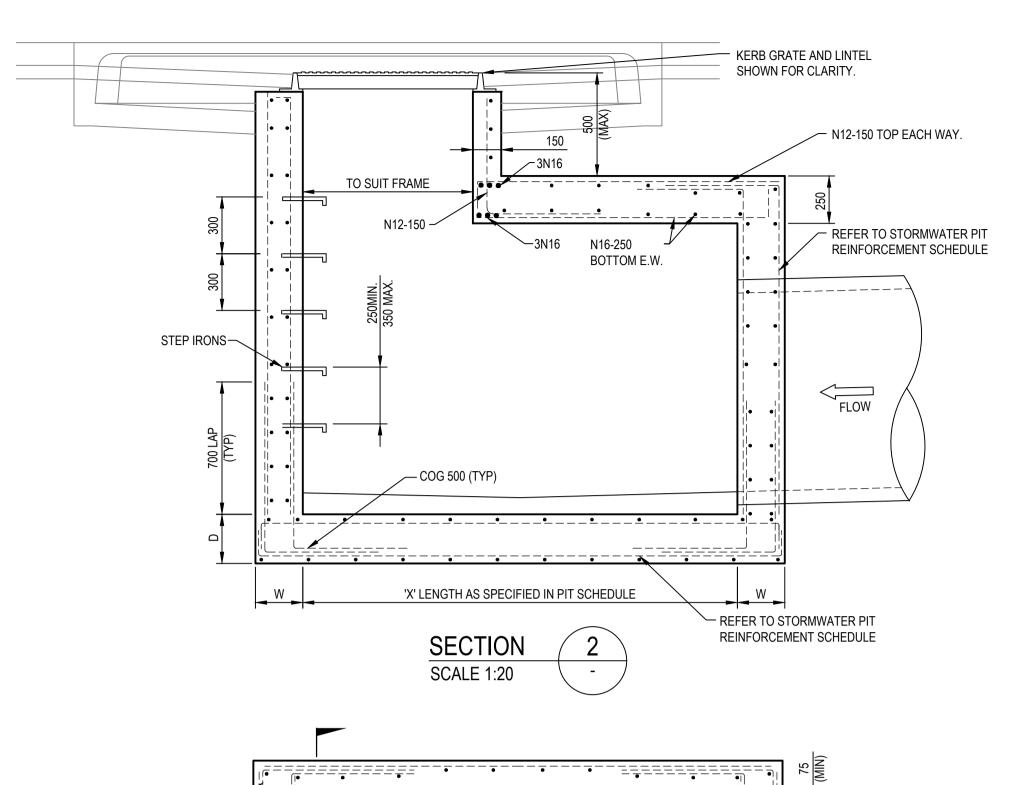


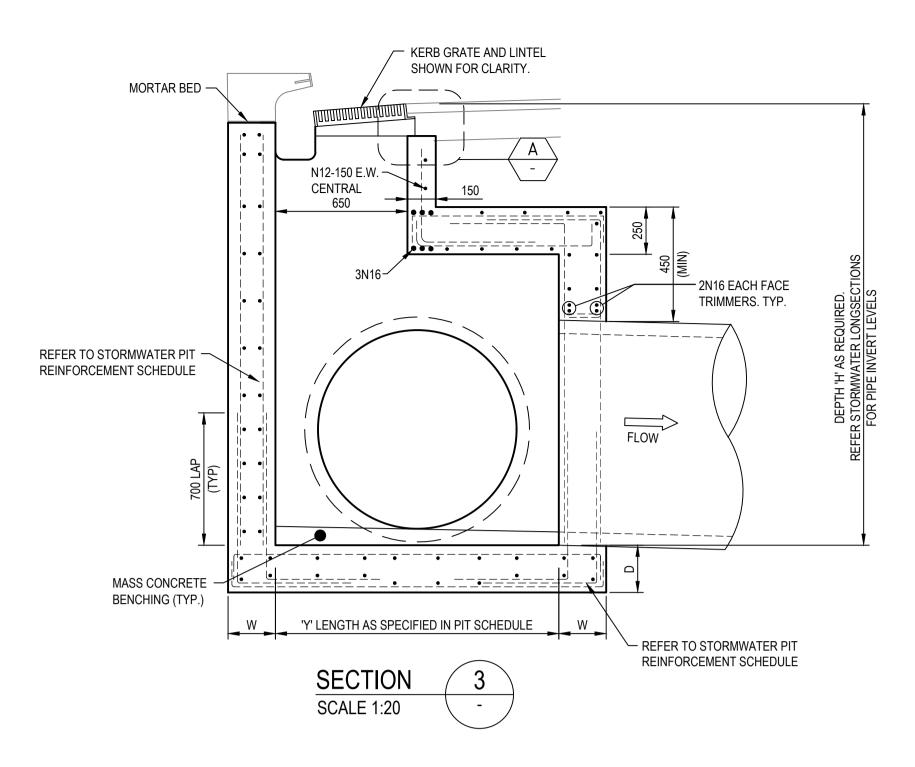

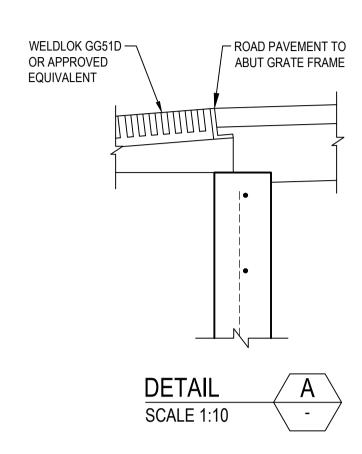


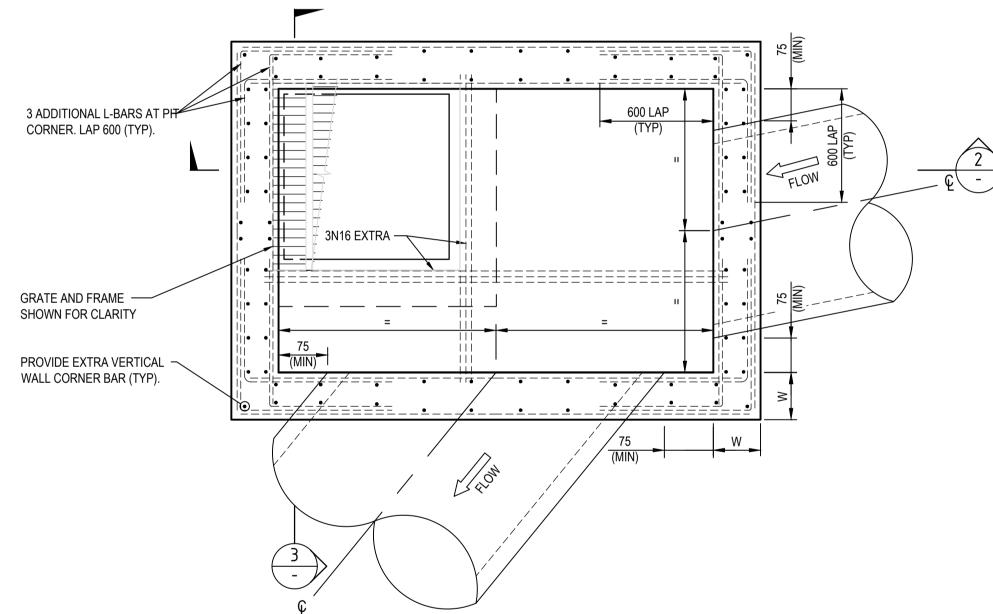



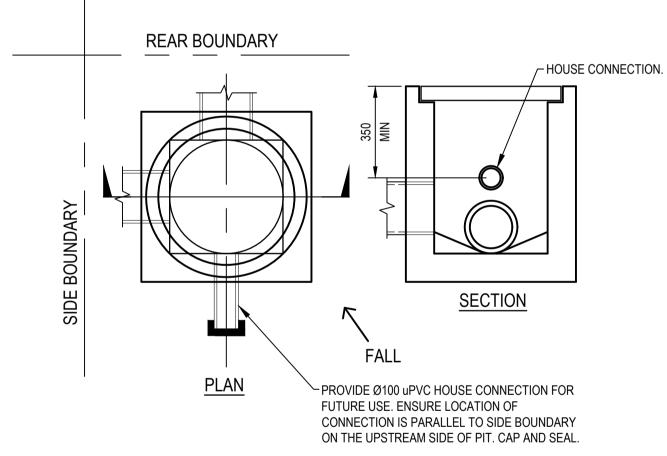

PENRITH CITY COUNCIL STANDARD INTERALLOTMENT DRAINAGE PIT SCALE 1:20

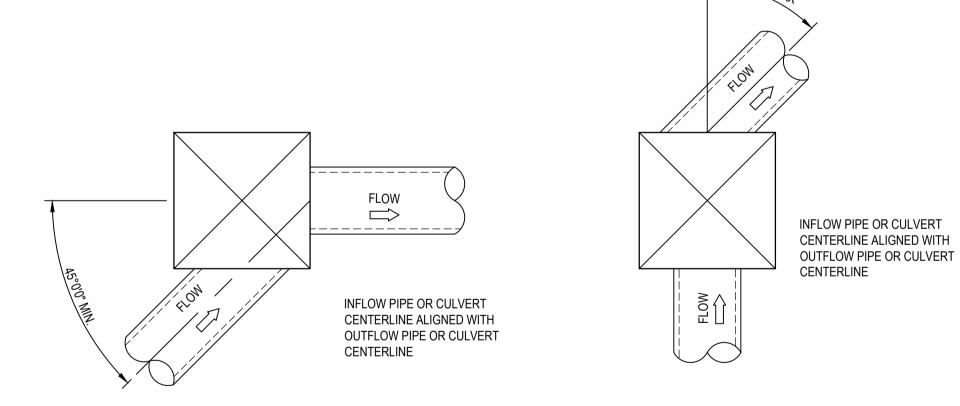

# DEFLECTION ANGLE GREATER THAN 45° (SIDE OF PIT)

PIT ALIGNMENT REQUIREMENTS

TYPICAL DETAILS OF STORMWATER PIPE OR CULVERT ALIGNMENTS THROUGH STORMWATER PITS. STORMWATER PIPE OR CULVERT ALIGNMENTS NOT SHOWN SHOULD BE CONSTRUCTED SIMILARLY IN ORDER TO STREAMLINE FLOWS FROM UPSTREAM TO DOWNSTREAM AND MINIMISE HEADLOSS.

# IMPORTANT NOTE: PIT STANDARD DETAILS

PENRITH COUNCIL STANDARD GRATED GULLY PITS DETAIL, SD2001 TO BE USED FOR PIT DETAILS WHERE:

A. PIT INTERNAL WIDTH IN ANY DIRECTION IS LESS THAN OR EQUAL TO 1200mm, AND B. PIT DEPTH FROM SETOUT POINT TO INVERT IS LESS THAN OR EQUAL TO 2000mm.

NOTE: PIT REINFORCEMENT TO BE SELECTED USING MAXIMUM PIT DIMENSION

FOR PITS WIDER THAN 1200mm AND/OR DEEPER THAN 2000mm REFER TO THE BELOW TABLE AND DETAILS.

NON PCC STORMWATER PIT REINFORCEMENT SCHEDULE									
PIT DIMENSIONS(mm)		WALL DIMENSIONS(mm)		VERTICAL	HORIZONTAL	BASE			
LENGTH 'X','Y'	DEPTH 'H'	BASE THICKNESS 'D'	WALL THICKNESS 'W'	REINFORCEMENT		REINFORCEMENT			
1200 <x,y<3300< td=""><td>2000<h<3900< td=""><td>230</td><td>230</td><td>N12-200 E.F.</td><td>N12-200 E.F.</td><td>N12-200 E.F.</td></h<3900<></td></x,y<3300<>	2000 <h<3900< td=""><td>230</td><td>230</td><td>N12-200 E.F.</td><td>N12-200 E.F.</td><td>N12-200 E.F.</td></h<3900<>	230	230	N12-200 E.F.	N12-200 E.F.	N12-200 E.F.			
X,Y<1200	H<6000	230	230	N16-250 E.F.	N16-250 E.F.	N16-250 E.F.			

### NOTES:

PIT REINFORCEMENT TO BE SELECTED USING MAXIMUM PIT DIMENSION.

MINIMUM COVER TO REINFORCING AND CONCRETE STRENGTH AS SPECIFIED ON SHEET 1011.

25.07.19 ISSUED FOR DEVELOPMENT APPLICATION APPROVAL DAC ARM ARM DAC ISSUED FOR DRAFT DA DOCUMENTATION REISSUED FOR COORDINATION DAC 20.12.18 06.08.18 DRAFT - ISSUED FOR COORDINATION DAC Date Description Des. Verif. Appd.



© Cardno Limited All Rights Reserved. This document is produced by Cardno Limited solely for the benefit of and use by the client in accordance with the terms of the retainer. Cardno Limited does not and shall not assume any responsibility or liability whatsoever to any third party arising out of any use or reliance by third party on the content of this document.



Cardno (NSW/ACT) Pty Ltd   ABN 95 001 145 035
Suite 3.01, Level 3, 3 Horwood Place
Parramatta, NSW 2150
Tel: 02 9496 7700 Fax: 02 9439 5170
Web: www.cardno.com.au

			SOALL 1.20	WA1
rawn MCD	Date 25.07.19	Client LENDLEASE		
hecked DAC	Date 25.07.19	Project JORDAN SPRINGS EAST	Status	APPROVAL
esigned DAC	Date 25.07.19	STAGE 3C - CIVIL WORKS		R CONSTRUCTION PURPOSES
erified ARM	Date 25.07.19	DEVELOPMENT APPLICATION  Title OTORNAVATER PRAINAGE RETAIL O	Datum AHD	Scale Size A1
pproved		STORMWATER DRAINAGE DETAILS SHEET 2	Drawing Number	Revision
ARM	25.07.19	OFFICE E	CV-CARDNO	O-ST03C-2202 4

