

QUEST: LOT 3008, NORTH PENRITH, NSW 2750 EXTERNAL SIGNAGE DEVELOPMENT APPLICATION

Version 1 16.03.16

Document Set ID: 7117974 Version: 1, Version Date: 14/04/2016 CONTENTS /

PLANS & ELEVATIONS	3
SITE PLAN	4
E-W	5
E-E	6
E-N	7
S02	8
SIGNAGE SPECIFICATIONS	9
ID-P	10
ID-B-1	12
ID-B-2	13
ID-B-3	14
ID-B-4	15
ID-B: SECTION Q, DETAIL R	16
ID-CP	17
FINISHES SCHEDULE	18

Document Set ID: 7117974 Version: 1, Version Date: 14/04/2016

E-W

WEST ELEVATION

- .. ID-P Pylon Identification
- 2. ID-B-1 Entrance Identification
- . ID-B-2 High Level Identification



Drawing: J-2015-000568_QUE_PEN_E-W_B.ai

WEST ELEVATION SCALE- 1:250 @ A3

Version: 1, Version Date: 14/04/2016

Date: 16/03/2016

EAST ELEVATION

4. ID-B-3 High Level Identification



EAST ELEVATION SCALE- 1:250 @ A3

Version: 1, Version Date: 14/04/2016

E-N /

NORTH ELEVATION

- 5. ID-B-4 Laneway Identification
- 6. ID-CP Carpark Identification




NORTH ELEVATION SCALE- 1:250 @ A3

Version: 1, Version Date: 14/04/2016

Drawn: NP

BG

- 1. ID-P Pylon Identification
- 2. ID-B-1 Entrance Identification

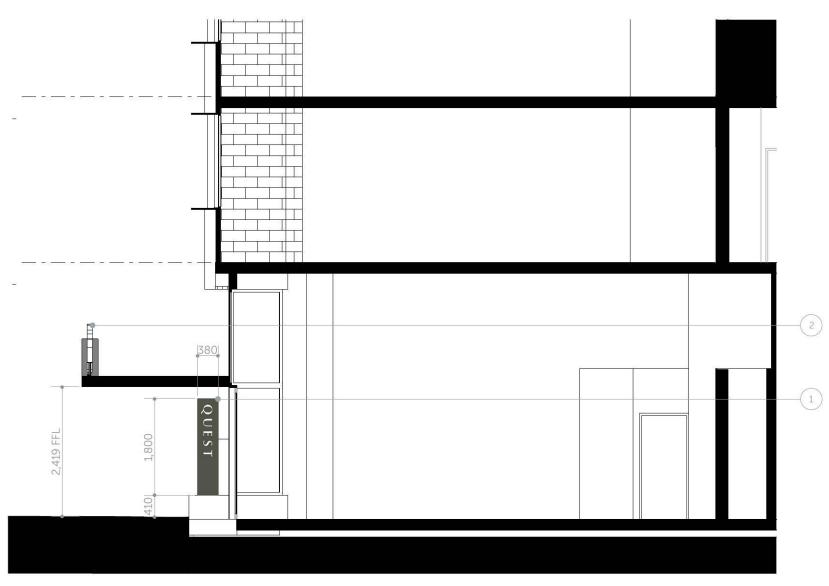

SECTION 02 SCALE- 1:50 @ A3

Document Set ID: 7117974 Version: 1, Version Date: 14/04/2016

TOP VIEW SCALE- 1:10 @ A3 ID-P

GENERAL DIMENSIONS

/ 10

3mm ACM cladding, 2PAC painted. Fabricated galvanised steel frame.

Concrete footing.

Lasercut opal polycarbonate letterforms mounted flush-fit to face of sign.


ILLUMINATION:

Internally illuminated.

Sloan LED Great White 4 LED Modules (701269-WL4-MB) (6500 K) Modular 60 Power Supplies 12VDC.

Illumination hours: 24hrs

Date: 16/03/2016

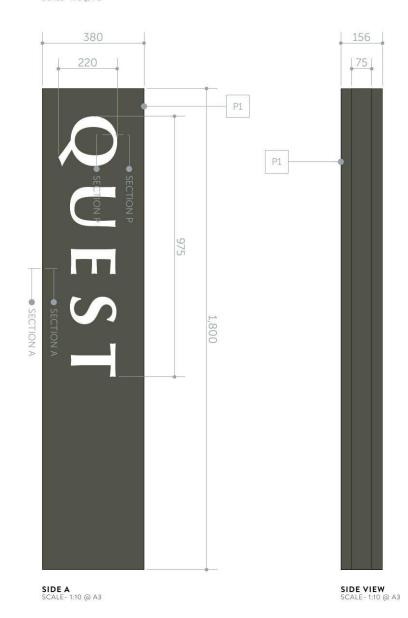

SIDE B SCALE- 1:10 @ A3

Drawn: NP

Project: Quest - Lot 3008, North Penrith, NSW 2750 Document Set ID: 7117974

Version: 1, Version Date: 14/04/2016

Drawing: J-2015-000568_QUE_PEN_ID_P_A.ai

BG

/ 11

TYPICAL CONSTRUCTION DETAILING

FRONT ELEVATION - ALUMINIUM FRAME

Cross brace to be added to frame behind ACM cladding joins to act as fish plate.

SECTION A - CLADDING FIXING DETAIL

- 3mm ACM sign face, 2PAC painted.
- 2. 150 x 100 x 3mm galvanised steel RHS internal frame.
- 3mm ACM spacer, adhered to sign face.
- 4. CSK fixing for attaching sign face to steel frame.
- 3mm ACM cover plate adhered to 3mm ACM spacer to conceal fixings.

SECTION D - BASE PLATE

- Material thicknesses subject to engineers approval - welded to fabricated galvanised steel frame and mechanically fixed to concrete footing.
- Width to be placed parallel to sign face.
- Connection plate and components to be placed below ground level.


SECTION P - FLUSH FIT TEXT ASSEMBLY:


- 3mm ACM
- 3mm profile cut opal acrylic letters adhered to clear acrylic sheet.
- 6mm clear acrylic backing adhered to 3mm ACM.

NOTE:


Typical construction drawings. All construction subject to engineers approval.

BG

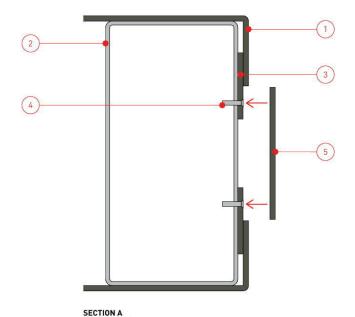


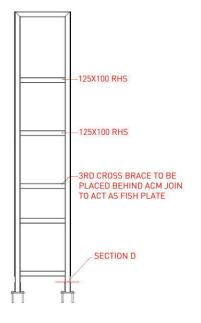

FRONT ELEVATION - ALUMINIUM FRAME

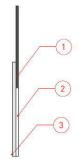

SECTION P - FLUSH FIT TEXT ASSEMBLY SCALE 1:10

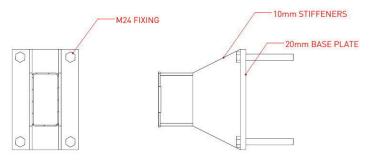

SECTION D - BASE PLATE

Version: 1, Version Date: 14/04/2016

ID-B-1 / 12

GENERAL DIMENSIONS & TYPICAL SECTION

TYPICAL SECTION:

- 1. 10mm profile cut opal acrylic face.
- CSK fixings to fix opal acrylic face into fabricated aluminium letter forms. Fixings to be painted white. Fixings not to penetrate too far into opal face or cause shadow.
- Fabricated 3mm aluminium letter form. All welds to be ground smooth.
- Standoff sleeve 50x50x3mm CHS Stainless steel. 2PAC painted black.
- Mounting rail 100x50x3mm M/S Angle. Multiple modules bolted down to internal structure. Part to be confirmed by engineer. 2PAC painted black.
- Standoffs M12 all threaded and locknuts welded to 100x50 angle washers to prevent corrosion. Internal plates to ensure level installation. Part not to cause shadow.

LED SPEC:

V180 Large White LED Modules (701269-6WLG1-MB) Modular 60 Power Supplies 12VDC.

Illumination hours: Reception opening hours using timer.

LED illumination should not exceed 10 lux at a distance of 3m from the face of the sign.


This will be tested (using a lux meter) in the factory prior to installation.

NOTE:


Transformer location TBC by contractor. Connection detail and fixings TBC by engineer.



TOP VIEW SCALE- 1:25 @ A3

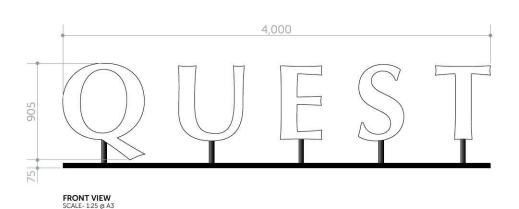

Drawing: J-2015-000568_QUE_PEN_ID-B-1_A.ai

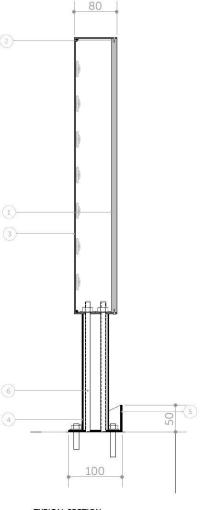

TYPICAL SECTION SCALE- 1:5 @ A3

ID-B-2

/ 13

GENERAL DIMENSIONS & SECTION J

Fabricated aluminium letterforms with opal acrylic face panel.

ILLUMINATION:


Letterforms face illuminated only.

Sloan LED V180 Large White LED Modules (701269-6WLG1-MB) Modular 60 Power Supplies 12VDC.

Illumination hours: Reception opening hours using timer.


SECTION J - FABRICATED TEXT ASSEMBLY:

- LED units fixed to Part 4 as per manufactures instructions.
- 10mm opal acrylic face with routed flange detail - fixed to Part 4 using mechanical fixings Part 3.
- Mechanical grub screw fixings (subject to engineers approval) into letter.
- 4. 3mm aluminium fabricated can.
- Mechanically fixed to building - fixings to be determined by site conditions and subject to engineers approval.

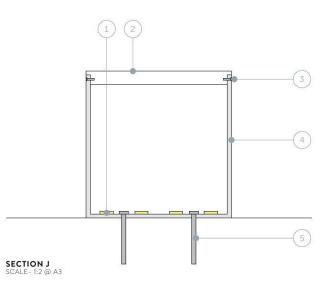

Drawn: NP

TOP VIEW SCALE- 1:50 @ A3

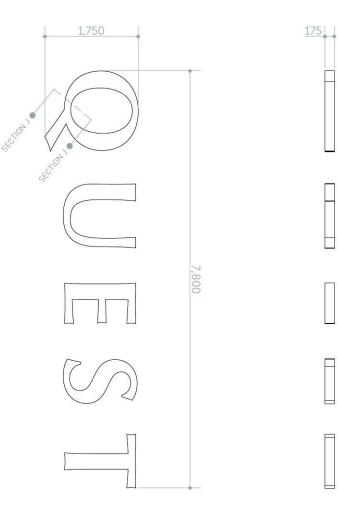

SIDE VIEW SCALE- 1:50 @ A3

FRONT VIEW SCALE- 1:50 @ A3

Version: 1, Version Date: 14/04/2016

GENERAL DIMENSIONS

4mm ACM cladding, 2PAC painted. Fabricated aluminium frame.

ILLUMINATION:


Letterforms face illuminated only.


Sloan LED V180 Large White LED Modules (701269-6WLG1-MB) Modular 60 Power Supplies 12VDC.

Illumination hours: Reception opening hours using timer.



TOP VIEW SCALE- 1:50 @ A3

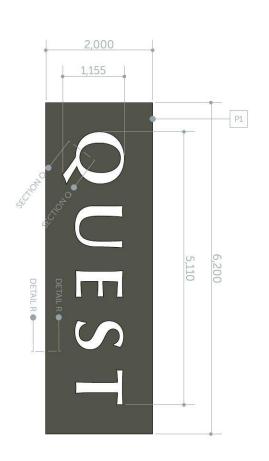

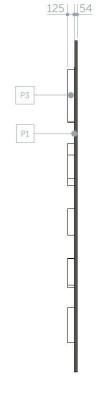

FRONT VIEW SCALE - 1:50 @ A3

SIDE VIEW SCALE- 1:50 @ A3

Date: 8/03/2016

GENERAL DIMENSIONS


4mm ACM cladding, 2PAC painted. Fabricated aluminium frame.

ILLUMINATION:

Letterforms face illuminated only.

Sloan LED V180 Large White LED Modules (701269-6WLG1-MB) Modular 60 Power Supplies 12VDC.

Illumination hours: Reception opening hours using timer.

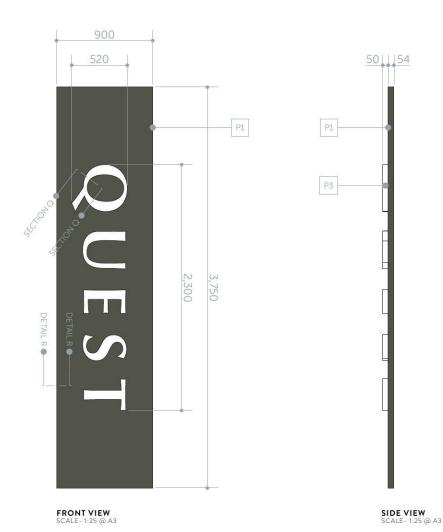

TOP VIEW SCALE- 1:25 @ A3

SECTION Q DETAIL R

FRAME ASSEMBLY:

- 1. 65 x 5 mm fabricated aluminium SHS frame
 - Fixed to existing wall as shown.
- 30 x 30 x 3 aluminium equal angle used as fish plate behind ACM panel joins.
- Mechanical fixings into wall fixing type is dependent on site conditions.

SECTION Q - FABRICATED TEXT ASSEMBLY:

Fabricated text adhered and fixed to frame assembly using mechanical fixings.


- LED units fixed to base of letter as per manufactures instructions.
- 10mm opal acrylic face with routed flange detail - fixed to Part 4 using mechanical fixings Part 3.
- Mechanical grub screw fixings (subject to engineers approval) into Part 2 and Part 4.
- 3mm aluminium fabricated can adhered and mechanically fixed to 4mm ACM cladding.

DETAIL R:


- 1. 4mm ACM cladding
- 2. CSK fixing ACM to 65 x 5mm SHS frame.
- . 65 x 5mm SHS frame

Date: 12/08/2015


 Mechanical fixings into wall fixing type is dependent on site conditions.

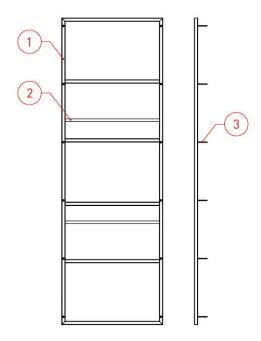

FRAME ASSEMBLY SCALE 1:50

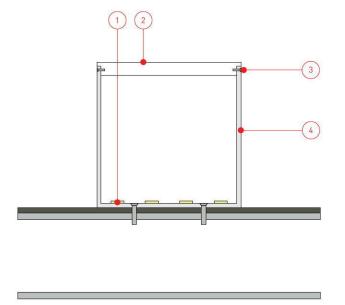

SECTION Q SCALE- 1:2 @ A3

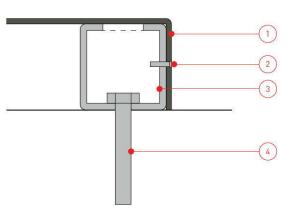

DETAIL R SCALE 1:2

ID-CP

/ 17

GENERAL DIMENSIONS & SECTION C

CONSTRUCTION METHOD:

Internal 50 x 50mm aluminium SHS frame.

3mm ACM cladding, 2PAC painted, letterforms lasercut from face.

20mm lasercut opal acrylic push fit 'P' and 'QUEST' letterforms.

Internally mounted 3mm clear acrylic panel for fixing of letterforms

Suitable fixing method to be determined by site conditions.

ILLUMINATION:

Internally illuminated.

Sloan LED V180 Mini LED Modules (701269-WLP2-MB) (6500 K) Modular 60W Power Supplies 12VDC.


Illumination hours: 24hrs


SECTION C:

Date: 9/03/2016

- 1. 3mm ACM sheet mechanically fixed using CSK fixings to 50 x 50 x 2mm SHS frame.
- Mechanical fixings to existing wall - fixings to suit site conditions.
- 3. 3mm ACM sheet with LED units adhered - Fixed to framework.
- 4. 3mm clear acrylic panel for mounting of 20mm acrylic QUEST and P.

TOP VIEW SCALE- 1:10 @ A3

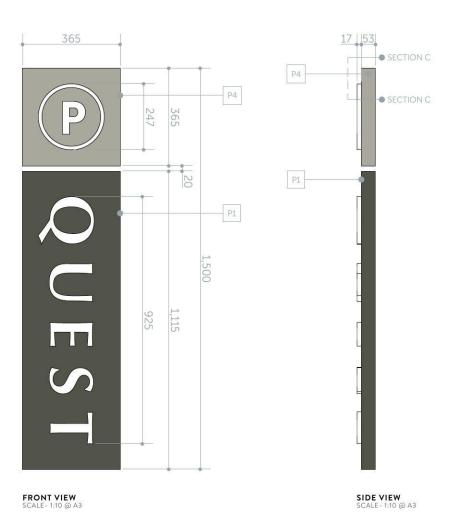

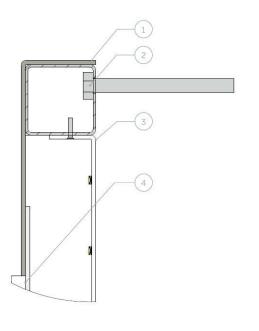

Drawn: NP

SECTION C SCALE- 1:5 @ A3

Version: 1, Version Date: 14/04/2016

Drawing: J-2015-000568_QUE_PEN_ID-CP_A.ai

FINISHES SCHEDULE / 18

COLOUR:	SELF-		SELF	F-ADHESIVE VINYL: PAINT		PAINT & COATINGS:	
	PMS 418 C C: 0 M: 0 Y: 25		V1	AVERY Storm Grey 962	P1 P2	DULUX Vintage Green PG1E8 - Satin DULUX Vintage Green PG1E8 - Low Sheen	
	WHITE C: 0 M: 0 Y: 0		V2	AVERY White 900	Р3	DULUX Natural White PN1E1 - Satin	
	PMS 414 C C: 0 M: 15 Y: 10	K: 20	V3 V4	AVERY Dove Grey 960 AVERY Translucent Beige Grey 5568 C	P4 P5	DULUX Pozieres PG2D3 - Satin DULUX Pozieres PG2D3 - Low Sheen	
	PMS 294 C C: 100 M: 50 Y: 0		V5	AVERY Empire Blue 968			
			V6 V7 V8 V9 V10 V11 V12 V13 V14 V15	AVERY MPI 2000 AVERY MPI 3000 AVERY MPI 2120 Matt Permanent Blockout AVERY MPI 4510/4520 Mesh Banner AVERY Etchmark Window Film AVERY DOL 2100 Matt AVERY DOL 2200 Lustre AVERY DOL 4300 Anti-graffiti AVERY DOL 3200 Lustre	P6	Automotive clear coat - Satin Automotive clear coat - Low Sheen	

All colours, paint and vinyl specifications shown throughout this document have been assigned with a 'Finishes Reference' which relates back to this

The following is an example of the Finishes Reference:



All colours, paint and vinyl specifications must be adhered to, unless otherwise confirmed in writing by Quest or an authorised representative.

P: 1300 551 027 **E:** info@bestgroupaust.com

HEAD OFFICE:

249/251 Chapel St Prahran VIC 3181

SYDNEY OFFICE:

Level 5, 112 Castlereagh Street Sydney, 2000, Australia



Document Set ID: 7117974 Version: 1, Version Date: 14/04/2016

North Penrith Serviced Apartments


DA Landscape Design Report

Lot 3008 DP 1184498 Lord Sheffield Circuit, Penrith







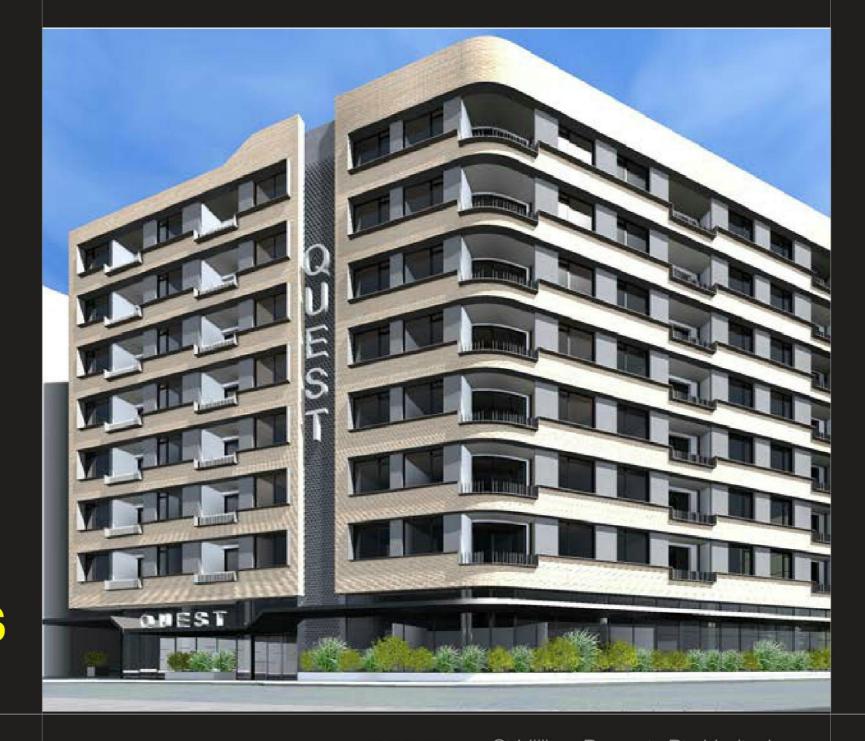

CLIENT: St Hilliers Property Pty Limited

ARCHITECT: DKO Architecture

STATUS: ISSUE: DA SUBMISSION

ATE: 08



URBIS STAFF RESPONSIBLE FOR THIS REPORT WERE:

Director: Mark Kuhne, AlLA 1226 **Senior Consultant:** Cameron Greatbatch

 Job Code:
 ND1444

 Report Number:
 ND1444-A

 Issue - A (DA)
 07/04/2016

Cover page image source: dKO Architecture, 2016

Copyright 2016

© URBIS 2016

This publication is subject to copyright. Except as permitted under the Copyright Act 1968, no part of it may in any form or by any means (electronic, mechanical, photocopying, recording or otherwise) be reproduced, stored in a retrieval system or transmitted without prior written permission. Enquiries should be addressed to the publishers.


URBIS

Australia Asia Middle East

www.urbis.com.au

Document Set ID: 7117974 Version: 1, Version Date: 14/04/2016

CONTENTS

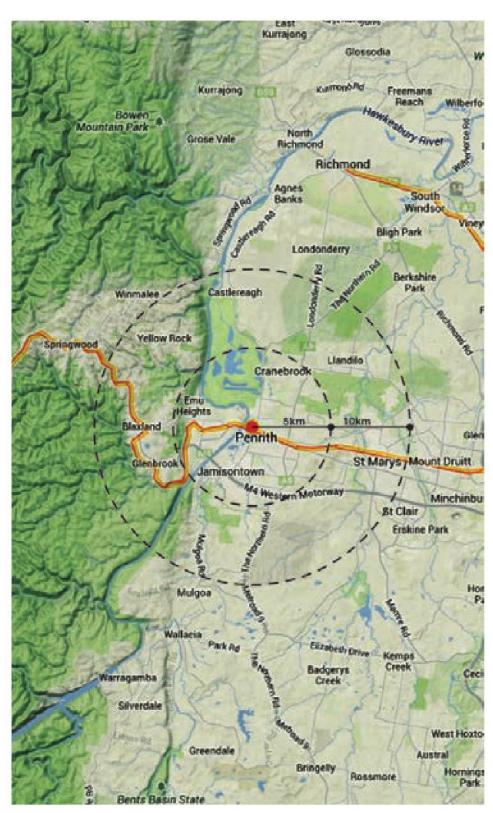

Introduction Landscape Master Plan Strate	gy
Vision	
Thornton Precinct Plan And Staging Plan	n
Thornton Landscape Design Statement	
Landscape Objectives	
Site Context	
Development Proposal	
Landscape Character	
Landscape Masterplan	
Design Response:	
Lighting	
Water Management	
Plant Establishment Maintenance	
Safety and Security	

Accesibility

Landscape Site Analysis Plan	ç
Ground Floor Landscape Plan	10
Level 2 Landscape Plan	11
Typical Landscape Sections Section A Section B	12
Indicative Planting Strategy Species Selection	13
Indicative Planting Palette	14
Materials Strategy	15



Draft Master Plan, August 2014

Lot 3008 - Lord Sheffield Circuit, Penrith

Version: 1, Version Date: 14/04/2016

THORNTON LANDSCAPE **MASTER PLAN STRATEGY**

Introduction


The public domain for Thornton Central will be largely formed by a rich network of public spaces at ground level, bounded by the railway line and station to the south, Lord Sheffield Circuit to the north and the proposed retail/commercial buildings to the eastern and western edges of Station Plaza.

Vision

There is a tremendous opportunity for the development to contribute meaningfully to the local community through a new integrated urban design footprint. The Station Plaza and adjacent pedestrian plaza links can contribute substantially to the social, economic and cultural fabric of the surrounding neighbourhood and those communities beyond, in the greater Penrith area.

This design theme will:

- Create an optimistic public open space for the people of Thornton and surrounding neighbourhoods with distinct landscape themes - Central Station Plaza, Pedestrian Plaza Links, Café Terraces and Promenades, pedestrian priority streetscapes and Podium Residential Gardens.
- Facilitate opportunities for passive, active, programmed and un programmed activities.
- Generate a strong sense of 'place' that befits the location
- Promote ecological corridors creating 'Urban Lungs' to improve the value of the natural environment through water re-use and filtration and promoting green links.
- Integrate a public transport corridor with pedestrian and cycleway connections to provide a truly multi-modal transport hub.

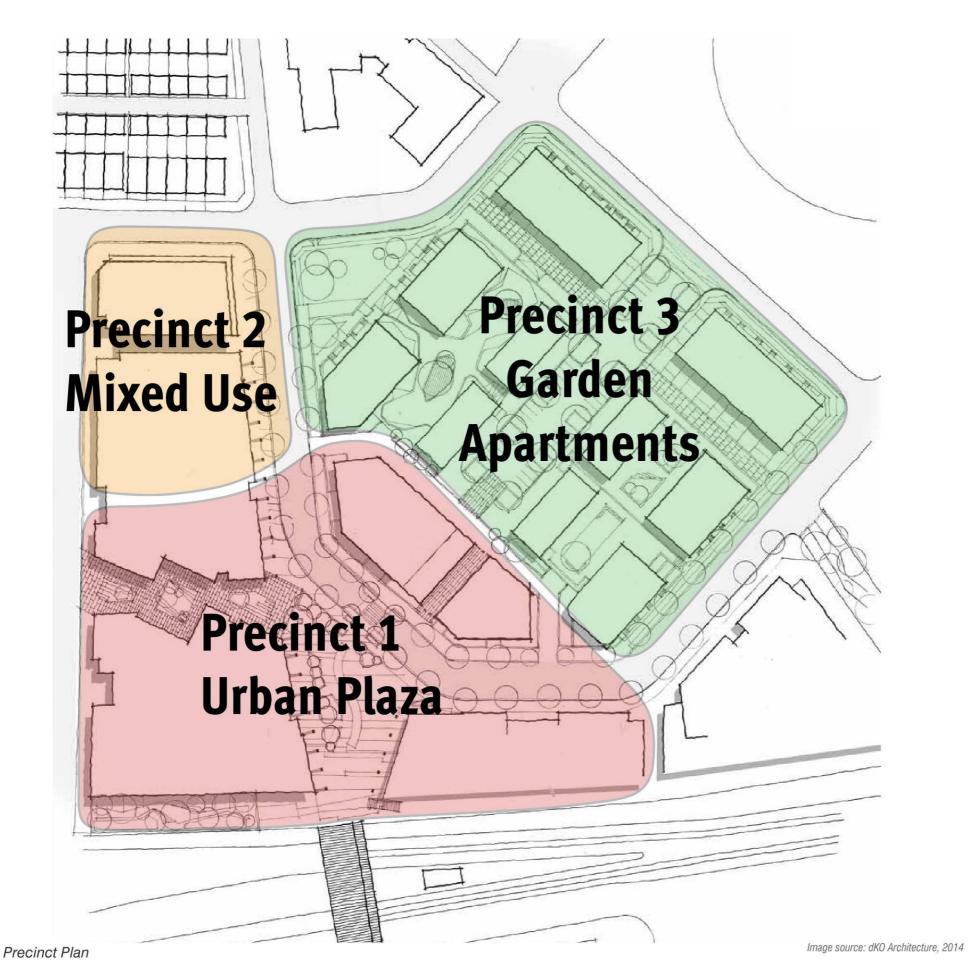

THORNTON PRECINCT **PLAN AND STAGING PLAN**

The overall master plan is comprised of three distinctly identifiable precincts as illustrated in the image left:

- Precinct 1 Urban Plaza:
- Precinct 2 Mixed use, and;
- Precinct 3 Garden Apartments.

The implementation of the master plan comprises stages 1 to 7A as illustrated in the image below. The subject site referred to in this Report apply to DA01 (formerly Stage 4o) of the Thornton Masterplan.



Staging Plan

Image source: dKO Architecture, 2014



Lot 3008 - Lord Sheffield Circuit, Penrith DA - Landscape Design Report





THORNTON LOT 3008 LANDSCAPE DESIGN **STATEMENT**

Landscape Objectives

The landscape design responds to Council Landscape Objectives which

- Ensure that landscape design reinforces the principles of Ecologically Sustainable Development;
- Promote landscape design and planning as part of a fully integrated approach to site development;
- Ensure landscape design takes into account the site's context, landscape and visual character, existing landscape features and amenity, both at the local and regional scale;
- Encourage the development of quality landscape design associated with new development that is consistent with industry best-practice;
- Encourage the retention of existing trees and vegetation to enhance landscape character;
- Ensure landscape design adequately complements the proposed built form and minimises the impacts of scale, mass and bulk of the development in its context;
- Encourage landscape design that can be effectively maintained to a high standard for the life of that development; and
- Establish a framework for allowing "Controlled Private Certification" of the landscape design components of new developments

and is under Construction

Lot 3008 - Lord Sheffield Circuit, Penrith

DA - Landscape Design Report



Site Context

The site subject to this report is located approximately 70 metres north of Penrith Railway Station. It forms DA - Lot 3008 of the proposed Thornton Urban Village, situated within Precinct One, 'Urban Plaza' of the overall master plan.

The proposed development within Lot 3008 has an activated frontage along Lord Sheffield Circuit to the west, a public through link connecting the Railway Plaza to tEngineers Place and landscape treatment to the podium and carpark. A small courtyard space to the south is provided for the services apartments.

The site is accessible by car via the proposed rear laneway from Lord Sheffield Circuit, the main circuitous route that services the overall development. The streetscape proposed for Lord Sheffield Circuit will be:

"a predominant focus on the appropriate mix of formal and native plant species used through out the site. Overall, a leafy, deciduous character to the streetscapes will aid in the enforcement of a European styled village character'. (UrbanGrowth, 2014)

The site's walkable catchment includes: Penrith Railway Station, Westfield Shopping Centre, Penrith CBD, Smith's Paddock and Thornton Hall.

Development Proposal

The development for Lot 3008 of the Thornton Central Masterplan comprises serviced apartments. Its landscape amenity is characterised by three typolgies:

- 1. Public Through Site Link;
- 2. Perimeter planting to ground level and;
- 3. Landscape treatment to the podium and carpark

LANDSCAPE CHARACTER

The underlying principles from which the landscape concept has been developed are set out below. The design approach to the landscape has been to:

- Create edges which both define the public realm and provide a dynamic experience.;
- Provide an activated 24/7 public through site link that connects the Railway Plaza to Engineers Place and Smiths Paddock beyond;
- Ensure the through site link reads as an extension of the surrounding public domain:
- Enhance the arrival experience to the service apartments;
- Provide an understory layer of planting that achieves a level of screening that is lush and green in appearance to the perimeter of the site at ground level.

- A small communal coutyard and garden is provided to the eastern corner of the site:
- Provide a green canopy over the podium carpark and through site link laneway;
- Planters will provide additional interest and amenity to the podium that will be viewed from both the adjacent public domain and surrounding evelated apartments.

Landscape Masterplan

DESIGN RESPONSE:

- To generate a strong sense of 'place' by providing a high quality public domain to the 24/7 through site link laneway;
- Common landscape spaces are linked by using the same planting and materials palette;
- Landscape edges provide green edges to the built form;
- A simple, modern environment to the communal courtyard;
- Lighting, catenary planting/vines, seating benches and public art define the through site link. These elements will be developed during the detail design stages;
- All paving materials and furniture would be subject to relevant Australian Standards.











High Quality Paving & Furnit

SYDNEY
201 SUSSEX STREET
TOWER 2, LEVEL 23, DARLING PARK
SYDNEY NSW 2000
7974 S Py Ltd ABN 50 105 256 228

Version: 1. Version Date: 14/04/2016

Lot 3008 - Lord Sheffield Circuit, Penrith

DA - Landscape Design Report

LIGHTING

The proposed lighting will:

- Provide appropriate levels of lighting of public spaces such as driveways entry points, courtyard, podium landscape treatment and through site links;
- Provide appropriate lighting and visibility of entries to entry points;
- Be developed to provide maximum nocturnal programming opportunities
- Be designed to meet relevant Australian Lighting Standards. Integrated landscape lighting is proposed to all the landscape elements (benches. feature trees), the pathways will be lit by low level bollards and directional in-ground lights.

WATER MANAGEMENT

Water Sensitive Urban Design (WSUD) principals have been realised into the landscape design in a way that celebrates a sustainable water cycle.

- Water sourced from the onsite rainwater collection will be used for the landscape irrigation, all irrigation systems will comprise of subsurface drip systems and automatic timers with rainwater / soil moisture sensor controls:
- Where possible storm water runoff will be directed to the lawn and garden beds on the podium gardens;
- Irrigation will be provided to all soft landscape areas and will be specified within the tender package;
- Low water demand shrub planting is proposed.

PLANT ESTABLISHMENT MAINTENANCE

Maintenance works includes but is not limited to:

- Inspection of soil moisture levels and replenishment as necessary.
- Inspection for and control of soil and insect pests, diseases and other such infestations
- Pruning and repair of all branches and foliage, removal of debris and soil surface and addition of soil and / or mulch to soil surface.
- Maintenance of proper growing medium nutrient levels to ensure maximum vegetation health. A suitable list of health characteristics is to be provided by an agreed specialist and testing is to be maintained on a minimum yearly basis.
- Replacement of plants that fall below plant presentation standards for
- Monitoring and maintenance of efficiency and effectiveness of irrigation system.
- Control of pests and diseases infestation shall be in strict accordance with all regulations and manufactures recommendations. Supply documentation of such compliance upon request by responsible authority.

SAFETY AND SECURITY

An integrated approach to safety will improve actual and perceived personal security in pedestrian public domain areas:

- Pedestrian routes will be continuous and without dead ends;
- All paths are overlooked from adjoining buildings and adjacent streets which will provide a high level of passive surveillance;

- All external spaces will have multiple clear sight lines without obstacles, proposed shrub planting is low level which will prevent places to hide;
- All paths will be well lit at night time and designed to meet relevant Australian Lighting Standards;
- Low-level lighting shall be provided to common areas of the development and be in accordance with AS 4282 to ensure external light does not spill onto adjoining properties.
- Signage will be provided across the precinct to assist with wayfinding and navigation through the site.
- Irrigation will be provided to all soft landscape areas.

ACCESIBILITY

The landscape design will comply in accordance with the Federal Disabilities Discrimination Act 1992, the NSW Anti Discrimination Act 1977, the Disability (Access to Premises - Buildings) Standards 2010, and all relevant Australian Standards. The following design elements have been considered in the landscape proposal to ensure equal access for people with disabilities:

- Pedestrian routes:
- Tactile warning strips with a strong contrast to adjoining paving;
- Stairways/steps;
- Landings;
- Ramps;
- Handrails;
- Seating:
- Lighting; and
- Signage.









PROJECT NO: ND1444


DATE: 08 04 16 ISSUE: A

Lot 3008 - Lord Sheffield Circuit, Penrith

TOWER 2, LEVEL 23, DARLING PARK

LOT 3008 - LANDSCAPE SITE ANALYSIS PLAN

Scale 1:200 @ A1

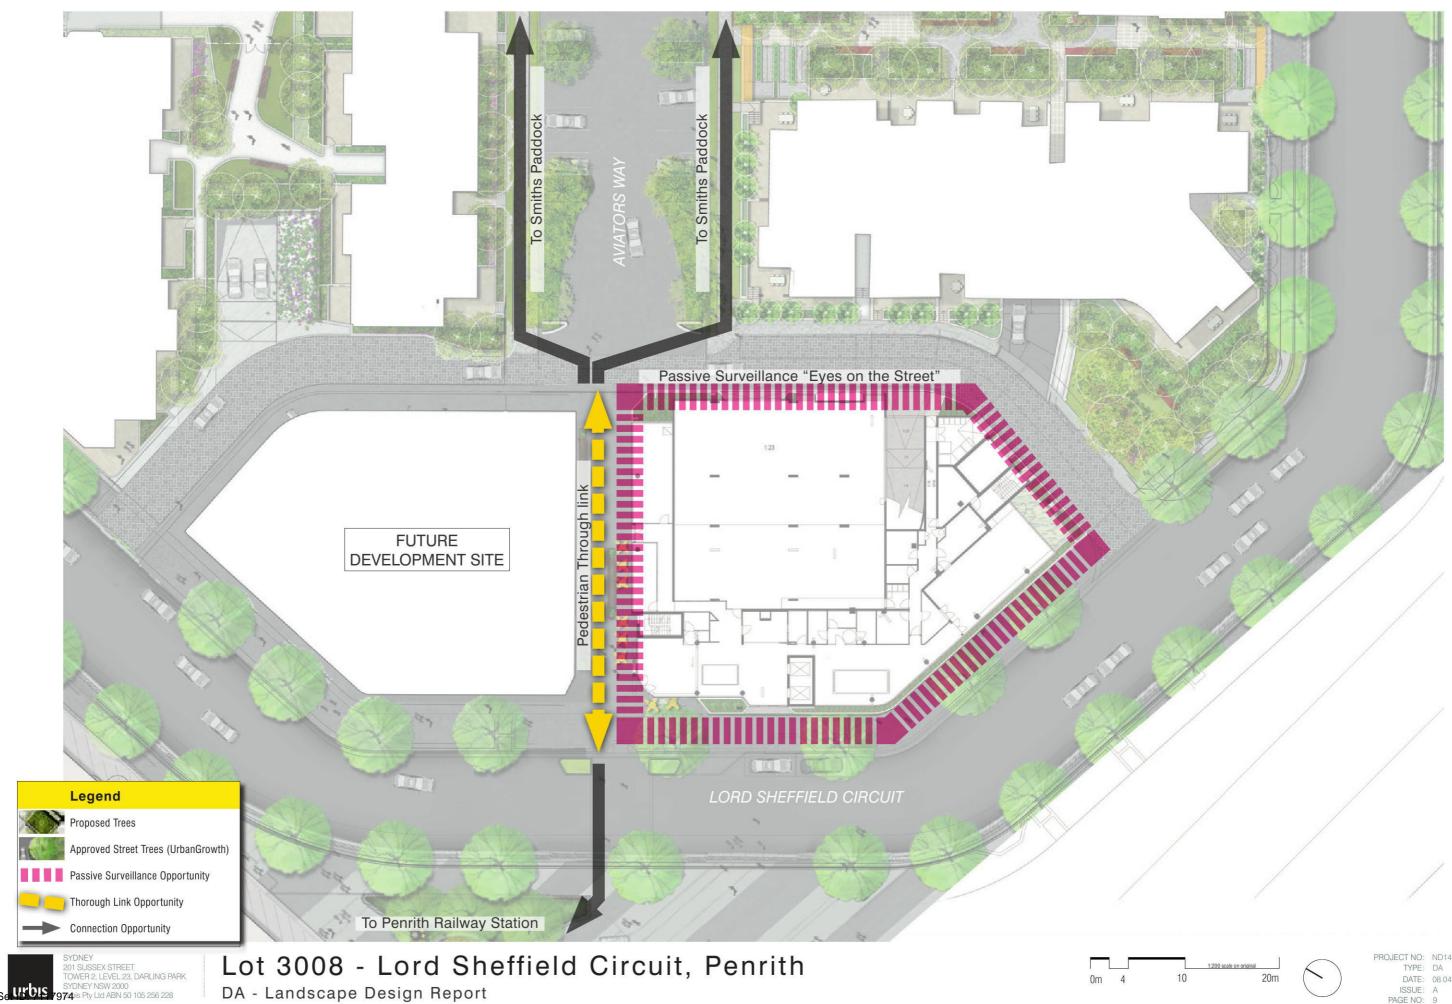

Version: 1, Version Date: 14/04/2016

DATE: 08.04.16 ISSUE: A

INDICATIVE PLANTING STRATEGY

Species Selection

Plants have been chosen for their contrasting form, foliage and colour, promoting a diversity of trees and understory planting. Responding to the proposed streetscape planting on the site, the surrounding context and climatic conditions, we have proposed a combination of exotic and native plants, providing a strong connection to the surrounding streets.

Proposed trees are primarily located along the new footpaths, providing shade to the walkways and seating benches on these circulation routes, the overall planting theme is to provide year round colour and vibrancy.









Botanical Name	Common Name	Height & Spread at Maturity (m)
STREETSCAPE		
SHRUBS AND HEDGES	3	
Callistemon 'Captain Cook'	Bottlebrush	4.0 x 3.0
Callistemon 'Hannah Ray'	Bottlebrush	2.5 x 2.0
Gardenia augusta	Gardenia	2.0 x 1.0
Grevillea 'Coconut Ice'	Grevillea	2.0 x 2.0
Grevillea 'Honey Gem'	Grevillea	1.0 x 0.75
Grevillea 'Superb'	Grevillea	1.5 x 2.0
Grevillea juniperina	Grevillea	1.5 x 0.5
Westringia fruticosa	Coastal Rosemary	1.5 x 1.5
Westringia longifolia	Long Leaf Westringia	3.0 x 3.0
COURTYARD & PODIU	M ONLY	
Agave Americana Marginata M Variegated	Varigated Octopus Agave	1.8 x 1.8
Camellia sasanqua	Camellia	2.0 x 1.0
Daphne odora	Winter Daphne	3.0 x 1.5
Dicksonia antarctica	Winter Daphne	8.0 x 4
Gardenia augusta	Gardenia	2.0 x 1.0
Lobelia gibberoa	Lobelia	3.5 x 4.0
Leucadendron 'Sundance'	Conebushes	1.5 x 1.5
Nandina domestica	Sacred Bamboo	1.8 x 1.5
Nandina domestica 'Nana'	Dwarf Sacred Bamboo	1.2 x 1.0
Syzygium paniculatum 'Nana'	Dwarf Bush Cherry	3.0 x 1.5
Viburnum tinus	Laurustinus	2.5 x 2.0
Westringia fruticosa	Coastal Rosemary	1.5 x 1.5
VINES		
Pandorea jasminoides	Bower of Beauty	15-20m runners
Trachelospermum jasminoides	Star Jasmine	15-20m runners

Landscape Typology



Lot 3008 - Lord Sheffield Circuit, Penrith

INDICATIVE PLANTING PALETTE



Lot 3008 - Lord Sheffield Circuit, Penrith
DA - Landscape Design Report

PROJECT NO: ND1444 TYPE: DA DATE: 08.04.16 ISSUE: A PAGE NO: 13

Version: 1, Version Date: 14/04/2016

SYDNEY 201 SUSSEX STREET TOWER 2, LEVEL 23, DARLING PARK

MATERIALS STRATEGY

All paving materials and street furniture would be subject to relevant Australian Standards and comply with Council's guidelines.

Paving to the through link will be an extension of the public domain paving.

The courtyard will consist of contrasting finishes, textures and materials (concrete, stone and timber).

Through link benches have been provided along, cafe tables and chairs can also be accommodated adjacent to the proposed cafe and main entrance.

Indicative Materials Palette













Sydney
Level 23, Darling Park Tower 2
201 Sussex Street
Sydney, NSW 2000
t 02 8233 9900
f 02 8233 9966

Melbourne Level 12, 120 Collins Street Melbourne VIC 3000 t 03 8663 4888 f 03 8663 4999

Brisbane Level 7, 123 Albert Street Brisbane QLD 4000 t 07 3007 3800 f 07 3007 3811

Perth
Level 1, 55 St Georges Terrace
Perth WA 6000
t 08 9346 0500
f 08 9221 1779

Australia • Asia • Middle East www.urbis.com.au info@urbis.com.au

Document Set ID: 7117974 Version: 1, Version Date: 14/04/2016

Ŋ

S	CHEDULE OF	LINES
No.	BEARING	DISTANCE
2	115°37′40"	10.78
3	179°25′45″	5.85
4	192°30′45″	8.94
5	14°58′05″	8.84
6	104°58′05"	1.045
7	4°00'40"	3.305
8	154°26′55″	0.315
11	287°07′35″	5.7
12	68°12′25″	4.245
13	154°49′15″	4.485
14	109°26′55″	5.655
15	199°26′55″	5.655
21	109°26′55″	5.655
22	199°26′55″	5.655
23	289°54′10″	4.6
24	290°28′	0.985
25	20°29′30″	7.485
26	290°29′30″	1.74
27	61°26′05″	8.485
29	289°26′55″	5.655
	r	

19°26′55"


30

M.G.A.

SCHEDULE OF REFERENCE MARKS

5.655

.20		No.	BEARING	DISTANCE	DESCRIPTION	
10-Jul-		Н	67°19′35″	11.59	DH&WFD (DP1171491)	
J.		I	84°40′35″	17.64	DH&WFD (DP1171491)	12
-0		J	156°28′50″	4.61 & 22.715	DH&WFD (DP1184495)	DP15397
::1		K	196°56′15″	4.045 & 17.84	DH&WFD (DP1184495)	
/Prt:		L	160°45′10"	4.09 & 17.88	DH&WFD (DP1184495)	
4/		М	191°57′	5.03 & 22.53	DH&WFD (DP1184495)	/
		N	46°25′50″	5.995 & 15.745	DH&WFD (DP1171493)	
OK		0	134°05′05"	4.315 & 19.07	DH&WFD (DP1171493)	
sc.		S	334°23'10"	4.07 & 17.87	DH&WFD (DP1171493)	
S		T	70°09′	5.75 & 15.05	DH&WFD (DP1171493)	
Sts:		U	192°23′25″	3.895	DH&WFD (DP1171491)	
s/		U	223°08′30"	8.53	SSM180838	
2		U	159°11′30″	17.96	DH&W	
201		٧	297°23′45″	8	BOLTFD (DP1159973)	
-2		W	246"34'10"	5.325	BOLTFD (DP1159973)	
-JuI-		Х	180°39′10″	7.97	DH&WFD (DP1159973)	
ا -		Υ	205°34′35″	11.93	DH&WFD (DP1171491)	
02		AA	352°48′25″	10.18	DH&W	
Rev: 02		AA	313°45′30″	19.72	DH&W	
Re		AB	280°20′25″	7.635	DH&W	
\ 		AB	274°54′25″	19.095	DH&W	'A
P Ω:]		AC	188°31'45"	4.245	DH&W	,,,,,,,,,,,,,,,,,,,,,,,,,,,,,,,,,,,,,,
98 Sr		AC	190°03′40″	18.435	DH&W	
44 /		AD	257°13′20″	9.355	DH&W	
18 rs		AD	211°57′	18.79	DH&W	
4		AE	342°53′	4.12	DH&W	
::DP : Lawye	-	AF	110°26′35″	4.835	DH&W	
C L		AG	269°56′10″	8.015	DH&W	
/Doc	١	AG	308°34'45"	16.225	DH&W	
ra.		AH	15°04′25″	4.535	DH&W	
06 St.		ΑI	39°29′25″	8.155	DH&W	
89 0		ΑI	333°39′35"	8.865	DH&W	
89. em	'	ΑJ	103°27′40″	27.185	DH&W	
9q:R896806 /	'	renenenenel				•
ው ው ተ	ment	Set IDO	71117394 30 4	40 50 Table of mn	1 80 90 100 1	10 120 130 140
r ersi	on: 1,	Version	Date: 14/04/2016			

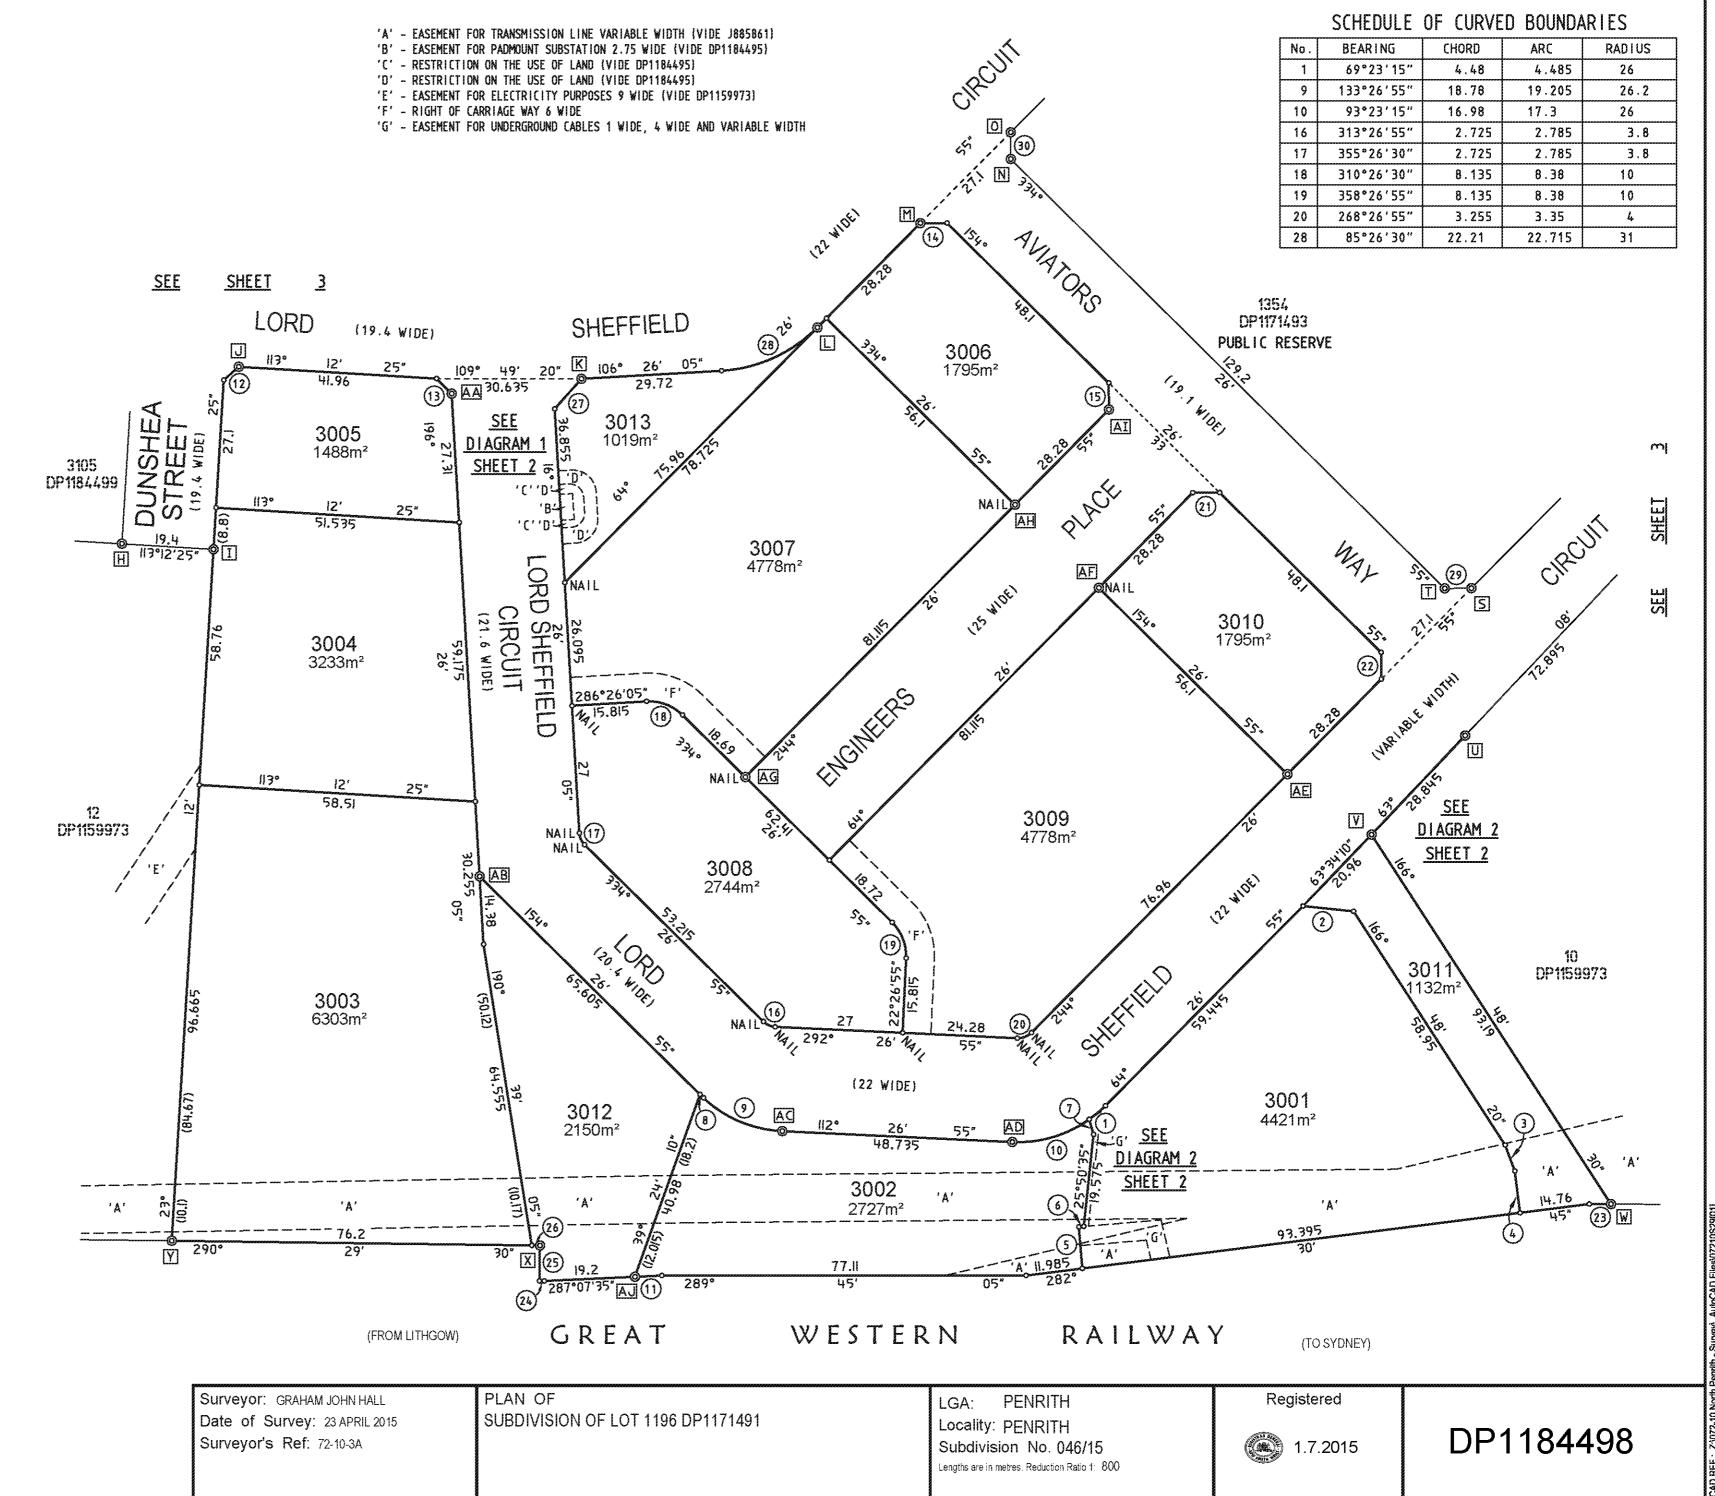

(D) od/ment Set 10 7117394 30 40 50 Table of mm 80 90 100 110 120 130 140 PVersion: 1, Version Date: 14/04/2016

6 263 217.8

6 263 196.1

6 263 424.4

COMBINED SCALE FACTOR 1.000151

ESTABLISHED MARK SOURCE: SCIMS DATED 20/04/2015

56 U U TRAVERSE

56 U U TRAVERSE

56 U U TRAVERSE

56 U U TRAVERSE

Surveyor: GRAHAM JOHN HALL

Surveyor's Ref: 72-10-3A

Date of Survey: 23 APRIL 2015

PLAN OF

SUBDIVISION OF LOT 1196 DP1171491

Registered

1.7.2015

DP1184498

PENRITH

Lengths are in metres. Reduction Ratio 1: 1000

Subdivision No. 046/15

Locality: PENRITH

LGA:

SSM.186021 286 680.5

SSM.186044 286 748.3

SSM.191390 286 617.8

SSM.191561 286 675.5 6 263 384.9

Ŋ

/Pgs:ALL

22

Ŋ

/Prt:10-Jul

었

/Sts:SC



NORTH PENRITH SERVICED APARTMENTS LORD SHEFFIELD CIRCUIT THORNTON PENRITH NSW

STORMWATER DRAINAGE

DRAWING LIST

-900 LEGEND AND COVER SHEET

H-901 GROUND FLOOR DA SUBMISSION STORMWATER LAYOUT H-902 LEVEL 01 DA SUBMISSION STORMWATER LAYOUT

C19, 38-48

NSW

MACARTHUR

STREET ULTIMO,

(02) 8346 4500

ROUDLY PRESENTING: Value Innovation Trust

WAYS ONE STEP AHEAD

SYMBOLS LEGEND LINETYPES LEGEND **ABBREVIATIONS** AAV AIR ADMITTANCE VALVE ABV AIR BLEED VALVE AFFL ABOVE FINISHED FLOOR LEVEL AIR ADMITTANCE VALVE OR MAXI VENT PENETRATES THROUGH WALL ATFW ARRESTOR TRAP FLOOR WASTE ATFW (1) ARRESTOR TRAP FLOOR WASTE BD BALCONY DRAIN FIRE HYDRANT BDP BALCONY DOWNPIPE BALANCING VALVE PIPE DROPPER BOUNDARY TRAP FIRE HOSE REEL **BALANCING VALVE** _____ e ____ e ____ BAYONET POINT (GAS) PIPE RISER (LARGE) FIRE SPRINKLERS **CHAMBER VENT** CW COLD WATER EXISTING GAS SERVICE BOUNDARY TRAP DCV DOUBLE CHECK VALVE PIPE RISER (SMALL) DP DOWNPIPE EXISTING DRAINAGE SERVICE CLEAR OUT HOT WATER PIPE FINISHED FLOOR LEVEL FIRE HOSE REEL EXISTING WATER SERVICE HOT WATER RETURN PIPE FHR FIRE HYDRANT CHECK VALVE / NON RETURN VALVE PRESSURE GAUGE FIXTURE UNIT STRUCTURAL BEAM FLOOR WASTE RECYCLED COLD WATER CONNECT TO EXISTING PRESSURE LIMITING VALVE **GRATED DRAIN GROUND LEVEL** PIPEWORK CAST IN SLAB GAS METER DIRECTION OF FLOW PRESSURE RELIEF VALVE HIGH LEVEL HOSE TAP DOUBLE CHECK VALVE PIT WITH GAS TIGHT LID HW HOT WATER HWU HOT WATER UNIT PIT WITH GRATED LID IL INVERT LEVEL SANITARY PLUMBING DRAWING CONTINUATION PRESSURE SWITCH SITE LOCATION MAP STORMWATER EXISTING DOWNPIPE SUBSOIL DRAINAGE \boxtimes **FILTER** PUMP CONTROL PANEL TRADE WASTE FIRE HOSE REEL RAINWATER OUTLET FLANGE REDUCED PRESSURE ZONE DEVICE FLOW SWITCH REFLUX VALVE FLOOR WASTE REVISION GARBAGE CHUTE SPRAYER SERVICE IDENTIFICATION SYMBOL GAS BALL VALVE SEWER MAN HOLE GAS METER SOLENOID VALVE GAS REGULATOR SPREADER GRATED DRAIN STOP VALVE FIRE HYDRANT STRAINER FIXTURE POINT STREET FIRE HYDRANT FLEXIBLE CONNECTION / EXPANSION JOINT LOCATION OF SITE-HOT WATER UNIT THERMOSTATIC MIXING VALVE HOSE TAP INSPECTION OPENING OVERFLOW GULLY PATH VALVE

St Hilliers

StHilliers

A: 88 CUMBERLAND

P: (02) 9259 5200

STREET, THE

ROCKS NSW

PROJECT

THORNTON QUEST

LOT 3008, NORTH PENRITH

A: L7 2-14 KINGS

CROSS ROAD

POTTS POINT

+61 2 8488 4600

NSW 2011

INSPECTION OPENING

IPMF INDUCT PIPE MICA FLAP

LOADING UNITS

MDL METER DATA LOGGER

NRV NON RETURN VALVE

PD PLANTER DRAIN
PLV PRESSURE LIMITING VALVE

PVC POLYVINYL CHLORIDE

RDZD REDUCED PRESSURE ZONE DEVICE

RL REDUCED LEVEL

RWO RAINWATER OUTLET

SYDP SYPHONIC DOWNPIPE

SURFACE LEVEL

SANITARY PLUMBING

SPD SEWER PUMP DISCHARGE

O/F OVERFLOW

SHR SHOWER

SK KITCHEN SINK

ST SOIL STACK

SV STOP VALVE

STW STORMWATER

TUNDISH

WC WATER CLOSET

WM WASHING METER

UNDER BENCH

LOW LEVEL

Rev Description

APPROVAL ISSUE


AMENDMENTS/REVISIONS

AMENDMENTS/REVISIONS

Initials Date Rev Description

North Penrith Serviced Apartments

	Town Planning	Drawing Register	
Number	Drawing Type	Drawing Name	Scale
DA000	Cover Pages	Cover Sheet	
DA100	Site Series	Site Plan	
DA101	Site Series	CONTEXT PLAN	
DA200	Plans	Ground Floor Plan	1:100@A1
DA201	Plans	Level 1	ad all part of southly by writing the
DA202	Plans	Level 2	
DA203	Plans	Level 3	
DA204	Plans	Level 4	
DA205	Plans	Level 5	* **** * * **** * ****
DA206	Plans	Level 6	
DA207	Plans	Level 7	
DA208	Plans	Roof Plan	
DA209.1	1:50 unit plans	1:50 Unit Plans	
DA209.2	1:50 unit plans	1:50 Unit Plans	
DA300	Elevations & Sections	West / South Elevations	
DA301	Elevations & Sections	Elevations - Streetscapes	* **** * **** * ****
DA302	Elevations & Sections	North Elevation	
DA303	Elevations & Sections	East Elevation	
DA304	Elevations & Sections	Elevations - Northern S.S	* * * * * * * * * * * * * * * *
DA305	Elevations & Sections	Sections	
DA306	Elevations & Sections	Sections	
DA307	Elevations & Sections	Sections	
DA400	Supporting Drawings	Shadows - 21 June-9-	
DA401	Supporting Drawings	Artists Impression	
DA402	Supporting Drawings	Artists Impression	
DA403	Supporting Drawings	Artists Impression	

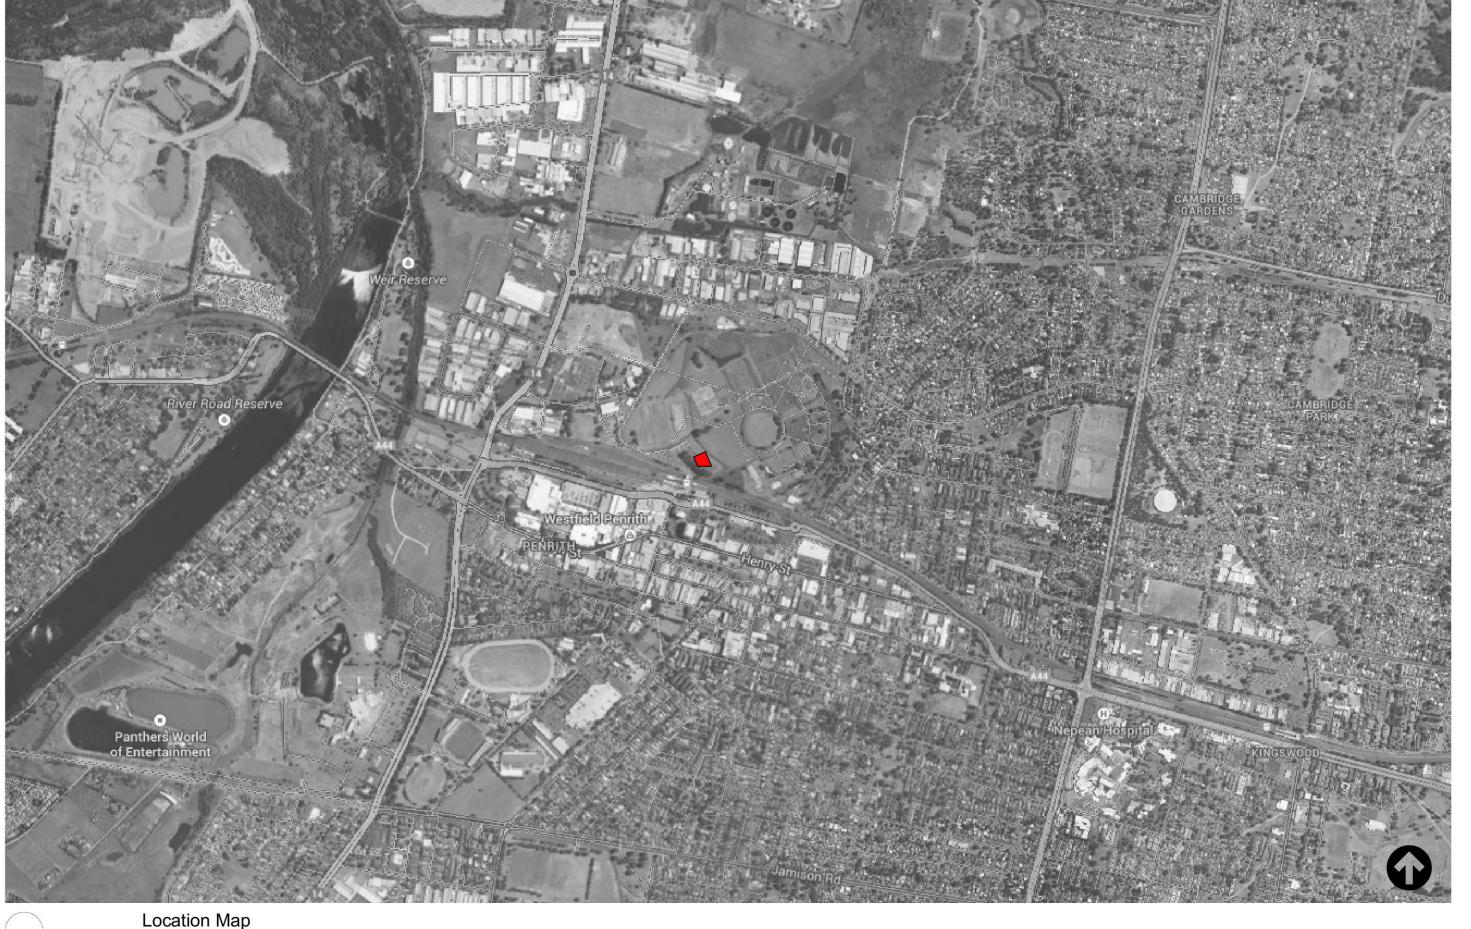





email: eddy@elephantsfoot.com.au

phone: 02 9780 3500

email: todwyer@rawfire.com

DKO Architecture (NSW) Pty Ltd C19, 38-48 MacArthur Street

info@DKO.com.au, www.DKO.com.au


Except as allowed under copyright act, no part of this drawing may be reproduced or otherwise dealt with without written permission of DKO Architecture.


Koos de Keijzer 5767 & David Randerson 8542 © DKO Architecture (NSW) Pty Ltd

Ultimo, NSW 2007

T +61 2 8346 4500

ABN: 81 956 706 590

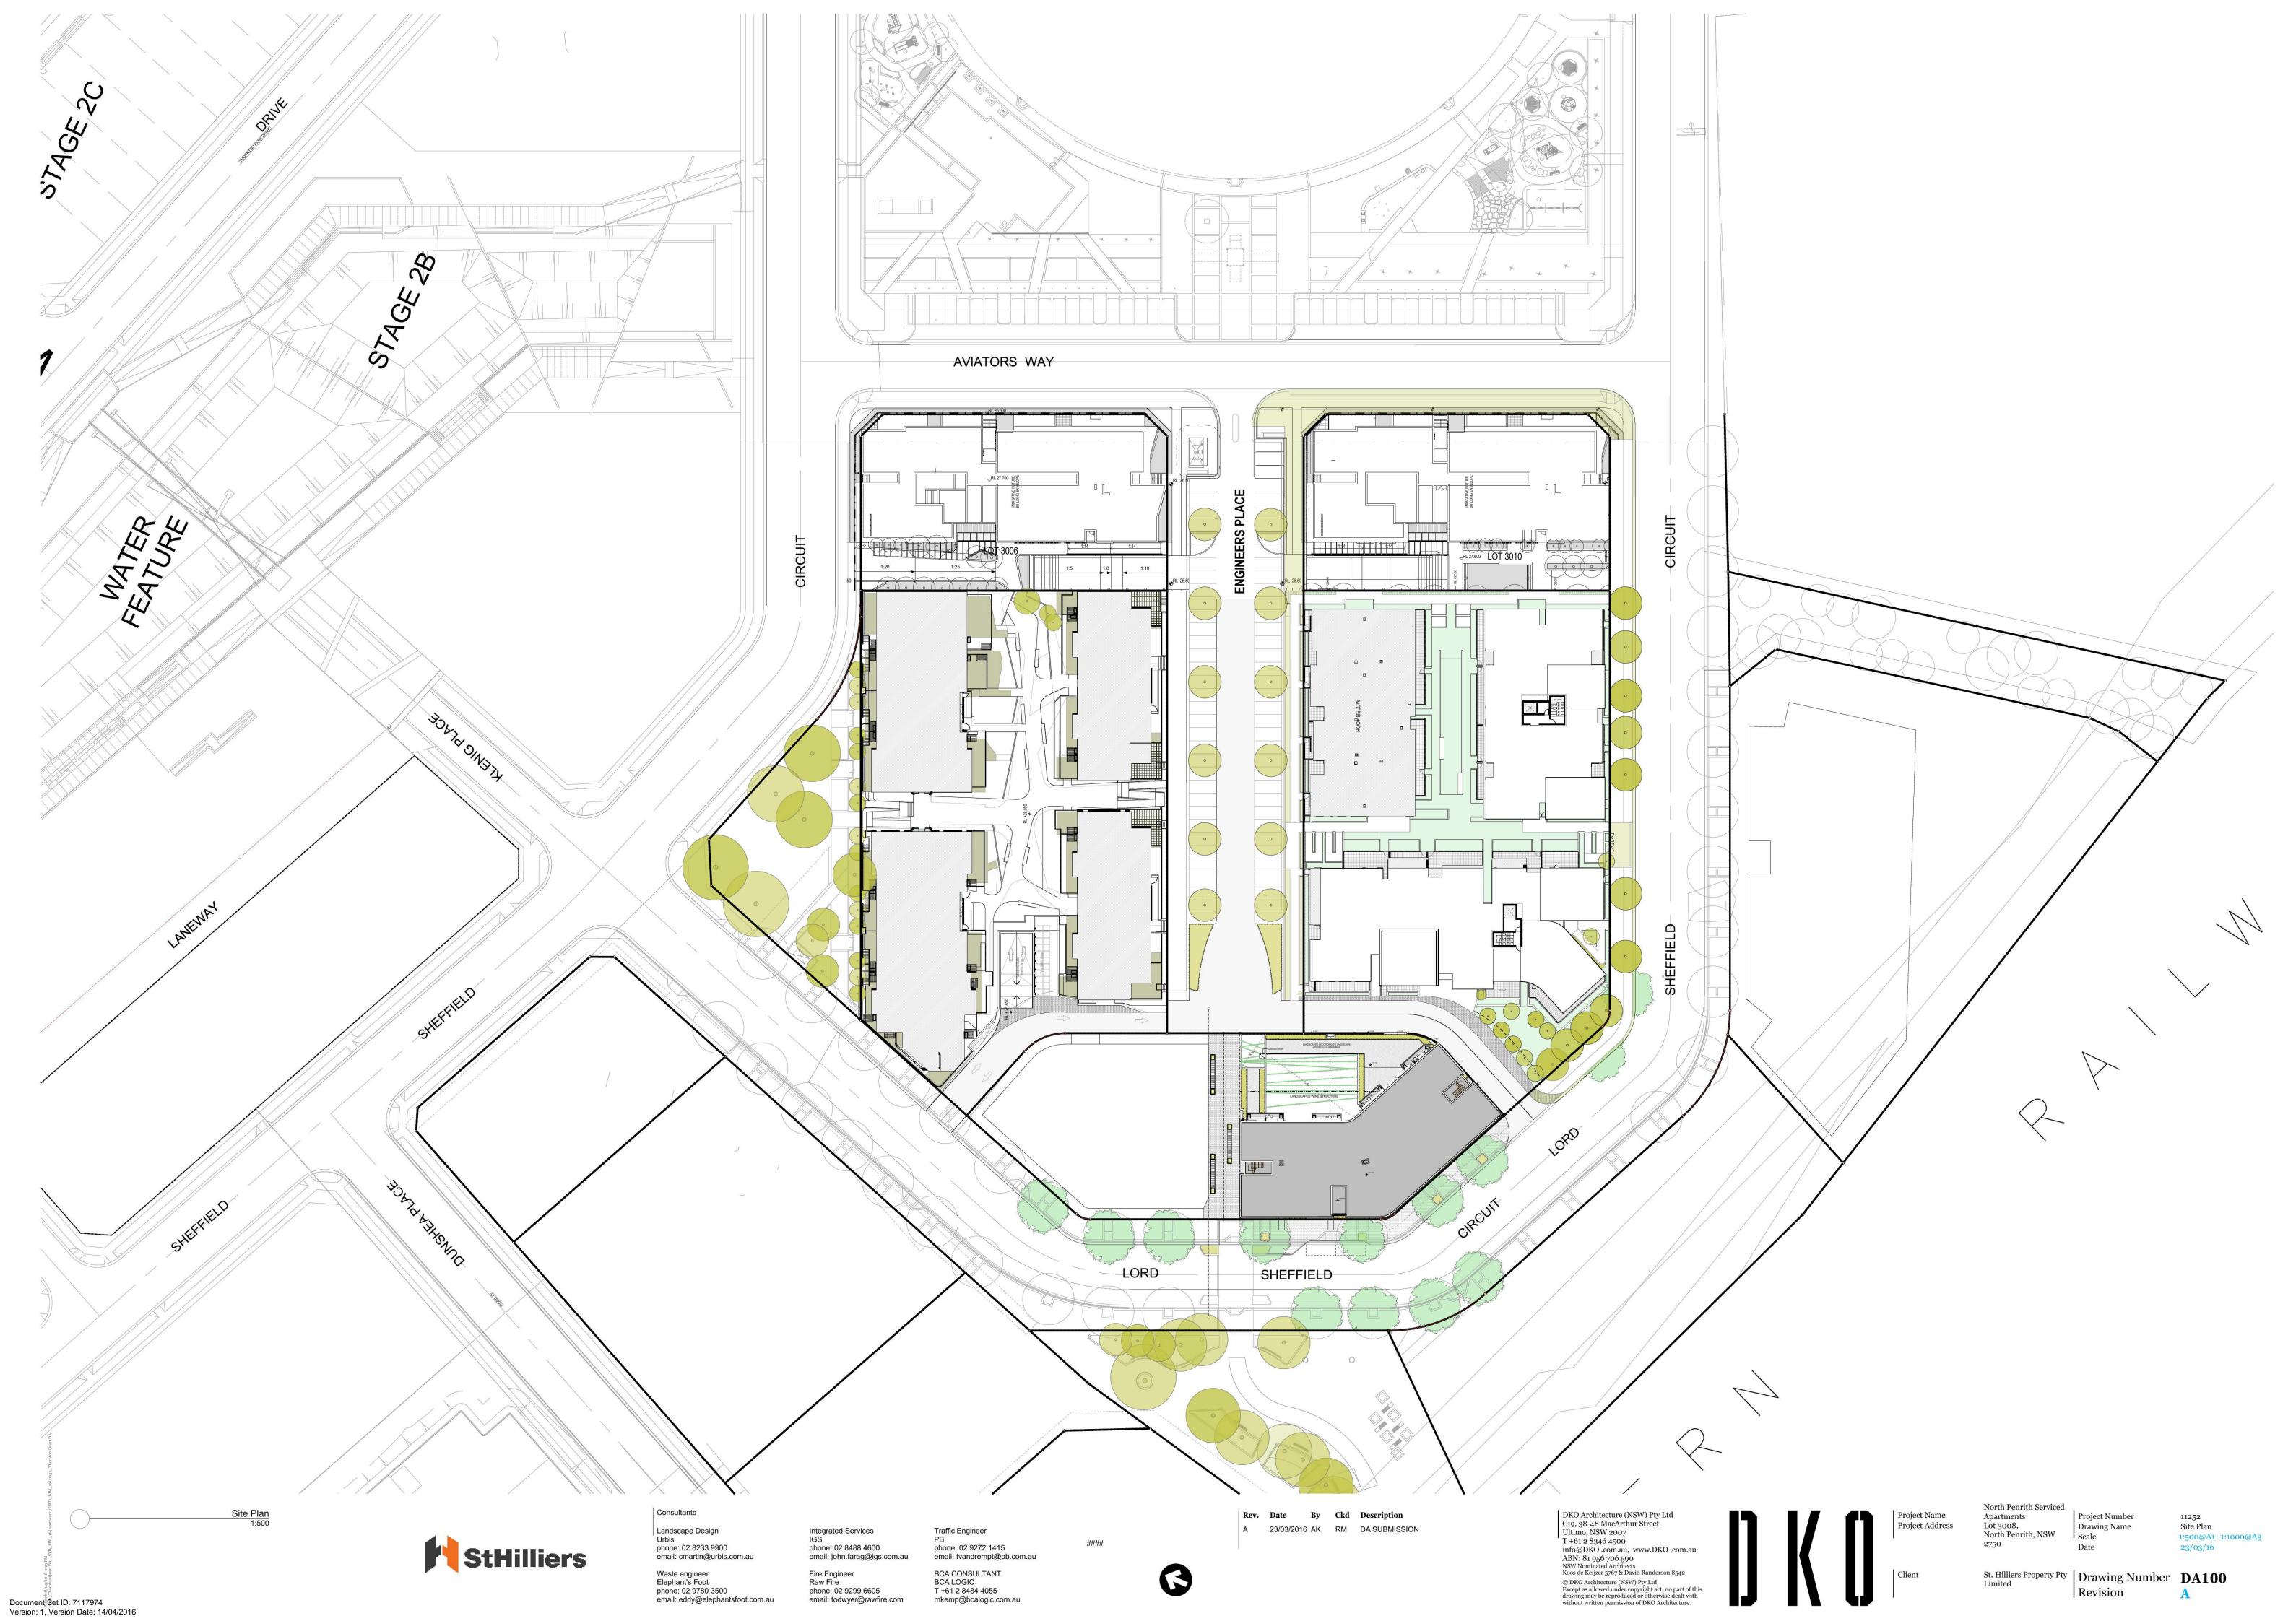

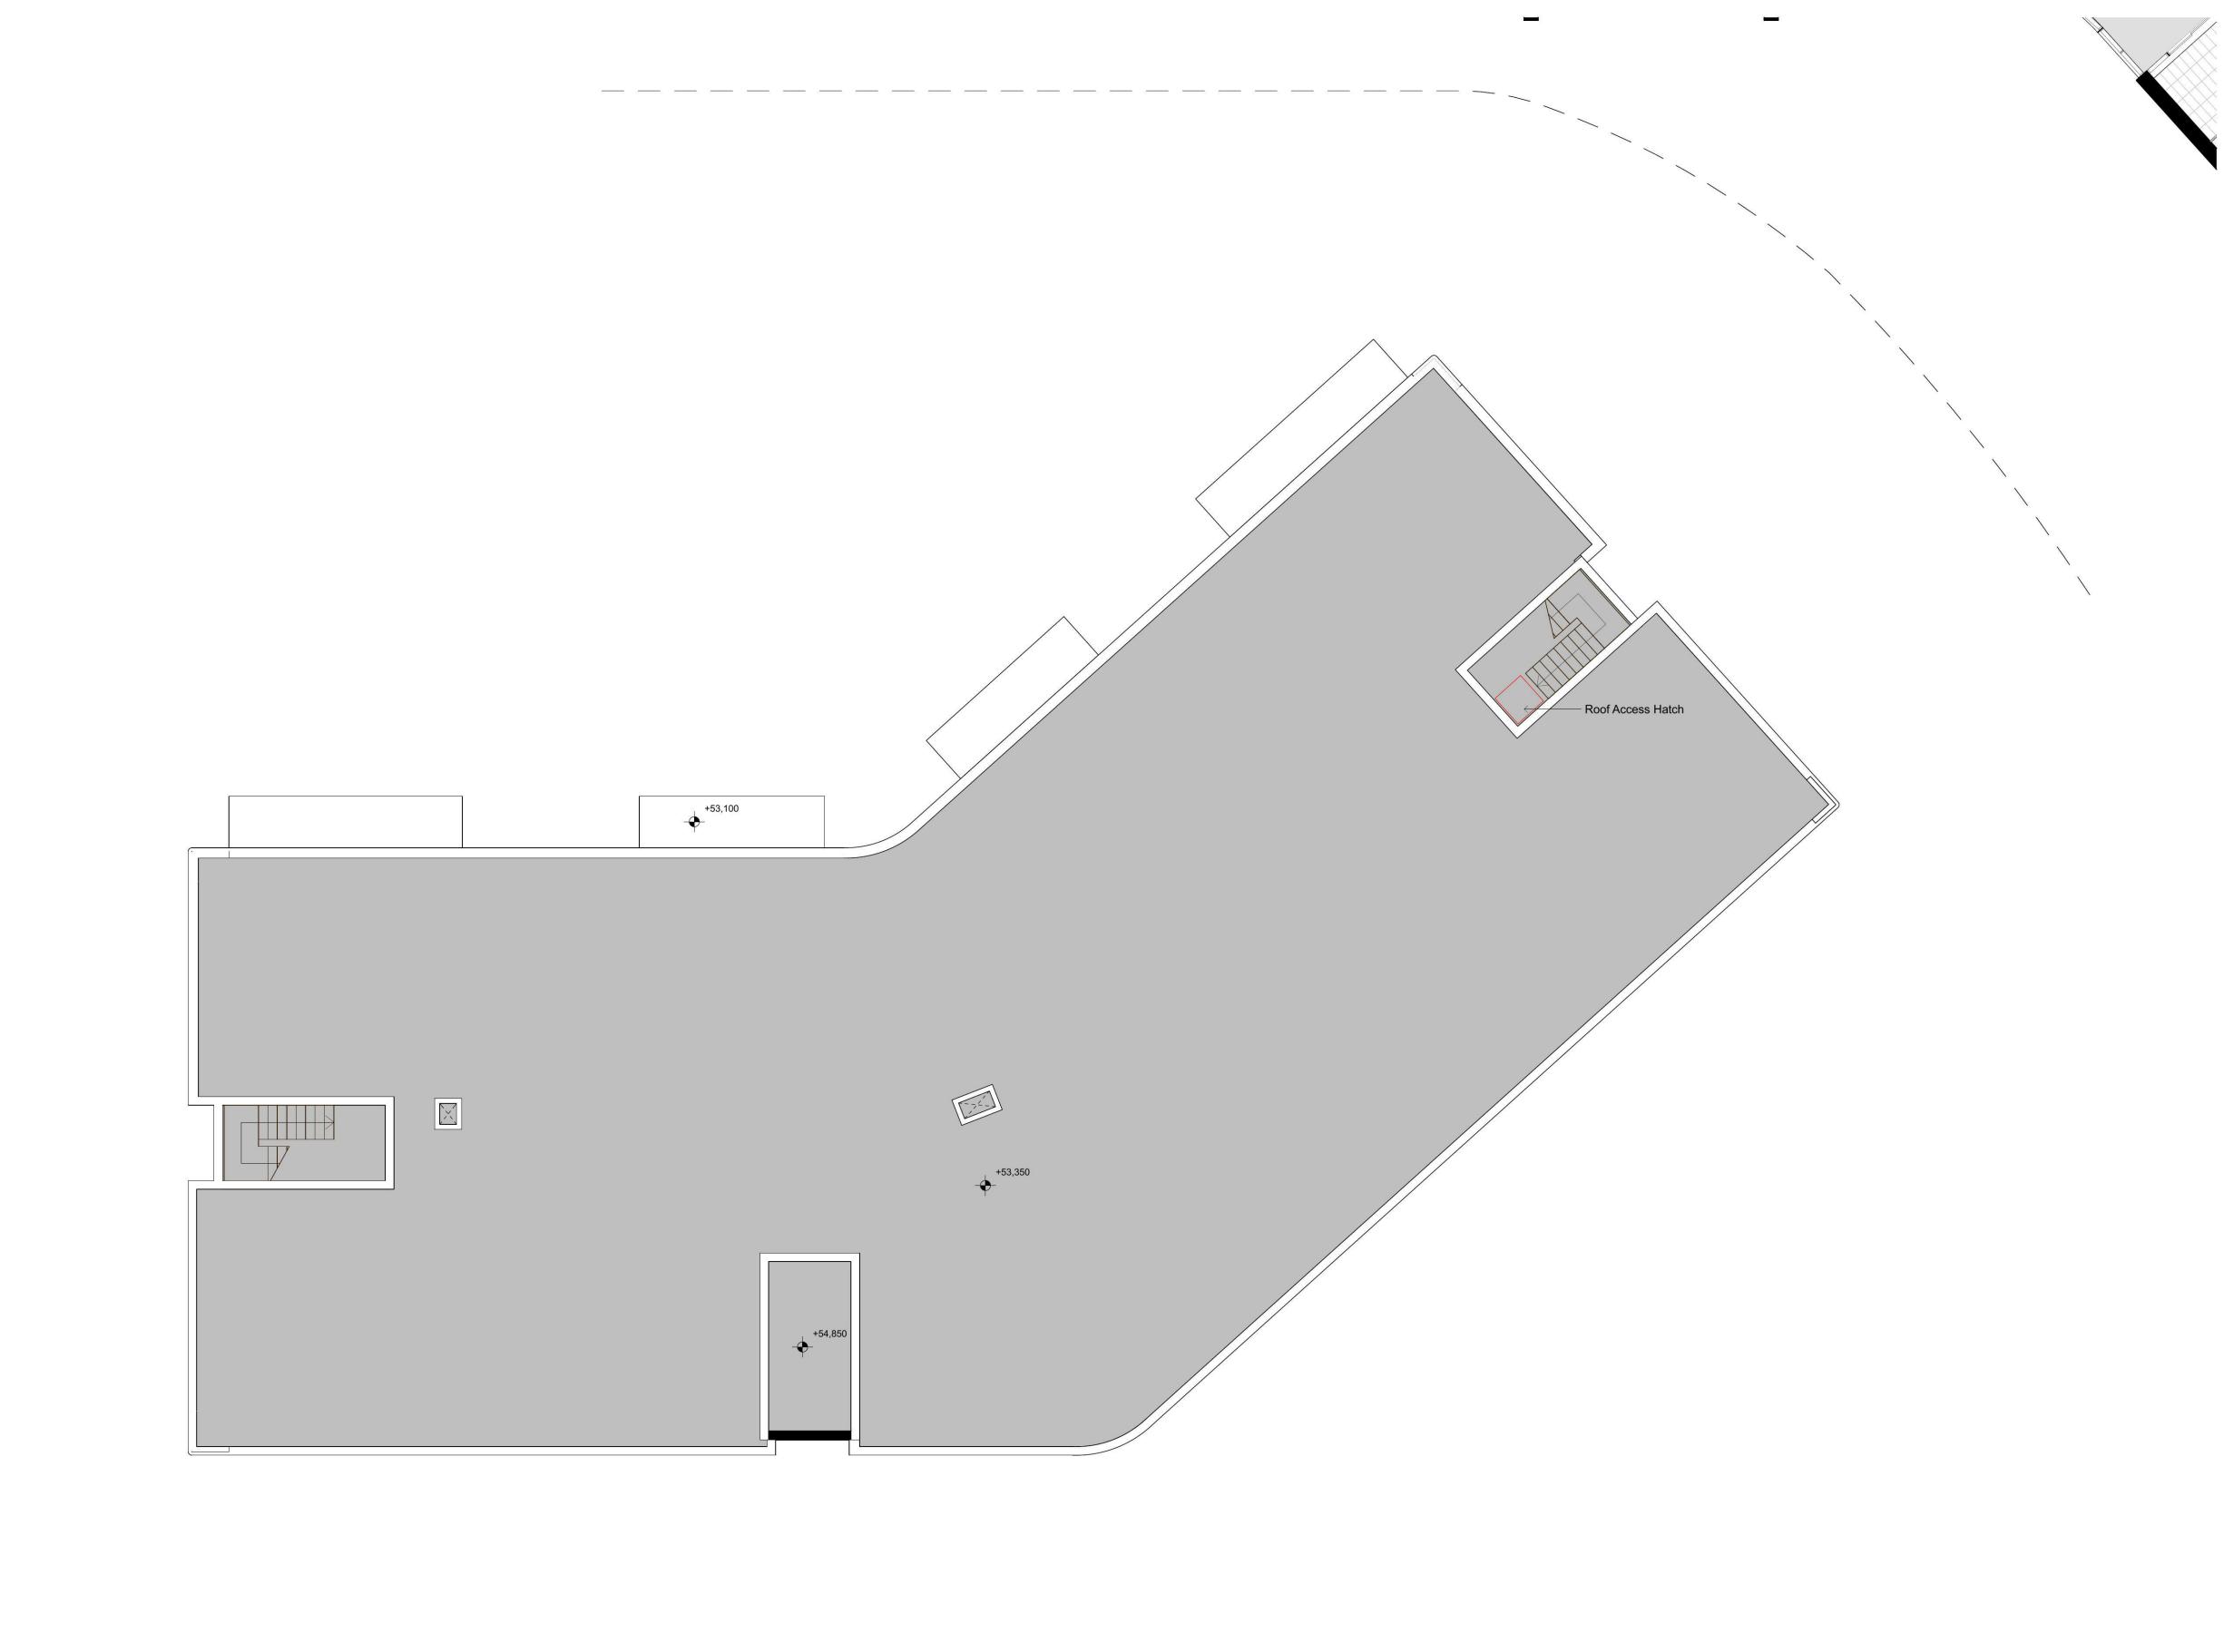



Roof 1:100

Document Set ID: 7117974 Version: 1, Version Date: 14/04/2016

Consultants Waste engineer Elephant's Foot phone: 02 9780 3500 email: eddy@elephantsfoot.com.au

Integrated Services IGS phone: 02 8488 4600 email: john.farag@igs.com.au

Traffic Engineer PB phone: 02 9272 1415 email: tvandrempt@pb.com.au ####



Rev. Date By Ckd Description

DKO Architecture (NSW) Pty Ltd
C19, 38-48 MacArthur Street
Ultimo, NSW 2007
T +61 2 8346 4500
info@DKO.com.au, www.DKO.com.au
ABN: 81 956 706 590
NSW Nominated Architects
Koos de Keijzer 5767 & David Randerson 8542
© DKO Architecture (NSW) Pty Ltd
Except as allowed under copyright act, no part of this
drawing may be reproduced or otherwise dealt with
without written permission of DKO Architecture.

North Penrith Serviced
Apartments
Lot 3008,
North Penrith, NSW
2750

Project Number
Drawing Name
Scale
Date

11252 Roof Plan 1:100@A1 1:200@A3 23/03/16

St. Hilliers Property Pty Limited Drawing Number Revision DA208



Document Set ID: 7117974 Version: 1, Version Date: 14/04/2016

Note: Not a True Elevation.



email: eddy@elephantsfoot.com.au

email: todwyer@rawfire.com

mkemp@bcalogic.com.au



DKO Architecture (NSW) Pty Ltd C19, 38-48 MacArthur Street Ultimo, NSW 2007 T+61 2 8346 4500 info@DKO .com.au, www.DKO .com.au ABN: 81 956 706 590 NSW Nominated Architects Koos de Keijzer 5767 & David Randerson 8542

© DKO Architecture (NSW) Pty Ltd
Except as allowed under copyright act, no part of this
drawing may be reproduced or otherwise dealt with
without written permission of DKO Architecture.

North Penrith Serviced Apartments
Lot 3008,
North Penrith, NSW

Drawing Name

West / South Elevations 1:100@A1 1:200@A3 23/03/16



StHilliers

Document Set ID: 7117974 Version: 1, Version Date: 14/04/2016 Consultants Landscape Design Urbis phone: 02 8233 9900 email: cmartin@urbis.com.au Waste engineer Elephant's Foot phone: 02 9780 3500

email: eddy@elephantsfoot.com.au

Integrated Services IGS phone: 02 8488 4600 email: john.farag@igs.com.au Fire Engineer Raw Fire phone: 02 9299 6605

email: todwyer@rawfire.com

Traffic Engineer phone: 02 9272 1415 email: tvandrempt@pb.com.au BCA CONSULTANT BCA LOGIC T +61 2 8484 4055

mkemp@bcalogic.com.au

####

Rev. Date By Ckd Description 23/03/2016 AK RM DA SUBMISSION

DKO Architecture (NSW) Pty Ltd C19, 38-48 MacArthur Street Ultimo, NSW 2007 T+61 2 8346 4500 info@DKO.com.au, www.DKO.com.au

ABN: 81 956 706 590 NSW Nominated Architects Koos de Keijzer 5767 & David Randerson 8542

© DKO Architecture (NSW) Pty Ltd
Except as allowed under copyright act, no part of this
drawing may be reproduced or otherwise dealt with
without written permission of DKO Architecture.

North Penrith Serviced Apartments Lot 3008, North Penrith, NSW 2750

Scale

11252 Elevations - Streetscapes Drawing Name 1:100@A1 1:200@A3 23/03/16

St. Hilliers Property Pty | Drawing Number DA301







Consultants Landscape Design Urbis phone: 02 8233 9900 email: cmartin@urbis.com.au Waste engineer Elephant's Foot phone: 02 9780 3500

email: eddy@elephantsfoot.com.au

Integrated Services IGS phone: 02 8488 4600 email: john.farag@igs.com.au Fire Engineer Raw Fire phone: 02 9299 6605

email: todwyer@rawfire.com

Traffic Engineer phone: 02 9272 1415 email: tvandrempt@pb.com.au BCA CONSULTANT BCA LOGIC T +61 2 8484 4055

mkemp@bcalogic.com.au

####

Rev. Date By Ckd Description 23/03/2016 AK RM DA SUBMISSION DKO Architecture (NSW) Pty Ltd C19, 38-48 MacArthur Street Ultimo, NSW 2007 T +61 2 8346 4500 info@DKO.com.au, www.DKO.com.au © DKO Architecture (NSW) Pty Ltd
Except as allowed under copyright act, no part of this
drawing may be reproduced or otherwise dealt with
without written permission of DKO Architecture.

ABN: 81 956 706 590 NSW Nominated Architects Koos de Keijzer 5767 & David Randerson 8542

Project Address

North Penrith Serviced Apartments
Lot 3008,
North Penrith, NSW
2750

Drawing Name Scale

11252 North Elevation 1:100@A1 1:200@A3 23/03/16

St. Hilliers Property Pty Limited Drawing Number DA302 Revision



EAST ELEVATION 1:100 01



Consultants Landscape Design Urbis phone: 02 8233 9900 email: cmartin@urbis.com.au Waste engineer Elephant's Foot phone: 02 9780 3500

email: eddy@elephantsfoot.com.au

Integrated Services IGS phone: 02 8488 4600 email: john.farag@igs.com.au Fire Engineer Raw Fire phone: 02 9299 6605

email: todwyer@rawfire.com

Traffic Engineer phone: 02 9272 1415 email: tvandrempt@pb.com.au BCA CONSULTANT BCA LOGIC T +61 2 8484 4055

mkemp@bcalogic.com.au

####

Rev. Date By Ckd Description 23/03/2016 AK RM DA SUBMISSION DKO Architecture (NSW) Pty Ltd C19, 38-48 MacArthur Street Ultimo, NSW 2007 T+61 2 8346 4500 info@DKO.com.au, www.DKO.com.au ABN: 81 956 706 590 NSW Nominated Architects Koos de Keijzer 5767 & David Randerson 8542 © DKO Architecture (NSW) Pty Ltd
Except as allowed under copyright act, no part of this
drawing may be reproduced or otherwise dealt with
without written permission of DKO Architecture.

2750

North Penrith Serviced Apartments Lot 3008, North Penrith, NSW Drawing Name Scale

11252 East Elevation 1:100@A1 1:200@A3 23/03/16

St. Hilliers Property Pty | Drawing Number DA303 Revision





Consultants

Landscape Design
Urbis
phone: 02 8233 9900
email: cmartin@urbis.com.au

Waste engineer
Elephant's Foot
phone: 02 9780 3500

email: eddy@elephantsfoot.com.au

Integrated Services
IGS
phone: 02 8488 4600
email: john.farag@igs.com.au

Fire Engineer
Raw Fire
phone: 02 9299 6605
email: todwyer@rawfire.com

Traffic Engineer
PB
phone: 02 9272 1415
email: tvandrempt@pb.com.au

BCA CONSULTANT
BCA LOGIC
T +61 2 8484 4055

mkemp@bcalogic.com.au

####

Rev.DateByCkdDescriptionA23/03/2016 AKRMDA SUBMISSION

DKO Architecture (NSW) Pty Ltd
C19, 38-48 MacArthur Street
Ultimo, NSW 2007
T +61 2 8346 4500
info@DKO .com.au, www.DKO .com.au
ABN: 81 956 706 590
NSW Nominated Architects
Koos de Keijzer 5767 & David Randerson 8542
© DKO Architecture (NSW) Pty Ltd
Except as allowed under copyright act, no part of this
drawing may be reproduced or otherwise dealt with
without written permission of DKO Architecture.

Project No Project Ad

Project Name Apartm Project Address Lot 300 North F 2750

North Penrith Serviced Apartments Lot 3008, North Penrith, NSW

Project Number Drawing Name Scale

11252 Elevations - Northern S.S 1:100@A1 1:200@A3 23/03/16

St. Hilliers Property Pty Limited Drawing Number DA304 Revision





Consultants Landscape Design Urbis phone: 02 8233 9900 email: cmartin@urbis.com.au

email: eddy@elephantsfoot.com.au

Integrated Services IGS phone: 02 8488 4600 Fire Engineer Raw Fire phone: 02 9299 6605 email: todwyer@rawfire.com

Traffic Engineer #### email: tvandrempt@pb.com.au BCA CONSULTANT BCA LOGIC T +61 2 8484 4055 mkemp@bcalogic.com.au

Rev. Date By Ckd Description 23/03/2016 AK RM DA SUBMISSION DKO Architecture (NSW) Pty Ltd C19, 38-48 MacArthur Street Ultimo, NSW 2007 T+61 2 8346 4500 info@DKO.com.au, www.DKO.com.au © DKO Architecture (NSW) Pty Ltd
Except as allowed under copyright act, no part of this
drawing may be reproduced or otherwise dealt with
without written permission of DKO Architecture.


ABN: 81 956 706 590 NSW Nominated Architects Koos de Keijzer 5767 & David Randerson 8542

North Penrith Serviced Apartments
Lot 3008,
North Penrith, NSW
2750

Drawing Name Scale

11252 Sections 1:100@A1 1:200@A3 23/03/16

St. Hilliers Property Pty Limited Drawing Number DA305 Revision

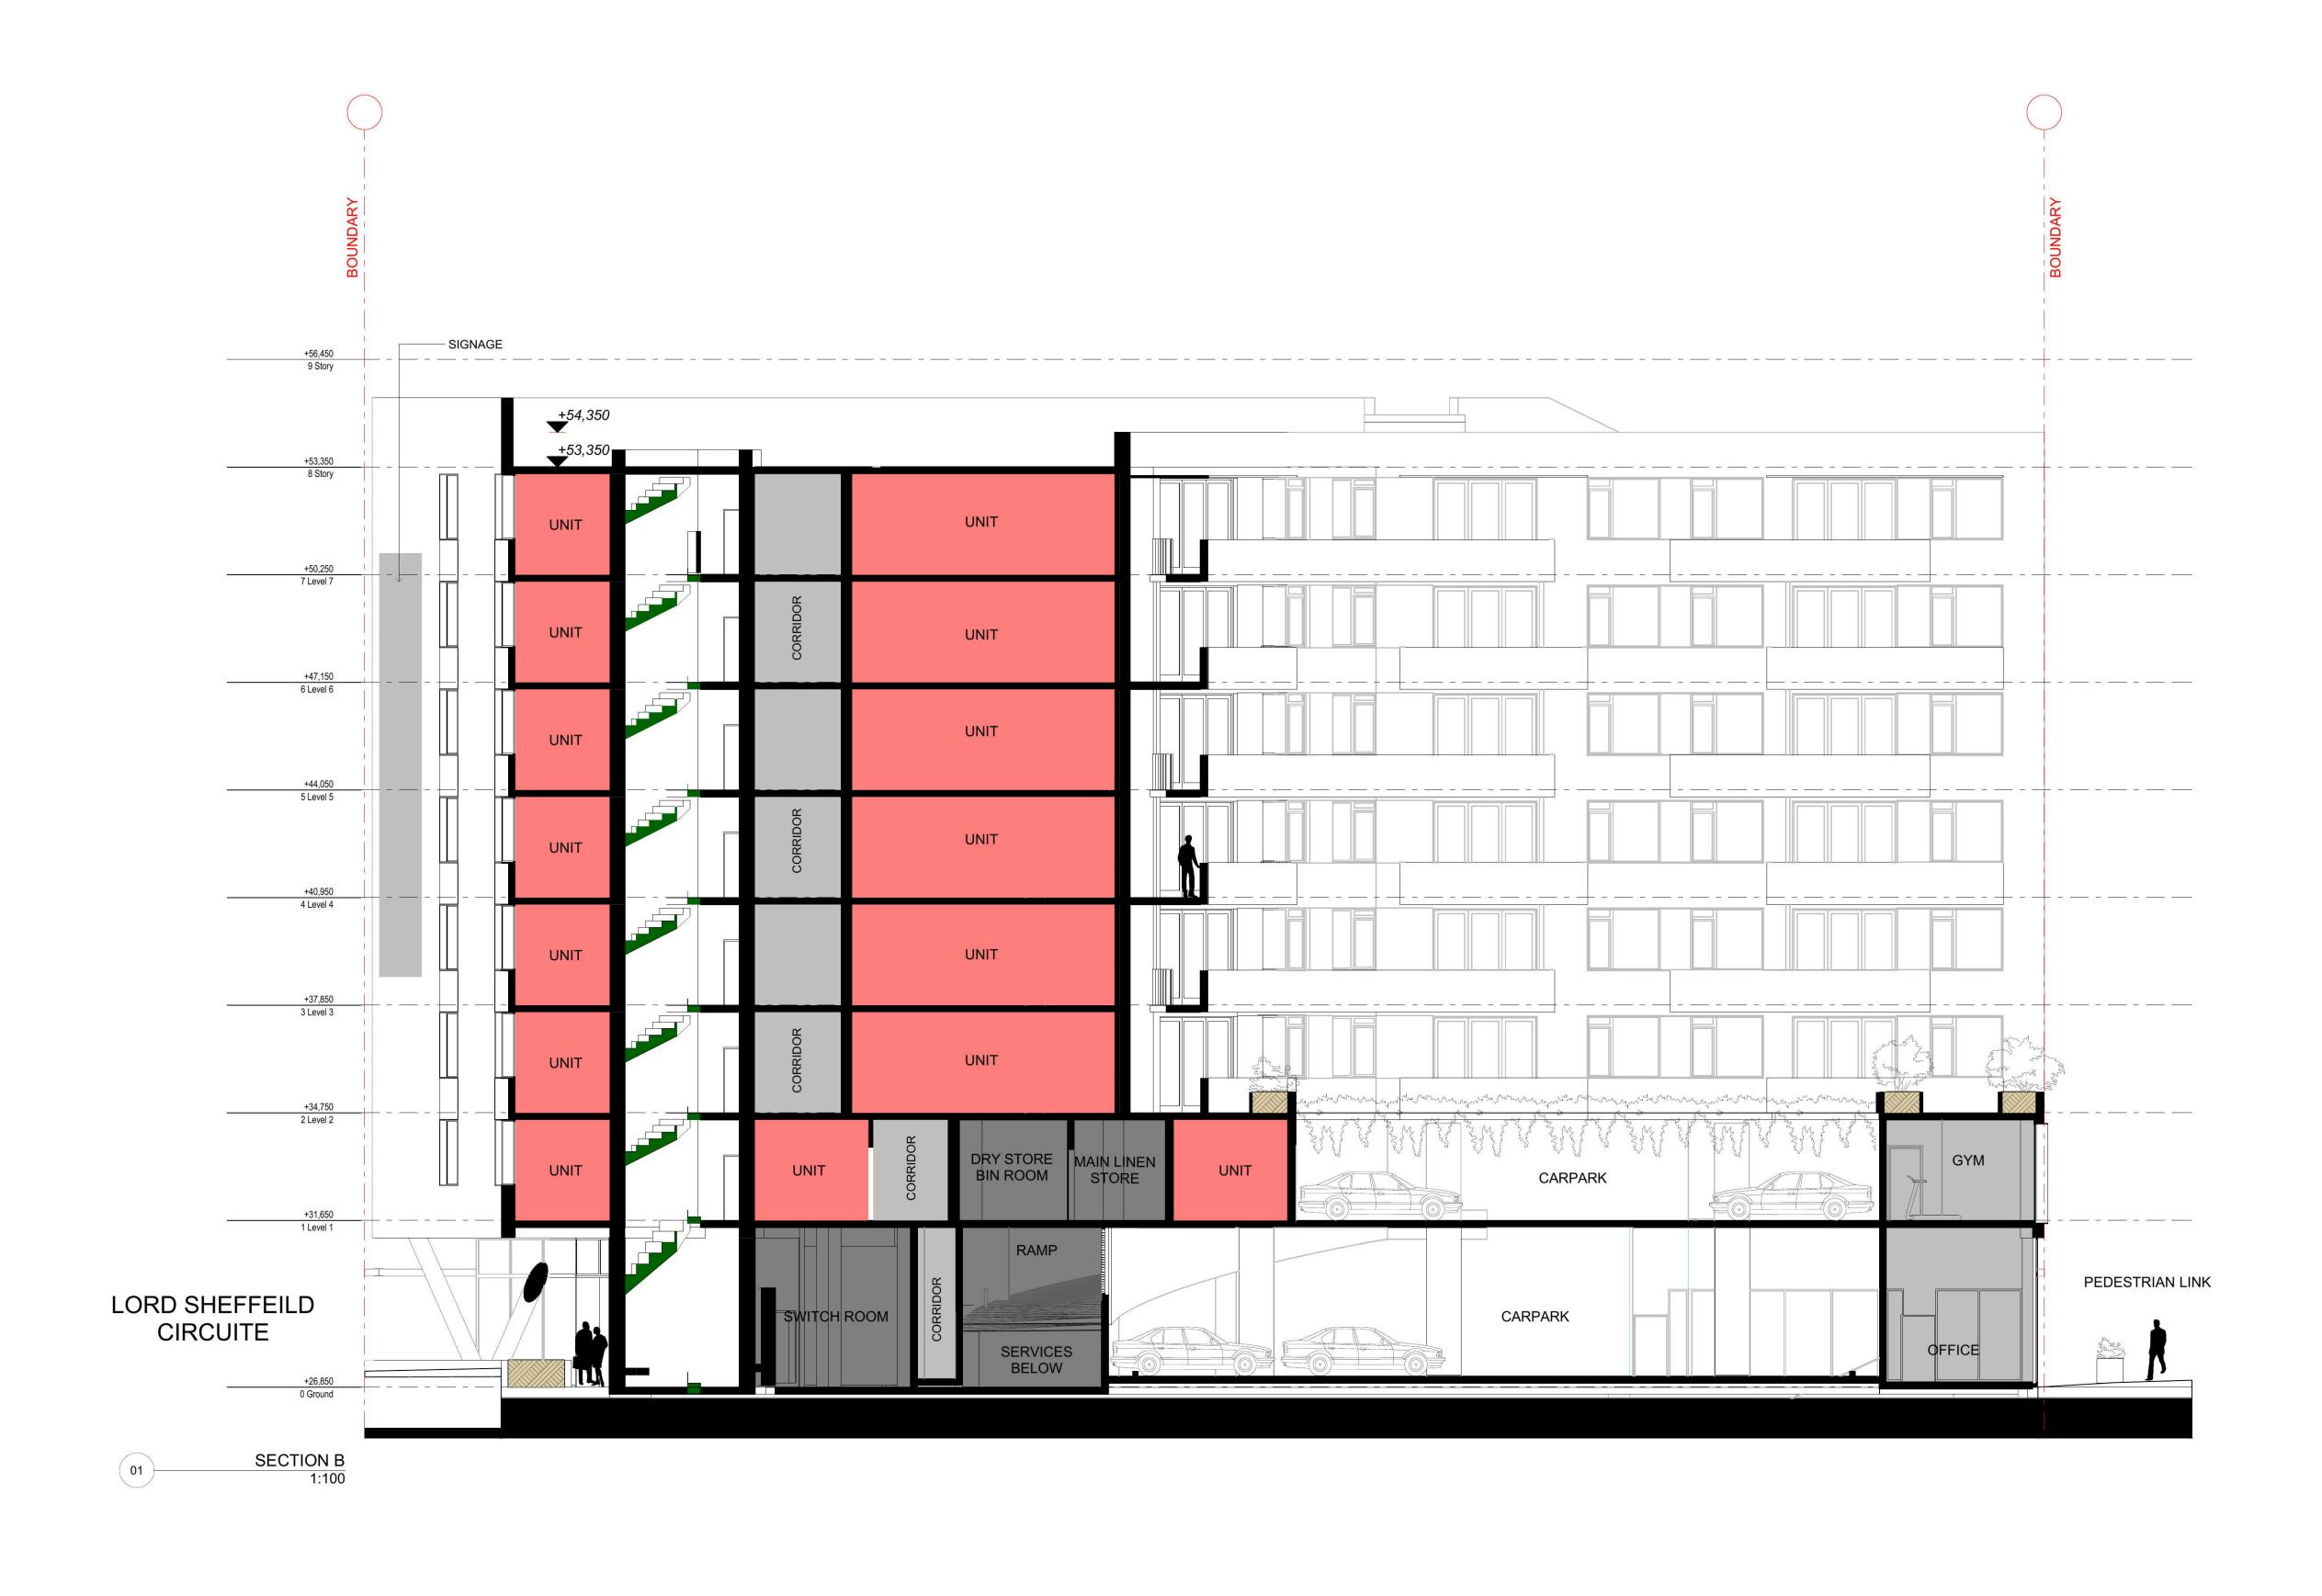



Consultants Landscape Design Urbis phone: 02 8233 9900 email: cmartin@urbis.com.au Waste engineer Elephant's Foot phone: 02 9780 3500

email: eddy@elephantsfoot.com.au

Integrated Services IGS phone: 02 8488 4600 email: john.farag@igs.com.au Fire Engineer Raw Fire phone: 02 9299 6605 email: todwyer@rawfire.com

Traffic Engineer phone: 02 9272 1415 email: tvandrempt@pb.com.au BCA CONSULTANT BCA LOGIC T +61 2 8484 4055 mkemp@bcalogic.com.au


Rev. Date By Ckd Description 23/03/2016 AK RM DA SUBMISSION DKO Architecture (NSW) Pty Ltd C19, 38-48 MacArthur Street Ultimo, NSW 2007 T +61 2 8346 4500 info@DKO.com.au, www.DKO.com.au ABN: 81 956 706 590 NSW Nominated Architects Koos de Keijzer 5767 & David Randerson 8542 © DKO Architecture (NSW) Pty Ltd
Except as allowed under copyright act, no part of this
drawing may be reproduced or otherwise dealt with
without written permission of DKO Architecture.

North Penrith Serviced Lot 3008, North Penrith, NSW Scale

11252 Sections 1:100@A1 1:200@A3 23/03/16

St. Hilliers Property Pty | Drawing Number DA306

Drawing Name

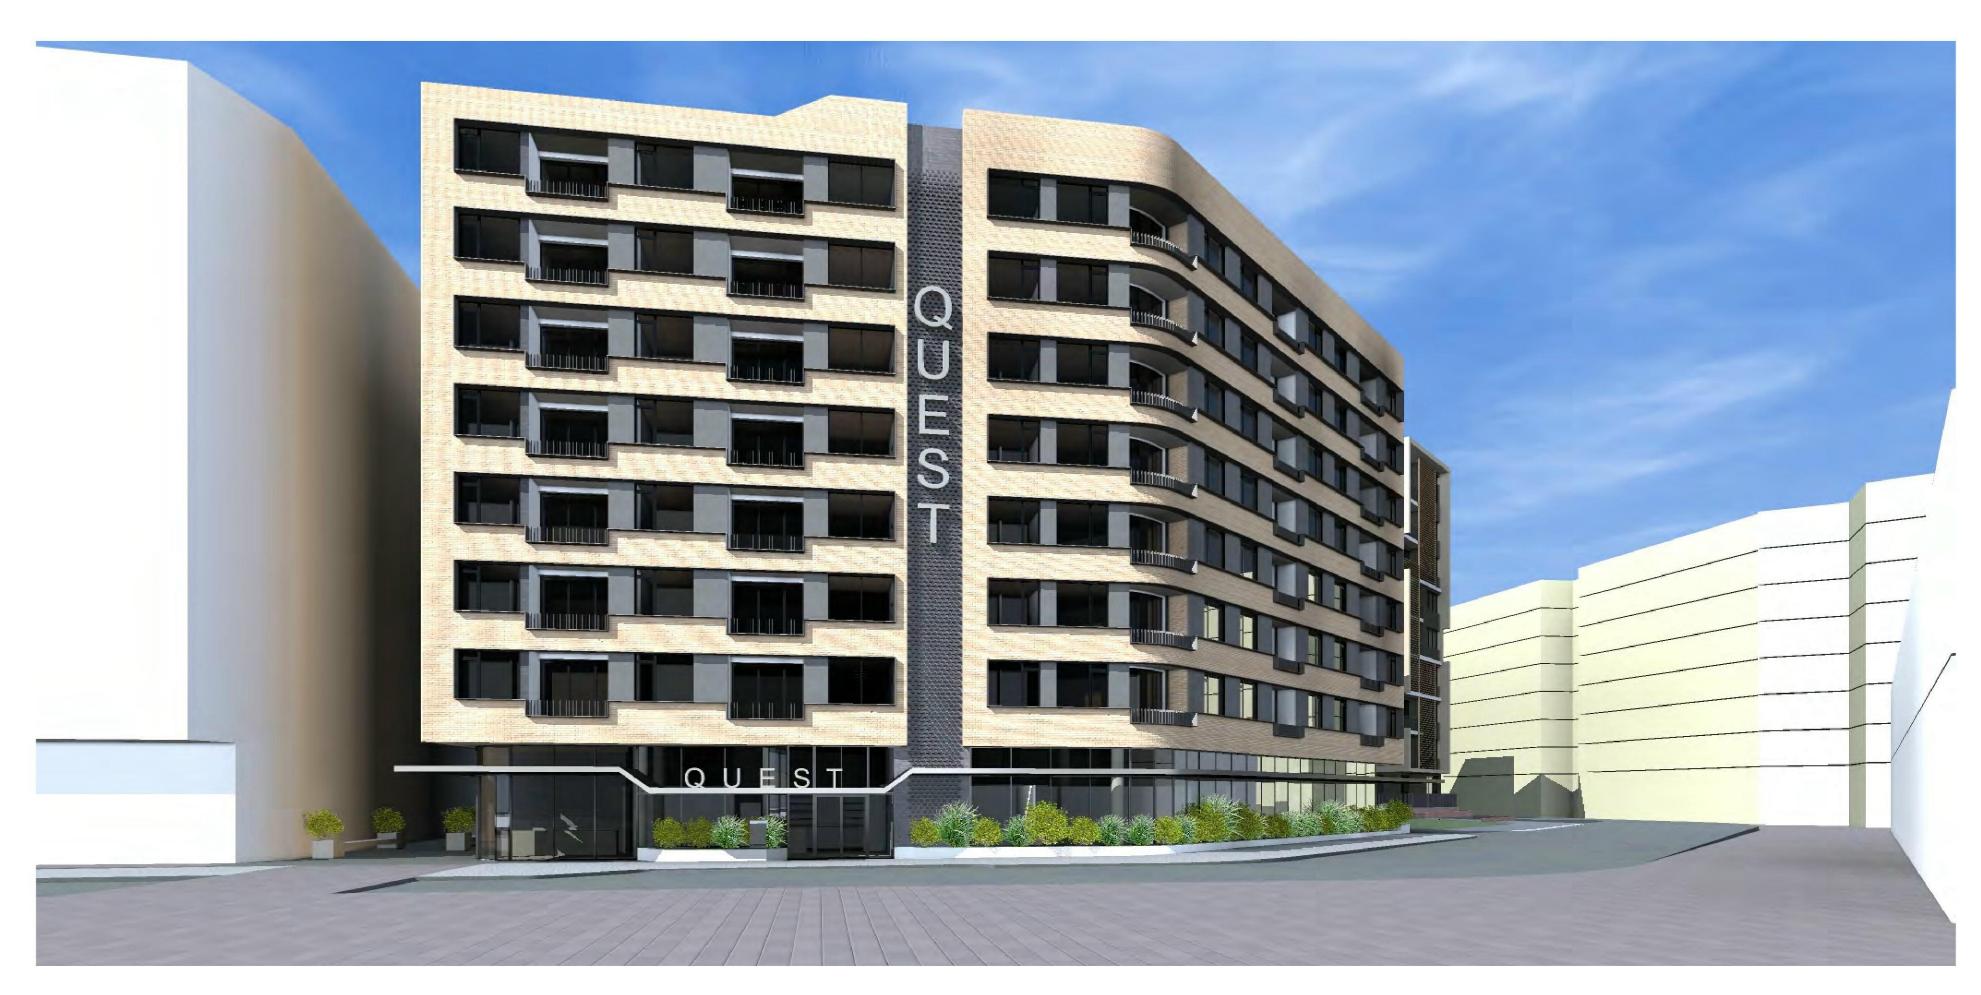







Consultants Landscape Design Urbis phone: 02 8233 9900 email: cmartin@urbis.com.au

Waste engineer Elephant's Foot phone: 02 9780 3500 email: eddy@elephantsfoot.com.au Fire Engineer Raw Fire phone: 02 9299 6605 email: todwyer@rawfire.com

Integrated Services IGS Traffic Engineer phone: 02 8488 4600 email: john.farag@igs.com.au phone: 02 9272 1415 email: tvandrempt@pb.com.au BCA CONSULTANT BCA LOGIC T +61 2 8484 4055 mkemp@bcalogic.com.au

3

Rev. Date By Ckd Description 23/03/2016 AK RM DA SUBMISSION DKO Architecture (NSW) Pty Ltd
C19, 38-48 MacArthur Street
Ultimo, NSW 2007
T +61 2 8346 4500
info@DKO .com.au, www.DKO .com.au
ABN: 81 956 706 590
NSW Nominated Architects
Koos de Keijzer 5767 & David Randerson 8542
© DKO Architecture (NSW) Pty Ltd
Except as allowed under copyright act, no part of this
drawing may be reproduced or otherwise dealt with
without written permission of DKO Architecture.

North Penrith Serviced
Apartments
Lot 3008,
North Penrith, NSW
2750

Project I
Drawing
Scale
Date

Artists Impression
N/A 23/03/16

St. Hilliers Property Pty Limited Drawing Number **DA401** Revision







Consultants Landscape Design Urbis phone: 02 8233 9900 email: cmartin@urbis.com.au Waste engineer Elephant's Foot phone: 02 9780 3500 email: eddy@elephantsfoot.com.au

Integrated Services IGS phone: 02 8488 4600 email: john.farag@igs.com.au Fire Engineer Raw Fire phone: 02 9299 6605 email: todwyer@rawfire.com

Traffic Engineer phone: 02 9272 1415 email: tvandrempt@pb.com.au BCA CONSULTANT BCA LOGIC T +61 2 8484 4055 mkemp@bcalogic.com.au

Rev. Date By Ckd Description 23/03/2016 AK RM DA SUBMISSION DKO Architecture (NSW) Pty Ltd
C19, 38-48 MacArthur Street
Ultimo, NSW 2007
T +61 2 8346 4500
info@DKO .com.au, www.DKO .com.au
ABN: 81 956 706 590
NSW Nominated Architects
Koos de Keijzer 5767 & David Randerson 8542
© DKO Architecture (NSW) Pty Ltd
Except as allowed under copyright act, no part of this
drawing may be reproduced or otherwise dealt with
without written permission of DKO Architecture.

North Penrith Serviced Apartments
Lot 3008,
North Penrith, NSW
2750

Artists Impression 23/03/16

St. Hilliers Property Pty Limited Drawing Number DA402 Revision







Consultants Landscape Design Urbis phone: 02 8233 9900 email: cmartin@urbis.com.au Waste engineer Elephant's Foot phone: 02 9780 3500 email: eddy@elephantsfoot.com.au

Integrated Services IGS phone: 02 8488 4600 email: john.farag@igs.com.au Fire Engineer Raw Fire phone: 02 9299 6605 email: todwyer@rawfire.com

Traffic Engineer PB phone: 02 9272 1415 email: tvandrempt@pb.com.au BCA CONSULTANT BCA LOGIC T +61 2 8484 4055 mkemp@bcalogic.com.au

Rev. Date By Ckd Description 23/03/2016 AK RM DA SUBMISSION DKO Architecture (NSW) Pty Ltd
C19, 38-48 MacArthur Street
Ultimo, NSW 2007
T +61 2 8346 4500
info@DKO.com.au, www.DKO.com.au
ABN: 81 956 706 590
NSW Nominated Architects
Koos de Keijzer 5767 & David Randerson 8542
© DKO Architecture (NSW) Pty Ltd
Except as allowed under copyright act, no part of this
drawing may be reproduced or otherwise dealt with
without written permission of DKO Architecture.

North Penrith Serviced Apartments Lot 3008, North Penrith, NSW 2750

Artists Impression 23/03/16

St. Hilliers Property Pty Limited Drawing Number DA403 Revision