

Document Set ID: 9188100

Version: 4, Version Date: 29/07/2020



<u>SITE AREA:</u>

LANDSCAPED/DEEP SOIL AREAS: LANDSCAPED AREA AT REAR: LANDSCAPED AREA AT FRONT:

TOTAL LANDSCAPED AREA: REQUIRED AREA:

GROUND FLOOR COMMUNAL: LEVEL 5 COMMUNAL: TOTAL COMMUNAL:

<u>Car Parking:</u> Visitor:

RESIDENT: SERVICE VEHICLE: TOTAL REQUIRED: TOTAL PROVIDED:


BIKE PARKING: MOTORBIKE PARKING: 1894.4sqm

488sqm 185sqm

673sqm (35.5% OF TOTAL SITE AREA) 663sqm (35% OF TOTAL SITE AREA) 380sqm(70sqm INTERNAL)

133sqm 513sqm (27% OF SITE AREA)


10 (INCLUDES 1 WASHBAY) 50 (INCLUDES 4 ACCESSIBLE)

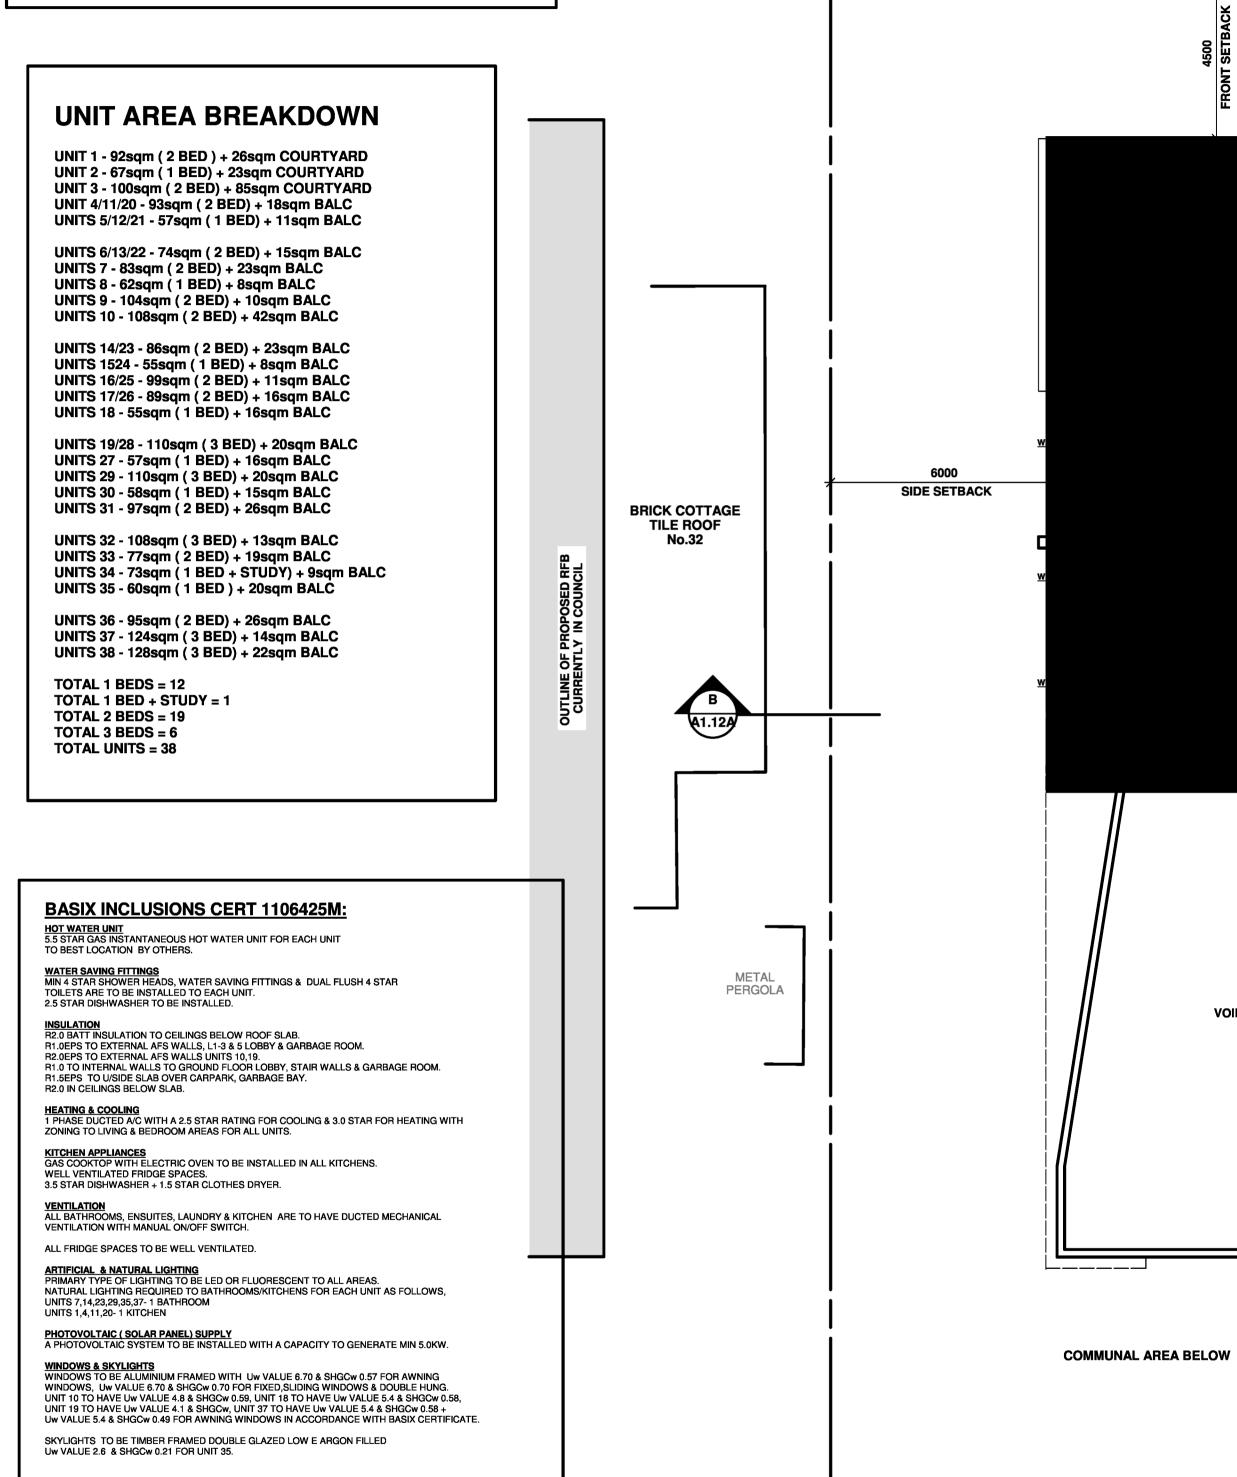

ADG COMPLIANCE TABLE

REQUIRED 6-12m	PROPOSED
6-12m	
V ILIII	6-12m
MIN 3.6m 1BR, 4m 2+ BR	3.7m 1 BR, 4.3m 2+ BR
MIN 9-10sqm MIN 3m CLEAR	MIN 11sqm + 3m
473sqm	GROUND FLOOR 380sqm (310sqm + 70sqm)+ MIN 3n
	5TH FLOOR - 133sqm + MIN 3m
	TOTAL COMMUNAL AREA 513sqm
MIN 85% OF 38 UNITS = 32 UNITS	32 UNITS
1 LARGE TREE OR 2 MEDIUM TREES + 80sqm	2 LARGE TREES + 10+ MEDIUM TREES + 373sqm
133sqm	288sqm + 6m
15sqm + 3m	MIN 23sqm + MIN 3m
8-12sqm MIN 2-2.4m	10sqm + 2m
60% OF 38 UNITS = 22.8 UNITS	25 UNITS
MIN 2700mm	MIN 2700mm
STUDIO 35sqm, 1BR 50sqm,	STUDIO 35sqm, 1BR MIN 50sqm
2BR 70sqm, 3BR 90sqm	2BR MIN 83sqm, 3BR MIN 115sqm
STUDIO 4m3, 1BR 6m3, 2BR 8m3, 3BR 10m3	STUDIO 4m3, 1BR 6m3, 2BR 8m3, 3BR 10m3
	MIN 9-10sqm MIN 3m CLEAR 473sqm MIN 85% OF 38 UNITS = 32 UNITS 1 LARGE TREE OR 2 MEDIUM TREES + 80sqm 133sqm 15sqm + 3m 8-12sqm MIN 2-2.4m 60% OF 38 UNITS = 22.8 UNITS MIN 2700mm STUDIO 35sqm, 1BR 50sqm, 2BR 70sqm, 3BR 90sqm

Doo Version: 4, Version Date: 29/07/2020

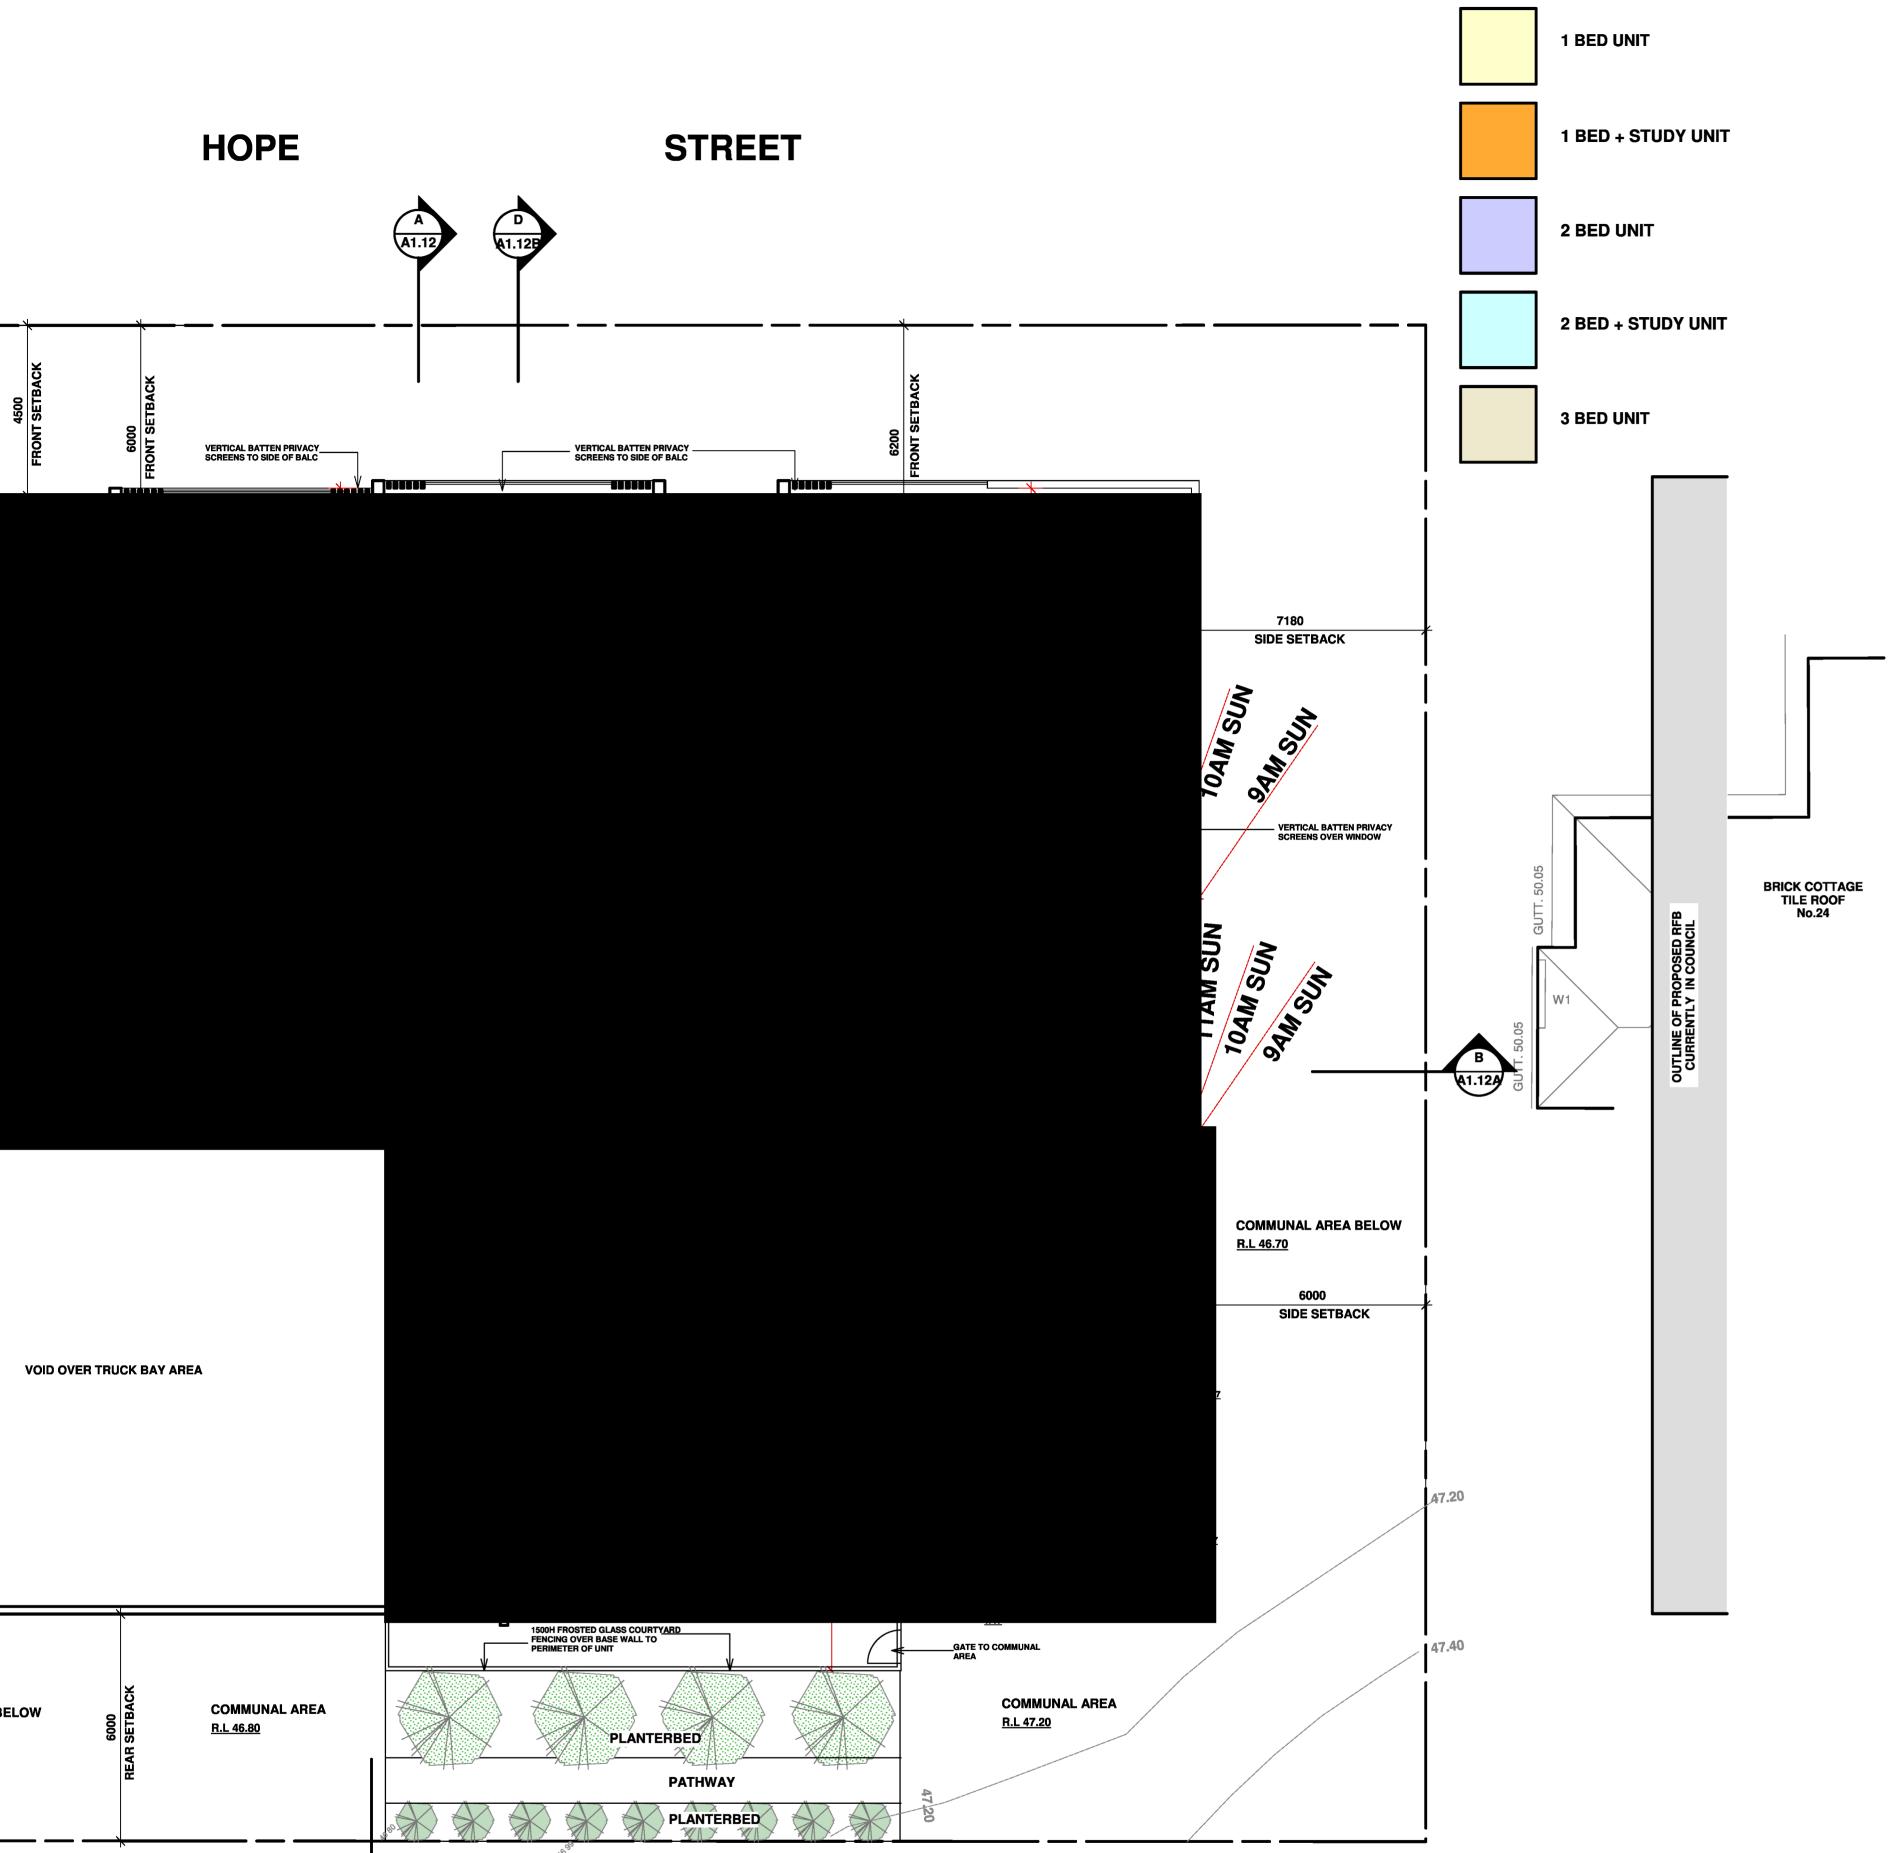

A1.12




Scale: 1:100

NOTE: ALL EXHAUST FANS ARE TO BE SEALED

SIGN & TECHNOLOGY Pty Ltd	PROJECT :	PROPOSED UNIT DEV AT 26-30 HOPE ST PE	/ELOPMENT LOCATED		T.N M.M
grove St Wentworthville 2145,	TITLE:	PROPOSED PLAN LEV	/EL 1		
is Langley NSW 2147 Mob: 0412 109 759	SCALE :	A1 @ 1:100	DRAWN : MM		
ild-design.com.au	PROJECT DA	TE: FEB 2020	CHECKED: ZH	REV: A	
IECT ZACHARY HAU 9914	PROJECT No	. 201727A	DWG No. DA1.04	4	



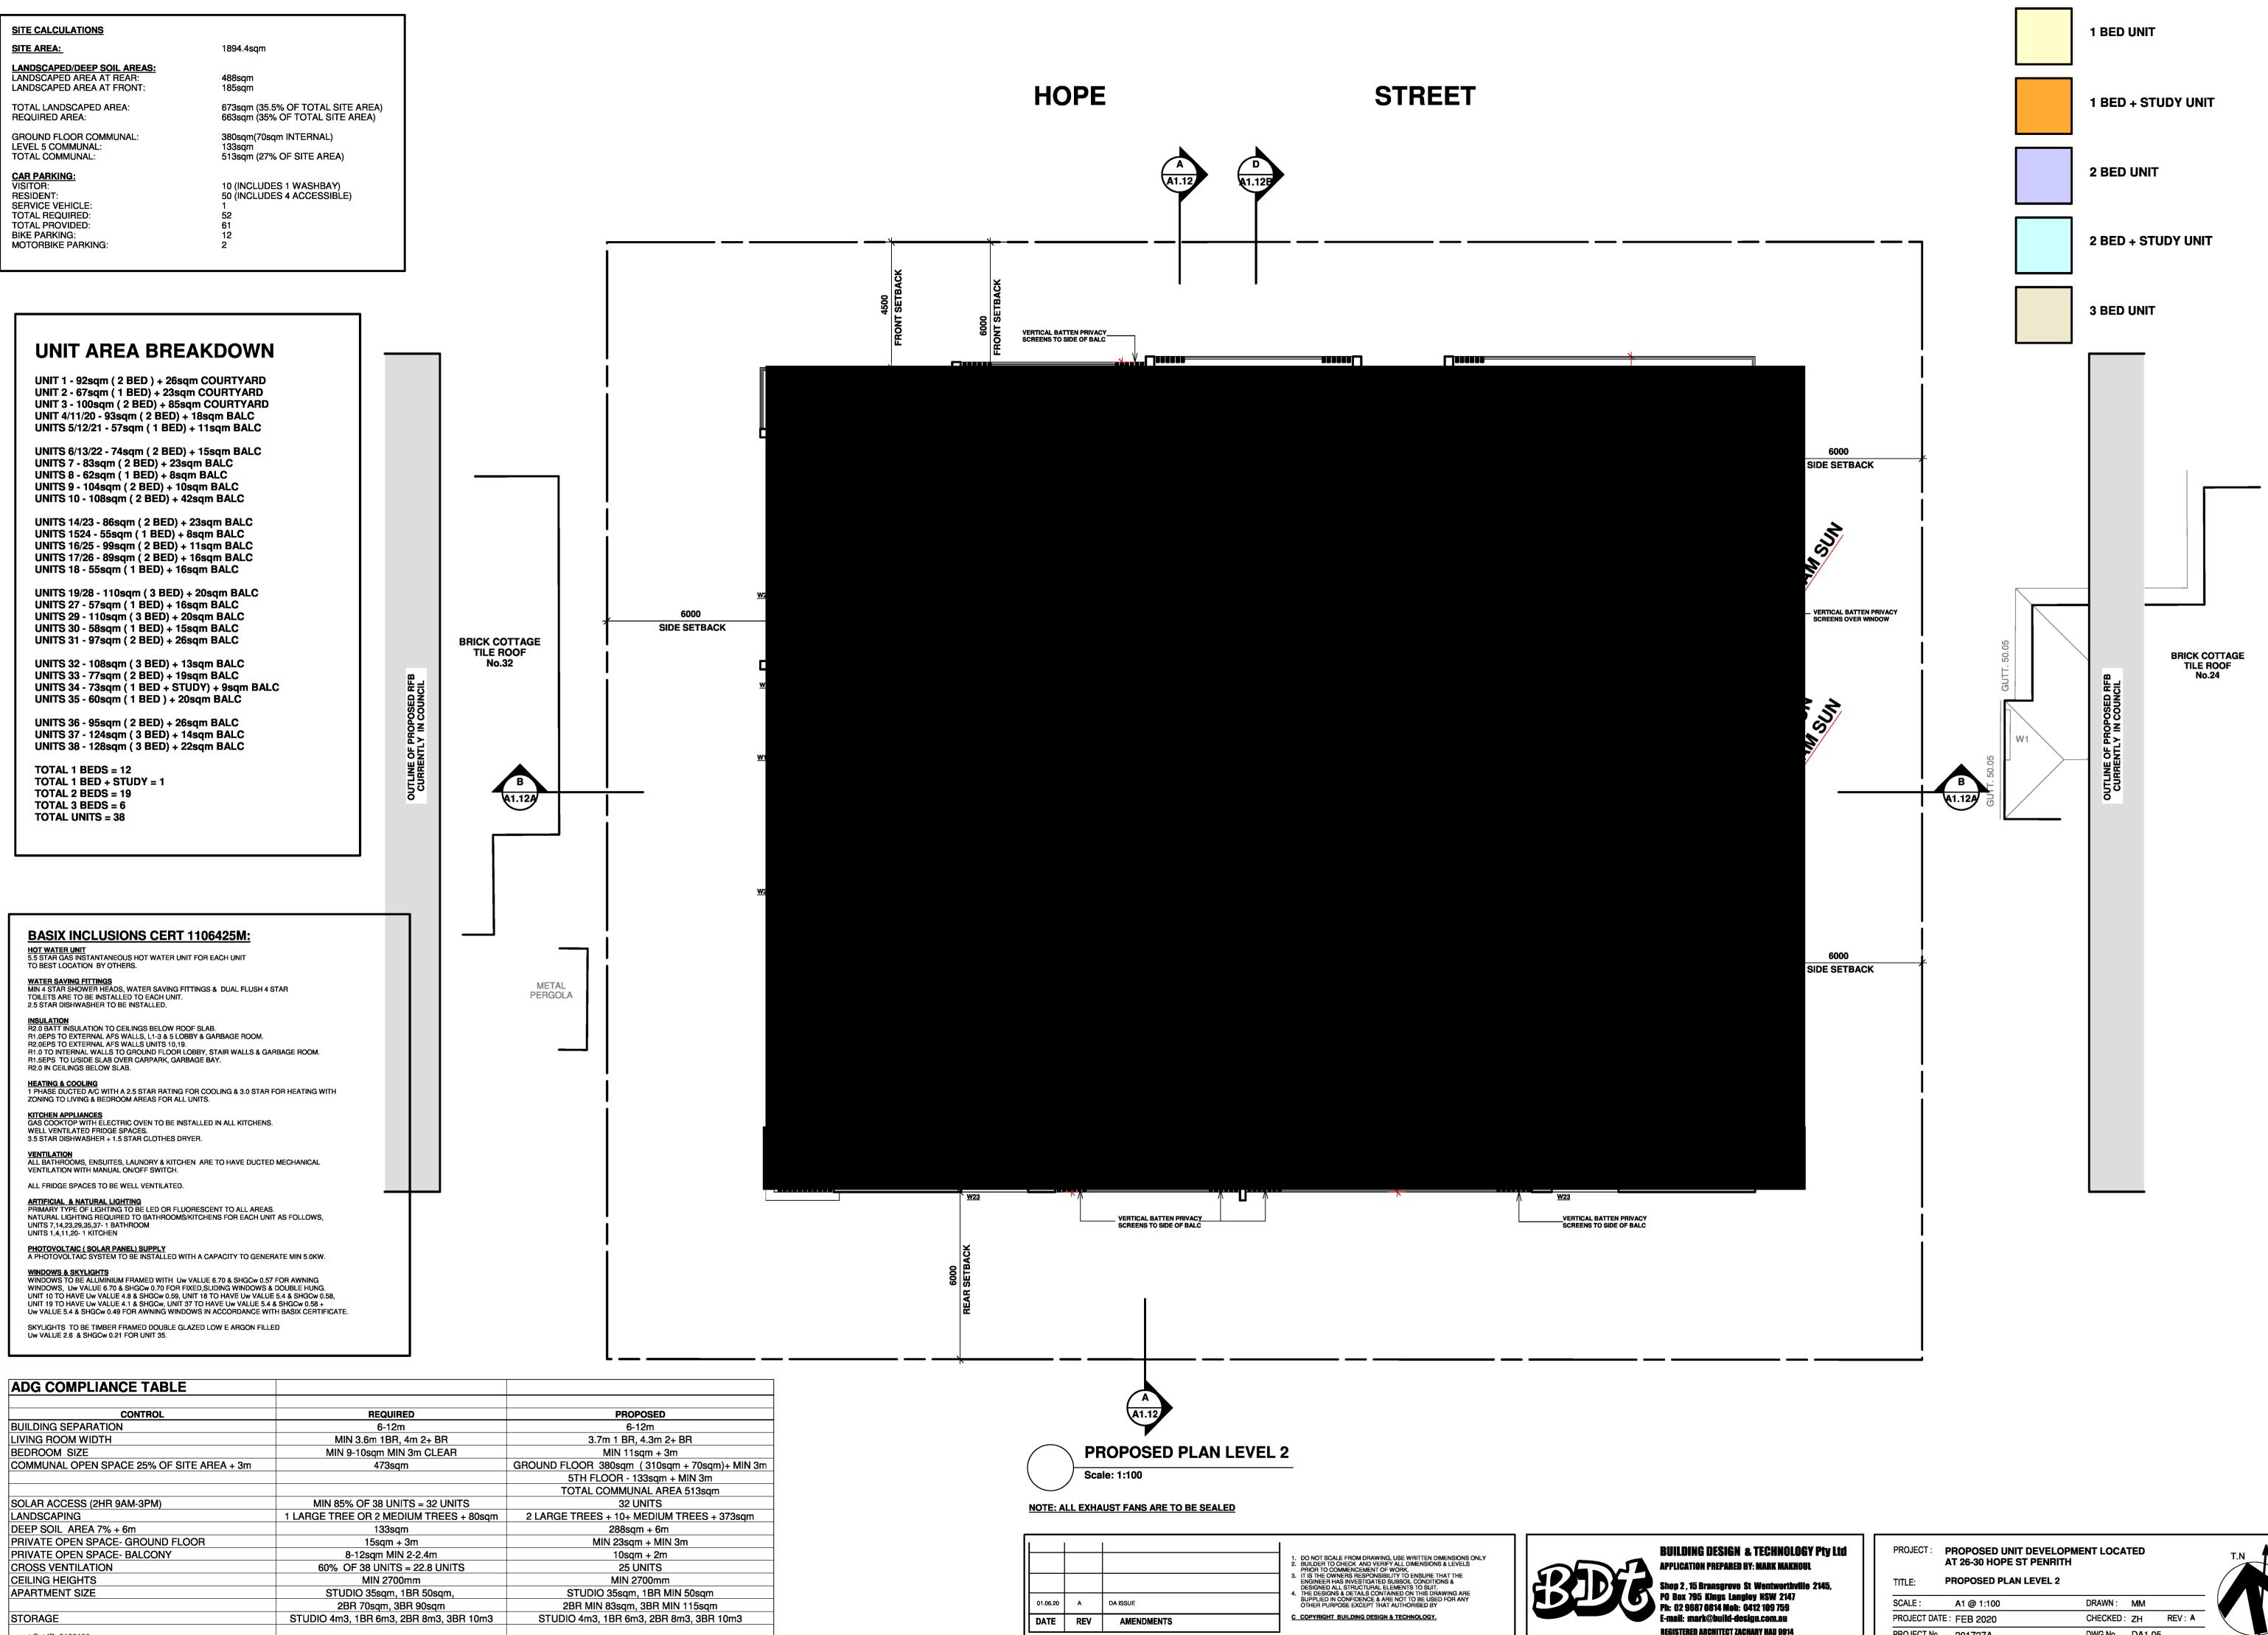

CONTROL	REQUIRED	PROPOSED
BUILDING SEPARATION	6-12m	6-12m
LIVING ROOM WIDTH	MIN 3.6m 1BR, 4m 2+ BR	3.7m 1 BR, 4.3m 2+ BR
BEDROOM SIZE	MIN 9-10sqm MIN 3m CLEAR	MIN 11sqm + 3m
COMMUNAL OPEN SPACE 25% OF SITE AREA + 3m	473sqm	GROUND FLOOR 380sqm (310sqm + 70sqm)+ MIN 3m
		5TH FLOOR - 133sqm + MIN 3m
		TOTAL COMMUNAL AREA 513sqm
SOLAR ACCESS (2HR 9AM-3PM)	MIN 85% OF 38 UNITS = 32 UNITS	32 UNITS
LANDSCAPING	1 LARGE TREE OR 2 MEDIUM TREES + 80sqm	2 LARGE TREES + 10+ MEDIUM TREES + 373sqm
DEEP SOIL AREA 7% + 6m	133sqm	288sqm + 6m
PRIVATE OPEN SPACE- GROUND FLOOR	15sqm + 3m	MIN 23sqm + MIN 3m
PRIVATE OPEN SPACE- BALCONY	8-12sqm MIN 2-2.4m	10sqm + 2m
CROSS VENTILATION	60% OF 38 UNITS = 22.8 UNITS	25 UNITS
CEILING HEIGHTS	MIN 2700mm	MIN 2700mm
APARTMENT SIZE	STUDIO 35sqm, 1BR 50sqm,	STUDIO 35sqm, 1BR MIN 50sqm
	2BR 70sqm, 3BR 90sqm	2BR MIN 83sqm, 3BR MIN 115sqm
STORAGE	STUDIO 4m3, 1BR 6m3, 2BR 8m3, 3BR 10m3	STUDIO 4m3, 1BR 6m3, 2BR 8m3, 3BR 10m3
ument Set ID: 9188100		

Doo Version: 4, Version Date: 29/07/2020

CHNOLOGY Pty Ltd Ark Makhoul	PROJECT :	PROPOSED UNIT DEVELO AT 26-30 HOPE ST PENRIT		TED		T.N M.M
entworthville 2145,	TITLE:	PROPOSED PLAN LEVEL 2				
SW 2147 109 759	SCALE :	A1 @ 1:100	DRAWN :	MM		
om.au	PROJECT DA	TE: FEB 2020	CHECKED :	ZH	REV: A	
HAU 9914	PROJECT No	. 201727A	DWG No.	DA1.0	5	



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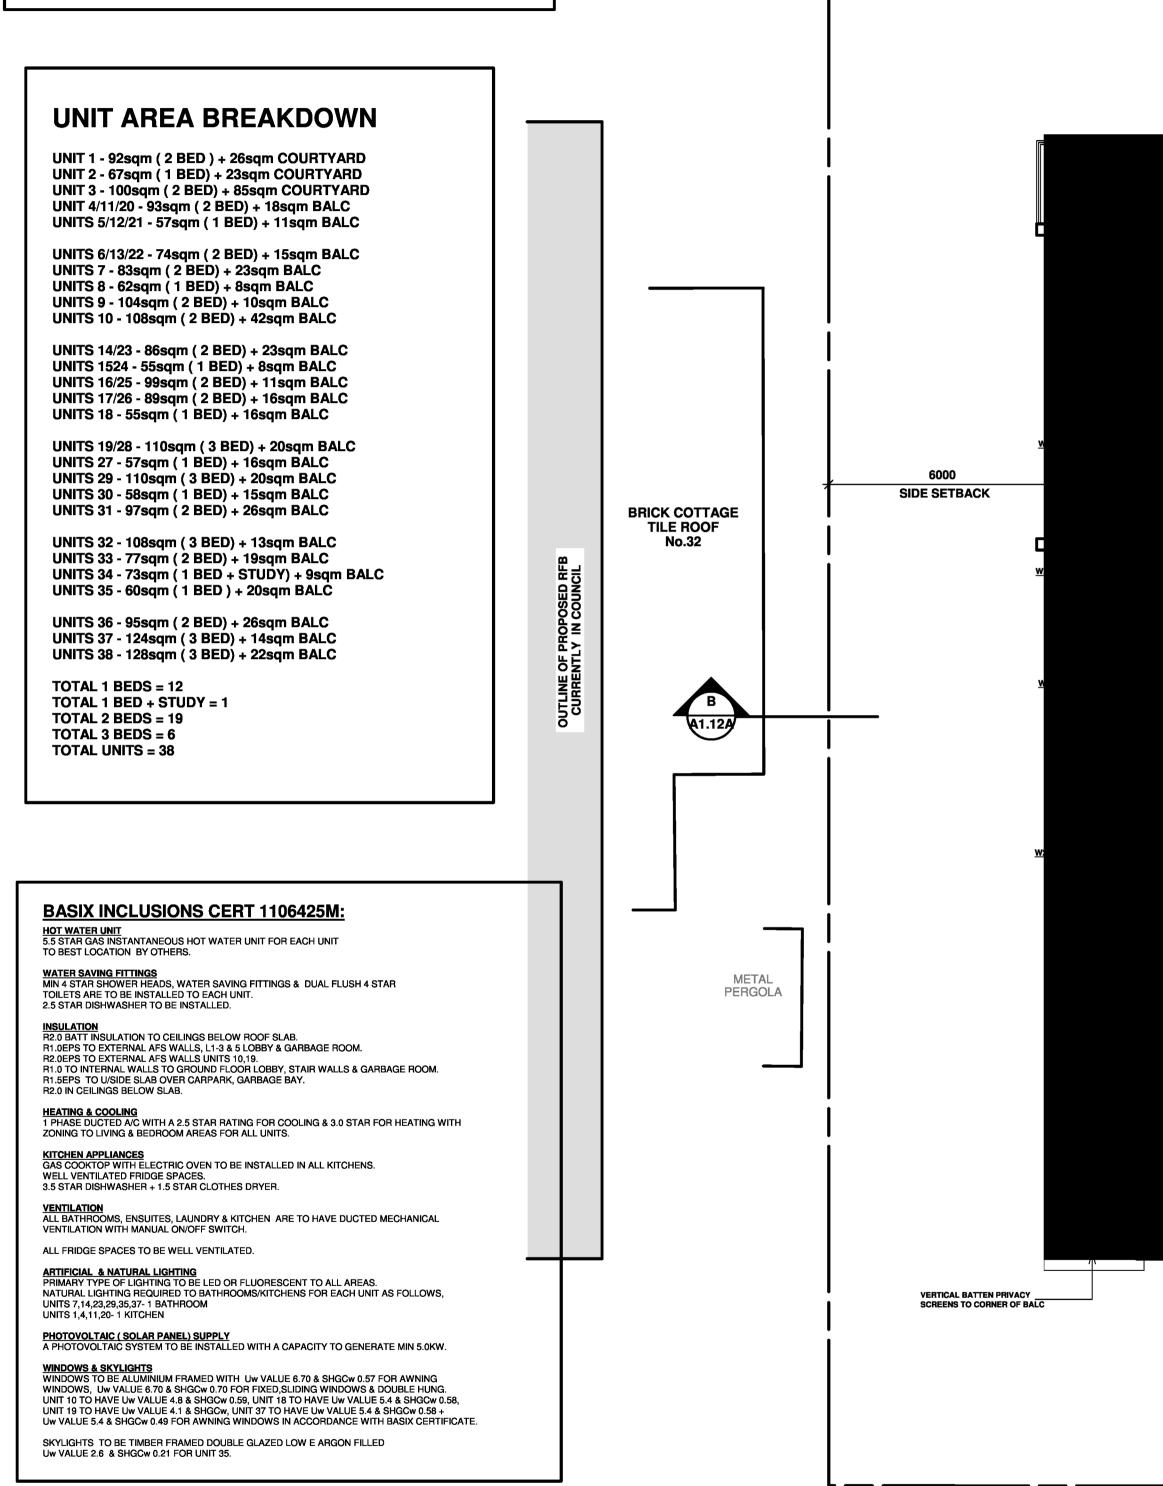
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61

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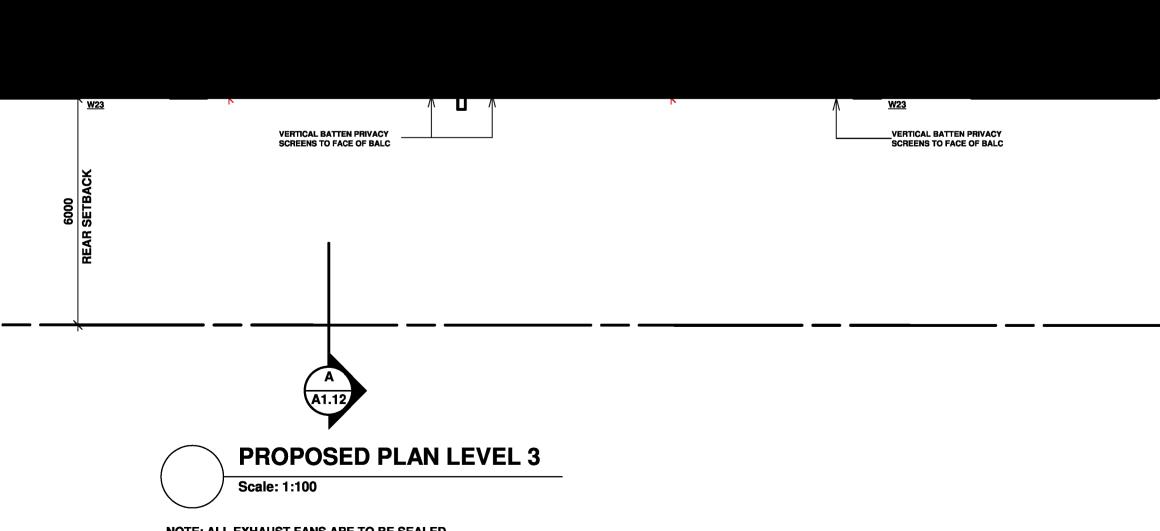
ADG COMPLIANCE TABLE


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ument Set ID: 9188100		


Doo Version: 4, Version Date: 29/07/2020

01.06.20 DATE	A	DA ISSUE AMENDMENTS	1. DO NOT SCALE FROM DRAWING, USE WRITTEN DIMENSIONS ONLY 2. BUILDER TO CHECK AND VERIFY ALL DIMENSIONS & LEVELS PRIOR TO COMMENCEMENT OF WORK. 3. IT IS THE OWNERS RESPONSIBILITY TO ENSURE THAT THE ENGINEER HAS INVESTIGATED SUBSOIL CONDITIONS & DESIGNED ALL STRUCTURAL ELEMENTS TO SUIT. 4. THE DESIGNS & DETAILS CONTAINED ON THIS DRAWING ARE SUPPLIED IN CONFIDENCE & ARE NOT TO BE USED FOR ANY OTHER PURPOSE EXCEPT THAT AUTHORISED BY C COPYRIGHT BUILDING DESIGN & TECHNOLOGY.		BDB	BUILDING DESIG APPLICATION PREPAR Shop 2 , 15 Bransgro PO Box 795 Kings L Ph: 02 9687 0814 Mc E-mail: mark@build REGISTERED ARCHITECT
]		


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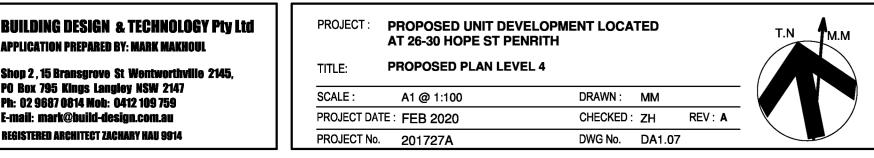



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Version: 4, Version Date: 29/07/2020

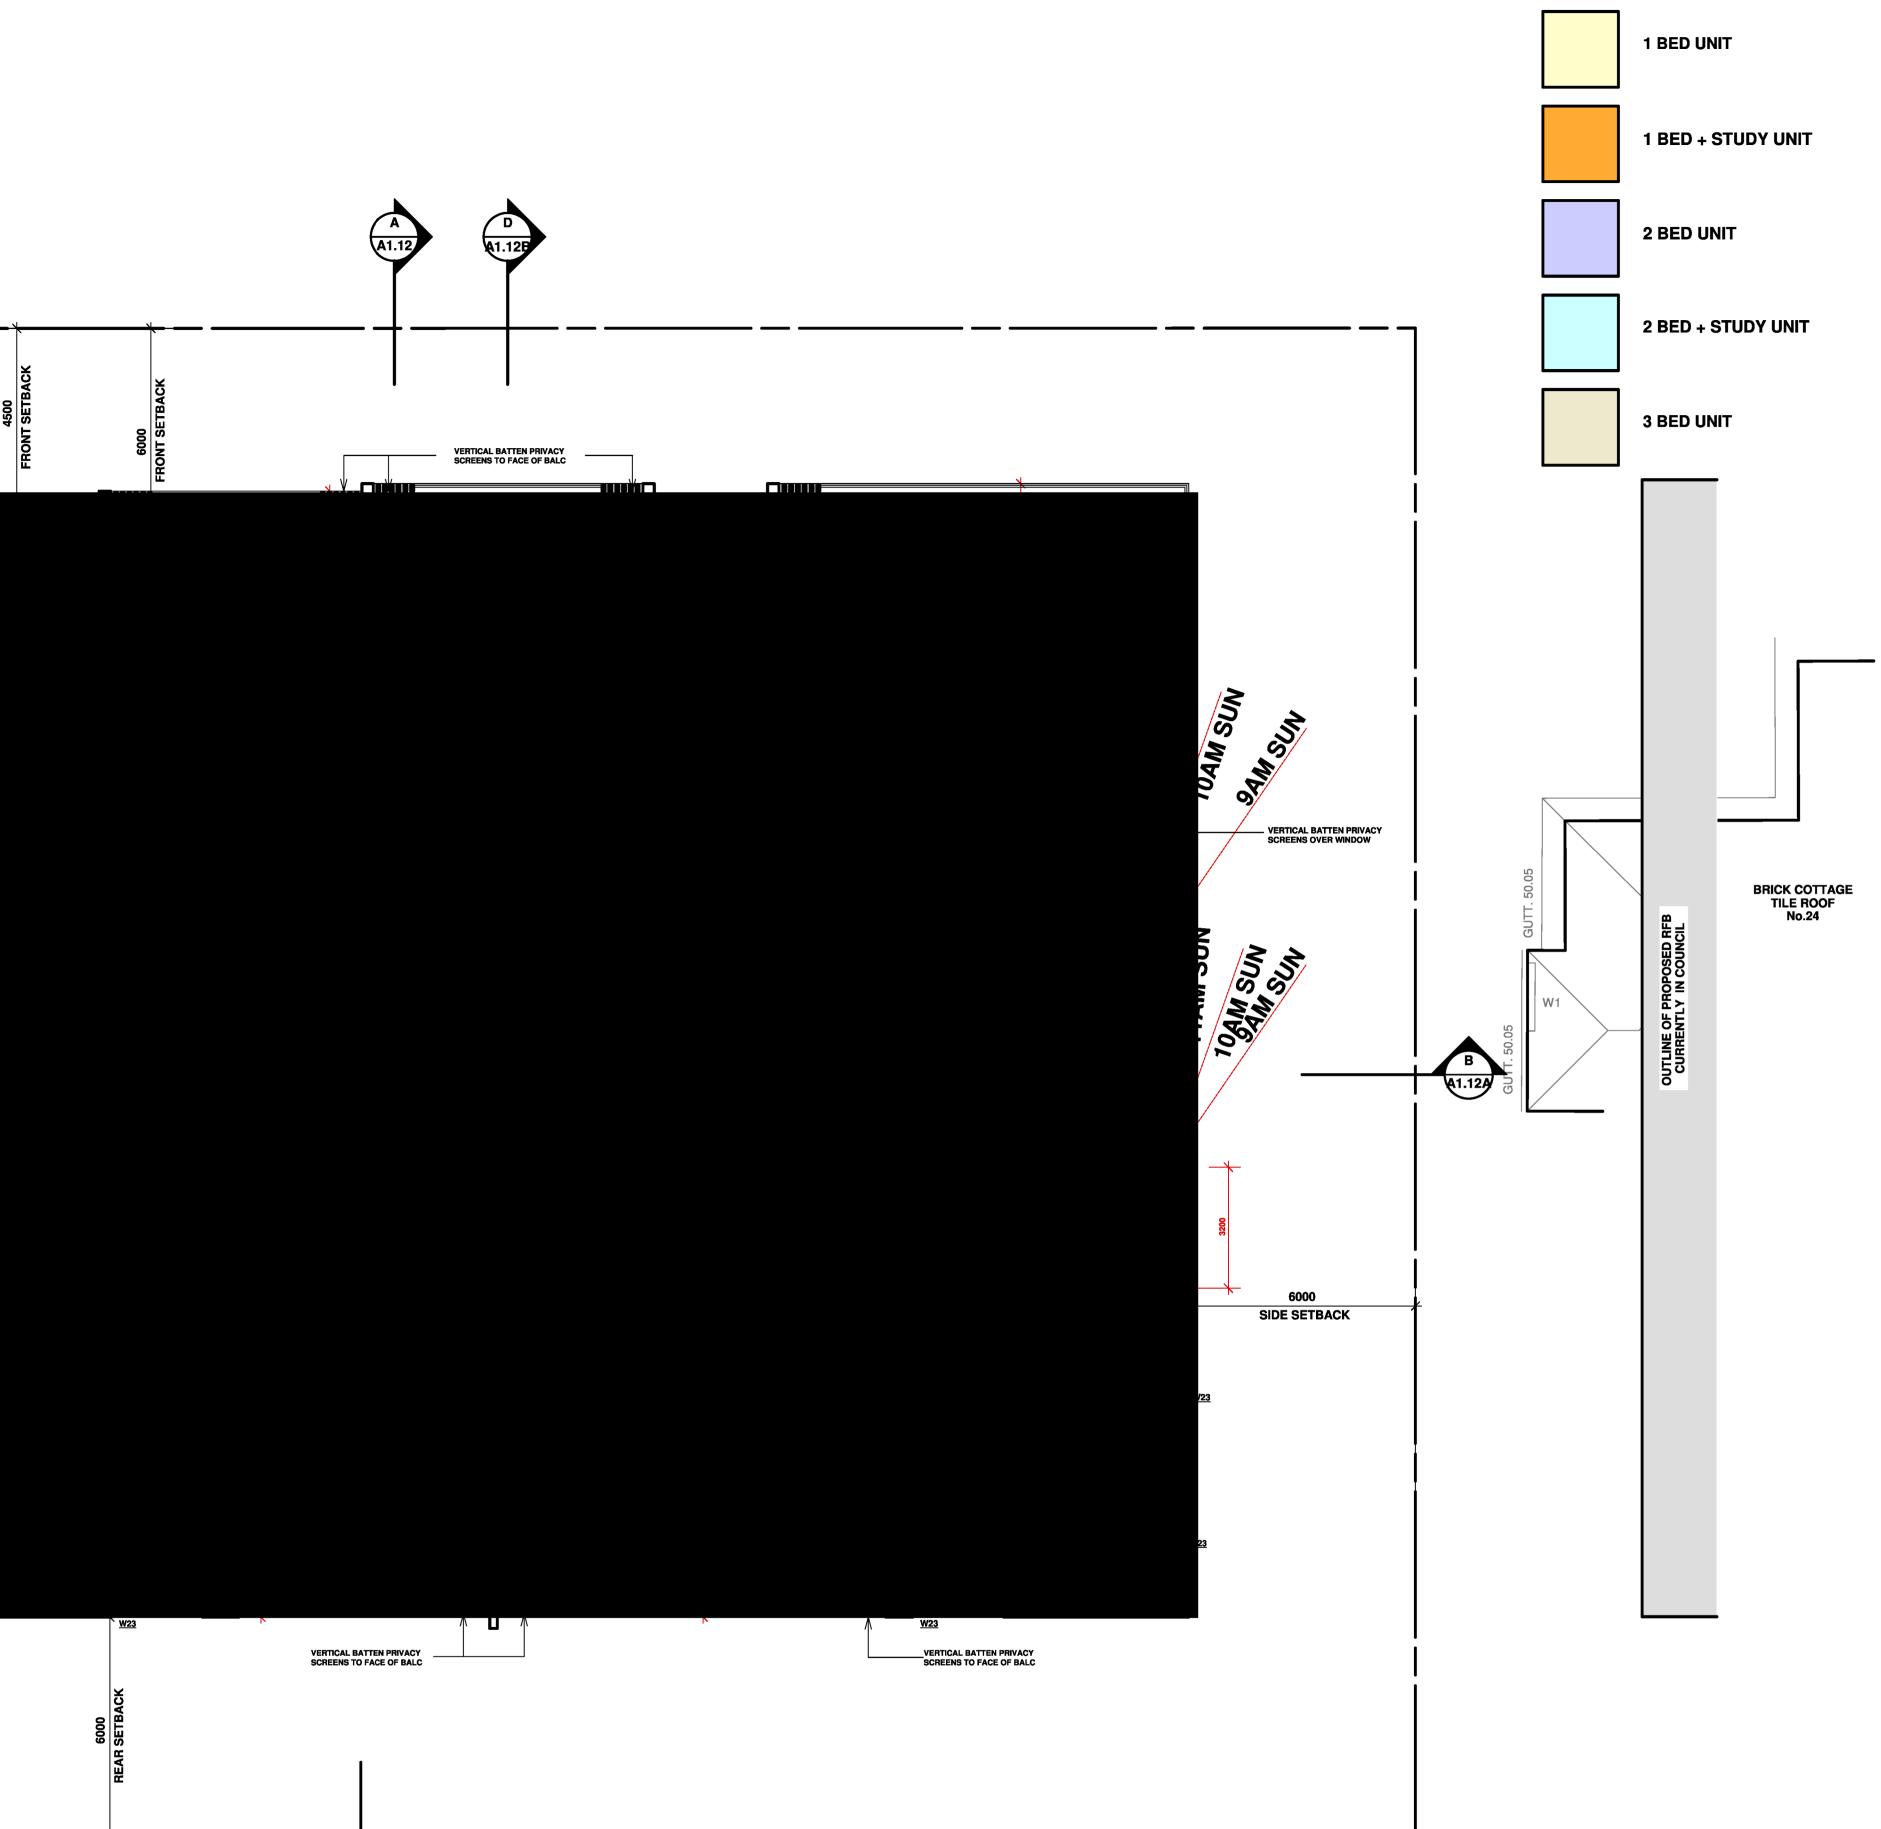ATE	REV	AMENDMENTS	C COPYRIGHT BUILDING DESIGN & TECHNOLOGY.
1.06.20	A	DA ISSUE	4. THE DESIGNS & DETAILS CONTAINED ON THIS DRAWING ARE SUPPLIED IN CONFIDENCE & ARE NOT TO BE USED FOR ANY OTHER PURPOSE EXCEPT THAT AUTHORISED BY
			 IT IS THE OWNERS RESPONSIBILITY TO ENSURE THAT THE ENGINEER HAS INVESTIGATED SUBSOIL CONDITIONS & DESIGNED ALL STRUCTURAL ELEMENTS TO SUIT. THE DESIGNS & DETAILS CONTAINED ON THIS DRAWING ARE
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Shop 2 , 15 Bransgrove St Wentworthville 2145, PO Box 795 Kings Langley NSW 2147 Ph: 02 9687 0814 Mob: 0412 109 759 E-mail: mark@build-design.com.au **REGISTERED ARCHITECT ZACHARY HAU 9914**

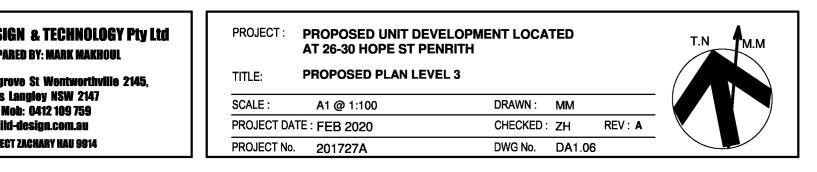

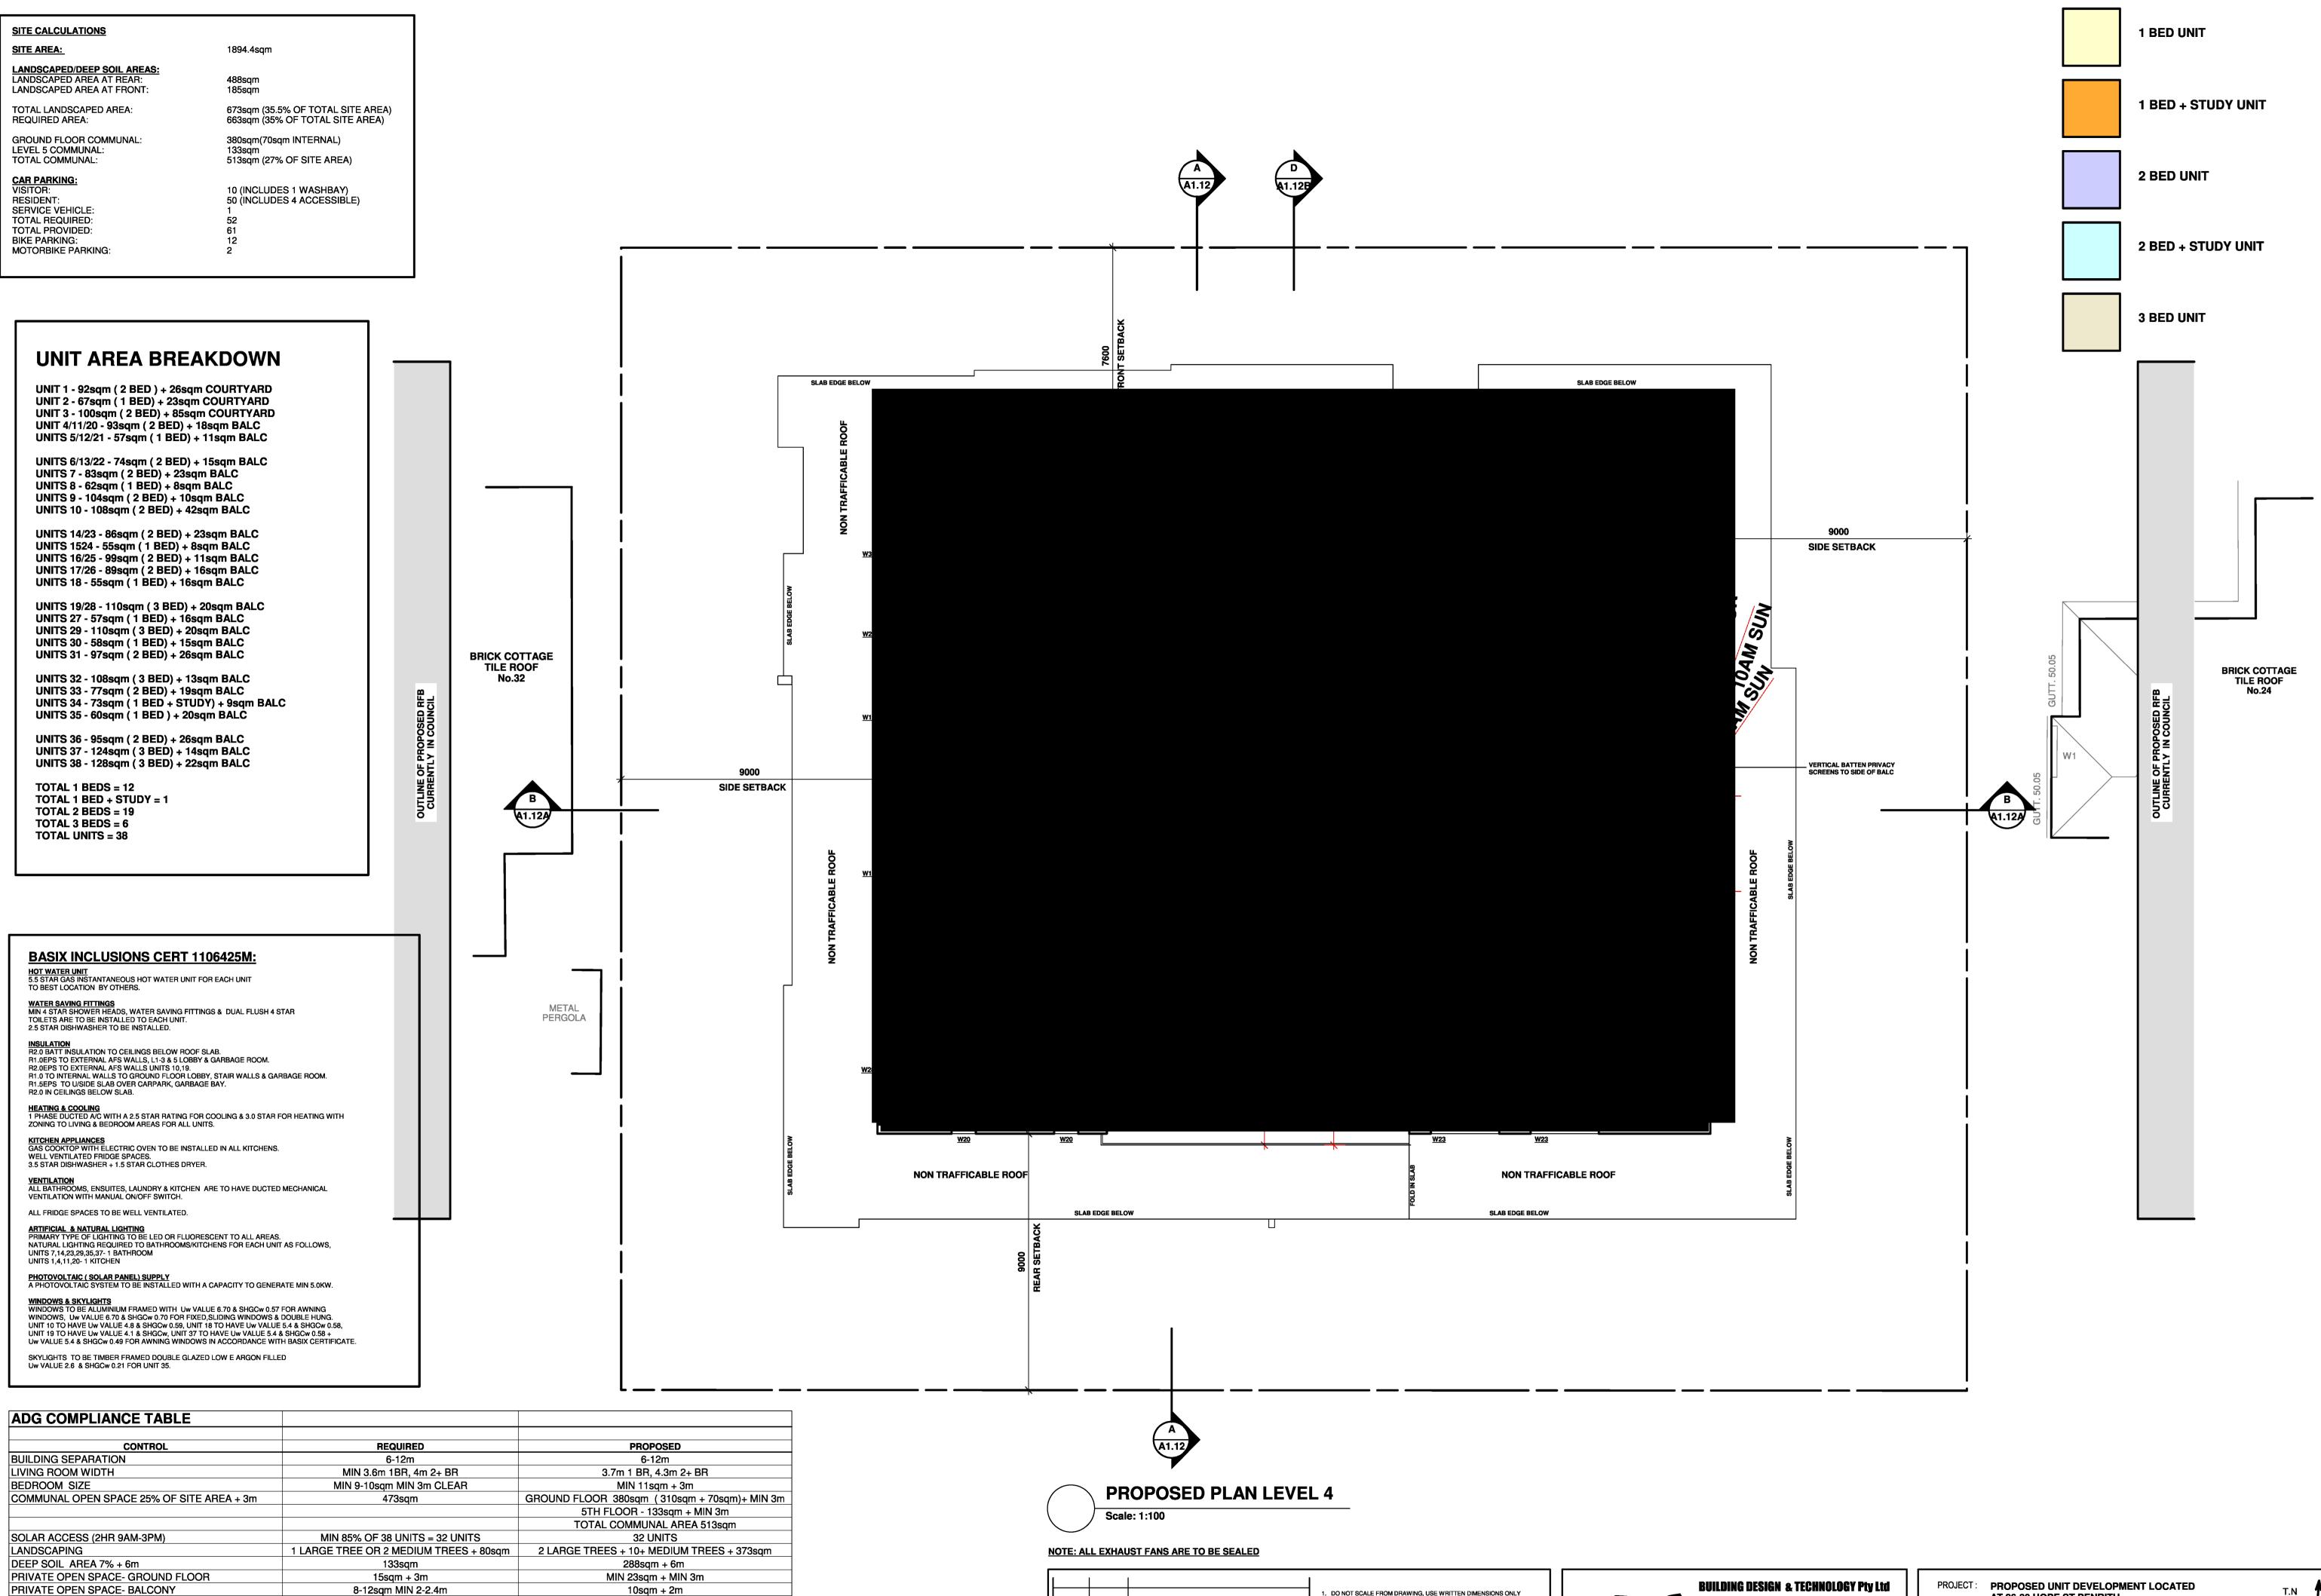

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nument Set ID: 0199100		
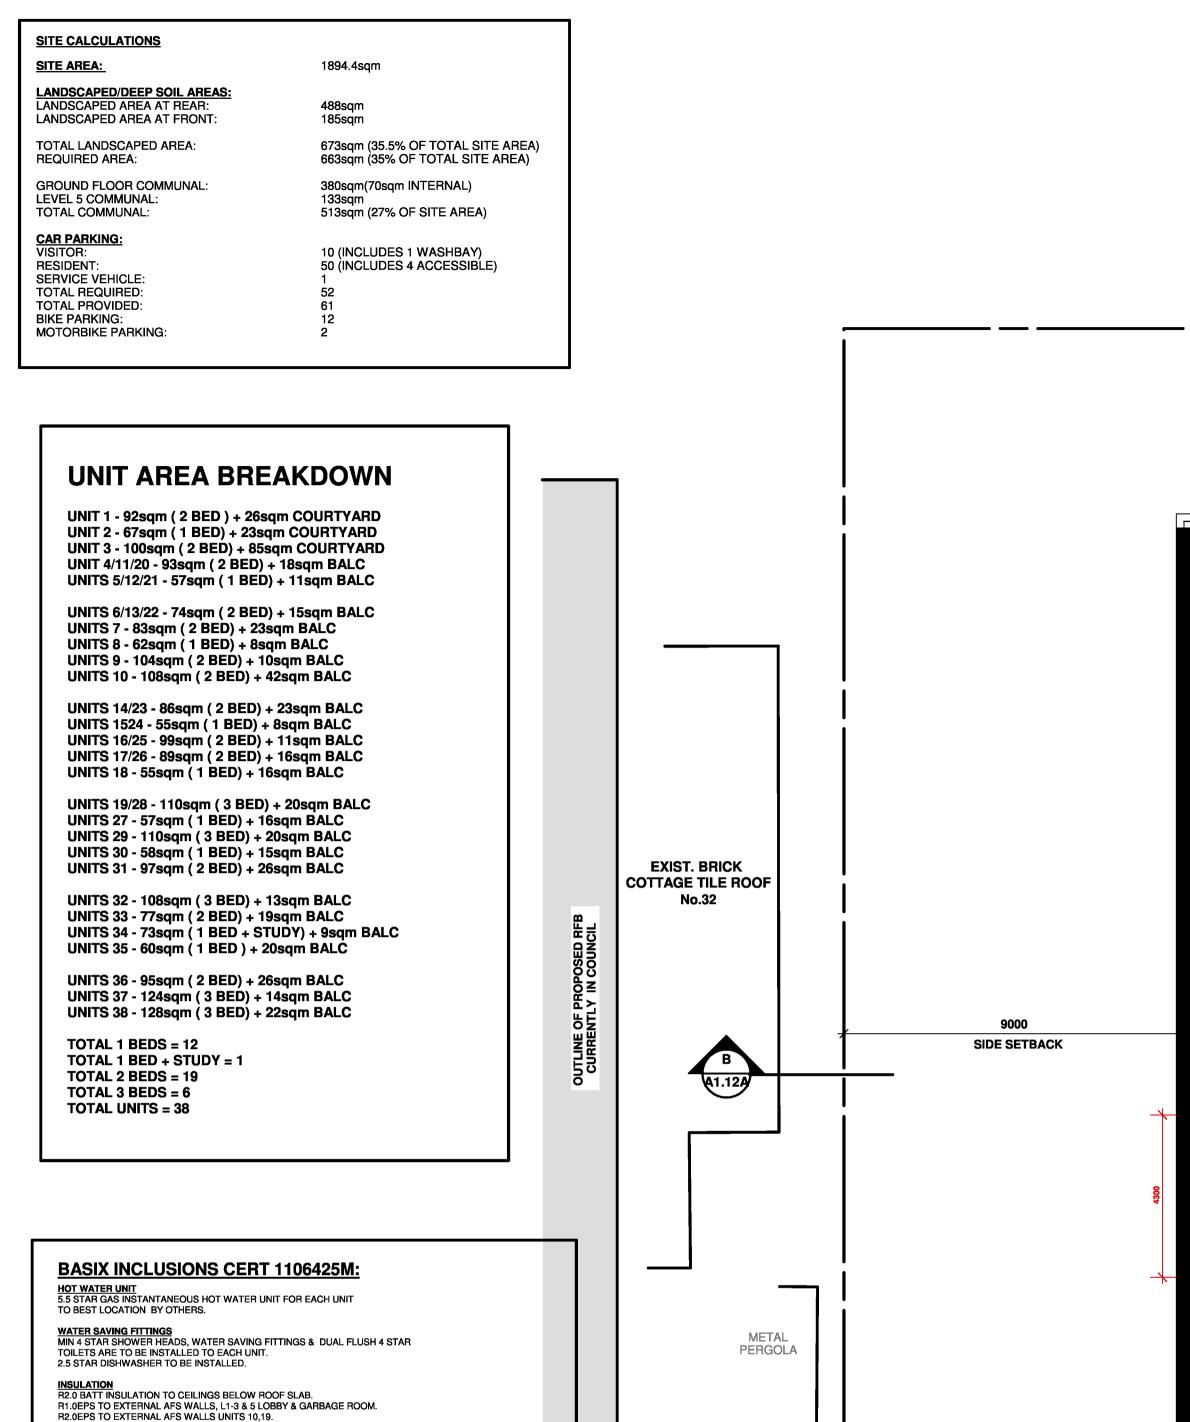
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R1.0 TO INTERNAL WALLS TO GROUND FLOOR LOBBY, STAIR WALLS & GARBAGE ROOM. R1.5EPS TO U/SIDE SLAB OVER CARPARK, GARBAGE BAY.

VENTILATION ALL BATHROOMS, ENSUITES, LAUNDRY & KITCHEN ARE TO HAVE DUCTED MECHANICAL

NATURAL LIGHTING REQUIRED TO BATHROOMS/KITCHENS FOR EACH UNIT AS FOLLOWS,

PHOTOVOLTAIC (SOLAR PANEL) SUPPLY A PHOTOVOLTAIC SYSTEM TO BE INSTALLED WITH A CAPACITY TO GENERATE MIN 5.0KW.

WINDOWS & SKYLIGHTS WINDOWS TO BE ALUMINIUM FRAMED WITH UW VALUE 6.70 & SHGCW 0.57 FOR AWNING WINDOWS, UW VALUE 6.70 & SHGCW 0.70 FOR FIXED, SLIDING WINDOWS & DOUBLE HUNG. UNIT 10 TO HAVE UW VALUE 4.8 & SHGCW 0.59, UNIT 18 TO HAVE UW VALUE 5.4 & SHGCW 0.58, UNIT 19 TO HAVE UW VALUE 4.1 & SHGCW, UNIT 37 TO HAVE UW VALUE 5.4 & SHGCW 0.58 + UW VALUE 5.4 & SHGCW 0.49 FOR AWNING WINDOWS IN ACCORDANCE WITH BASIX CERTIFICATE.

KITCHEN APPLIANCES GAS COOKTOP WITH ELECTRIC OVEN TO BE INSTALLED IN ALL KITCHENS.

ARTIFICIAL & NATURAL LIGHTING PRIMARY TYPE OF LIGHTING TO BE LED OR FLUORESCENT TO ALL AREAS.

SKYLIGHTS TO BE TIMBER FRAMED DOUBLE GLAZED LOW E ARGON FILLED

HEATING & COOLING 1 PHASE DUCTED A/C WITH A 2.5 STAR RATING FOR COOLING & 3.0 STAR FOR HEATING WITH

R2.0 IN CEILINGS BELOW SLAB.


ZONING TO LIVING & BEDROOM AREAS FOR ALL UNITS.


WELL VENTILATED FRIDGE SPACES. 3.5 STAR DISHWASHER + 1.5 STAR CLOTHES DRYER.

VENTILATION WITH MANUAL ON/OFF SWITCH. ALL FRIDGE SPACES TO BE WELL VENTILATED.


UNITS 7,14,23,29,35,37- 1 BATHROOM UNITS 1,4,11,20- 1 KITCHEN

Uw VALUE 2.6 & SHGCw 0.21 FOR UNIT 35.

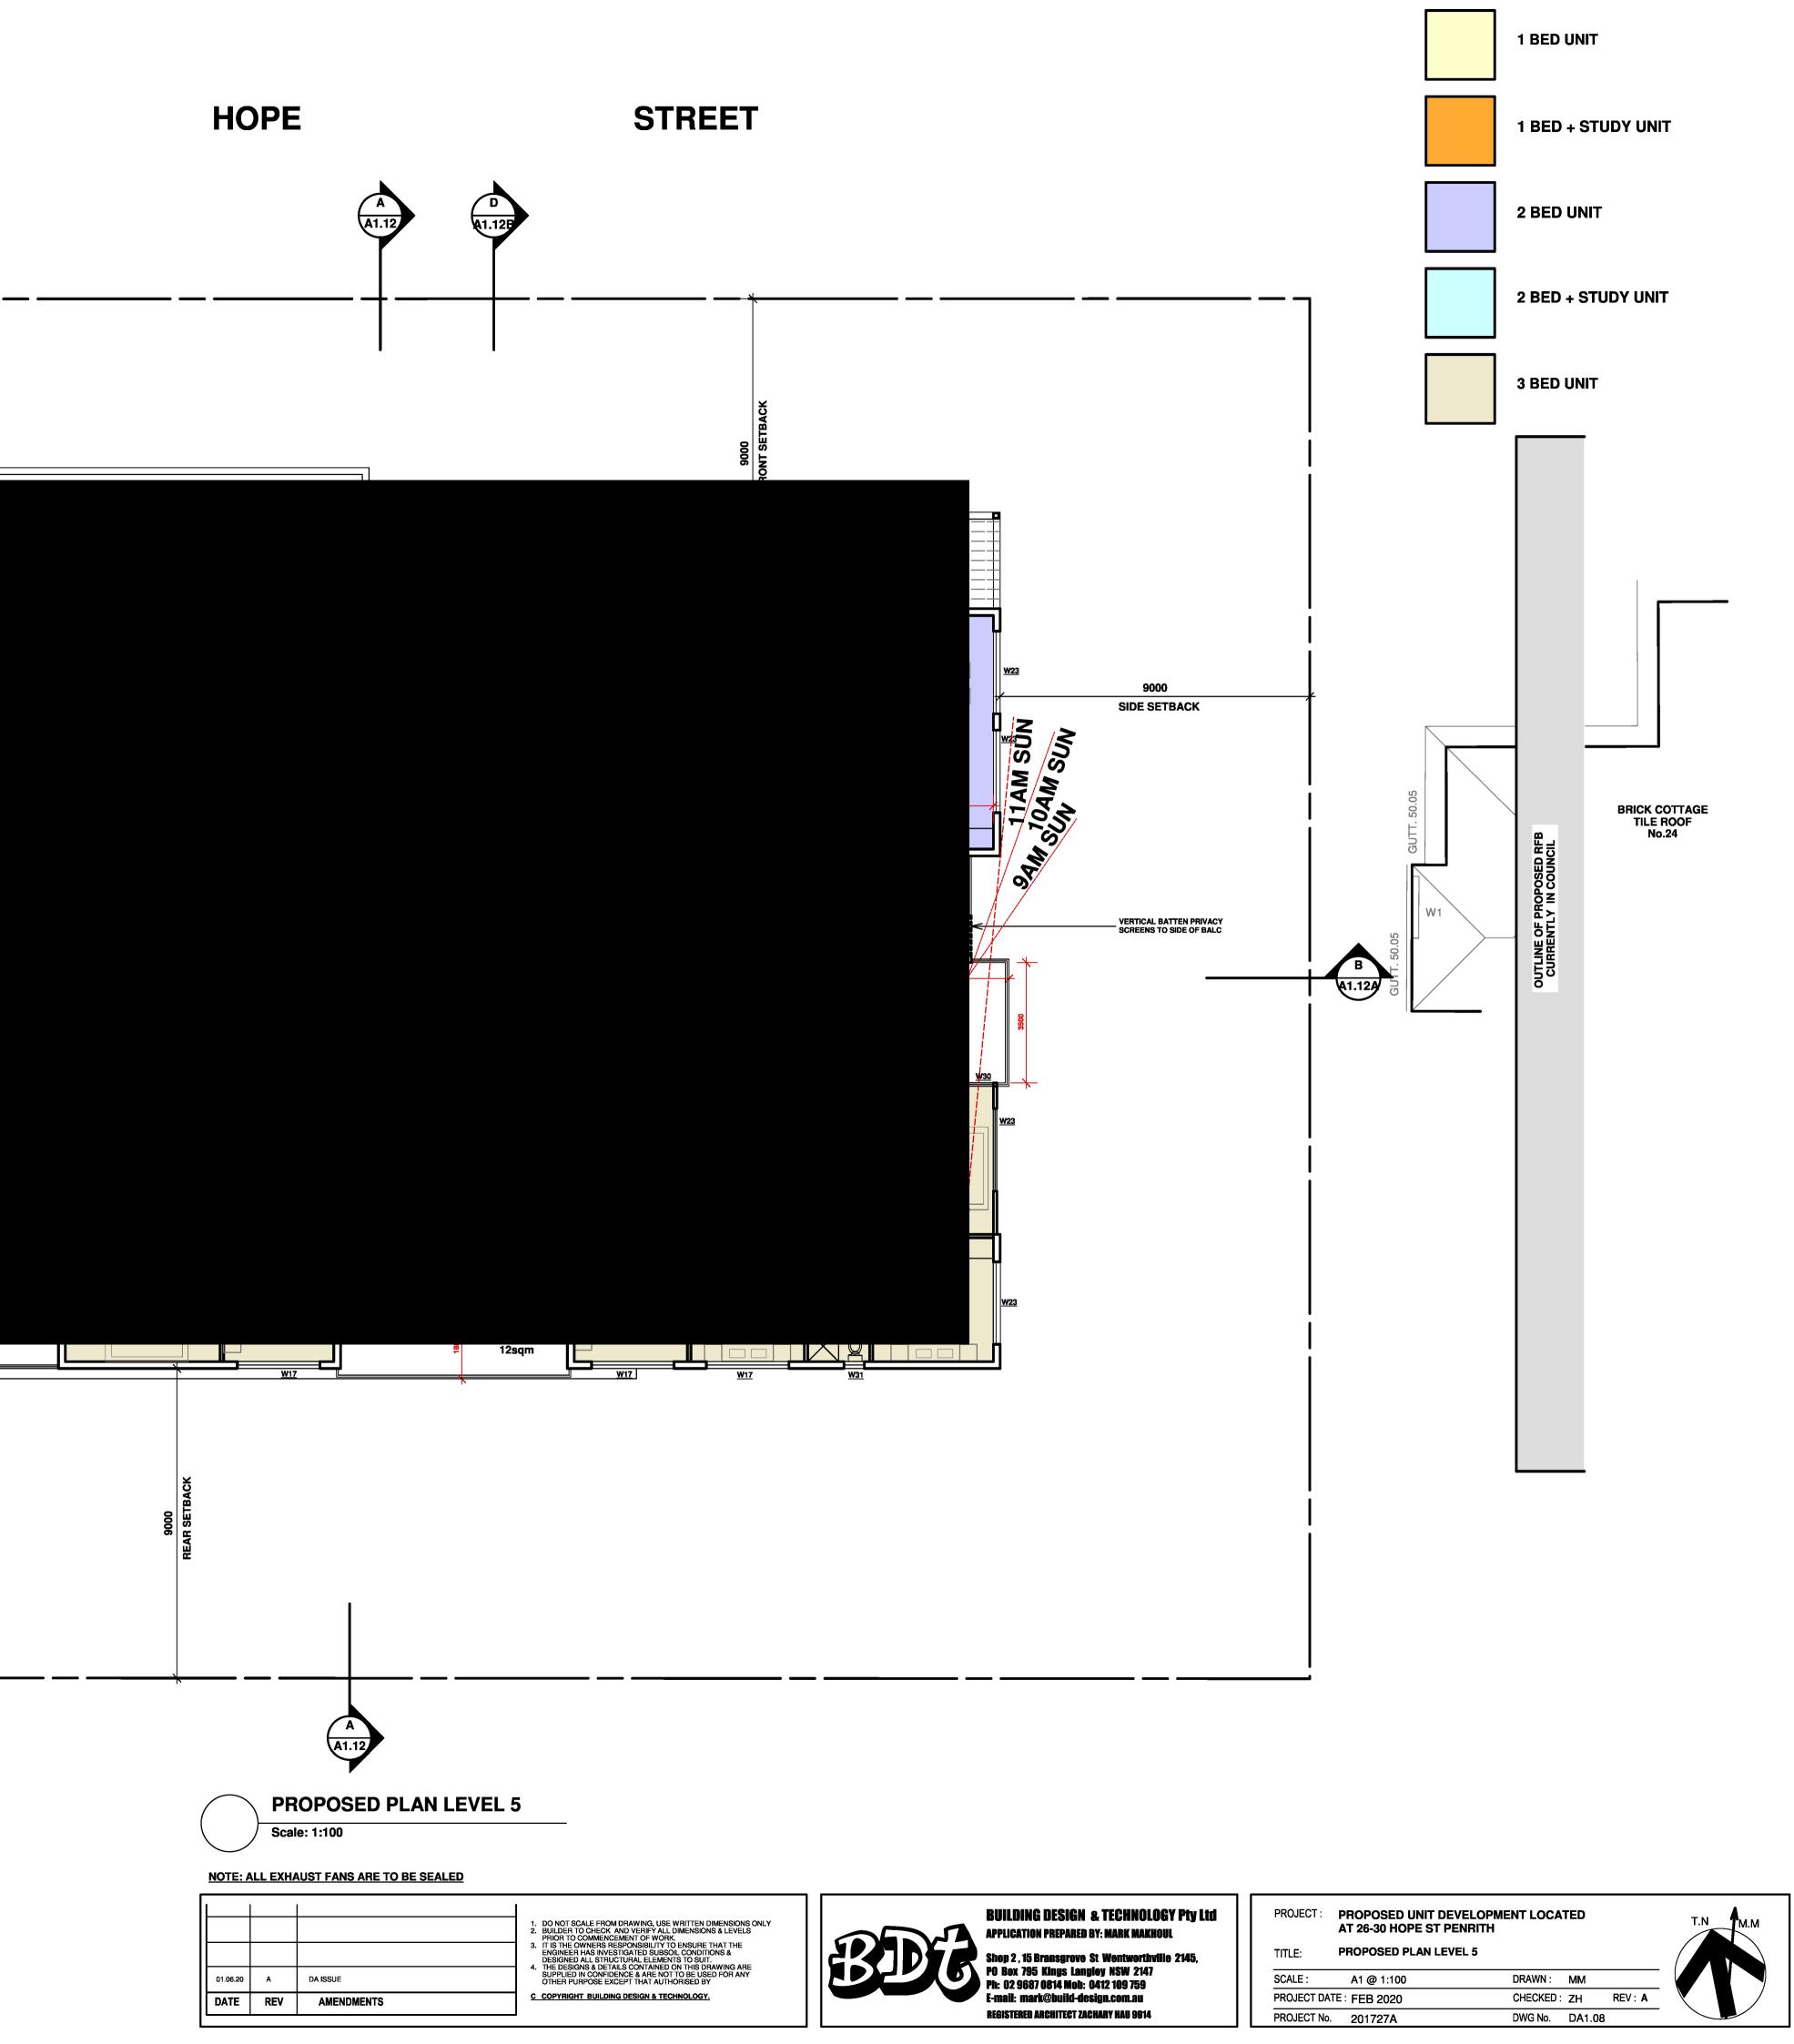

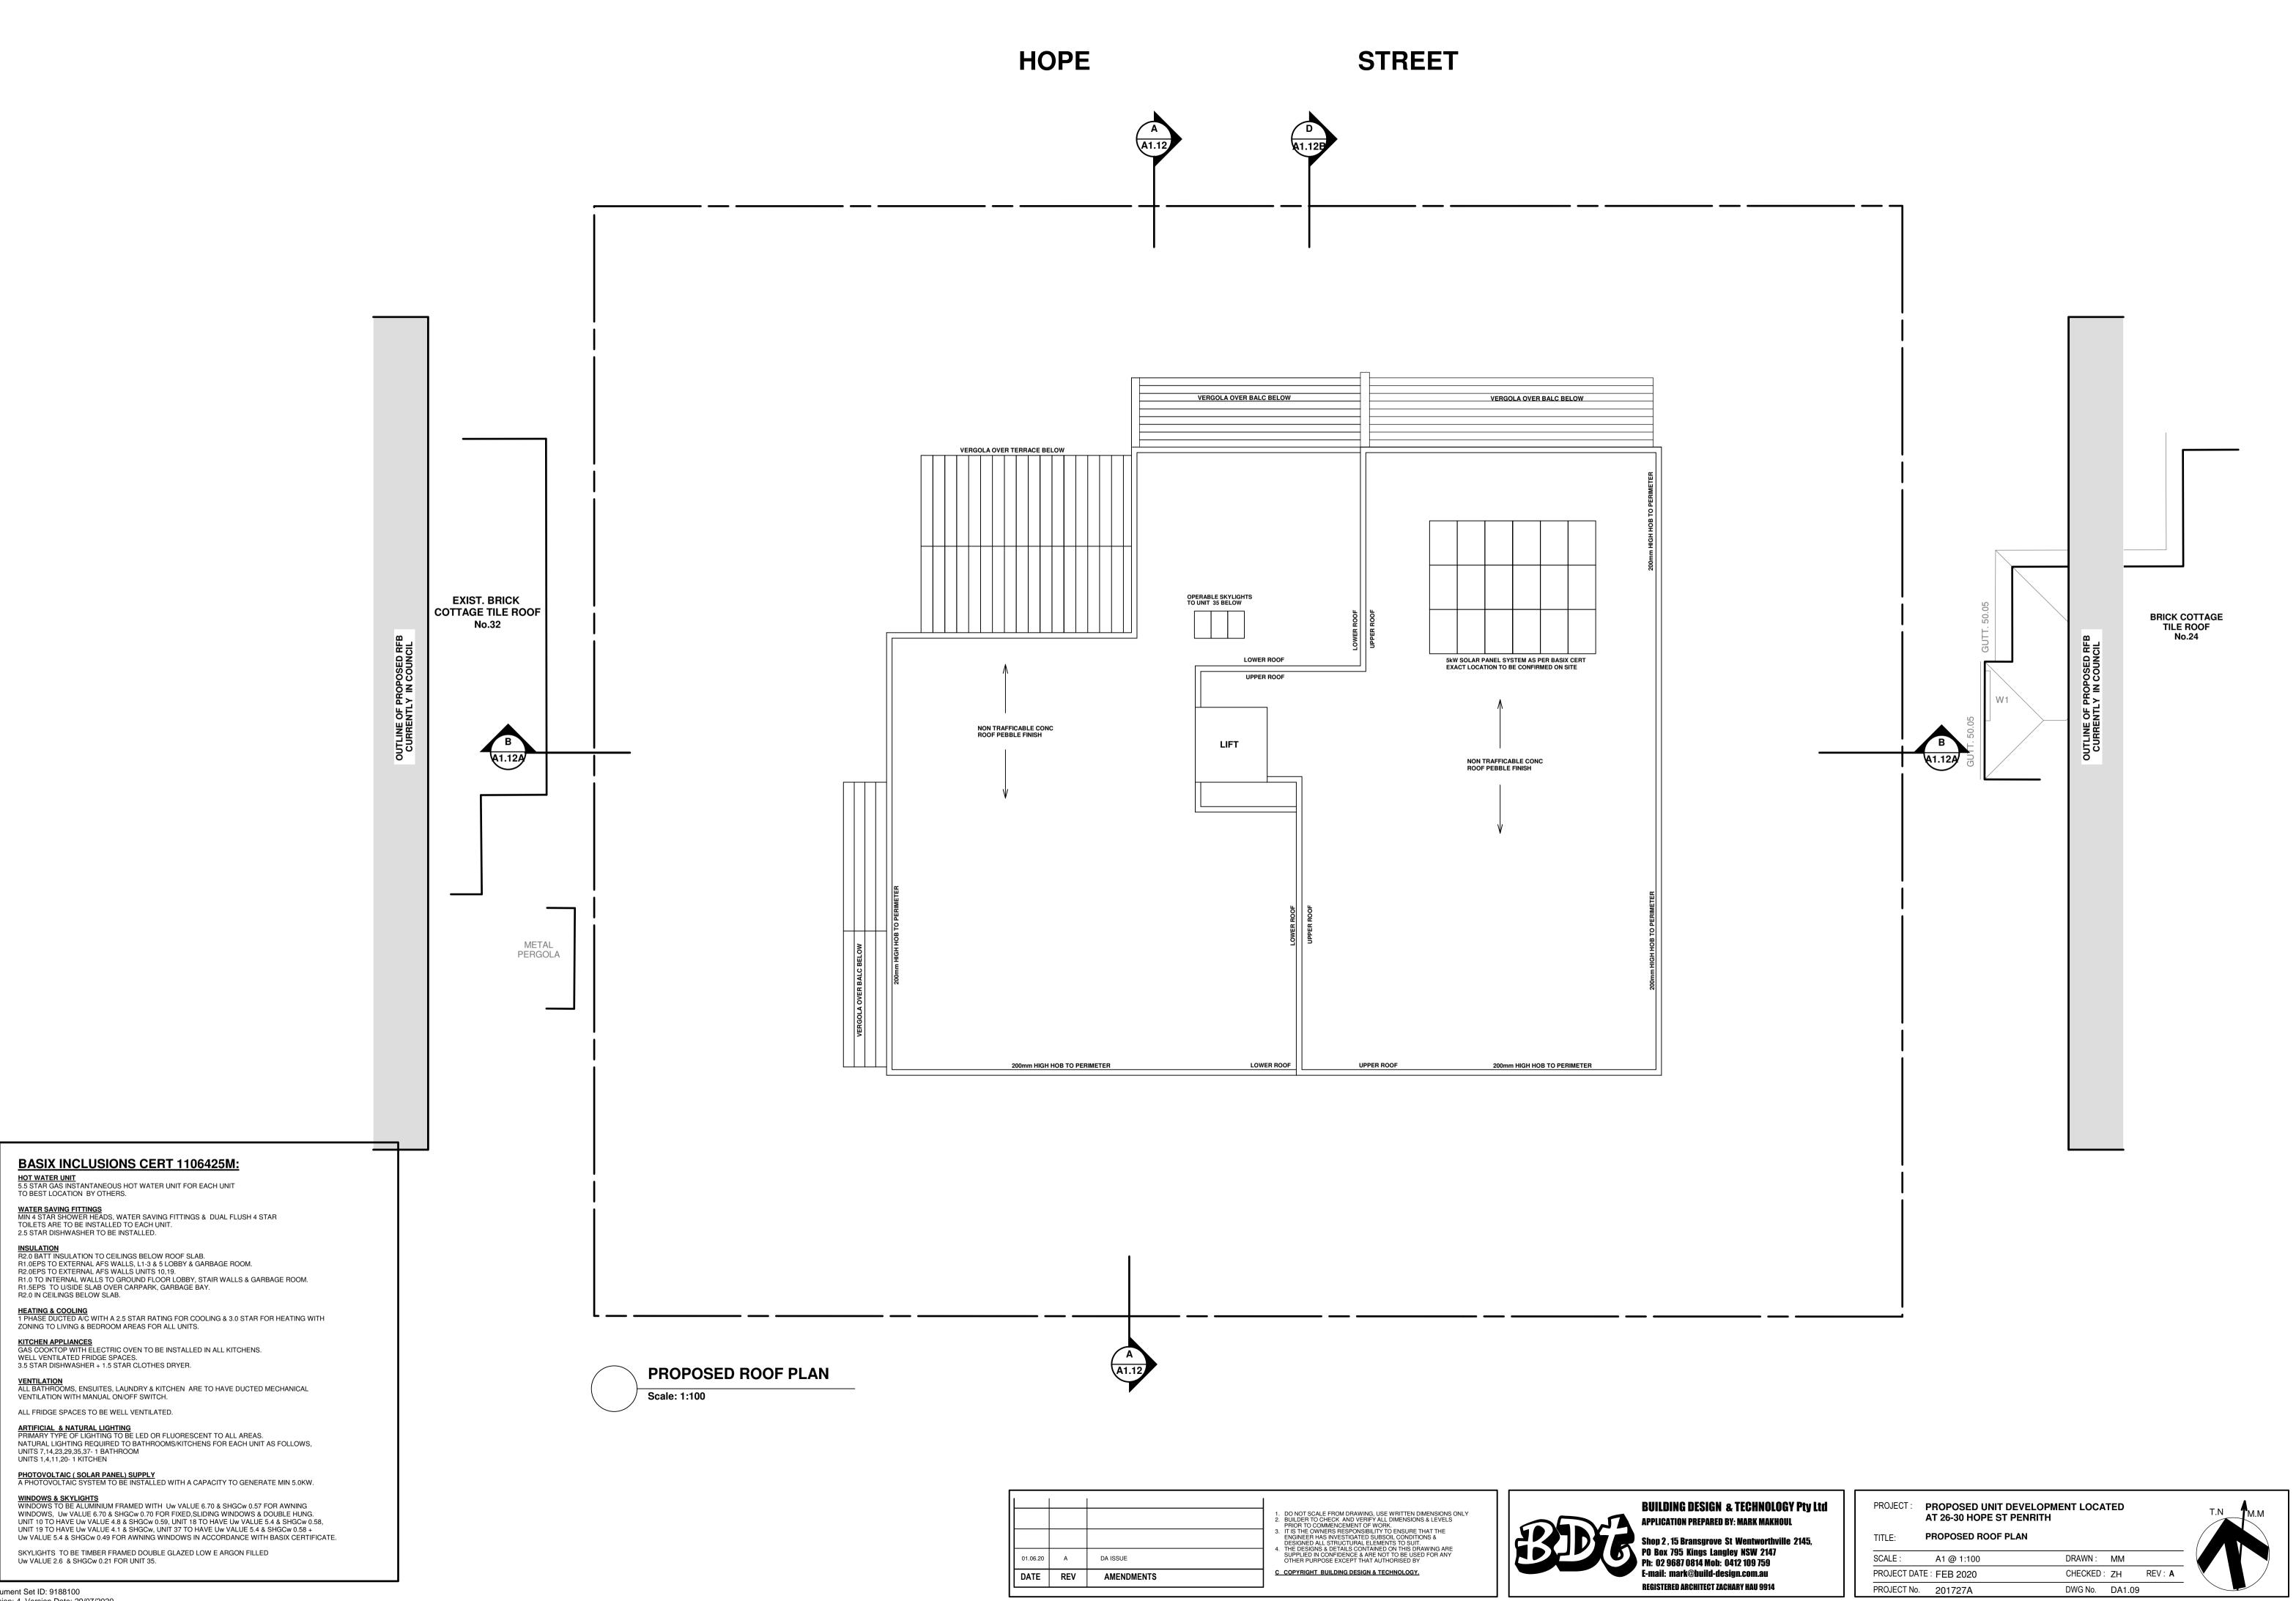

01.06.20 A DA ISSUE DATE REV AMENDMENTS	 DO NOT SCALE FROM DRAWING, USE WRITTEN DIMENSIONS ONLY BUILDER TO CHECK AND VERIFY ALL DIMENSIONS & LEVELS PRIOR TO COMMENCEMENT OF WORK. IT IS THE OWNERS RESPONSIBILITY TO ENSURE THAT THE ENGINEER HAS INVESTIGATED SUBSOLI CONDITIONS & DESIGNED ALL STRUCTURAL ELEMENTS TO SUIT. THE DESIGNS & DETAILS CONTAINED ON THIS DRAWING ARE SUPPLIED IN CONFIDENCE & ARE NOT TO BE USED FOR ANY OTHER PURPOSE EXCEPT THAT AUTHORISED BY C COPYRIGHT BUILDING DESIGN & TECHNOLOGY.
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	4. THE DESIGNS & DETAILS CONTAINED ON THIS DRAWING ARE SUPPLIED IN CONFIDENCE & ARE NOT TO BE USED FOR ANY	
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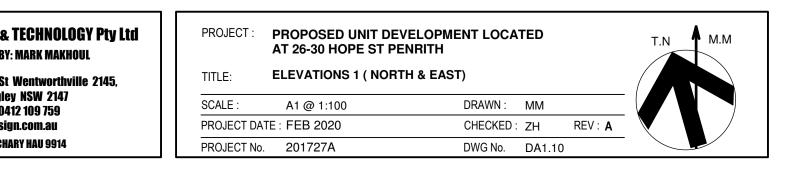
Shop 2, 15 Bransgrove St Wentworthvi PO Box 795 Kings Langley NSW 2147 Ph: 02 9687 0814 Mob: 0412 109 759 E-mail: mark@build-design.com.au REGISTERED ABCHITECT 7ACHARY HAU 9914
REGISTERED ARCHITECT ZACHARY HAU 9914

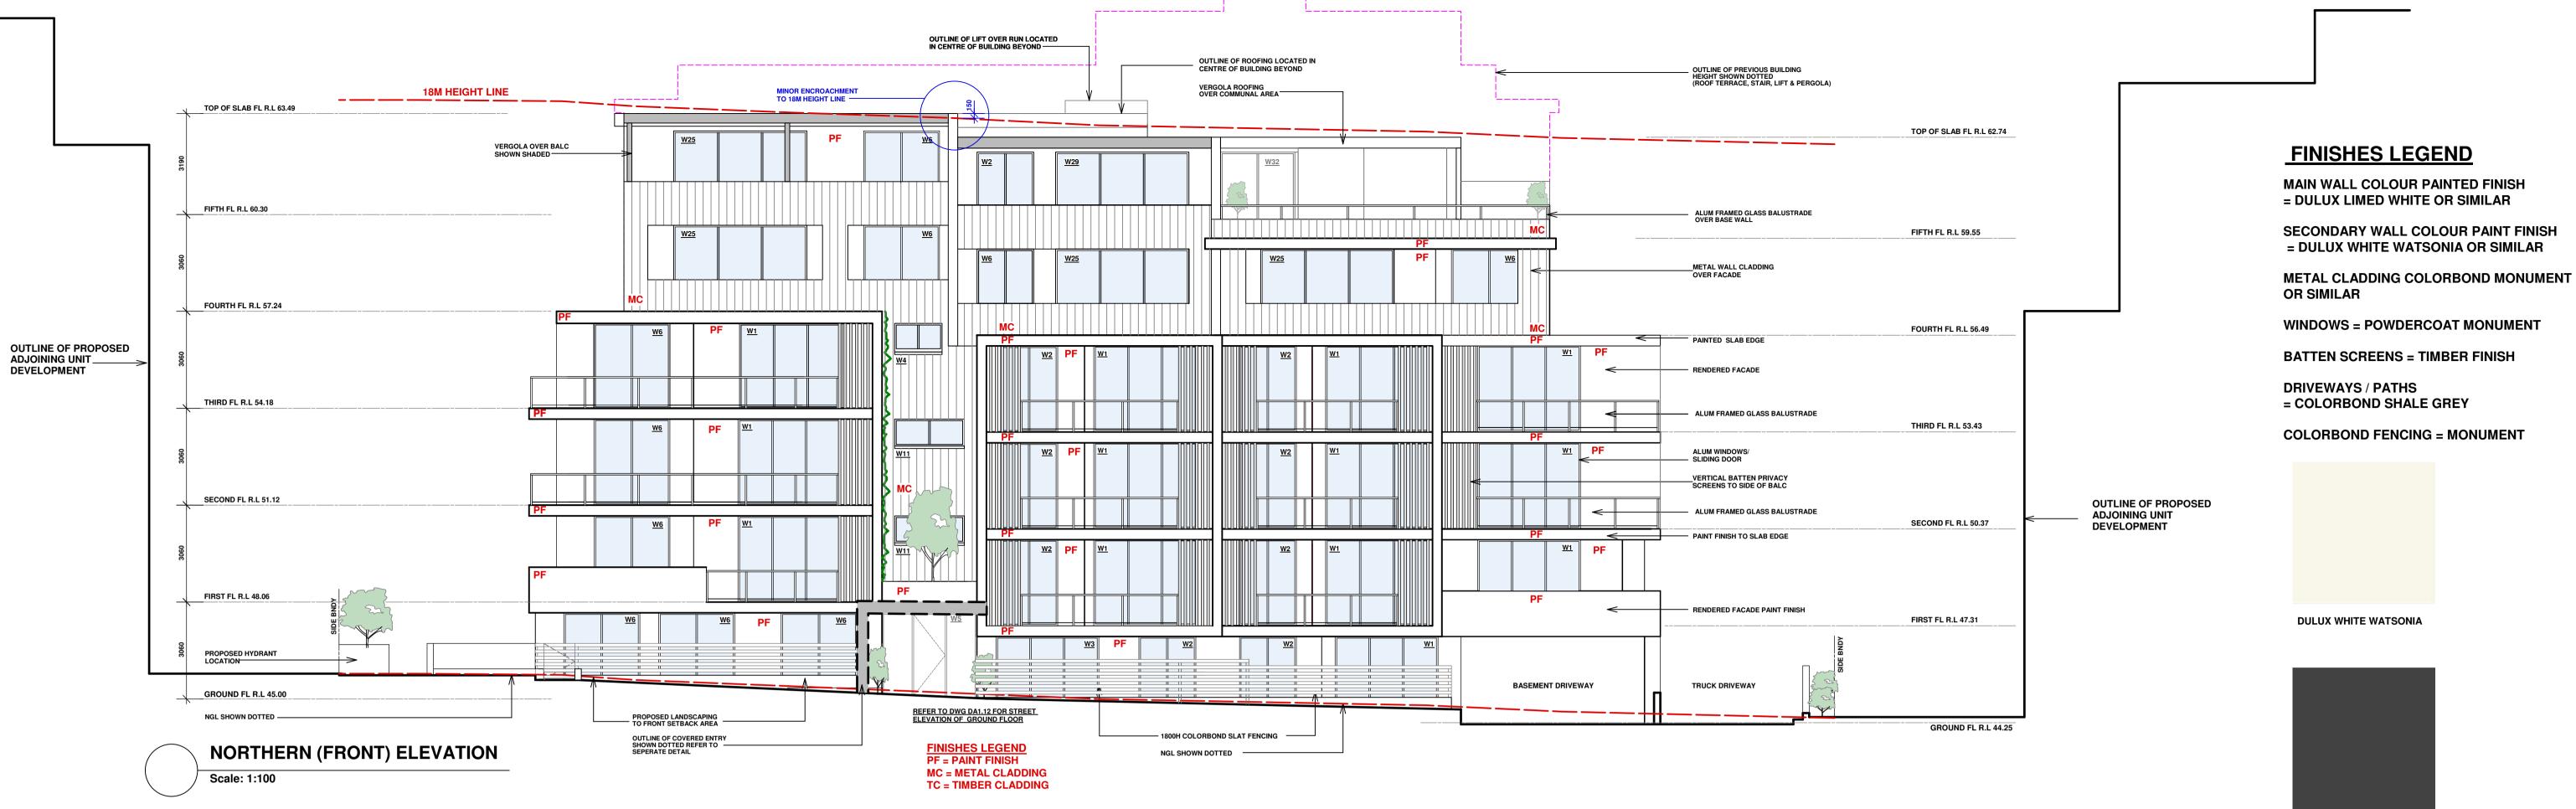COLORBOND MONUMENT



DULUX LIMED WHITE

WINDOW	SCHEDUL	E			
WINDOW NO	WIDTH	HEIGHT	TOTAL	ТҮРЕ	
1	3250	2720	21	SLIDING DOOR	
2	1800	2720	10	SLIDING DOOR	
3	3000	2720	1	SLIDING DOOR	
4	1500	900	5	SLIDING WINDOW	
5	3000	2720	1	GLAZED HINGED DOOR WITH SIDE LITE	
6	2400	2720	33	SLIDING DOOR	
7	3370	2720	1	SLIDING DOOR	
8	1800	800	2	LOUVRE WINDOW	
9	1550	1200	2	SLIDING WINDOW	
10	1800	1800	3	SLIDING WINDOW	
11	2200	850	2	SLIDING WINDOW	
12	2400	850	3	SLIDING WINDOW	
13	600	850	3	AWNING WINDOW	
14	2100	1200	3	SLIDING WINDOW	
15	2160	2720	3	SLIDING DOOR	
16	1800	2720	1	GLAZED HINGED DOOR WITH SIDE LITE	
17	2400	1200	15	SLIDING WINDOW	
18	2600	2720	3	SLIDING DOOR	
19	3200	2720	3	SLIDING & FIXED WINDOW	
20	850	1800	12	AWNING WINDOW	
21	1800	1200	2	SLIDING WINDOW	
22	1600	2720	2	GLAZED HINGED DOOR WITH SIDE LITE	
23	2400	1550	18	SLIDING WINDOW	
24	2770	1200	2	SLDING WINDOW	
25	4210	2720	4	SLIDING DOOR	
26	3200	2720	1	SLIDING DOOR	
27	3500	2720	2	SLIDING DOOR	
28	1800+1300	1200	1	SLIDING CORNER WINDOW	
29	4000	2720	3	SLIDING DOOR	
30	3600	2720	2	SLIDING & FIXED WINDOW	
31	600	1200	2	AWNING WINDOW	
32	2350	2720	1	FIXED WINDOW	
			152		







WINDOW	SCHEDUL	E		
WINDOW NO	WIDTH	HEIGHT	TOTAL	ТҮРЕ
1	3250	2720	21	SLIDING DOOR
2	1800	2720	10	SLIDING DOOR
3	3000	2720	1	SLIDING DOOR
4	1500	900	5	SLIDING WINDOW
5	3000	2720	1	GLAZED HINGED DOOR WITH SIDE LITE
6	2400	2720	33	SLIDING DOOR
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13	600	850	3	AWNING WINDOW
14	2100	1200	3	SLIDING WINDOW
15	2160	2720	3	SLIDING DOOR
16	1800	2720	1	GLAZED HINGED DOOR WITH SIDE LITE
17	2400	1200	15	SLIDING WINDOW
18	2600	2720	3	SLIDING DOOR
19	3200	2720	3	SLIDING & FIXED WINDOW
20	850	1800	12	AWNING WINDOW
21	1800	1200	2	SLIDING WINDOW
22	1600	2720	2	GLAZED HINGED DOOR WITH SIDE LITE
23	2400	1550	18	SLIDING WINDOW
24	2770	1200	2	SLDING WINDOW
25	4210	2720	4	SLIDING DOOR
26	3200	2720	1	SLIDING DOOR
27	3500	2720	2	SLIDING DOOR
28	1800+1300	1200	1	SLIDING CORNER WINDOW
29	4000	2720	3	SLIDING DOOR
30	3600	2720	2	SLIDING & FIXED WINDOW
31	600	1200	2	AWNING WINDOW
32	2350	2720	1	FIXED WINDOW



North East Elevation




North West Elevation



South West Elevation



South East Elevation

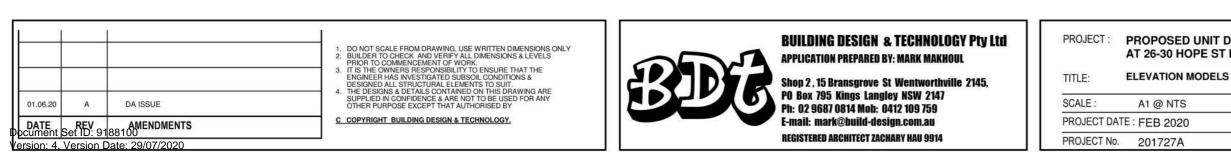



Rooftop Communail Area

PROPOSED UNIT DEVELOPMENT LOCATED AT 26-30 HOPE ST PENRITH

DRAWN :	MM	
CHECKED :	ZH	REV: A
DWG No.	DA1.1	1A





West Elevation



North Elevation





East Elevation

III 1	1		
01.06.20	A	DA ISSUE	
DATE Document	Set ID: 91	AMENDMENTS	
Version: 4.	Version D	Date: 29/07/2020	

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C COPYRIGHT BUILDING DESIGN & TECHNOLOGY.



BUILDING DESIGN & TECHNOLOGY Pty Ltd APPLICATION PREPARED BY: MARK MAKHOUL

Shop 2, 15 Bransgrove St Wentworthville 2145, PO Box 795 Kings Langley NSW 2147 Ph: 02 9687 0814 Mob: 0412 109 759 E-mail: mark@build-design.com.au **REGISTERED ARCHITECT ZACHARY HAU 9914**

South Elevation


PROJECT :	PROPOSED AT 26-30 HO
TITLE:	ELEVATION
SCALE :	A1 @ NTS
PROJECT DA	TE : FEB 2020
PROJECT No	201727A



UNIT DEVELOPMENT LOCATED **DPE ST PENRITH**

HEIGHT LINES

DRAWN :	MM	
CHECKED :	ZH	REV: A
DWG No.	DA1.11E	}

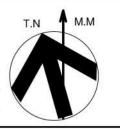



Scale: 1:100

	A	DA ISSUE	ENGINEER HAS INVESTIGATED SUBSOIL CONDITIONS & DESIGNED ALL STRUCTURAL ELEMENTS TO SUIT. 4. THE DESIGNS & DETAILS CONTAINED ON THIS DRAWING ARE SUPPLIED IN CONFIDENCE & ARE NOT TO BE USED FOR ANY OTHER PURPOSE EXCEPT THAT AUTHORISED BY C COPYRIGHT BUILDING DESIGN & TECHNOLOGY.	BUG
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BUILDING DESIGN & TECHNOLOGY Pty Ltd **APPLICATION PREPARED BY: MARK MAKHOUL**

Shop 2 , 15 Bransgrove St Wentworthville 2145, PO Box 795 Kings Langley NSW 2147 Ph: 02 9687 0814 Mob: 0412 109 759 E-mail: mark@build-design.com.au REGISTERED ARCHITECT ZACHARY HAU 9914

FINISHES LEGEND

MAIN WALL COLOUR PAINTED FINISH = DULUX LIMED WHITE OR SIMILAR

SECONDARY WALL COLOUR PAINT FINISH = DULUX WHITE WATSONIA OR SIMILAR

METAL CLADDING COLORBOND MONUMENT **OR SIMILAR**

WINDOWS = POWDERCOAT MONUMENT

BATTEN SCREENS = TIMBER FINISH

DRIVEWAYS / PATHS = COLORBOND SHALE GREY


COLORBOND FENCING = MONUMENT




DULUX WHITE WATSONIA




COLORBOND MONUMENT

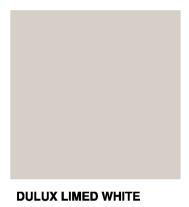

	PROPOSED UNIT DEVELOPME AT 26-30 HOPE ST PENRITH	ENT LOCA	TED		Т. М. М. М
TITLE:	SECTION AA & FRONT FENCE EI	EVATION			
SCALE :	A1 @ 1:100	DRAWN :	MM		
PROJECT DATE	: FEB 2020	CHECKED :	ZH	REV: A	
PROJECT No.	201727A	DWG No.	DA1.12		

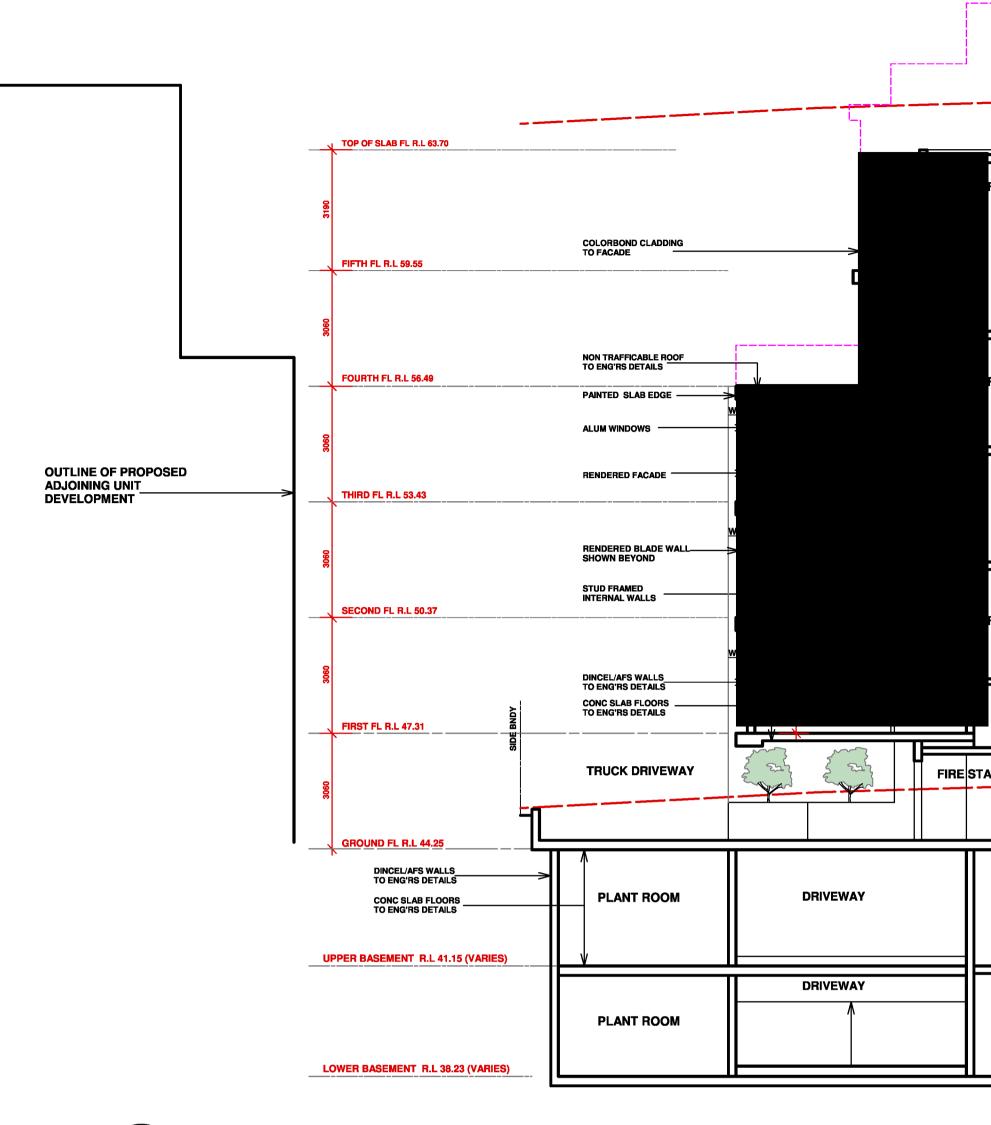



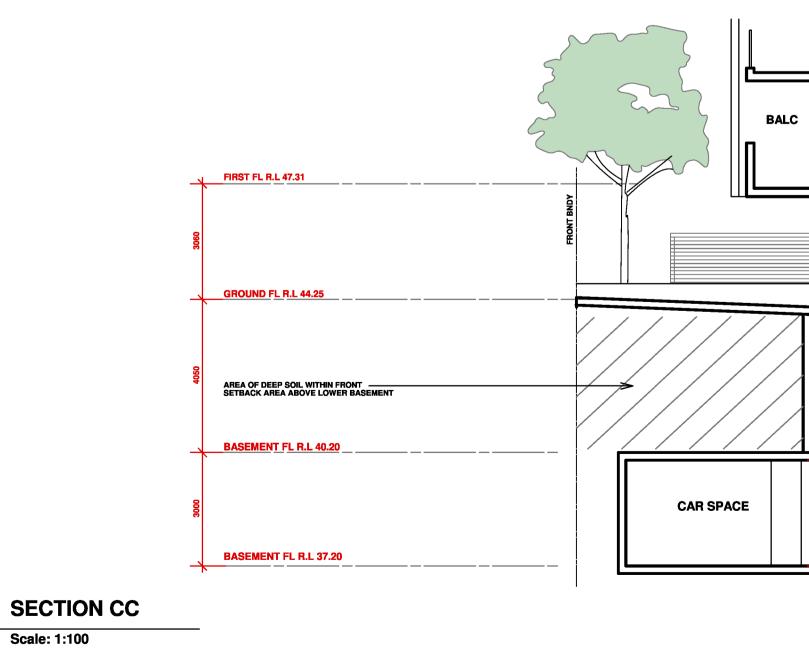

			OUTLINE OF PREVIOUS BUILI HEIGHT SHOWN DOTTED (ROOF TERRACE, STAIR, LIFT	DING T & PERGOLA)			
							NON TRAFFIC/ TO ENG'RS DE
			7		i		
FIRE STAIR		LIFT WELL					RENDERED BL SHOWN BEYO
FIRE STAIR						je	TO ENG'RS DE
						~	ALUM FRAMEI
							DINCEL/AFS V
							CONC SLAB F
		WELL					
	ſ						
	FOYER/ WALKWAY		GARBAGE ROOM	BIKE STORE	AISLE	CARSPACE	
	FOYER/ WALKWAY		CARSPACE	2750	AISLE	CARSPACE	
	L	111				<u> </u>	

<u>W1</u>	UNIT 4	GARBAGE TRUCK TURNBAY AREA	
	AISLE REFER TO DA1.02 FOR FURTHER DETAILS	B CAR SPACE AISLE B	DEEP SOI PLANTING
2800	FURTHER DETAILS DRIVEWAY AISLE 00 CAR SPACE 00 00 00 00 00 00 00 00 00 00 00 00 00	AISLE CAR SPACE	

01.06.20 DATE	A REV	DA ISSUE AMENDMENTS	1. DO NOT SCALE FROM DRAWING, USE WRITTEN DIMENSIONS ONLY 2. BUILDER TO CHECK AND VERIFY ALL DIMENSIONS & LEVELS PRIOR TO COMMENCEMENT OF WORK. 3. IT IS THE OWNERS RESPONSIBILITY TO ENSURE THAT THE ENGINEER HAS INVESTIGATED SUBSOLI CONDITIONS & DESIGNED ALL STRUCTURAL ELEMENTS TO SUIT. 4. THE DESIGNS & DETAILS CONTAINED ON THIS DRAWING ARE SUPPLIED IN CONFIDENCE & ARE NOT TO BE USED FOR ANY OTHER PURPOSE EXCEPT THAT AUTHORISED BY C. COPYRIGHT BUILDING DESIGN & TECHNOLOGY.			BUILDING DE APPLICATION PRE Shop 2 , 15 Brans PO Box 795 King Ph: 02 9687 0814 E-mall: mark@bu REGISTERED ARCHI
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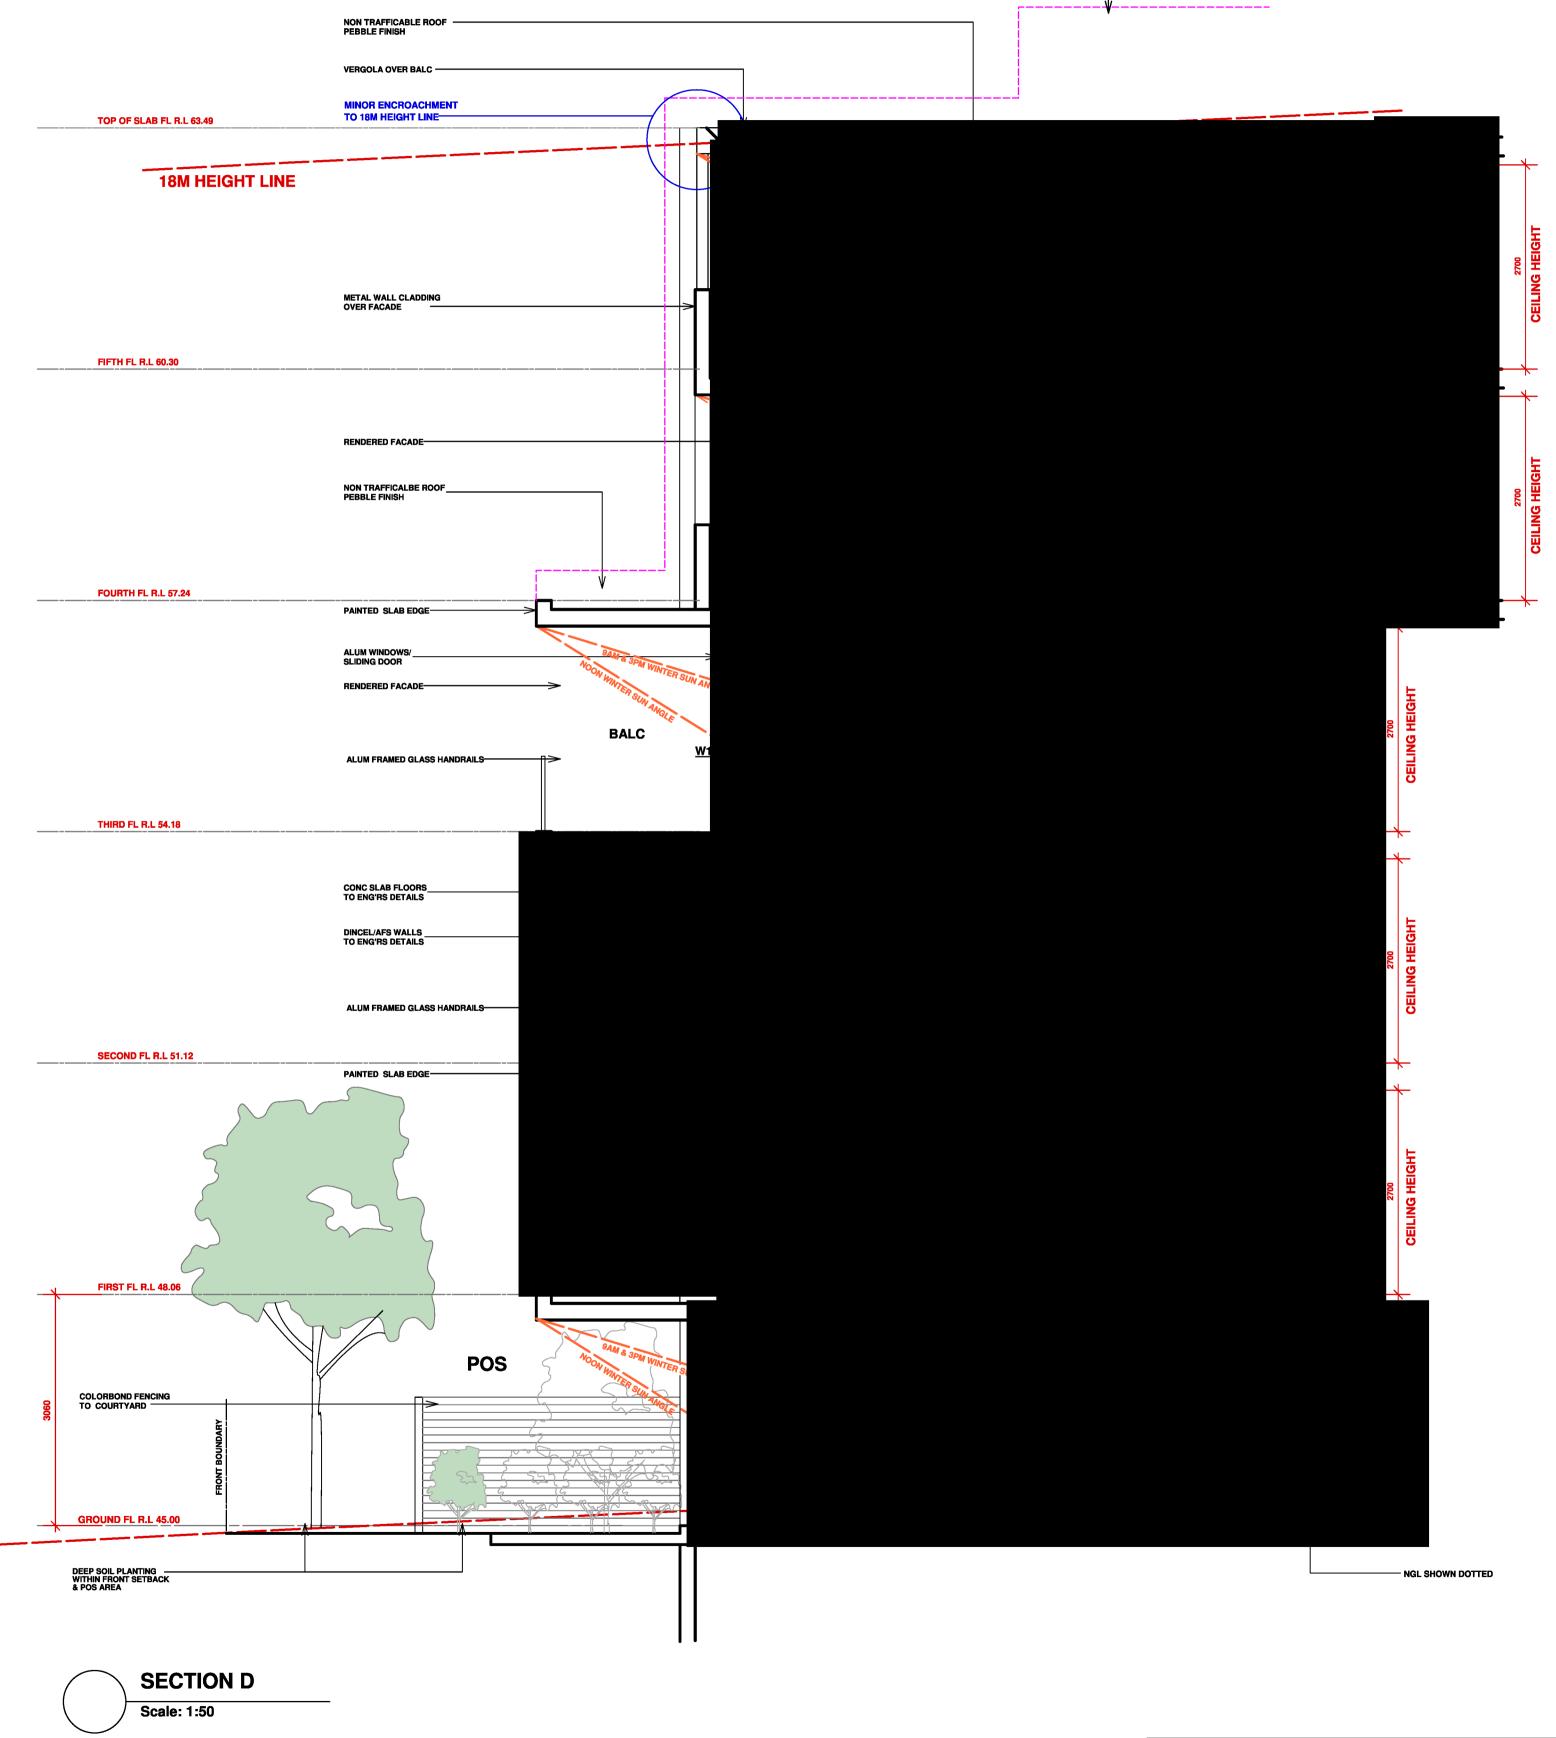
18M HEIGHT LINE		
	ROOF SLAB FL R.L 63.49	
NDERED BLADE WALL	FIFTH FL R.L 60.30	
IM SLIDING DOORS	FOURTH FL R.L 57.24	
3060		
IM FRAMED GLASS HANDRAILS	THIRD FL R.L 54.18	OUTLINE OF PROPOSED
		ADJOINING UNIT DEVELOPMENT
CEL/AFS WALLS	SECOND FL R.L 51.12	
NC SLAB FLOORS ENG'RS DETAILS		
	FIRST FL R.L 48.06	
	GROUND FL R.L 45.00	
DEEP SOIL AREA		
LEAR BNDY		
P ŚOIL NTING		
IGN & TECHNOLOGY Pty Ltd Ared by: Mark Makhoul	PROJECT : PROPOSED UI AT 26-30 HOPE	NIT DEVELOPMENT LOCATED E ST PENRITH

Т. М. М.

SIGN & TECHNOLOGY Pty Ltd Pared by: Mark Makhoul


grove St Wentworthville 2145, Is Langley NSW 2147 I Mob: 0412 109 759 Illd-design.com.au TECT Zachary Hau 9914

	AT 26-30 HOPE ST PENR	ITH		
TITLE:	SECTION BB & CC			
SCALE :	A1 @ 1:100	DRAWN :	MM	- (
PROJECT D	ATE : FEB 2020	CHECKED :	ZH REV:	
PROJECT N	lo. 201727A	DWG No.	DA1.12A	_ \



01.06.20 DATE	A	DA ISSUE AMENDMENTS	 DO NOT SCALE FROM DRAWING, USE WRITTEN DIMENSIONS ONLY BUILDER TO CHECK AND VERIFY ALL DIMENSIONS & LEVELS PRIOR TO COMMENCEMENT OF WORK. IT IS THE OWNERS RESPONSIBILITY TO ENSURE THAT THE ENGINEER HAS INVESTIGATED SUBSOIL CONDITIONS & DESIGNED ALL STRUCTURAL ELEMENTS TO SUIT. THE DESIGNS & DETAILS CONTAINED ON THIS DRAWING ARE SUPPLIED IN CONFIDENCE & ARE NOT TO BE USED FOR ANY OTHER PURPOSE EXCEPT THAT AUTHORISED BY C COPYRIGHT BUILDING DESIGN & TECHNOLOGY.
DATE	KEV	AMENDMENIS	J


_ OUTLINE OF PREVIOUS BUILDING HEIGHT SHOWN DOTTED

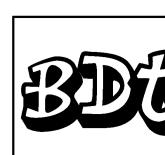

BUILDING DESIGN & TECHNOLOGY Pty Ltd **APPLICATION PREPARED BY: MARK MAKHOUL**


Shop 2 , 15 Bransgrove St Wentworthville 2145, PO Box 795 Kings Langley NSW 2147 Ph: 02 9687 0814 Nob: 0412 109 759 E-mail: mark@build-design.com.au REGISTERED ARCHITECT ZACHARY HAU 9914

PROJECT: PROPOSED UNIT DEVELOPMENT LOCATED AT 26-30 HOPE ST PENRITH			
TITLE:	SECTION D		
SCALE :	1:50 @ A1	DRAWN: MM	
PROJECT D	ATE : FEB 2020	CHECKED: ZH	REV: A
PROJECT N	o. 201727A	DWG No. DA1.1	2B

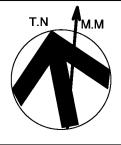

HOPE

STREET

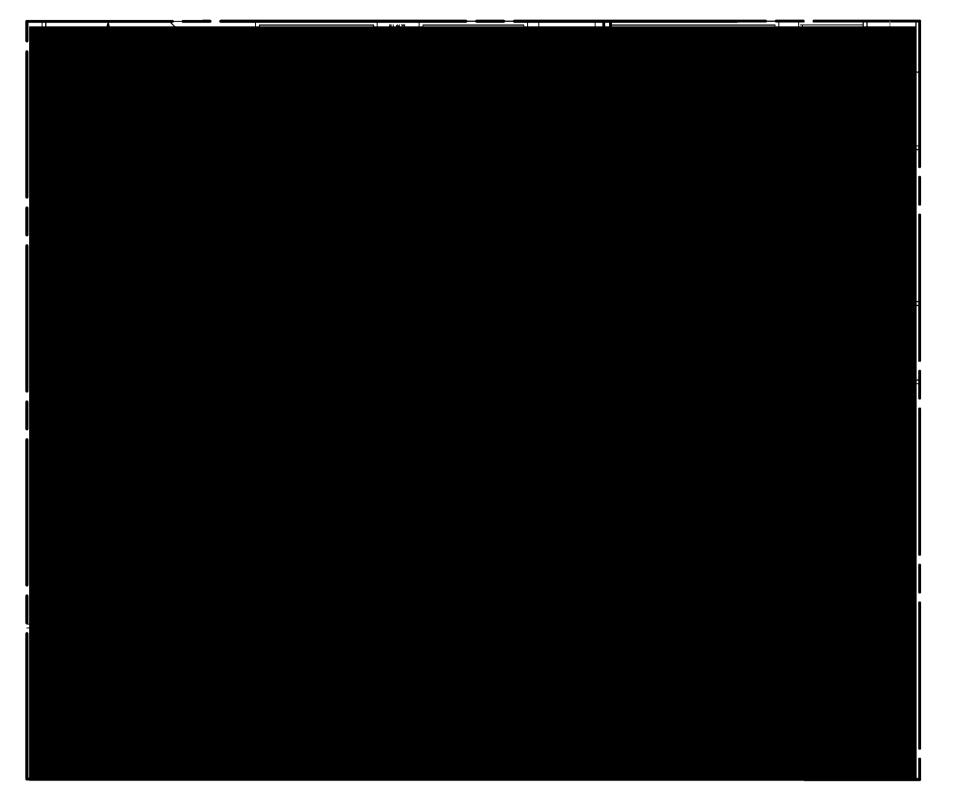


GROUND FLOOR PLAN Scale: 1:200

COLOURED UNITS ACHIEVE CROSS VENTILATION



STREET

HOPE

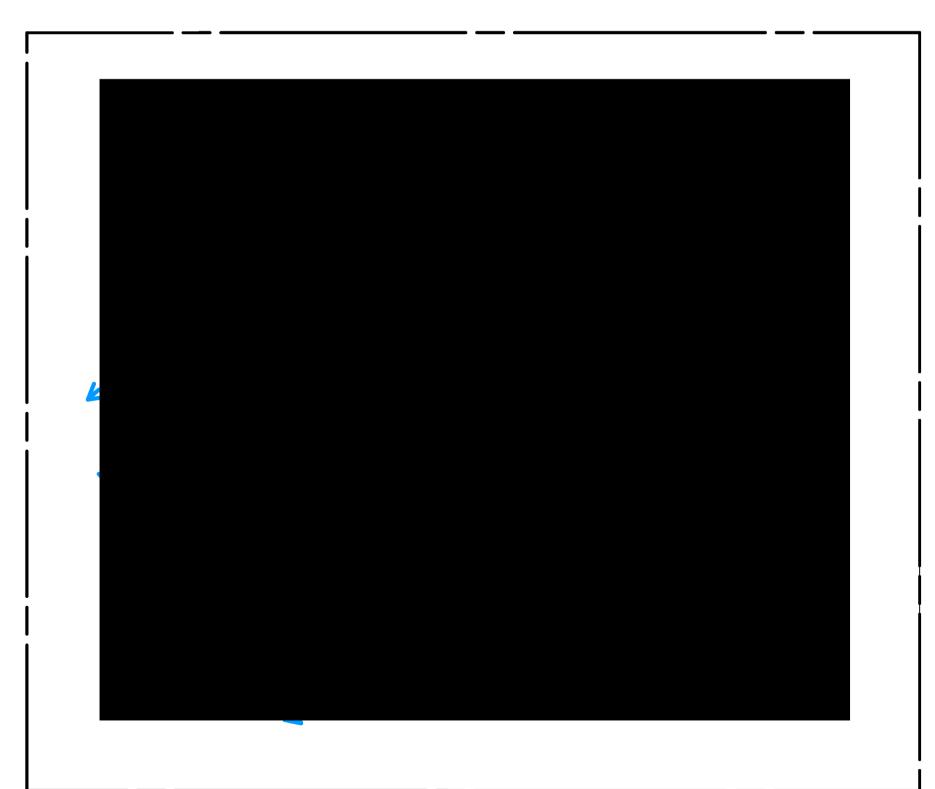



THIRD FLOOR PLAN

COLOURED UNITS ACHIEVE CROSS VENTILATION

TOTAL UNITS - 38 **CROSS VENTILATED UNITS - 25 (66%) REQUIRED VENTILATED UNITS - 23 (60%)**

FIRST FLOOR PLAN Scale: 1:200

_ ___ ___

COLOURED UNITS ACHIEVE CROSS VENTILATION

HOPE






FOURTH FLOOR PLAN Scale: 1:200

COLOURED UNITS ACHIEVE CROSS VENTILATION

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COLOURED UNITS ACHIEVE CROSS VENTILATION



COLOURED UNITS ACHIEVE CROSS VENTILATION

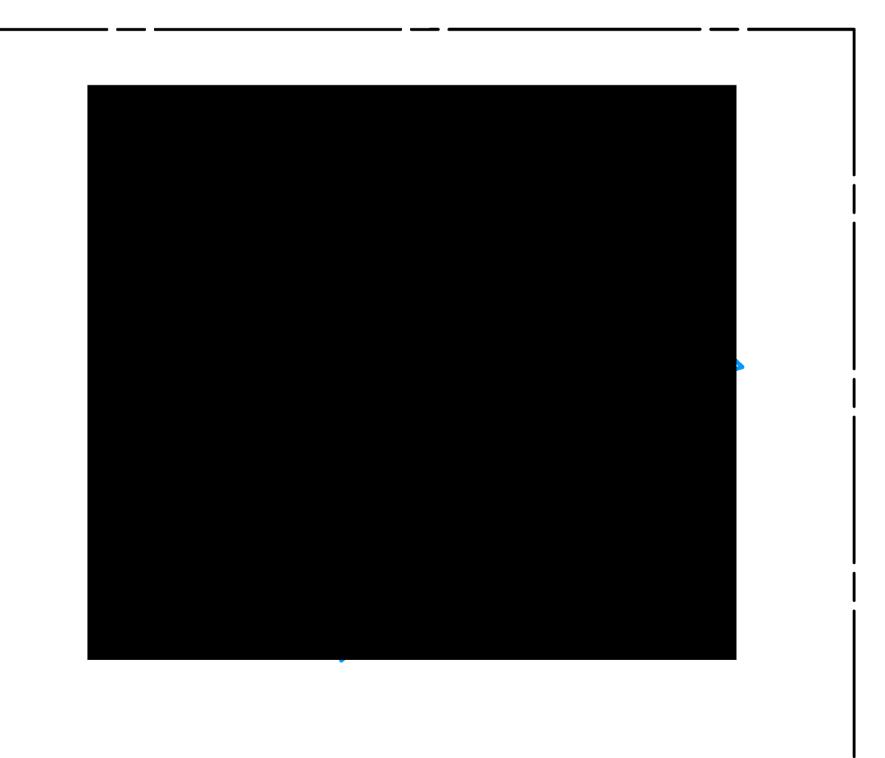
HOPE

STREET


CHNOLOGY Pty Ltd Ark Makhoul	PROJECT :	PROPOSED UNIT DI AT 26-30 HOPE ST F	EVELOPMENT LOCA PENRITH	TED		T.N M.M
ntworthville 2145,	TITLE:	VENTILATION PLAN				
SW 2147 109 759	SCALE :	A1 @ 1:100	DRAWN :	MM		
om.au	PROJECT DAT	TE: FEB 2020	CHECKED :	ZH	REV: A	
HAU 9914	PROJECT No.	201727A	DWG No.	DA1.13		






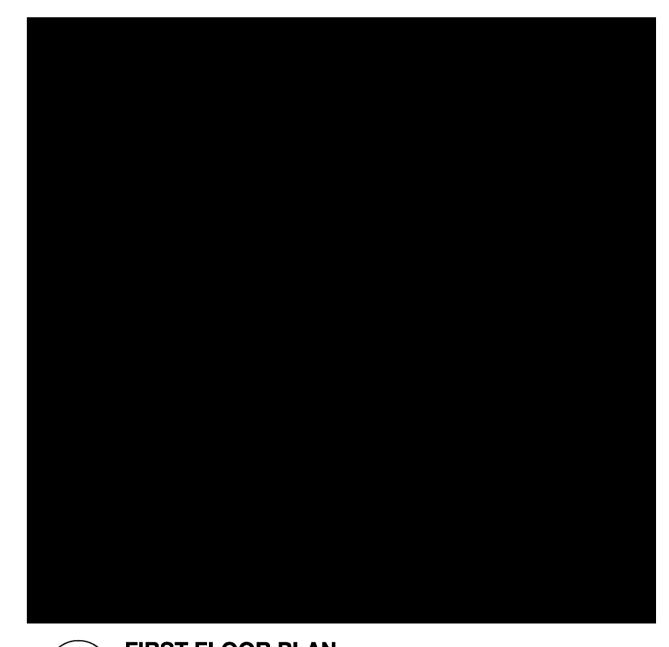





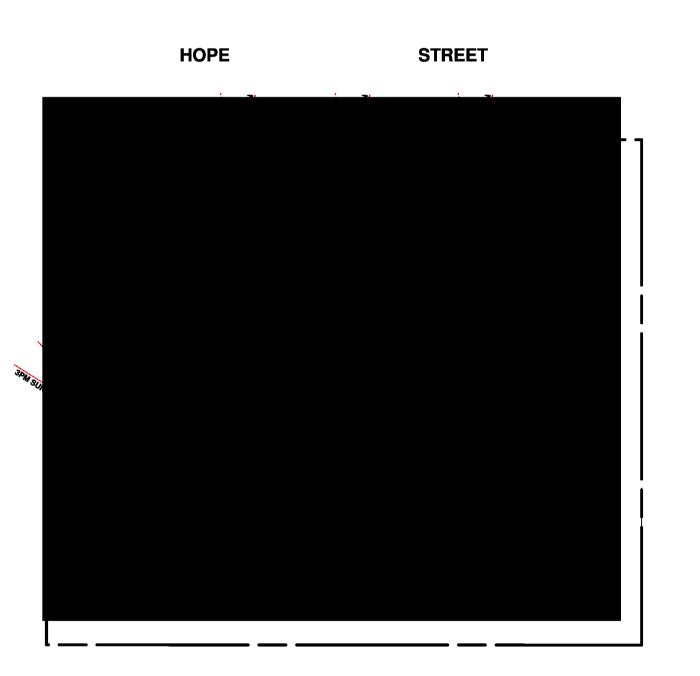




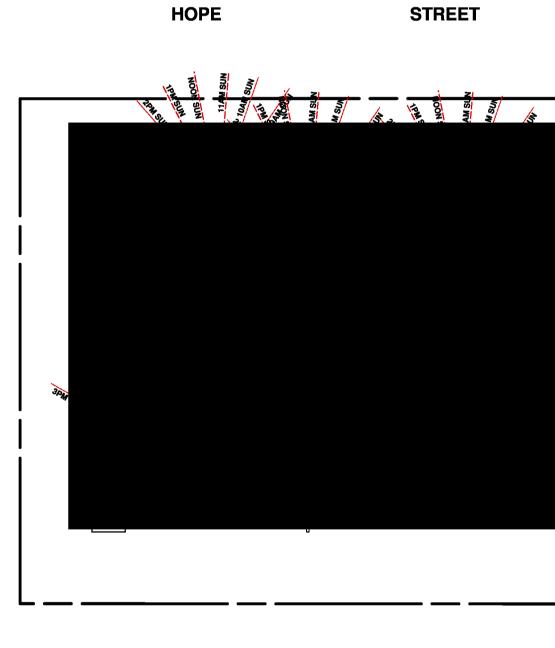

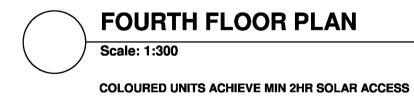

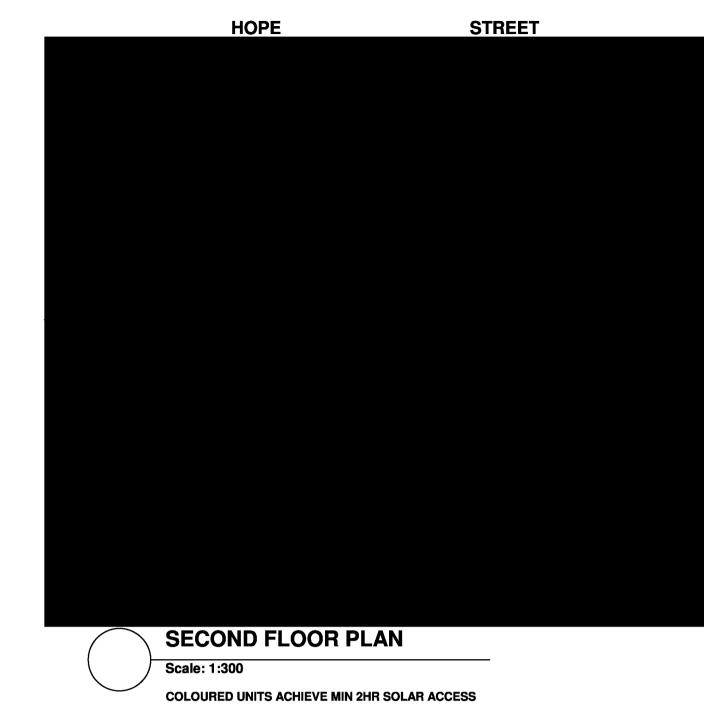

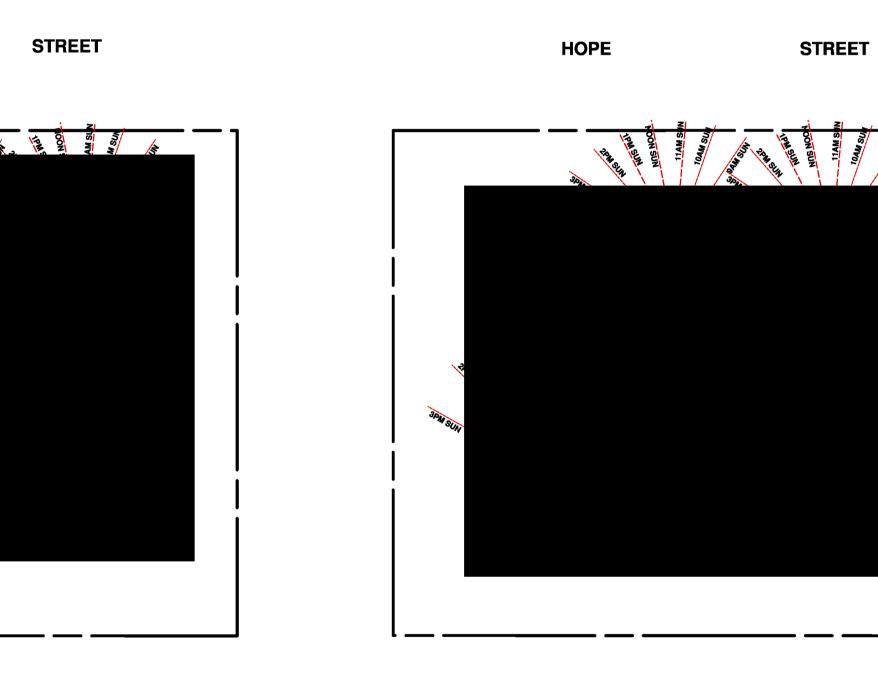

FIFTH FLOOR PLAN Scale: 1:300 COLOURED UNITS ACHIEVE MIN 2HR SOLAR ACCESS

DATE	REV	AMENDMENTS	C COPYRIGHT BUILDING DESIGN & TECHNOLOGY.
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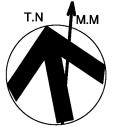


BUILDING DESIGN & TECHNOLOGY Pty Ltd **APPLICATION PREPARED BY: MARK MAKHOUL**

Shop 2 , 15 Bransgrove St Wentworthville 2145, PO Box 795 Kings Langley NSW 2147 Ph: 02 9687 0814 Nob: 0412 109 759 E-mail: mark@build-design.com.au REGISTERED ARCHITECT ZACHARY HAU 9914

SOLAR AC	CESS SC	HEDULE						
UNIT NO	9AM	10AM	11AM	12NOON	1PM	2PM	3PM	COMPLIES
1	YES	YES	YES	YES	YES	YES	YES	YES
2	YES	YES	YES	YES	YES	YES	YES	YES
3	YES	YES	YES	YES	YES	YES	YES	YES
4	YES	YES	YES	YES	YES	YES	YES	YES
5	YES	YES	YES	YES	YES	YES	YES	YES
6	YES	YES	YES	YES	YES	YES	YES	YES
7	YES	YES	YES	YES	YES	YES	YES	YES
8	YES	YES	YES	NO	NO	NO	NO	YES
9	YES	YES	YES	NO	NO	NO	NO	YES
10	NO	NO	NO	NO	NO	NO	NO	NO
11	YES	YES	YES	YES	YES	YES	YES	YES
12	YES	YES	YES	YES	YES	YES	YES	YES
13	YES	YES	YES	YES	YES	YES	YES	YES
14	YES	YES	YES	YES	YES	YES	YES	YES
15	YES	YES	YES	NO	NO	NO	NO	YES
16	YES	YES	YES	NO	NO	NO	NO	YES
17	NO	NO	NO	NO	NO	NO	NO	NO
18	NO	NO	NO	NO	NO	NO	NO	NO
19	NO	NO	NO	YES	YES	YES	YES	YES
20	YES	YES	YES	YES	YES	YES	YES	YES
21	YES	YES	YES	YES	YES	YES	YES	YES
22	YES	YES	YES	YES	YES	YES	YES	YES
23	YES	YES	YES	YES	YES	YES	YES	YES
24	YES	YES	YES	NO	NO	NO	NO	YES
25	YES	YES	YES	NO	NO	NO	NO	YES
26	NO	NO	NO	NO	NO	NO	NO	NO
27	NO	NO	NO	NO	NO	NO	NO	NO
28	NO	NO	NO	YES	YES	YES	YES	YES
29	YES	YES	YES	YES	YES	YES	YES	YES
30	YES	YES	YES	YES	YES	YES	YES	YES
31	YES	YES	YES	YES	YES	YES	YES	YES
32	YES	YES	YES	NO	NO	NO	NO	YES
33	NO	NO	NO	NO	NO	NO	NO	NO
34	NO	NO	NO	YES	YES	YES	YES	YES
35	YES	YES	YES	YES	YES	YES	YES	YES
36	YES	YES	YES	YES	YES	YES	YES	YES
37	YES	YES	YES	NO	NO	NO	NO	YES
38	NO	NO	NO	YES	YES	YES	YES	YES
TOTAL								32/38 (85%)

PROJECT : PROPOSED UNIT DEVELOPMENT LOCATED AT 26-30 HOPE ST PENRITH SOLAR ACCESS PLAN TITLE: SCALE : 1:300 @ A1 DRAWN : MM PROJECT DATE : FEB 2020 CHECKED : ZH REV : A PROJECT No. 201727A DWG No. DA1.14



01.06.20	А	DA ISSUE	
DATE ocument	Set ID: 91	88100	
		Date: 29/07/2020	

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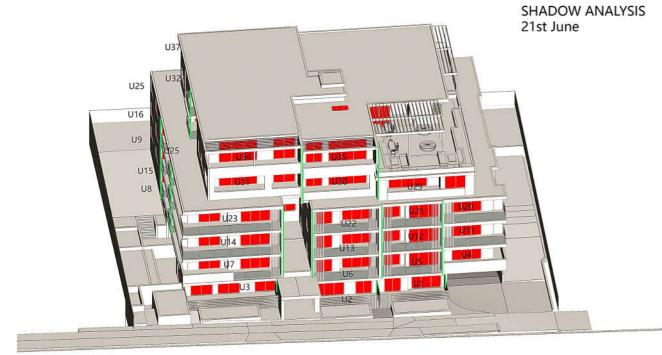
C COPYRIGHT BUILDING DESIGN & TECHNOLOGY.


BUILDING DESIGN & TECHNOLOGY Pty Ltd APPLICATION PREPARED BY: MARK MAKHOUL

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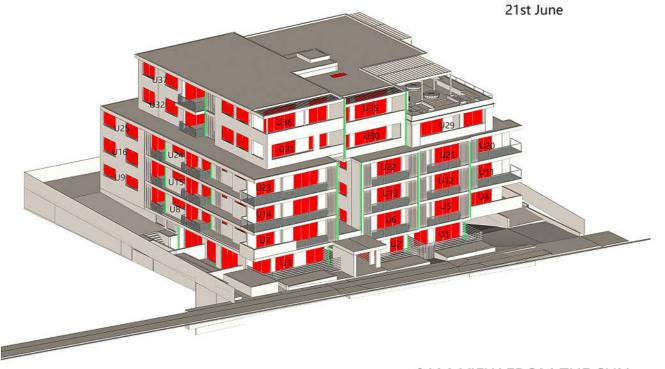
PROJECT :	PROPOSED UNIT DEVELO AT 26-30 HOPE ST PENRIT		TED	
TITLE:	9AM-NOON SUN VIEWS			
SCALE :	A1 @ NTS	DRAWN :	MM	
PROJECT DA	TE : FEB 2020	CHECKED :	ZH	REV: A
PROJECT No.	201727A	DWG No.	DA1.1	4A


11AM-VIEW FROM THE SUN



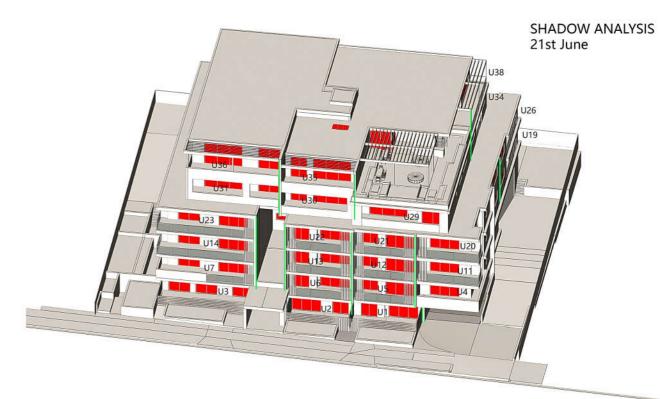

9AM-VIEW FROM THE SUN




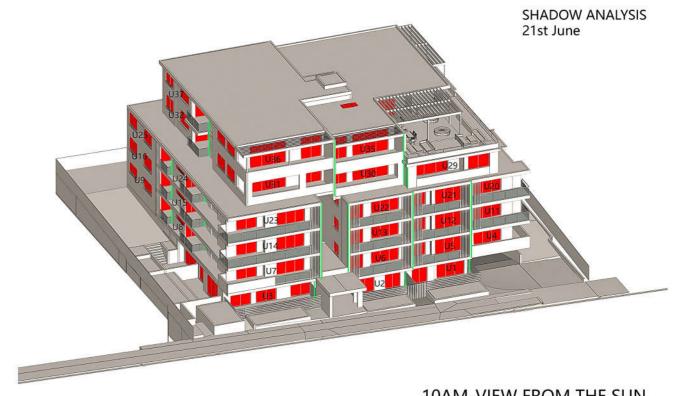

SHADOW ANALYSIS

10AM-VIEW FROM THE SUN

12PM-VIEW FROM THE SUN

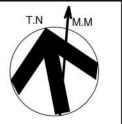

	SHADOW ANALYSIS 21st June
1PM-VIEW I	FROM THE SUN
	SHADOW ANALYSIS 21st June
3PM-VIEW	FROM THE SUN
1. DO NOT SCALE FROM DRAWING, USE WRITTEN DIMENSIONS ONLY	PROJEC

	01.06.20	A	DA ISSUE	
b	DATE ocument	Set D: 9	AMENDMENTS	
4	ersion: 4,	Version I	Date: 29/07/2020	

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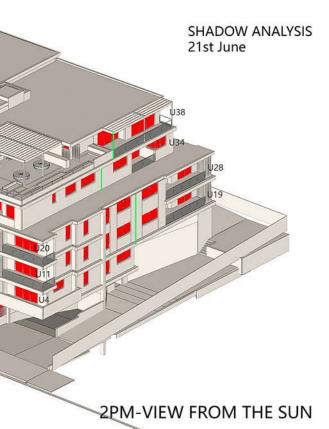
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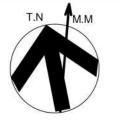
APPLICATION PREPARED BY: MARK MAKHOUL


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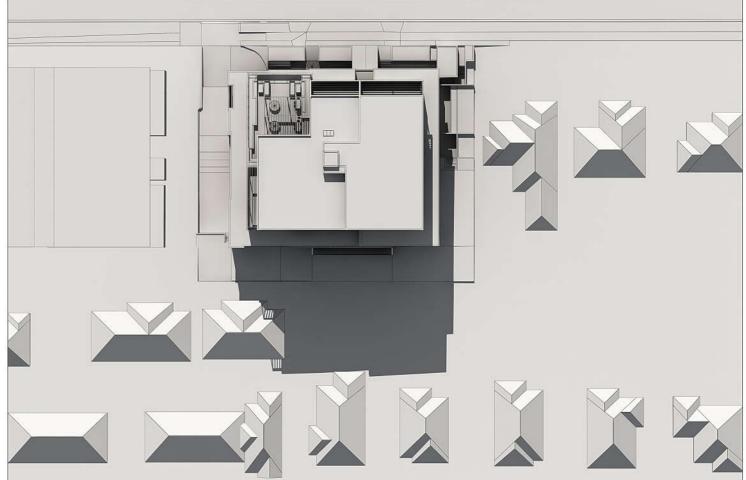
PROJECT :	PROPOSED UNIT DEVELO AT 26-30 HOPE ST PENRI		TED	
TITLE:	1PM-3PM SUN VIEWS			
SCALE :	A1 @ NTS	DRAWN :	MM	
PROJECT DA	TE : FEB 2020	CHECKED :	ZH	REV: A
PROJECT No.	201727A	DWG No.	DA1.1	4B










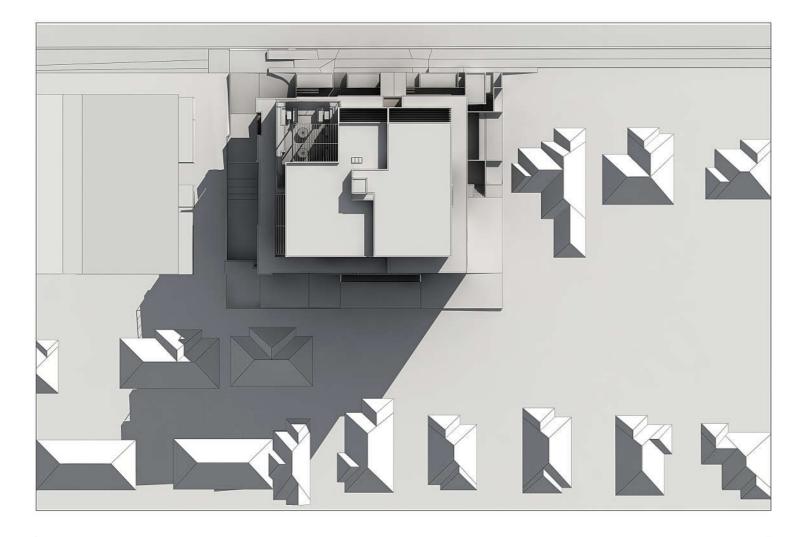

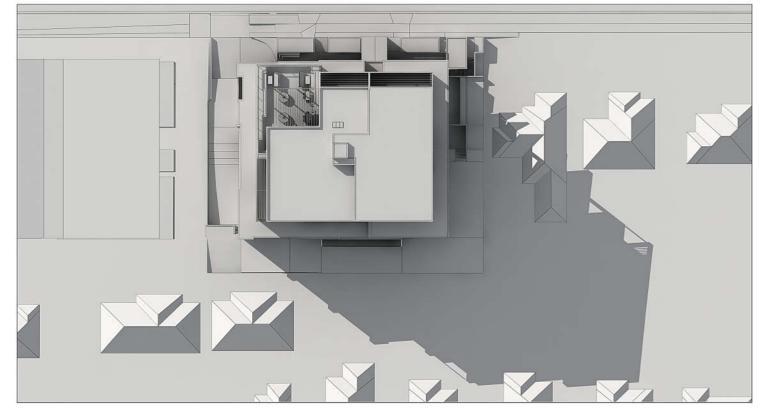



1. 9am June 21 Winter Shadows 2. Noon June 21 Winter Shadows 3. 3pm June 21 Winter Shadows

01.06.20	A	DA ISSUE	
DATE	REV	AMENDMENTS	

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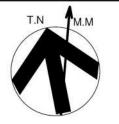
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PROJECT :	PROPOSED UNIT DEV AT 26-30 HOPE ST PE		TED	
TITLE:	JUNE 21 WINTER SHAL	DOW PLAN		
SCALE :	1:300 @341	DRAWN :	MM	
PROJECT DA	TE : FEB 2020	CHECKED :	ZH	REV: A
PROJECT No.	201727A	DWG No.	DA1.15	



LOCATION OF STOCKPILE MATERIAL I.E CEMENT, SAND, ETC. ALL STOCK GUTTERS & FOOTPATHS. STOCKPILES -WHILE NOT IN USE.

> TILE ROOF No.32

ALL EROSION & SEDIMENT CONTROL MEASURE LOCATIONS ARE TO BE CONFIRMED ON SITE & INSPECTED DAILY OUTLINE OF EXIST. WORKS ON SITE TO BE DEMOLISHED SHOWN DOTTED



RETAIN MATERIALS FROM DEMOLISHED PART OF RESIDENCE. MATERIALS IN GOOD CONDITIONS

CONNECT TEMPORARY OR PERMANENT DOWNPIPES TO THE STORMWATER SYSTEM BEFORE

NOTE:

ARE TO BE RE-USED AS PART OF NEW WORKS.

LAYING THE ROOF. ALL STORMWATER DISCHARGE SHOULD NOT CAUSE SOIL EROSION

SITE MANAGEMENT PROGRAM

DEMOLITION OF EXISTING RESIDENTIAL DWELLINGS. LOCATION OF WASTE MATERIAL STORE TO BE LOCATED AT THE FRONT OF EACH PROPERTY. ALL WASTE MATERIAL TO BE STORED IN SKIP **BINS FOR REMOVAL.**


STAGE 1:

EARLY CONNECTION TO STORMWATER

<u>STAGE 2:</u> FOLLOWING THE FORMATION OF THE BASEMENT AREA , THE BASEMENT AREA IS TO BE USED FOR MATERIAL STORE AND STOCKPILE AREAS.

Version: 4, Version Date: 29/07/2020

<u>STAGE 3:</u> AFTER COMPLETION OF THE GROUND FLOOR CONCRETE SLAB, THE PROPOSED SLAB IS NOW TO BE USED AS MATERIAL AND STOCK PILE STORE.

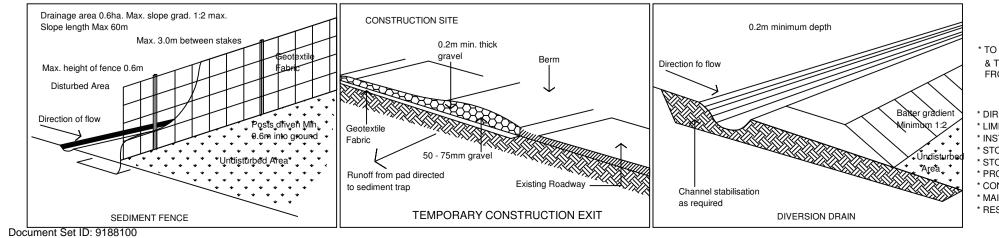


SEDIMENT CONTROL POLICY OBJECTIVE * TO MINIMISE DISTURBANCE TO SOIL AND VEGETATION ON THE SITE & TO PREVENT EROSION AND THE EXPORT OF SEDIMENT FROM THE SITE GENERAL NOTES:

* DIRECT CLEAN UPHILL WATER AROUND THE BUILDING SITE * LIMIT ACCESS TO ONE POINT AND STABILISE * INSTALL SEDIMENT FENCES BELOW THE SITE * STOCKPILE AND PROTECT STRIPPED TOPSOIL * STORE MATERIALS WITHIN THE SEDIMENT FENCE ENVELOPE * PROVIDE A PROTECTED WASHOUT AREA * CONNECT STORMWATER BEFORE ROOF IS LAID * MAINTAIN CONTROLS * RESPREAD TOPSOIL AND STABILISE SITE

HOPE

STREET

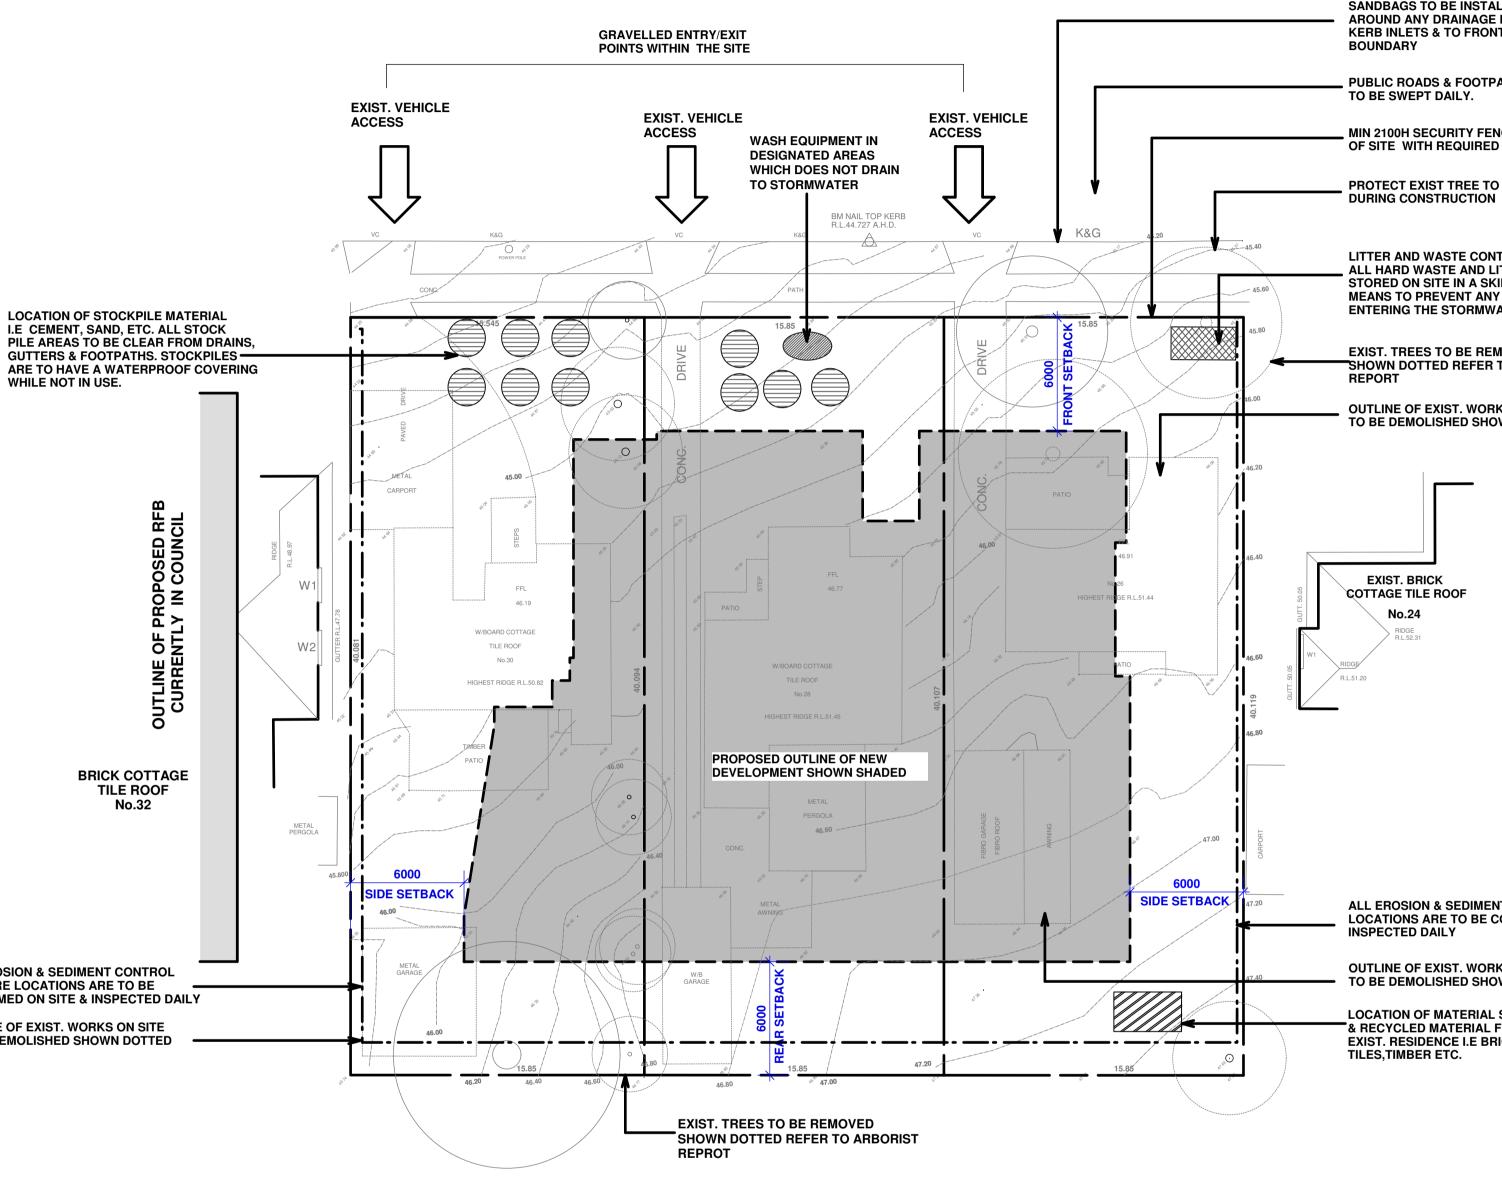

SITE MANAGEMENT PLAN

01.06.20	A	DA ISSUE	DO NOT SCALE FROM DRAWING, USE WRITTEN DIMENSIONS ONLY BUILDER TO CHECK AND VERIFY ALL DIMENSIONS & LEVELS PRIOR TO COMMENCEMENT OF WORK. TI IS THE OWNERS RESPONSIBILITY TO ENSURE THAT THE ENGINEER HAS INVESTIGATED SUBSOIL CONDITIONS & DESIGNED ALL STRUCTURAL ELEMENTS TO SUIT. THE DESIGNS & DETAILS CONTAINED ON THIS DRAWING ARE SUPPLIED IN CONFIDENCE & ARE NOT TO BE USED FOR ANY OTHER PURPOSE EXCEPT THAT AUTHORISED BY
DATE	REV	AMENDMENTS	C COPYRIGHT BUILDING DESIGN & TECHNOLOGY.



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- SANDBAGS TO BE INSTALLED AROUND ANY DRAINAGE PITS, **KERB INLETS & TO FRONT**
- **PUBLIC ROADS & FOOTPATHS**
- MIN 2100H SECURITY FENCING TO PERIMTER OF SITE WITH REQUIRED SIGNAGE
- PROTECT EXIST TREE TO REMAIN
- LITTER AND WASTE CONTROL. ALL HARD WASTE AND LITTER MUST BE STORED ON SITE IN A SKIP BIN OR OTHER MEANS TO PREVENT ANY MATERIAL FROM ENTERING THE STORMWATER SYSTEM
- EXIST. TREES TO BE REMOVED SHOWN DOTTED REFER TO ARBORIST
- OUTLINE OF EXIST. WORKS ON SITE TO BE DEMOLISHED SHOWN DOTTED

- ALL EROSION & SEDIMENT CONTROL MEASURE LOCATIONS ARE TO BE CONFIRMED ON SITE & INSPECTED DAILY
- OUTLINE OF EXIST. WORKS ON SITE TO BE DEMOLISHED SHOWN DOTTED
- LOCATION OF MATERIAL STORE & RECYCLED MATERIAL FROM EXIST. RESIDENCE I.E BRICKS, TILES, TIMBER ETC.

PROJECT :	PROPOSED UNIT DEV AT 26-30 HOPE ST PE		TED		T.N
TITLE:	SITE MANAGEMENT PLA	N			
SCALE :	A1 @ 1:200	DRAWN :	MM		
PROJECT DA	TE : FEB 2020	CHECKED :	ZH	REV : A	
PROJECT No.	201727A	DWG No.	DA1.16		-

