
DRAWING REGISTER					
DRAWING NUMBER	DRAWING NAME	DRAWING ISSUE DATE	CURRENT REVISION		
DA 01/03	SITE ANALYSIS, SUBDIVISION PLAN & BASIX	FEB 2014	R01 R01		
DA 02/03	FLOOR PLANS, ELEVATIONS & SECTION	FEB 2014	R01		
DA 03/03	SHADOW ANALYSIS	FEB 2014			

CONTROL	REQUIRED/PERMITTED	PROVIDED	COMPLIANCE
Minimum Allotment Size	450 m²	453m²	Yes
Site Coverage	max 50%	41%	Yes
Private Open Space	min 20% of Lot Area = 90.6m ²	69+69m ² = 138m ²	Yes
Setbacks (min/m) - Primary Front (Building)	4.5m	4.5m	Yes
- Side and Rear (Main Dwelling)	0.9m	1m	
- Corner Lots (Secondary Street Frontage)	3m	3m	
Maximum no. of Storeys	2	2	Yes

SITE BOUNDARY	
WIND DIRECTION	
PROPOSED BUILDING	
B NEIGHBOURHOOD PROPERTIES	
PRIVATE OPEN SPACE	
VEHICULAR ACCESS	
▼ VEHICULAR ACCESS	
TREES TO BE RETAINED	

TREES TO BE REMOVED

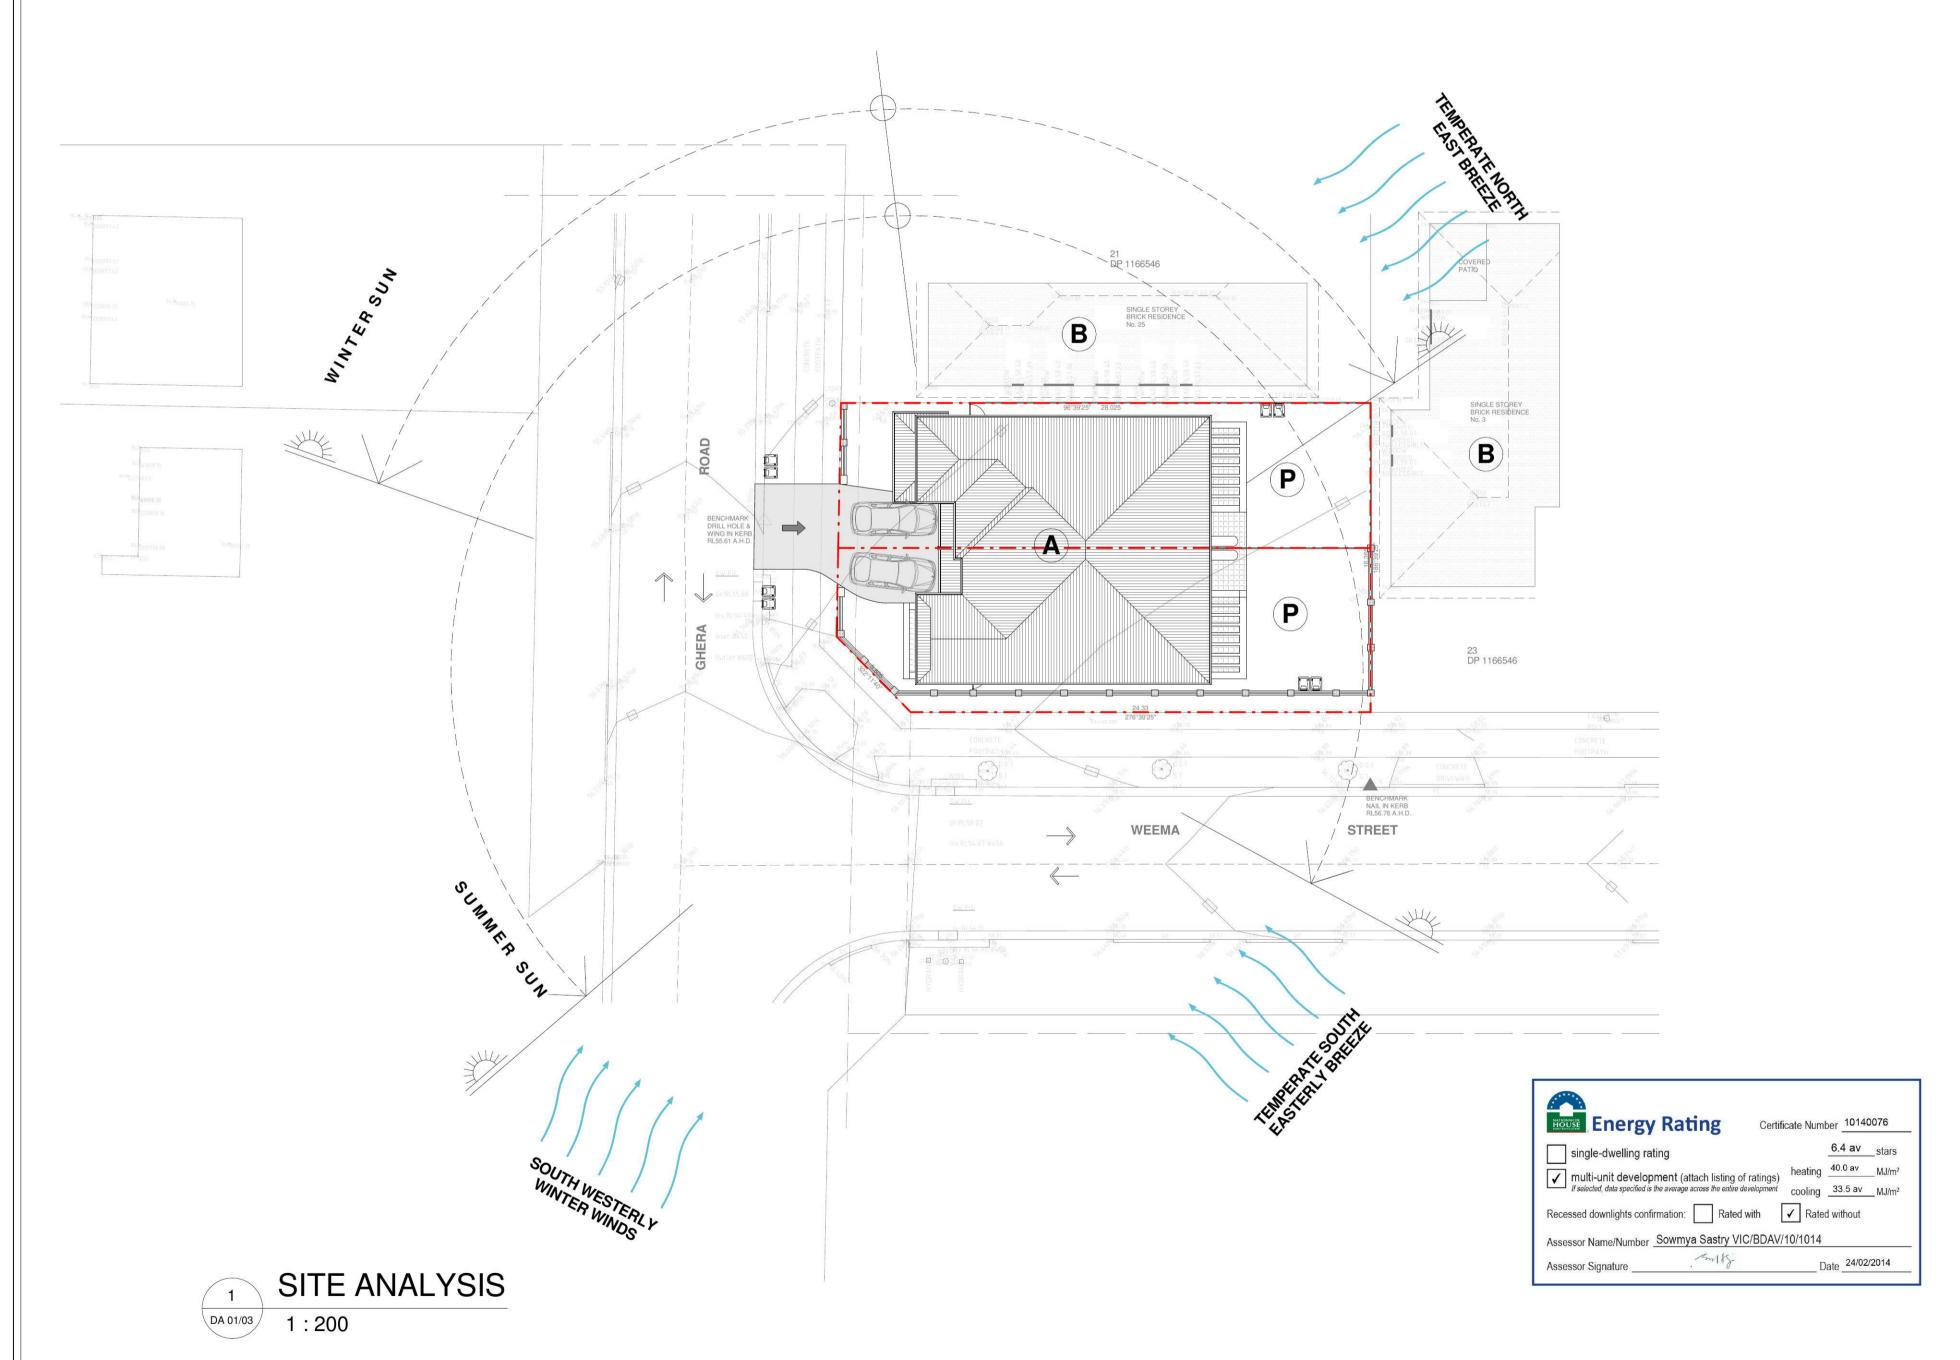





BASIX SPECIFICATIONS


specifications refer to table.

Water Commitments	
Showerheads:	3 Star (.4.5 but<=6 L/min) all dwellings
Toilets	5 Star flushing system all dwellings
Kitchen and Bathroom Taps	5 Star all dwellings
Water Tank	N/A
Energy Commitments	
Hot Water System	3 Star gas instantaneous
Bathroom, Kitchen and Laundry Ventilation	Individual fan ducted to façade or roof
Air Conditioning (Heating & Cooling)	2.5 Star 1-phase air conditioning (Cooling) 3.5 Star 1-phase air conditioning (Heating)
Cooktop and Oven	Gas cooktop and electric oven all dwellings

THERMAL PERFORMANCE SPECIFICATIONS

Assessor# BDAV 10/1	014 Certificate # 1014007	76 Date of Issue: 24/02/2014		
Project: 23 GHERA RO CADDENS NSW 2747 Total Dwellings: 2	AD			
	uda a	Eules and four without downsors and		
Terrain Category: Subu Roof Ventilation: Unve		Exhaust fans without dampers: no		
Subfloor: Slab on Grou		Ventilated skylights: no		
		Open fire, unflued gas heaters: no Vented downlights: no		
Living area open to ent Seals to windows and		Wall and ceiling vents: yes Details		
Building Elements	Material			
S. M. T.				
External Walls	Brick Veneer	R2 Bulk Insulation		
	Double Brick partition wall	No Insulation		
	FC sheet cladding	n/a		
Internal Walls	Plasterboard on studs	-		
Ceiling	Plasterboard	R2 Bulk Insulation to ceilings with roo		
Roof	Metal – Medium Color (Refer to drawings for locations)	R 1.5 Bulk Insulation with foil facing		
	Suspended Slab	n/a		
Floors	Concrete slab on ground	-		
200 P 200 D 200	Suspended slab to first floor			
Windows/ Skylights	Improved Aluminium frame	U value 6.35or less		
	Single glazed throughout	SHGC 0.77 +/- 10%		

Lighting: These dwellings have been rated without downlights. If downlights are to be provided, the plans need to be re-assessed. Refer to individual dwelling ratings for heating and cooling loads.

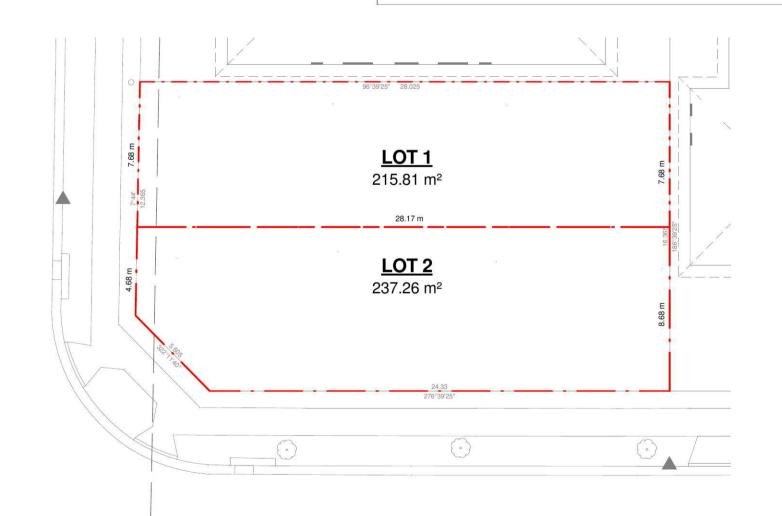

Unit Numbers



FEB 2014



GENERAL NOTES

1.ALL DIMENSIONS AND FLOOR AREAS TO BE VERIFIED BUILDIER PRIOR TO THE COMMENCEMENT OF ANY BUILD WORK.
2.ANY DESCREPANCIESW ARE TO BE CONFIRMEND BY THE DESIGNER.
3.LEVELS SHOWN ARE APPROXIMATE UNLESS ACCOMPANIED BY REDUCED LEVELS BY A REGISTERED

4.FIGURED DIMENSIONS ARE TO BE TAKEN IN PREFERENCE TO SCALING.
5.ALL BOUNDARY CLEARANCE MUST BE VERIFIED BY THE SURVEYOR PRIOR TO THE COMMENCEMENT OF ANY BUILDING WORK.
6.WHERE ENGINEERING OR HYDRAULIC DRAWINGS ARE REQUIRED, SUCH MUST TAKE PREFERENCE TO THIS DRAWING.
7.STORMWATER TO BE CONNECTED AND DISCHARGED TO COUNCIL'S REQUIREMENTS AND TO AS 3500.3
8. ALL SERVICES TO BE LOCATED AND VERIFIED BY THE BUILDER WITH THE RELEVANT AUTHORITIES PRIOR TO THE COMMENCEMNET OF ANY BUILDING.

ISS	UED FOR:						
	COUNCIL MEETING						
/	DEVELOPMENT APPLICATION						
	SECTION 96						
	CONSTRUCTION ONLY	R01	ISSUED FOR DEVELOPMENT APPLICATION	21/02/2014	TS/PI	CK	
		ISSUE	AMENDMENTS	DATE	DRAWN	CHKD	

TRUE NORTH

SCALE 1:200 @A1


DRAWING NUMBER:
DA 01/03


DRAWING TITLE:
SITE ANALYSIS, SUBDIVISION
PLAN & BASIX


DATE

PROJECT

LOT 22 IN DP 1166456 23 GHERA ROAD CADDENS

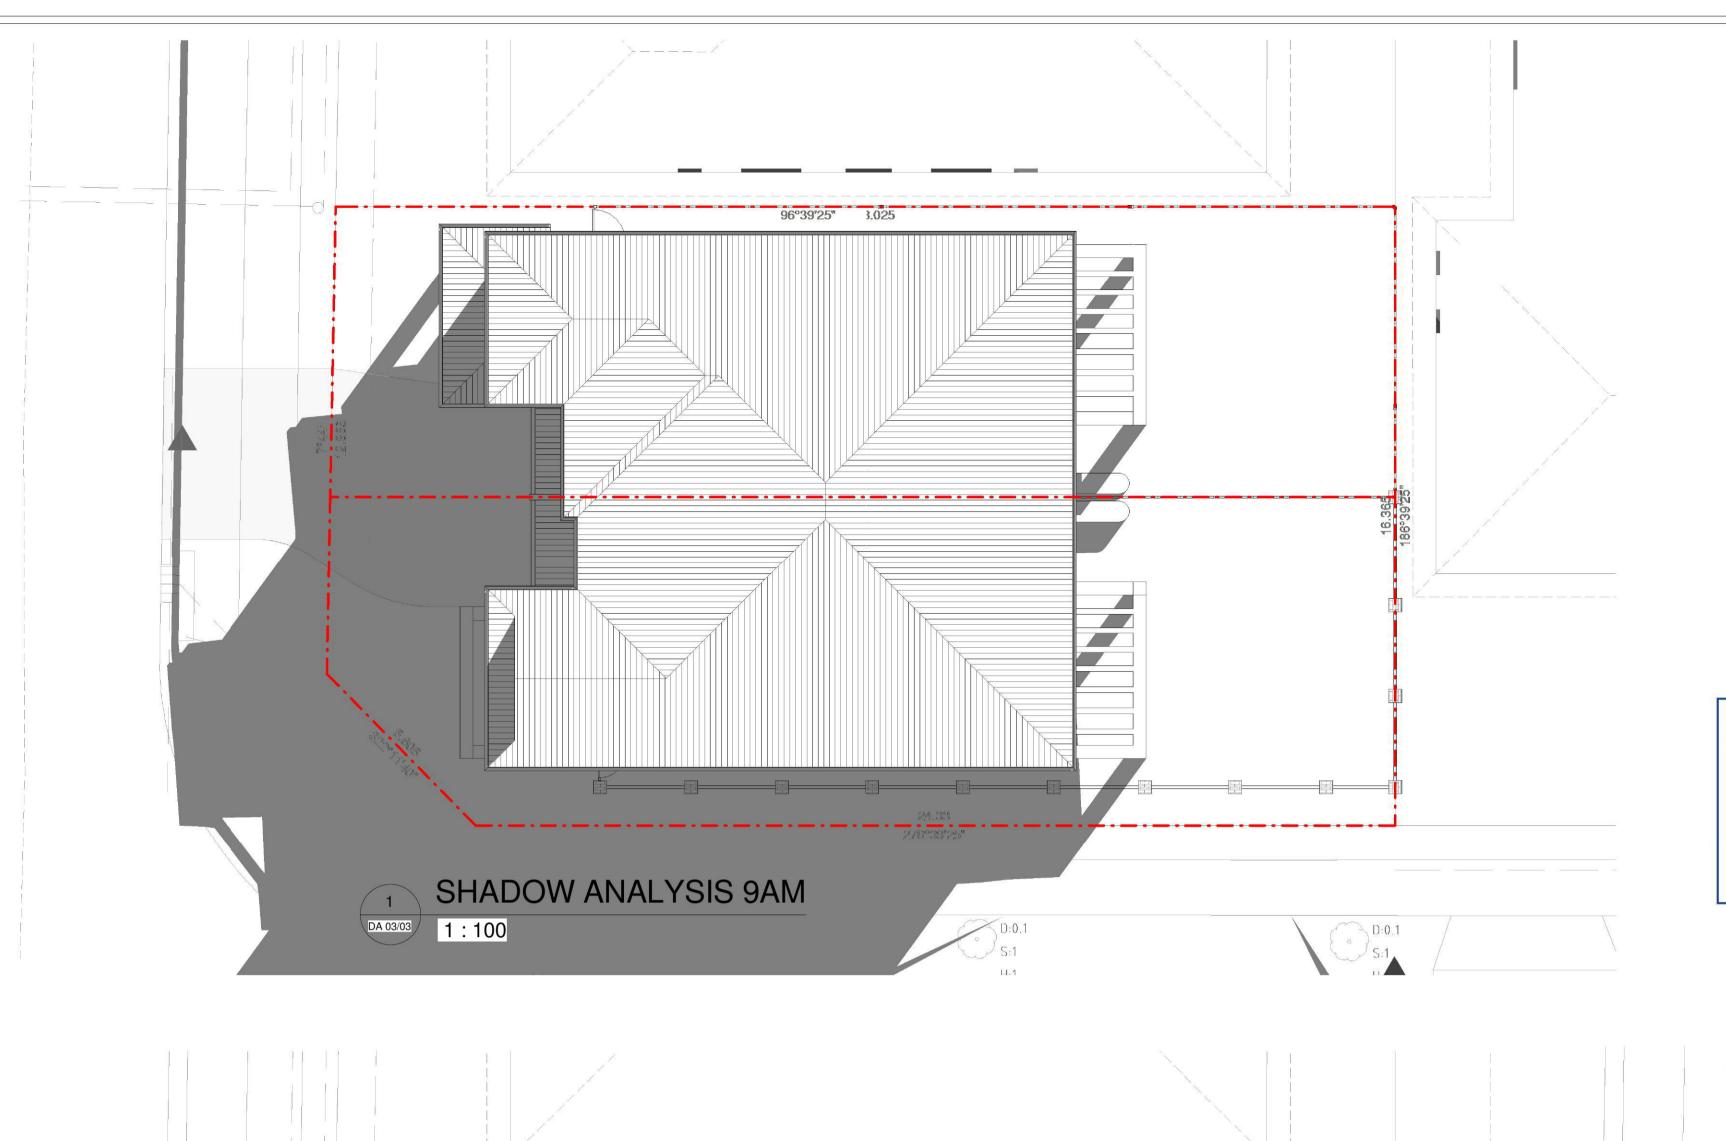

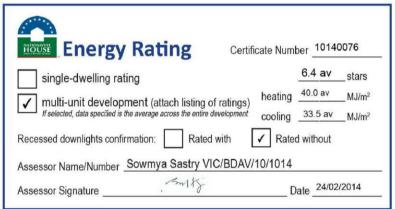

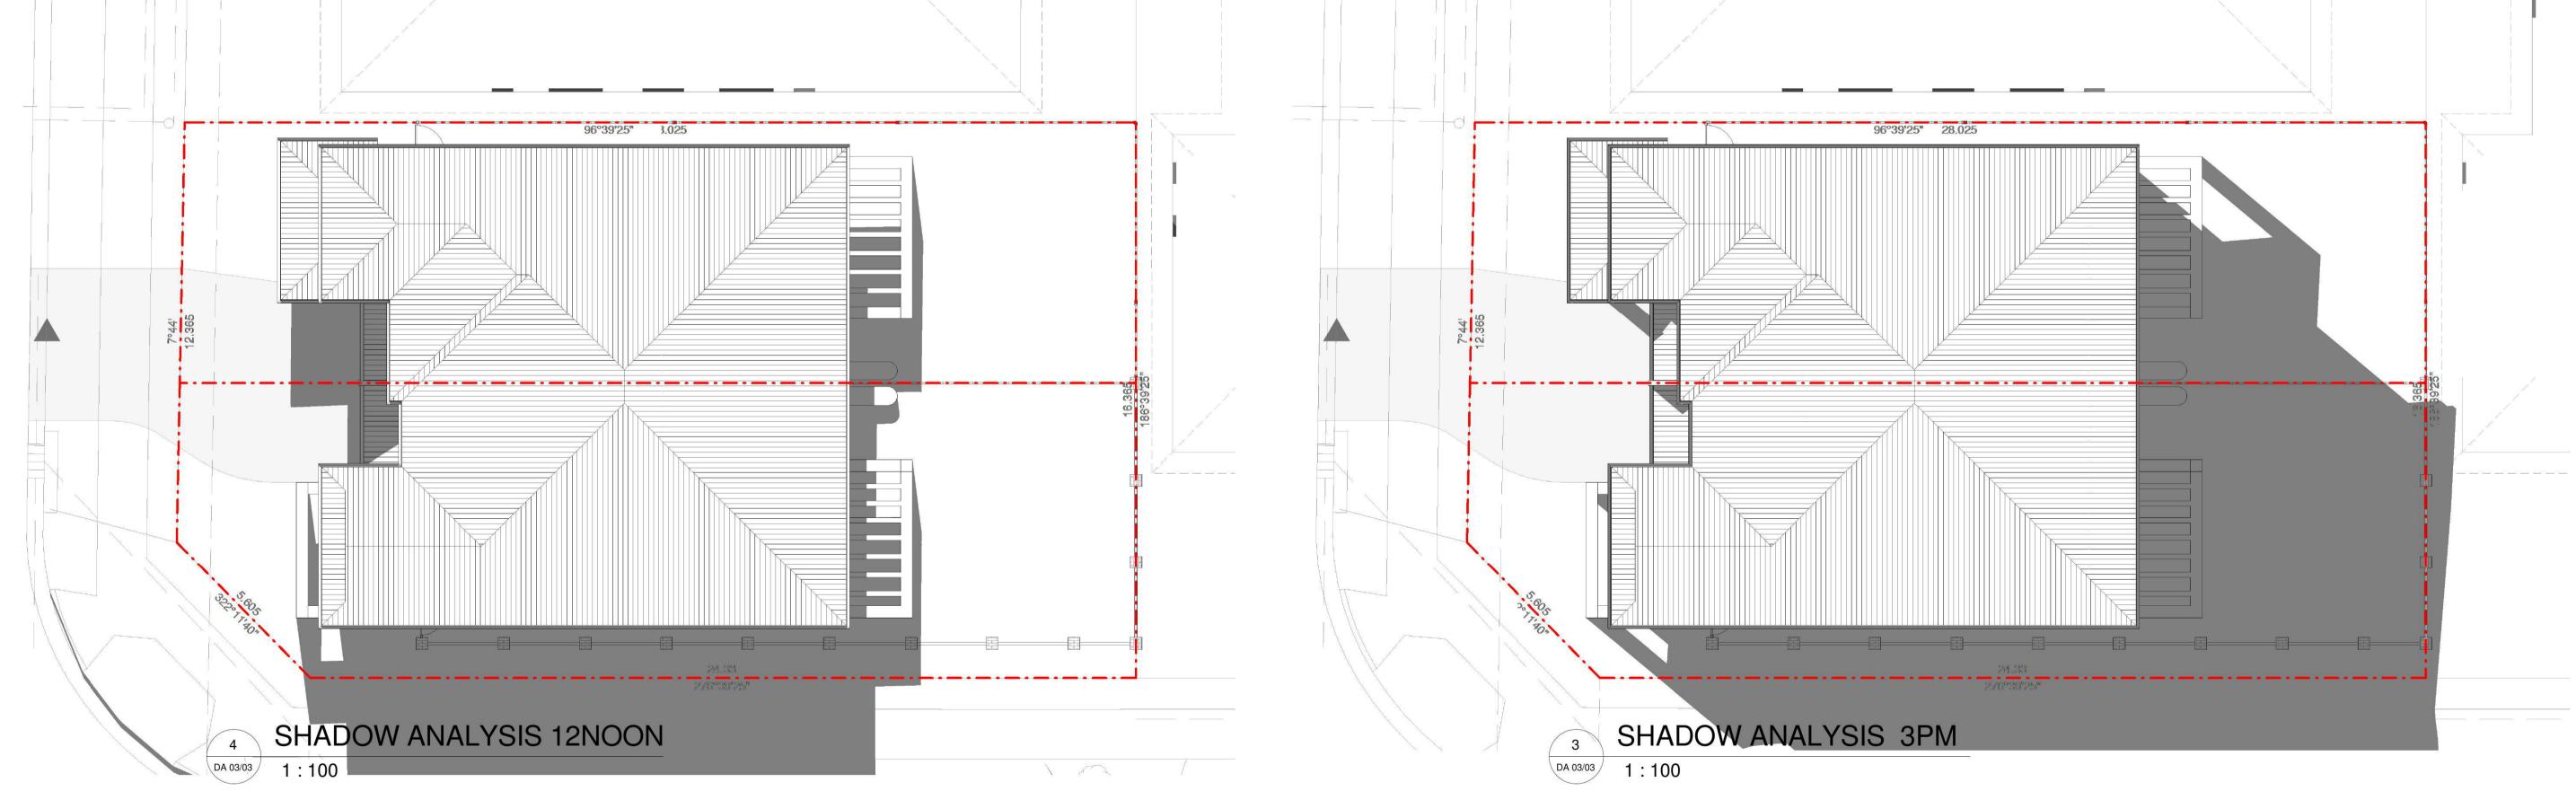



GENERAL NOTES

1.ALL DIMENSIONS AND FLOOR AREAS TO BE VERIFIED BUILDIER PRIOR TO THE COMMENCEMENT OF ANY BUILDING WORK.
2.ANY DESCREPANCIESW ARE TO BE CONFIRMEND BY THE DESIGNER.
3.LEVELS SHOWN ARE APPROXIMATE UNLESS ACCOMPANIED BY REDUCED LEVELS BY A REGISTERED

4.FIGURED DIMENSIONS ARE TO BE TAKEN IN PREFERENCE TO SCALING.
5.ALL BOUNDARY CLEARANCE MUST BE VERIFIED BY THE SURVEYOR PRIOR TO THE COMMENCEMENT OF ANY BUILDING WORK.
6.WHERE ENGINEERING OR HYDRAULIC DRAWINGS ARE REQUIRED, SUCH MUST TAKE PREFERENCE TO THIS DRAWING.
7.STORMWATER TO BE CONNECTED AND DISCHARGED TO COUNCIL'S REQUIREMENTS AND TO AS 3500.3
8. ALL SERVICES TO BE LOCATED AND VERIFIED BY THE BUILDER WITH THE RELEVANT AUTHORITIES PRIOR TO THE COMMENCEMNET OF ANY BUILDING.

ISSUED FOR:				8	
COUNCIL MEETING					
DEVELOPMENT APPLICATION	·				
SECTION 96					
CONSTRUCTION ONLY	R01	ISSUED FOR DEVELOPMENT APPLICATION	21/02/2014	TS/PI	CK
	ISSUE	AMENDMENTS	DATE	DRAWN	CHKD

TRUE NORTH DR
DR

SCALE 1:100@A1

DRAWING NUMBER:
DA 03/03
DRAWING TITLE:
SHADOW ANALYSIS

DATE

FEB 2014

ISSUE PROJECT

LOT 22 IN DP 1166456 23 GHERA ROAD CADDENS