
DEVELOPMENT APPLICATION

PROPOSED UNIT DEVELOPMENT

LOT 34-36, DP 31239 26-30 HOPE STREET, PENRITH NSW 2750

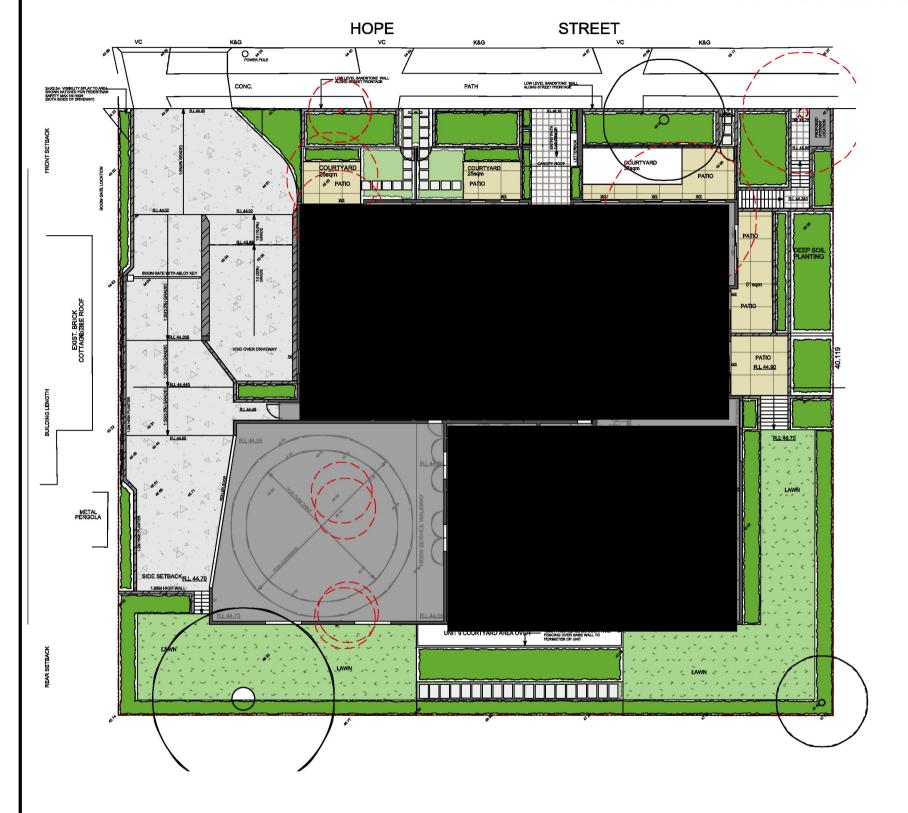

PLANTING SCHEDULE

Latin Name	Common Name	Quantity	Pot Size	Spread	Height
Acmena smithii 'Hot Flush'	Lillypilly	15	15lt	1000	2000
Alcantarea imperialis 'Rubra'	Bromeliard	11	300mm	1200	10000
Aloe barberae	Tree Aloe	3	45LT	1100	2500
Archontophoenix cunninghamiana	Bangalow Palm	4	25lt	5000	10000
Bambusa textilis 'Gracilis'	Slender Weavers	13	35lt	1500	6000
Callistemon viminalis	Bottlebrush	4	25LT	4000	6000
Carpobrotus glaucescens	Pigface	29	2.5LT	600	600
Casuarina glauca	Cousin It	9	300MM	500	2000
Cordyline terminalis 'Rubra'	Red Ti	24	150mm	1000	2000
Crassula 'Max Cook'	Crassula	4	200mm	1000	1000
Crassula ovata 'Blue Bird'	Crassula	10	200mm	1000	1000
Dichondra repens	Kidney Weed	37	5lt	1000	100
Doryanthes excelsa	Gymea Lily	3	15lt	1500	1500
Dypsis lutescens	Golden Cane Palm	12	300mm	2500	10000
Elaeocarpus eumundi	Quandong	21	250mm	2500	6000
Glochidion ferdinandi	Cheese Tree	2	25LT	4500	8000
Hibbertia scandens	Climbing Guinea Flower	34	tube	1000	350
Howea forsteriana	Kentia Palm	2	45lt	3000	15000
Lagerstroemia 'Natchez'	White Crepe Myrtle	4	75lt	3000	6000
Lomandra 'Tanika'	Dwarf Lomandra	90	5lt	500	500
Metrosideros excelsa	NZ Xmas Bush	3	45LT	1200	3000
Philodrendron 'Rojo Congo'	Philodendron	46	200mm	750	2500
Philodrendron 'Xanadu'	Dwarf Philodendron	94	140mm	750	1000
Phormium 'Yellow Wave'	Dwarf NZ Flax	15	5lt	750	750
Rhaphiolepis 'Oriental Pearl'	Indian Hawthorn	23	200mm	1000	1000
Sansevieria laurentii	Mother in Law Tongue	32	200mm	750	900
Senecio serpens	Chalk Sticks	19	5lt	750	300
Syzygium australe 'Pinnacle'	Lillypilly	39	25lt	1500	2500
Trachelospermum jasminoidies 'Varieg	Variegated Star Jasmine	39	200mm	800	600
Tristianiopsis laurina	Water Gum	7	25lt	4000	7000
Viola hederaceae	Native Violets	85	tube	400	300
Yucca elephantipes	Yucca	15	25lt	1000	2000

SITE LOCATION



CONTOUR LANDSCAPE ARCHITECTURE PO Box 698 MONA VALE NSW 1660 Tel: 0434 500 705 - AIDLM <u>PROJECT</u>

Proposed Unit Development

<u>SITE</u>

26-30 Hope Street, Penrith, NSW 2750 NOTES

comply with building code of australia and all relevant australian standards all works shall be in accordance with development application and construction certificate conditions of consent all levels to all all levels to all relevant productions of consent all levels to all relevant productions of consent all levels to all relevant productions of consent all levels to all relevant productions of australia and all relevant australia and all relevant all levels to all relevant productions of australia and all relevant australian shall be consented to a survey information relating to existing site data

refer to survey information relating to verify all dimensions prior to works do not scale from drawings use figured dimentions in preference

all descrepancies to landscape architect for determination

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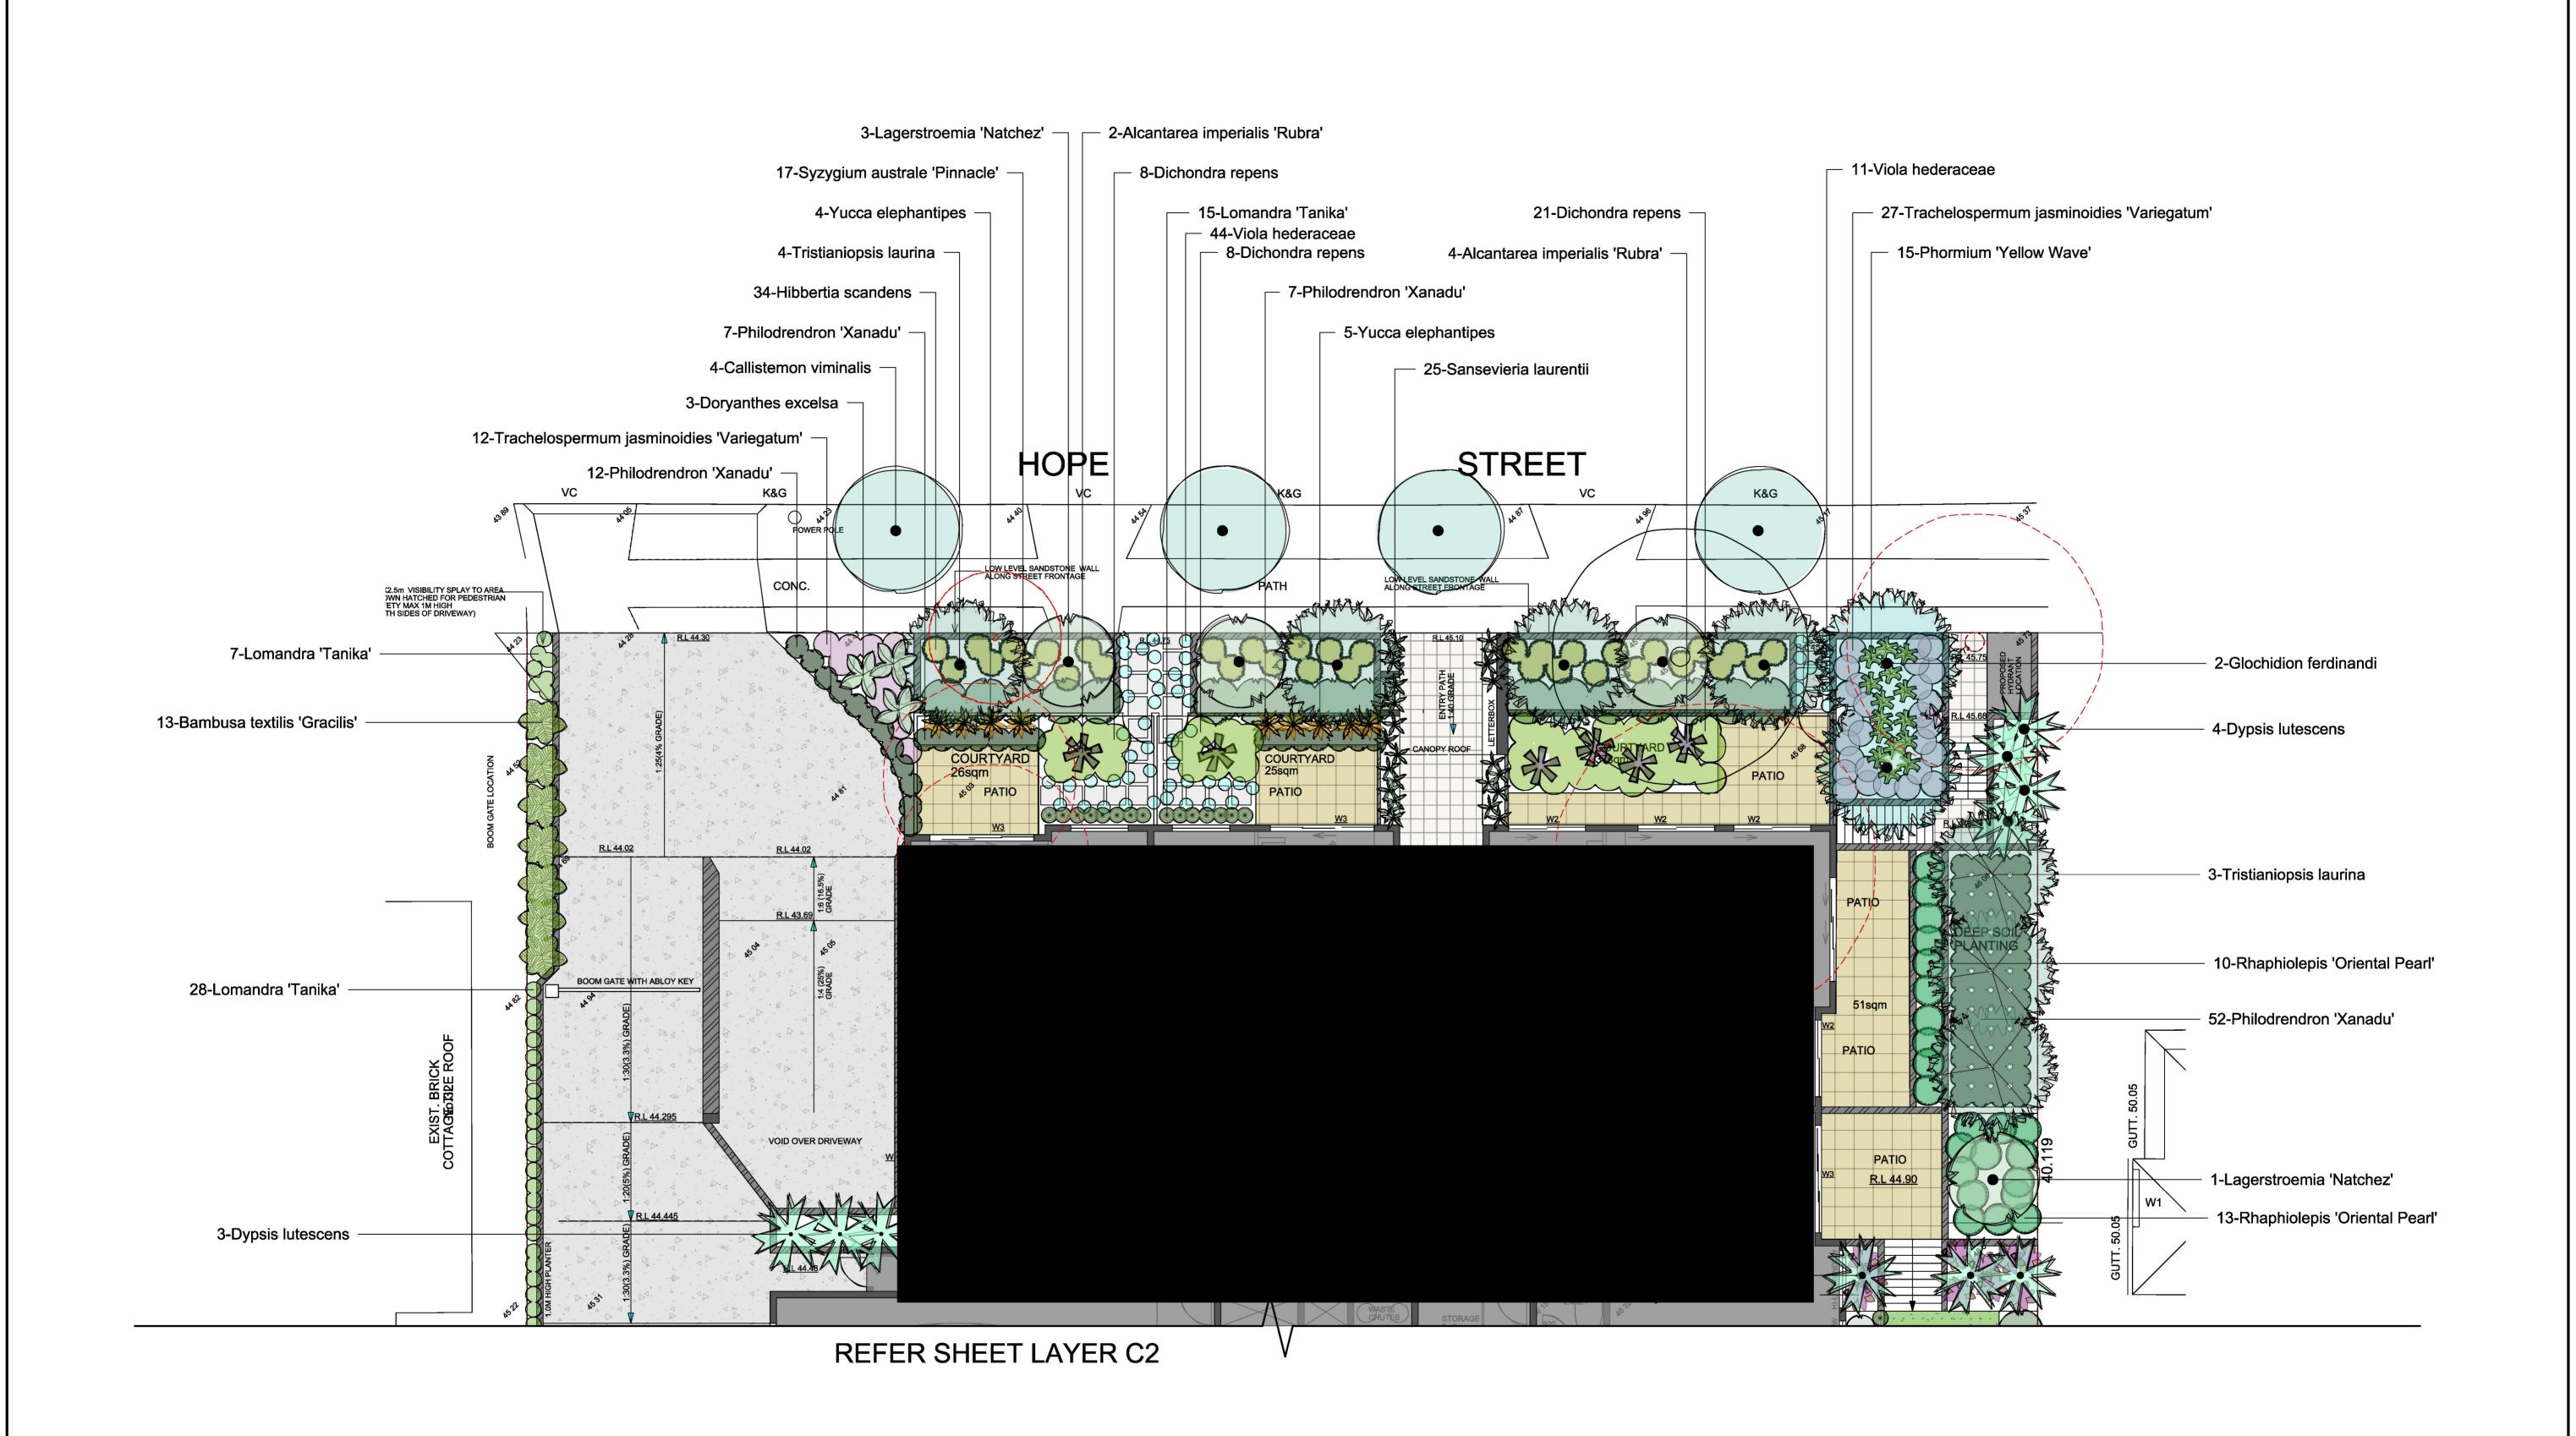
ter landscape architects.


DATE REV. ISSUE 26/05/20 A
 DATE:
 26/05/2020
 DRAWING SITE PLAN

 SCALE:
 1:250 @ A3
 DRAWING NO: CO_BDT

 DRAWN:
 LH
 REV: A





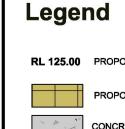

RL 125.00 PROPOSED LEVEL PROPOSED PAVED AREA CONCRETE PROPOSED LAWN AREA

PROPOSED TIMBER DECK

PLAN ISSUE

26/05/20 A


CONTOUR PO Box 698 MONA VALE NSW 1660

Tel: 0434 500 705 - AIDLM

PROJECT Proposed Unit Development 26-30 Hope Street, Penrith, NSW 2750

comply with building code of australia and all relevant australian standards all works shall be in accordence with development application and refer to survey information relating to existing site data verify all dimensions prior to works do not scale from drawings use figured dimentions in preference to scaling refer all descrepancies to landscape architect for determination this drawing is copyright and must not be retained, copied, used or reproduced in any way without prior written permission of contour landscape architects.

DRAWING DATE: 26/05/2020 **GROUND FLOOR LANDSCAPE** PLAN (SHEET 1) 1:100 @ A1 SCALE: DRAWING NO: C1_BDT DRAWN: LH

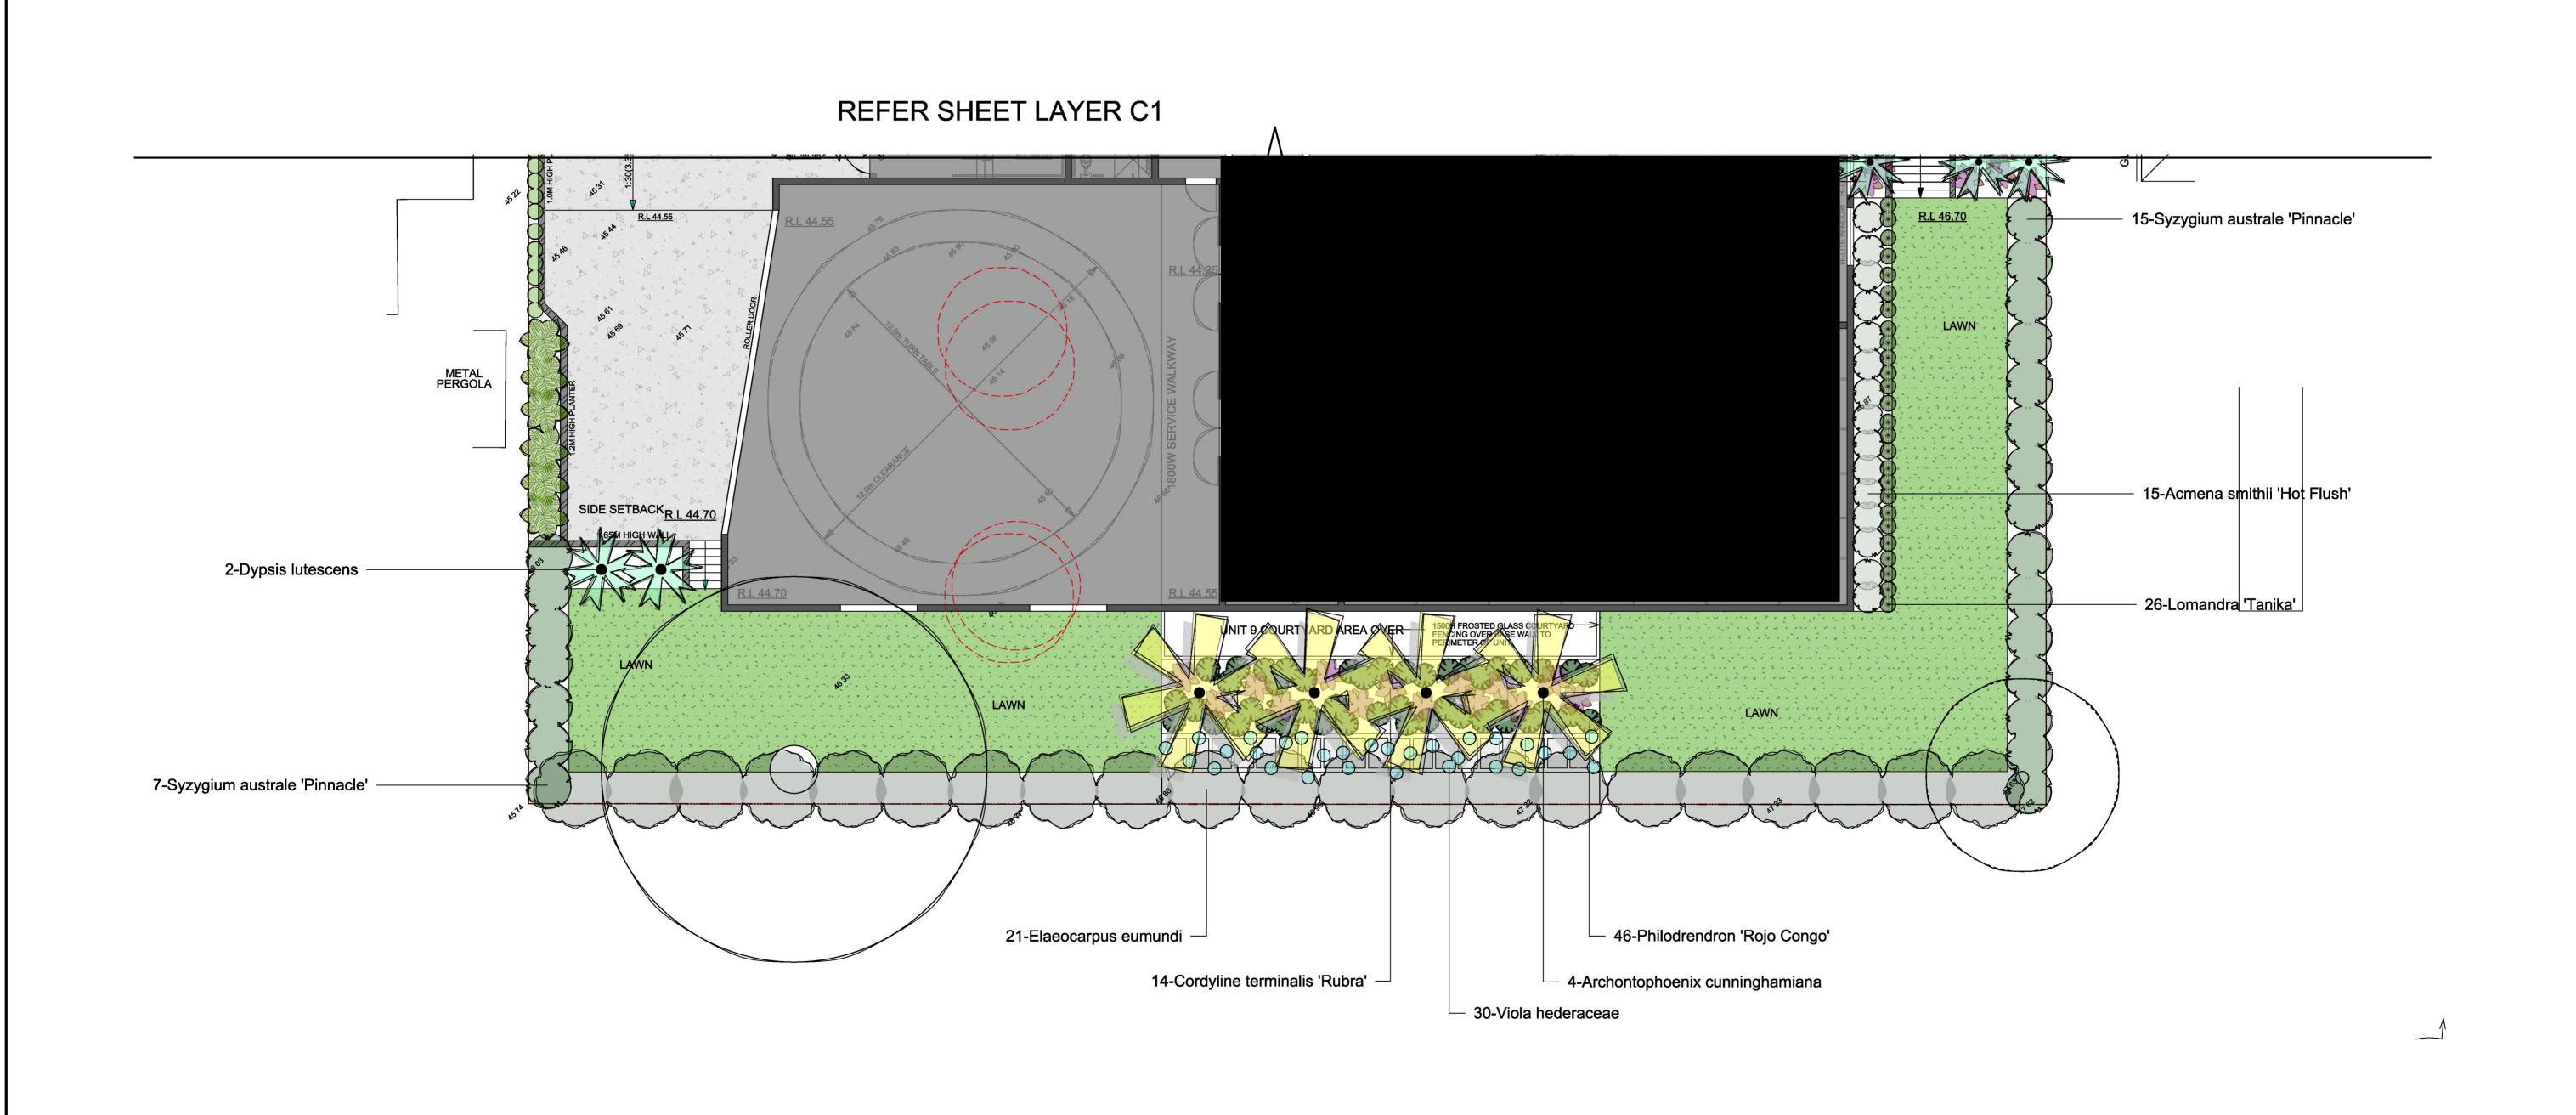

PROJECT

Proposed Unit Development

26-30 Hope Street, Penrith, NSW 2750

CONTOUR

PO Box 698 MONA VALE NSW 1660 Tel: 0434 500 705 - AIDLM

PLAN ISSUE

26/05/20 A

NOTES

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DRAWING

DRAWING NO: C2_BDT

PLAN (SHEET 2)

GROUNDFLOOR LANDSCAPE

DATE:

SCALE:

DRAWN:

26/05/2020

1:100 @ A1

LH

Legend


RL 125.00 PROPOSED LEVEL

CONCRETE

PROPOSED PAVED AREA

PROPOSED LAWN AREA

PROPOSED TIMBER DECK

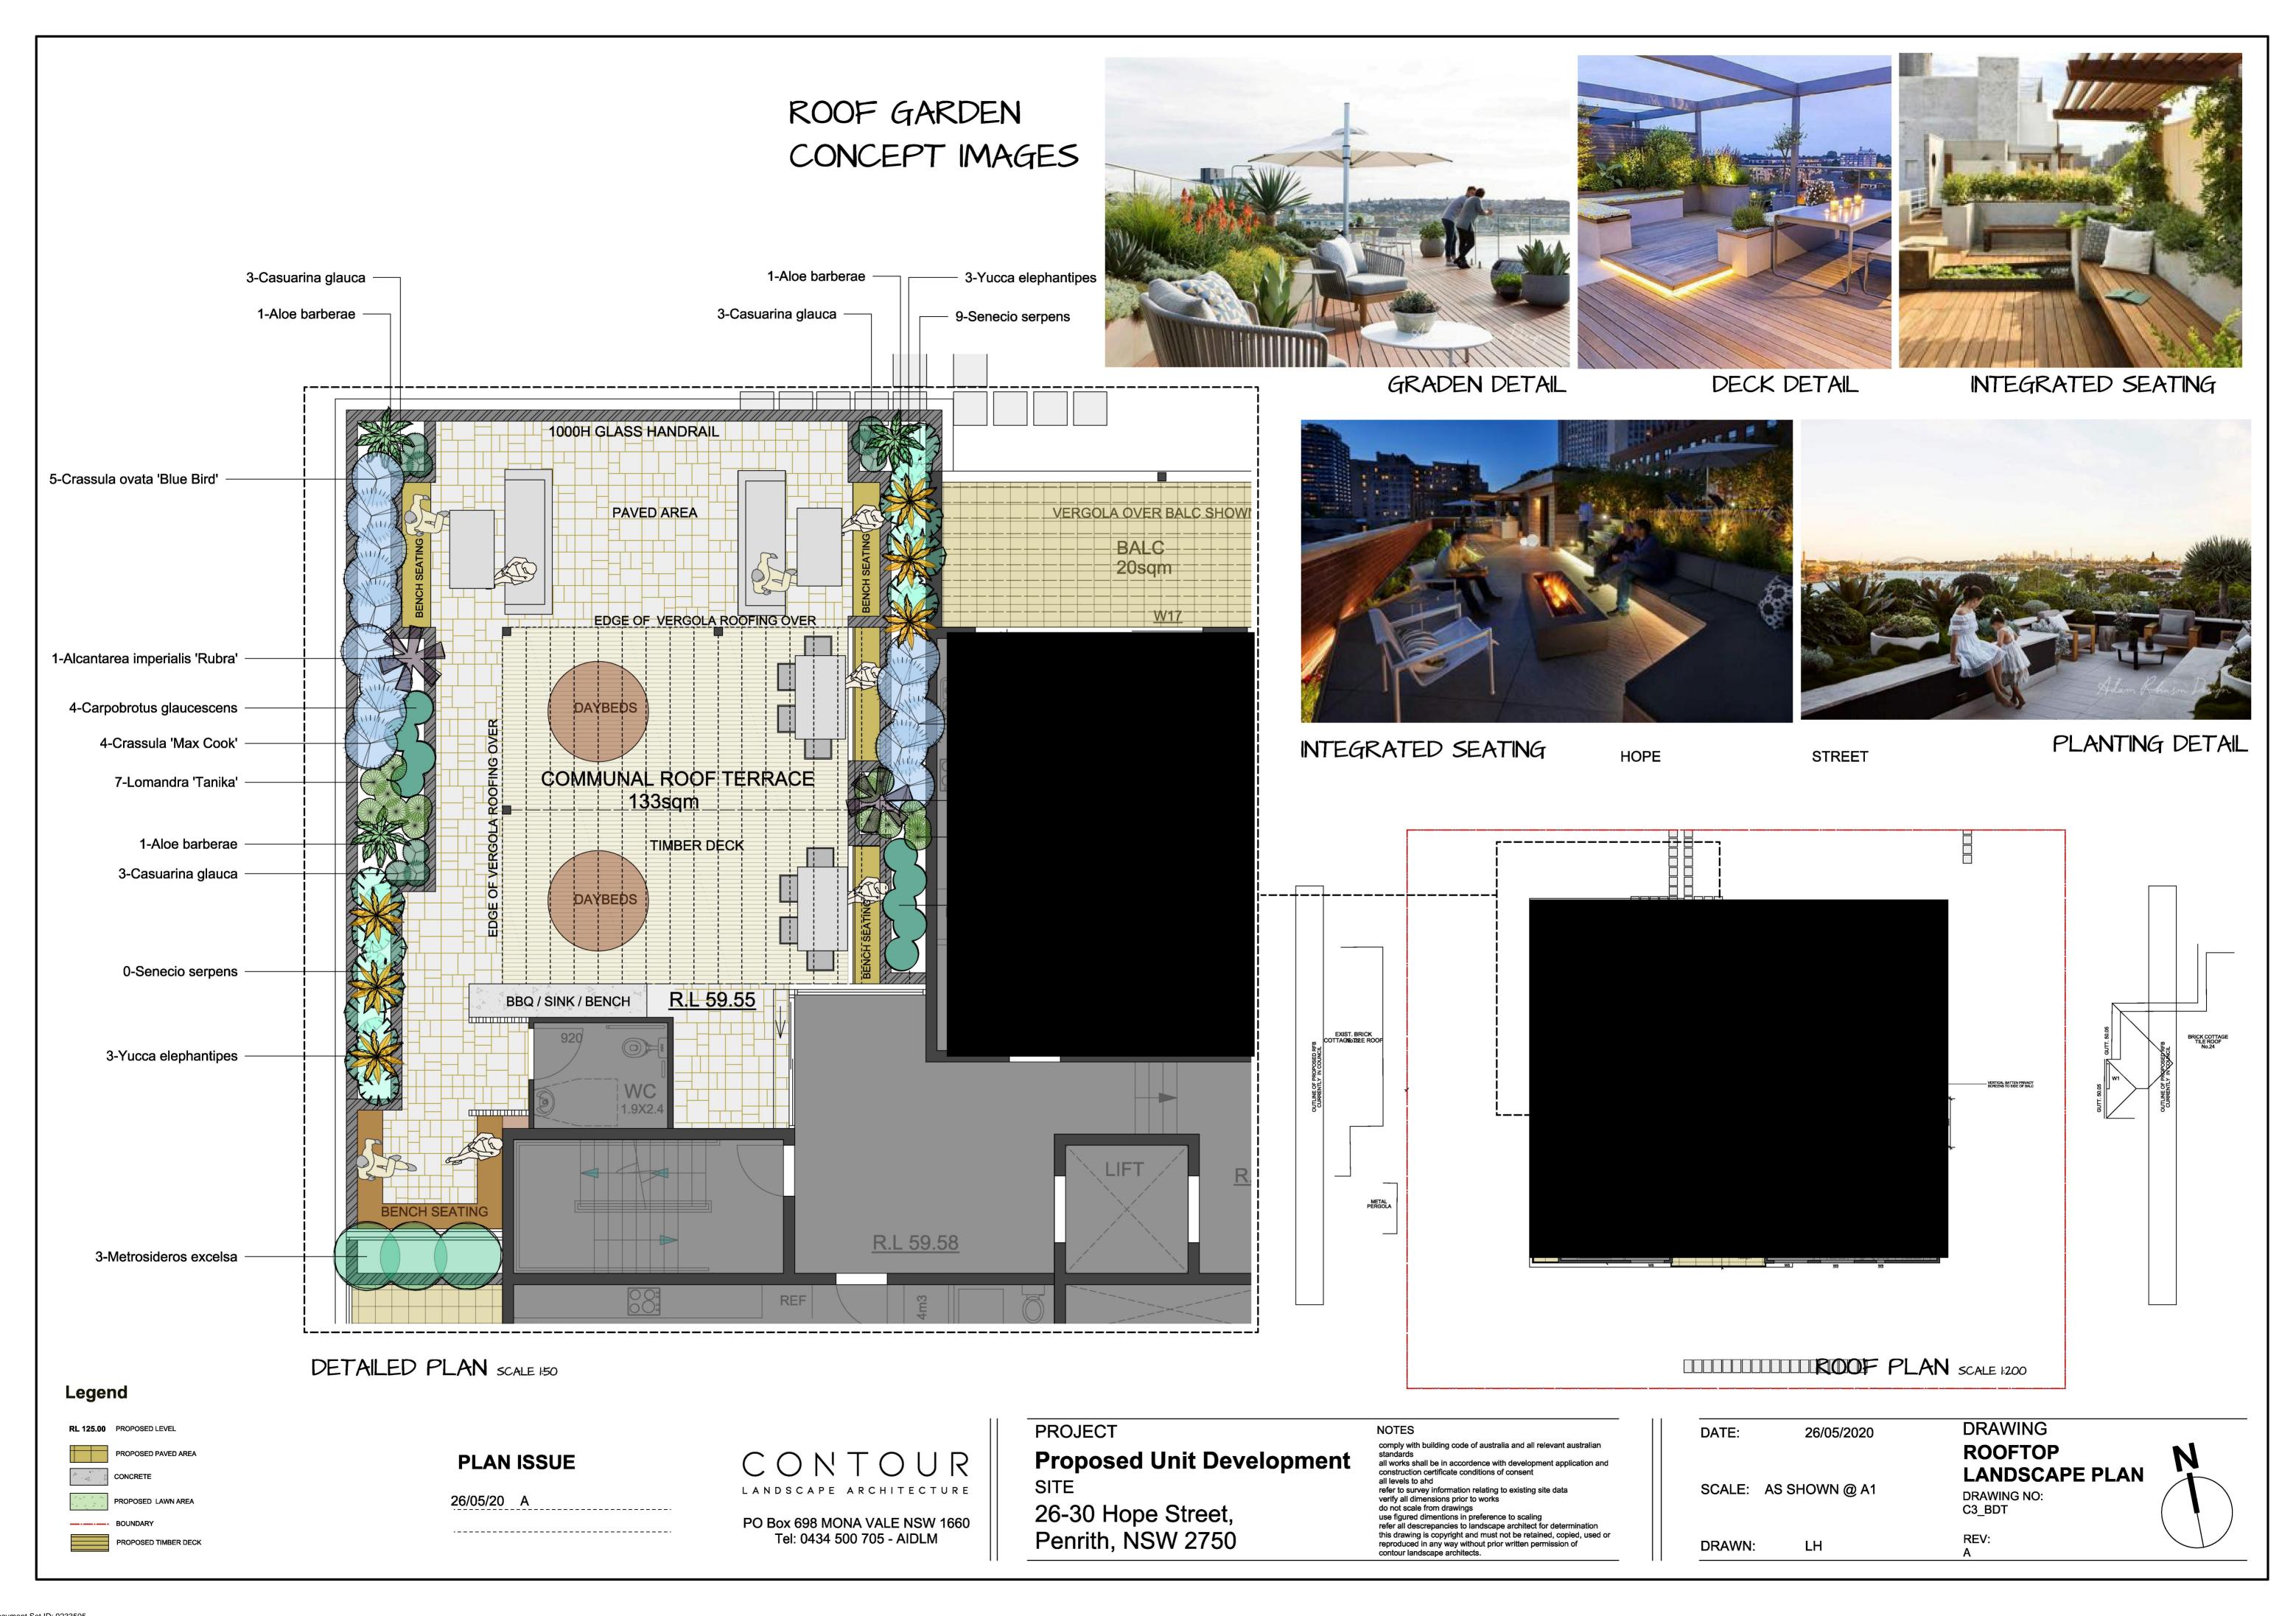

HOPE STREET PROPOSED GREEN WALL - REFER DETAILS ON DWD C5 VERTICAL BATTEN PRIVACY— SCREENS TO SIDE OF BALC BALC 15sqm BALC 23sqm BALC 18sqm - 20-Carpobrotus glau<mark>cescens</mark> - 3-Alcantarea imperia<mark>l</mark>is 'Rubra' 16-Philodrendron 'Xanadu' 1-Howea forsteriana BRICK COTTAGE TILE ROOF No.32 BRICK COTTAGE TILE ROOF No.24 COMMUNAL AREA BELOW R.L 46.70 VOID OVER TRUCK BAY AREA 47.20 TERRACE 42sqm 1500H FROSTED GLASS COURTYARD FENCING OVER BASE WALL TO PERIMETER OF UNIT _GATE TO COMMUNAL AREA COMMUNAL AREA COMMUNAL AREA COMMUNAL AREA BELOW NOTE: REFER PLANTING SCHEDULE ON DWG CO R.L 47.20 R.L 46.80 Legend DRAWING **PROJECT** RL 125.00 PROPOSED LEVEL DATE: 26/05/2020 comply with building code of australia and all relevant australian FIRST FLOOR LANDSCAPE CONTOUR standards
all works shall be in accordence with development application and
construction certificate conditions of consent
all levels to ahd PROPOSED PAVED AREA **Proposed Unit Development PLAN ISSUE PLAN** CONCRETE 1:100 @ A1 SCALE: refer to survey information relating to existing site data DRAWING NO: 26/05/20 A PROPOSED LAWN AREA verify all dimensions prior to works 26-30 Hope Street, Penrith, NSW 2750 C4_BDT do not scale from drawings use figured dimentions in preference to scaling refer all descrepancies to landscape architect for determination PO Box 698 MONA VALE NSW 1660 Tel: 0434 500 705 - AIDLM ---- BOUNDARY .---this drawing is copyright and must not be retained, copied, used or reproduced in any way without prior written permission of contour landscape architects. DRAWN: PROPOSED TIMBER DECK LH





PROPOSED PAVED AREA

PROPOSED LAWN AREA PROPOSED TIMBER DECK **PLAN ISSUE**

26/05/20 A

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PROJECT Proposed Unit Development

26-30 Hope Street, Penrith, NSW 2750

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DRAWING DATE: 26/05/2020 **SECOND & THIRD FLOOR** LANDSCAPE PLAN 1:100 @ A1 SCALE: DRAWING NO: C5_BDT DRAWN:

OPTLINE SPECIFICATION

ALL LANDSCAPE WORKS SHALL BE EXECUTED BY A COMPETENT LANDSCAPE CONTRACTOR EXPERIENCED IN HORTICULTURAL PRACTICE AND LANDSCAPE CONSTRUCTION. THE CONTRACTOR SHALL HOLD A CURRENT NSW STRUCTURAL LANDSCAPE LICENSE OR BE A MEMBER OF THE NSW LANDSCAPE CONTRACTORS ASSOCIATION, IRRIGATION WORKS SHALL BE EXECUTED BY A CONTRACTOR SUITABLY QUALIFIED AND LICENSED BY THE NSW DEPARTMENT OF FAIR TRADING FOR URBAN IRRIGATION.

THESE GENERAL LANDSCAPE SPECIFICATIONS SHALL BE READ IN CONJUNCTION WITH DETAILED SPECIFICATIONS PREPARED BY CONTOUR LANDSCAPE ARCHITECTURE, STRUCTURAL ENGINEERING PLANS, STORMWATER ENGINEER PLANS, ARBORICULTURAL IMPACT ASSESSMENT REPORT, D.A. CONSENT CONDITIONS

LANDSCAPE HARDWORKS DEMOLITION, BULK EARTHWORKS, RETAINING WALLS, STONE FACING, PLANTER BOXES, PAVING, DRAINAGE, WATERPROOFING, FENCING AND ALL SITE CONSTRUCTION INDICATED SHALL BE EXECUTED IN ACCORDANCE WITH LANDSCAPE ARCHITECTURAL, ARCHITECTURAL + ENGINEERING SPECIFICATIONS LANDSCAPE WORKS SHALL GENERALLY BE UNDERTAKEN IN ACCORDANCE WITH DA APPROVED PLANS AND CONSTRUCTION CERTIFICATE PLANS AND DETAILS AND SHALL BE COMPLIANT WITH:

AS4970-2009 Protection of trees on development sites AS 4970-2009/Amdt 1-2010 Protection of trees on development sites AS4373-2007 Pruning of amenity trees AS4419-2003 Soils for landscaping and garden use AS4454-2012 Composts, soil conditioners and mulches

AS3743-2003 Potting mixes

AS/NZ3500:2015 Plumbing and drainage Set

BEFORE LANDSCAPE WORK IS COMMENCED THE LANDSCAPE CONTRACTOR IS TO ESTABLISH THE POSITION OF ALL SERVICES LINES AND ENSURE TREE PLANTING IS CARRIED OUT AT LEAST 3 METRES AWAY FROM THESE SERVICES. SERVICES LIDS, VENTS AND HYDRANTS SHALL BE LEFT EXPOSED AND NOTE COVERED BY ANY LANDSCAPE FINISHES (TURNING, PAVING, GARDEN BEDS ETC.) FINISH ADJOINING SURFACES FLUSH WITH PIT LIDS

MANAGEMENT OF TREE PROTECTION

A QUALIFIED AND APPROVED ARBORIST IS TO BE CONTRACTED TO UNDERTAKE OR MANAGE THE INSTALLATION OF PROTECTIVE FENCING, AND TO UNDERTAKE SUCH MEASURES AS THEY DEEM APPROPRIATE TO PRESERVE THE SUBJECT TREES TO BE RETAINED. THE ARBORIST IS TO BE RETAINED FOR THE ENTIRE CONTRACT PERIOD TO UNDERTAKE ONGOING MANAGEMENT AND REVIEW OF THE TREES.

CARE SHALL BE TAKEN DURING THE ENTIRE PERIOD OF WORKS TO ENSURE NO DAMAGE TO ROOTS OR CANOPIES OF TREES TO BE RETAINED. NO STORING OF BUILDING MATERIALS, WASHING OF EQUIPMENT, DISPOSAL OF CHEMICALS, ETC. SHALL BE PERMITTED BENEATH CANOPY OF TREES TO BE RETAINED. NO EXCAVATION OR TRENCHING SHOULD OCCUR BENEATH CANOPIES EXCEPT FOR COUNCIL-APPROVED WORKS, ALL EXCAVATION BENEATH TREE CANOPIES SHALL BE UNDERTAKEN TO COUNCIL / PROJECT ARBORIST INSTRUCTIONS. PROJECT ARBORIST SHALL BE ADVISED AND ATTEND SITE IF TREE ROOTS GREATER THAN 50MM DIAMETER ARE ENCOUNTERED.

PREPARATION BY BUILDER

BUILDER SHALL REMOVE ALL EXISTING CONCRETE PATHWAYS, FENCES, FOOTINGS, WALLS, ETC. NOT NOTATED TO BE RETAINED AND COMPLETE ALL NECESSARY EXCAVATION WORK PRIOR TO COMMENCEMENT ON SITE BY LANDSCAPE CONTRACTOR. BUILDER SHALL ALSO INSTALL NEW RETAINING WALLS, KERBS, LAYBACK KERB, CROSSOVER, PATHWAYS, ETC. AND MAKE GOOD ALL EXISTING KERBS, GUTTERS, ETC. AS NECESSARY AND TO APPROVAL OF COUNCIL. BUILDER SHALL ENSURE THAT A MINIMUM 450MM OF TOPSOIL IN GARDEN AREA AND A MINIMUM 150MM OF TOPSOIL IN LAWN AREAS EXISTS. SHOULD REQUIRED DEPTHS NOT EXIST BUILDER SHALL CONTACT LANDSCAPE ARCHITECT AND ASK FOR INSTRUCTIONS PRIOR TO COMPLETION OF EXCAVATION WORKS.

ALL LEVELS AND SURFACE DRAINAGE SHALL BE DETERMINED BY OTHERS AND APPROVED ON SITE BY LANDSCAPE CONTRACTOR

SOIL PREPARATION + PLANTING SOILS

CULTIVATE TO A DEPTH OF 300MM ALL PROPOSED LAWN AND GARDEN AREAS. DO NOT CULTIVATE BENEATH EXISTING TREES TO BE RETAINED. IN AREAS WHERE FILL IS REQUIRED GAIN REQUIRED SHAPES AND LEVELS USING A PREMIUM GRADE SOIL MIX. IN AREAS WHERE EXCAVATION IS REQUIRED (IF IN CLAY) OVER EXCAVATE AS REQUIRED TO ALLOW FOR INSTALLATION OF 500MM DEPTH OF PREMIUM GRADE TOPSOIL MIX TO GARDEN AREAS AND 300M DEPTH OF PREMIUM GRADE TOPSOIL MIX TO LAWN AREAS

SUBGRADE PREPARATION
BEFORE LAYING TOPSOIL, THE FOLLOWING SUBGRADE TREATMENT MUST BE APPLIED TO ALL FINISHED SUBGRADE AREAS:
1. FAIR + TRIM TO RELATIVE LEVEL TO ACCOMMODATE REQUIRE OVERALL SOIL DEPTH

- 2 REMOVE ROCK >100mm DIAMETER
- 3. REMOVE RUBBISH SUCH AS CONSTRUCTION GENERATED WASTER, PLASTICS, METALS, GLASS
- 4 APPLY GYPSUM AND LIME AT MANUFACTURER'S RECOMMENDED RATES
- 5. LOOSEN SUBGRADE TO 200mm DEPTH LEAVING SURFACE 'KEYED' TO ACCEPT TOPSOIL

CONTRACTOR SHALL UNDERTAKE PH TESTS AND ADJUST WHERE NECESSARY TO ACHIEVE A PH WITHIN THE 5.5 - 7.5 RANGE. MIX IN GYPSUM AT MANUFACTURER'S RECOMMENDED RATES IF CLAY SOIL ENCOUNTERED.

UNDERTAKE ALL REQUIRED ACTION TO ENSURE THAT NO ROOTBALLS OF PROPOSED PLANTS SIT IN CLAY WELLS AND THAT ALL GARDEN AREAS AND LAWN AREAS DRAIN SATISFACTORILY. NOTE IT IS INTENDED THAT WHEREVER POSSIBLE EXISTING LEVELS SHALL NOT BE ALTERED THROUGH GARDEN AND LAWN AREAS. IT IS THE CONTRACTOR'S RESPONSIBILITY TO ENSURE THAT THE END RESULT OF THE PROJECT IS THAT ALL LAWN AND GARDEN AREAS DRAIN SUFFICIENTLY (BOTH SURFACE AND SUBSTRATE), ARE AT REQURIED FINISH LEVELS AND HAVE SUFFICIENT SOIL DEPTHS TO ENABLE LAWN AND PLANTS TO THRIVE AND GROW. SHOULD ALTERNATIVE WORKS TO THOSE SPECIFIED REQUIRED TO ACHIEVE THAT RESULT. CONTRACTOR SHALL INFORM BUILDER AT TIME OF TENDER AND

ALL PLANTS SHALL BE WELL GROWN AND DISEASE FREE, PLANTING SHALL BE IN ACCORDANCE WITH PLANTING SCHEDULE, TREES SHALL BE GROWN TO NATSPEC, GENERAL PLANT MATERIAL (EXOTICS AND ENDEMIC) SUPPLY PLANTS IN ACCORDANCE WITH PLANTING SCHEDULE. NO SUBSTITUTIONS ARE PERMITTED WITHOUT THE CONSENT OF THE SUPERVISING LANDSCAPE ARCHITECT. PLANT MATERIAL SHALL BE GROWN TO NATSPEC AND SHALL BE VIGOROUS, WELL ESTABLISHED, FREE OF DISEASE AND PESTS, HARDENED OFF, TRUE TO FORM, AND GROWN IN THEIR FINAL CONTAINERS FOR NOT LESS THAN 12 WEEKS. TREES SHALL HAVE A SINGLE LEADING SHOOT AND POTS FREE FROM WEEDS.

IMMEDIATELY REJECT DRIED OUT, DAMAGED OR UNHEALTHY PLANT MATERIAL BEFORE PLANTING.

PLANT HOLES SHALL BE DUG APPROXIMATELY TWICE THE WIDTH AND TO 100MM DEEPER THAN PLANT ROOTBALLS THAT THEY ARE TO RECEIVE. BASE AND SIDES OF HOLE SHALL BE FURTHER LOOSENED. FERTILISER, FOLLOWED BY 100MM DEEPER THAN PLANT ROOTBALLS THAT THEY ARE TO RECEIVE. SHALL THEN BE PLACED INTO BASE OF HOLE AND LIGHTLY CONSOLIDATED. BASE OF HOLE SHALL THEN BE WATERED. REMOVE PLANT (NOTAINER AND INSTALL PLANT INTO HOLE. ROOTBALL SHALL BE BACKFILLED WITH SURROUNDING TOPSOIL AND TOPSOIL FIRMED INTO PLACE. AN APPROVED SHALLOW DISH SHALL BE THOROUGHLY WATERED AND MAIN TAILED FOR STEM. BASE OF STEM OF PLANT SHALL BE THOROUGHLY WATERED AND MAIN TAILED FOR THE DURATION OF THE CONTRACT

STAKES + TIES

THE LANDSCAPE CONTRACTOR SHALL REPLACE OR ADJUST PLANT STAKES, AND TREE GUARDS AS NECESSARY OR AS DIRECTED BY THE LANDSCAPE ARCHITECT.

STAKES SHALL BE STRAIGHT HARDWOOD, FREE FROM KNOTS AND TWISTS, POINTED AT ONE END AND SIZED ACCORDING TO THE SIZE OF PLANTS TO BE STAKED.

- 5-15 LITRE SIZE PLANT 1X 1200 X 25 X 25MM
- 35-75 LITRE SIZE PLANT 2X 1500 X 38 X 38MM 100+ LITRE SIZE PLANT 3X 1800 X 50 X 50MM

TIES SHALL BE 50MM WIDE HESSIAN WEBBING OR APPROVED EQUIVALENT NAILED OR STAPLED TO STAKE. DRIVE STAKES A MINIMUM ONE THIRD OF THEIR LENGTH, AVOIDING DAMAGE TO THE ROOT SYSTEM, ON THE WINDWARD SIDE OF THE PLANT.

AT PLANTING SPREAD SLOW RELEASE FERTILIZER AROUND DRIPLINE OF ALL PLANTS AT MANUFACTURER'S RECOMMENDED RATES

EQUAL TO OSMOCOTE PLUS TRACE ELEMENTS - ALL PURPOSE NPK 19.4 : 1.6 : 6

NATIVE PLANTS: EQUAL TO OSMOCOTE PLUS TRACE ELEMENTS - NATIVE GARDENS NPK 17.9: 0.8: 7.3

ENSURE ALL MULCH IS FREE OF WEED SEED AND VEGETATIVE MATERIAL. PROVIDE SAMPLE OF MULCH FOR CLIENT APPROVAL PRIOR TO DELIVERY.

PLACE MULCH TO REQUIRED DEPTH, (REFER TO DRAWINGS) CLEAR OF PLANT STEMS, AND RAKE TO AN EVEN SURFACE FINISHING 25MM BELOW ADJOINING LEVELS. ENSURE MULCH IS WATERED IN AND TAMPED DOWN DURING INSTALLATION.


EDGING SHALL BE INSTALLED AT THE JUNCTION OF LAWN AND GARDEN AREAS AS INDICATED ON DRAWINGS. EDGE SHALL BE FINISHED LEVEL WITH LAWN OR ADJOINING GRAVEL, EDGE SHALL TYPICALLY BE 100MM HIGH WITH ALUMINIUM FINISH, INSTALL TO


FENCING


RETAIN ALL EXISTING FENCING UNLESS ADVISED OTHERWISE BY BUILDER.




PROJECT	NOTES
Proposed Unit Development	comply with building code of australia and all relevant australian standards all works shall be in accordence with development application and construction certificate conditions of consent
SITE	all levels to ahd refer to survey information relating to existing site data verify all dimensions prior to works
26-30 Hope Street,	do not scale from drawings use figured dimentions in preference to scaling refer all descrepancies to landscape architect for determination
Penrith, NSW 2750	this drawing is copyright and must not be retained, copied, used or reproduced in any way without prior written permission of contour landscape architects.

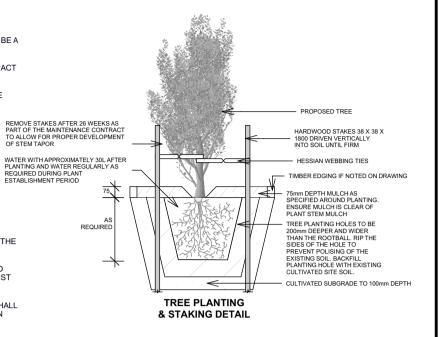

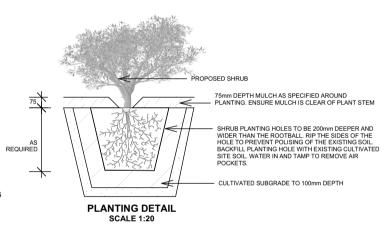

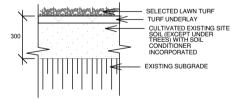



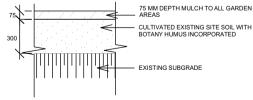

SOIL TO GARDEN AREAS SCALE 1:20

DATE:	26/05/2020	DRAWING LANDSCAPE DETAILS
SCALE:	N/A @ A3	DRAWING NO: C6_BDT
DRAWN:	LH	REV: A