

# CADDENS HILL - PLAYING FIELD CONSTRUCTION CERTIFICATE

PROPOSED CARPARK, ROAD & DRAINAGE WORKS



LOCALITY SKETCH

Prepared By:

# J. WYNDHAM PRINCE

CONSULTING CIVIL INFRASTRUCTURE ENGINEERS
& PROJECT MANAGERS

PO Box 4366 PENRITH WESTFIELD NSW 2750 P 02 4720 3300 F 02 4720 3399

**W** www.jwprince.com.au **E** jwp@jwprince.com.au

ISSUED FOR CONSTRUCTION APPROVAL

110358/CC800 A
FILE No. 110358CC800

# **LEGEND DESCRIPTION PROPOSED EXISTING FUTURE EXTENT OF WORKS** KG **KERB & GUTTER** 3. THE CONTRACTOR SHALL LOCATE AND LEVEL ALL EXISTING SERVICES PRIOR TO COMMENCING CONSTRUCTION AND PRAM RAMP PERMISSION OF THE OWNERS. TO BE PROVIDED PRIOR TO THE APPROVAL OF THE PLANS. DRAINAGE LINE, PIT & EASEMENT (05/06) Ø600 DRAINAGE LINE & PIT HEADWALL **GUIDE POSTS** ......... 00000000000 **EXTENT OF FILL** EXTENT OF CUT CONTOURS —·—·-46.0-·—·— CATCH DRAIN —>——>— KERB RETURN No ELECTRICITY, POWER POLE —E—E—E—E— TELECOM, BOX WATER, STOP VALVE, HYDRANT \_w\_\_w\_\_w\_ SEWER. MANHOLE \_s\_s\_s\_s\_ GAS —g—g—g— — eG — eG — eG — TREES TO BE RETAINED 0 TREES TO BE REMOVED STREET NAME SIGNS **SURVEY MARKS - BENCH MARKS** STATE SURVEY MARKS RECOVERY PEGS STAGE 5 STAGE BOUNDARY STAGE 6 STABILISED SITE ACCESS SEDIMENT FENCE STRAW BALE BARRIER STOCKPILE PROTECTIVE FENCING MESH AND GRAVEL INLET FILTER GEOTEXTILE INLET FILTER

## **GENERAL NOTES:**

- ALL WORKS ARE TO BE IN ACCORDANCE WITH PENRITH CITY COUNCILS "DESIGN GUIDELINES FOR ENGINEERING WORKS FOR SUBDIVISIONS AND DEVELOPMENTS" & "ENGINEERING CONSTRUCTION SPECIFICATION FOR CIVIL WORKS".
- 2.a. STATE SURVEY MARKS LOCATIONS TO BE FIXED BY PROJECT SURVEYOR DURING WORK AS EXECUTED SURVEY
- OF SUBDIVISION. SURVEY MARKS SHOWN THUS ▲ SHALL BE RETAINED AT ALL TIMES. WHERE RETENTION IS NOT POSSIBLE THE
- SUPERINTENDENT MUST BE NOTIFIED AND CONSENT RECEIVED PRIOR TO THEIR REMOVAL.
- MAKE ARRANGEMENTS WITH THE RELEVANT AUTHORITY TO RELOCATE OR ADJUST IF NECESSARY. 4. THE CONTRACTOR SHALL NOT ENTER UPON NOR DO ANY WORK WITHIN ADJACENT LANDS WITHOUT THE WRITTEN
- 5. THE CONTRACTOR SHALL MAINTAIN SERVICES AND ALL WEATHER ACCESS AT ALL TIMES TO ADJOINING PROPERTIES.
- 6. NO TREE SHALL BE FELLED, LOPPED OR REMOVED WITHOUT THE PRIOR APPROVAL OF COUNCIL'S ENGINEER.
- 7. TREES TO BE RETAINED ON SITE SHALL BE PROTECTED BY SUITABLE STURDY APPROVED PROTECTIVE FENCING PRIOR TO COMMENCEMENT OF SITE WORKS.
- 8. THE CONTRACTOR SHALL CLEAR THE SITE BY REMOVING ALL RUBBISH, FENCES OUT-HOUSES, CAR BODIES AND
- 9. EXISTING SEDIMENT BASINS SHALL BE DEWATERED AND DESILTED. LEVELS SHALL BE OBTAINED ON SOUND MATERIAL PRIOR TO FILLING.
- 10. FILLING IS TO BE FROM A NOMINATED SOURCE, OF SOUND CLEAN MATERIAL, FREE FROM LARGE ROCK, STUMPS, CONTAMINATED MATTER, INDUSTRIAL AND BUILDING WASTE, ORGANIC MATTER AND OTHER DEBRIS. PLACING OF FILLING ON THE PREPARED AREAS SHALL NOT COMMENCE UNTIL THE AUTHORITY TO DO SO HAS BEEN OBTAINED FROM THE COUNCIL.
- 11. SITE FILL AREAS:- THE CONTRACTOR SHALL TAKE LEVELS OF EXISTING SURFACE AFTER STRIPPING TOPSOIL AND PRIOR TO COMMENCING FILL OPERATIONS.
- 12. ALL SITE FILLING TO BE COMPACTED TO 95% STANDARD COMPACTION AND SHALL BE CONTROLLED BY A REGISTERED SOIL LABORATORY IN ACCORDANCE WITH COUNCIL'S "ENGINEERING CONSTRUCTION SPECIFICATION FOR CIVIL
- ALL SITE REGRADING AREAS SHALL BE GRADED AT A MINIMUM 1% TO THE ENGINEERS. REQUIREMENTS.
- 14. SURPLUS EXCAVATED MATERIAL SHALL BE PLACED WHERE DIRECTED BY THE SUPERINTENDENT
- 15. EASEMENT WIDTHS SHALL BE IN ACCORDANCE WITH 3.11 DRAINAGE EASEMENTS OF PENRITH CITY COUNCIL'S DESIGN GUIDELINES FOR ENGINEERING WORKS FOR SUBDIVISION AND DEVELOPMENTS.

PIPE DIA.	EASEMENT WID
150Ø	1.5m
225Ø	2.0m
300Ø	2.0m
3 <b>7</b> 5Ø	2.5m
450Ø	2.5m
545Ø	2.5m
600Ø	2.5m
675Ø	3.0m

- 16. DRAINAGE LINES UNDER ROADS SHALL BE BACKFILLED WITH NON-COHESIVE SAND AND HAVE 3m OF SUBSOIL DRAIN WRAPPED IN APPROVED FILTER SOCK, DISCHARGING INTO DOWN STREAM PITS. PIPE CLASS INDICATED ARE FOR REINFORCED CONCRETE PIPES (RCP)
- IF FIBRE REINFORCED CONCRETE PIPES (FRC) REFER TO PENRITH CITY COUNCIL "ENGINEERING CONSTRUCTION SPECIFICATION FOR CIVIL WORKS"
- 17. ALL CONDUITS AND MAINS SHALL BE LAID PRIOR TO LAYING FINAL ASPHALTIC CONCRETE SEAL.
- 18. VEHICULAR CROSSINGS SHALL BE CONSTRUCTED IN KERB AND GUTTER WHERE SHOWN IN ACCORDANCE WITH PCC STANDARD DRAWING SD1004.
- 19. PRAM CROSSINGS SHALL BE CONSTRUCTED IN KERB AND GUTTER IN ACCORDANCE WITH COUNCIL'S STANDARD
- 20. STREET NAME SIGNS SHALL BE ERECTED, WHERE SHOWN, IN ACCORDANCE WITH COUNCIL'S STANDARD SD1006/1 AND
- 21. ALL NEW WORKS SHALL MAKE A SMOOTH JUNCTION WITH EXISTING CONDITIONS.
- 22. ALL INTERALLOTMENT DRAINAGE LINES SHALL BE LAID AT A MINIMUM GRADE OF 1% UNLESS OTHERWISE INDICATED.
- 23. DRAINAGE LINES ON PLANS ARE DIAGRAMMATIC ONLY AND PIPE CENTRELINES SHALL ENTER AND EXIT PITS AT THE CENTRE OF THE RESPECTIVE PIT WALLS.
- 24. DIMENSIONS OF ANY DETAIL SHALL NOT BE SCALED DIMENSIONS, IF IN DOUBT, SHALL BE VERIFIED BY THE
- 25. ALL CONSTRUCTION AND RESTORATION WORK ON COUNCIL'S ROAD AND FOOTPATH AREA ARE TO BE CARRIED OUT IN ACCORDANCE WITH THE APPROVED DRAWINGS AND COUNCIL'S STANDARD SPECIFICATIONS AND APPROVED BY PENRITH CITY COUNCIL THROUGH A \$138 ROADS ACT APPROVAL.
- 26. ALL LAND THAT HAS BEEN DISTURBED BY EARTHWORKS IS TO BE SPRAY GRASSED OR SIMILARLY TREATED TO ESTABLISH A GRASS COVER.
- 27. NO FILL MATERIAL IS TO BE IMPORTED TO THE SITE WITHOUT THE PRIOR APPROVAL OF PCC IN ACCORDANCE WITH SYDNEY REGIONAL ENVIRONMENTAL PLAN No.20 (HAWKESBURY-NEPEAN RIVER) (No.2-1997). NO RECYCLING OF MATERIAL FOR USE OF FILL MATERIAL SHALL BE CARRIED OUT ON THE SITE WITHOUT THE PRIOR APPROVAL OF COUNCIL.
- 28. ALL EARTHWORKS SHALL BE UNDERTAKEN IN ACCORDANCE WITH AS3798 AND PCC DESIGN GUIDELINES FOR ENGINEERING WORKS FOR SUBDIVISIONS AND DEVELOPMENTS AND ENGINEERING CONSTRUCTION SPECIFICATIONS FRO CIVIL WORKS.
- 29. VEHICLE CROSSINGS TO BE LOCATED 1.0m CLEAR OF ANY LINTELS.
- 30. ALL VERGE AREAS EXTEND FROM BACK OF KERB TO PROPERTY BOUNDARY TO BE TURFED.
- 31. ALL STORMWATER PITS WITH DEPTHS GREATER THAN 1.0m TO HAVE GALVANISED OR OTHERWISE APPROVED STEP IRONS AT 300mm SPACING INSTALLED.
- 32. KERB TYPES USED IN SITE ARE KERB AND GUTTER UNLESS OTHERWISE NOTED. FOR DETAILS REFER TO PENRITH CITY COUNCIL "ENGINEERING CONSTRUCTION SPECIFICATION FOR CIVIL WORKS" STANDARD SD1003/1 & SD1003/2.
- 33. KERB ADAPTORS SHALL BE PROVIDED FOR ALL LOTS DRAINING TO THE STREET. FOR DETAIL REFER TO PENRITH CITY COUNCIL "ENGINEERING CONSTRUCTION SPECIFICATION FOR CIVIL WORKS"
- 34. ALL WASTE MATERIAL STORED ON-SITE ARE TO BE CONTAINED WITHIN A DESIGNATED AREA SUCH AS A WASTE BAY OR BIN. CONTRACTOR TO ENSURE THAT NO WASTE MATERIALS ARE ALLOWED TO ENTER THE STORMWATER SYSTEM OR NEIGHBOURING PROPERTIES. THE DESIGNATED WASTE STORAGE AREAS SHALL PROVIDE AT LEAST TWO WASTE BAY/BINS SO AS TO ALLOW FOR THE SEPARATION OF WASTES. AND ARE TO BE FULLY ENCLOSED WHEN SITE IS UNATTENDED.
- 35. AN APPROPRIATE QUALIFIED PERSON/S SHALL SUPERVISE ALL FILLING WORKS.

## **SURVEY SET OUT INFORMATION NOTES:**

- 1. ALL SITE SET OUT AND CONTROL POINTS ARE TO BE CERTIFIED BY A REGISTERED SURVEYOR.
- 2. THE INFORMATION DETAILED ON THE CERTIFIED CONSTRUCTION CERTIFICATE PLANS TAKES PRECEDENCE OVER ALL ELECTRONIC INFORMATION PROVIDED. THE ORDER OF PRIORITY FOR USE OF ALL INFORMATION PROVIDED IS AS FOLLOWS:
  - a. CERTIFIED CONSTRUCTION CERTIFICATE DRAWINGS b. 2D DRAFTING BASE (ELECTRONIC FILE)
  - c. 3D DTM (ELECTRONIC FILE)
- 3. ANY DISCREPANCY BETWEEN ANY OF THE INFORMATION CONTAINED WITHIN THESE FILES IS TO BE BROUGHT TO THE ATTENTION OF THE SUPERINTENDENT PRIOR TO CONSTRUCTION WHO WILL SEEK CLARIFICATION AND ISSUE INSTRUCTIONS ON THE APPROPRIATE COURSE OF ACTION.

## **SURVEY BY:**

## SDG LAND DEVELOPMENT SOLULTIONS

**UNIT 7 1B KLEINS ROAD** 

**NORTHMEND 2152** 

Ph. (02) 9630 7955

FILE: 6072 CONTOUR ISSUE D.DWG DATE: 22/4/16

## Survey By:

# VINCE MORGAN (SURVEYORS) PTY. LTD.

CONSULTING SURVEYORS P.O. Box 227, Penrith. 2751 Ph. (02) 4721 5293


Date: 21/09/16 File Name: 20467-L2.dwg Date: 21/09/16 File Name: 210916topo.dxf

## **CUSTOM MADE PRECAST PIT NOTES:**

- 1. DESIGN DOCUMENTATION REFLECTS PRECAST DRAINAGE PITS BEING USED FOR THE SITE. UNLESS NOTED OTHERWISE.
- 2. AUSPITS CUSTOM MADE PRECAST PITS TO BE USED.
- 3. PITS TO COMPLY WITH THE FOLLOWING PARAMETERS:
- 3.a. ARE SPECIFICALLY MANUFACTURED FOR THE PROJECT.
- EACH PIT IS ACCOMPANIED BY A CERTIFICATE OF STRUCTURAL ADEQUACY SIGNED BY A NPER ENGINEER (STRUCTURAL)
- THE STRUCTURAL CERTIFICATION OF THE PITS SHOULD INCLUDE ANY ADDITIONAL PRECAST ELEMENTS REQUIRED TO BRING THE PIT UP TO FINAL
- LEVELS ON SITE. PITS MUST BE FIRMLY BEDDED ON SOUND MATERIAL.
- CONCRETE IS TO BE POURED AROUND THE BASE TO AID IN STABILISATION OF THE PIT.
- PIT FLOORS ARE TO HAVE A 1% FALL TOWARDS THE OUTLET PIPE.
- ANY PIT REQUIRING MODIFICATION AFTER IT HAS BEEN POURED IN THE FACTORY OR DAMAGED IN TRANSPORT CANNOT BE USED.
- ALL WORK TO BE TO THE SATISFACTION OF COUNCIL'S DEVELOPMENT INSPECTORS.

IT IS THE CONTRACTORS RESPONSIBILITY TO PROVIDE DETAILED PIT DRAWINGS AND STRUCTURAL CERTIFICATION IF INSITU PITS ARE TO BE CONSTRUCTED.

ALL CAST INSITU PITS TO BE IN ACCORDANCE WITH PCC STANDARD DRAWINGS SD2001/1, SD2001/2 AND SD2001/3. ANY PIT GREATER THAN 2m DEEP WILL REQUIRE SEPARATE APPROVAL.

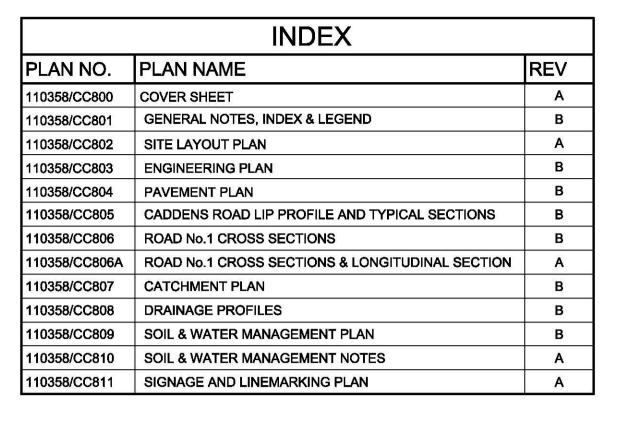

BEFORE YOU DIG

UTILITIES SHOWN ARE DIAGRAMMATIC ONLY, CONTRACTORS ARE RESPONSIBLE TO LOCATE AND AVOID DAMAGE TO THEM. NOTE: UTILITIES SHOWN MAY NOT INCLUDE ALL SERVICES WITHIN THE LIMIT OF WORKS



APPROVED CONSTRUCTION CERTIFICATE.

& PROJECT MANAGERS

# ISSUED FOR CONSTRUCTION APPROVAL

CADDENS HILL - PLAYING FIELD CARPARK, ROAD & DRAINAGE WORKS

110358/CC801 FILE No: 110358CC801

A1 ORIGINAL

**GENERAL NOTES, INDEX & LEGEND** 

SHEET SIZE:

J. WYNDHAM PRINCE CONSULTING CIVIL INFRASTRUCTURE ENGINEERS & PROJECT MANAGERS

JT JT MP MS 12/03/18 JT NM MP MS 07/12/17


DRN CKD APR DATE


PO Box 4366 PENRITH WESTFIELD NSW 2750 P 02 4720 3300 F 02 4720 3399 W www.jwprince.com.au E jwp@jwprince.com.au


Document Set ID: 8182560 Version: 1. Version Date: 11/05/2018


B INDEX AMENDED
A ISSUE FOR CONSTRUCTION APPROVAL


**AMENDMENT** 

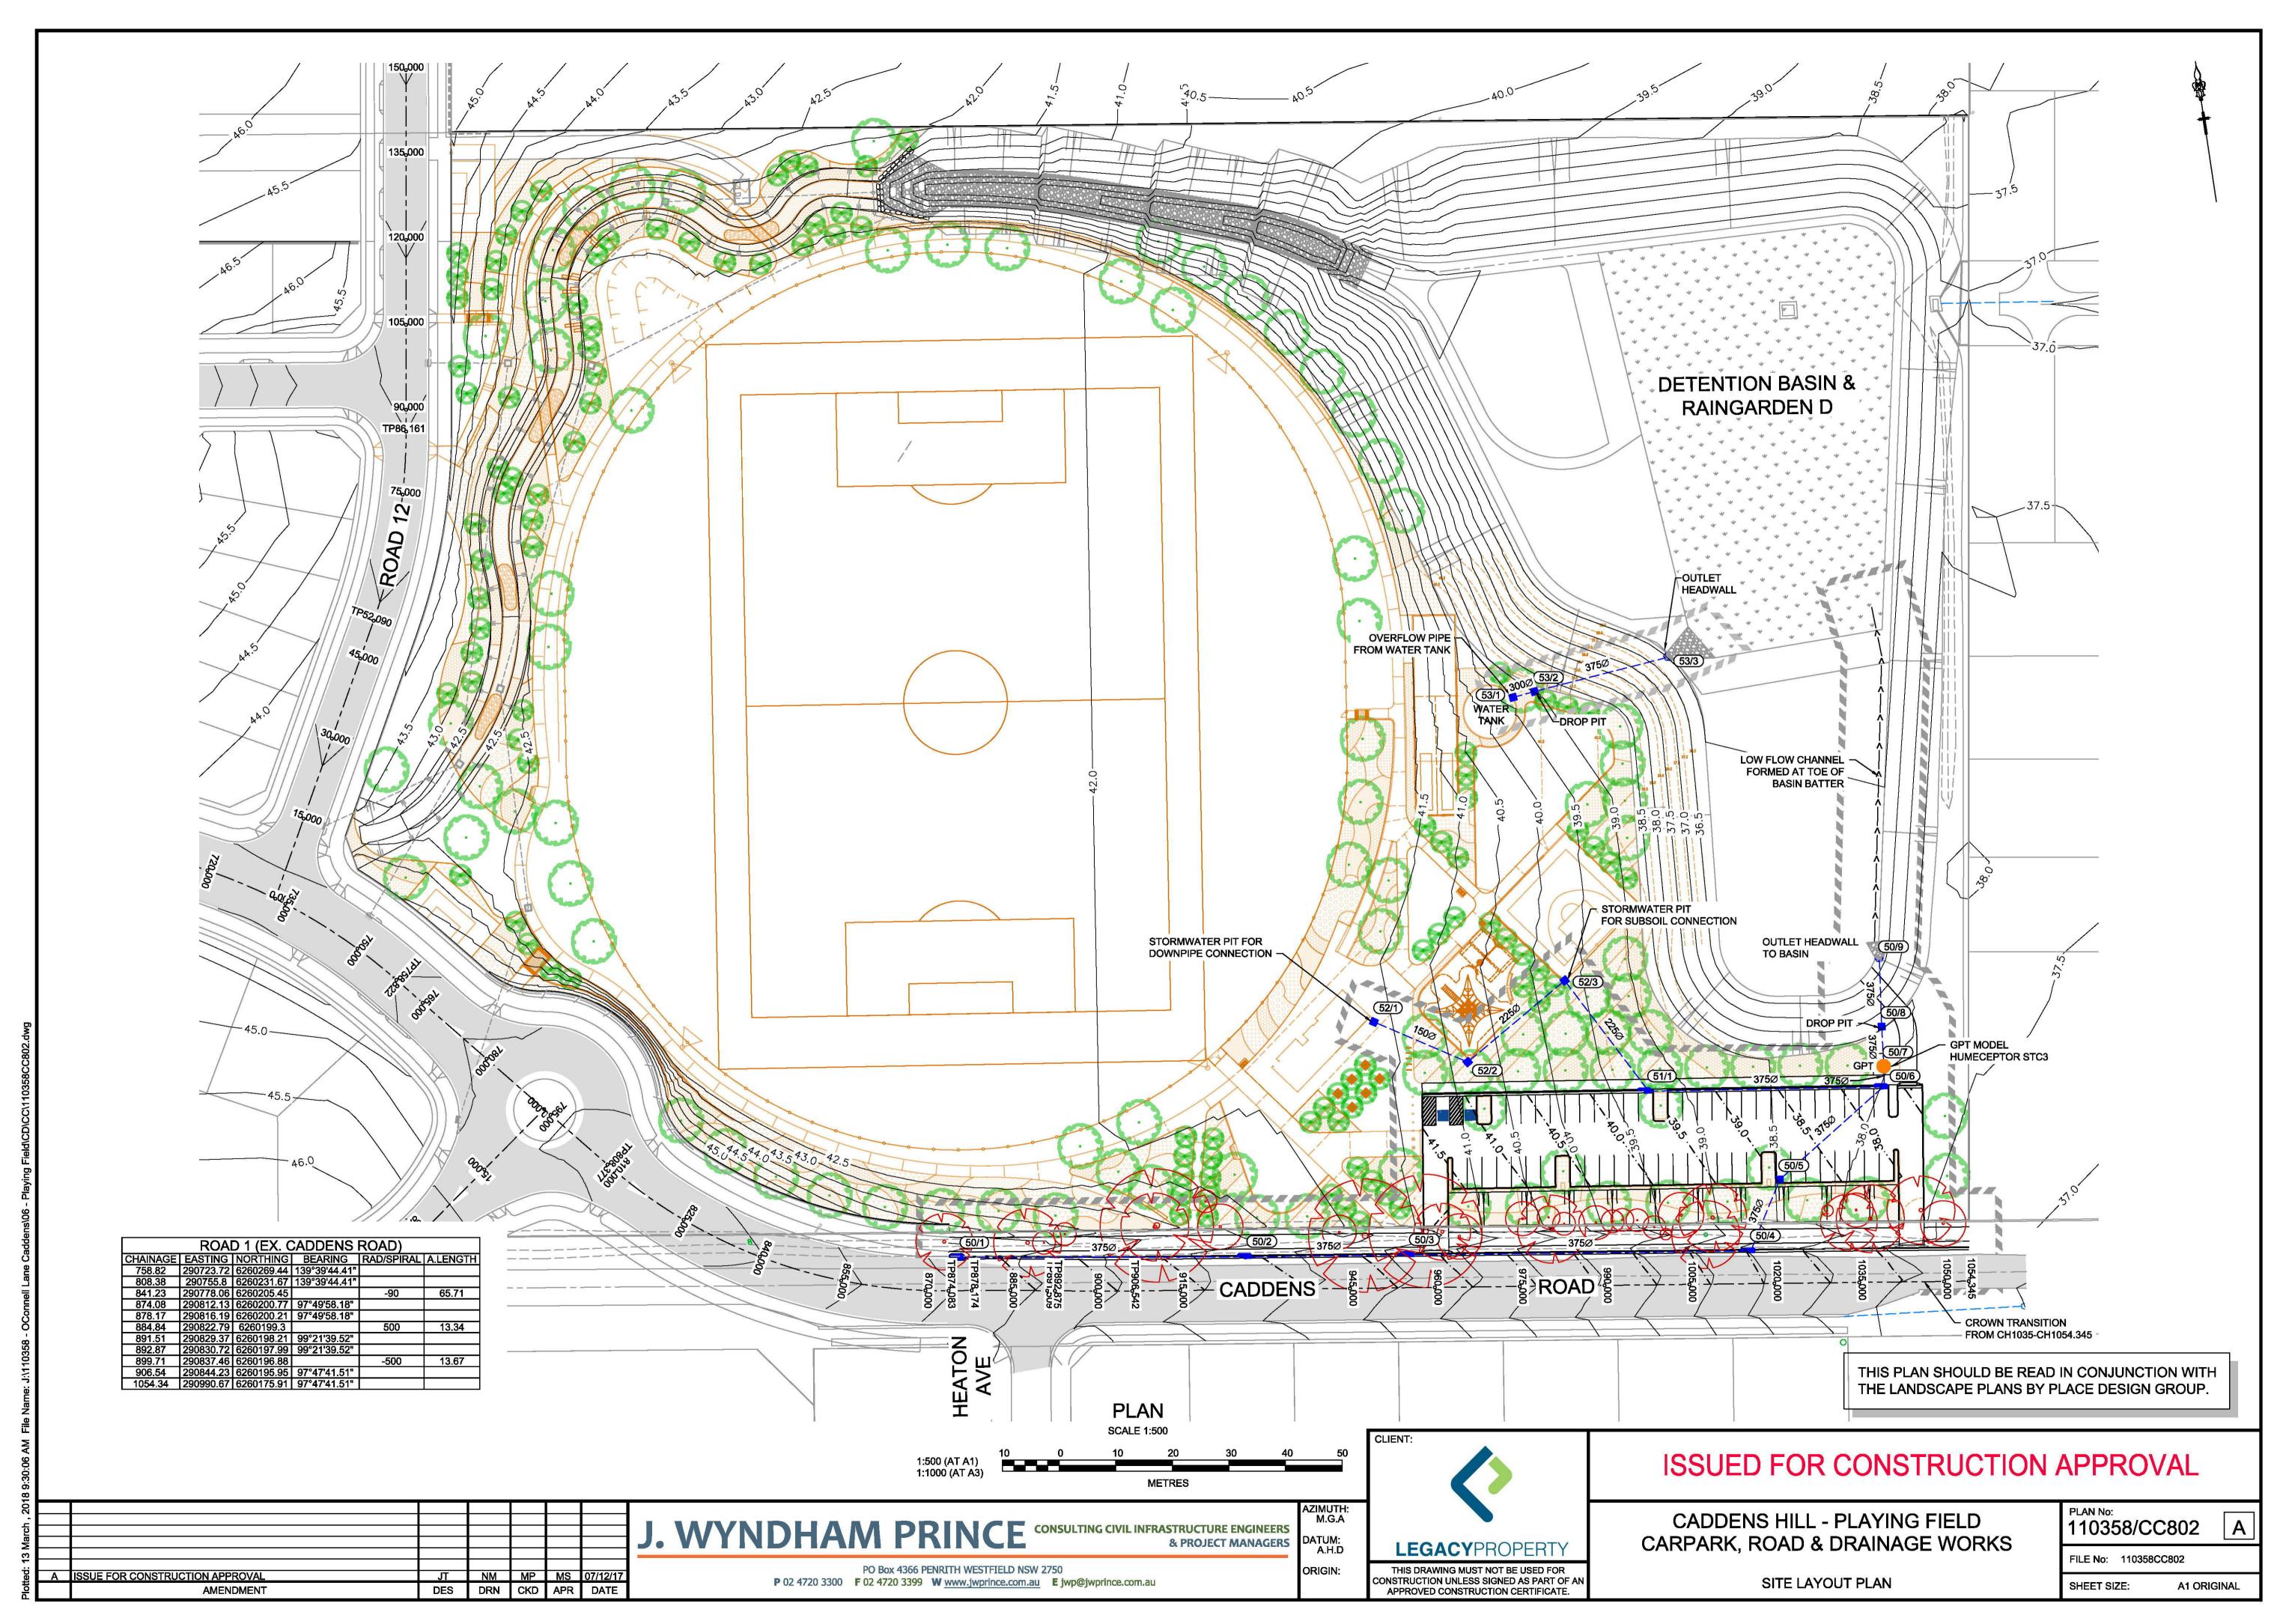


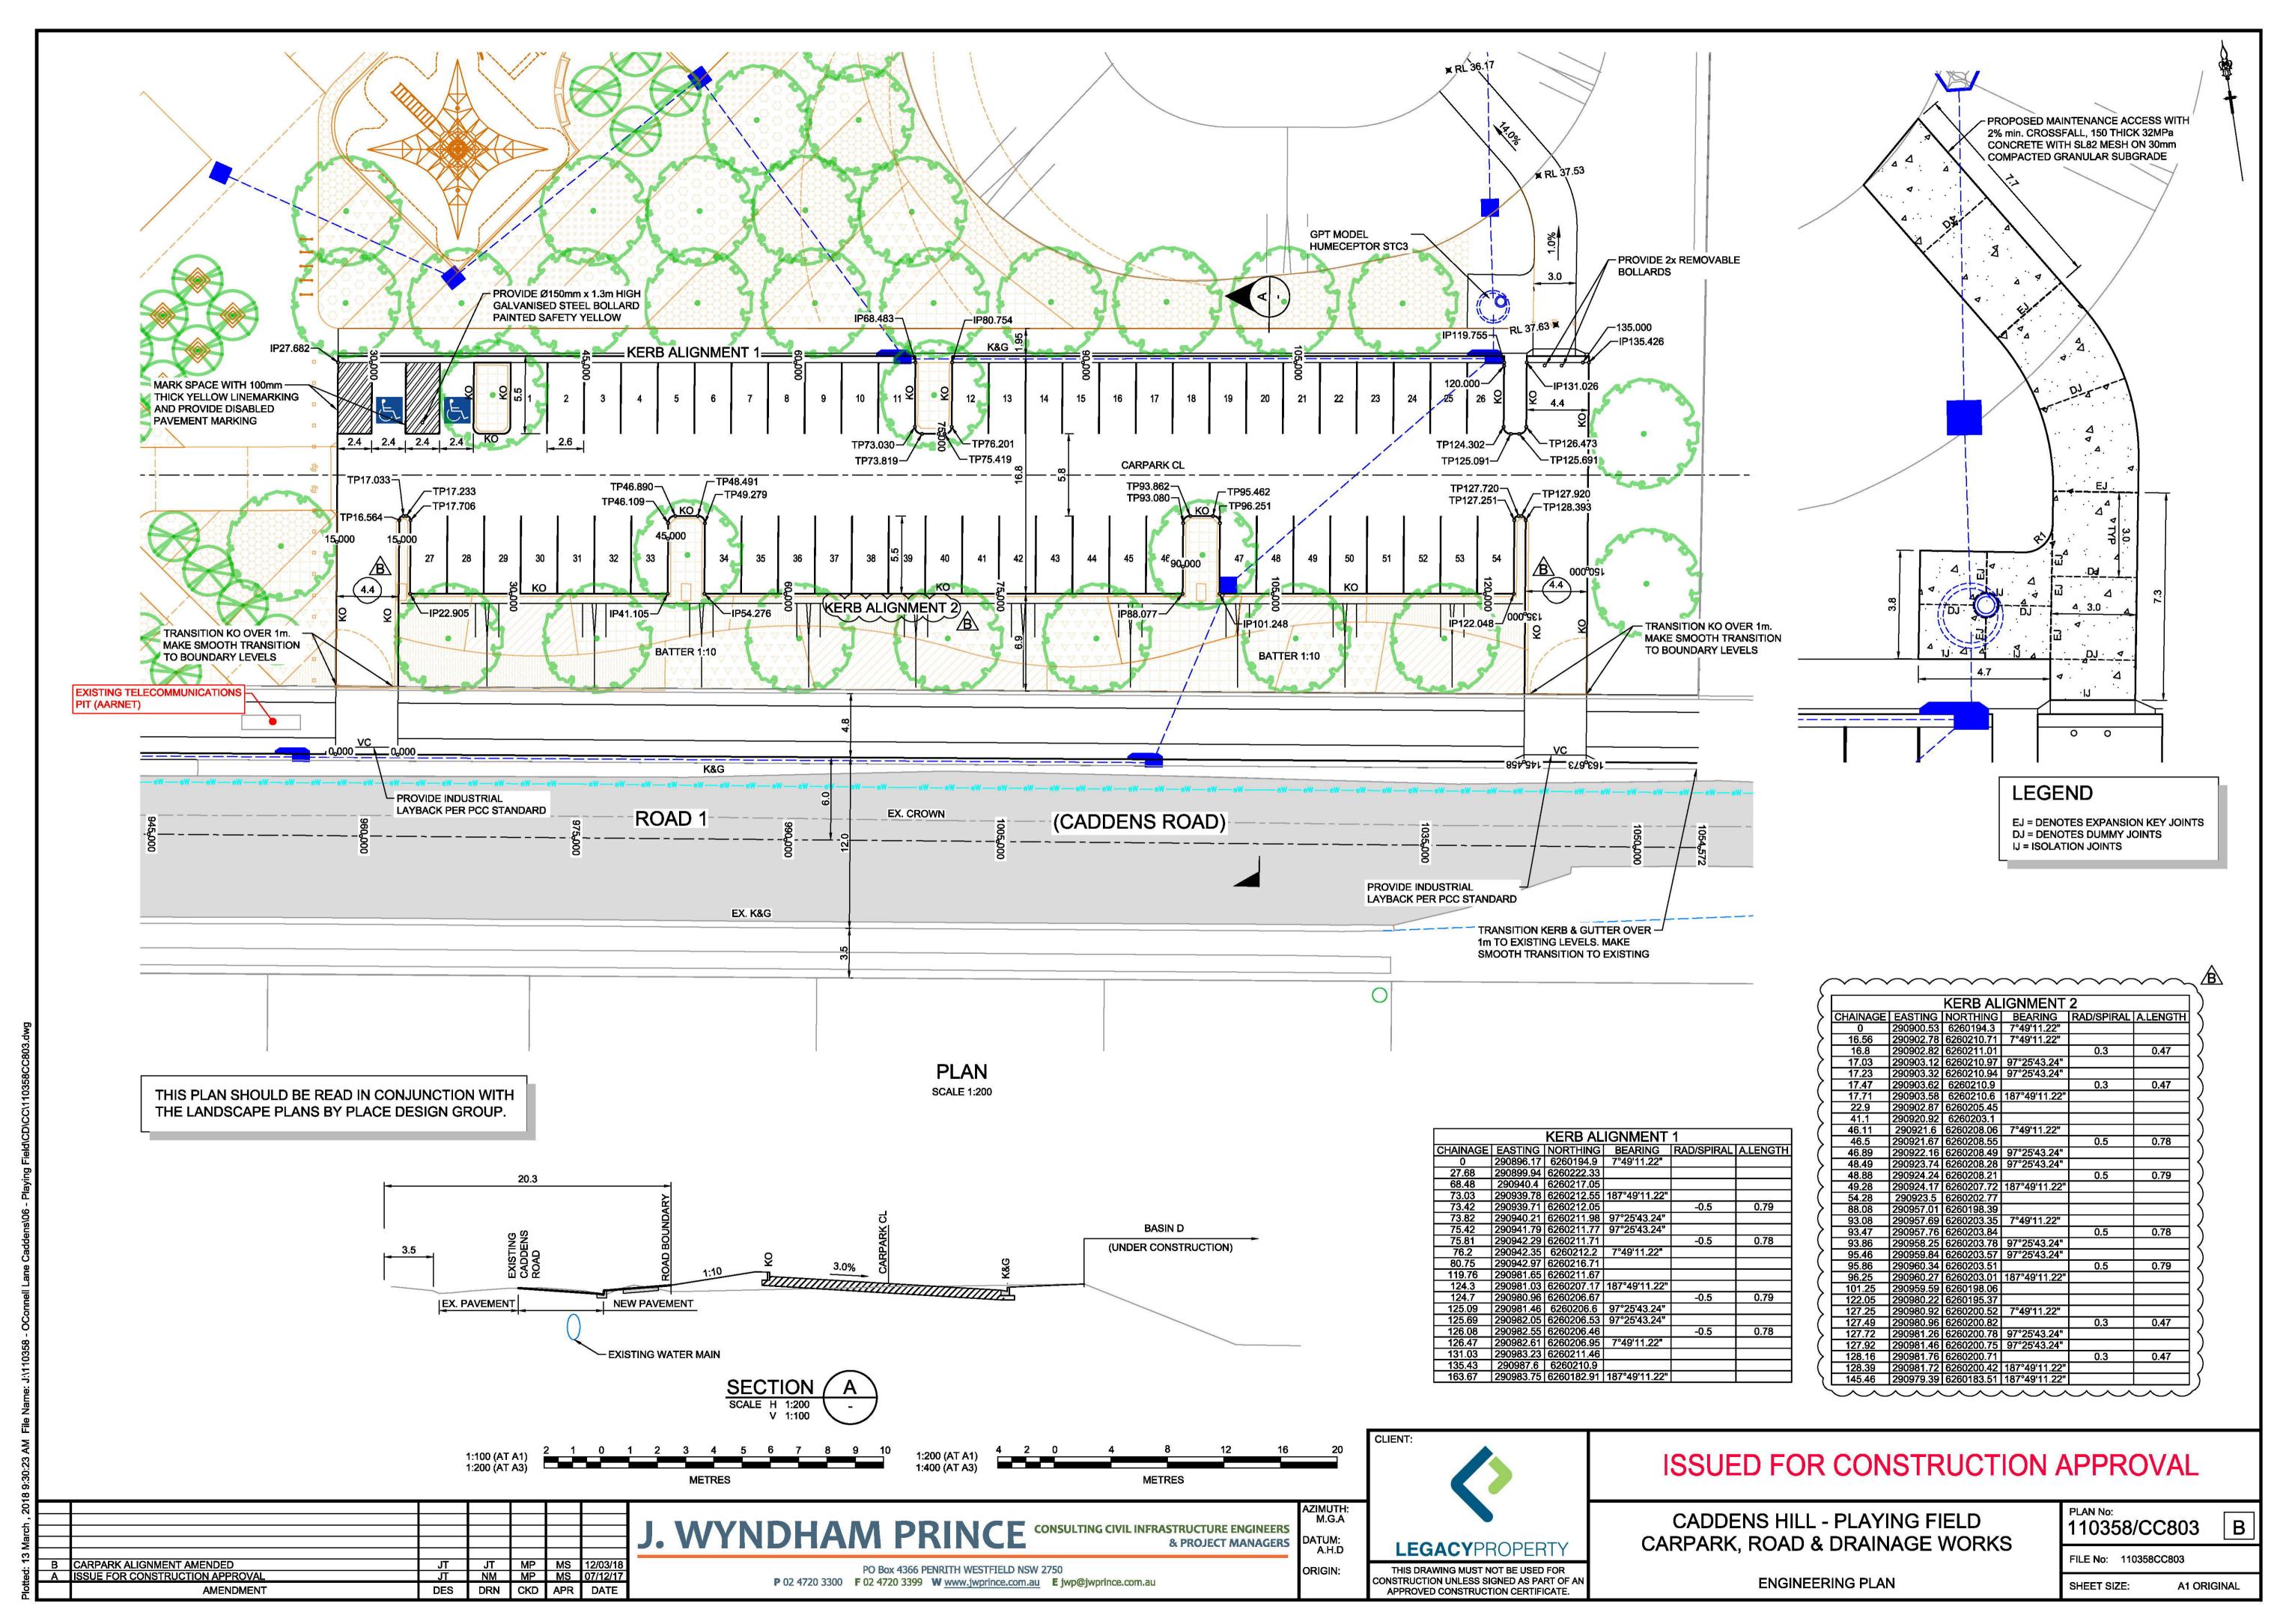


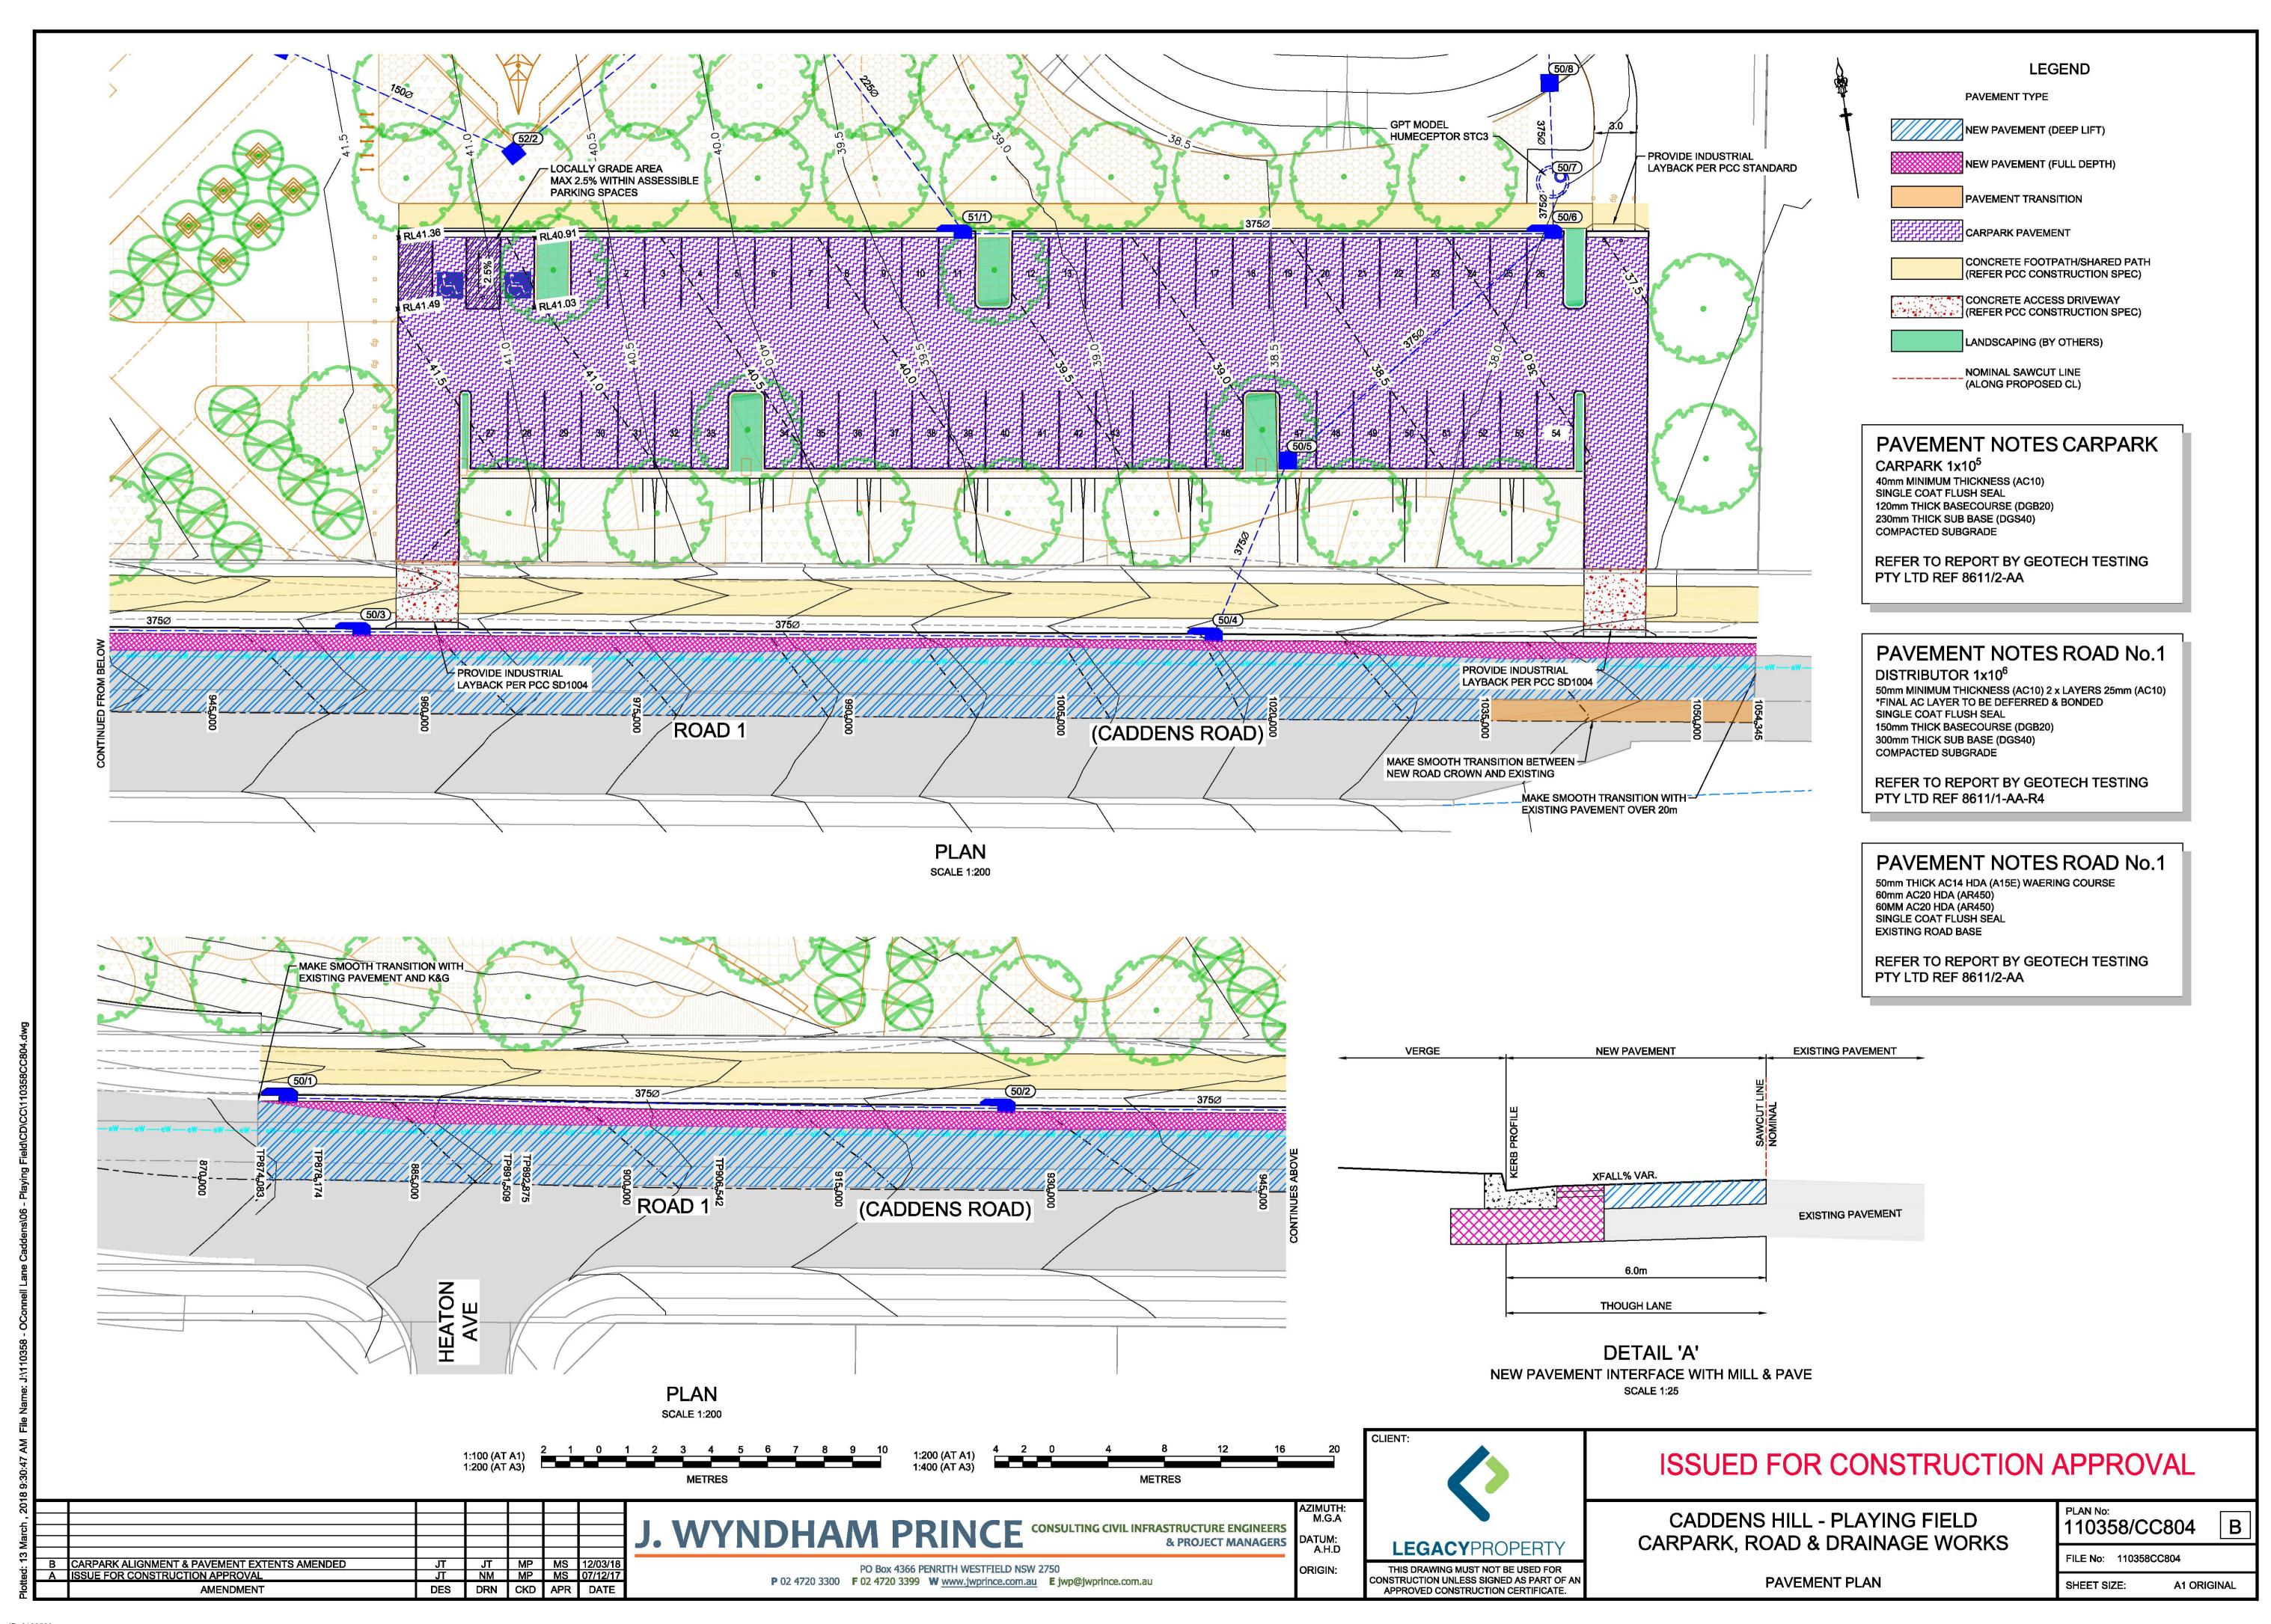

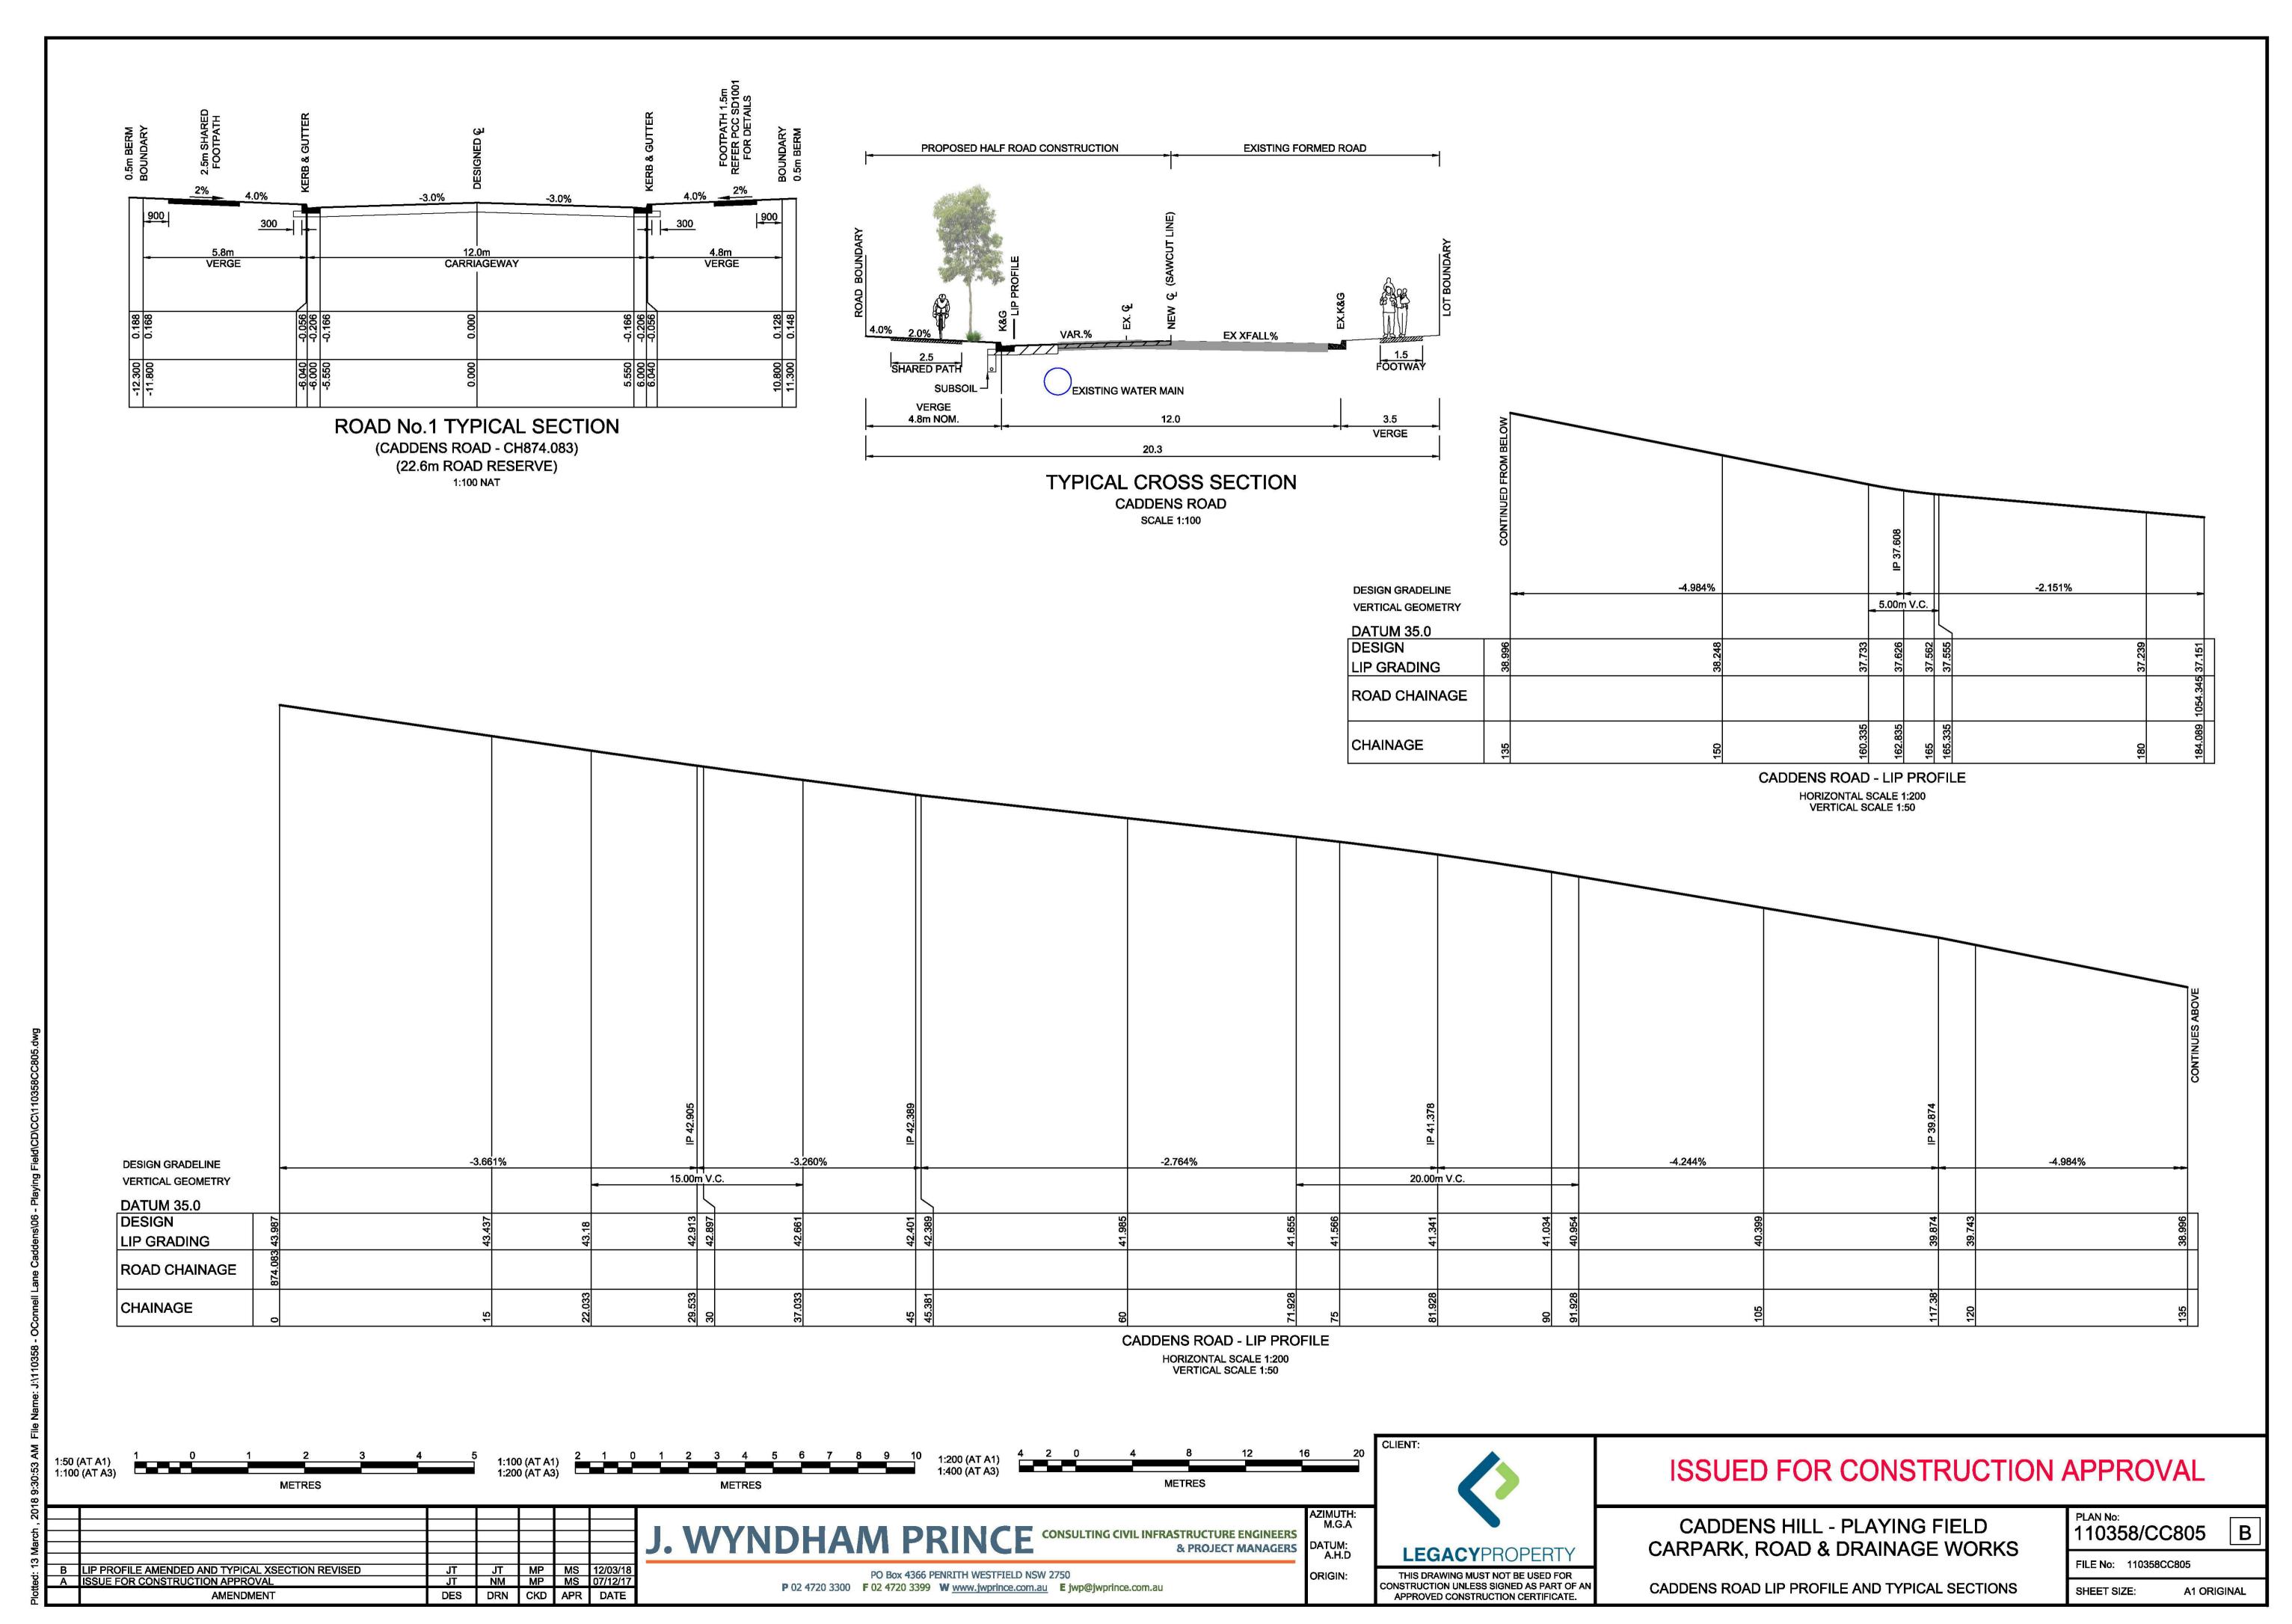

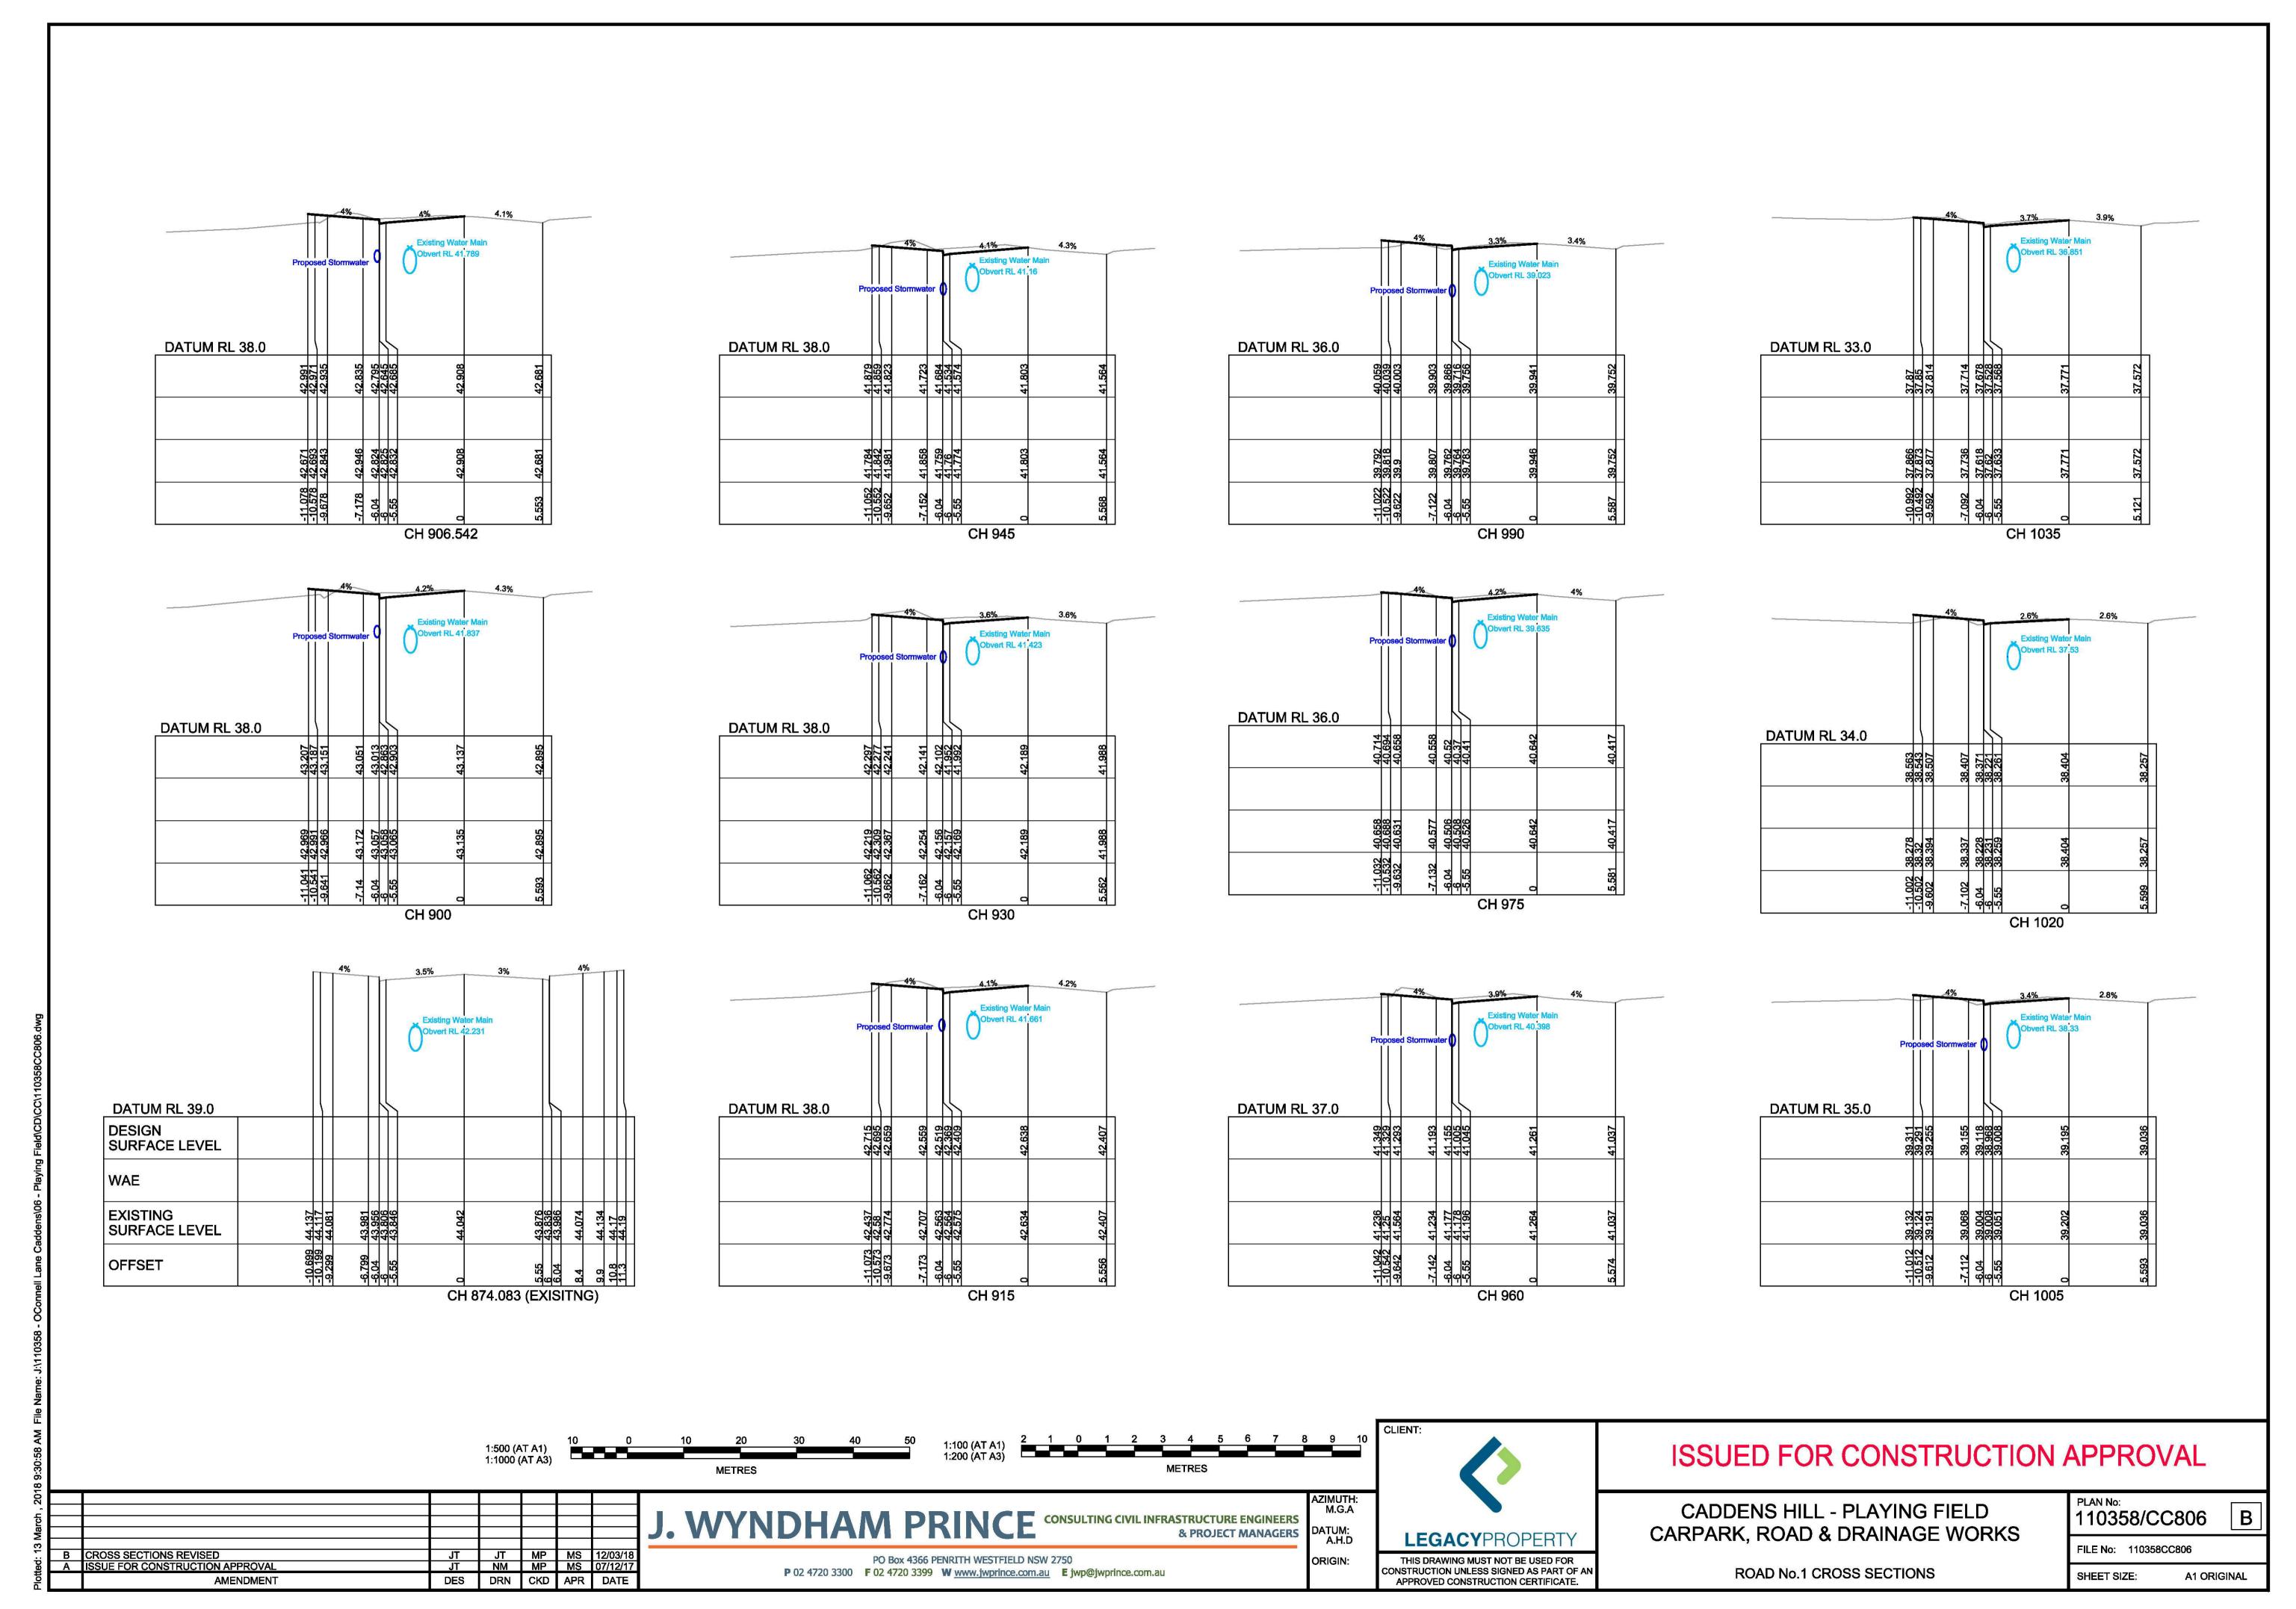


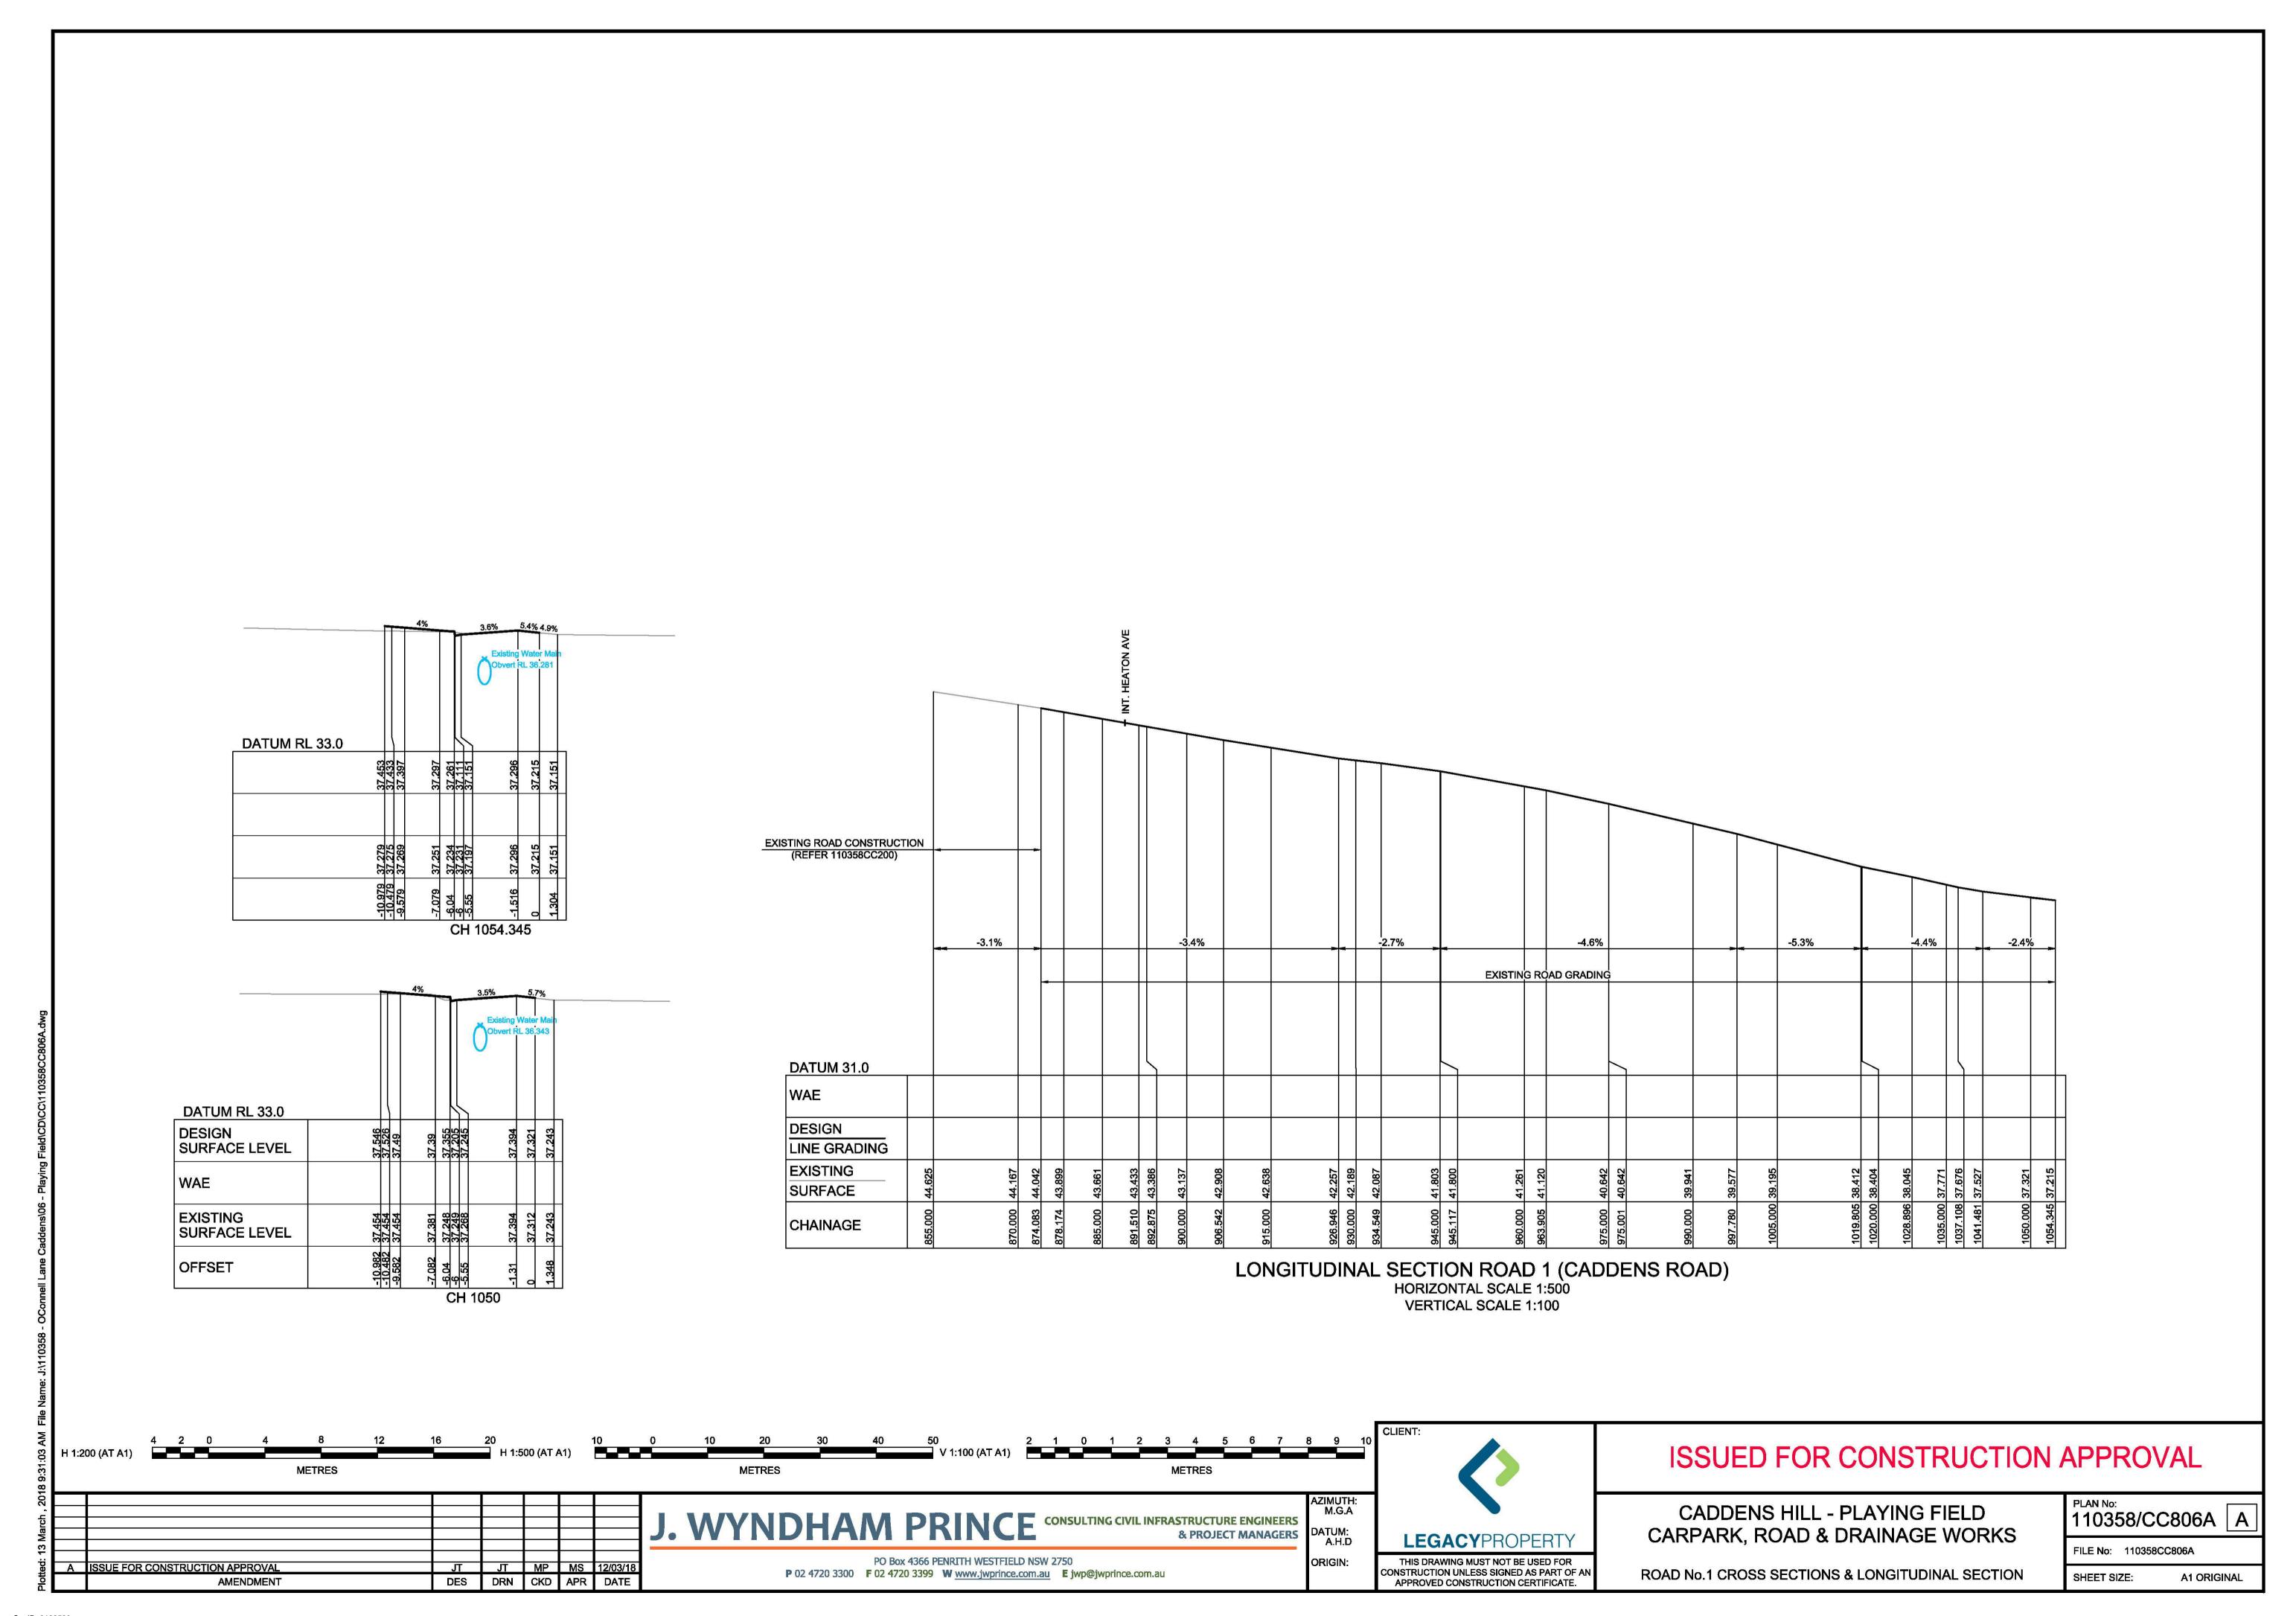

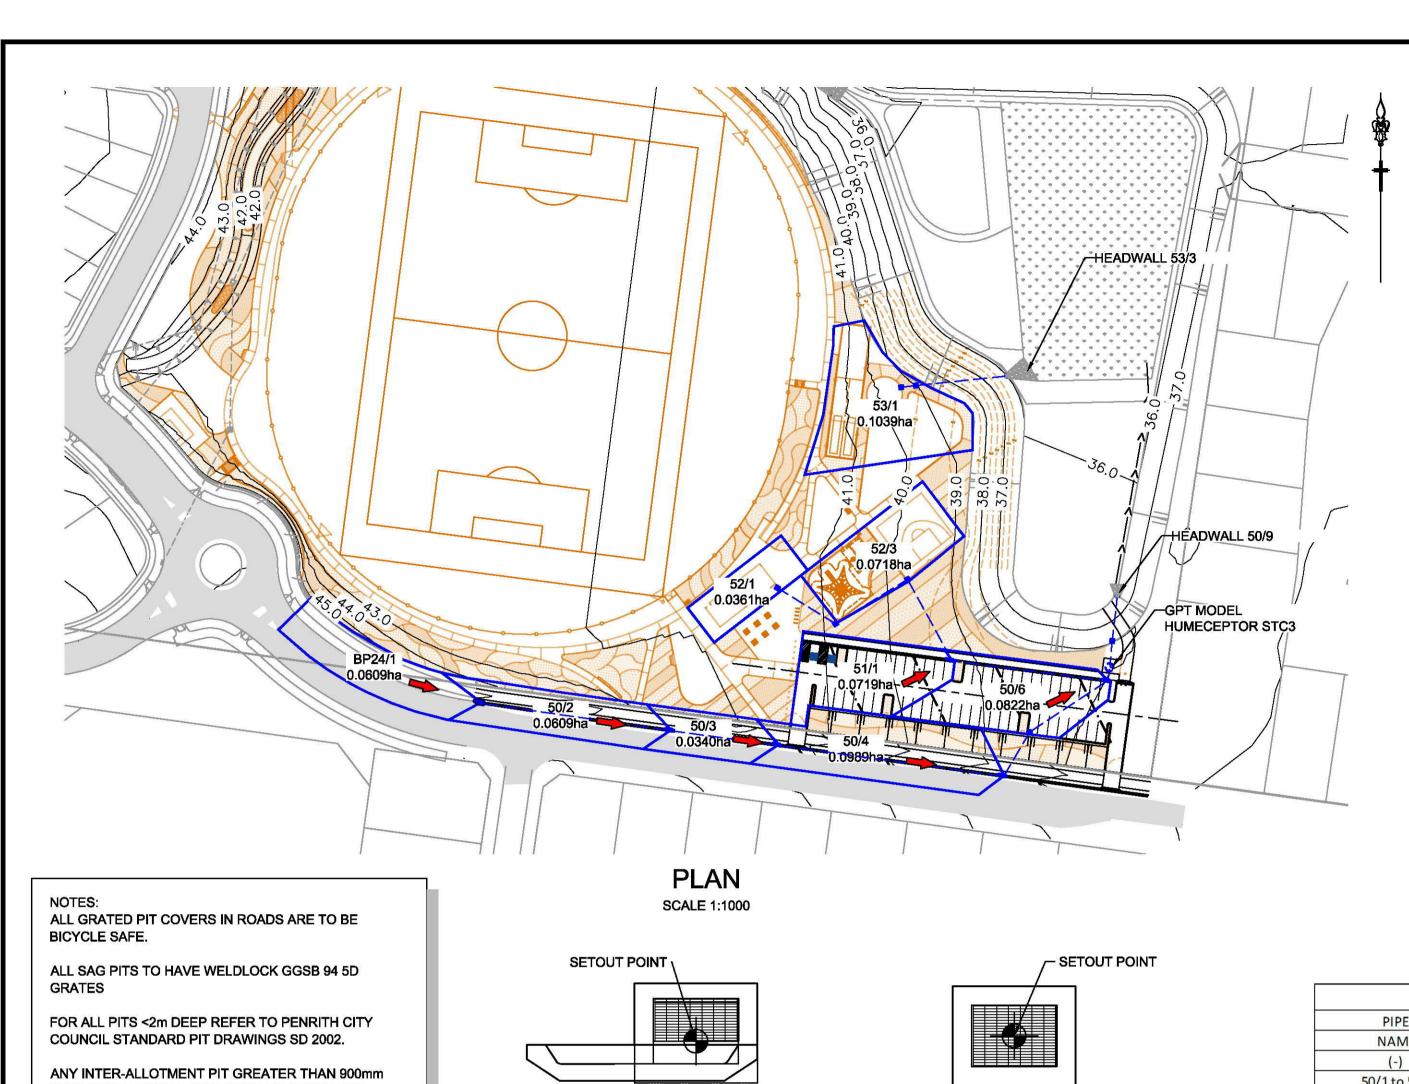

7.0m ADDITIONAL ROCK OVER PIPE MINIMUM 0.6m² **~**0.8m DIAMETER ANGULAR EXTEND WINGWALL AS ROCK GROUTED TO BASE INDICATED ON PLAN 375mm \_\_\_\_\_\_\_RL MEDIA BED 300mm THICK ROCK-APRON ON BIDIM A44

> **HEADWALL 53/3** SCALE N.T.S.

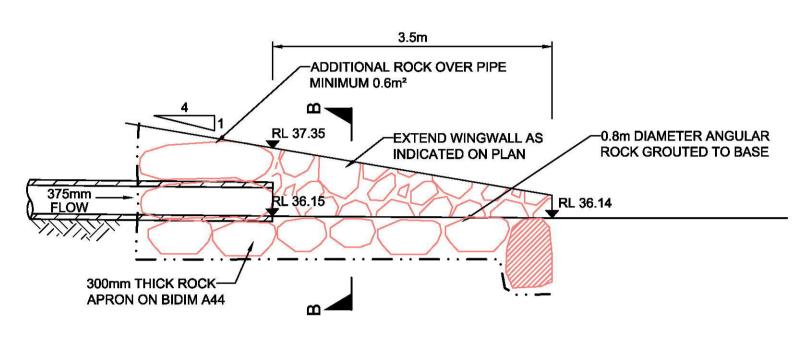

N.T.S

4.0m (NOM)

**HEADWALL OUTLET STRUCTURE** 

**LEGEND** 

PROPOSED CATCHMENT

- STACKED ROCK HEADWALL

MINIMUM 0.8m WIDTH

SIZED ROCK

FLOW DIRECTION


**HEADWALL 50/9** SCALE N.T.S.

DEEP SHALL HAVE A CONCRETE LID REFER PCC CONSTRUCTION SPEC SECTION 6.7.


SETOUT DETAIL KERB INLET PIT

(LINTEL)

GRATED SURFACE INLET PIT (GSIP)

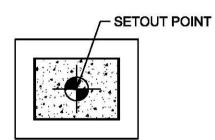

IAD - JUNCTION PIT (JP)

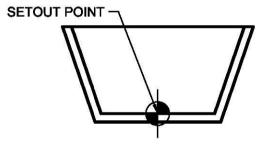

SETOUT DETAIL HEADWALL

							DE:	SIGN STO	ORM 1:5	Syr ARI	HYDRAU	LIC RES	ULTS	~							
PIPE	PIPE	PIPE	PIPE	PIPE	CRITICAL	PEAK	CAPACITY	PEAK	PIPE	PIPE	PIPE	U/S PIT	D/S PIT	PITLOSS	WSE LOSS	U/S PIPE	D/S PIPE	HGL	MINIMUM	MINIMUM	COMMENTS
NAME	DIAMETER	TYPE	LENGTH	GRADE	STORM	FLOW	RATIO	VELOCITY	U/S IL	D/S IL	D/S DROP	Ku	Kw	Ku.V'head	Kw.V'head	HGL	HGL	GRADE	COVER	FREEBOARD	
(-)	(mm)	(-)	(m)	(%)	(min)	(L/s)	(-)	(m/s)	(m)	(m)	(m)	(-)	(-)	(m)	(m)	(m)	(m)	(%)	(m)	(m)	
50/1 to 50/2	375	RRJ2	50.79	3.11	25	19	0.06	1.56	42.135	40.555	0.065	4.5	4.5	0.56	0.56	42.199	40.615	3.12	1.1	1.529	
50/2 to 50/3	375	RRJ2	28.7	2.73	25	37	0.12	1.78	40.491	39.707	0.093	2.62	2.62	0.35	0.35	40.586	39.795	2.76	1.1	1.448	
50/3 to 50/4	375	RRJ2	60.27	4.39	25	47	0.12	1.3	39.615	36.971	0.019	7	7	0.22	0.22	39.702	37.193	4.16	1.1	1.47	
50/4 to 50/5	375	RRJ2	13.36	1	25	75	0.39	1.24	36.953	36.819	0.05	9.7	9.7	0.21	0.21	37.193	36.983	1.57	1.22	1.228	
50/5 to 50/6	375	RRJ2	24.79	1	25	<b>7</b> 9	0.41	0.93	36.769	36.521	0.05	0.32	0.32	0.01	0.01	36.983	36.955	0.11	0.78	1.994	
50/6 to 50/7	375	RRJ2	3.5	1	25	153	0.81	1.46	36.471	36.436	0.05	1.75	2	0.18	0.2	36.955	36.737	6.24	0.93	0.665	
50/7 to 50/8	375	RRJ2	6.99	1	25	153	0.81	1.6	36.386	36.316	0.05	0.5	0.5	0.07	0.07	36.737	36.571	2.38	1.27	1.294	
50/8 to 50/9	375	RRJ2	11.63	1	25	153	0.8	1.75	36.266	36.15		0.2	0.2	0.03	0.03	36.565	36.405	1.38	1.21	1.363	
51/1 to 50/6	375	RRJ2	41.75	4	25	57	0.15	1.54	38.191	36.521	0.05	7	7	0.45	0.45	38.289	36.955	3.2	0.74	1.209	
52/1 to 52/2	150	uPVC	18.03	4.39	25	12	0.28	1.72	40.891	40.1	0.143	4.5	4.5	0.68	0.68	40.958	40.154	4.46	0.6	0.697	
52/2 to 52/3	225	uPVC	22.4	4.82	25	12	0.09	1.99	39.957	38.877	0.242	0.24	1.22	0.05	0.25	40.003	38.923	4.82	0.6	0.82	
52/3 to 51/1	225	uPVC	24.32	1	25	35	0.59	1.12	38.636	38.392	0.201	6.1	6.02	0.3	0.31	38.843	38.517	1.34	0.6	0.84	
53/1 to 53/2	300	uPVC	3.92	1	20	33	0.26	0.85	36.961	36.922	0.568	4.5	4.5	0.16	0.16	37.181	37.027	3.93	1.81	2.13	
53/2 to 53/3	375	RRJ2	23.85	4	20	33	0.09	0.48	36.354	35.4		2.09	2.71	0.02	0.03	36.429	36.36	0.29	0.27	2.561	
BP24/1 to BP24/2	2	No Flow	6.3	1	10	0	0	0	43.371	43.308	8.5	0	0	0	0	43.371	43.308	1	1.1	0.948	

								DESIGN STO	DRM 1:5yr AR	I HYDROLOGI	C RESULTS								
PIT	PIT	CATCHMENT	PERCENT	Tc	Tc	CRITICAL	APPROACH	CAPTURED	UNCAPTURED	GRATE	ROAD	ROAD	BYPASS		ВҮР	ASS CHANNEL			COMMENTS
NAME	TYPE	AREA	IMPERVIOUS	IMP	PERV	STORM	FLOW	FLOW	FLOW	DEPTH	GRADE	CROSSFALL	PIT	FLOW	U/S FLOW WIDTH	U/S VxD	D/S FLOW WIDTH	D/S VxD	
(-)	(-)	(Ha)	(%)	(min)	(min)	(min)	(L/s)	(L/s)	(L/s)	(mm)	(%)	(%)	(-)	(L/s)	(m)	(m/s^2)	(m)	(m/s^2)	(-)
50/1	1.8 m lintel		0	6	6	15	19	19	0	56	3.7	3.6	50/2	19	1	0.05	1	0.05	
50/2	1.8 m lintel	0.061	95	6	6	25	19	19	0	46	2.8	3.4	50/3	10	0.66	0.04	1.18	0.02	
50/3	1.8 m lintel	0.034	95	6	6	25	10	10	0	61	3.5	3.7	50/4	30	1.18	0.07	1.18	0.07	
50/4	1.8 m lintel	0.099	85	6	6		30	29	1	19	5	2.8	LOST	1	0.22		0.22		
50/5	JP		0	6	6		0	0	0	0									
50/6	1.8 m lintel	0.082	95	6	6	25	26	26	0	0									
50/7	GPT		0	6	6		0	0	0	0	5								
50/8	JP		0	6	6		0	0	0	0									1
50/9	H.W.						0	0	0	0									
51/1	1.8 m lintel	0.072	95	6	6	25	23	23	0	0									
52/1	NODE	0.036	100	6	6	25	12	12	0	0	8								
52/2	JP		0	6	6		0	0	0	0									
52/3	JP	0.072	100	6	6	15	23	23	0	0									
53/1	NODE	0.104	100	6	6	15	33	33	0	0									1
53/2	JP		0	6	6		0	0	0	0									
53/3	H.W.						0	0	0	0									
BP24/1	BYPASS NODE	0.061	85	6	6	25	19	0	0	56	3.3	3	50/1	19	1	0.05	1	0.05	
BP24/2	BYPASS NODE						0	0	0	0	•								

ł						
	PIT	PIT	PIT	PIT	PIT	COMMENTS
	NAME	TYPE	EASTING	NORTHING	DEPTH	
	(-)	(-)	(m)	(m)	(m)	
	50/1	1.8 m lintel	290815.07	6260206.418	1.593	
	50/2	1.8 m lintel	290865.332	6260199.122	1.544	
	50/3	1.8 m lintel	290893.764	6260195.23	1.557	
	50/4	1.8 m lintel	290953.479	6260187.055	1.468	
	50/5	JP	290960.273	6260198.562	2.208	
	50/6	1.8 m lintel	290980.968	6260212.214	1.149	
	50/7	GPT	290981.41	6260215.681	1.645	
	50/8	JP	290982.073	6260222.635	1.662	
	50/9	H.W.	290983.39	6260234.194	0.375	
	51/1	1.8 m lintel	290939.567	6260217.612	1.307	
	52/1	NODE	290893.442	6260236.669	0.765	
	52/2	JP	290908.791	6260227.209	0.866	
	52/3	JP	290927.875	6260238.937	1.047	
	53/1	NODE	290926.191	6260289.75	2.35	WATER TANK
	53/2	JP	290930.085	6260290.211	2.636	
	53/3	H.W.	290953.805	6260292.679	0.375	

PIT SCHEDULE

& PROJECT MANAGERS

B CARPARK ALIGNMENT AMENDED
A ISSUE FOR CONSTRUCTION APPROVAL JT JT MP MS 12/03/18 JT NM MP MS 07/12/17 DES DRN CKD APR DATE **AMENDMENT** 

J. WYNDHAM PRINCE CONSULTING CIVIL INFRASTRUCTURE ENGINEERS & PROJECT MANAGERS

PO Box 4366 PENRITH WESTFIELD NSW 2750 P 02 4720 3300 F 02 4720 3399 W <u>www.jwprince.com.au</u> E jwp@jwprince.com.au

AZIMUTH: M.G.A DATUM: A.H.D **LEGACY**PROPERTY ORIGIN: THIS DRAWING MUST NOT BE USED FOR CONSTRUCTION UNLESS SIGNED AS PART OF AN APPROVED CONSTRUCTION CERTIFICATE.


# ISSUED FOR CONSTRUCTION APPROVAL


CADDENS HILL - PLAYING FIELD CARPARK, ROAD & DRAINAGE WORKS

CATCHMENT PLAN

FILE No: 110358CC807 A1 ORIGINAL SHEET SIZE:

110358/CC807

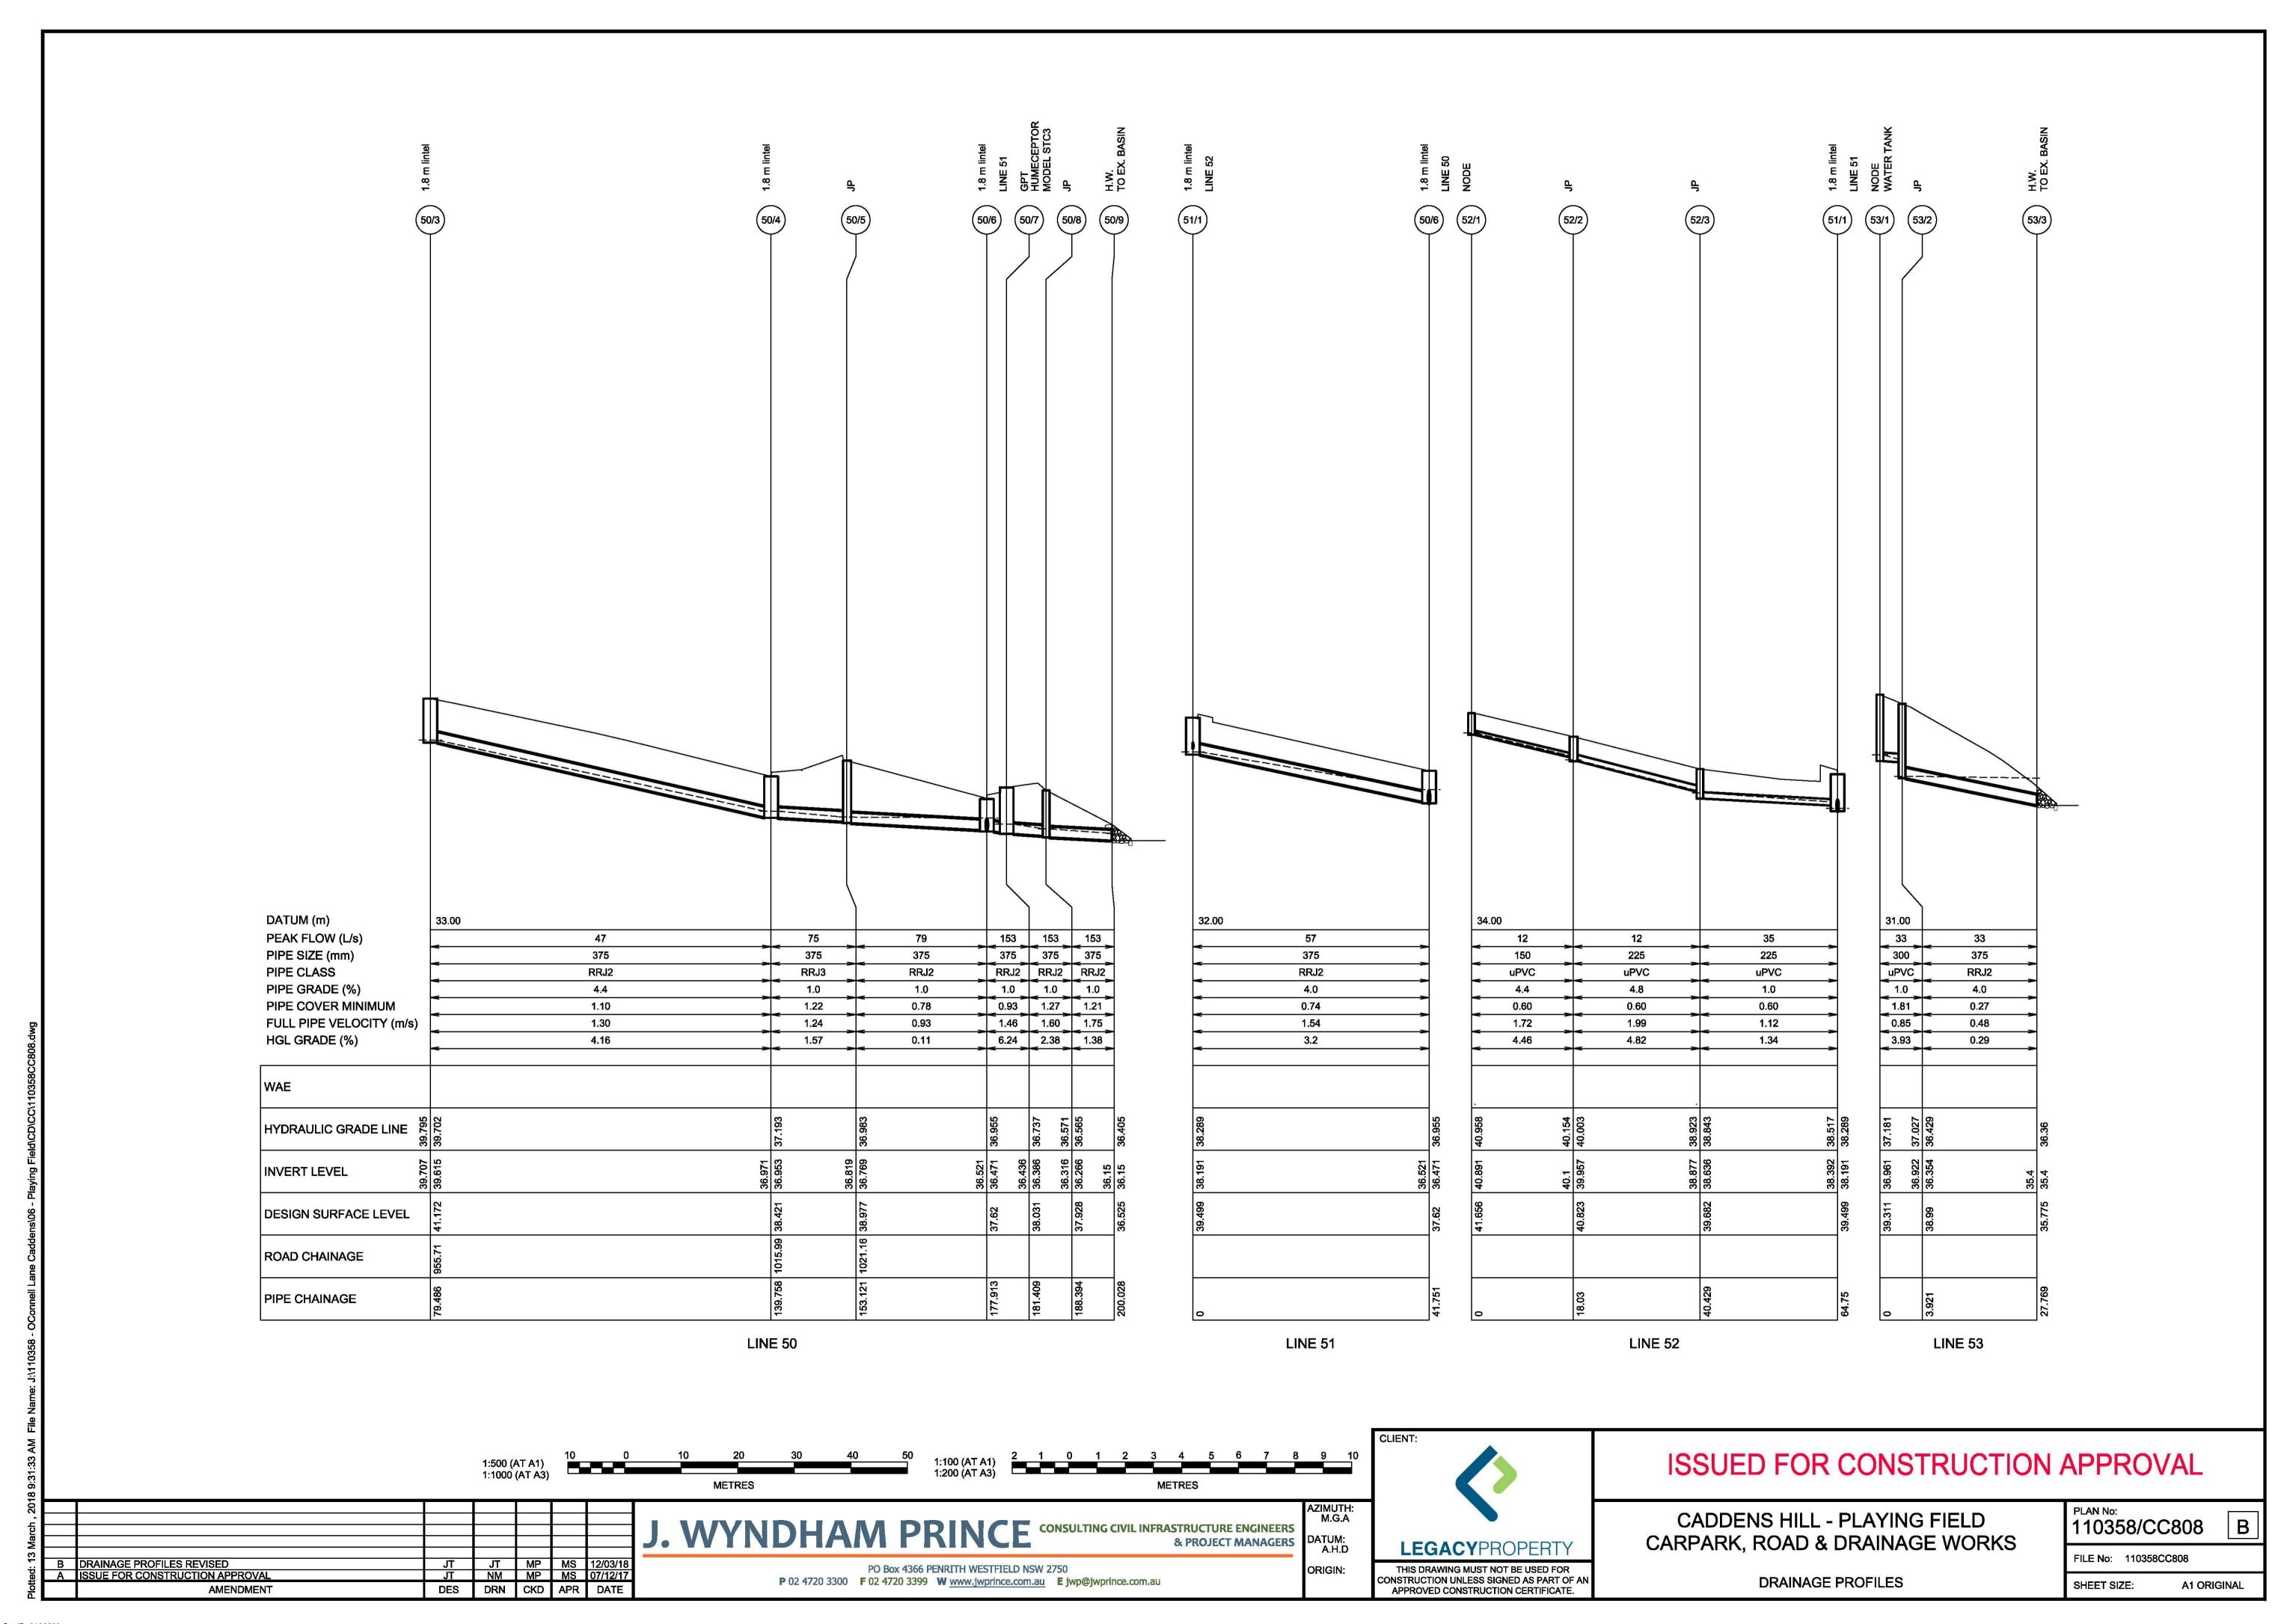

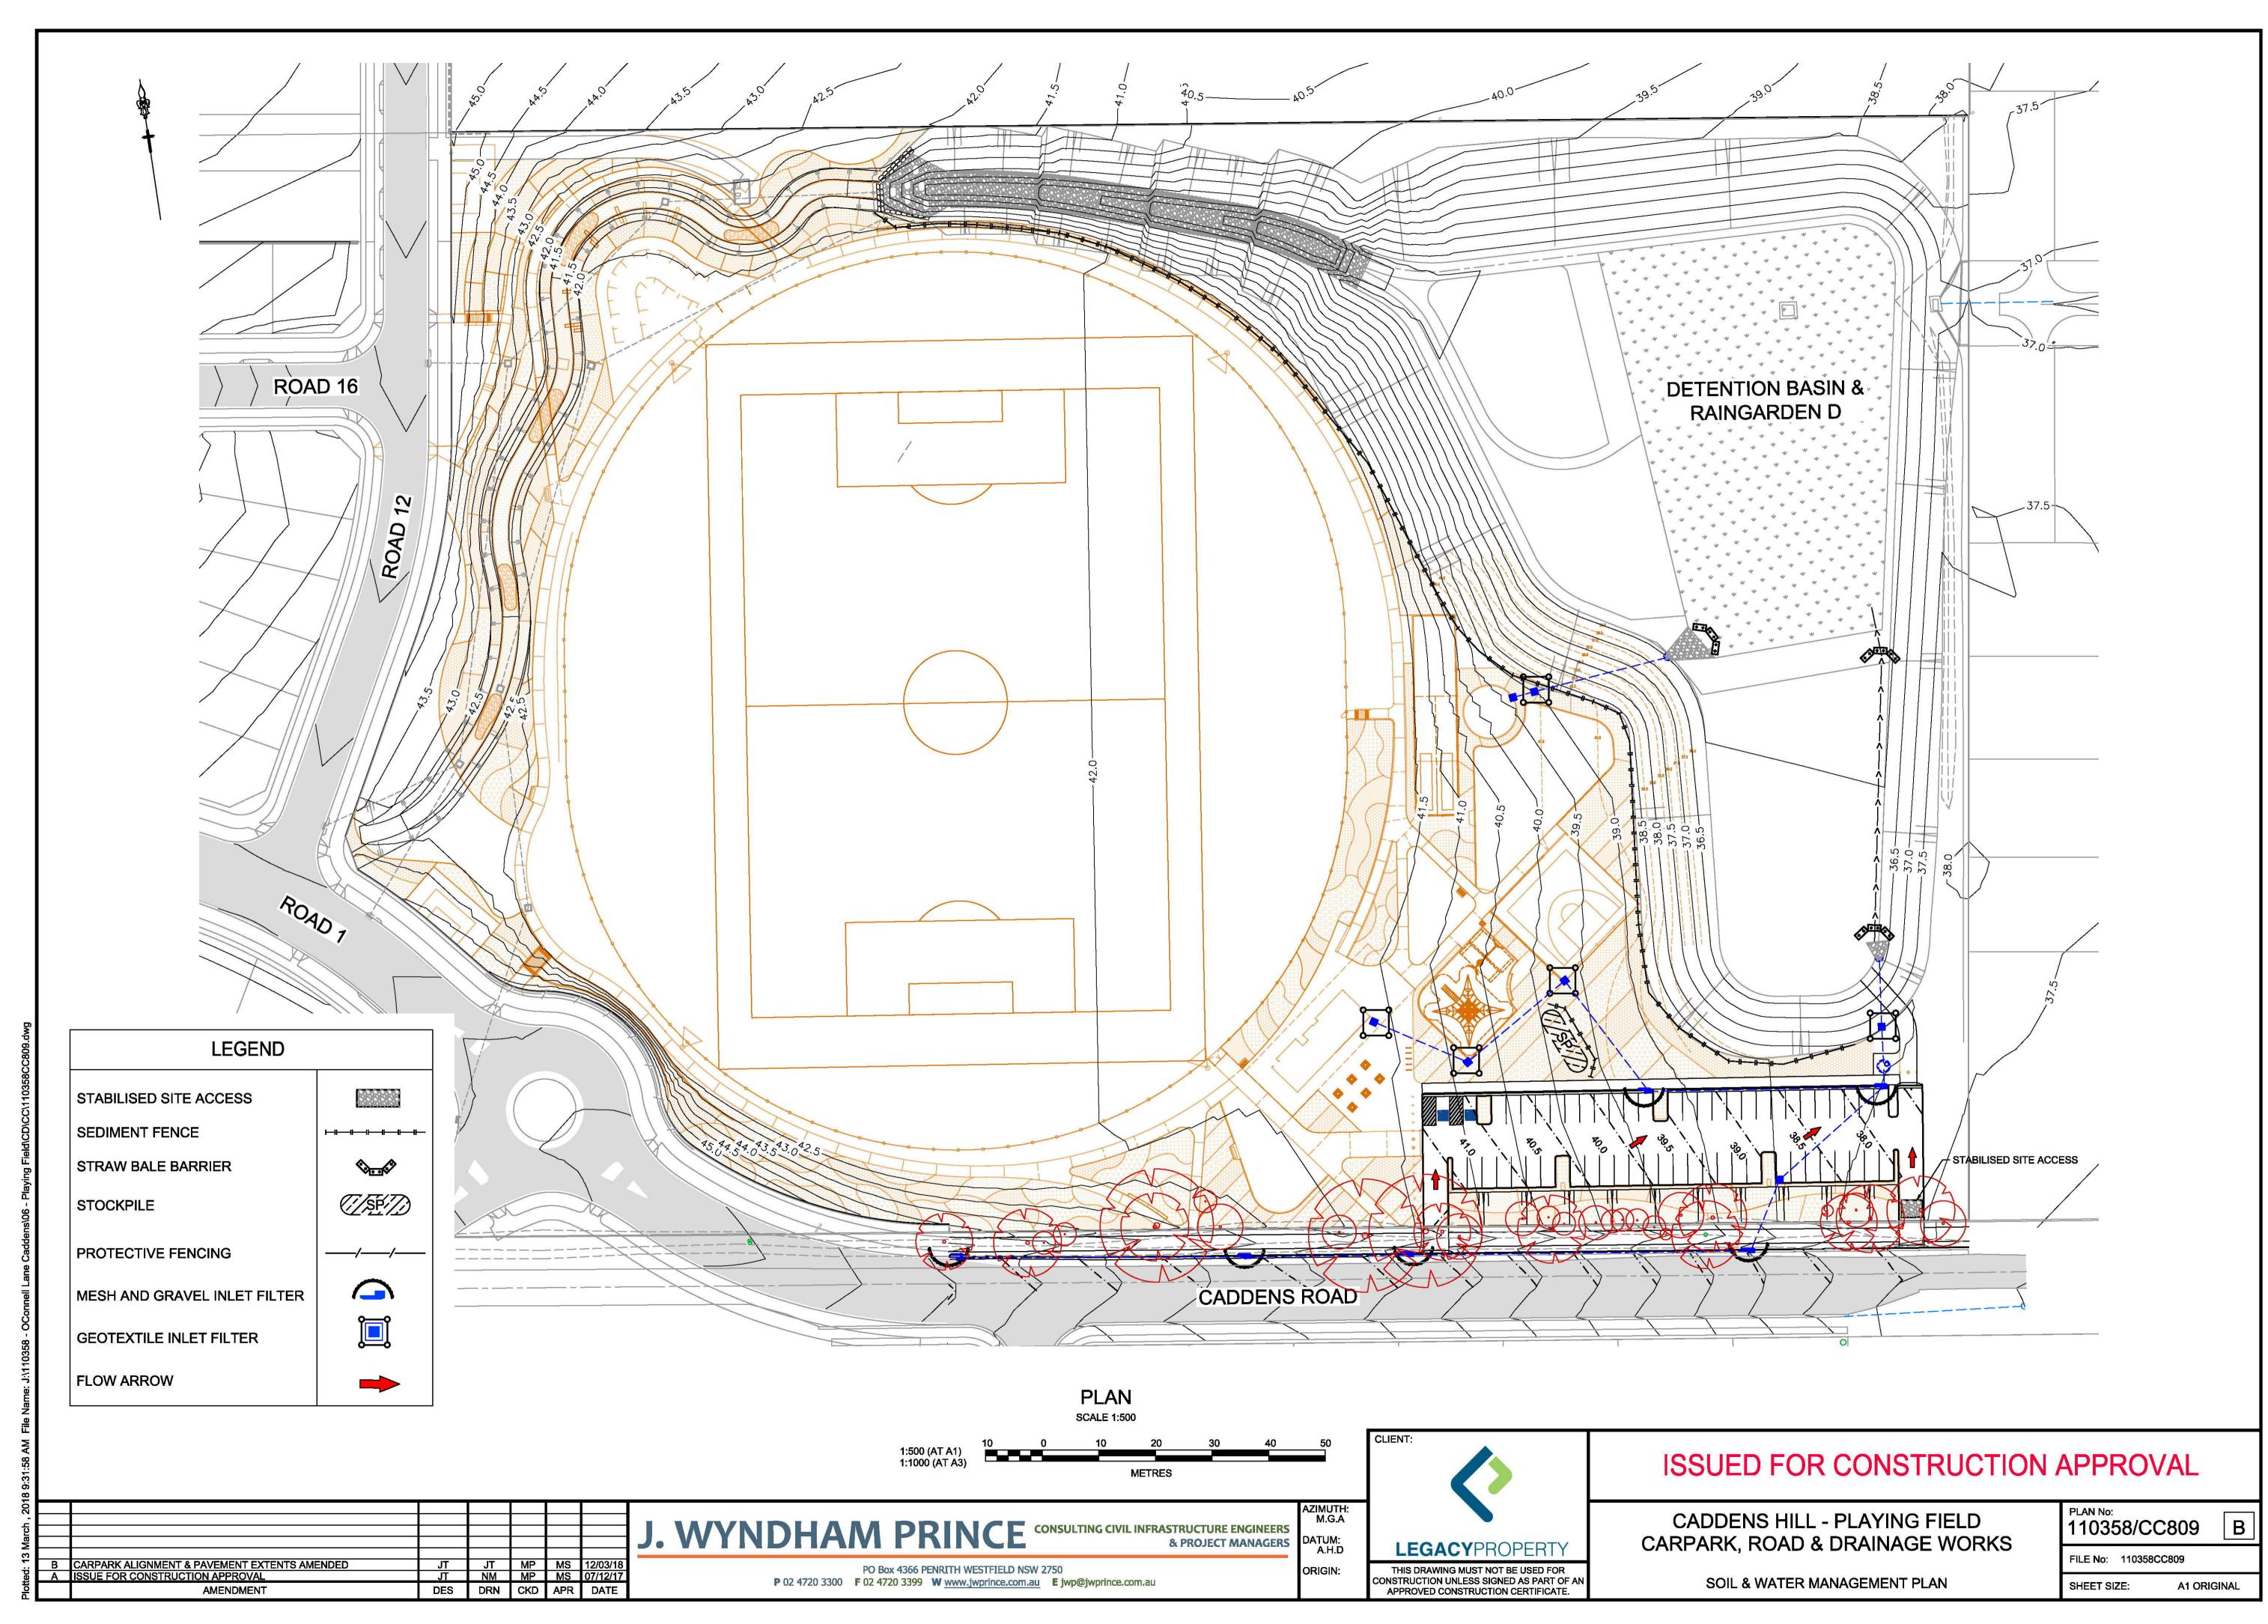

## **GENERAL NOTES:**

- 1. ALL EROSION AND SEDIMENT CONTROL MEASURES AND STANDARD DRAWINGS, INCLUDING REVEGETATION AND STORAGE OF SOIL AND TOPSOIL, SHALL BE IMPLEMENTED TO THE REQUIREMENTS OF THE "SOILS AND CONSTRUCTION - VOLUME 1, 4TH EDITION, MARCH 2004 ".
- 2. TOPSOIL FROM ALL AREAS TO BE DISTURBED SHALL BE STOCKPILED AND LATER RESPREAD TO AID REVEGETATION IN THOSE AREAS.
- 3. ALL DRAINAGE WORKS SHALL BE CONSTRUCTED AND STABILISED AS EARLY AS POSSIBLE DURING
- 4. ALL TAIL-OUT DRAINS SHALL BE COUCH GRASSED AND TRAPEZOIDAL IN SECTION. STRAW BALES SHALL BE PLACED AS A SEDIMENT CONTROL DEVICE WHERE REQUIRED.
- 5. VEHICULAR TRAFFIC SHALL BE CONTROLLED DURING DEVELOPMENT CONFINING ACCESS WHERE POSSIBLE TO PROPOSED OR EXISTING ROAD ALIGNMENTS. AREAS TO BE LEFT UNDISTURBED SHALL BE MARKED OFF.
- 6. ROADS SHALL BE PAVED AS EARLY AS POSSIBLE AFTER FORMATION.
- 7. DISTURBANCE OF VEGETATION SHALL BE LIMITED TO FILL AREAS, ROADWAYS AND DRAINAGE LINES. NO LOT GRADING SHALL BE CARRIED OUT IN UNDISTURBED AREAS WITHOUT CONSULTATION WITH COUNCIL'S
- 8. ALL DISTURBED AREAS SHALL BE REVEGETATED AS SOON AS THE RELEVANT WORKS ARE COMPLETED.
- 9. ALL SEDIMENT BASINS AND TRAPS SHALL BE CLEANED WHEN THE STRUCTURES ARE A MAXIMUM 60% FULL OF SOLID MATERIALS, INCLUDING DURING THE MAINTENANCE PERIOD.
- 10. THE SOIL AND WATER MANAGEMENT PLAN IS TO BE READ IN CONJUNCTION WITH THE ENGINEERING PLANS, AND COUNCIL'S WRITTEN GUIDELINES FOR THE DEVELOPMENT OF LAND.
- 11. CONTRACTORS SHALL ENSURE THAT ALL SOIL AND WATER MANAGEMENT WORKS ARE UNDERTAKEN AS SPECIFIED ON THE PLAN AND IN ACCORDANCE WITH THE GUIDELINES SHOWN IN "MANAGING URBAN STORMWATER - SOILS AND CONSTRUCTION 4TH EDITION" ("THE BLUE BOOK").
- 12. ALL CONTRACTORS AND SUBCONTRACTORS ARE RESPONSIBLE FOR REDUCING THE SOIL EROSION AND POLLUTION OF DOWNSLOPE AREAS.
- 13. THE SOIL EROSION HAZARD ON THE SITE IS TO BE KEPT AS LOW AS POSSIBLE AND GENERALLY IN ACCORDANCE WITH THE FOLLOWING SCHEDULE:

LAND USE	LIMITATION	COMMENTS
CONSTRUCTION AREAS	DISTURBANCE TO BE NO FURTHER THAN 5m (PREF 2m) FROM THE EDGE OF ANY ESSENTIAL ENGINEERING ACTIVITY AS SHOWN ON THESE PLANS	ALL SITE WORKERS WILL CLEARLY RECOGNISE THESE ZONES - WHERE APPROPRIATE THE CONSTRUCTION AREAS ARE TO BE IDENTIFIED WITH BARRIER FENCING (DOWNSLOPE) OR SIMILAR MATERIAL.
ACCESS AREAS	LIMITED TO A MAXIMUM WIDTH OF 10m	THE SITE MANAGER SHALL DETERMINE AND MARK THE LOCATION OF THESE ZONES ONSITE. THEY CAN VARY IN POSITION TO BEST CONSERVE THE EXISTING VEGETATION AND PROTECT DOWNSTREAM AREAS WHILE BEING CONSIDERATE OF THE NEEDS OF EFFICIENT WORKS ACTIVITIES. ALL SITE WORKERS SHALL CLEARLY RECOGNISE THEIR BOUNDARIES. WHERE APPROPRIATE THE ACCESS AREAS ARE TO BE MARKED WITH BARRIER MESH, SEDIMENT FENCING OR SIMILAR MATERIALS.
REMAINING LANDS	ENTRY PROHIBITED EXCEPT FOR ESSENTIAL THINNING OF PLANT GROWTH	THINNING OF GROWTH MAY BE REQUIRED FOR FIRE HAZARD REDUCTION.

WORKS WITHIN WATERWAYS AND CREEKS SHALL BE RESTRICTED AS DIRECTED - ALL LANDS WITHIN CREEKS AND WATERWAYS SHALL HAVE C-FACTORS BELOW 0.05 FROM 1st JANUARY TO 15th MAY USING MATERIALS THAT CAN CATER FOR CONCENTRATED FLOWS.

- 14. WORKS ARE TO BE UNDERTAKEN IN THE FOLLOWING SEQUENCE. EACH SUBSEQUENT STAGE IS NOT TO COMMENCE UNTIL THE PREVIOUS ONE IS COMPLETE:-
- a. INSTALL ALL BARRIER AND SEDIMENT FENCING WHERE SHOWN ON THE PLAN AND TO DETAIL(SD) 6-8.
- b. CONSTRUCT STABILISED SITE ACCESS AS SHOWN ON THE PLAN AND TO DETAIL (SD) 6-14.
- c. CONSTRUCT LOW FLOW EARTH BANKS WHERE SHOWN ON THE PLAN AND TO DETAIL (SD) 5-5. d. PROVIDE TEMP. ACCESS TO THE SEDIMENT BASIN(S)AND PROTECT THIS WITH SEDIMENT FENCING (SD) 6-8
- OR BARRIER FENCING AND EARTH BANKS (SD) 5-5. e. PLACE SEDIMENT FENCING (SD) 6-8 DOWNSLOPE OF LANDS TO BE DISTURBED FOR CONSTRUCTION OF
- THE SEDIMENT BASINS. f. CONSTRUCT SEDIMENT BASIN(S) GENERALLY IN ACCORDANCE WITH (SD) 6-4
- g. STABILISE LAND SURFACES DISTURBED BY CONSTRUCTION OF THE SEDIMENT BASIN(S) AS SOON AS FINAL LEVELS ARE ESTABLISHED
- h. CLEAR THE SITE AND STRIP AND STOCKPILE THE TOPSOIL IN THE LOCATIONS SHOWN ON THE PLAN OR AS DIRECTED BY THE SITE SUPERINTENDENT TO DETAIL (SD) 4-1.
- UNDERTAKE ALL ESSENTIAL CONSTRUCTION WORKS. GRADE LOT AREAS TO FINAL GRADES AND APPLY PERMANENT STABILISATION (LANDSCAPING) WITHIN 14 DAYS OF COMPLETION OF CONSTRUCTION WORKS.
- k. REMOVE TEMPORARY EROSION CONTROL MEASURES AFTER THE PERMANENT LANDSCAPING HAS BEEN COMPLETED.
- 15. CLEARLY VISIBLE BARRIER FENCING SHALL BE INSTALLED WHERE DIRECTED BY THE SITE SUPERINTENDENT
- 16. EARTH BATTERS SHALL BE CONSTRUCTED WITH AS LOW A GRADIENT AS PRACTICABLE BUT NO STEEPER THAN:-
- a. 2(h) 1(v) WHERE SLOPE LENGTH IS LESS THAN 7m
- b. 2.5(h) 1(v) WHERE SLOPE LENGTH IS BETWEEN 7m AND 10m

TO CONTROL AND PROHIBIT UNNECESSARY SITE DISTURBANCE

- c. 3(h) 1(v) WHERE SLOPE LENGTH IS BETWEEN 10m AND 12m
- d. 4(h) 1(v) WHERE SLOPE LENGTH IS BETWEEN 12m AND 18m e. 5(h) - 1(v) WHERE SLOPE LENGTH IS BETWEEN 18m AND 27m
- f. 6(h) 1(v) WHERE SLOPE LENGTH IS GREATER THAN 27m

SLOPE LENGTHS CAN BE SHORTENED BY USING LOW FLOW EARTH BANKS AS CATCH DRAINS ABOVE THE EARTH BATTER AREA.

NM MP MS 07/12/17

DES DRN CKD APR DATE

- 17. PROTECTION FROM EROSIVE FORCES SHALL BE UNDERTAKEN ON ALL LANDS TO MEET THE REQUIREMENTS OF TABLE J3-3 "MAXIMUM ACCEPTABLE C-FACTORS AT NOMINATED TIMES DURING WORKS" FROM "MANAGING URBAN STORMWATER - SOILS AND CONSTRUCTION 4TH EDITION"
- 18. TEMPORARY GROUND COVER IN SHEET FLOW AREAS IS TO BE IN ACCORDANCE WITH TABLE J3-4 "PLANT SPECIES FOR GROUND COVER" FROM "MANAGING URBAN STORMWATER - SOILS AND CONSTRUCTION 4TH EDITION" WHERE PRACTICAL FOOT AND VEHICULAR TRAFFIC SHALL BE KEPT AWAY FROM REHABILITATED
- 19. WHERE POSSIBLE THE CONSTRUCTION PROGRAM IS TO BE SCHEDULED SO THAT THE TIME FROM STARTING LAND DISTURBANCE ACTIVITIES TO STABILISATION IS A DURATION OF LESS THAN 6 MONTHS - THIS MEANS ACHIEVING A C-FACTOR OF LESS THAN 0.1 AND SETTING IN MOTION A PROGRAM THAT ENSURES THAT IT DROPS PERMANENTLY, (BY VEGETATION, PAVING, ARMOURING etc.) TO LESS THAN 0.05 WITHIN A FURTHER 60 DAYS. LOCAL WATER RESTRICTIONS PERMITTING, LANDS THAT HAVE BEEN NEWLY PLANTED WITH GRASS SPECIES SHALL BE WATERED REGULARLY UNTIL AN EFFECTIVE COVER HAS BEEN ESTABLISHED AND PLANTS ARE GROWING VIGOROUSLY. FOLLOW-UP SEED AND FERTILISER SHALL BE APPLIED AS NECESSARY IN AREAS OF MINOR SOIL EROSION AND/OR INADEQUATE VEGETATIVE PROTECTION. NOTWITHSTANDING THIS SCHEDULE WORKS SO THAT THE DURATION FROM THE CONCLUSION OF LAND SHAPING TO THE COMPLETION OF FINAL STABILISATION IS LESS THAN 20 WORKING DAYS.
- 20. SEDIMENT FENCES (SD) 6-8 SHALL:-
- a. BE INSTALLED WHERE SHOWN ON THE PLAN AND AS DIRECTED AT THE DISCRETION OF THE SITE SUPERINTENDENT DURING THE COURSE OF CONSTRUCTION TO CONTAIN THE COARSER SEDIMENT FRACTIONS AS NEAR AS POSSIBLE TO THEIR SOURCE.
- b. HAVE A CATCHMENT AREA NOT EXCEEDING 720sq.m. AND A STORAGE DEPTH OF AT LEAST 0.6m.
- c. PROVIDE AN UPSLOPE RETURN OF 1m AT INTERVALS ALONG THE FENCE WHERE THE CATCHMENT AREA EXCEEDS 720sq.m. TO LIMIT THE DISCHARGE REACHING EACH SECTION TO 50litres/sec IN A MAX. 10yr Tc DISCHARGE.
- 21. STOCKPILES (SD) 4-1 SHALL BE LOCATED AS SHOWN ON THE PLANS AND AT THE DISCRETION OF THE SITE
- 22. DURING WINDY WEATHER LARGE UNPROTECTED AREAS ARE TO BE KEPT MOIST (NOT WET) BY SPRINKLING WITH WATER TO KEEP DUST UNDER CONTROL. IN THE EVENT WATER IS NOT AVAILABLE IN SUFFICIENT QUANTITIES SOIL BINDERS AND/OR DUST RETARDANTS SHALL BE USED OR THE SURFACE SHALL BE LEFT IN A CLODDY STATE THAT RESISTS REMOVAL BY WIND.
- 23. STOCKPILES SHALL NOT BE LOCATED WITHIN 5m OF HAZARD AREAS, INCLUDING LIKELY AREAS OF HIGH VELOCITY FLOWS SUCH AS WATERWAYS, PAVED AREAS OR DRIVEWAYS.
- 24. THE SEDIMENT RETENTION BASINS (SD) 6-4 SHALL:-
- a. BE CONSTRUCTED WHERE SHOWN ON THE PLANS.
- b. BE FLOCCULATED (APPENDIX E MANAGING URBAN STORMWATER SOILS & CONSTRUCTION 4TH ED.) BEFORE DISCHARGE OCCURS (UNLESS THE DESIGN STORM EVENT IS EXCEEDED)
- c. HAVE ONE OR MORE PEGS PLACED ON THE FLOOR TO CLEARLY INDICATE THE LEVEL AT WHICH DESIGN CAPACITY OCCURS AND WHEN SEDIMENT SHALL BE REMOVED.
- 25. STORED CONTENTS OF THE BASINS SHALL BE TREATED WITH GYPSUM (APPENDIX E MANAGING URBAN STORMWATER SOILS & CONSTRUCTION 4TH ED.) OR OTHER FLOCCULATING AGENTS WHERE THEY CONTAIN MORE THAN 50mg/litre OF SUSPENDED SOLIDS. TREATMENT SHALL BE AS FOLLOWS:-
- a. LOWER SUSPENDED SOLIDS TO LESS THAN 50mg/litre WITHIN 24hrs OF FILLING
- b. THE BASINS SHALL THEN BE ALLOWED TO STAND 36 TO 48hrs FOR FLOCCULATED PARTICLES TO SETTLE c. THE BASINS SHALL THEN BE DRAINED SO THAT FULL STORAGE CAPACITY IS REGAINED WITHOUT DISCHARGING SEDIMENT FROM THE SITE.
- 26. SEDIMENT REMOVED FROM ANY TRAPPING DEVICE SHALL BE DISPOSED IN LOCATIONS WHERE FURTHER EROSION AND CONSEQUENT POLLUTION TO DOWNSLOPE LANDS AND WATERWAYS SHALL NOT OCCUR.
- 27. WATER SHALL BE PREVENTED FROM DIRECTLY ENTERING THE PERMANENT DRAINAGE SYSTEM UNLESS IT IS RELATIVELY SEDIMENT FREE (ie THE CATCHMENT HAS BEEN LANDSCAPED AND/OR ANY LIKELY SEDIMENT HAS BEEN TREATED IN AN APPROVED DEVICE) NEVERTHELESS STORMWATER INLETS SHALL BE PROTECTED
- 28. TEMPORARY SOIL AND WATER MANAGEMENT STRUCTURES SHALL BE REMOVED ONLY AFTER THE LANDS THEY ARE PROTECTING ARE STABILISED.
- 29. ACCEPTABLE BINS SHALL BE PROVIDED FOR ANY CONCRETE AND MORTAR SLURRIES, PAINTS, ACID WASHINGS, LIGHTWEIGHT WASTE MATERIALS AND LITTER. CLEARANCE SERVICES SHALL BE PROVIDED AT LEAST ONCE A WEEK.

## STOCKPILE NOTES:

- 1. SPOIL AND TOPSOIL STOCKPILES SHALL BE LOCATED AWAY FROM DRAINAGE LINES AND AREAS WHERE WATER MAY CONCENTRATE.
- 2. IF STOCKPILES ARE TO BE IN PLACE FOR LONGER THAN 14 DAYS THEN THEY SHALL BE STABILIZED BY COVERING WITH A MULCH OR WITH TEMPORARY VEGETATION.
- 3. FOLLOWING CONSTRUCTION, TOPSOIL SHALL BE RESPREAD TO A MINIMUM DEPTH OF 100mm ON THE BARE
- SOIL SURFACES AND REVEGETATED.

## SEDIMENTATION CONTROL DEVICES:

- ALL STRAW BALES SHALL BE BOUND WITH WIRE. STRAW BALES SHALL BE PLACED END TO END IN A SINGLE ROW AND EMBEDDED INTO THE SOIL TO A DEPTH OF 100mm. EACH BALE SHALL BE SECURELY ANCHORED WITH TWO STEEL STAKES DRIVEN 600mm INTO THE GROUND AND LOCKED ON THE BALE CENTRELINE.
- 2. SILT FENCES SHALL BE CONSTRUCTED BY STRETCHING A FILTER FABRIC (PROPEX OR SIMILAR) BETWEEN POSTS AT 2.5m CENTRES. FABRIC SHALL BE BURIED 150mm ALONG IT'S LOWER EDGE.
- 3. PROVIDE STRIP OF TURF MIN. 300mm WIDE BEHIND KERB + 1m WIDE AROUND ALL SURFACE INLET PITS

## SITE INSPECTION AND MAINTENANCE:

- A SELF-AUDITING PROGRAM SHALL BE ESTABLISHED BASED ON A INSPECTION TEST PLAN (ITP) OR LOG BOOK. A SITE INSPECTION USING THE ITP SHALL BE MADE BY THE SITE MANAGER -:
- a. AT LEAST WEEKLY
- b. IMMEDIATELY BEFORE SITE CLOSURE
- c. IMMEDIATELY FOLLOWING RAINFALL EVENTS IN EXCESS OF 5mm IN ANY 24hr PERIOD.

## THE SELF AUDIT SHALL INCLUDE:-

- a. RECORDING THE CONDITION OF EVERY 'BEST MANAGEMENT PRACTICE' EMPLOYED
- b. RECORDING MAINTENANCE REQUIREMENTS (IF ANY) FOR EACH 'BEST MANAGEMENT PRACTICE'
- c. RECORDING THE VOLUMES OF SEDIMENT REMOVED FROM SEDIMENT RETENTION SYSTEMS WHERE **APPLICABLE**
- d. RECORDING THE SITE WHERE SEDIMENT IS DISPOSED
- e. FORWARDING A SIGNED DUPLICATE OF THE COMPLETED CHECK SHEET TO THE PROJECT MANAGER/DEVELOPER FOR THEIR INFORMATION.
- 2. IN ADDITION A SUITABLY QUALIFIED PERSON SHALL BE RESPONSIBLE FOR OVERSEEING THE INSTALLATION
- REQUIRED TO SPEND A MINIMUM OF:a. 2hrs ONSITE EACH FORTNIGHT UP UNTIL COMPLETION OF ROAD AND DRAINAGE WORKS AND/OR THE
- COMMISSIONING OF SEDIMENT BASIN(S)/WATER QUALITY CONTROL FACILITIES, AND DURING THE DECOMMISSIONING OF SAME AND/OR FINAL SITE STABILISATION. TO PROVIDE A SHORT MONTHLY WRITTEN REPORT

AND MAINTENANCE OF ALL SOIL AND WATER MANAGEMENT WORKS ON THE SITE. THE PERSON SHALL BE

b. ONE HOUR ONSITE EACH 2 MONTHS DURING THAT PHASE WHERE THE DEVELOPERS RESPONSIBILITIES ARE LIMITED TO MAINTENANCE OF THE SDS DEVICES AND/OR SEDIMENT BASINS (ie DURING THE STAGE WHEN BUILDING WORKS CAN BE UNDERTAKEN) TO PROVIDE A SHORT WRITTEN REPORT EACH 4 MONTHS

### THE RESPONSIBLE PERSON SHALL ENSURE THAT:-

- a. THIS PLAN IS BEING IMPLEMENTED CORRECTLY
- b. REPAIRS ARE BEING UNDERTAKEN AS REQUIRED c. ESSENTIAL MODIFICATIONS TO THIS PLAN ARE BEING MADE IF AND WHEN NECESSARY. EACH REPORT
- SHALL CERTIFY THAT WORKS HAVE BEEN CARRIED OUT ACCORDING TO THE APPROVED PLANS.
- 3. WASTE BINS SHALL BE EMPTIED AS NECESSARY, DISPOSAL OF WASTE SHALL BE IN A MANNER APPROVED BY THE SITE SUPERINTENDENT
- 4. PROPER DRAINAGE OF THE SITE SHALL BE MAINTAINED. DRAINS (INCLUDING INLET AND OUTLET WORKS) SHALL BE CHECKED TO ENSURE THAT THEY ARE OPERATING AS INTENDED, ESPECIALLY THAT:-
- a. NO LOW POINTS EXIST WHICH CAN OVERTOP IN A LARGE STORM EVENT.
- b. AREAS OF EROSION ARE REPAIRED (e.g LINED WITH SUITABLE MATERIAL) AND/OR VELOCITY OF FLOW IS REDUCED APPROPRIATELY THROUGH CONSTRUCTION OF SMALL CHECK DAMS OR INSTALLING
- ADDITIONAL DIVERSIONS UPSLOPE c. BLOCKAGES ARE CLEARED (THESE MIGHT OCCUR BECAUSE OF SEDIMENT POLLUTION, SAND/SOIL/SPOIL BEING DEPOSITED IN OR TOO CLOSE TO THEM, BREACHED BY VEHICLE WHEELS etc)
- SAND/SOIL/SPOIL MATERIALS PLACED CLOSER THAN 2m FROM HAZARD AREAS SHALL BE REMOVED SUCH HAZARD AREAS INCLUDE ANY AREAS OF HIGH VELOCITY WATER FLOWS (eg WATERWAYS AND GUTTERS) PAVED AREAS AND DRIVEWAYS.
- 6. RECENTLY STABILISED LANDS SHALL BE CHECKED TO ENSURE THAT THE EROSION HAZARD HAS BEEN EFFECTIVELY REDUCED. ANY REPAIRS SHALL BE INITIATED AS APPROPRIATE.
- EXCESSIVE VEGETATIVE GROWTH SHALL BE CONTROLLED THROUGH MOWING OR SLASHING.
- 8. ALL SEDIMENT DETENTION SYSTEMS SHALL BE KEPT IN GOOD WORKING CONDITION. IN PARTICULAR ATTENTION SHALL BE GIVEN TO:-
- a. RECENT WORKS TO ENSURE THAT THEY HAVE NOT RESULTED IN DIVERSION OF SEDIMENT LADEN WATER
- DEGRADABLE PRODUCTS TO ENSURE THAT THEY ARE REPLACED AS REQUIRED
- c. SEDIMENT REMOVAL TO ENSURE THE DESIGN CAPACITY OR LESS REMAINS IN THE SETTLING ZONE.
- ADDITIONAL EROSION AND/OR SEDIMENT CONTROL WORKS SHALL BE CONSTRUCTED AS MIGHT BECOME NECESSARY TO ENSURE THE DESIRED PROTECTION IS GIVEN TO DOWNSLOPE LANDS AND WATERWAYS (ie MAKE ONGOING CHANGES TO THIS PLAN WHERE IT PROVES INADEQUATE IN PRACTICE OR IS SUBJECTED TO CHANGES IN CONDITIONS AT THE WORKS SITE OR ELSEWHERE IN THE CATCHMENT.
- 10. EROSION AND SEDIMENT CONTROL MEASURES SHALL BE MAINTAINED IN A FUNCTIONING CONDITION UNTIL ALL EARTHWORKS ACTIVITIES ARE COMPLETED AND THE SITE STABILISED.
- 11. WATERS IN SEDIMENT RETENTION BASIN(S) THAT OCCUPY MORE THAN 1/4 OF THE DESIGN CAPACITY DURING THAT STAGE OF THE WORKS UP UNTIL COMMISSIONING OF THE BASIN(s) SHALL BE:-
- a. TREATED WITH A FLOCCULATING AGENT (APPENDIX E MANAGING URBAN STORMWATER SOILS & CONSTRUCTION 4TH ED.)
- b. DISCHARGED WITHIN 5 days FROM THE CONCLUSION OF ANY STORM EVENT LARGE ENOUGH TO FILL THE BASIN TO THAT LEVEL.
- 12. LITTER, DEBRIS AND COARSE SEDIMENT SHALL BE REMOVED FROM THE GROSS POLLUTANT TRAPS AND TRASH RACKS AS REQUIRED.

SOIL AND WATER MANAGEMENT SHALL BE READ IN CONJUNCTION WITH CADDENS HILL STAGES 2 BULK EARTHWORKS CC APPROVAL

DATUM: **LEGACY**PROPERTY

THIS DRAWING MUST NOT BE USED FOR

ONSTRUCTION UNLESS SIGNED AS PART OF AN

APPROVED CONSTRUCTION CERTIFICATE.

ISSUED FOR CONSTRUCTION APPROVAL

CADDENS HILL - PLAYING FIELD CARPARK, ROAD & DRAINAGE WORKS

**SOIL & WATER MANAGEMENT NOTES** 

110358/CC810

FILE No: 110358CC810


SHEET SIZE:


A1 ORIGINAL

Document Set ID: 8182560

**AMENDMENT** 

SUE FOR CONSTRUCTION APPROVAL

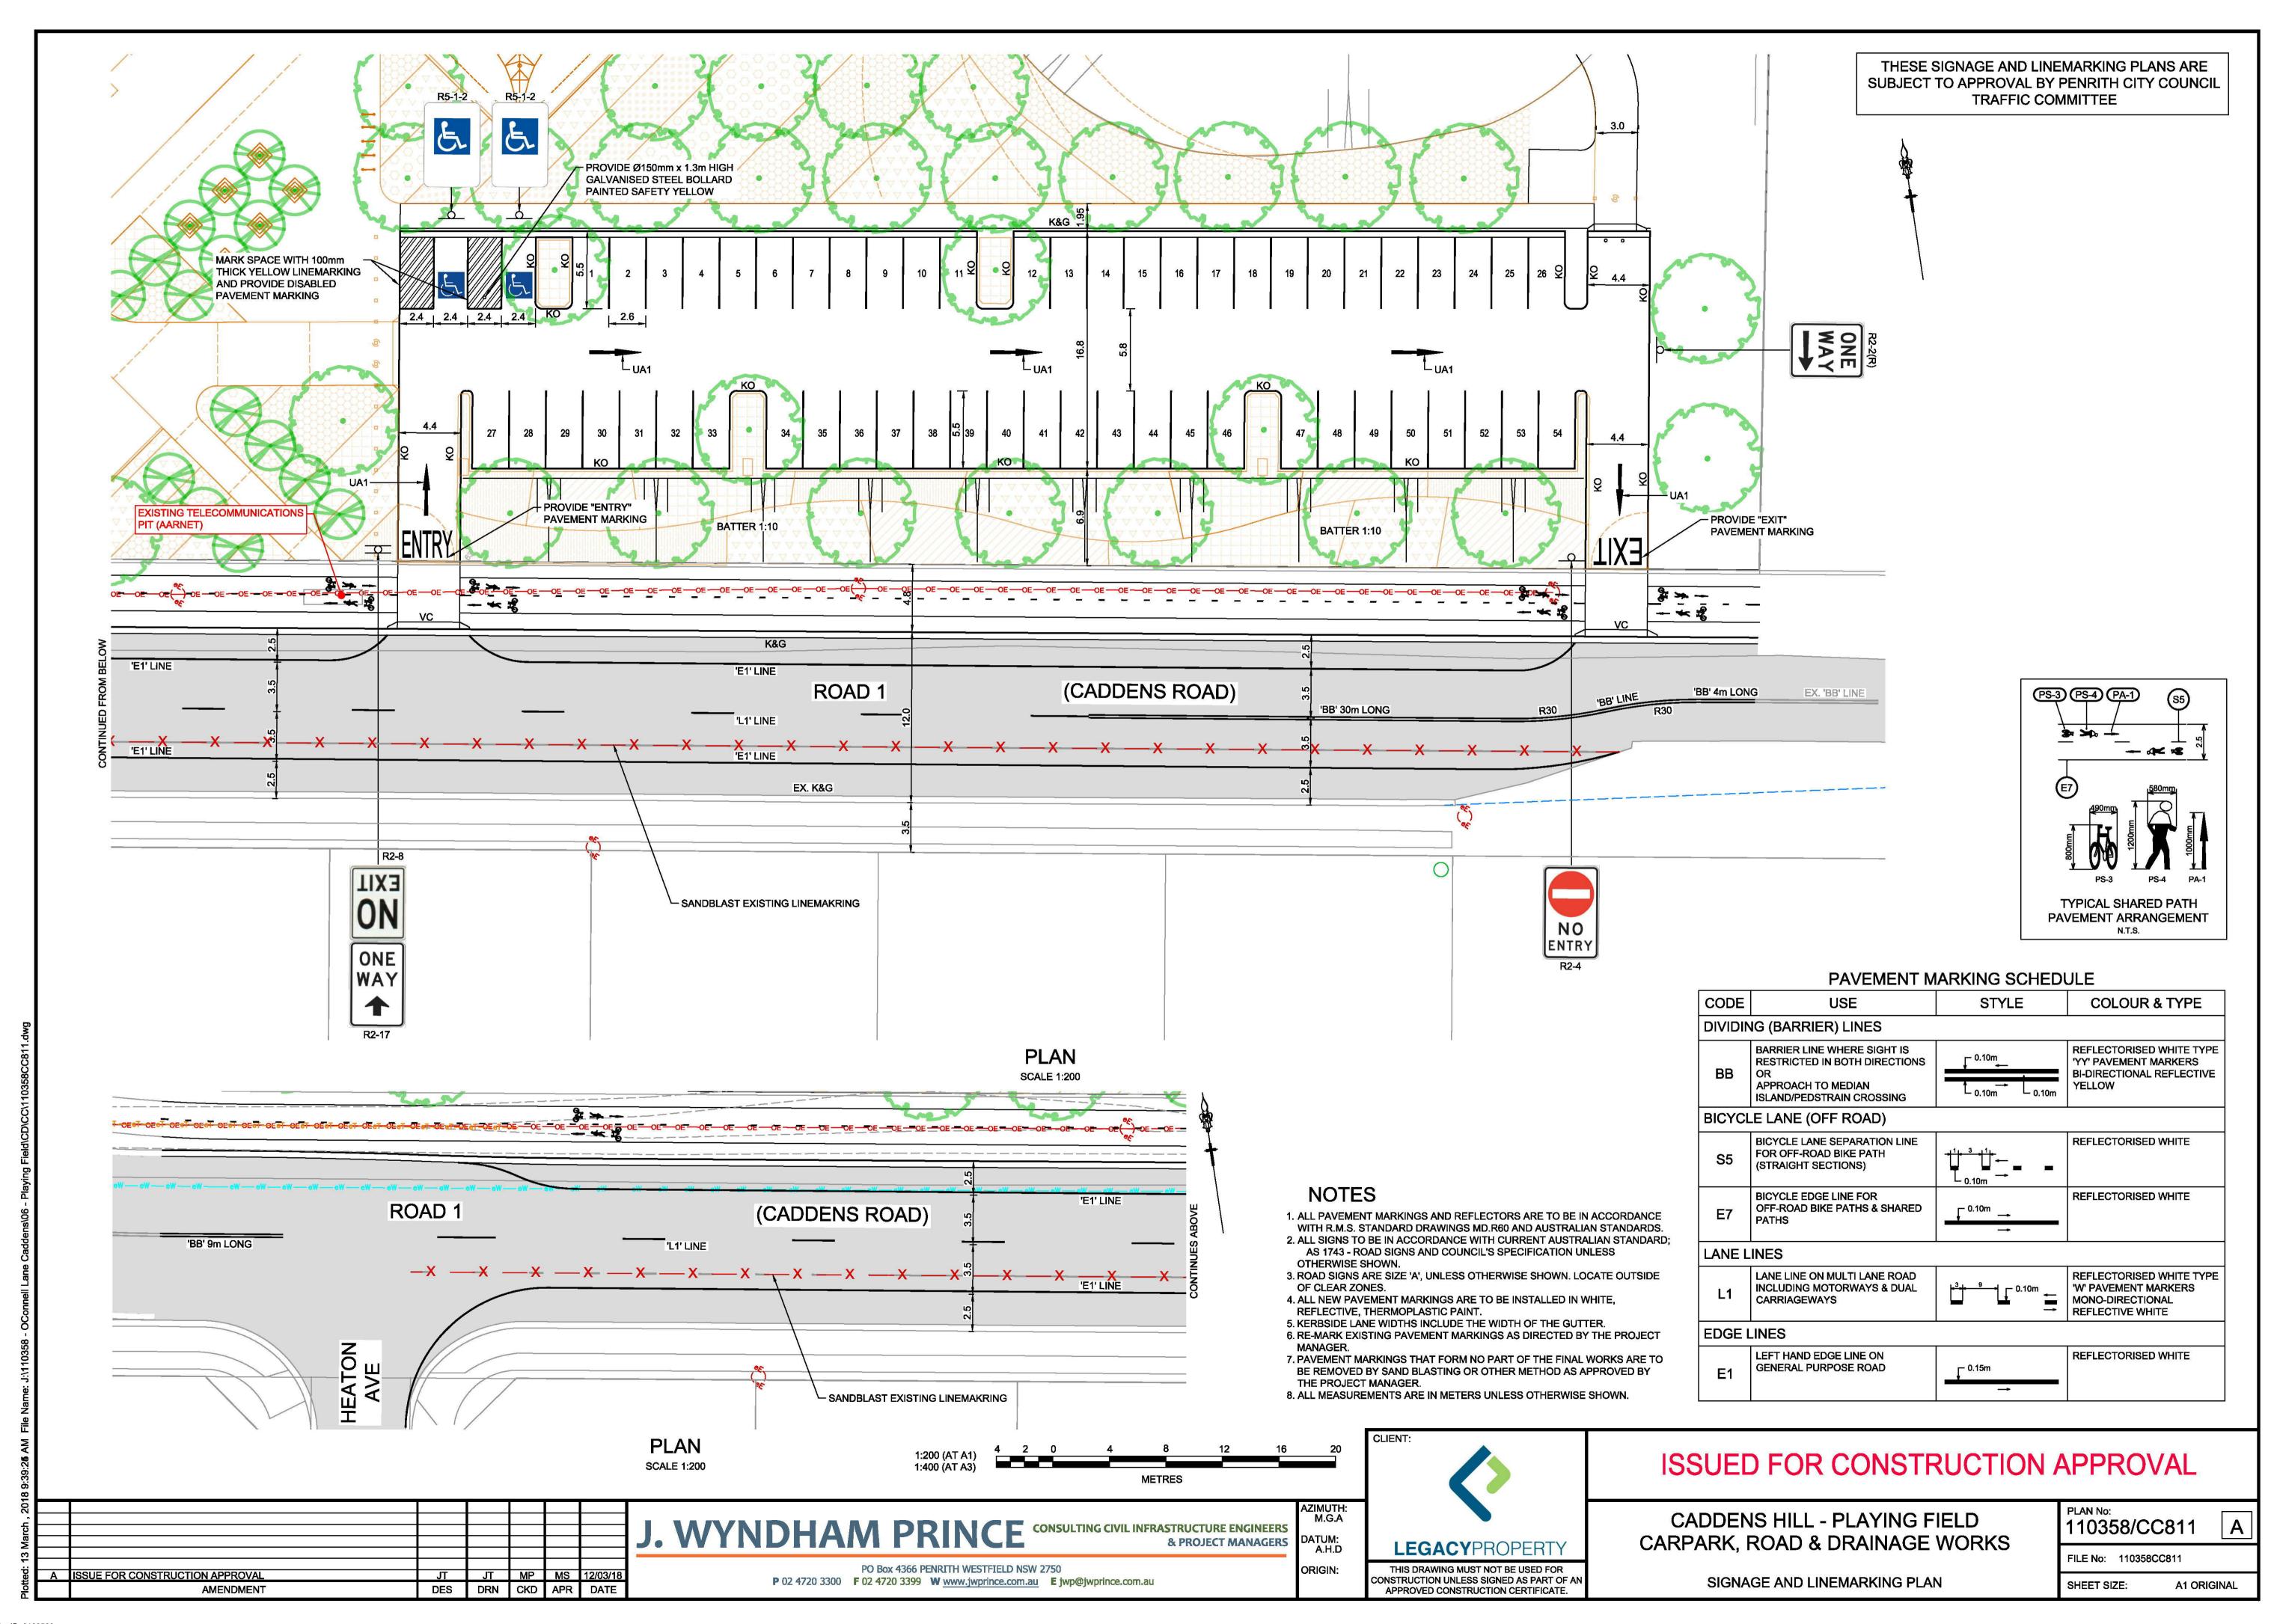

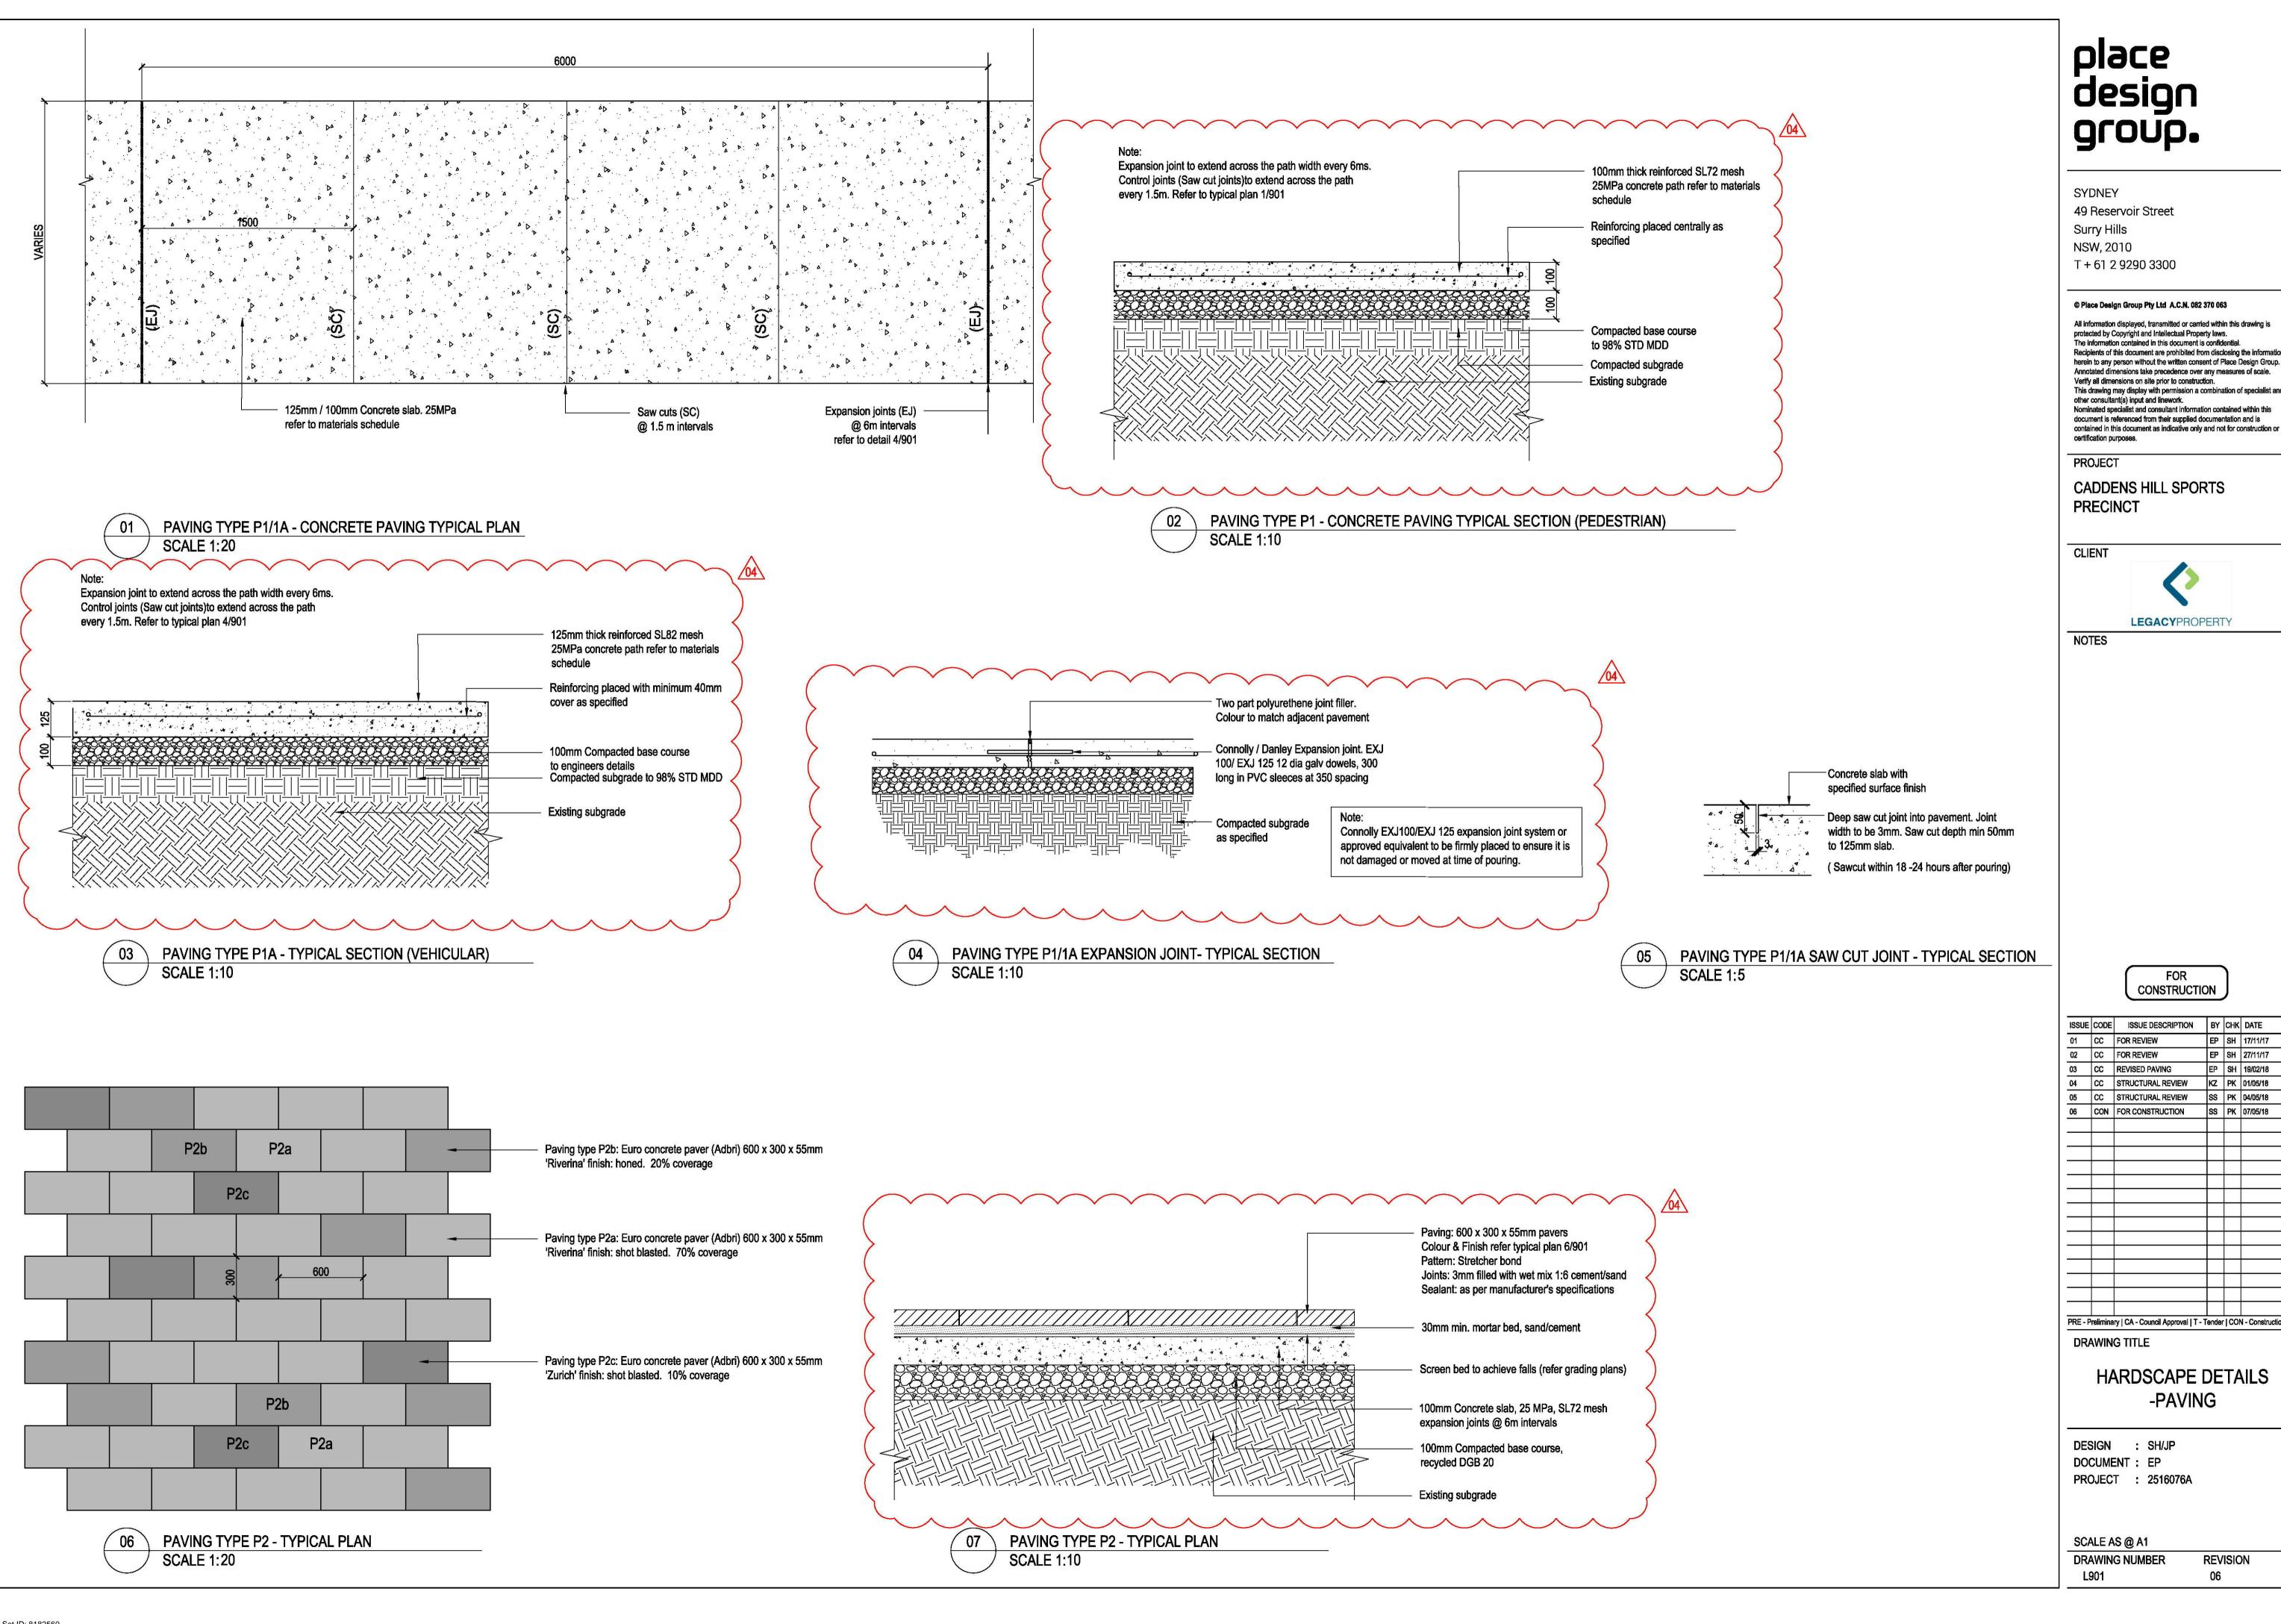


All information displayed, transmitted or carried within this drawing is protected by Copyright and Intellectual Property laws. The information contained in this document is confidential Recipients of this document are prohibited from disclosing the information herein to any person without the written consent of Place Design Group. Annotated dimensions take precedence over any measures of scale. This drawing may display with permission a combination of specialist and Nominated specialist and consultant information contained within this





ISSUE CODE | ISSUE DESCRIPTION | BY CHK DATE EP SH 17/11/17 EP SH 27/11/17 SS PK 04/05/18 SS PK 07/05/18 PRE - Preliminary | CA - Council Approval | T - Tender | CON - Construction

HARDSCAPE DETAILS

REVISION 06

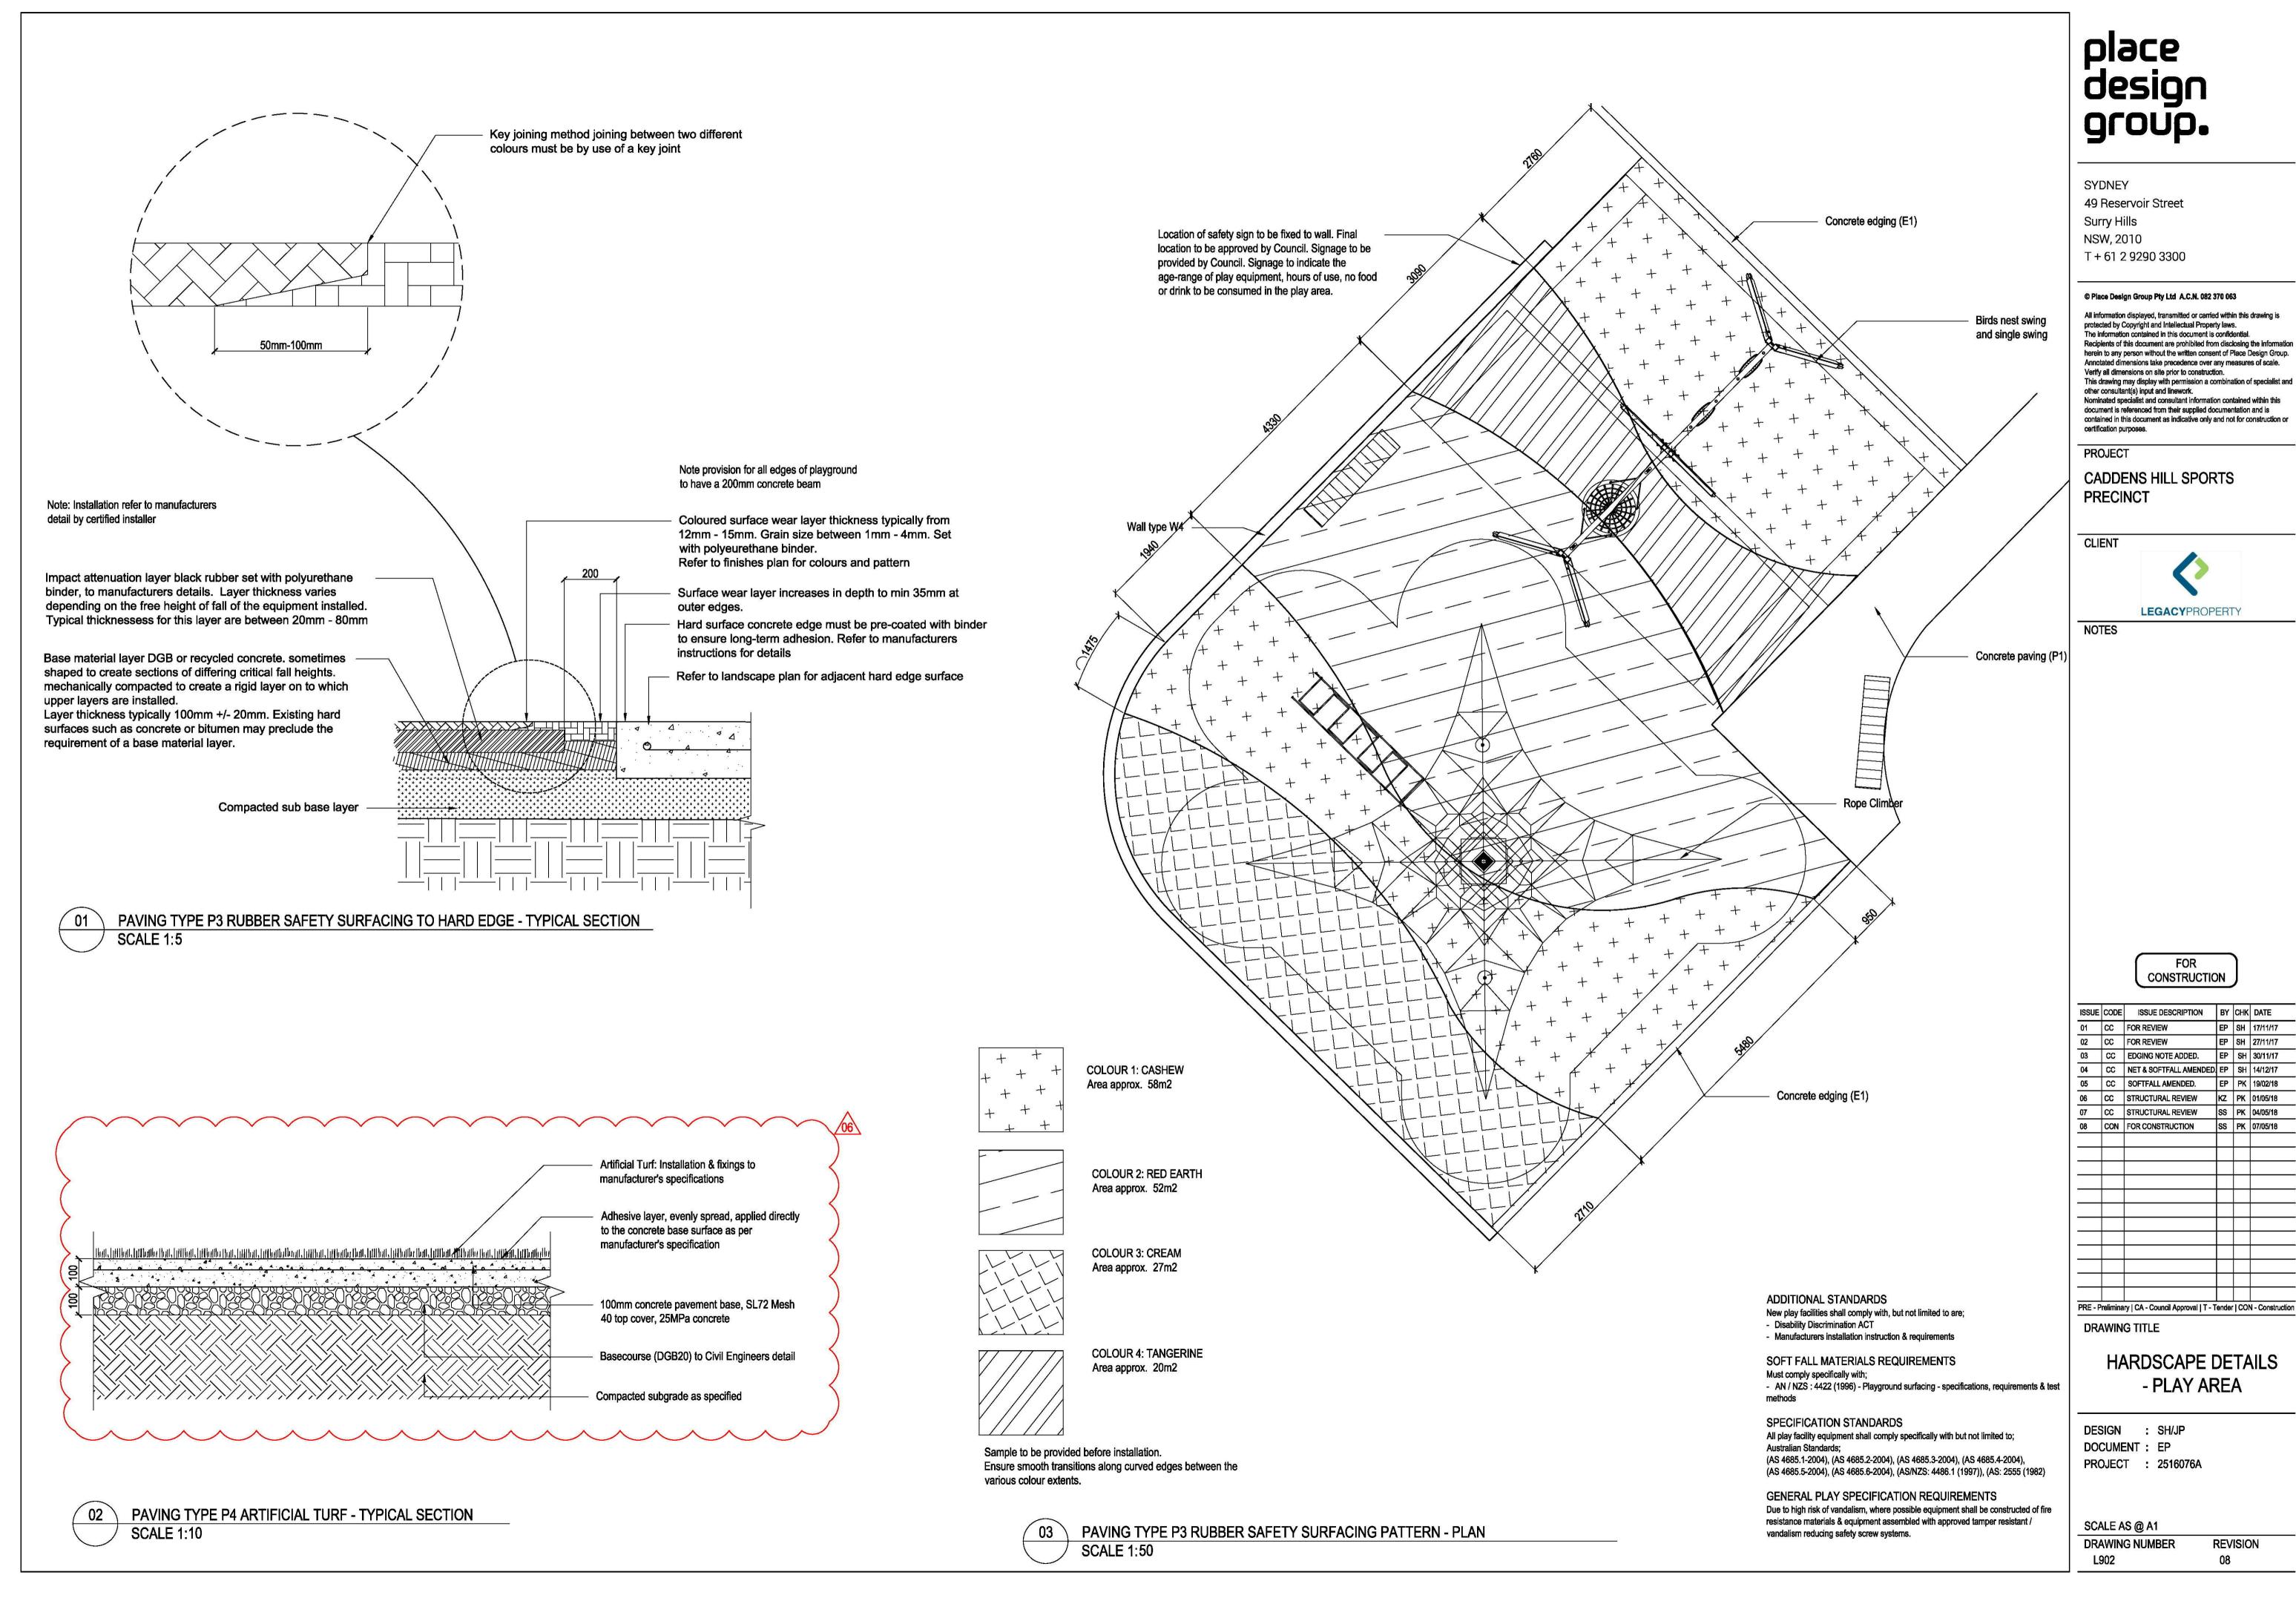


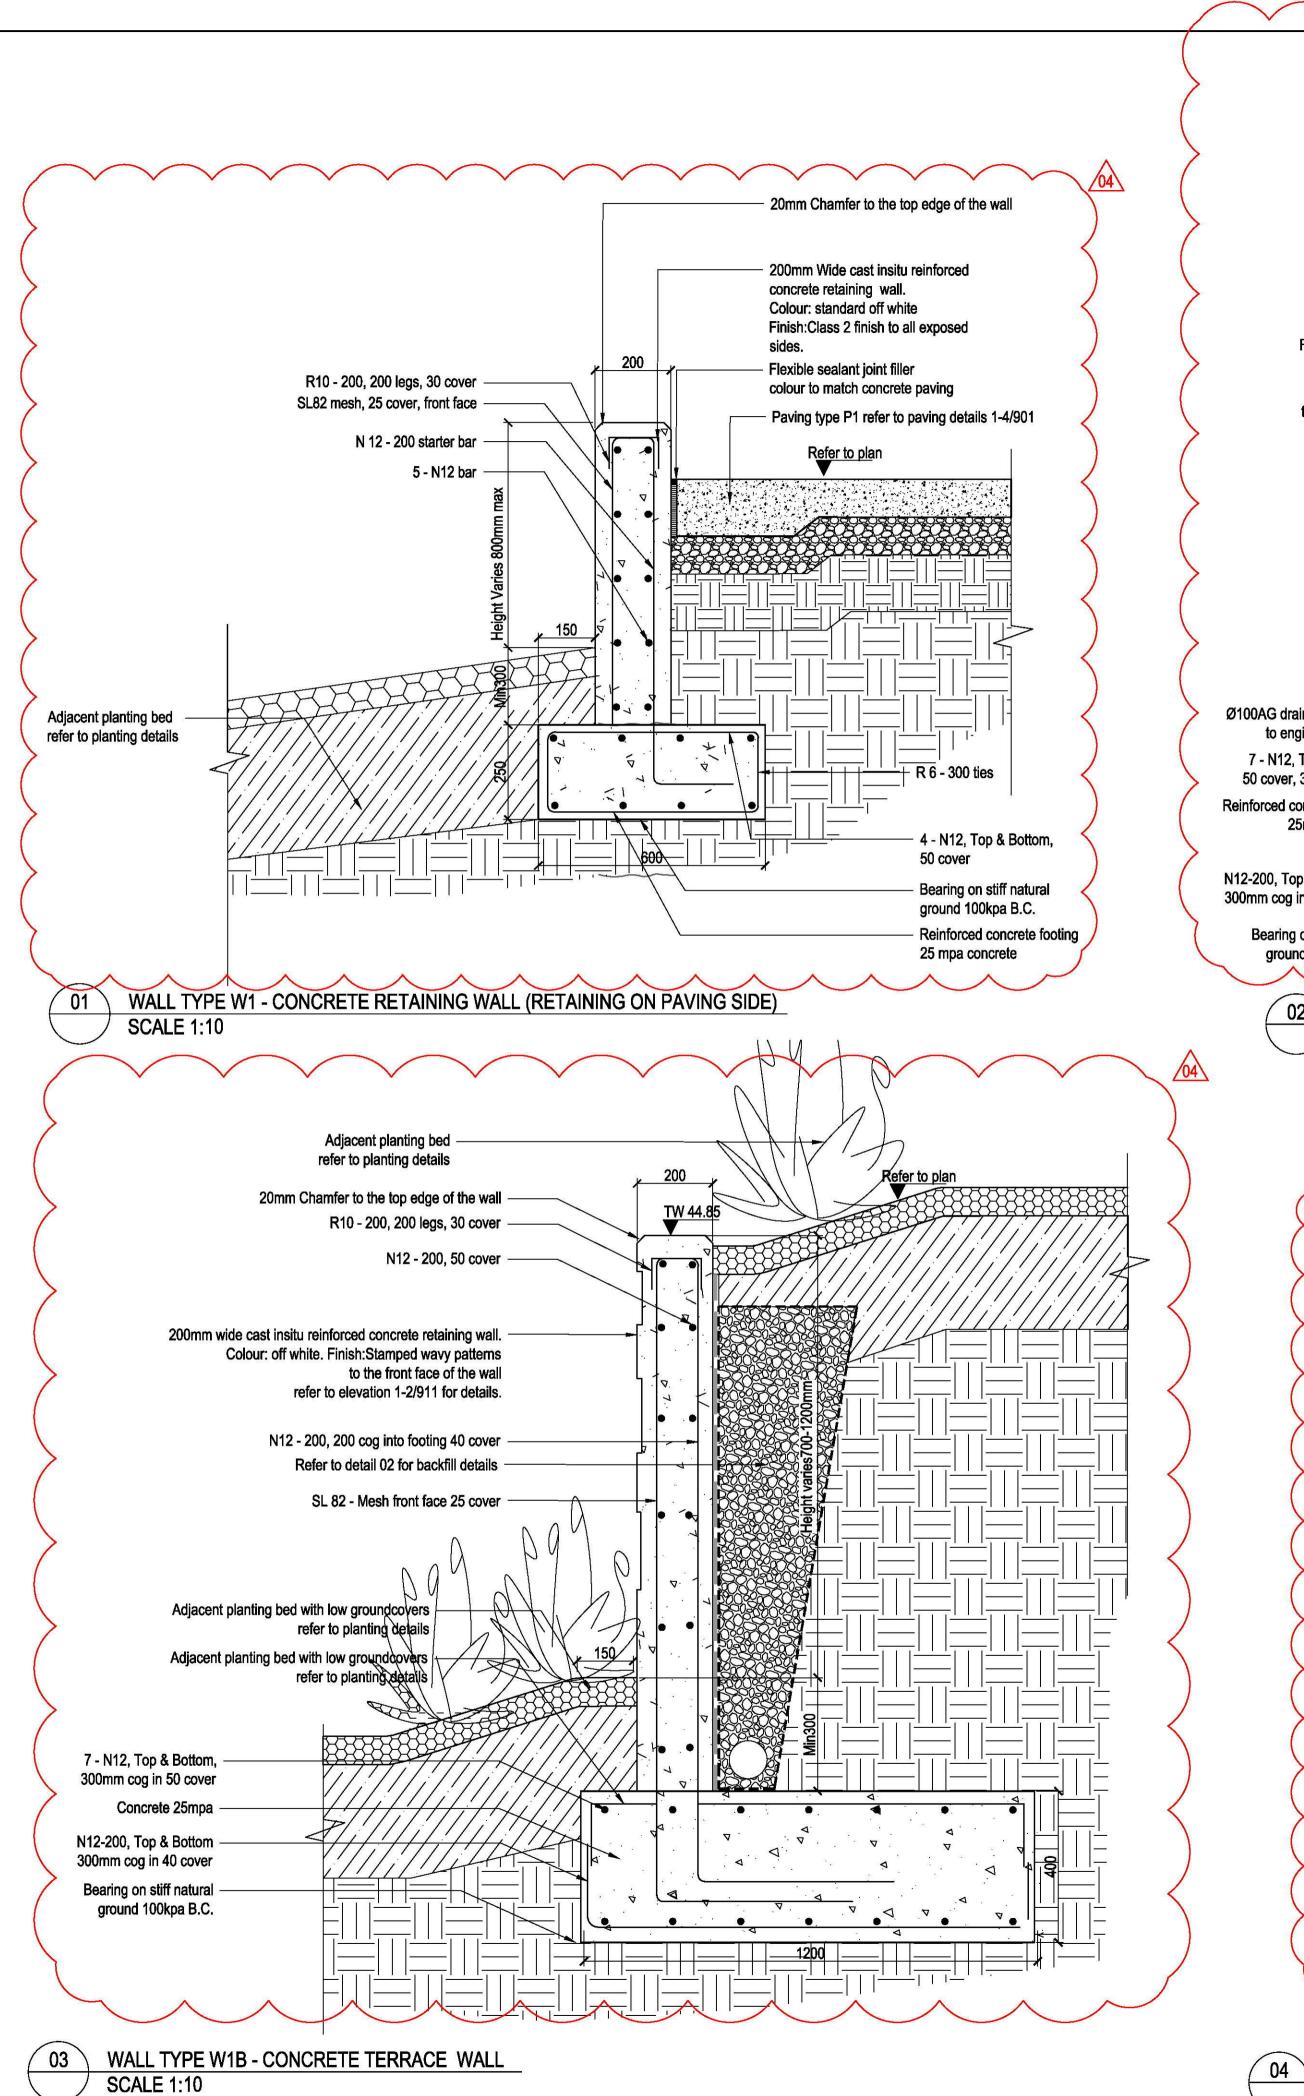

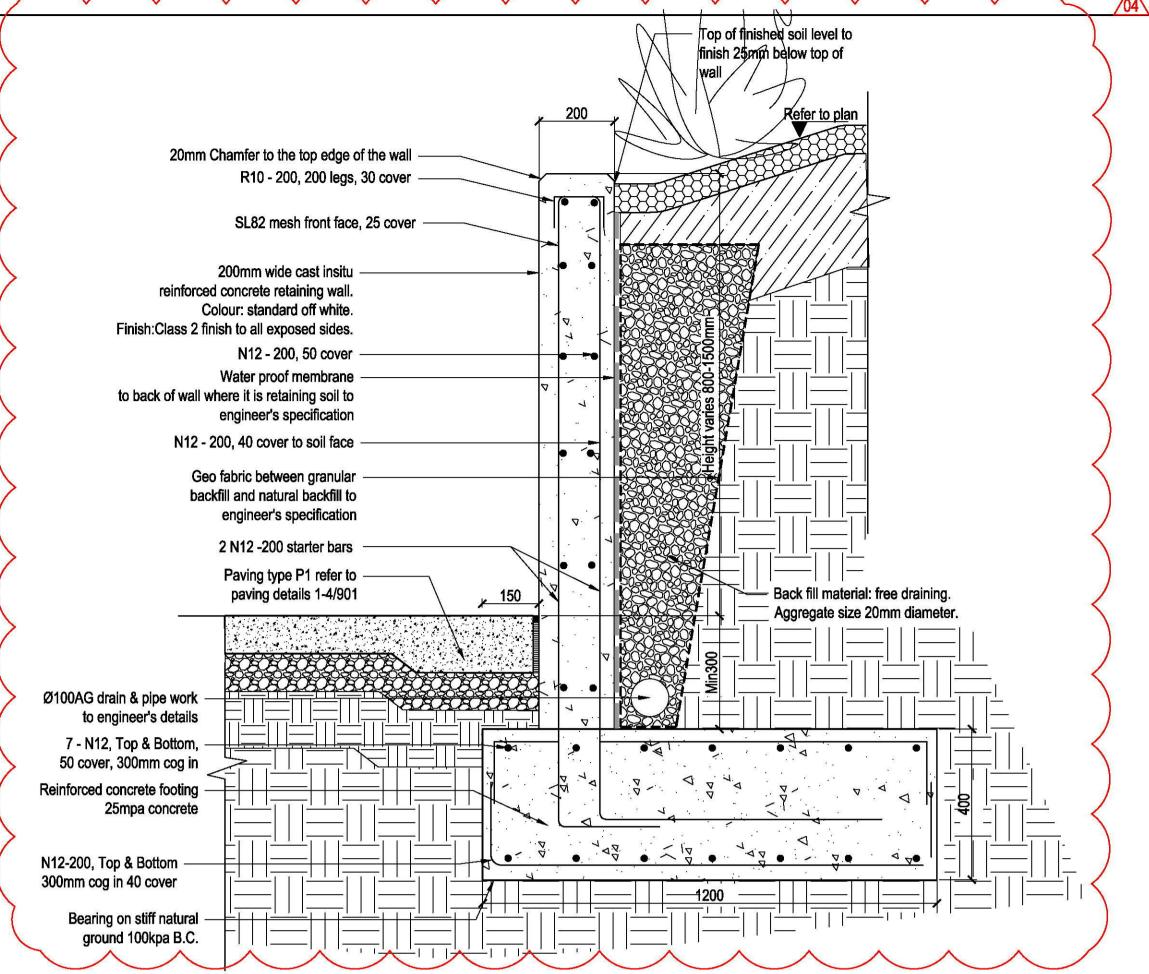

WALL TYPE W1A - CONCRETE TERRACE WALL

**SCALE 1:10** 

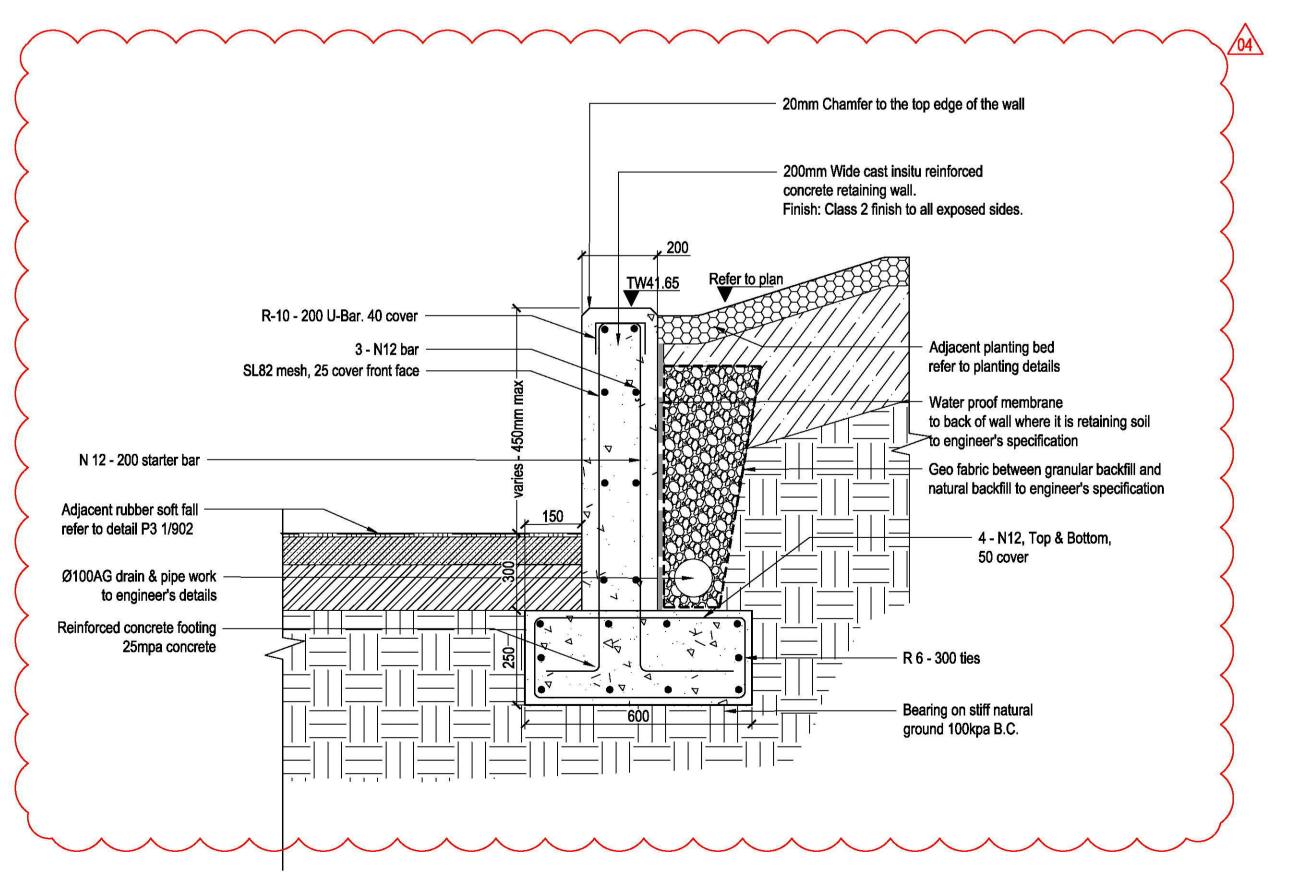

WALL TYPE W1 - CONCRETE RETAINING WALL TO PLAYGROUND (RETAINING ON PLANTING SIDE)

SCALE 1:10

# place design group.

SYDNEY
49 Reservoir Street
Surry Hills
NSW, 2010
T + 61 2 9290 3300

#### © Place Design Group Pty Ltd A.C.N. 082 370 063

All information displayed, transmitted or carried within this drawing is protected by Copyright and Intellectual Property laws.

The information contained in this document is confidential.

Recipients of this document are prohibited from disclosing the information herein to any person without the written consent of Place Design Group. Annotated dimensions take precedence over any measures of scale. Verify all dimensions on site prior to construction.

This drawing may display with permission a combination of specialist and other consultant(s) input and linework.

Nominated specialist and consultant information contained within this document is referenced from their supplied documentation and is

contained in this document as indicative only and not for construction or

**PROJECT** 

certification purposes.

CADDENS HILL SPORTS PRECINCT

CLIENT



NOTES

FOR CONSTRUCTION

ISSUE	CODE	ISSUE DESCRIPTION	BY	СНК	DATE
01	CC	FOR REVIEW	EP	SH	17/11/17
02	CC	FOR REVIEW	EP	SH	27/11/17
03	СС	SKATE DETERRENT REMOVED	EP	SH	19/02/18
04	C	STRUCTURAL REVIEW	ΚZ	PK	01/05/18
05	င	STRUCTURAL REVIEW	SS	PK	04/05/18
06	CON	FOR CONSTRUCTION	SS	PK	07/05/18
				1	

HARDSCAPE DETAILS

- WALLS


06

DESIGN : SH/JP
DOCUMENT : EP
PROJECT : 2516076A


L910


SCALE AS @ A1

DRAWING NUMBER REVISION

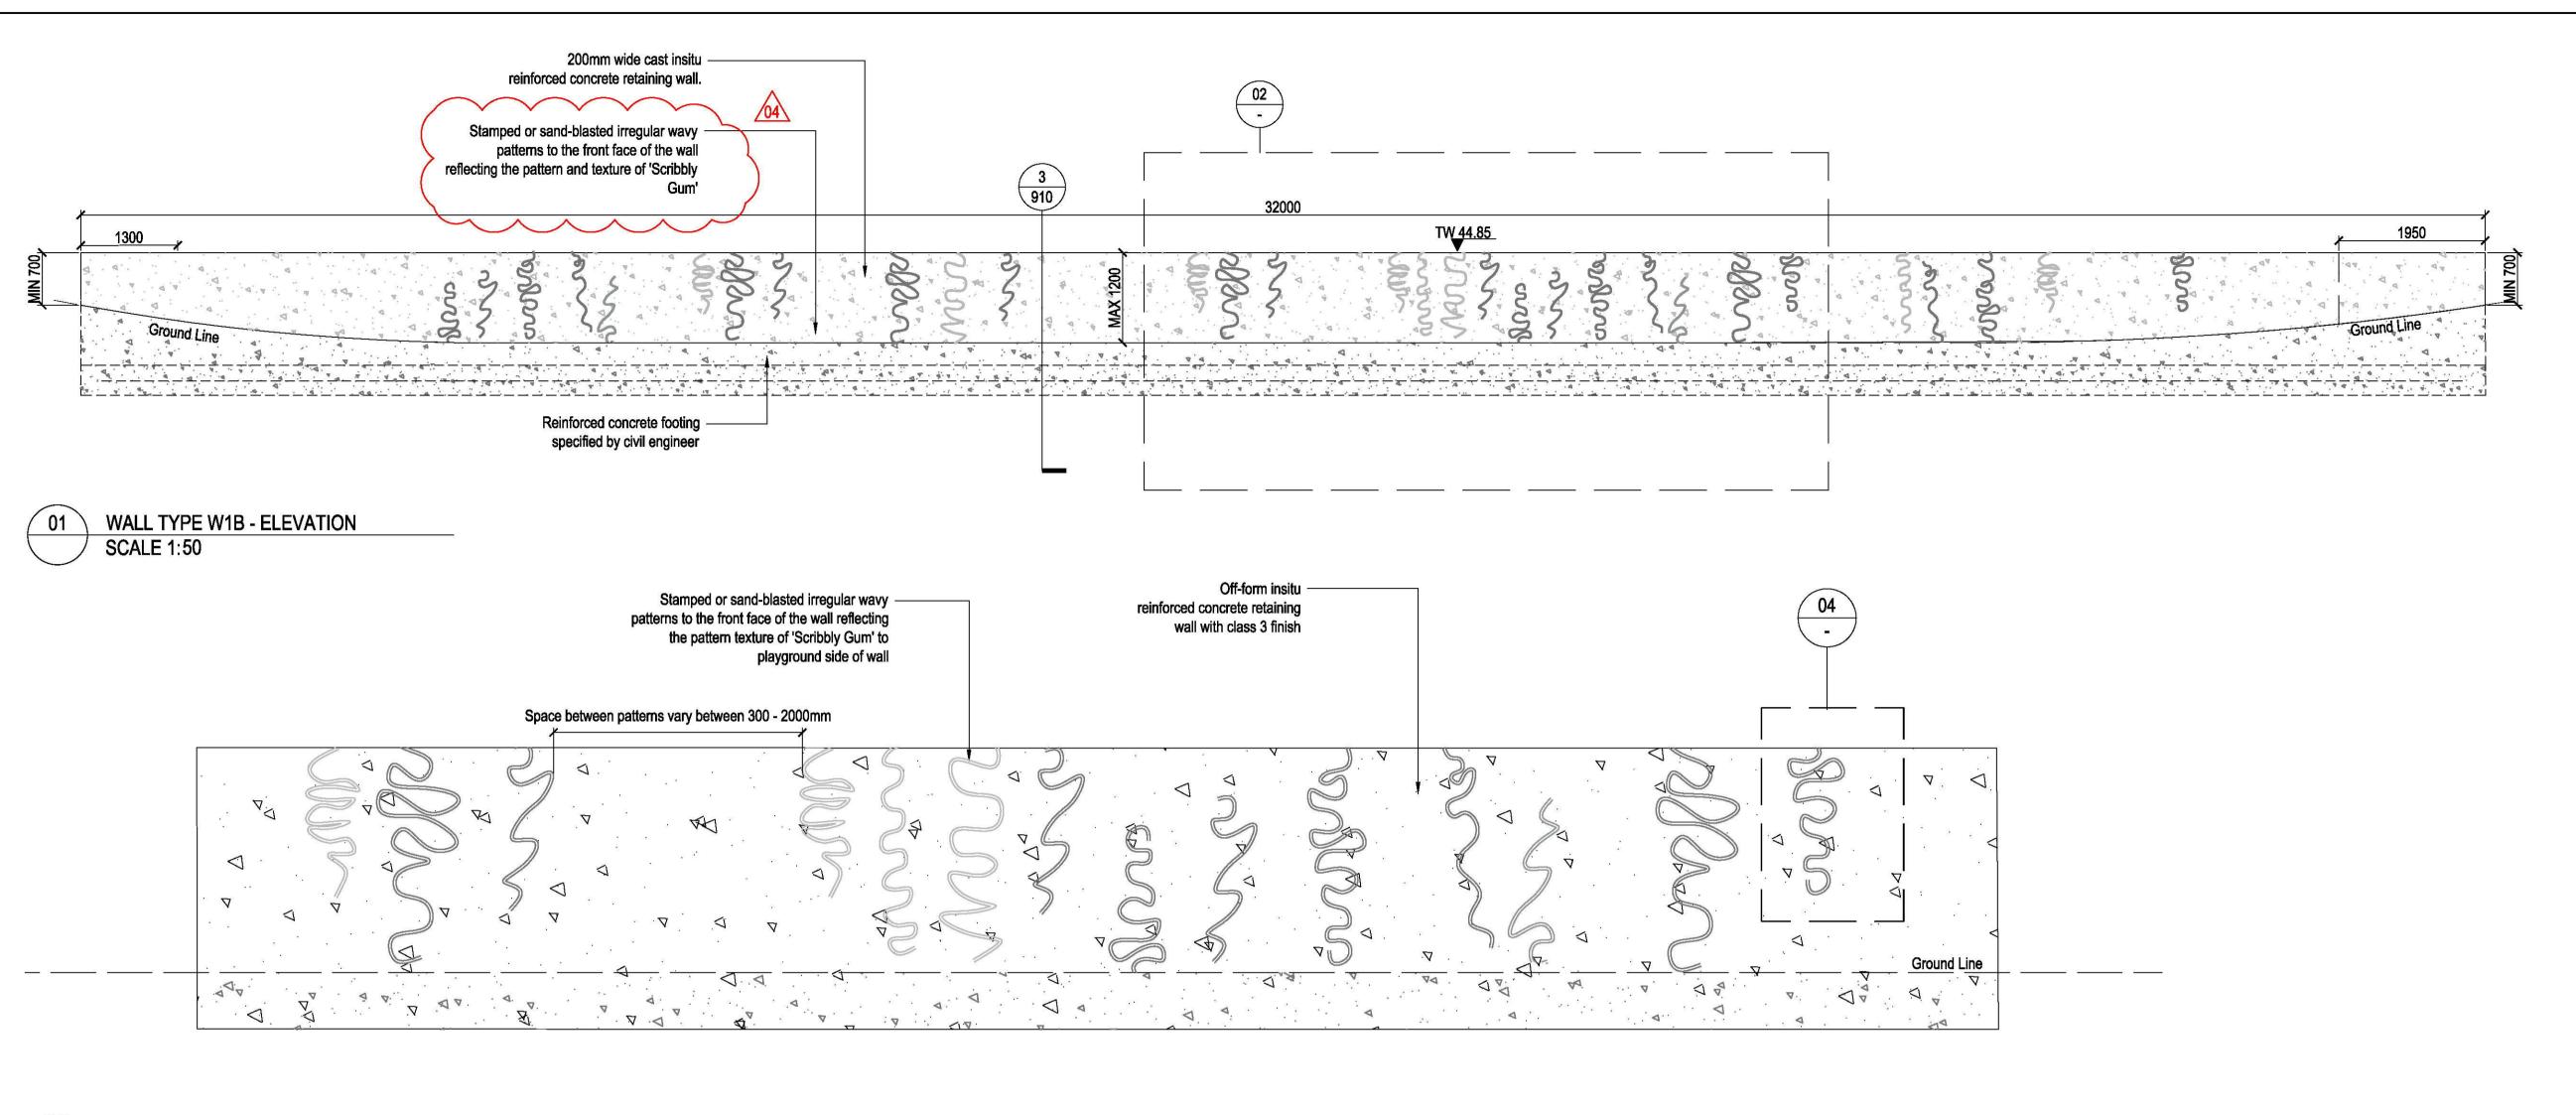

02 WALL TYPE W1B - INDICATIVE DETAIL PATTERN
SCALE 1:20

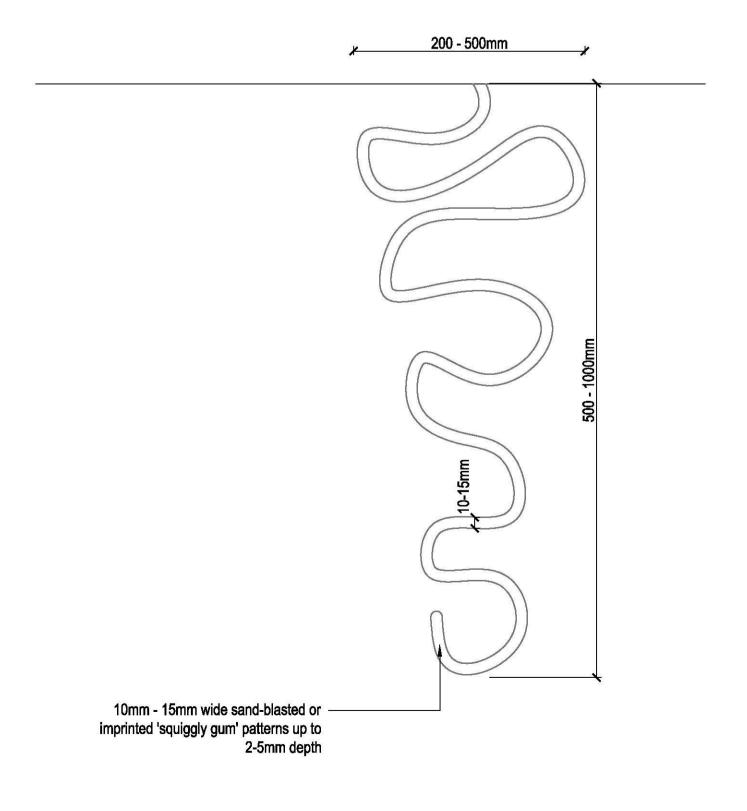

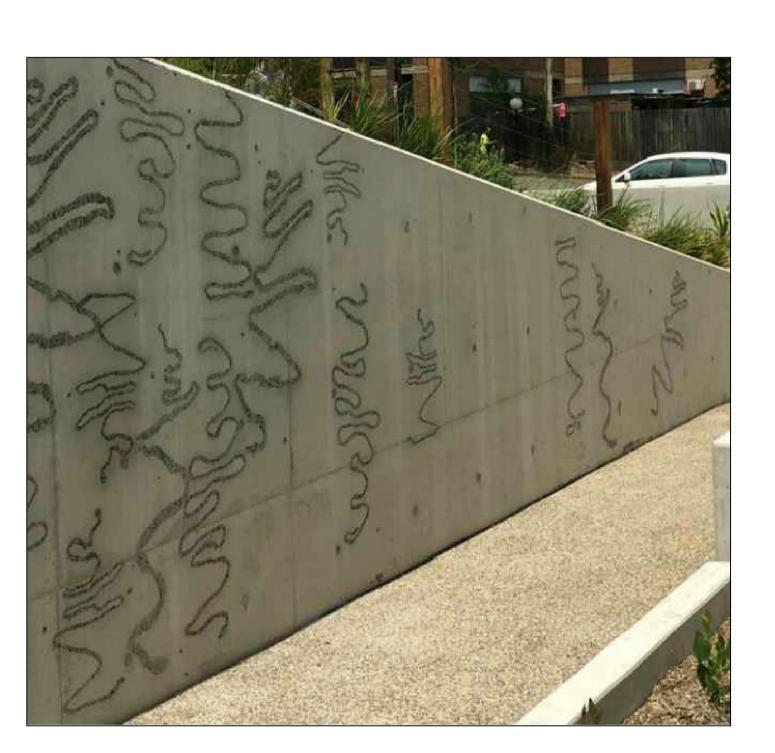

O4 SAND-BLASTED/STAMPED TYPICAL WAVY PATTERN SCALE 1:5

# place design group.

SYDNEY
49 Reservoir Street
Surry Hills
NSW, 2010
T + 61 2 9290 3300

#### © Place Design Group Pty Ltd A.C.N. 082 370 063

All information displayed, transmitted or carried within this drawing is protected by Copyright and Intellectual Property laws.

The information contained in this document is confidential.

Recipients of this document are prohibited from disclosing the information herein to any person without the written consent of Place Design Group. Annotated dimensions take precedence over any measures of scale. Verify all dimensions on site prior to construction.

This drawing may display with permission a combination of specialist and other consultant(s) input and linework.

Nominated specialist and consultant information contained within this document is referenced from their supplied documentation and is contained in this document as indicative only and not for construction or certification purposes.

PROJECT

CADDENS HILL SPORTS PRECINCT

CLIENT



NOTES

FOR CONSTRUCTION

ISSUE	CODE	ISSUE DESCRIPTION	BY	CHK	DATE
01	CC	FOR REVIEW	EP	SH	17/11/17
02	CC	FOR REVIEW	EP	SH	27/11/17
03	CC	REVISED WALL DETAIL	EP	SH	19/02/18
04	CC	STRUCTURAL REVIEW	ΚZ	PK	01/05/18
05	CC	STRUCTURAL REVIEW	SS	PK	04/05/18
06	CON	FOR CONSTRUCTION	SS	PK	07/05/18
			_		
			4		
			+		
			-		
			3 2 3		
			3 2		
			3 2		
			0.00		
			Т		
PRE - P	relimina	ry   CA - Council Approval   T -	Tender	COI	V - Constr

HARDSCAPE DETAILS


- WALLS


DESIGN : SH/JP
DOCUMENT : EP
PROJECT : 2516076A


SCALE AS @ A1

DRAWING NUMBER REVISION

1 06

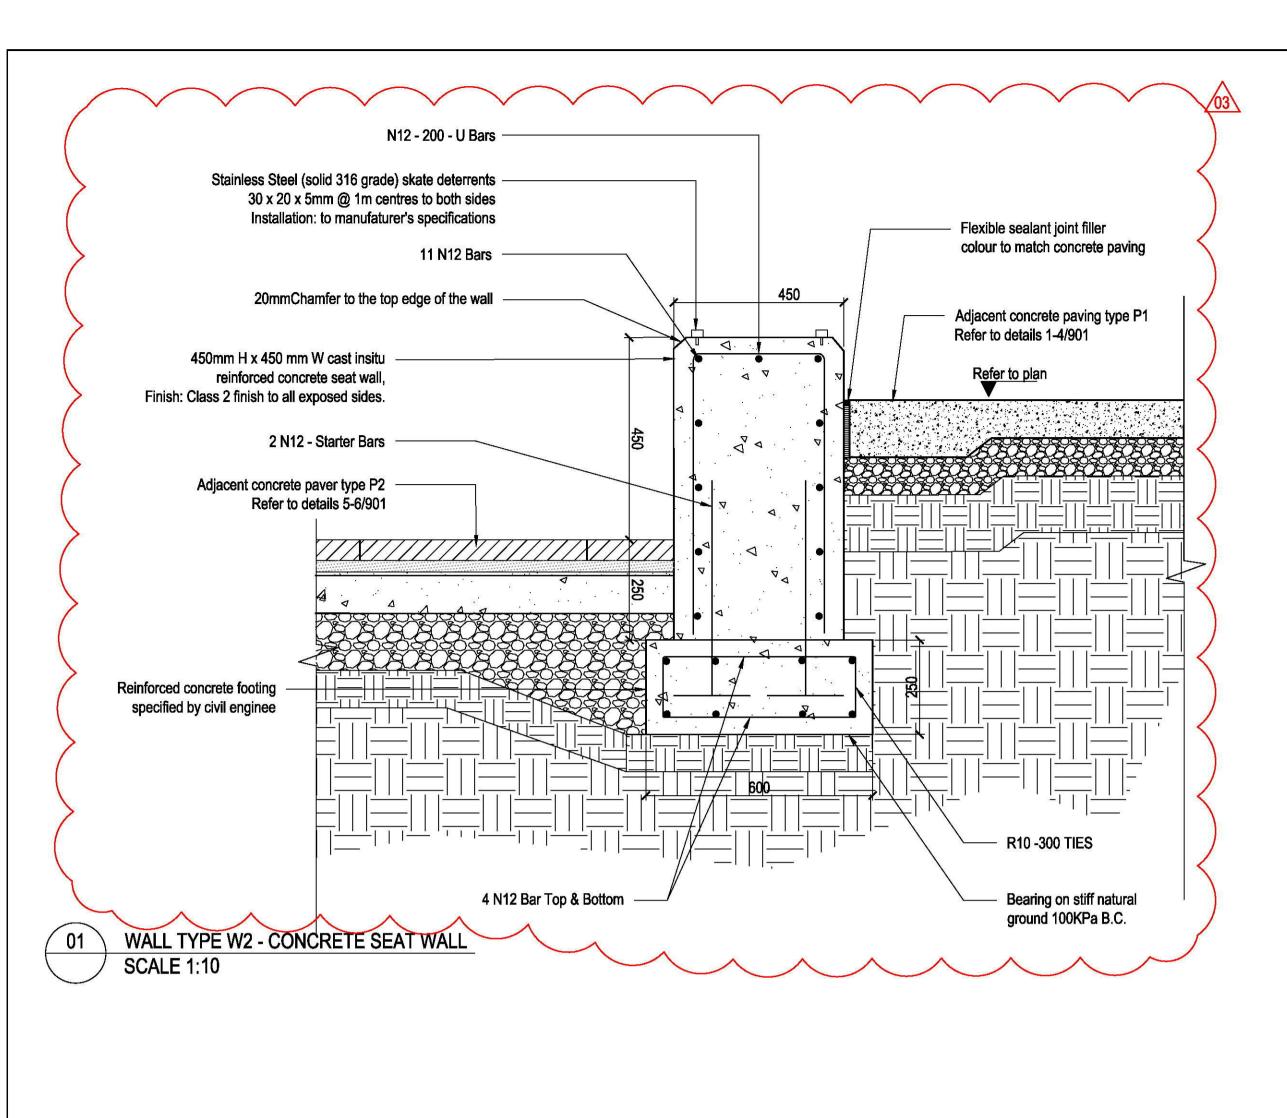


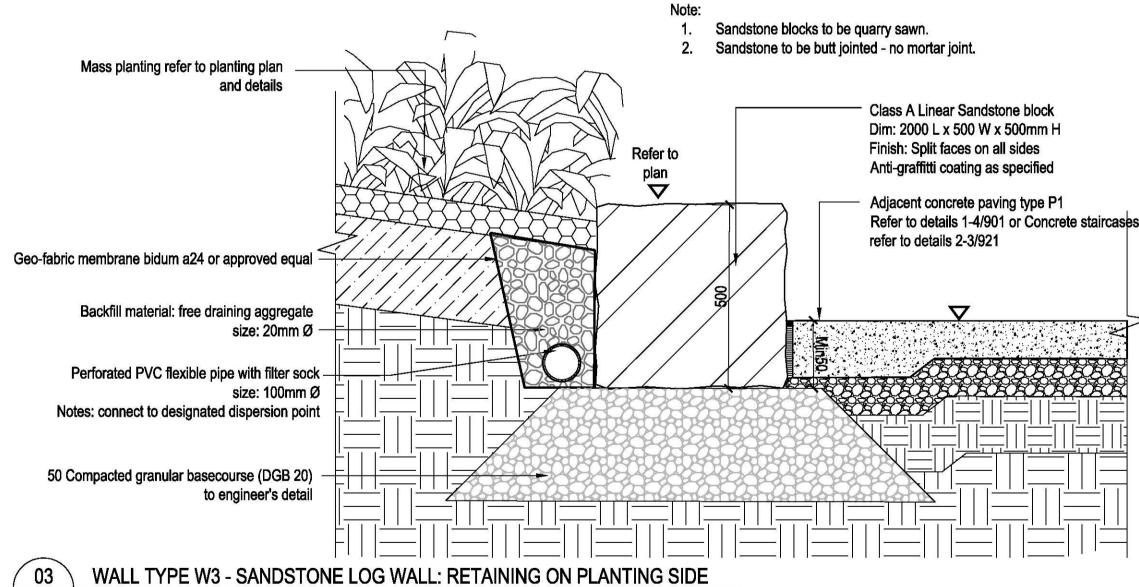

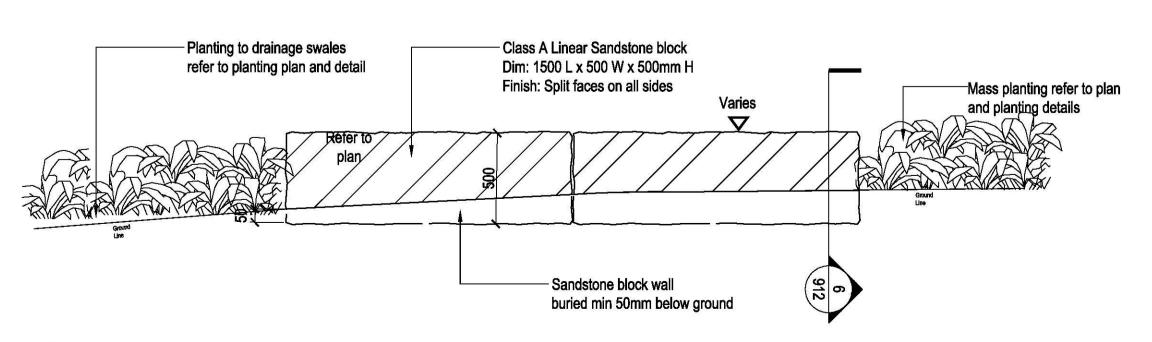


WALL TYPE W3A - SANDSTONE LOG WALL TO DRAINAGE SWALE - ELEVATION SCALE 1:20


## Sandstone blocks to be quarry sawn. 2. Sandstone to be butt jointed - no mortar joint.

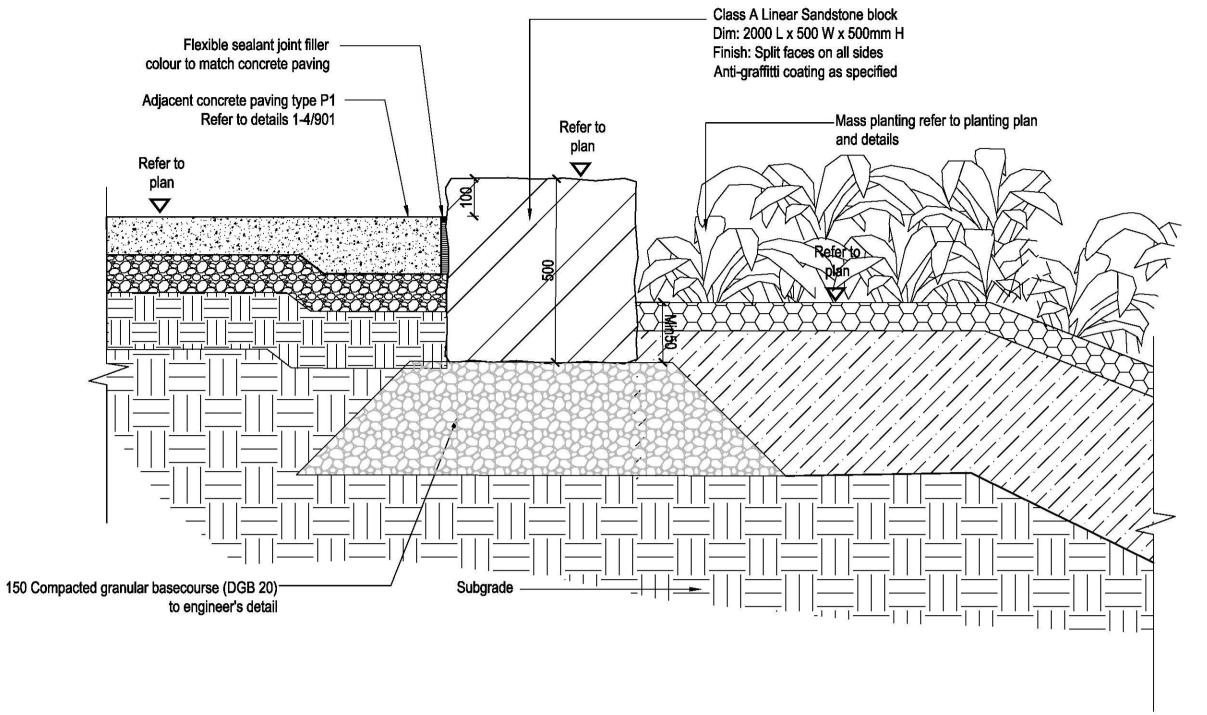

# WALL TYPE W3 - SANDSTONE LOG WALL: RETAINING ON PAVING SIDE **SCALE 1:10**

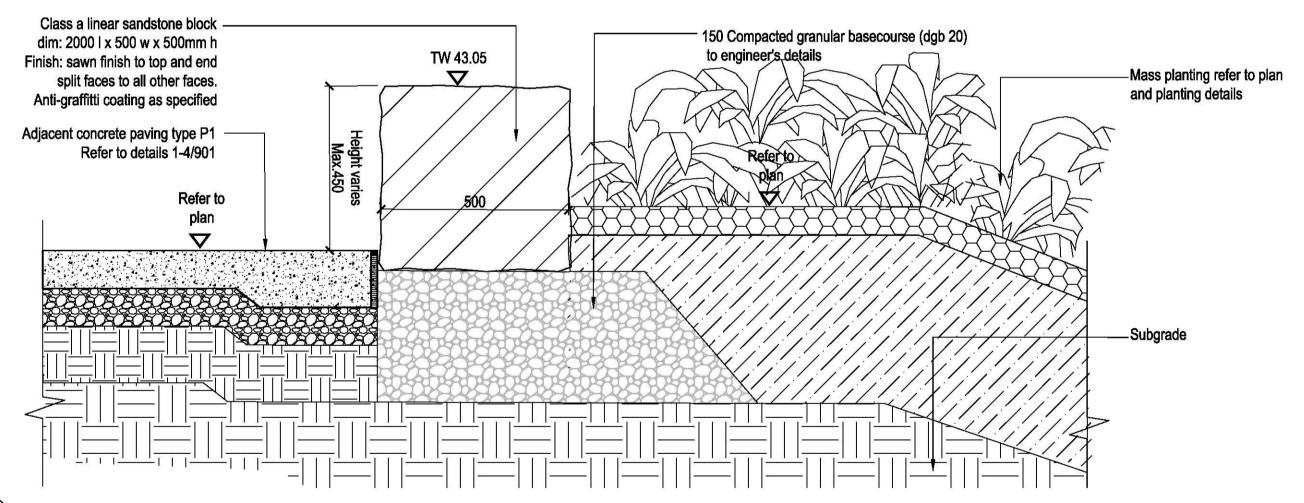

WALL TYPE W3B - SANDSTONE SEAT WALL (FREE STANDING) **SCALE 1:10** 

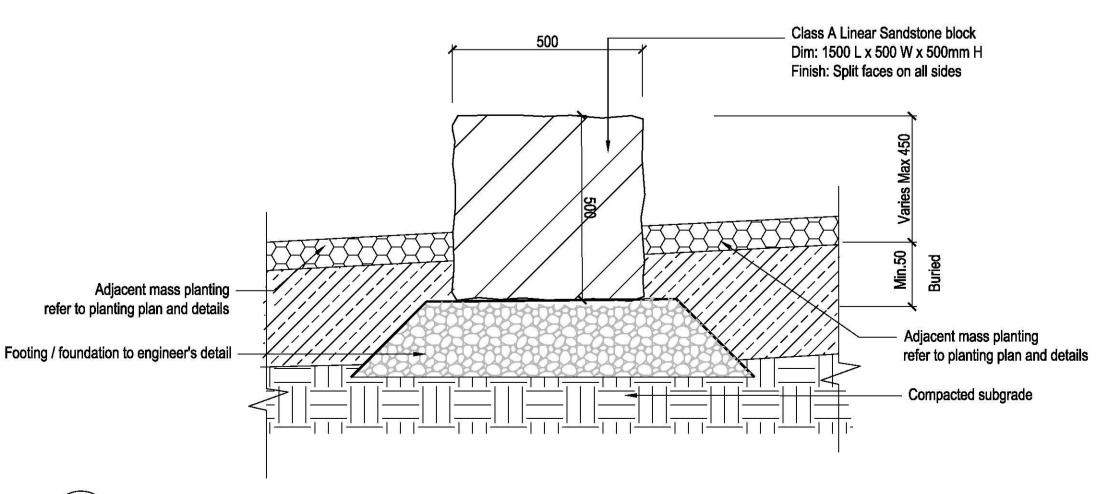

WALL TYPE W3A - SANDSTONE LOG WALL TO DRAINAGE SWALE - DETAIL SECTION SCALE 1:10

# place design group.

SYDNEY 49 Reservoir Street Surry Hills NSW, 2010 T + 61 2 9290 3300

#### © Place Design Group Pty Ltd A.C.N. 082 370 063

All information displayed, transmitted or carried within this drawing is protected by Copyright and Intellectual Property laws. The information contained in this document is confidential Recipients of this document are prohibited from disclosing the information herein to any person without the written consent of Place Design Group. Annotated dimensions take precedence over any measures of scale. Verify all dimensions on site prior to construction. This drawing may display with permission a combination of specialist and other consultant(s) input and linework. Nominated specialist and consultant information contained within this document is referenced from their supplied documentation and is contained in this document as indicative only and not for construction or

**PROJECT** 

certification purposes.

CADDENS HILL SPORTS PRECINCT

CLIENT



**NOTES** 

CONSTRUCTION

ISSUE	CODE	ISSUE DESCRIPTION	BY	СНК	DATE
01	CC	FOR REVIEW	EP	SH	17/11/17
02	СС	FOR REVIEW	EP	SH	27/11/17
03	CC	STRUCTURAL REVIEW	ΚZ	PK	01/05/18
04	CC	STRUCTURAL REVIEW	SS	PK	04/05/18
05	CON	FOR CONSTRUCTION	SS	PK	07/05/18
				8	
			_		
			_		
			<u> </u>		w meen or
PRE - P	relimina	ry   CA - Council Approval   T -	Tender	CO	N - Constru
DRA	AWIN	G TITLE			

HARDSCAPE DETAILS - WALLS

REVISION

05

DESIGN : SH/JP


DOCUMENT: EP PROJECT : 2516076A


SCALE AS @ A1 DRAWING NUMBER

L912

Document Set ID: 8182560 Version: 1, Version Date: 11/05/2018

SCALE 1:10

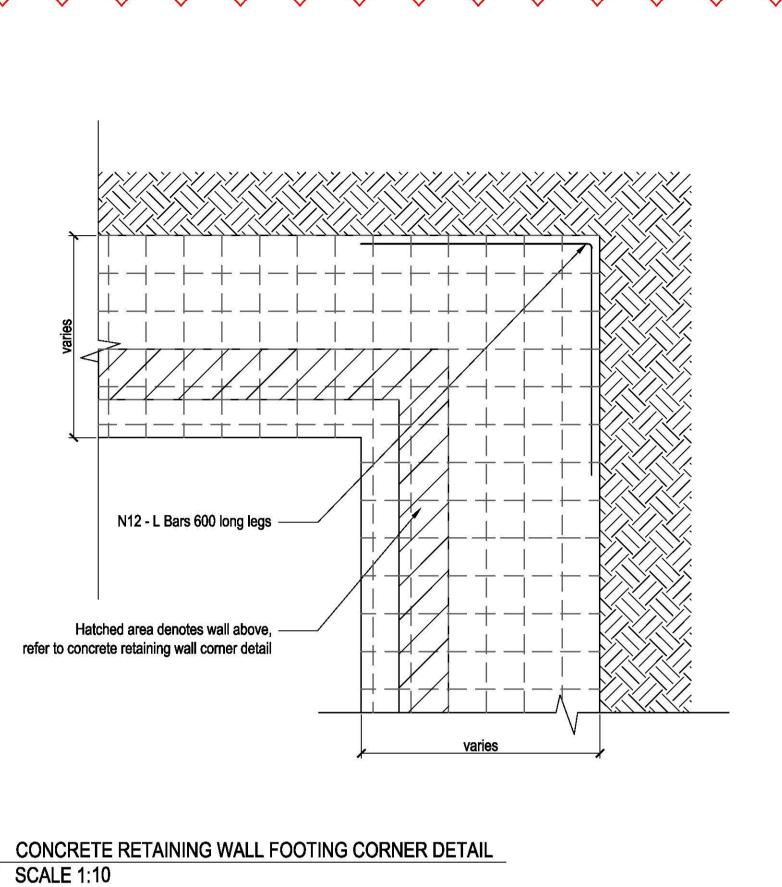

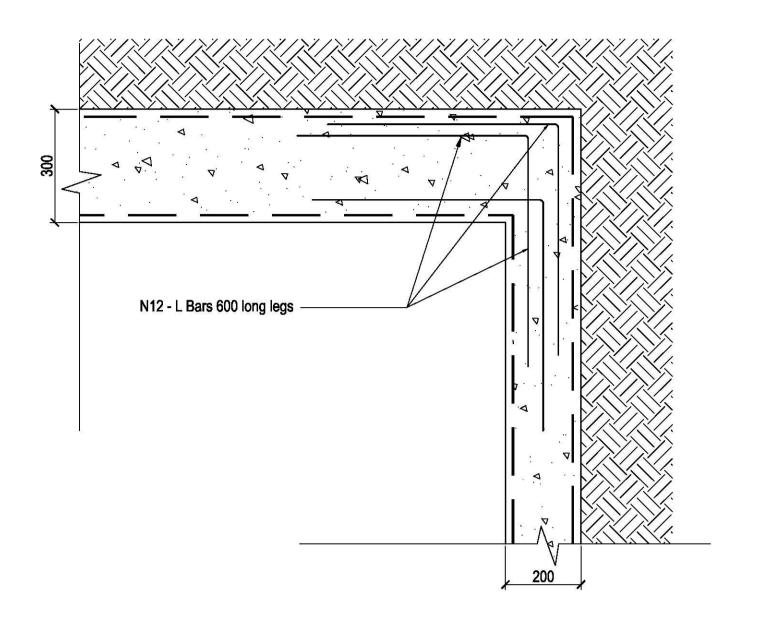

02 CONCRETE RETAINING WALL CORNER DETAIL SCALE 1:10

# place design group.

SYDNEY
49 Reservoir Street
Surry Hills
NSW, 2010
T + 61 2 9290 3300

#### © Place Design Group Pty Ltd A.C.N. 082 370 063

All information displayed, transmitted or carried within this drawing is protected by Copyright and Intellectual Property laws.

The information contained in this document is confidential.
Recipients of this document are prohibited from disclosing the information herein to any person without the written consent of Place Design Group. Annotated dimensions take precedence over any measures of scale.

Verify all dimensions on site prior to construction.

This drawing may display with permission a combination of specialist and other consultant(s) input and linework.

Nominated specialist and consultant information contained within this document is referenced from their supplied documentation and is contained in this document as indicative only and not for construction or

PROJECT

certification purposes.

# CADDENS HILL SPORTS PRECINCT

CLIENT



NOTES

FOR CONSTRUCTION


ISSUE	CODE	ISSUE DESCRIPTION	BY	СНК	DATE
01	СС	STRUCTURAL REVIEW	ΚZ	PK	01/05/18
02	CC	STRUCTURAL REVIEW	SS	PK	04/05/18
03	CON	FOR CONSTRUCTION	SS	PK	07/05/18
,					
DDE D	anlimic -	aul CA Council Appendit T	Canda	100	l Consta
PKE - P	reilmina	ry   CA - Council Approval   T - 1	ender	JUUI	v - Constru
DR/	WIN	G TITLE			

HARDSCAPE DETAILS
- WALLS


DESIGN : SH/JP
DOCUMENT : EP
PROJECT : 2516076A


SCALE AS @ A1

DRAWING NUMBER REVISION
L913 03

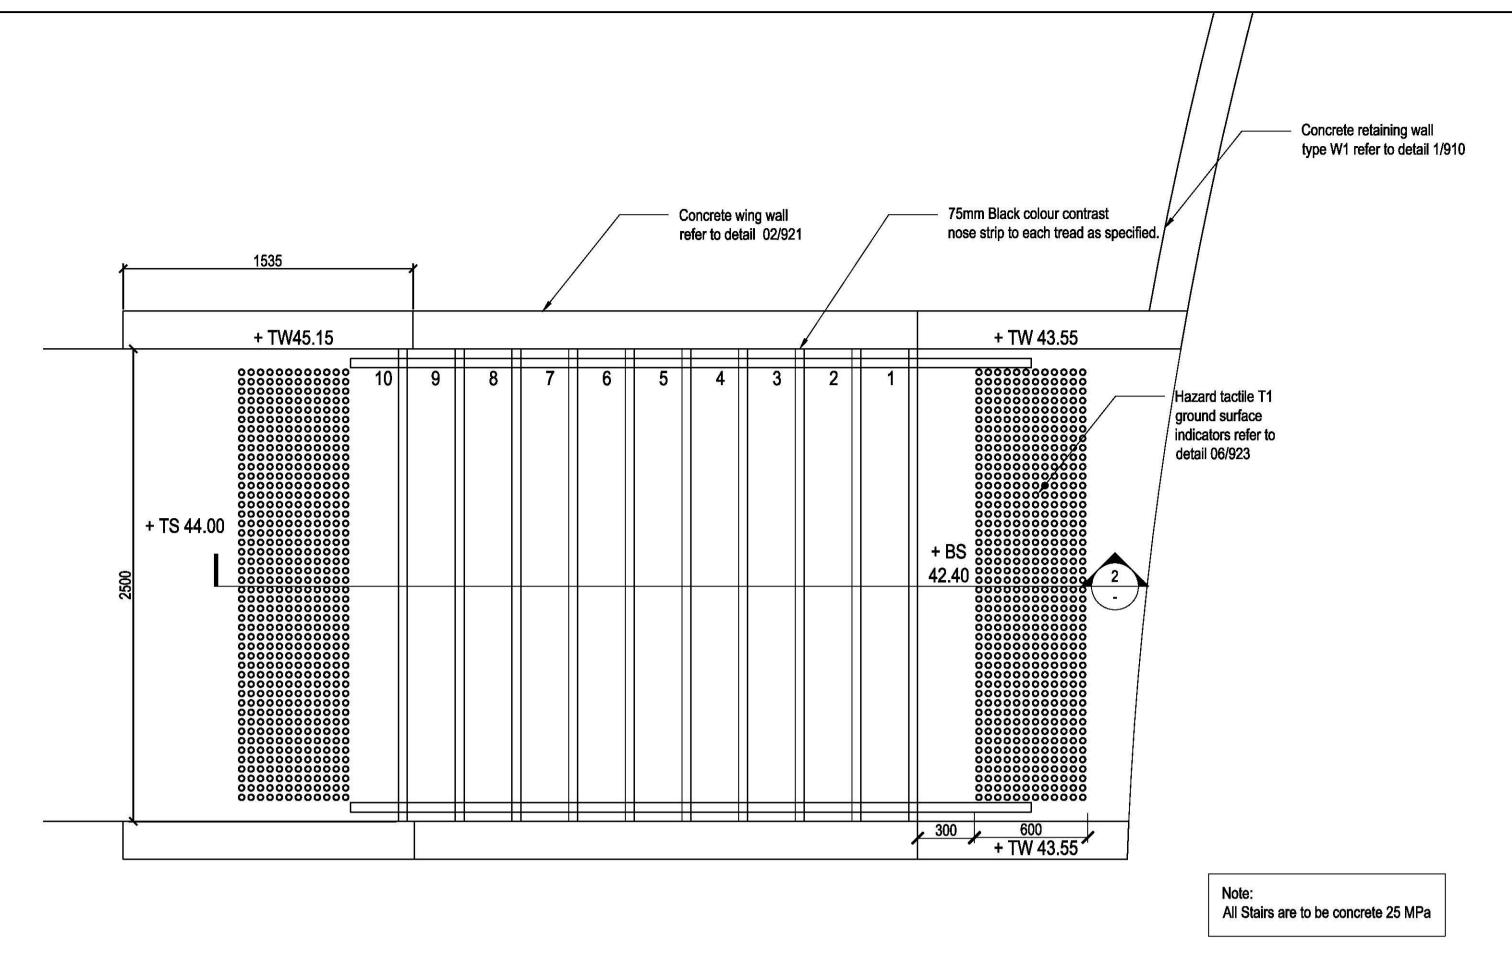


01 STAIR TYPE S1 - DETAIL PLAN SCALE 1:20

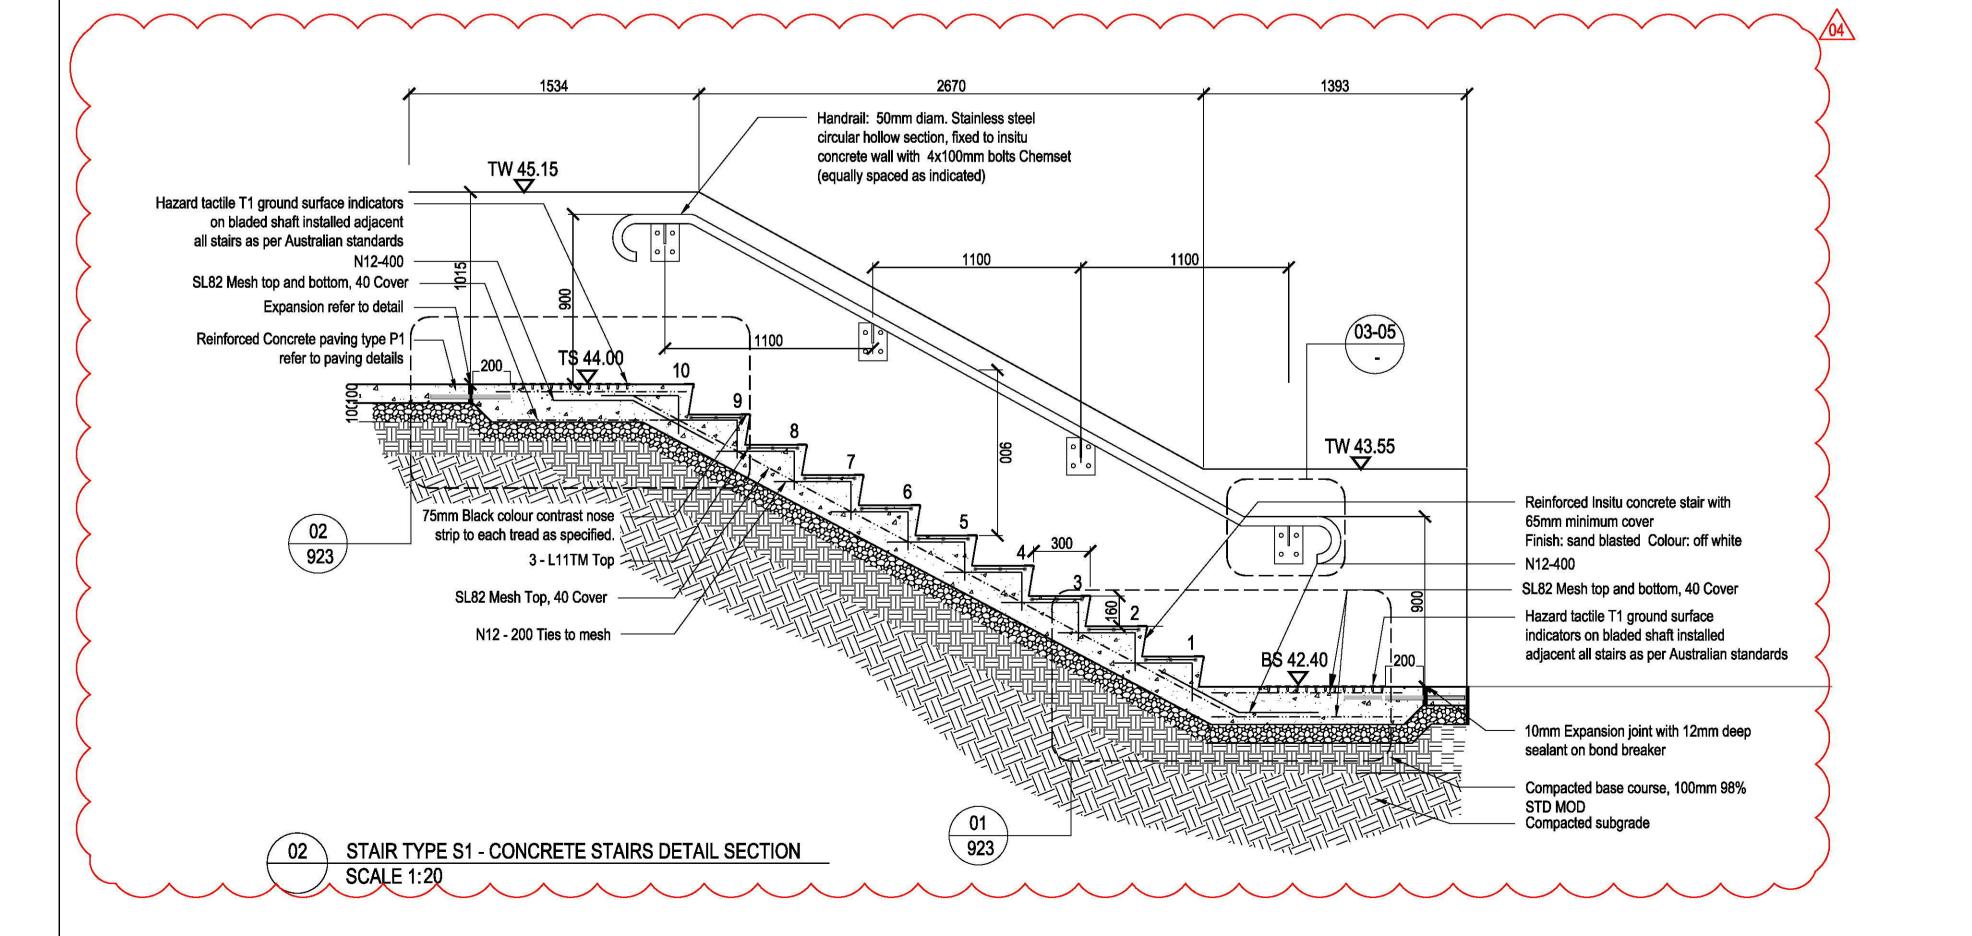


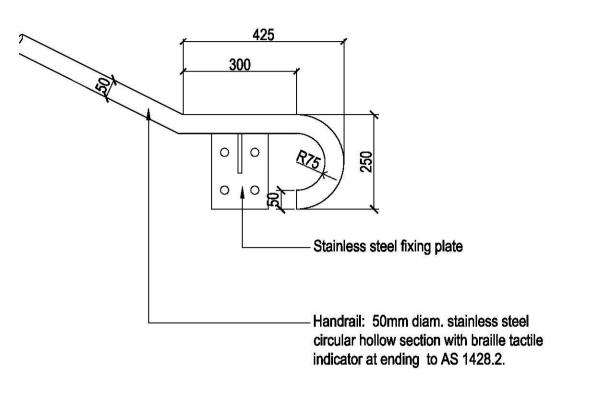

O3 STAIR TYPE S1 - STAINLESS STEEL HANDRAIL DETAIL SCALE 1:10

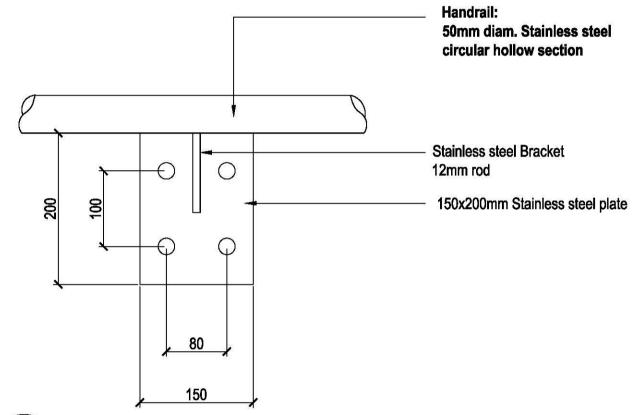

STAIR TYPE S1 - STAINLESS STEEL HANDRAIL FIXING
SCALE 1:5

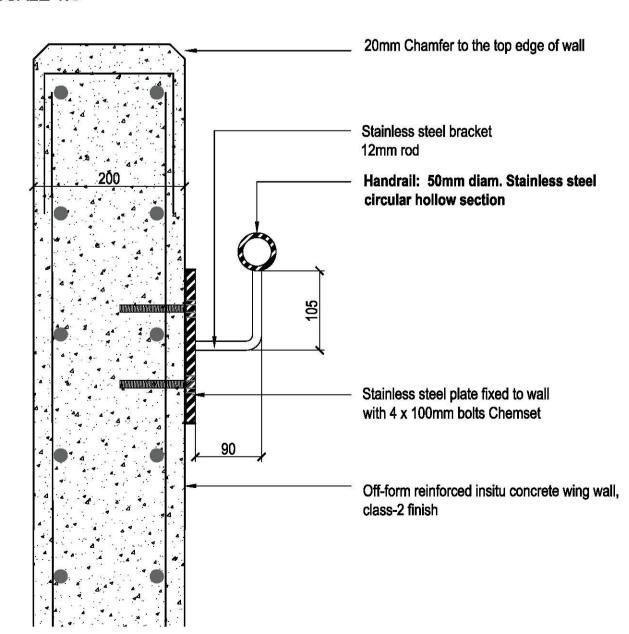

05 STAIR TYPE S1 - STAINLESS STEEL HANDRAIL FIXING SCALE 1:10

# place design group.

SYDNEY
49 Reservoir Street
Surry Hills
NSW, 2010
T + 61 2 9290 3300

#### © Place Design Group Pty Ltd A.C.N. 082 370 063

All information displayed, transmitted or carried within this drawing is protected by Copyright and Intellectual Property laws.

The information contained in this document is confidential.

Recipients of this document are prohibited from disclosing the information herein to any person without the written consent of Place Design Group. Annotated dimensions take precedence over any measures of scale. Verify all dimensions on site prior to construction.

This drawing may display with permission a combination of specialist and other consultant(s) input and linework.

Nominated specialist and consultant information contained within this document is referenced from their supplied documentation and is contained in this document as indicative only and not for construction or certification purposes.

#### **PROJECT**

CADDENS HILL SPORTS PRECINCT

## CLIENT



NOTES

FOR CONSTRUCTION


SSUE	CODE	ISSUE DESCRIPTION	BY	СНК	DATE
01	CC	FOR REVIEW	EP	SH	17/11/17
02	СС	FOR REVIEW	EP	SH	27/11/17
03	СС	REVISED TEXT	EP	SH	19/02/18
04	CC	STRUCTURAL REVIEW	ΚZ	PK	01/05/18
05	СС	STRUCTURAL REVIEW	ΚZ	PK	04/05/18
06	CON	FOR CONSTRUCTION	SS	PK	07/05/18
					4
PRE - P	relimina	ry   CA - Council Approval   T - 1	Tender	CO	N - Construction
DRA	WIN	G TITLE			

HARDSCAPE DETAILS
- STAIRS

DESIGN : SH/JP
DOCUMENT : EP
PROJECT : 2516076A

SCALE AS @ A1


DRAWING NUMBER REVISION
L920 06

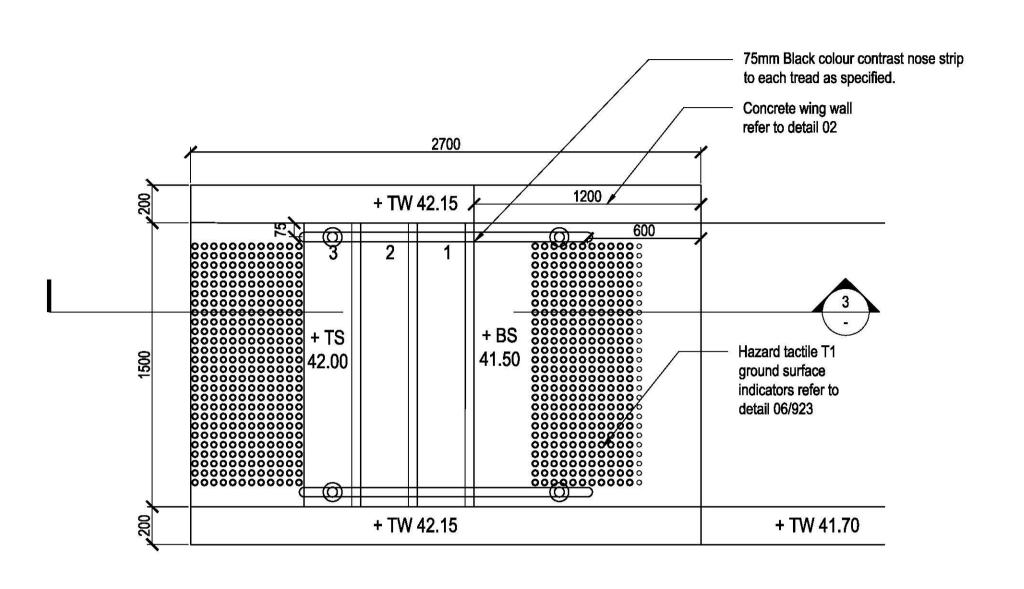

03 923 Hazard tactile T1 ground surface indicators on bladed shaft installed adjacent all stairs as per Australian standards Handrail: 50mm diam. Stainless steel circular hollow section, core-drilled into N12-400 concrete stairs Concrete wing wall type W1 refer to detail 02 Stainless steel upstand to be core-drilled SL82 Mesh top and bottom, 40 Cover into stairs. Stainless steel flange to base Expansion joint refer to detail Reinforced Concrete paving type P1 refer to paving details Footpath as specified 75mm Black colour contrast nose strip to each tread as specified. 3 - L11TM Top 🕏 02 SL82 Mesh Top, 40 Cover N12 - 200 Ties to mesh

O1 STAIR TYPE S2 - DETAIL PLAN
SCALE 1:20

STAIR TYPE S2 - CONCRETE STAIRS DETAIL SECTION
SCALE 1:20

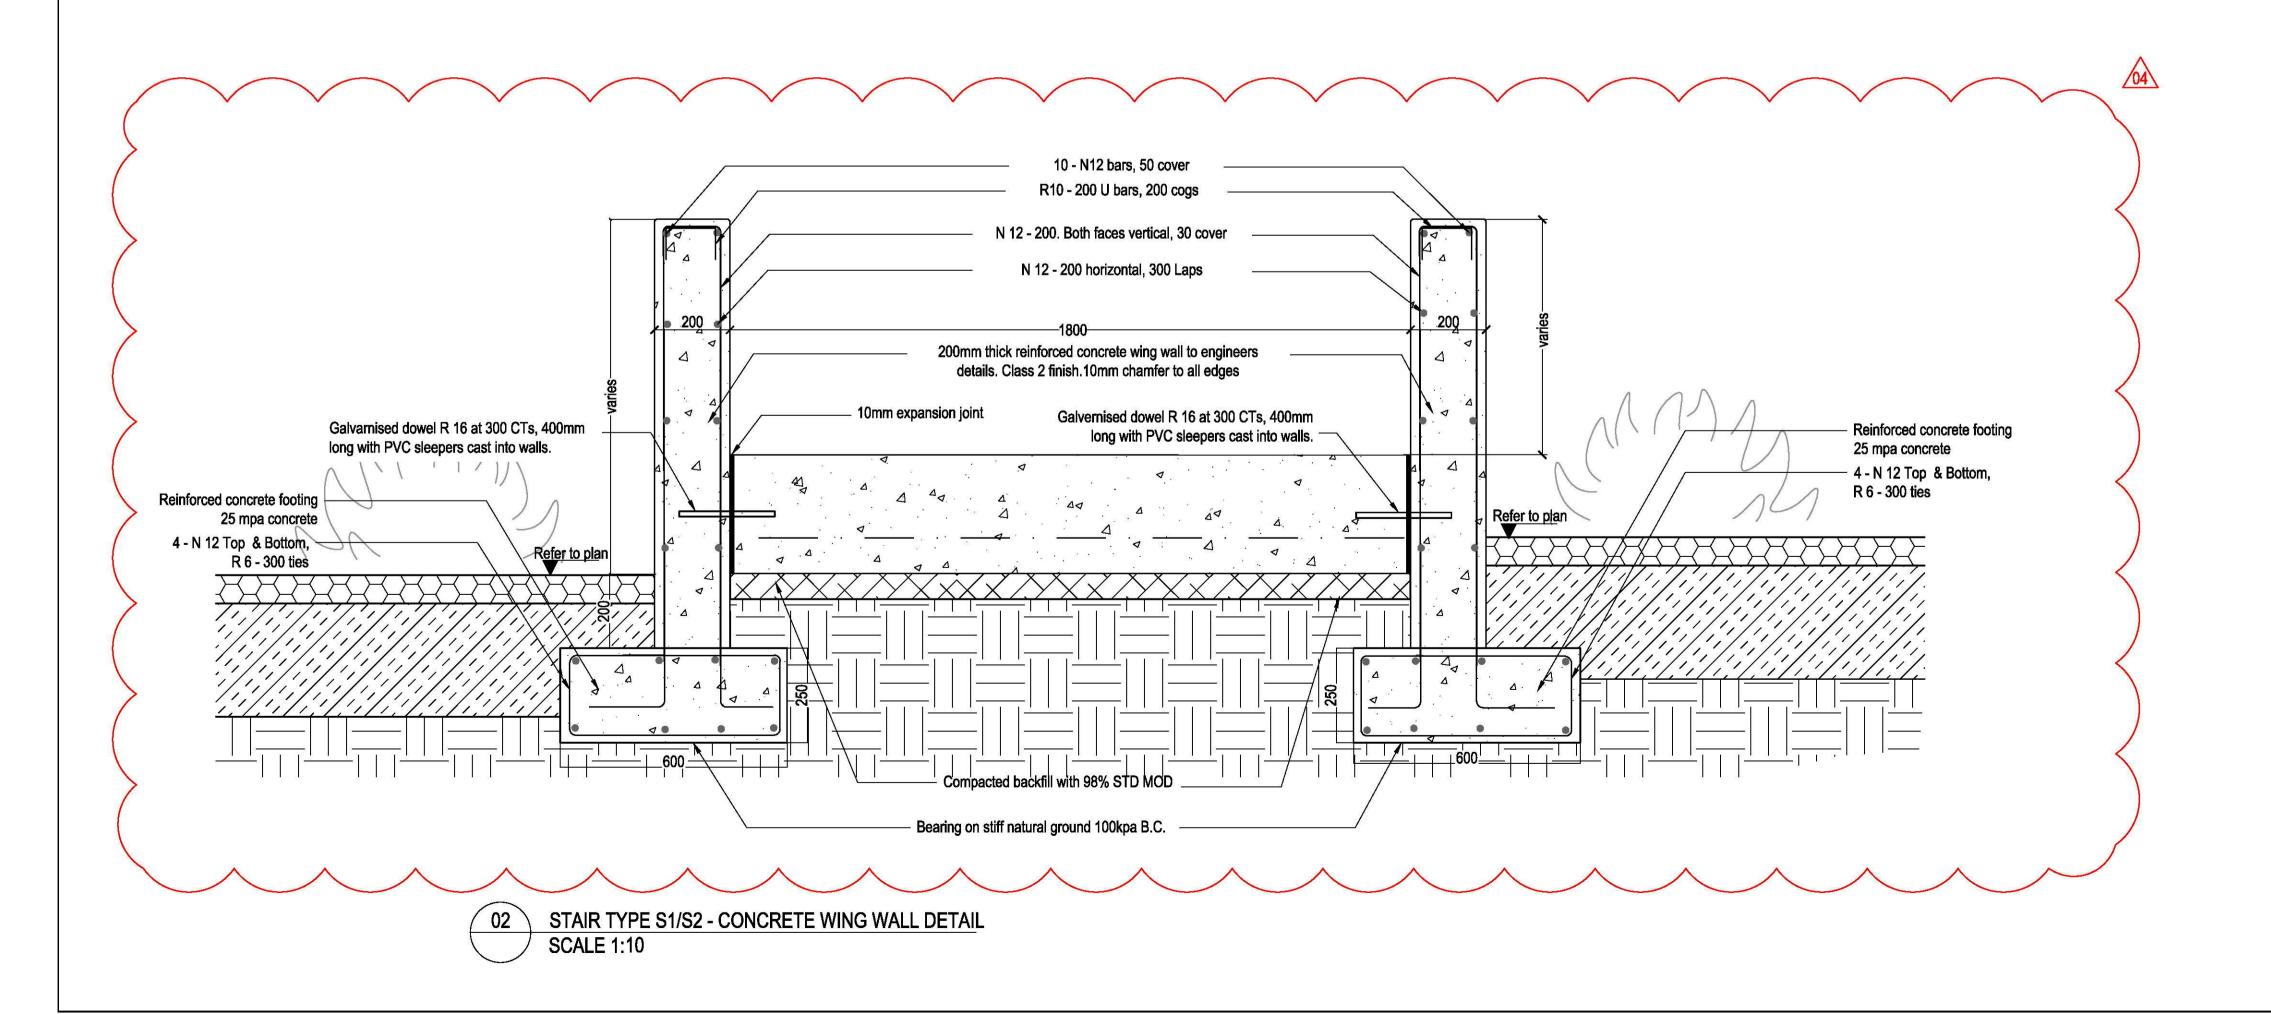

# place design group.

SYDNEY
49 Reservoir Street
Surry Hills
NSW, 2010
T + 61 2 9290 3300

#### © Place Design Group Pty Ltd A.C.N. 082 370 063

All information displayed, transmitted or carried within this drawing is protected by Copyright and Intellectual Property laws.

The information contained in this document is confidential.

Recipients of this document are prohibited from disclosing the information herein to any person without the written consent of Place Design Group. Annotated dimensions take precedence over any measures of scale. Verify all dimensions on site prior to construction.

This drawing may display with permission a combination of specialist and other consultant(s) input and linework.

Nominated specialist and consultant information contained within this document is referenced from their supplied documentation and is contained in this document as indicative only and not for construction or

**PROJECT** 

certification purposes.

CADDENS HILL SPORTS PRECINCT

CLIENT



NOTES

FOR CONSTRUCTION


ISSUE	CODE	ISSUE DESCRIPTION	BY	CHK	DATE
01	CC	FOR REVIEW	EP	SH	17/11/17
02	CC	FOR REVIEW	EP	SH	27/11/17
03	CC	REVISED TEXT	EP	SH	19/02/18
04	CC	STRUCTURAL REVIEW	ΚZ	PK	01/05/18
05	CC	STRUCTURAL REVIEW	ΚZ	PK	04/05/18
06	CON	FOR CONSTRUCTION	SS	PK	07/05/18
PRE - P	relimina	ry   CA - Council Approval   T -	Tender	CO	V - Constr
		G TITLE		20	

HARDSCAPE DETAILS
- STAIRS


DESIGN : SH/JP
DOCUMENT : EP
PROJECT : 2516076A

SCALE AS @ A1

DRAWING NUMBER REVISION 1921 06

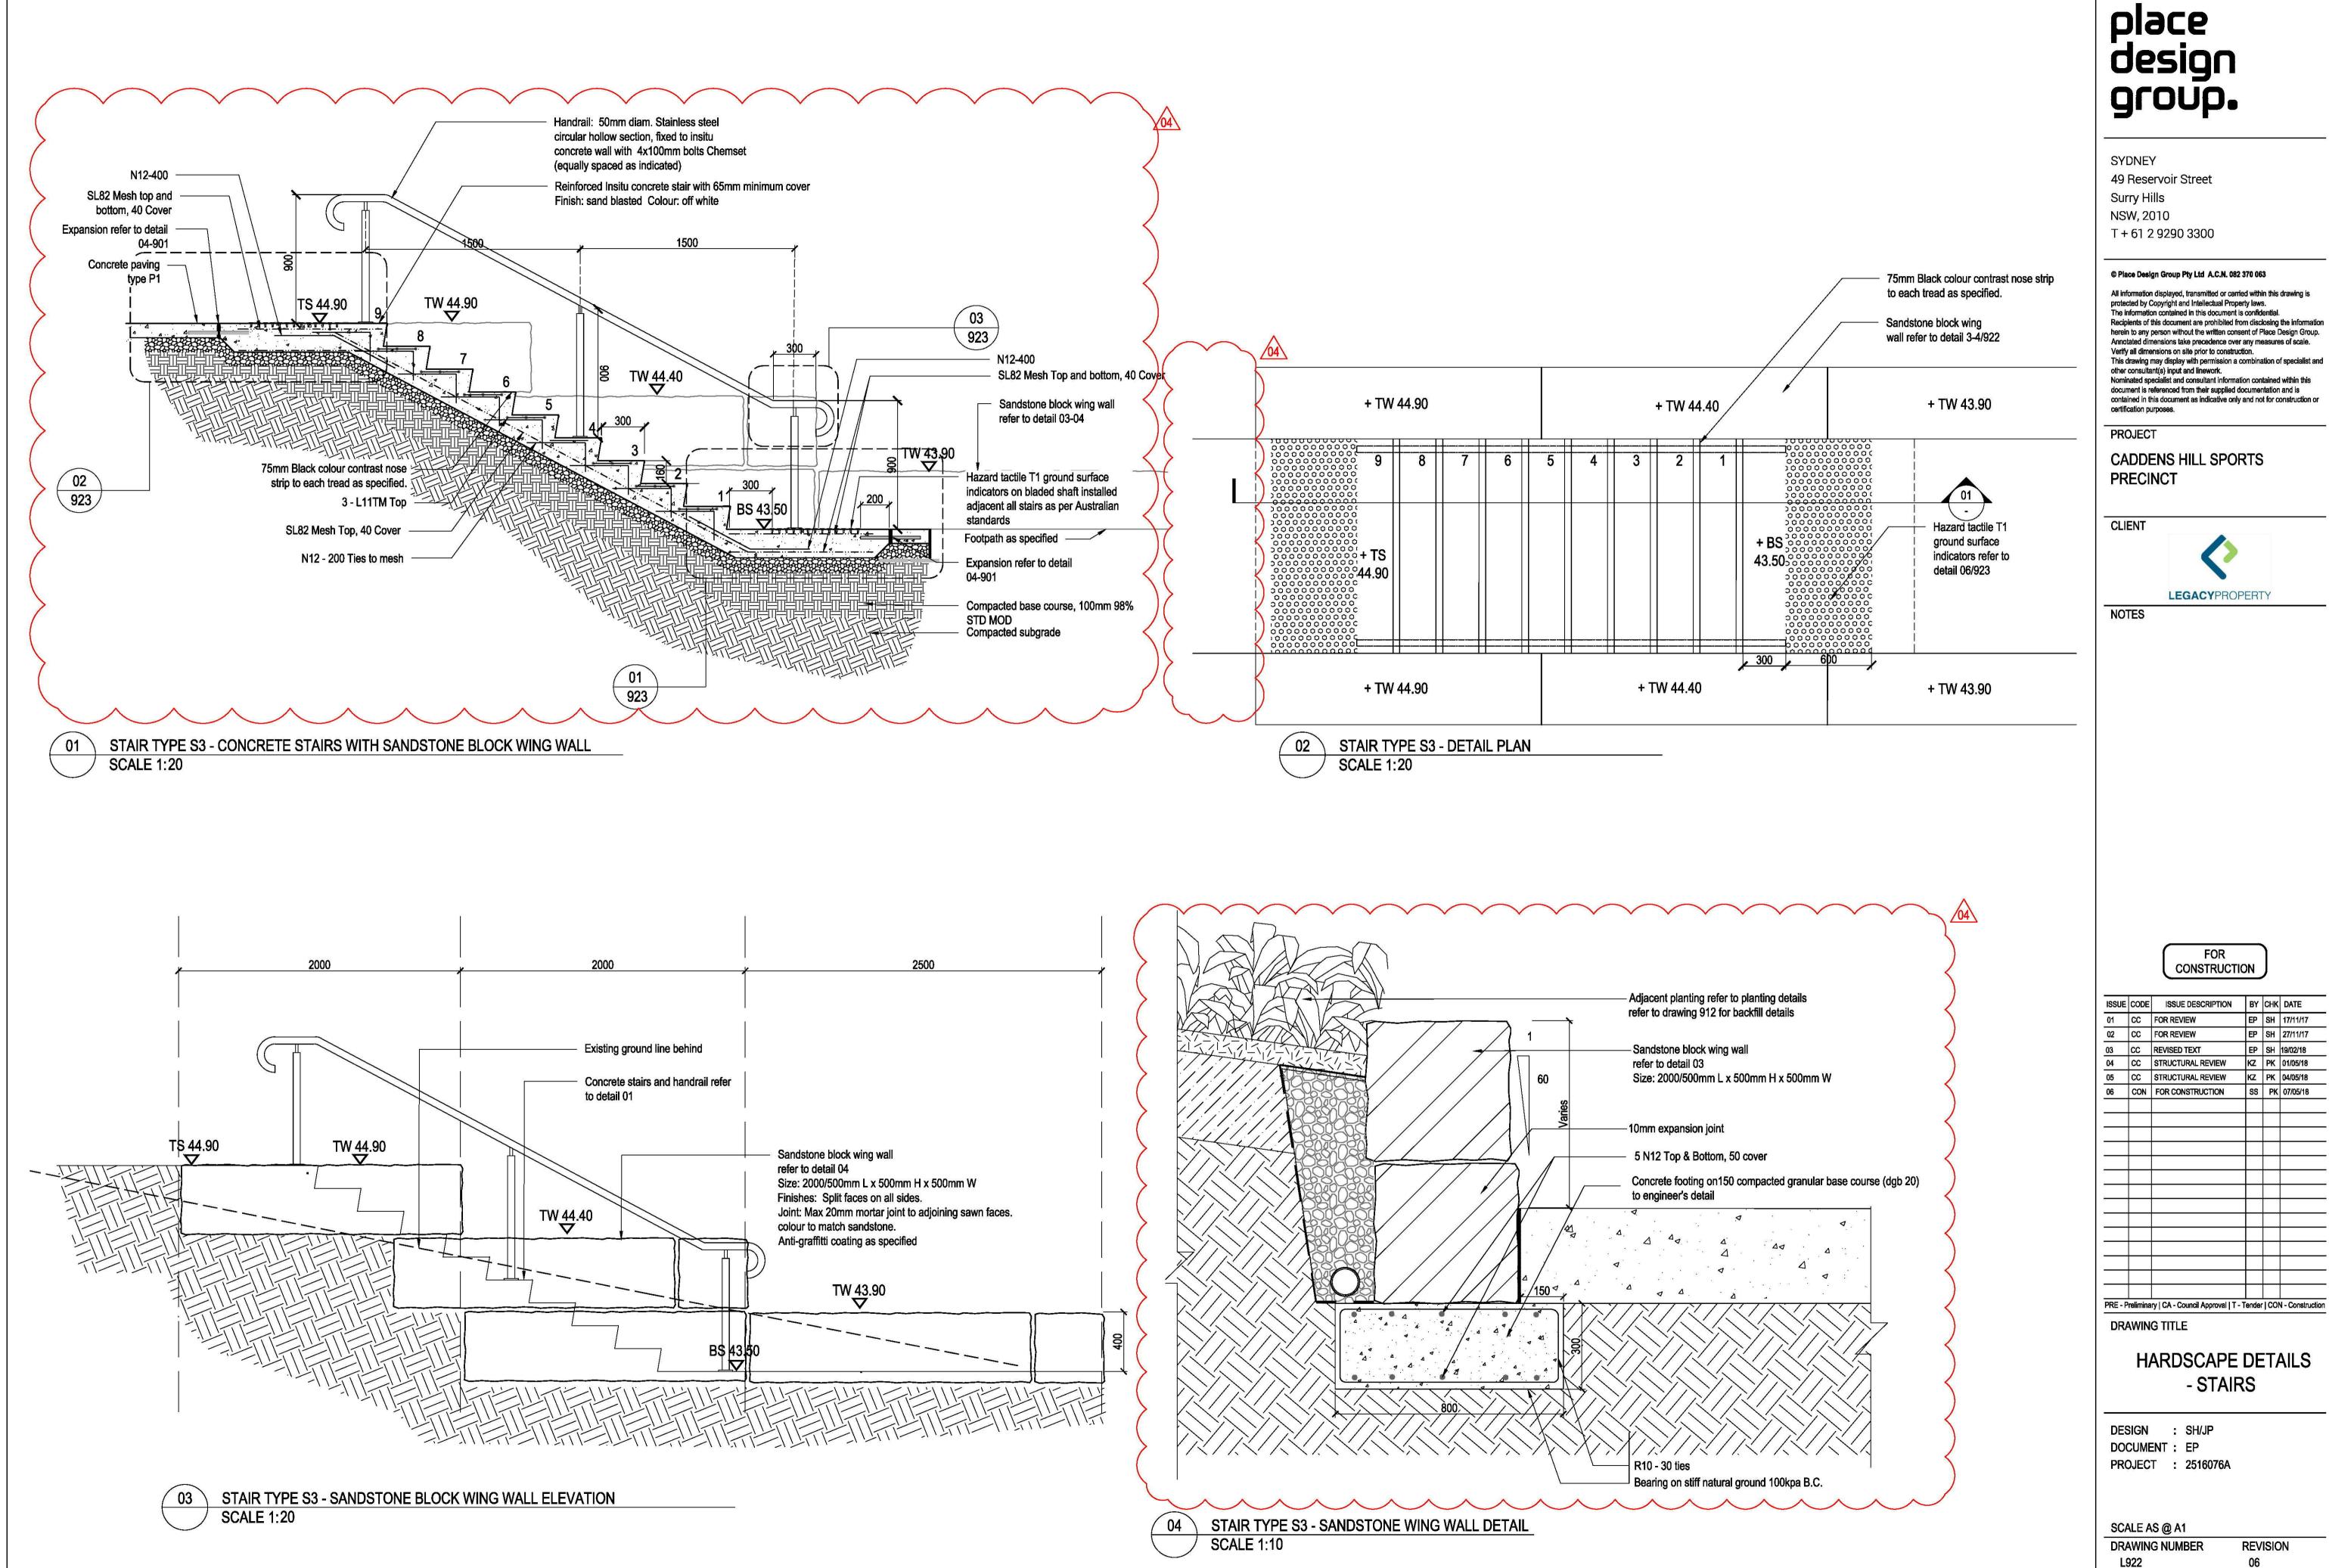

06

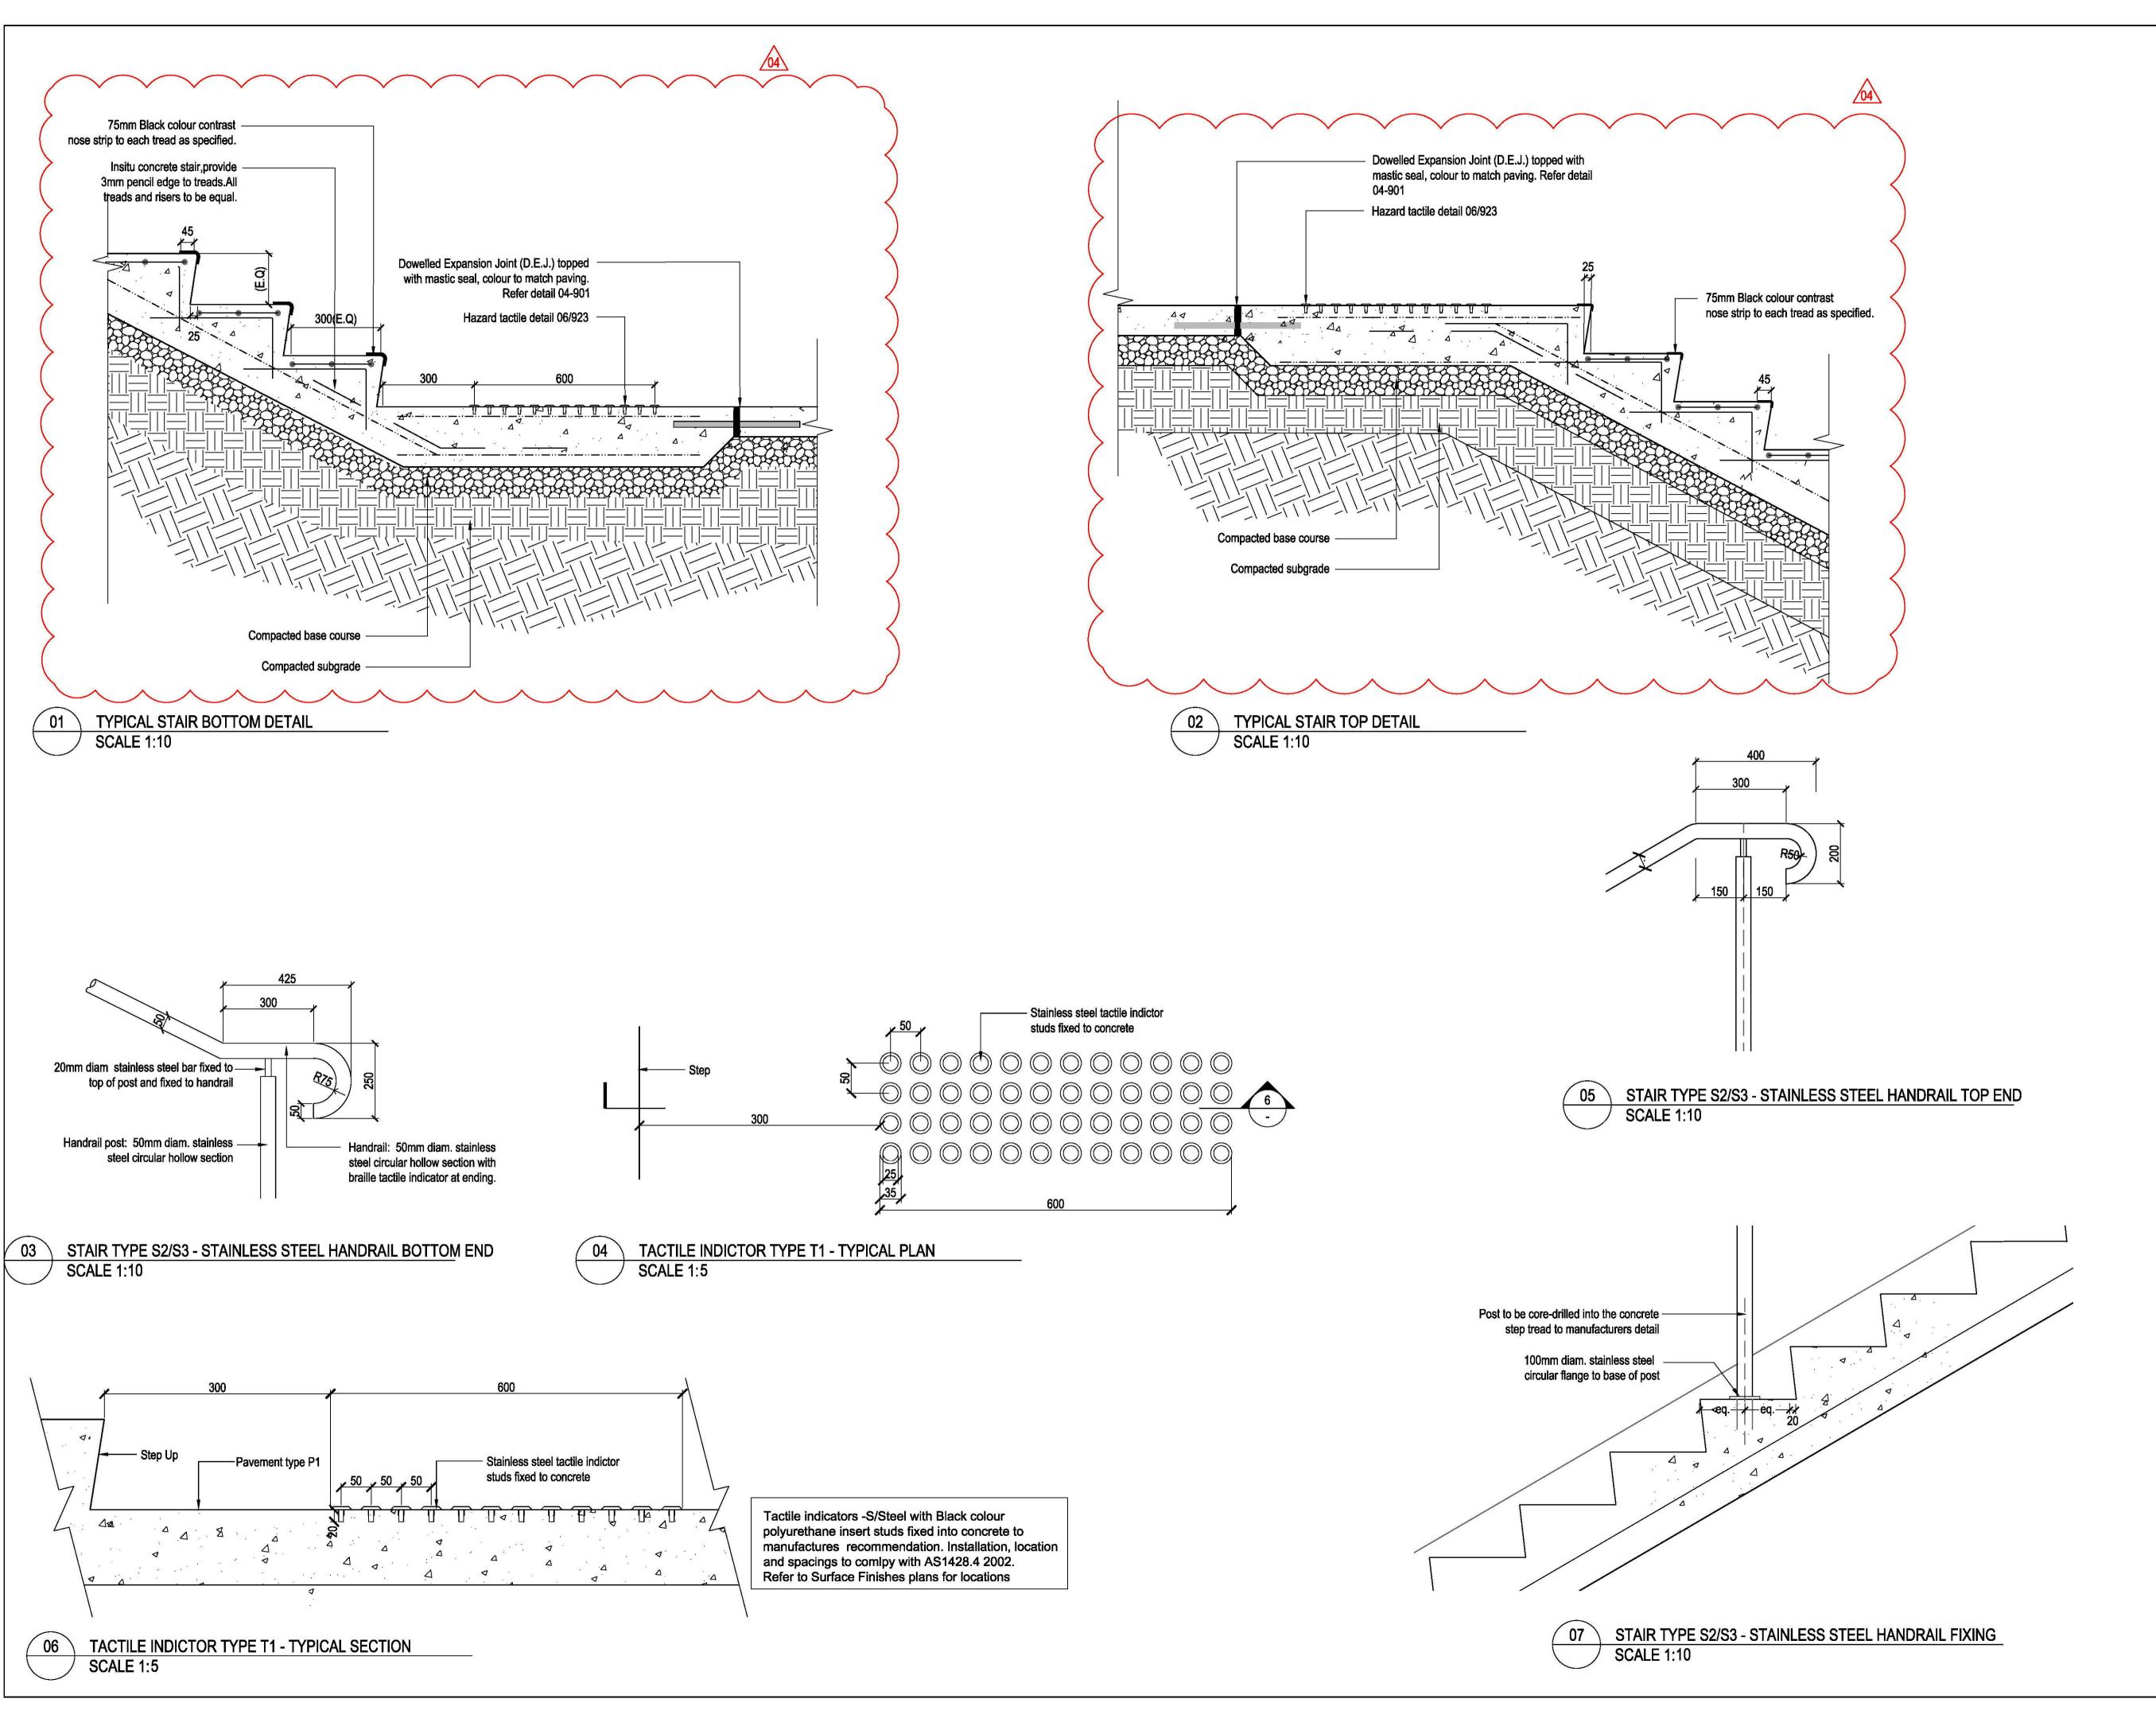

# place design group.

SYDNEY
49 Reservoir Street
Surry Hills
NSW, 2010
T + 61 2 9290 3300

#### © Place Design Group Pty Ltd A.C.N. 082 370 063

All information displayed, transmitted or carried within this drawing is protected by Copyright and Intellectual Property laws.

The information contained in this document is confidential.

Recipients of this document are prohibited from disclosing the information herein to any person without the written consent of Place Design Group. Annotated dimensions take precedence over any measures of scale. Verify all dimensions on site prior to construction.

This drawing may display with permission a combination of specialist and other consultant(s) input and linework.

Nominated specialist and consultant information contained within this document is referenced from their supplied documentation and is contained in this document as indicative only and not for construction or

PROJECT

certification purposes.

CADDENS HILL SPORTS PRECINCT

CLIENT



NOTES

FOR CONSTRUCTION

ISSUE	CODE	ISSUE DESCRIPTION	BY	CHK	DATE
01	CC	FOR REVIEW	EP	SH	17/11/17
02	CC	FOR REVIEW	EP	SH	27/11/17
03	cc	REVISED TEXT	EP	SH	19/02/18
04	CC	STRUCTURAL REVIEW	ΚZ	PK	01/05/18
05	CC	STRUCTURAL REVIEW	ΚZ	PK	04/05/18
06	CON	FOR CONSTRUCTION	SS	PK	07/05/18
			9	8	
PRE - P	relimina	ry   CA - Council Approval   T -	Tender	CO	V - Constr
DR/	MIWZ	G TITLE			

HARDSCAPE DETAILS
- STAIRS


REVISION


06

DESIGN : SH/JP
DOCUMENT : EP
PROJECT : 2516076A

SCALE AS @ A1
DRAWING NUMBER

L923

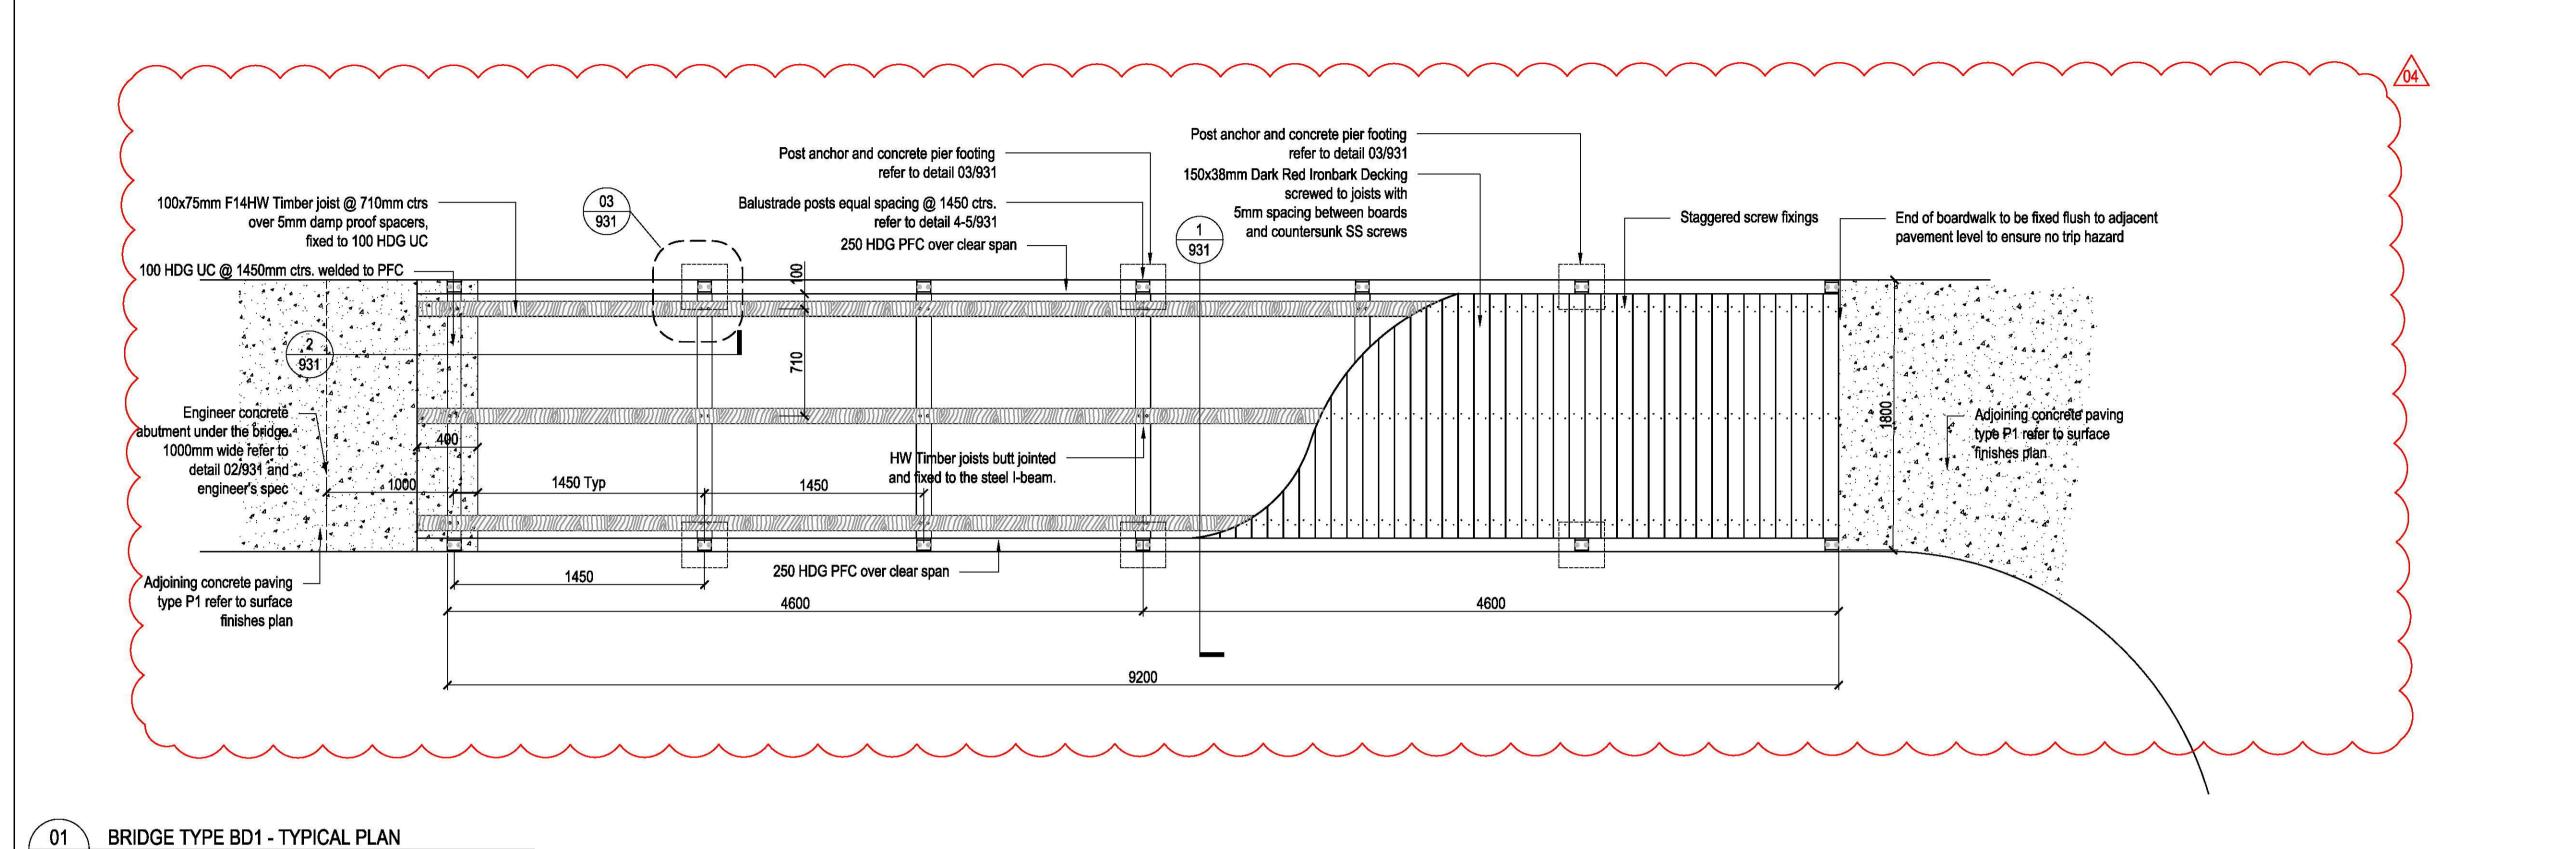

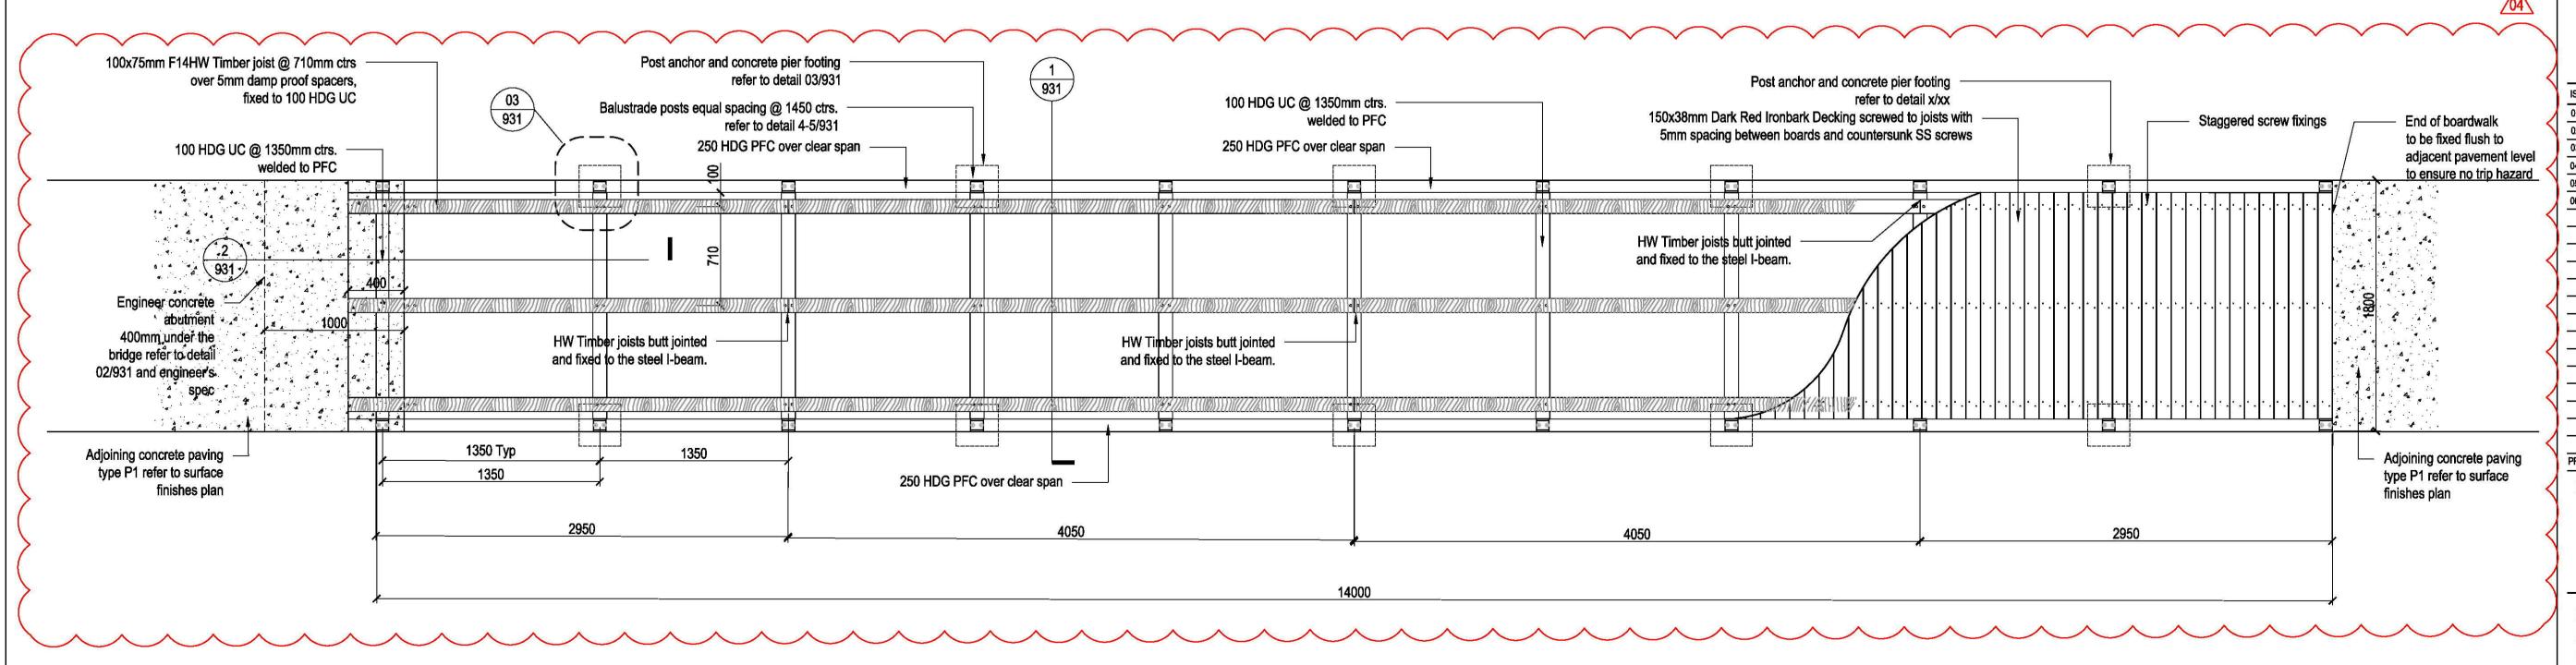

# place design group.

SYDNEY
49 Reservoir Street
Surry Hills
NSW, 2010
T + 61 2 9290 3300

### © Place Design Group Pty Ltd A.C.N. 082 370 063

All information displayed, transmitted or carried within this drawing is protected by Copyright and Intellectual Property laws.

The information contained in this document is confidential.

Recipients of this document are prohibited from disclosing the information herein to any person without the written consent of Place Design Group. Annotated dimensions take precedence over any measures of scale. Verify all dimensions on site prior to construction.

This drawing may display with permission a combination of specialist and other consultant(s) input and linework.

Nominated specialist and consultant information contained within this document is referenced from their supplied documentation and is contained in this document as indicative only and not for construction or

**PROJECT** 

certification purposes.

CADDENS HILL SPORTS PRECINCT

CLIENT



NOTES

FOR CONSTRUCTION

HARDSCAPE DETAILS
- STRUCTURE

DESIGN : SH/JP
DOCUMENT : EP
PROJECT : 2516076A


SCALE AS @ A1


DRAWING NUMBER REVISION
L930 06


BRIDGE TYPE BD2 - TYPICAL PLAN


**SCALE 1:25** 

**SCALE 1:25** 

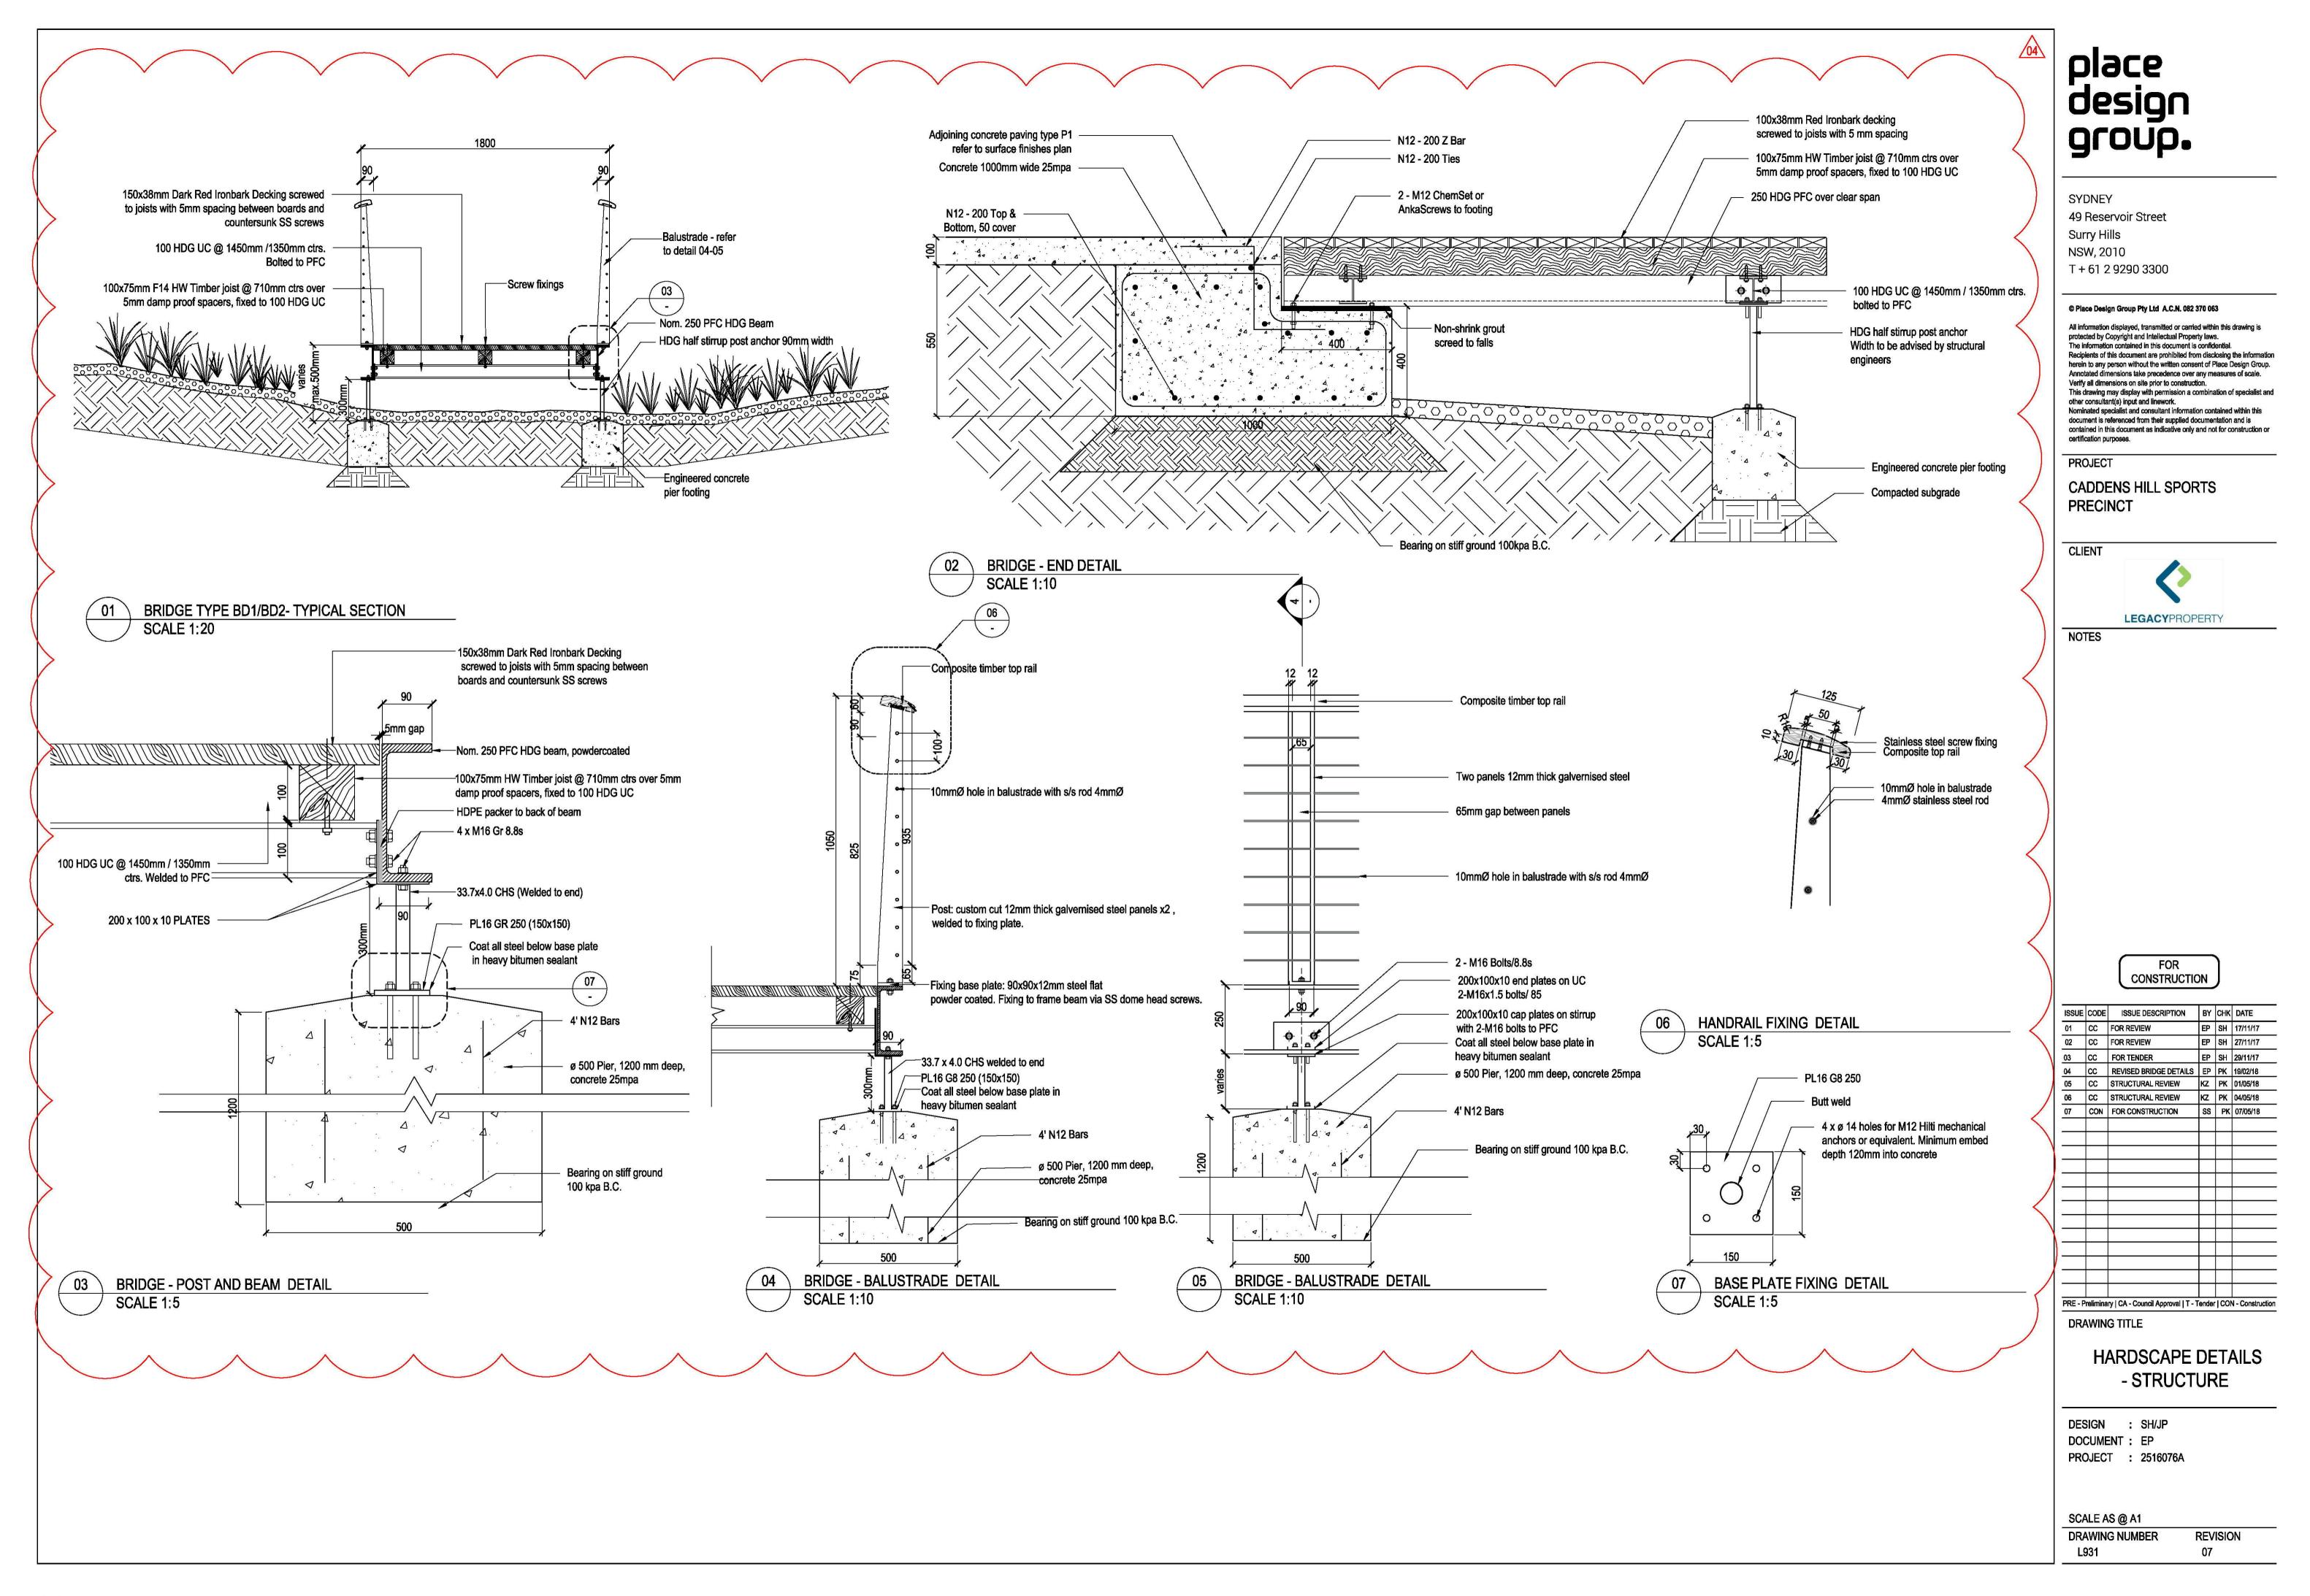

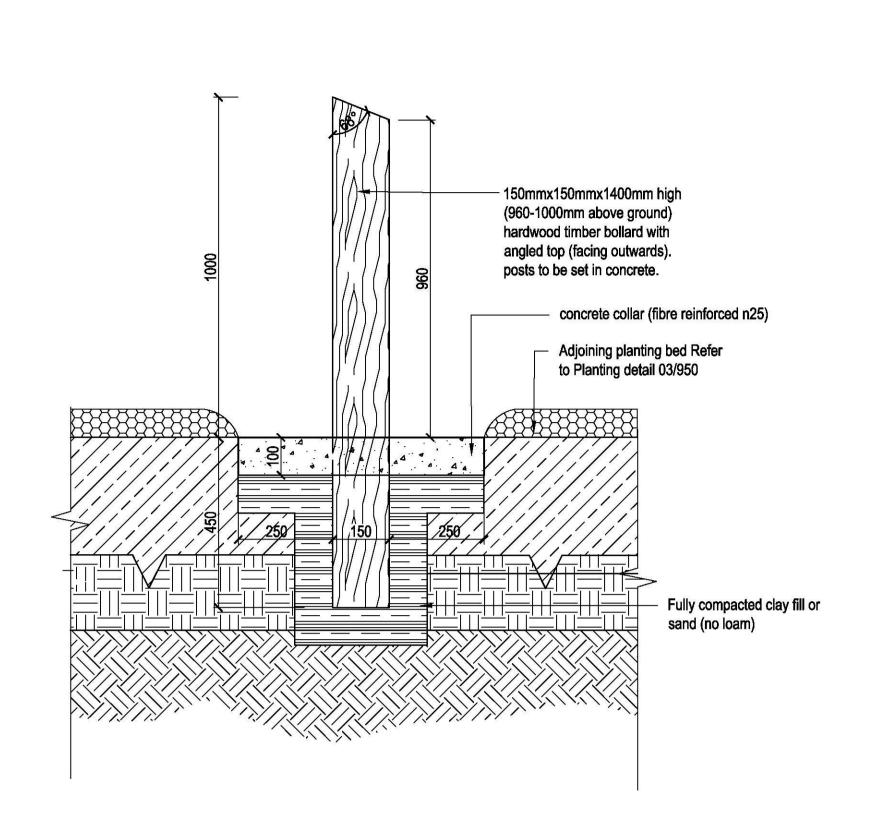

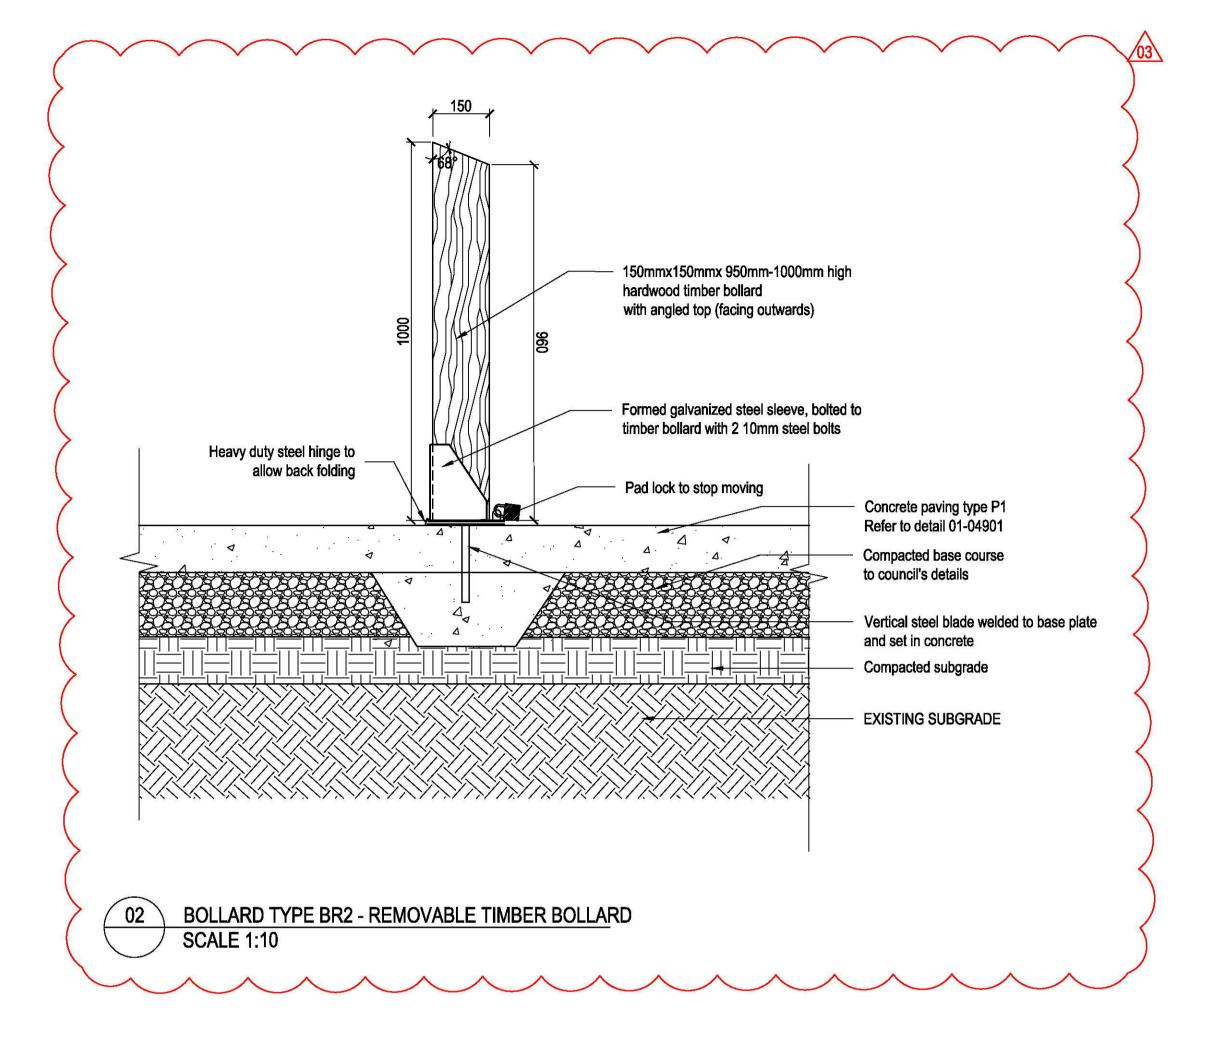

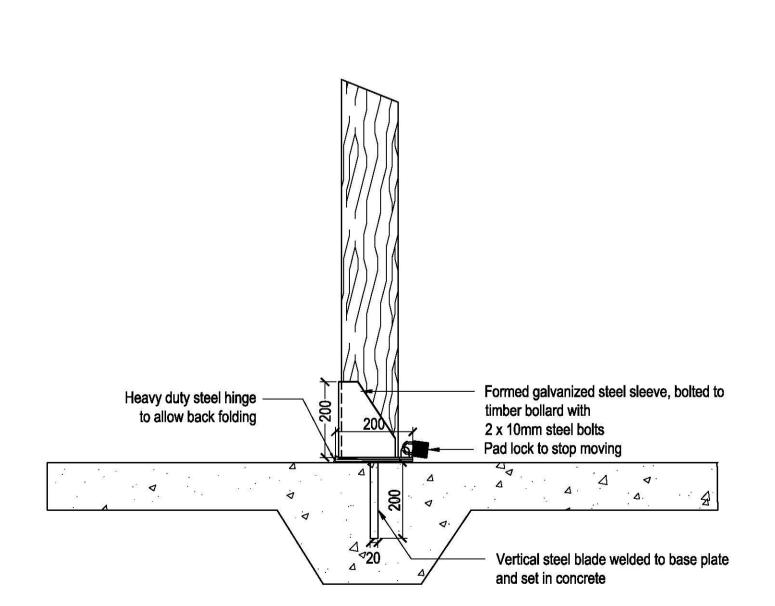

BOLLARD TYPE BR1 - FIXED TIMBER BOLLARD

SCALE 1:10

Bike hoop refer to manufacture's spec for Installation.

Posts Bolled to Concrete slab under povement

Concrete Plaver type P2 to paving details 05-06901

Augustrag Andrea

Manufacture's spec for Installation.

Once are state to Mile Manufacture's spec for Installation.

Manufacture's spec for Installation.

BOLLARD TYPE BR2 - REMOVABLE TIMBER BOLLARD FIXING DETAIL
SCALE 1:10

04 BIKE HOOP - TYPICAL DETIAL SCALE 1:10

# place design group.

SYDNEY
49 Reservoir Street
Surry Hills
NSW, 2010
T + 61 2 9290 3300

#### © Place Design Group Pty Ltd A.C.N. 082 370 063

All information displayed, transmitted or carried within this drawing is protected by Copyright and Intellectual Property laws.

The information contained in this document is confidential.

Recipients of this document are prohibited from disclosing the information herein to any person without the written consent of Place Design Group. Annotated dimensions take precedence over any measures of scale. Verify all dimensions on site prior to construction.

This drawing may display with permission a combination of specialist and other consultant(s) input and linework.

Nominated specialist and consultant information contained within this document is referenced from their supplied documentation and is contained in this document as indicative only and not for construction or certification purposes.

**PROJECT** 

CADDENS HILL SPORTS PRECINCT

CLIENT



NOTES

FOR CONSTRUCTION

SSUE	CODE	ISSUE DESCRIPTION	BY	СНК	DATE
01	CC	FOR REVIEW	EP	SH	17/11/17
02	СС	FOR REVIEW	EP	SH	27/11/17
)3	СС	STRUCTURAL REVIEW	ΚZ	PK	01/05/18
)4	CC	STRUCTURAL REVIEW	ΚZ	PK	04/05/18
)5	CON	FOR CONSTRUCTION	SS	PK	07/05/18
RF - P	relimina	ry   CA - Council Approval   T -	Tende	LCON	I - Constructi
		ry   CA - Council Approval   1 - G TITLE	· iende	r J COI	- Constructi


HARDSCAPE DETAILS
- FURNITURE


DESIGN : SH/JP
DOCUMENT : EP
PROJECT : 2516076A


SCALE AS @ A1

DRAWING NUMBER REVISION

05

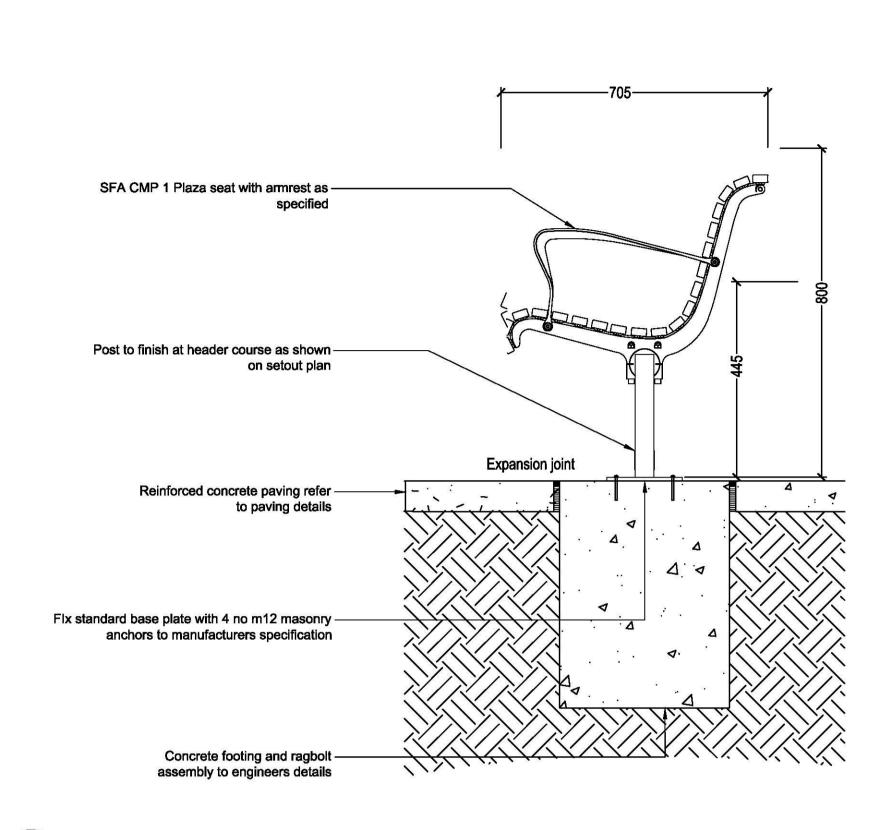

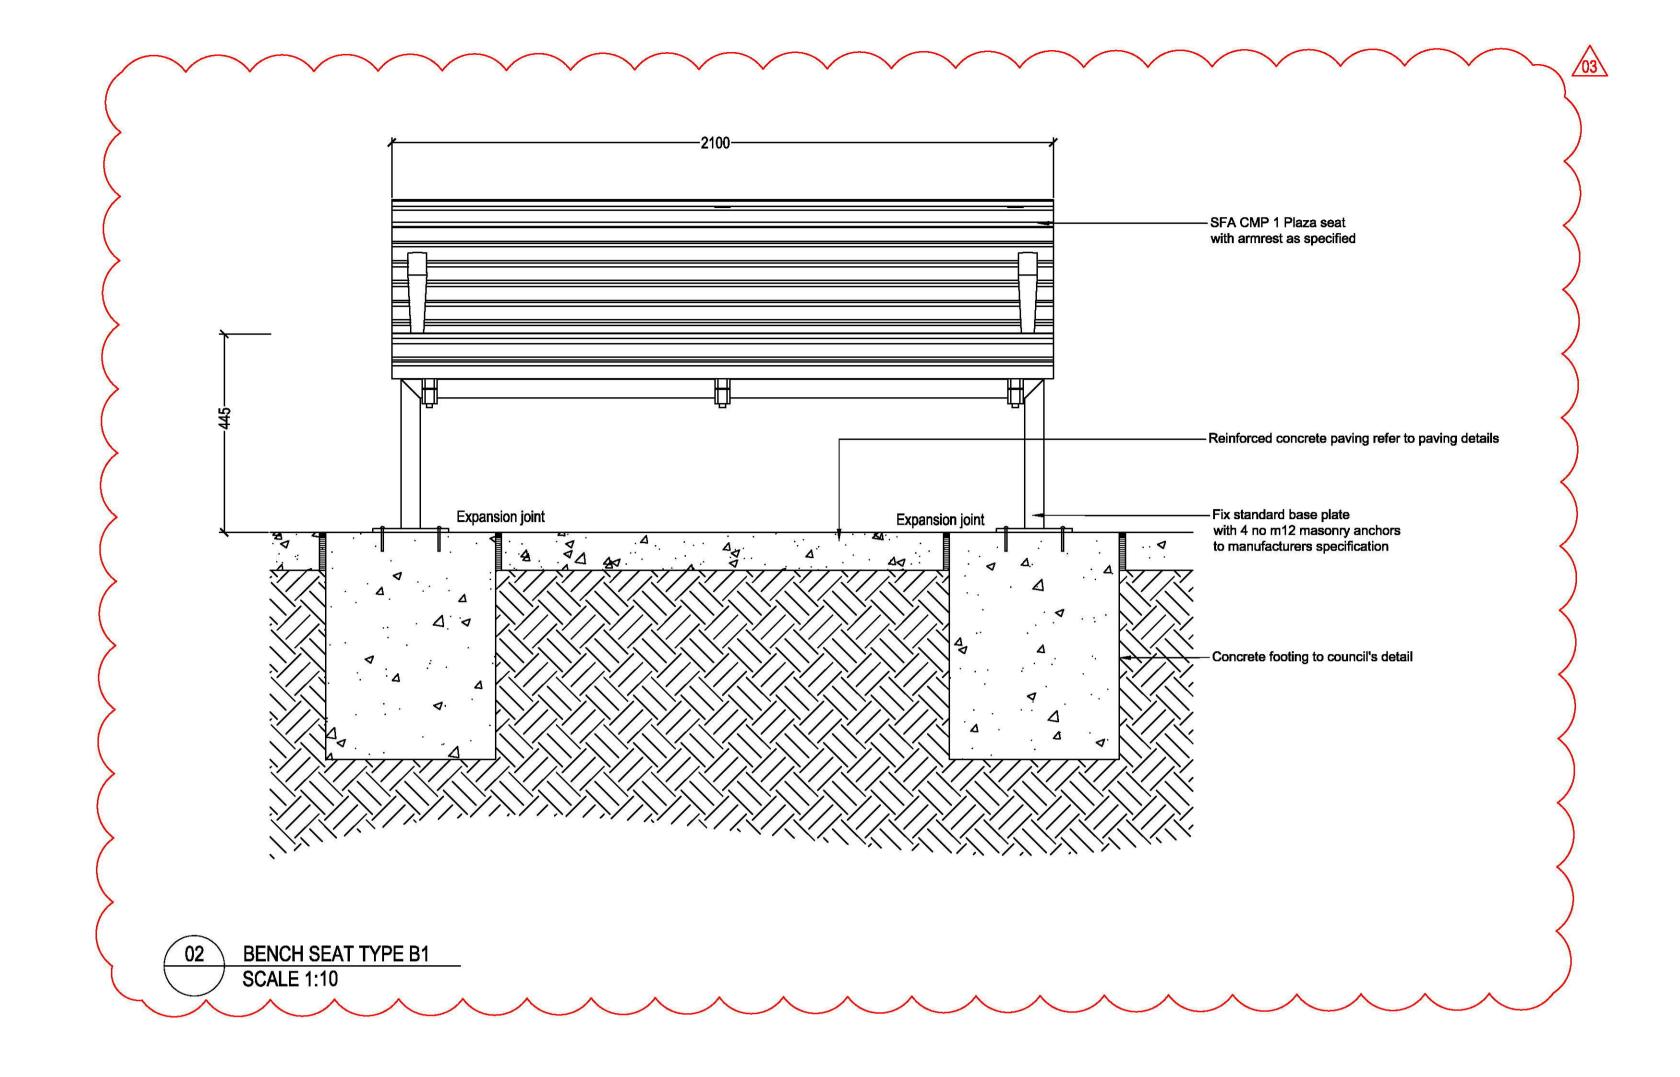


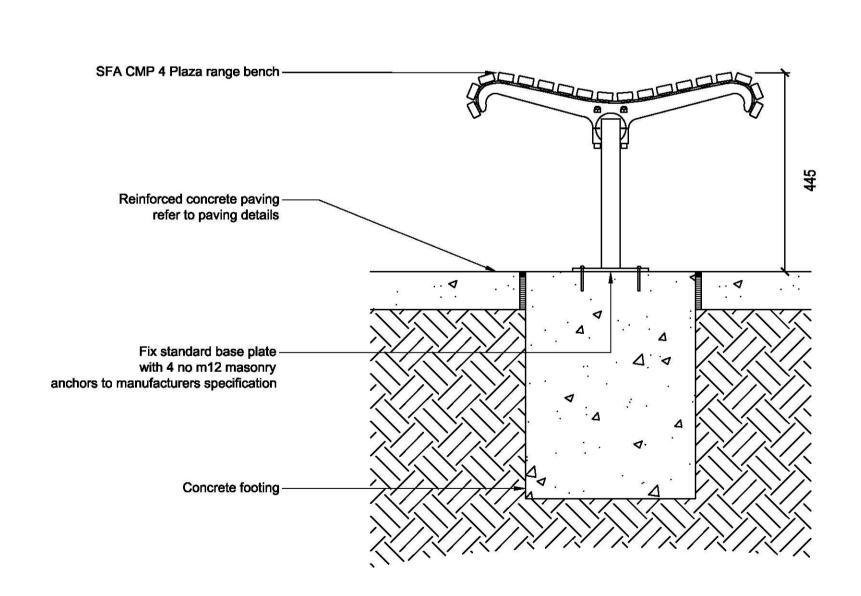

03 BENCH SEAT TYPE B2
SCALE 1:10

**BENCH SEAT TYPE B1** 

**SCALE 1:10** 

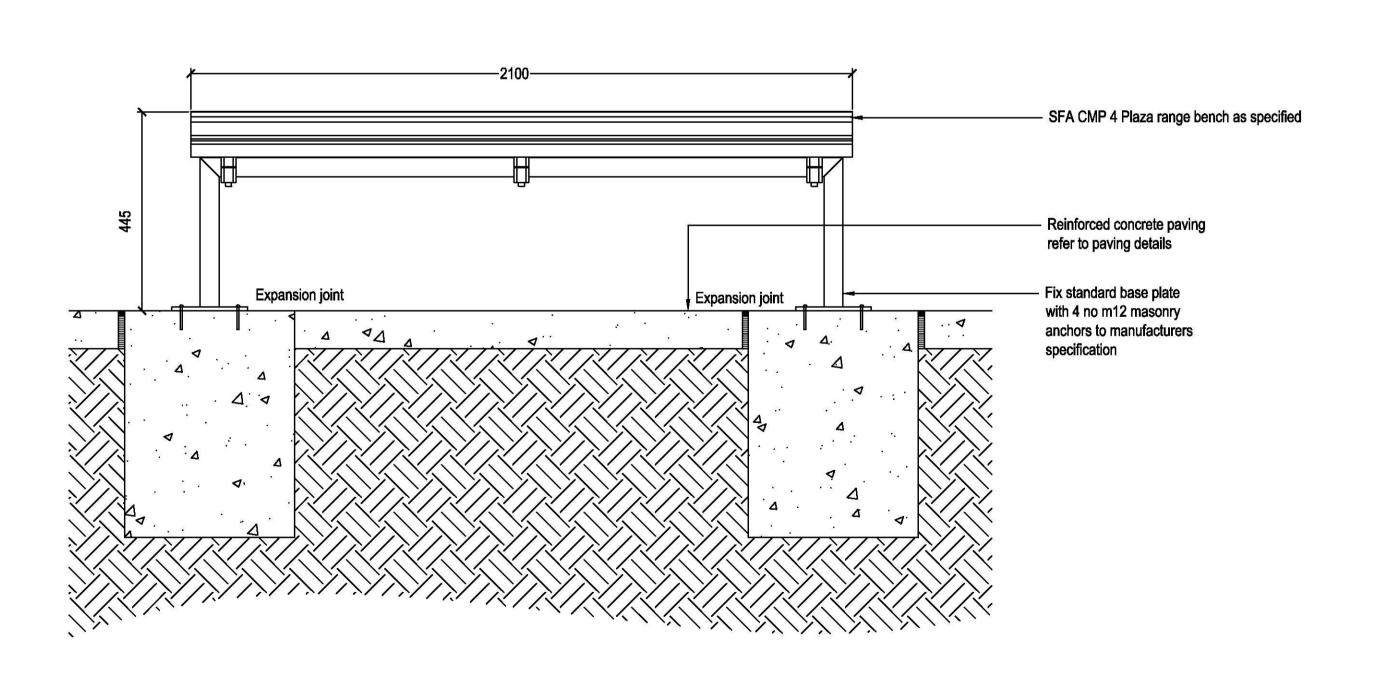

04 BENCH SEAT TYPE B2 SCALE 1:10

# place design group.

SYDNEY
49 Reservoir Street
Surry Hills
NSW, 2010
T + 61 2 9290 3300

#### © Place Design Group Pty Ltd A.C.N. 082 370 063

All information displayed, transmitted or carried within this drawing is protected by Copyright and Intellectual Property laws.

The information contained in this document is confidential.

Recipients of this document are prohibited from disclosing the information herein to any person without the written consent of Place Design Group. Annotated dimensions take precedence over any measures of scale. Verify all dimensions on site prior to construction.

This drawing may display with permission a combination of specialist and other consultant(s) input and linework.

Nominated specialist and consultant information contained within this document is referenced from their supplied documentation and is contained in this document as indicative only and not for construction or certification purposes.

PROJECT

CADDENS HILL SPORTS PRECINCT

CLIENT



NOTES

FOR CONSTRUCTION

ISSUE	CODE	ISSUE DESCRIPTION	BY	CHK	DATE
01	CC	FOR REVIEW	EP	SH	17/11/17
02	CC	FOR REVIEW	EP	SH	27/11/17
03	CC	STRUCTURAL REVIEW	ΚZ	PK	01/05/18
04	CC	STRUCTURAL REVIEW	ΚZ	PK	04/05/18
05	CC	STRUCTURAL REVIEW	ΚZ	PK	04/05/18
06	CON	FOR CONSTRUCTION	SS	PK	07/05/18
			+		
		101 0		100	
PRE - P	relimina	ry   CA - Council Approval   T -	Tende	CO	V - Constr

HARDSCAPE DETAILS
- FURNITURE

DESIGN : SH/JP
DOCUMENT : EP
PROJECT : 2516076A

SCALE AS @ A1

DRAWING NUMBER REVISION L933 06