

ASSOCIATED DOCUMENTS ARE SUBJECT TO COPYRIGHT LAWS & MAY NOT BE REPRODUCED IN ANY FORM WITHOUT WRITTEN CONSENT FROM AUSTRALIAN SUSTAINABLE DESIGN AND CONSTRUCTION PTY LTD T/AS AUSDAC.



COMMENCEMENT OF ANY BUILDING WORK. ANY DISCREPANCIES ARE TO BE BROUGHT TO THE ATTENTION OF THE DESIGNER.

2) LEVELS SHOWN ARE APPROXIMATE UNLESS ACCOMPANIED BY REDUCED LEVELS.

3) FIGURED DIMENSIONS MUST BE TAKEN IN PREFERENCE TO SCALING.

4) ALL BOUNDARY CLEARANCES MUST BE VERIFIED BY THE SURVEYOR PRIOR TO THE COMMENCEMENT OF ANY BUILDING WORKS.

5) WHERE ENGINEERING DRAWINGS ARE REQUIRED SUCH MUST TAKE PREFERENCE TO THIS DRAWING

6) STORMWATER TO BE DISCHARGED TO COUNCIL'S REQUIREMENTS AND AS 3500.3-1990. 7) ALL SERVICES TO BE LOCATED & VERIFIED BY THE BUILDER WITH RELEVANT AUTHORITIES BEFORE ANY BUILDING WORK COMMENCES.

8) ALL CONSTRUCTION & MATERIALS TO BE IN ACCORDANCE WITH THE NATIONAL CONSTRUCTION CODE (NCC), LOCAL GOVERNMENT POLICIES, AUSTRALIAN STANDARDS 8 CURRENT MANUFACTURER'S SPECIFICATIONS & INSTALLATION DETAILS.

### **GMKA PTY LTD**

**BOARDING HOUSE** 


**Property Description** LOT 3 / DP 39084 - 31 SECOND

**AVE KINGSWOOD NSW 2747** 

#### SITE PLAN / ANALYSIS Project No. **Sheet Size** A3 100119 A01 17/3/2017 As indicated Drawn by Checked by SMSM

REV	DESCRIPTION	DATE	
01	CONCEPT	12/04/2017	
02	DA SUBMISSION	24/10/2017	7
03	ADDITIONAL INFORMATION	20/06/2018	AUSDAC
			AUSTRALIAN SUSTAINABI DESIGN AND CONSTRUCTION PTY LTI
			T: 1300 AUSDAC (287 322 F: 1300 856 935
			P: PO BOX 414, GRANVILL NSW 2142
			W: WWW.AUSDAC.COM.A



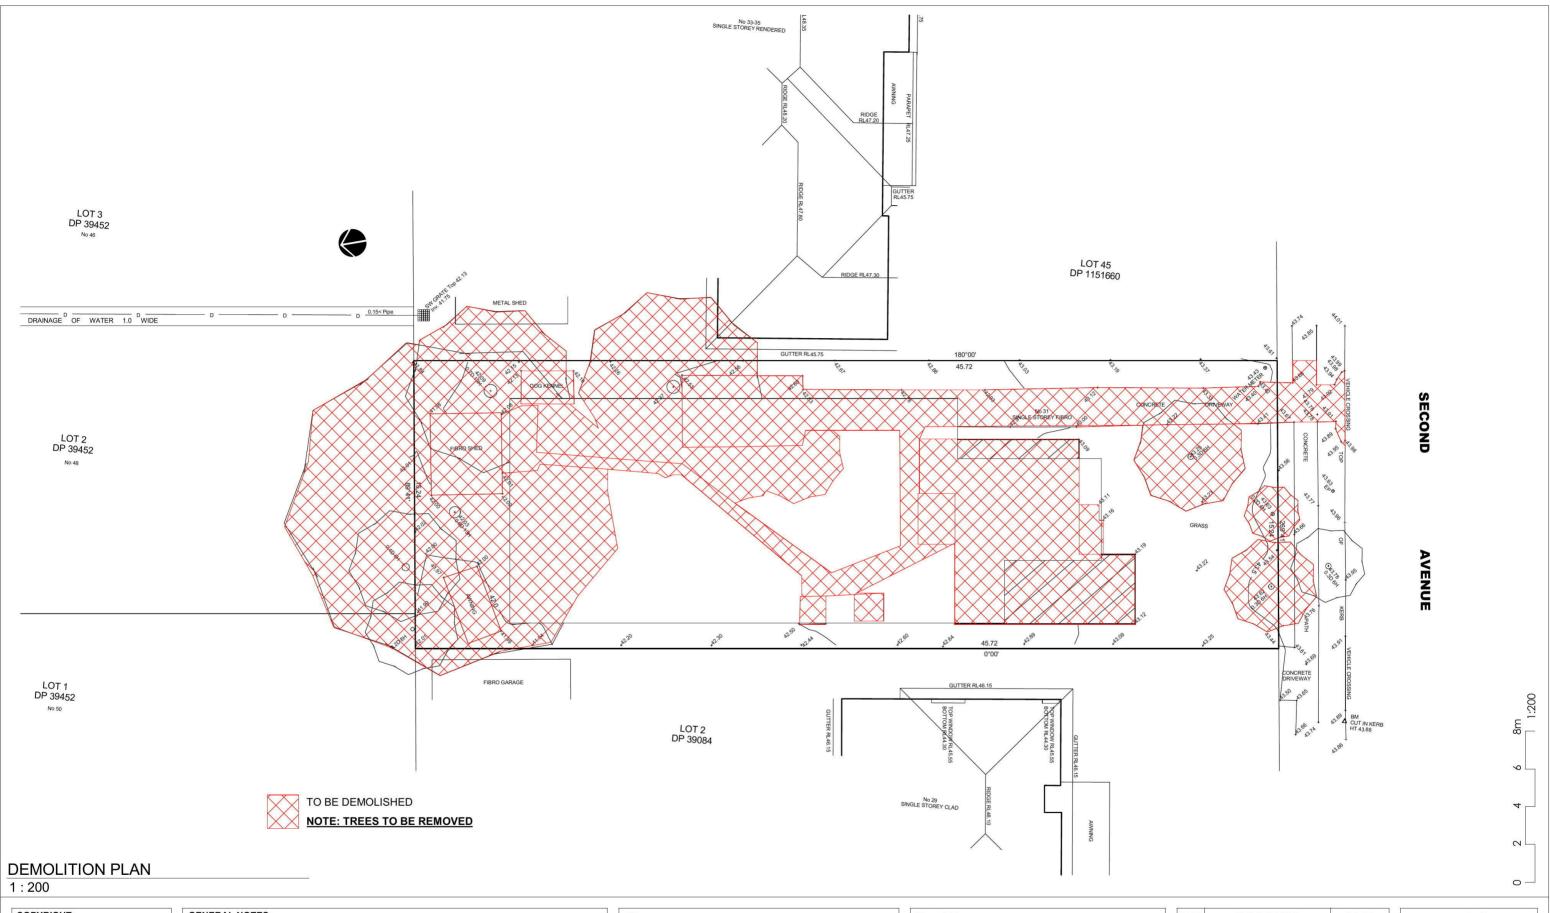

THIS DESIGN & THE ASSOCIATED DOCUMENTS ARE SUBJECT TO COPYRIGHT LAWS & MAY NOT BE REPRODUCED IN ANY FORM WITHOUT WRITTEN CONSENT FROM AUSTRALIAN SUSTAINABLE DESIGN AND CONSTRUCTION PTY LTD T/AS AUSDAC.



DIAL BEFORE

The Essential First Step Document Set ID: 8376860

1) ALL DIMENSIONS & FLOOR AREAS ARE TO BE VERIFIED BY THE BUILDER PRIOR TO THE COMMENCEMENT OF ANY BUILDING WORK. ANY DISCREPANCIES ARE TO BE BROUGHT TO THE ATTENTION OF THE DESIGNER.
2) LEVELS SHOWN ARE APPROXIMATE UNLESS ACCOMPANIED BY REDUCED LEVELS.

- 3) FIGURED DIMENSIONS MUST BE TAKEN IN PREFERENCE TO SCALING.
- 4) ALL BOUNDARY CLEARANCES MUST BE VERIFIED BY THE SURVEYOR PRIOR TO THE
- COMMENCEMENT OF ANY BUILDING WORKS.
  5) WHERE ENGINEERING DRAWINGS ARE REQUIRED SUCH MUST TAKE PREFERENCE TO THIS DRAWING.
- 6) STORMWATER TO BE DISCHARGED TO COUNCIL'S REQUIREMENTS AND AS 3500.3-1990. 7) ALL SERVICES TO BE LOCATED & VERIFIED BY THE BUILDER WITH RELEVANT AUTHORITIES BEFORE ANY BUILDING WORK COMMENCES.
- 8) ALL CONSTRUCTION & MATERIALS TO BE IN ACCORDANCE WITH THE NATIONAL CONSTRUCTION CODE (NCC), LOCAL GOVERNMENT POLICIES, AUSTRALIAN STANDARDS & CURRENT MANUFACTURER'S SPECIFICATIONS & INSTALLATION DETAILS.

GMKA PTY LTD
Project BOARDING HOUSE
Property Description LOT 3 / DP 39084 - 31 SECOND


AVE KINGSWOOD NSW 2747

DEMOLITION	I PLAN	
Project No.	Sheet No.	Sheet Size
100119	A02	A3
Date	Scale	
17/3/2017	1:200	
Drawn by	Checked by	
SM	SM	

DESCRIPTION	DATE	
CONCEPT	12/04/2017	
DA SUBMISSION	24/10/2017	7
ADDITIONAL INFORMATION	20/06/2018	AUSDAC
		AUSTRALIAN SUSTAINABL DESIGN AND CONSTRUCTION PTY LTD
		T: 1300 AUSDAC (287 322) F: 1300 856 935
		P: PO BOX 414, GRANVILLE NSW 2142
	CONCEPT	CONCEPT         12/04/2017           DA SUBMISSION         24/10/2017



Version: 1, Version Date: 11/09/2018

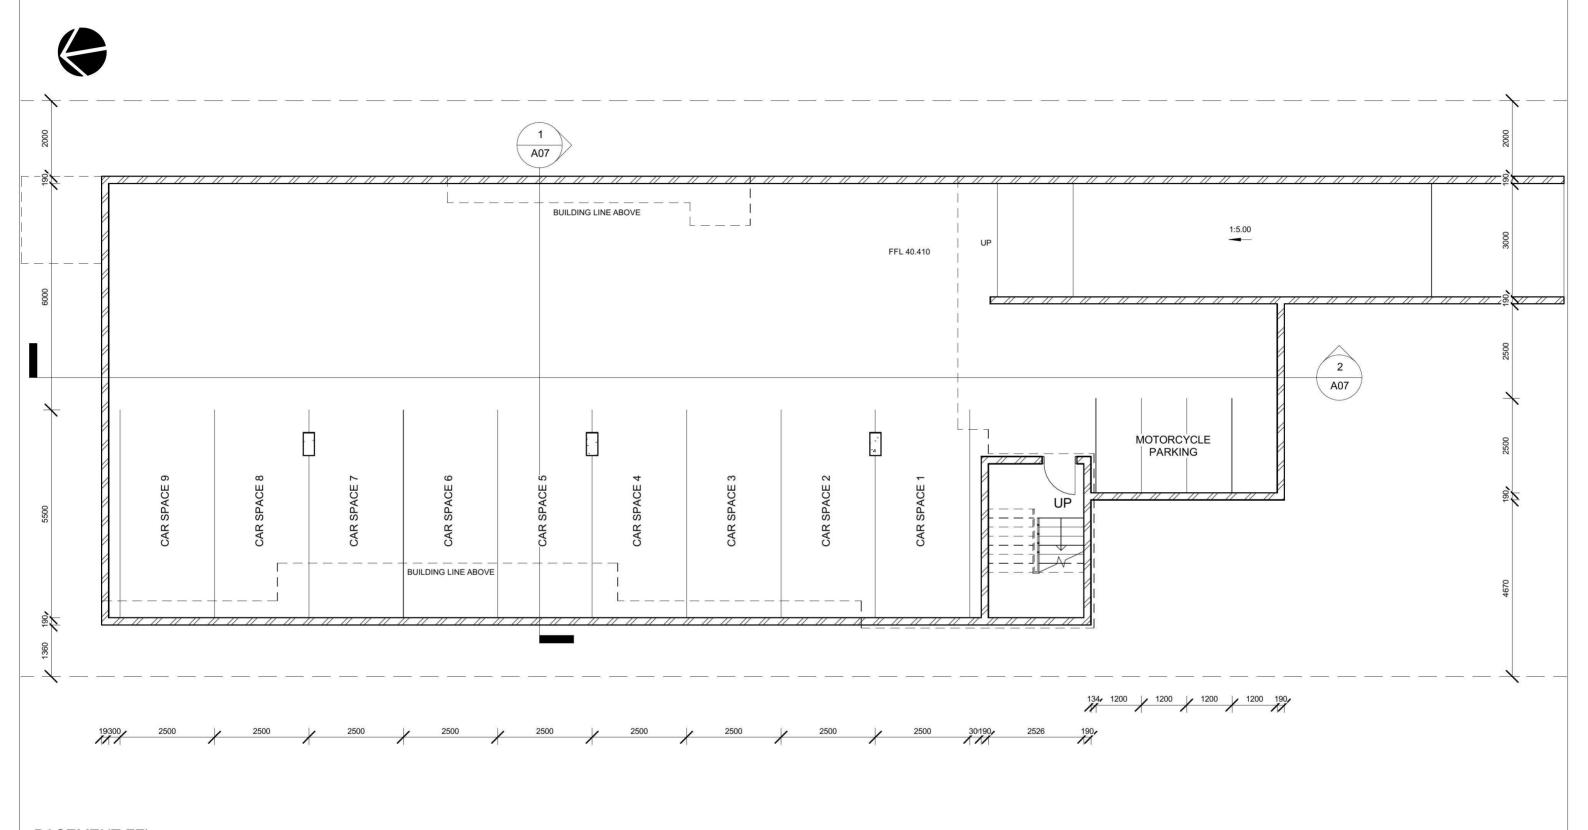

#### **BASEMENT FFL**

### 1:100

#### COPYRIGHT:

THIS DESIGN & THE ASSOCIATED DOCUMENTS ARE SUBJECT TO COPYRIGHT LAWS & MAY NOT BE REPRODUCED IN ANY FORM WITHOUT WRITTEN CONSENT FROM AUSTRALIAN SUSTAINABLE DESIGN AND CONSTRUCTION PTY LTD T/AS AUSDAC.



Version: 1, Version Date: 11/09/2018

The Essential First Step Document Set ID: 8376860

#### **GENERAL NOTES:**

1) ALL DIMENSIONS & FLOOR AREAS ARE TO BE VERIFIED BY THE BUILDER PRIOR TO THE COMMENCEMENT OF ANY BUILDING WORK. ANY DISCREPANCIES ARE TO BE BROUGHT TO THE ATTENTION OF THE DESIGNER.

2) LEVELS SHOWN ARE APPROXIMATE UNLESS ACCOMPANIED BY REDUCED LEVELS.

3) FIGURED DIMENSIONS MUST BE TAKEN IN PREFERENCE TO SCALING.


- 4) ALL BOUNDARY CLEARANCES MUST BE VERIFIED BY THE SURVEYOR PRIOR TO THE
- COMMENCEMENT OF ANY BUILDING WORKS.
  5) WHERE ENGINEERING DRAWINGS ARE REQUIRED SUCH MUST TAKE PREFERENCE TO THIS DRAWING.
- 6) STORMWATER TO BE DISCHARGED TO COUNCIL'S REQUIREMENTS AND AS 3500.3-1990.
  7) ALL SERVICES TO BE LOCATED & VERIFIED BY THE BUILDER WITH RELEVANT AUTHORITIES BEFORE ANY BUILDING WORK COMMENCES.
- 8) ALL CONSTRUCTION & MATERIALS TO BE IN ACCORDANCE WITH THE NATIONAL CONSTRUCTION CODE (NCC), LOCAL GOVERNMENT POLICIES, AUSTRALIAN STANDARDS & CURRENT MANUFACTURER'S SPECIFICATIONS & INSTALLATION DETAILS.

Client GMKA PTY LTD
Project
BOARDING HOUSE
Property Description
LOT 3 / DP 39084 - 31 SECOND


**AVE KINGSWOOD NSW 2747** 

BASEMENT PLA	N	
Project No.	Sheet No.	Sheet Size
100119	A03	A3
Date	Scale	
17/3/2017	1:100	
Drawn by	Checked by	
SM	SM	

REV	DESCRIPTION	DATE
01	CONCEPT	12/04/2017
02	DA SUBMISSION	24/10/2017
03	ADDITIONAL INFORMATION	20/06/2018

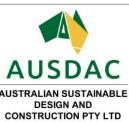

T: 1300 AUSDAC (287 322) F: 1300 856 935 P: PO BOX 414, GRANVILLE NSW 2142 W: WWW.AUSDAC.COM.AU

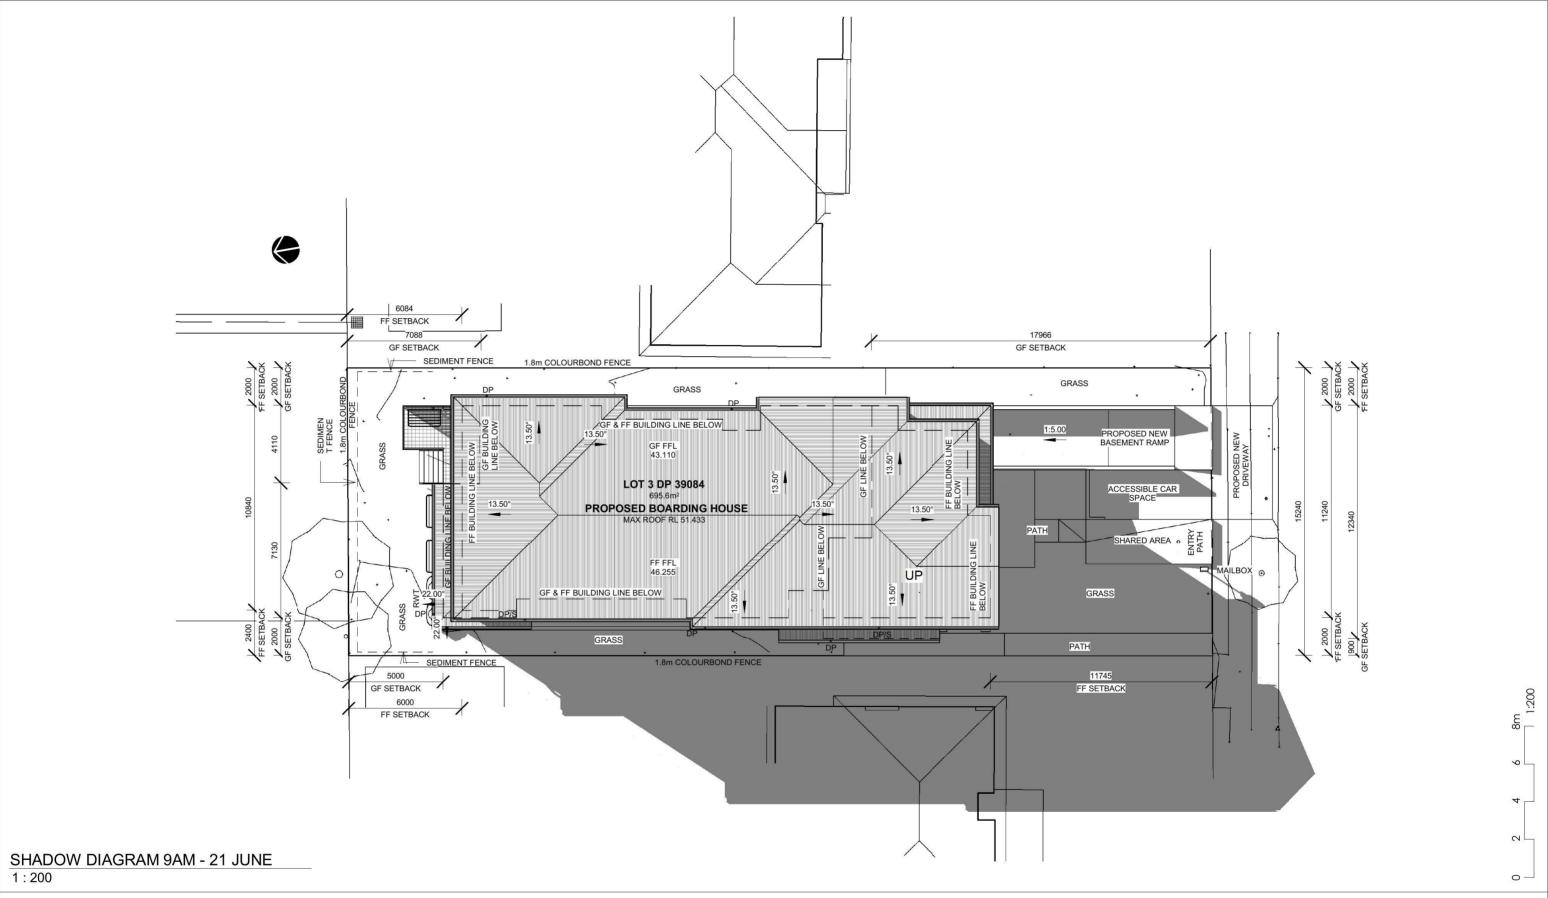

THIS DESIGN & THE ASSOCIATED DOCUMENTS ARE SUBJECT TO COPYRIGHT LAWS & MAY NOT BE REPRODUCED IN ANY FORM WITHOUT WRITTEN CONSENT FROM AUSTRALIAN SUSTAINABLE DESIGN AND CONSTRUCTION PTY LTD T/AS AUSDAC.



Document Set ID: 8376860 Version: 1, Version Date: 11/09/2018

The Essential First Step

AUTHORITIES BEFORE ANY BUILDING WORK COMMENCES. 8) ALL CONSTRUCTION & MATERIALS TO BE IN ACCORDANCE WITH THE NATIONAL CONSTRUCTION CODE (NCC), LOCAL GOVERNMENT POLICIES, AUSTRALIAN STANDARDS & CURRENT MANUFACTURER'S SPECIFICATIONS & INSTALLATION DETAILS.

#### **GENERAL NOTES:**

1) ALL DIMENSIONS & FLOOR AREAS ARE TO BE VERIFIED BY THE BUILDER PRIOR TO THE COMMENCEMENT OF ANY BUILDING WORK. ANY DISCREPANCIES ARE TO BE BROUGHT TO THE ATTENTION OF THE DESIGNER.
2) LEVELS SHOWN ARE APPROXIMATE UNLESS ACCOMPANIED BY REDUCED LEVELS.

3) FIGURED DIMENSIONS MUST BE TAKEN IN PREFERENCE TO SCALING. 4) ALL BOUNDARY CLEARANCES MUST BE VERIFIED BY THE SURVEYOR PRIOR TO THE

COMMENCEMENT OF ANY BUILDING WORKS.
5) WHERE ENGINEERING DRAWINGS ARE REQUIRED SUCH MUST TAKE PREFERENCE TO THIS DRAWING.

6) STORMWATER TO BE DISCHARGED TO COUNCIL'S REQUIREMENTS AND AS 3500.3-1990. 7) ALL SERVICES TO BE LOCATED & VERIFIED BY THE BUILDER WITH RELEVANT

## **GMKA PTY LTD**

**BOARDING HOUSE** 

**Property Description** 


LOT 3 / DP 39084 - 31 SECOND **AVE KINGSWOOD NSW 2747** 

Sheet Title SHADOW DIA JUNE	AGRAM 9AN	M - 21
Project No.	Sheet No.	Sheet Size
100119	A08	A3
Date	Scale	*
17/3/2017	1:200	)


Drawn by

SM

		REV	DESCRIPTION	DATE
RAM 9AM	1 - 21	01	CONCEPT	12/04/2017
		02	DA SUBMISSION	24/10/2017
Sheet No.	Sheet Size	03	ADDITIONAL INFORMATION	20/06/2018
A08	A3			
Scale				
1:200				
Checked by				
SM				

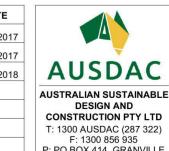

**DESIGN AND** CONSTRUCTION PTY LTD T: 1300 AUSDAC (287 322) F: 1300 856 935 P: PO BOX 414, GRANVILLE NSW 2142 W: WWW.AUSDAC.COM.AU

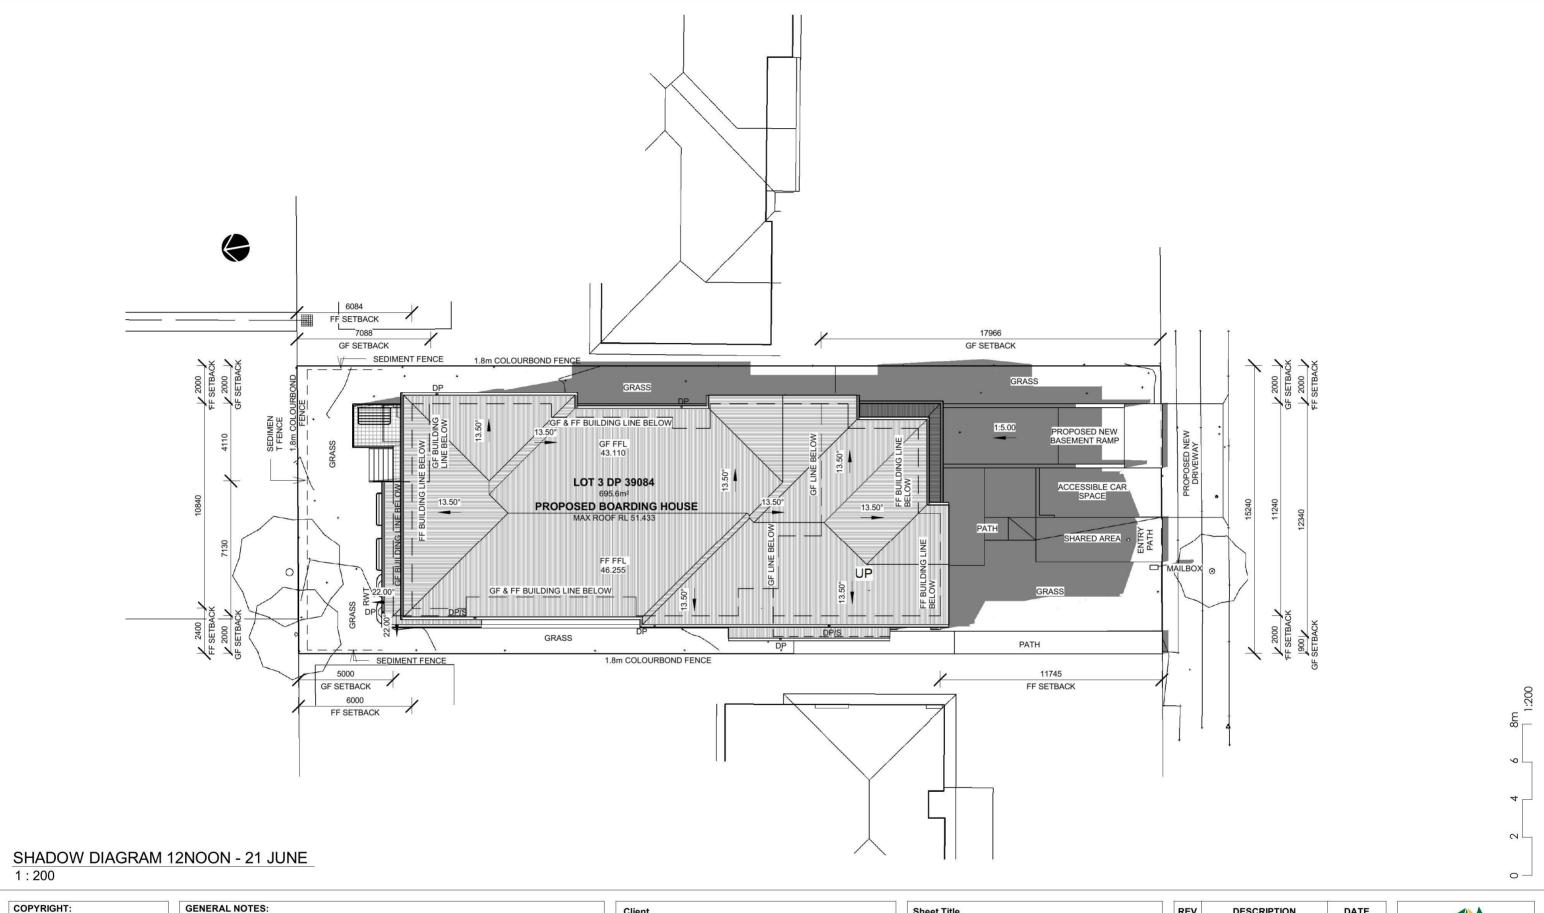

THIS DESIGN & THE ASSOCIATED DOCUMENTS ARE SUBJECT TO COPYRIGHT LAWS & MAY NOT BE REPRODUCED IN ANY FORM WITHOUT WRITTEN CONSENT FROM AUSTRALIAN SUSTAINABLE DESIGN AND CONSTRUCTION PTY LTD T/AS AUSDAC.



The Essential First Step

6) STORMWATER TO BE DISCHARGED TO COUNCIL'S REQUIREMENTS AND AS 3500.3-1990. 7) ALL SERVICES TO BE LOCATED & VERIFIED BY THE BUILDER WITH RELEVANT AUTHORITIES BEFORE ANY BUILDING WORK COMMENCES.

8) ALL CONSTRUCTION & MATERIALS TO BE IN ACCORDANCE WITH THE NATIONAL CONSTRUCTION CODE (NCC), LOCAL GOVERNMENT POLICIES, AUSTRALIAN STANDARDS 8 CURRENT MANUFACTURER'S SPECIFICATIONS & INSTALLATION DETAILS.

1) ALL DIMENSIONS & FLOOR AREAS ARE TO BE VERIFIED BY THE BUILDER PRIOR TO THE

COMMENCEMENT OF ANY BUILDING WORK. ANY DISCREPANCIES ARE TO BE BROUGHT TO THE ATTENTION OF THE DESIGNER.

2) LEVELS SHOWN ARE APPROXIMATE UNLESS ACCOMPANIED BY REDUCED LEVELS.

4) ALL BOUNDARY CLEARANCES MUST BE VERIFIED BY THE SURVEYOR PRIOR TO THE

5) WHERE ENGINEERING DRAWINGS ARE REQUIRED SUCH MUST TAKE PREFERENCE TO THIS DRAWING.

3) FIGURED DIMENSIONS MUST BE TAKEN IN PREFERENCE TO SCALING.

COMMENCEMENT OF ANY BUILDING WORKS.

### **GMKA PTY LTD**

**BOARDING HOUSE** 

**Property Description** LOT 3 / DP 39084 - 31 SECOND


**AVE KINGSWOOD NSW 2747** 

#### SHADOW DIAGRAM 12NOON -21 JUNE Project No. **Sheet Size** 100119 A09 A3 Scale 17/3/2017 1:200 Drawn by Checked by SM SM

REV	DESCRIPTION	DATE
01	CONCEPT	12/04/2017
02	DA SUBMISSION	24/10/2017
03	ADDITIONAL INFORMATION	20/06/2018



F: 1300 856 935 P: PO BOX 414, GRANVILLE NSW 2142 W: WWW.AUSDAC.COM.AU

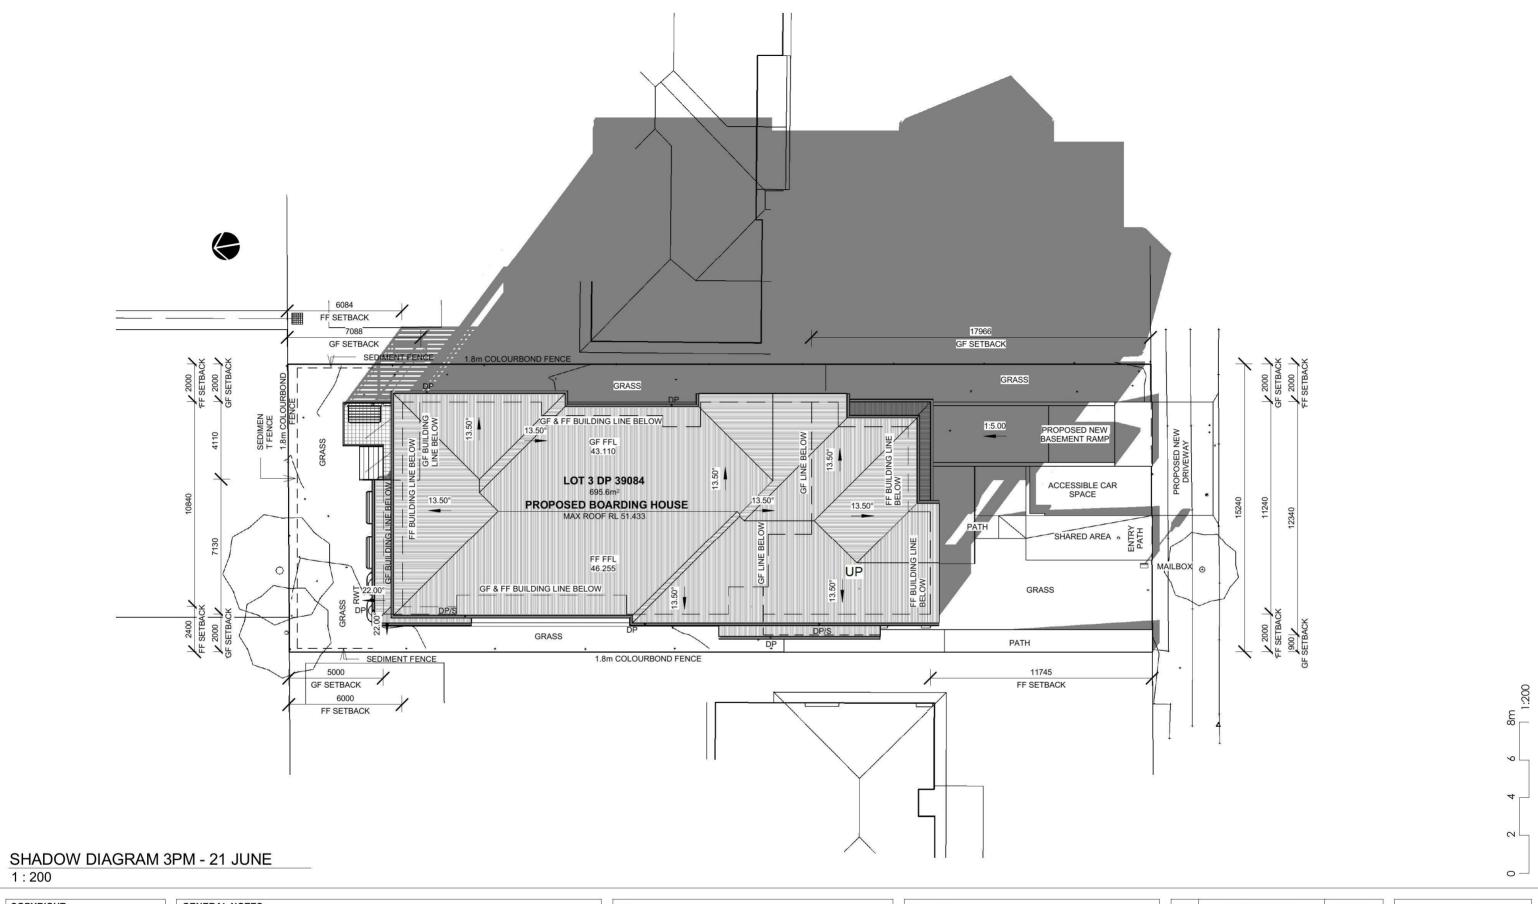

THIS DESIGN & THE ASSOCIATED DOCUMENTS ARE SUBJECT TO COPYRIGHT LAWS & MAY NOT BE REPRODUCED IN ANY FORM WITHOUT WRITTEN CONSENT FROM AUSTRALIAN SUSTAINABLE DESIGN AND CONSTRUCTION PTY LTD T/AS AUSDAC.



The Essential First Step

Document Set ID: 8376860

#### **GENERAL NOTES:**

1) ALL DIMENSIONS & FLOOR AREAS ARE TO BE VERIFIED BY THE BUILDER PRIOR TO THE COMMENCEMENT OF ANY BUILDING WORK. ANY DISCREPANCIES ARE TO BE BROUGHT TO THE ATTENTION OF THE DESIGNER.
2) LEVELS SHOWN ARE APPROXIMATE UNLESS ACCOMPANIED BY REDUCED LEVELS.

- 3) FIGURED DIMENSIONS MUST BE TAKEN IN PREFERENCE TO SCALING.
- 4) ALL BOUNDARY CLEARANCES MUST BE VERIFIED BY THE SURVEYOR PRIOR TO THE
- COMMENCEMENT OF ANY BUILDING WORKS.
  5) WHERE ENGINEERING DRAWINGS ARE REQUIRED SUCH MUST TAKE PREFERENCE TO THIS DRAWING.
- 6) STORMWATER TO BE DISCHARGED TO COUNCIL'S REQUIREMENTS AND AS 3500.3-1990.
- 7) ALL SERVICES TO BE LOCATED & VERIFIED BY THE BUILDER WITH RELEVANT AUTHORITIES BEFORE ANY BUILDING WORK COMMENCES.
- 8) ALL CONSTRUCTION & MATERIALS TO BE IN ACCORDANCE WITH THE NATIONAL CONSTRUCTION CODE (NCC), LOCAL GOVERNMENT POLICIES, AUSTRALIAN STANDARDS & CURRENT MANUFACTURER'S SPECIFICATIONS & INSTALLATION DETAILS.

### **GMKA PTY LTD**

**BOARDING HOUSE** 

**Property Description** 

LOT 3 / DP 39084 - 31 SECOND **AVE KINGSWOOD NSW 2747** 

SHADOW DIAG JUNE	RAM 3PM	1 - 21
Project No.	Sheet No.	Sheet Size
100119	A10	A3
Date	Scale	
17/3/2017	1:200	
Drawn by	Checked by	
SM	SM	

REV	DESCRIPTION	DATE
01	CONCEPT	12/04/2017
02	DA SUBMISSION	24/10/2017
03	ADDITIONAL INFORMATION	20/06/2018



T: 1300 AUSDAC (287 322) F: 1300 856 935 P: PO BOX 414, GRANVILLE NSW 2142 W: WWW.AUSDAC.COM.AU





COMMON BRICK - RENDERED COLORBOND DUNE



COMMON BRICK - RENDERED **COLORBOND JASPER** 



ALUMINIUM WINDOW FRAMES - COLORBOND SURFMIST



TILED FLOOR - FINISH TO COMPLY WITH CLAUSE 12 OF AS1428.1









ALUMINIUM SUN SHADES -**COLORBOND DUNE** 



**GUTTERS, FASCIA & DOWNPIPES** - COLORBOND DUNE



METAL ROOF SHEETING -**COLORBOND DUNE** 



ALUMINIUM ENTRY DOOR -**COLORBOND SURFMIST** 



### **GENERAL NOTES:**

1) ALL DIMENSIONS & FLOOR AREAS ARE TO BE VERIFIED BY THE BUILDER PRIOR TO THE COMMENCEMENT OF ANY BUILDING WORK. ANY DISCREPANCIES ARE TO BE BROUGHT TO THE ATTENTION OF THE DESIGNER.

2) LEVELS SHOWN ARE APPROXIMATE UNLESS ACCOMPANIED BY REDUCED LEVELS.

3) FIGURED DIMENSIONS MUST BE TAKEN IN PREFERENCE TO SCALING. 4) ALL BOUNDARY CLEARANCES MUST BE VERIFIED BY THE SURVEYOR PRIOR TO THE

COMMENCEMENT OF ANY BUILDING WORKS.
5) WHERE ENGINEERING DRAWINGS ARE REQUIRED SUCH MUST TAKE PREFERENCE TO THIS DRAWING.

6) STORMWATER TO BE DISCHARGED TO COUNCIL'S REQUIREMENTS AND AS 3500.3-1990.

7) ALL SERVICES TO BE LOCATED & VERIFIED BY THE BUILDER WITH RELEVANT

AUTHORITIES BEFORE ANY BUILDING WORK COMMENCES.
8) ALL CONSTRUCTION & MATERIALS TO BE IN ACCORDANCE WITH THE NATIONAL CONSTRUCTION CODE (NCC), LOCAL GOVERNMENT POLICIES, AUSTRALIAN STANDARDS & CURRENT MANUFACTURER'S SPECIFICATIONS & INSTALLATION DETAILS.

Client
GMKA PTY LTD
Project
BOARDING HOUSE
Property Description
LOT 3 / DP 39084 - 31 SECOND

**AVE KINGSWOOD NSW 2747** 

Sheet Title			
COLOUR SCHE	DULE		
Project No.	Sheet No.	Sheet Size	
100119	A11	A3	
Date	Scale		
17/3/2017	1:1		
Drawn by	Checked by		
SM	SM		

DESCRIPTION	DATE	
CONCEPT	12/04/2017	
DA SUBMISSION	24/10/2017	7
ADDITIONAL INFORMATION	20/06/2018	AUSDAC
		AUSTRALIAN SUSTAINAB DESIGN AND CONSTRUCTION PTY LT
	-	T: 1300 AUSDAC (287 322 F: 1300 856 935
		P: PO BOX 414, GRANVILL NSW 2142 W: WWW.AUSDAC.COM.A
	CONCEPT  DA SUBMISSION	CONCEPT 12/04/2017  DA SUBMISSION 24/10/2017



The Essential First Step Document Set ID: 8376860 Version: 1, Version Date: 11/09/2018

COPYRIGHT:

THIS DESIGN & THE

ASSOCIATED DOCUMENTS ARE SUBJECT TO COPYRIGHT LAWS & MAY NOT BE REPRODUCED IN

ANY FORM WITHOUT WRITTEN

DIAL BEFORE

**YOU DIG** 

www.1100.com.au

CONSENT FROM AUSTRALIAN SUSTAINABLE DESIGN AND CONSTRUCTION PTY LTD T/AS AUSDAC.

		Door Schedule			
Level	Mark	Comments	Height	Width	Head Height
GROUND FFL	1	920 TIMBER ENTRY DOOR	2040	820	2040
GROUND FFL	2	920 FIRE DOOR	2040	920	2040
GROUND FFL	3	820 SOLID TIMBER DOOR	2040	820	2040
GROUND FFL	4	820 SOLID TIMBER DOOR	2040	920	2040
GROUND FFL	5	920 INTERNAL DOOR	2040	920	2040
GROUND FFL	6	820 SOLID TIMBER DOOR	2040	820	2040
GROUND FFL	7	720 INTERNAL DOOR	2040	720	2040
GROUND FFL	8	820 SOLID TIMBER DOOR	2040	820	2040
GROUND FFL	9	720 INTERNAL DOOR	2040	720	2040
GROUND FFL	10	920 TIMBER ENTRY DOOR	2040	920	2040
GROUND FFL	11	920 SOLID TIMBER DOOR	2040	920	2040
GROUND FFL	12	920 SOLID TIMBER DOOR	2040	920	2040
GROUND FFL	13	720 INTERNAL DOOR	2040	720	2040
GROUND FFL	14	820 SOLID TIMBER DOOR	2040	820	2040
GROUND FFL	15	720 INTERNAL DOOR	2040	720	2040

		Door Schedule			
Level	Mark	Comments	Height	Width	Head Height
GROUND FFL	16	820 SOLID TIMBER DOOR	2040	820	2040
GROUND FFL	17	920 SOLID TIMBER DOOR	2040	920	2040
GROUND FFL	18	920 INTERNAL DOOR	2040	920	2040
FIRST FFL	19	820 SOLID TIMBER DOOR	2040	820	2040
FIRST FFL	20	720 INTERNAL DOOR	2040	720	2040
FIRST FFL	21	820 SOLID TIMBER DOOR	2040	820	2040
FIRST FFL	22	720 INTERNAL DOOR	2040	720	2040
FIRST FFL	23	820 SOLID TIMBER DOOR	2040	820	2040
FIRST FFL	24	720 INTERNAL DOOR	2040	720	2040
FIRST FFL	25	820 SOLID TIMBER DOOR	2040	820	2040
FIRST FFL	26	720 INTERNAL DOOR	2040	720	2040
FIRST FFL	27	820 SOLID TIMBER DOOR	2040	820	2040
FIRST FFL	28	720 INTERNAL DOOR	2040	720	2040
FIRST FFL	29	820 SOLID TIMBER DOOR	2040	820	2040
FIRST FFL	30	720 INTERNAL DOOR	2040	720	2040

		Door Schedule			
Level	Mark	Comments	Height	Width	Head Height
FIRST FFL	31	820 SOLID TIMBER DOOR	2040	820	2040
FIRST FFL	32	720 INTERNAL DOOR	2040	720	2040
FIRST FFL	33	820 SOLID TIMBER DOOR	2040	820	2040
FIRST FFL	34	820 SOLID TIMBER DOOR	2040	820	2040
FIRST FFL	35	720 INTERNAL DOOR	2040	720	2040
FIRST FFL	36	820 SOLID TIMBER DOOR	2040	820	2040
FIRST FFL	37	720 INTERNAL DOOR	2040	720	2040
FIRST FFL	38	720 INTERNAL DOOR	2040	720	2040
FIRST FFL	39	820 SOLID TIMBER DOOR	2040	820	2040
FIRST FFL	40	820 SOLID TIMBER DOOR	2040	820	2040
FIRST FFL	41	720 INTERNAL DOOR	2040	720	2040
FIRST FFL	42	820 SOLID TIMBER DOOR	2040	820	2040
FIRST FFL	43	720 INTERNAL DOOR	2040	720	2040
BASEMENT FFL	44	920 FIRE DOOR	2040	920	2040
GROUND FFL	47	920 SOLID TIMBER DOOR	2040	920	2040

		Window Schedule				
					Sill	Head
Level	Mark	Description	Height	Width	Height	Height
GROUND FFL	1	ALUMINIUM SLIDING WINDOW	600	1210	1600	2200
GROUND FFL	2	ALUMINIUM SLIDING WINDOW	600	1210	1600	2200
GROUND FFL	3	ALUMINIUM SLIDING WINDOW	600	1210	1600	2200
GROUND FFL	4	ALUMINIUM SLIDING WINDOW	600	610	1600	2200
<b>GROUND FFL</b>	5	ALUMINIUM SLIDING WINDOW	600	1210	1600	2200
<b>GROUND FFL</b>	6	ALUMINIUM SLIDING WINDOW	600	610	1600	2200
GROUND FFL	7	ALUMINIUM SLIDING WINDOW	600	1210	1600	2200
<b>GROUND FFL</b>	8	ALUMINIUM SLIDING WINDOW	600	1210	1600	2200
<b>GROUND FFL</b>	9	ALUMINIUM SLIDING WINDOW	600	1210	1600	2200
GROUND FFL	10	FIRE RATED ALUMINIUM SLIDING WINDOW	600	610	1600	2200
GROUND FFL	11	FIRE RATED ALUMINIUM SLIDING WINDOW	600	610	1600	2200
GROUND FFL	12	ALUMINIUM SLIDING WINDOW	600	1210	1600	2200
GROUND FFL	13	FIRE RATED ALUMINIUM SLIDING WINDOW	600	1210	1600	2200
GROUND FFL	14	ALUMINIUM SLIDING WINDOW	600	610	1600	2200

		Window Schedule				
					Sill	Head
Level	Mark	Description	Height	Width	Height	Height
GROUND FFL	15	FR GLASS BLOCKS	1300	700	900	2200
GROUND FFL	16	ALUMINIUM SLIDING WINDOW	1200	1210	1000	2200
GROUND FFL	17	ALUMINIUM SLIDING WINDOW	1200	1210	1000	2200
FIRST FFL	18	ALUMINIUM SLIDING WINDOW (1F,2S)	1200	1810	1000	2200
FIRST FFL	19	FIRE RATED ALUMINIUM SLIDING WINDOW	600	610	1600	2200
FIRST FFL	20	FIRE RATED ALUMINIUM SLIDING WINDOW	600	1210	1600	2200
FIRST FFL	21	ALUMINIUM SLIDING WINDOW	600	610	1600	2200
FIRST FFL	22	FIRE RATED ALUMINIUM SLIDING WINDOW	600	1210	1600	2200
FIRST FFL	23	FIRE RATED ALUMINIUM SLIDING WINDOW	600	610	1600	2200
FIRST FFL	24	ALUMINIUM SLIDING WINDOW	600	610	1600	2200
FIRST FFL	25	ALUMINIUM SLIDING WINDOW (1F,2S)	600	1810	1600	2200
FIRST FFL	26	ALUMINIUM SLIDING WINDOW	600	610	1600	2200
FIRST FFL	27	ALUMINIUM SLIDING WINDOW (1F,2S)	600	1810	1600	2200
FIRST FFL	28	ALUMINIUM SLIDING WINDOW	600	1210	1600	2200

		Window Schedule				
					Sill	Head
Level	Mark	Description	Height	Width	Height	Height
FIRST FFL	29	ALUMINIUM SLIDING WINDOW	600	610	1600	2200
FIRST FFL	30	ALUMINIUM SLIDING WINDOW	600	610	1600	2200
FIRST FFL	31	ALUMINIUM SLIDING WINDOW	600	1210	1600	2200
FIRST FFL	32	FIRE RATED ALUMINIUM SLIDING WINDOW	600	610	1600	2200
FIRST FFL	33	FIRE RATED ALUMINIUM SLIDING WINDOW	600	1210	1600	2200
FIRST FFL	34	FIRE RATED ALUMINIUM SLIDING WINDOW	600	1210	1600	2200
FIRST FFL	35	FIRE RATED ALUMINIUM SLIDING WINDOW	600	610	1600	2200
FIRST FFL	36	ALUMINIUM SLIDING WINDOW	600	1210	1600	2200
FIRST FFL	37	FIRE RATED ALUMINIUM SLIDING WINDOW	600	610	1600	2200
FIRST FFL	38	FIRE RATED ALUMINIUM SLIDING WINDOW	600	610	1600	2200
FIRST FFL	39	FIRE RATED ALUMINIUM SLIDING WINDOW	600	1210	1600	2200
FIRST FFL	40	ALUMINIUM SLIDING WINDOW	600	1210	1600	2200
FIRST FFL	41	ALUMINIUM SLIDING WINDOW (1F,2S)	1200	1810	1000	2200
FIRST FFL	42	ALUMINIUM SLIDING WINDOW	600	610	1600	2200





THIS DESIGN & THE ASSOCIATED DOCUMENTS ARE SUBJECT TO COPYRIGHT LAWS & MAY NOT BE REPRODUCED IN ANY FORM WITHOUT WRITTEN CONSENT FROM AUSTRALIAN



SUSTAINABLE DESIGN AND CONSTRUCTION PTY LTD T/AS AUSDAC.

The Essential First Step

6) STORMWATER TO BE DISCHARGED TO COUNCIL'S REQUIREMENTS AND AS 3500.3-1990. 7) ALL SERVICES TO BE LOCATED & VERIFIED BY THE BUILDER WITH RELEVANT

3) FIGURED DIMENSIONS MUST BE TAKEN IN PREFERENCE TO SCALING.

AUTHORITIES BEFORE ANY BUILDING WORK COMMENCES.
8) ALL CONSTRUCTION & MATERIALS TO BE IN ACCORDANCE WITH THE NATIONAL CONSTRUCTION CODE (NCC), LOCAL GOVERNMENT POLICIES, AUSTRALIAN STANDARDS & CURRENT MANUFACTURER'S SPECIFICATIONS & INSTALLATION DETAILS.

1) ALL DIMENSIONS & FLOOR AREAS ARE TO BE VERIFIED BY THE BUILDER PRIOR TO THE

COMMENCEMENT OF ANY BUILDING WORK. ANY DISCREPANCIES ARE TO BE BROUGHT TO THE ATTENTION OF THE DESIGNER.
2) LEVELS SHOWN ARE APPROXIMATE UNLESS ACCOMPANIED BY REDUCED LEVELS.

4) ALL BOUNDARY CLEARANCES MUST BE VERIFIED BY THE SURVEYOR PRIOR TO THE

COMMENCEMENT OF ANY BUILDING WORKS.
5) WHERE ENGINEERING DRAWINGS ARE REQUIRED SUCH MUST TAKE PREFERENCE TO THIS DRAWING.

# **GMKA PTY LTD BOARDING HOUSE Property Description**

LOT	3/	DP	39084	- 31	SEC	DNC
AVE	KIN	NGS	OOW	D NS	W 27	47

Sheet Title		
DOOR / WINDOW & PERSPECTIVE		DULES
Project No.	Sheet No.	Sheet Size
100119	A12	A3
Date	Scale	
17/3/2017		
Drawn by	Checked by	
SM	SM	

REV	DESCRIPTION	DATE
01	CONCEPT	12/04/2017
02	DA SUBMISSION	24/10/2017
03	ADDITIONAL INFORMATION	20/06/2018



T: 1300 AUSDAC (287 322) F: 1300 856 935 P: PO BOX 414, GRANVILLE NSW 2142 W: WWW.AUSDAC.COM.AU

#### 1. FALLS, SLIPS, TRIPS

#### a) WORKING AT HEIGHTS DURING CONSTRUCTION

Wherever possible, components for this building should be prefabricated off-site or at ground level to minimise the risk of workers falling more than two metres. However, construction of this building will require workers to be working at heights where a fall in excess of two metres is possible and injury is likely to result from such a fall. The builder should provide a suitable barrier wherever a person is required to work in a situation where falling more than two metres is a possibility.

#### DURING OPERATION OR MAINTENANCE

For houses or other low-rise buildings where scaffolding is appropriate:

Cleaning and maintenance of windows, walls. roof or other components of this building will require persons to be situated where a fall from a height in excess of two metres is possible. Where this type of activity is required, scaffolding, ladders or trestles should be used in accordance with relevant codes of practice. regulations or legislation.

For buildings where scaffold, ladders, trestles are not appropriate: Cleaning and maintenance of windows, walls, roof or other components of this building will require persons to be situated where a fall from a height in excess of two metres is possible. Where this type of activity is required, scaffolding, fall barriers or Personal Protective Equipment (PPE) should be used in accordance with relevant codes of practice, regulations or legislation.

#### b) SLIPPERY OR UNEVEN SURFACES FLOOR FINISHES Specified

If finishes have been specified by designer, these have been selected to minimise the risk of floors and paved areas becoming slippery when wet or when walked on with wet shoes/feet. Any changes to the specified finish should be made in consultation with the designer or, if this is not practical, surfaces with an equivalent or better slip resistance should be chosen.

#### FLOOR FINISHES By Owner

If designer has not not been involved in the selection of surface finishes, the owner is responsible for the selection of surface finishes in the pedestrian trafficable areas of this building. Surfaces should be selected in accordance with AS HB 197:1999 and AS/NZ 4586:2004

#### STEPS, LOOSE OBJECTS AND UNEVEN SURFACES

Due to design restrictions for this building, steps and/or ramps are included in the building which may be a hazard to workers carrying objects or otherwise occupied. Steps should be clearly marked with both visual and tactile warning during construction, maintenance. demolition and at all times when the building operates as a

Building owners and occupiers should monitor the pedestrian access ways and in particular access to areas where maintenance is routinely carried out to ensure that surfaces have not moved or cracked so that they become uneven and present a trip hazard. Spills, loose material, stray objects or any other matter that may cause a slip or trip hazard should be cleaned or removed from access ways.

Contractors should be required to maintain a tidy work site during construction, maintenance or demolition to reduce the risk of trips and falls in the workplace. Materials for construction or maintenance should be stored in designated areas away from access ways and work areas.

#### 2. FALLING OBJECTS

#### LOOSE MATERIALS OR SMALL OBJECTS

Construction, maintenance or demolition work on or around this building is likely to involve persons working above ground level or above floor levels. Where this occurs one or more of the following measures should be taken to avoid objects falling from the area

where the work is being carried out onto persons below.

- 1. Prevent or restrict access to areas below where the work is being carried out.
- Provide toeboards to scaffolding or work platforms.
- Provide protective structure below the work area.
- 4. Ensure that all persons below the work area have Personal Protective Equipment (PPE).

#### **BUILDING COMPONENTS**

During construction, renovation or demolition of this building, parts of the structure including fabricated steelwork, heavy panels and many other components will remain standing prior to or after supporting parts are in place. Contractors should ensure that temporary bracing or other required support is in place at all times when collapse which may injure persons in the area is a possibility.

Mechanical lifting of materials and components during construction, maintenance or demolition presents a risk of falling objects. Contractors should ensure that appropriate lifting devices are used. that loads are properly secured and that access to areas below the load is prevented or restricted.

#### 3. TRAFFIC MANAGEMENT

For building on a major road, narrow road or steeply sloping road: Parking of vehicles or loading/unloading of vehicles on this roadway may cause a traffic hazard. During construction, maintenance or demolition of this building designated parking for workers and loading areas should be provided. Trained traffic management personnel should be responsible for the supervision of these areas. For building where on-site loading/unloading is restricted: Construction of this building will require loading and unloading of materials on the roadway. Deliveries should be well planned to avoid congestion of loading areas and trained traffic management personnel should be used to supervise loading/unloading areas. For all buildings:

Busy construction and demolition sites present a risk of collision where deliveries and other traffic are moving within the site. A traffic management plan supervised by trained traffic management personnel should be adopted for the work site.

#### 4. SERVICES - GENERAL

Rupture of services during excavation or other activity creates a variety of risks including release of hazardous material. Existing services are located on or around this site. Where known, these are identified on the plans but the exact location and extent of services may vary from that indicated. Services should be located using an appropriate service (such as Dial Before You Dia). appropriate excavation practice should be used and, where necessary, specialist contractors should be used. Locations with underground power:

Underground power lines MAY be located in or around this site. All underground power lines must be disconnected or carefully located and adequate warning signs used prior to any construction, maintenance or demolition commencing. Locations with overhead power lines:

Overhead power lines MAY be near or on this site. These pose a risk of electrocution if struck or approached by lifting devices or other plant and persons working above ground level. Where there is a danger of this occurring, power lines should be, where practical, disconnected or relocated. Where this is not practical adequate warning in the form of bright coloured tape or signage should be used or a protective barrier provided.

#### 5. MANUAL TASKS

Components within this design with a mass in excess of 25kg should be lifted by two or more workers or by mechanical lifting device. Where this is not practical, suppliers or fabricators should be required to limit the component mass.

All material packaging, building and maintenance components

should clearly show the total mass of packages and where practical all items should be stored on site in a way which minimises bending before lifting. Advice should be provided on safe lifting methods in all areas where lifting may occur. Construction, maintenance and demolition of this building will require the use of portable tools and equipment. These should be fully maintained in accordance with manufacturer's specifications and not used where faulty or (in the case of electrical equipment) not carrying a current electrical safety tag. All safety guards or devices should be regularly checked and Personal Protective Equipment should be used in accordance with manufacturer's specification.

#### 6. HAZARDOUS SUBSTANCES **ASBESTOS**

For alterations to a building constructed prior to 1990: If this existing building was constructed prior to:

1990 - it therefore may corasbestos

1986 - it therefore is likely to crashestos

either in cladding material or in fire retardant insulation material. In either case, the builder should check and, if necessary, take appropriate action before demolishing, cutting, sanding, drilling or otherwise disturbing the existing structure.

#### POWDERED MATERIALS

Many materials used in the construction of this building can cause harm if inhaled in powdered form. Persons working on or in the building during construction, operational maintenance or demolition should ensure good ventilation and wear Personal Protective Equipment including protection against inhalation while using powdered material or when sanding, drilling, cutting or otherwise disturbing or creating powdered material.

#### TREATED TIMBER

The design of this building may include provision for the inclusion of treated timber within the structure. Dust or fumes from this material can be harmful. Persons working on or in the building during construction, operational maintenance or demolition should ensure good ventilation and wear Personal Protective Equipment including protection against inhalation of harmful material when sanding, drilling, cutting or using treated timber in any way that may cause harmful material to be released. Do not burn treated timber.

#### **VOLATILE ORGANIC COMPOUNDS**

Many types of glue, solvents, spray packs, paints, varnishes and some cleaning materials and disinfectants have dangerous emissions. Areas where these are used should be kept well ventilated while the material is being used and for a period after installation. Personal Protective Equipment may also be required. The manufacturer's recommendations for use must be carefully considered at all times

#### SYNTHETIC MINERAL FIBRE

Fibreglass, rockwool, ceramic and other material used for thermal or sound insulation may contain synthetic mineral fibre which may be harmful if inhaled or if it comes in contact with the skin, eyes or other sensitive parts or the body. Personal Protective Equipment including protection against inhalation of harmful material should be used when installing, removing or working near bulk insulation material.

#### TIMBER FLOORS

This building may contain timber floors which have an applied finish. Areas where finishes are applied should be kept well ventilated during sanding and application and for a period after installation. Personal Protective Equipment may also be required. The manufacturer's recommendations for use must be carefully considered at all times.

#### 7. CONFINED SPACES

Construction of this building and some maintenance on the building will require excavation and installation of items within excavations. Where practical, installation should be carried out using methods which do not require workers to enter the excavation. Where this is not practical, adequate support for the excavated area should be provided to prevent collapse. Warning signs and barriers to prevent accidental or unauthorised access to all excavations should be provided.

#### **ENCLOSED SPACES**

For buildings with enclosed spaces where maintenance or other access may be required:

Enclosed spaces within this building may present a risk to persons entering for construction, maintenance or any other purpose. The design documentation calls for warning signs and barriers to unauthorised access. These should be maintained throughout the life of the building. Where workers are required to enter enclosed spaces, air testing equipment and Personal Protective Equipment should be provided.

#### SMALL SPACES

For buildings with small spaces where maintenance or other access may be required:

Some small spaces within this building will require access by construction or maintenance workers. The design documentation calls for warning signs and barriers to unauthorised access. These should be maintained throughout the life of the building. Where workers are required to enter small spaces they should be scheduled so that access is for short periods. Manual lifting and other manual activity should be restricted in small spaces.

#### 8. PUBLIC ACCESS

Public access to construction and demolition sites and to areas under maintenance causes risk to workers and public. Warning signs and secure barriers to unauthorised access should be provided. Where electrical installations, excavations, plant or loose materials are present they should be secured when not fully supervised.

#### 9. OPERATIONAL USE OF BUILDING RESIDENTIAL BUILDINGS

This building has been designed as a residential building. If it, at a later date, it is used or intended to be used as a workplace, the provisions of the Work Health and Safety Act 2011 or subsequent replacement Act should be applied to the new use.

#### 10.OTHER HIGH RISK ACTIVITY

All electrical work should be carried out in accordance with Code of Practice: Managing Electrical Risks at the Workplace, AS/NZ 3012and all licensing requirements.

All work using Plant should be carried out in accordance with Code of Practice: Managing Risks of Plant at the Workplace. All work should be carried out in accordancCode of Practice: Managing Noise and Preventing Hearing Loss at Work. Due to the history of serious incidents it is recommended that particular care be exercised when undertaking work involving steel construction and concrete placement. All the above applies.

THESE NOTES MUST BE READ AND **UNDERSTOOD BY ALL INVOLVED IN** THE PROJECT. THIS INCLUDES (but is not excluded to): OWNER. **BUILDER, SUB-CONTRACTORS,** CONSULTANTS, RENOVATORS, **OPERATORS, MAINTENORS,** DEMOLISHERS.

### COPYRIGHT:

THIS DESIGN & THE ASSOCIATED DOCUMENTS ARE SUBJECT TO COPYRIGHT LAWS & MAY NOT BE REPRODUCED IN ANY FORM WITHOUT WRITTEN CONSENT FROM AUSTRALIAN SUSTAINABLE DESIGN AND CONSTRUCTION PTY LTD T/AS AUSDAC.



Document Set ID: 8376860 Version: 1, Version Date: 11/09/2018

#### **GENERAL NOTES**


- 1) ALL DIMENSIONS & FLOOR AREAS ARE TO BE VERIFIED BY THE BUILDER PRIOR TO THE COMMENCEMENT OF ANY BUILDING WORK. ANY DISCREPANCIES ARE TO BE BROUGHT TO THE ATTENTION OF THE DESIGNER
- 2) LEVELS SHOWN ARE APPROXIMATE UNLESS ACCOMPANIED BY REDUCED LEVELS.
- 3) FIGURED DIMENSIONS MUST BE TAKEN IN PREFERENCE TO SCALING. 4) ALL BOUNDARY CLEARANCES MUST BE VERIFIED BY THE SURVEYOR PRIOR TO THE
- COMMENCEMENT OF ANY BUILDING WORKS.

  5) WHERE ENGINEERING DRAWINGS ARE REQUIRED SUCH MUST TAKE PREFERENCE TO
- THIS DRAWING 6) STORMWATER TO BE DISCHARGED TO COUNCIL'S REQUIREMENTS AND AS 3500.3-1990. 7) ALL SERVICES TO BE LOCATED & VERIFIED BY THE BUILDER WITH RELEVANT
- AUTHORITIES BEFORE ANY BUILDING WORK COMMENCES. 8) ALL CONSTRUCTION & MATERIALS TO BE IN ACCORDANCE WITH THE NATIONAL CONSTRUCTION CODE (NCC), LOCAL GOVERNMENT POLICIES, AUSTRALIAN STANDARDS 8
- CURRENT MANUFACTURER'S SPECIFICATIONS & INSTALLATION DETAILS.
- **GMKA PTY LTD BOARDING HOUSE Property Description** LOT 3 / DP 39084 - 31 SECOND **AVE KINGSWOOD NSW 2747**

#### Sheet Title SAFETY NOTES Project No. Sheet No. **Sheet Size** A3 100119 A13 Scale 17/3/2017 1:100 Drawn by Checked by SM SM

REV	DESCRIPTION	DATE
01	CONCEPT	12/04/2017
02	DA SUBMISSION	24/10/2017
03	ADDITIONAL INFORMATION	20/06/2018



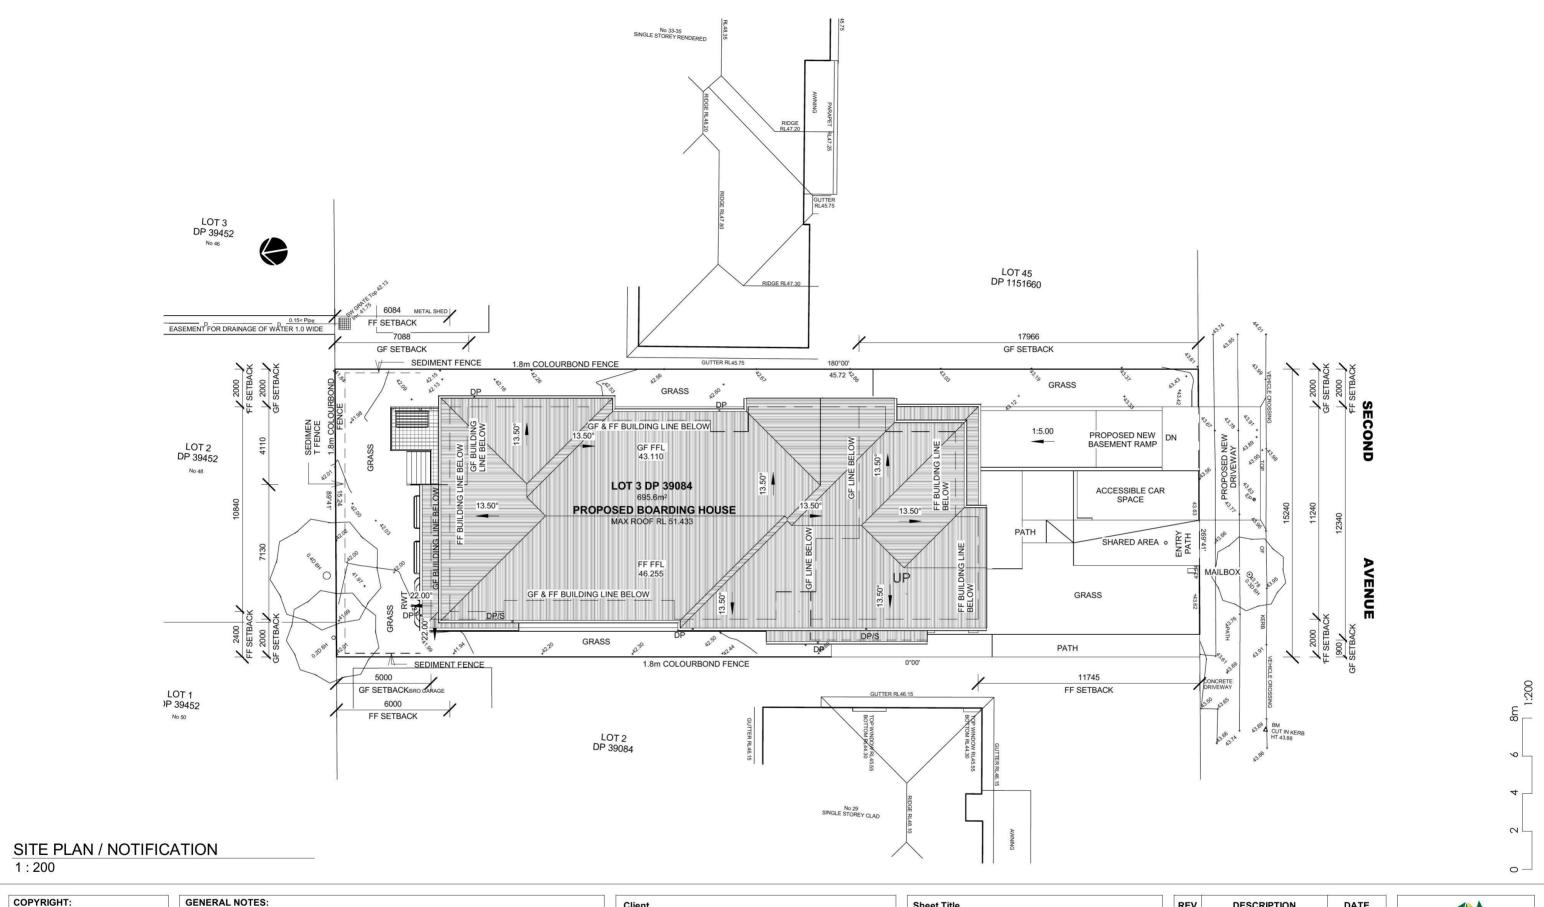

THIS DESIGN & THE ASSOCIATED DOCUMENTS ARE SUBJECT TO COPYRIGHT LAWS & MAY NOT BE REPRODUCED IN ANY FORM WITHOUT WRITTEN CONSENT FROM AUSTRALIAN SUSTAINABLE DESIGN AND CONSTRUCTION PTY LTD T/AS AUSDAC.



The Essential First Step

1) ALL DIMENSIONS & FLOOR AREAS ARE TO BE VERIFIED BY THE BUILDER PRIOR TO THE COMMENCEMENT OF ANY BUILDING WORK. ANY DISCREPANCIES ARE TO BE BROUGHT TO THE ATTENTION OF THE DESIGNER.
2) LEVELS SHOWN ARE APPROXIMATE UNLESS ACCOMPANIED BY REDUCED LEVELS.

3) FIGURED DIMENSIONS MUST BE TAKEN IN PREFERENCE TO SCALING.

4) ALL BOUNDARY CLEARANCES MUST BE VERIFIED BY THE SURVEYOR PRIOR TO THE

COMMENCEMENT OF ANY BUILDING WORKS.
5) WHERE ENGINEERING DRAWINGS ARE REQUIRED SUCH MUST TAKE PREFERENCE TO THIS DRAWING.

6) STORMWATER TO BE DISCHARGED TO COUNCIL'S REQUIREMENTS AND AS 3500.3-1990. 7) ALL SERVICES TO BE LOCATED & VERIFIED BY THE BUILDER WITH RELEVANT AUTHORITIES BEFORE ANY BUILDING WORK COMMENCES.

8) ALL CONSTRUCTION & MATERIALS TO BE IN ACCORDANCE WITH THE NATIONAL CONSTRUCTION CODE (NCC), LOCAL GOVERNMENT POLICIES, AUSTRALIAN STANDARDS 8 CURRENT MANUFACTURER'S SPECIFICATIONS & INSTALLATION DETAILS.


## **GMKA PTY LTD**

**BOARDING HOUSE** 

**Property Description** LOT 3 / DP 39084 - 31 SECOND **AVE KINGSWOOD NSW 2747** 

#### **NOTIFICATION PLAN** Project No. **Sheet Size NN01** A3 100119 Scale 17/3/2017 1:200 Drawn by Checked by SM SM


REV	DESCRIPTION	DATE	
01	CONCEPT	12/04/2017	
02	DA SUBMISSION	24/10/2017	7
03	ADDITIONAL INFORMATION	20/06/2018	AUSDAC
			AUSTRALIAN SUSTAINABLE DESIGN AND CONSTRUCTION PTY LTD
			T: 1300 AUSDAC (287 322) F: 1300 856 935 P: PO BOX 414, GRANVILLE
			NSW 2142 W: WWW.AUSDAC.COM.AU

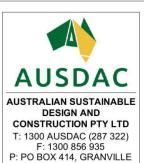



#### South East - NOTIFICATION

1:100

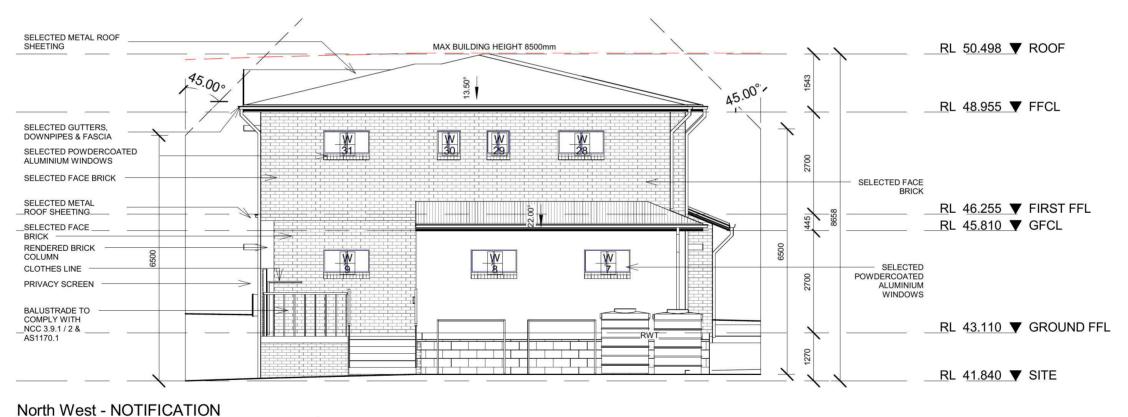

#### 1:100

#### COPYRIGHT:

THIS DESIGN & THE ASSOCIATED DOCUMENTS ARE SUBJECT TO COPYRIGHT LAWS & MAY NOT BE REPRODUCED IN ANY FORM WITHOUT WRITTEN CONSENT FROM AUSTRALIAN SUSTAINABLE DESIGN AND CONSTRUCTION PTY LTD T/AS AUSDAC.



The Essential First Step

#### **GENERAL NOTES:**

1) ALL DIMENSIONS & FLOOR AREAS ARE TO BE VERIFIED BY THE BUILDER PRIOR TO THE COMMENCEMENT OF ANY BUILDING WORK. ANY DISCREPANCIES ARE TO BE BROUGHT TO THE ATTENTION OF THE DESIGNER.
2) LEVELS SHOWN ARE APPROXIMATE UNLESS ACCOMPANIED BY REDUCED LEVELS.

3) FIGURED DIMENSIONS MUST BE TAKEN IN PREFERENCE TO SCALING. 4) ALL BOUNDARY CLEARANCES MUST BE VERIFIED BY THE SURVEYOR PRIOR TO THE

COMMENCEMENT OF ANY BUILDING WORKS. 5) WHERE ENGINEERING DRAWINGS ARE REQUIRED SUCH MUST TAKE PREFERENCE TO THIS DRAWING.

6) STORMWATER TO BE DISCHARGED TO COUNCIL'S REQUIREMENTS AND AS 3500.3-1990. 7) ALL SERVICES TO BE LOCATED & VERIFIED BY THE BUILDER WITH RELEVANT

AUTHORITIES BEFORE ANY BUILDING WORK COMMENCES. 8) ALL CONSTRUCTION & MATERIALS TO BE IN ACCORDANCE WITH THE NATIONAL CONSTRUCTION CODE (NCC), LOCAL GOVERNMENT POLICIES, AUSTRALIAN STANDARDS 8 CURRENT MANUFACTURER'S SPECIFICATIONS & INSTALLATION DETAILS.

### **GMKA PTY LTD**

**BOARDING HOUSE** 

**Property Description** LOT 3 / DP 39084 - 31 SECOND

**AVE KINGSWOOD NSW 2747** 

Sheet Title		
NOTIFICATIO	N PLAN	
Project No.	Sheet No.	Sheet Size
100119	NN02	A3
Date	Scale	
17/3/2017	1:100	
Drawn by	Checked by	
SM	SM	

REV	DESCRIPTION	DATE
01	CONCEPT	12/04/2017
02	DA SUBMISSION	24/10/2017
03	ADDITIONAL INFORMATION	20/06/2018



3

0

0 -

T: 1300 AUSDAC (287 322) F: 1300 856 935 P: PO BOX 414, GRANVILLE NSW 2142 W: WWW.AUSDAC.COM.AU



### South West - NOTIFICATION

1:100

#### COPYRIGHT:

THIS DESIGN & THE ASSOCIATED DOCUMENTS ARE SUBJECT TO COPYRIGHT LAWS & MAY NOT BE REPRODUCED IN ANY FORM WITHOUT WRITTEN CONSENT FROM AUSTRALIAN SUSTAINABLE DESIGN AND CONSTRUCTION PTY LTD T/AS AUSDAC.



The Essential First Step

#### **GENERAL NOTES:**

1) ALL DIMENSIONS & FLOOR AREAS ARE TO BE VERIFIED BY THE BUILDER PRIOR TO THE COMMENCEMENT OF ANY BUILDING WORK. ANY DISCREPANCIES ARE TO BE BROUGHT TO THE ATTENTION OF THE DESIGNER.

2) LEVELS SHOWN ARE APPROXIMATE UNLESS ACCOMPANIED BY REDUCED LEVELS.

3) FIGURED DIMENSIONS MUST BE TAKEN IN PREFERENCE TO SCALING.

4) ALL BOUNDARY CLEARANCES MUST BE VERIFIED BY THE SURVEYOR PRIOR TO THE COMMENCEMENT OF ANY BUILDING WORKS.

5) WHERE ENGINEERING DRAWINGS ARE REQUIRED SUCH MUST TAKE PREFERENCE TO THIS DRAWING.

6) STORMWATER TO BE DISCHARGED TO COUNCIL'S REQUIREMENTS AND AS 3500.3-1990. 7) ALL SERVICES TO BE LOCATED & VERIFIED BY THE BUILDER WITH RELEVANT AUTHORITIES BEFORE ANY BUILDING WORK COMMENCES.

8) ALL CONSTRUCTION & MATERIALS TO BE IN ACCORDANCE WITH THE NATIONAL CONSTRUCTION CODE (NCC), LOCAL GOVERNMENT POLICIES, AUSTRALIAN STANDARDS 8 CURRENT MANUFACTURER'S SPECIFICATIONS & INSTALLATION DETAILS.

# **GMKA PTY LTD BOARDING HOUSE Property Description**

LOT 3 / DP 39084 - 31 SECOND

**AVE KINGSWOOD NSW 2747** 

NOTIFICATIO	N PLAN	
Project No.	Sheet No.	Sheet Size
100119	NN03	A3
Date	Scale	
17/3/2017	1:100	
Drawn by	Checked by	
SM	SM	


REV	DESCRIPTION	DATE
01	CONCEPT	12/04/2017
02	DA SUBMISSION	24/10/2017
03	ADDITIONAL INFORMATION	20/06/2018



0 -

RL 43.110 GROUND FFL

RL 41.840 ▼ SITE

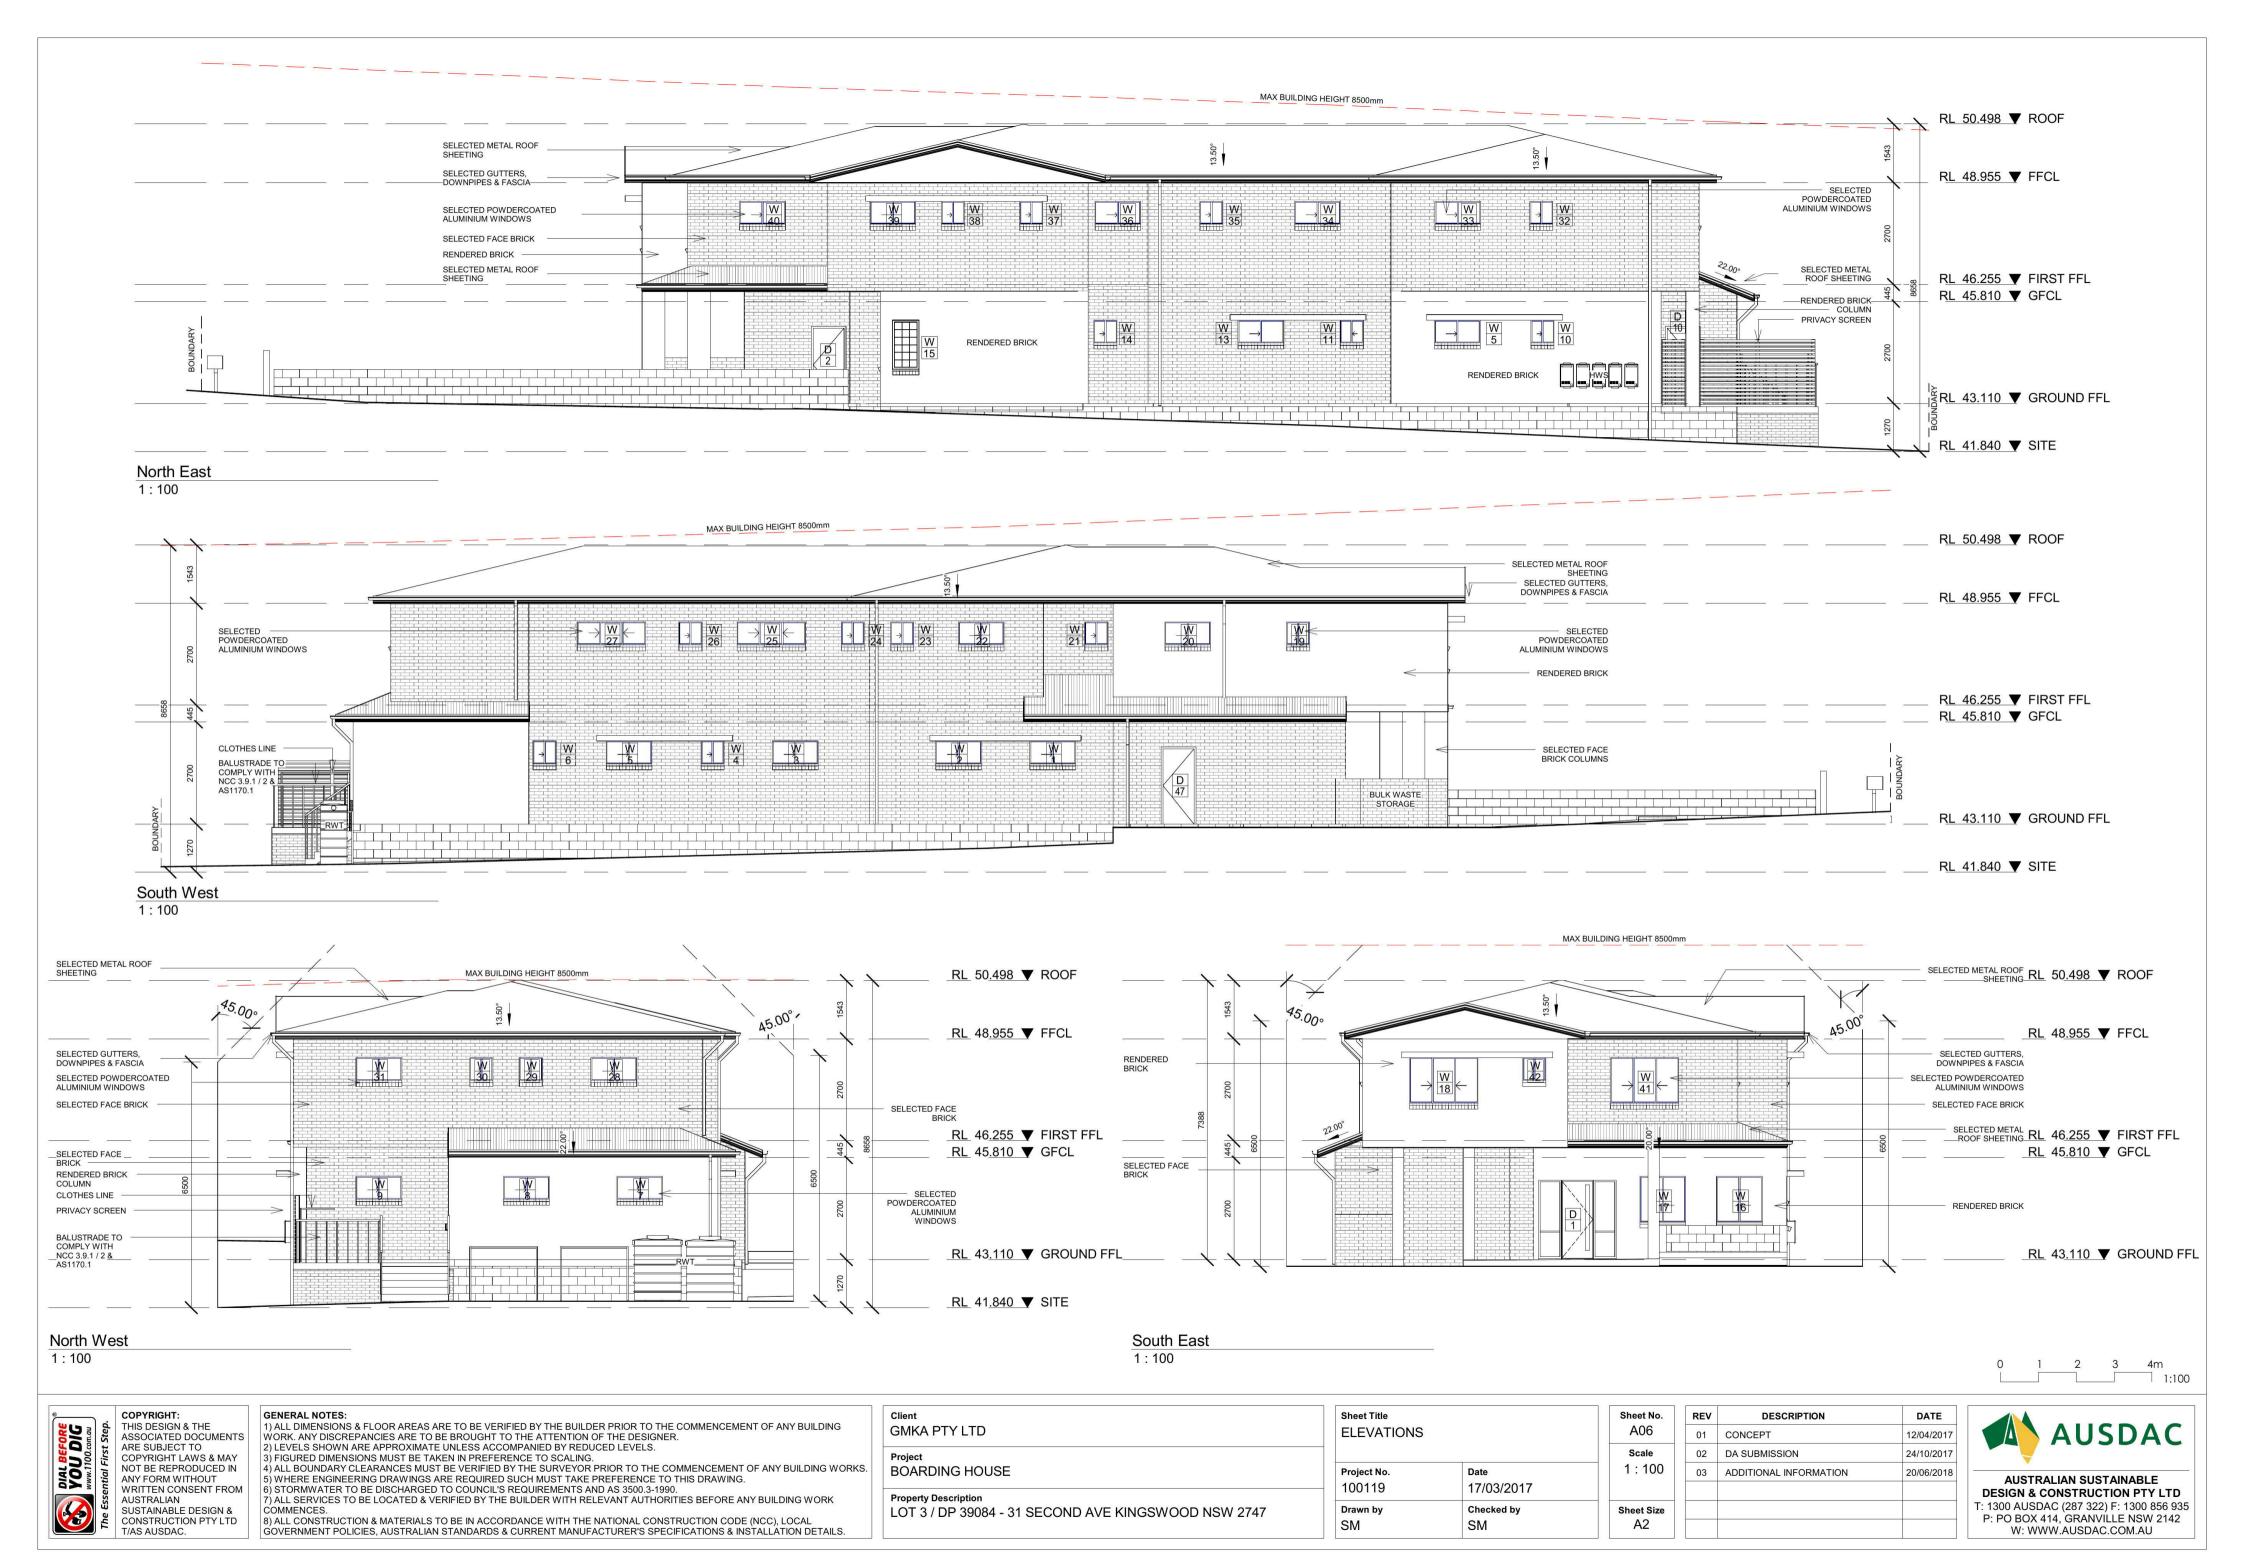


### ANNEXURE "A" TO TRANSFER GRANTING EASEMENT

PLAN SHOWING EASEMENT TO DRAIN WATER 1.5 WIDE OVER LOT 1 IN DP 39452



### **CRESCENT**

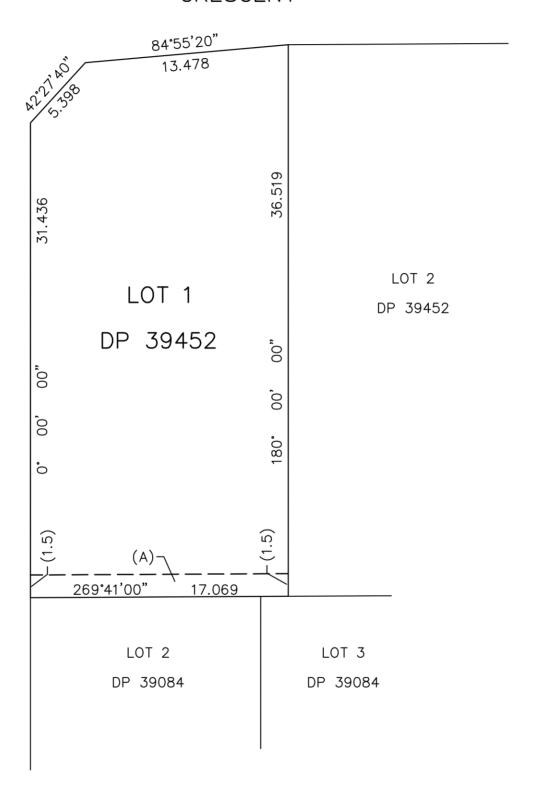

(A) EASEMENT TO DRAIN WATER 1.5 WIDE

ANTHONY

Peter Terence Wright

REGISTERED SURVEYOR

SCALE 1:250 @ A4